RESTROOM REFURBISHMENT SEAWORLD SAN DIEGO




6353 DEL CERRO BLVD., SAN DIEGO, CA 92120 619.698.9177 | www.coargroup.com

PROJECT:

DESIGN

San Diego, CA 92109

VICINITY MAP

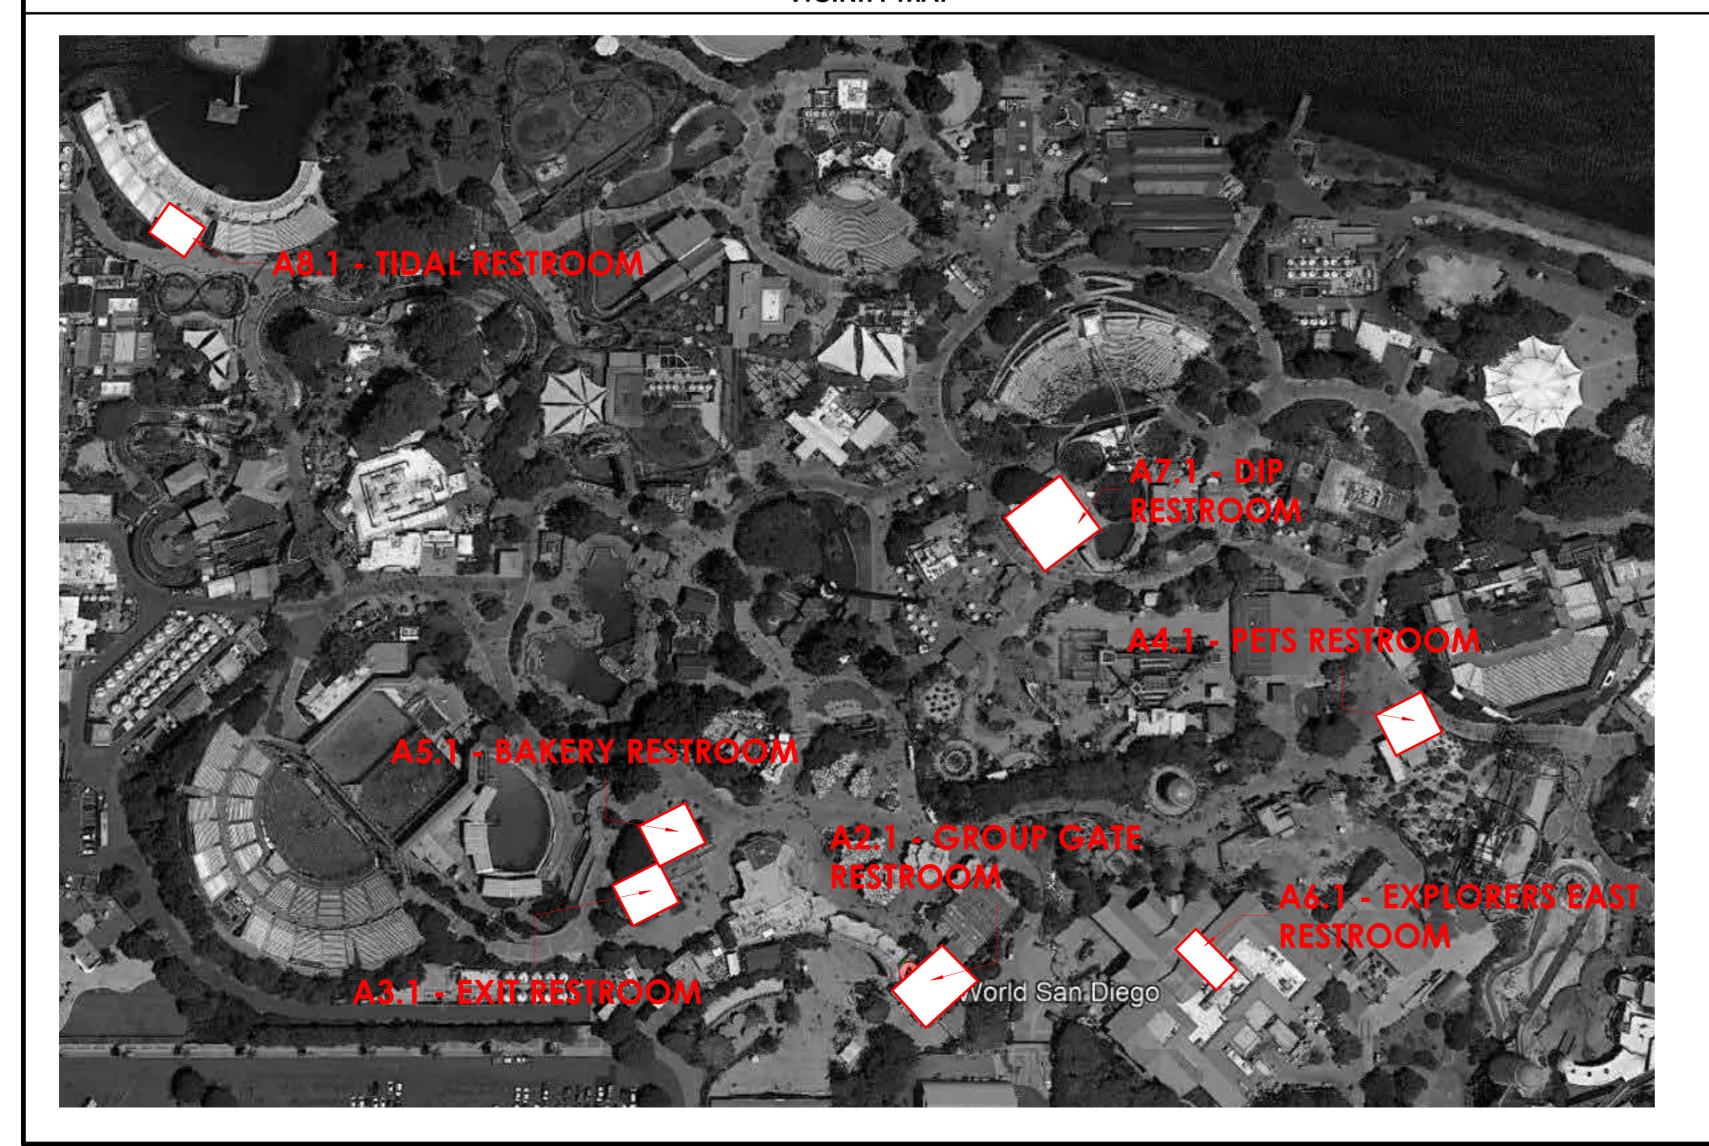

	PRO	PR				
PROJECT ADD ASSESSOR'S PA		(PROJECT ADDRESS) (PROJECT ADDRESS) (###-###-##) (OWNER INFO.)		ARCHITECTURE JEFF KATZ ARCHITECTURE 6353 Del Cerro Blvd San Diego, CA 92120 (619) 698-9177 / (619) 698-9178 (FAX) Contact: Jeff Katz, AIA jeff@jeffkatzarchitecture.com		
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CONSTRUCTIO	ON TYPE:	(CONSTRUCTION TYPE)		T-1 TITLE SHEET T-3 ACCESSIBILITY T-4 ACCESSIBILITY T-6 SIGNAGE ACC		
ALLOWABLE B	LDG AREA:		00,000 S.F.	A1.1 SITE PLAN A2.1 GROUP GATES		
R-3			00,000 S.F.	A3.1 EXIT RESTROOM		
S-2			00,000 S.F.	A4.1 PETS RESTROO A5.1 BAKERY RESTRO		
ACTUAL BLDG	S AREA:	FIRST FLOOR SECOND FLOOR	00,000 S.F. 00,000 S.F.	A6.1 EXPLORERS EA A6.2 SCHEDULES A7.1 DIP RESTROOM		
		TOTAL BUILDING AREA	00,000 S.F.	A8.1 TIDAL RESTROC		
ACTUAL AREA	<u>\:</u>					
B ACTUAL:			00,000 S.F.			
R-3 ACTUAL:			00,000 S.F.			
S-2 ACTUAL:			00,000 S.F.			
SITE AREA:			000,000 S.F. (00 ACRES)			
NUMBER OF S	TORIES:		2			
MAX BUILDING	G HEIGHT:		00' - 0''			
PARKING:	Parking Required:	Public: No Requirement				
	Parking Provided:	Accessible Parking	00 00			
	Public Parking:	Spaces: Standard Parking Spaces:	00			
		Total:		1		

LEGAL DESCRIPTION

PARCEL: (00000) LEGAL DESCRIPTION

SeaWorld San Diego Restroom Remodel A REGISTERED CALIFORNIA ARCHITECT, CIVIL OR STRUCTURAL ENGINEER SHALL 500 Sea World Dr.

SHEET INDEX

OBSERVE THE WORK OF CONSTRUCTION AND SUBMIT AFFIDAVITS ATTESTING TO

THE COMPLIANCE OF THE CONSTRUCTION WITH THE APPROVED CONTRACT

PROJECT TEAM

Description T-1 TITLE SHEET T-3 ACCESSIBILITY DETAILS T-6 SIGNAGE ACCESSIBILITY DETAILS **DESCRIPTION:** A2.1 GROUP GATE SCOPE OF WORK CONCEPT

A3.1 EXIT RESTROOM SCOPE OF WORK A4.1 PETS RESTROOM SCOPE OF WORK A5.1 BAKERY RESTROOM SCOPE OF WORK A6.1 EXPLORERS EAST SCOPE OF WORK A6.2 SCHEDULES A7.1 DIP RESTROOM SCOPE OF WORK A8.1 TIDAL RESTROOM SCOPE OF WORK

> **NOT FOR** CONSTRUCTION PROJECT NUMBER:

SHEET TITLE:

TITLE SHEET

CLEAR FLOOR SPACE FOR WHEELCHAIRS

- MINIMUM CLEAR FLOOR OR GROUND SPACE REQUIRED TO ACCOMMODATE A SINGLE, STATIONARY WHEELCHAIR AND OCCUPANT IS 30" x 48". MINIMUM CLEAR FLOOR OR GROUND SPACE FOR WHEELCHAIRS MAY BE POSITIONED FOR FORWARD OR PARALLEL APPROACH TO AN OBJECT. FLOOR OR GROUND SPACE FOR WHEEL CHAIRS MAY BE PART OF THE KNEE SPACE AND TOE CLEARANCE REQUIRED UNDER SOME OBJECTS. ONE FULL UNOBSTRUCTED SIDE OF THE CLEAR FLOOR OR GROUND SPACE SHALL ADJOIN AN ACCESSIBLE ROUTE OR ADJOIN ANOTHER CLEAR FLOOR SPACE.
- ALCOVES ARE TO BE 60" WIDE WHEN GREATER THAN 15" DEEP.
- PROVIDE AN ADDITIONAL 6" WIDTH ON ONE SIDE FOR ALCOVES GREATER THAN 24" DEEP AND DESIGNED FOR FRONT APPROACH.

<u>HAZARDS AND PROTRUDING OBJECTS</u>

- OBJECTS WITH LEADING EDGES BETWEEN 27" AND 80" ABOVE THE FINISHED FLOOR SHALL PROTRUDE NO MORE THAN 4" INTO CIRCULATION PATH.
- OBJECTS MOUNTED WITH THEIR LEADING EDGES AT OR BELOW 27" ABOVE THE FINISHED FLOOR MAY PROTRUDE ANY AMOUNT.
- OBJECTS MOUNTED ON POSTS / PYLONS MAY OVERHANG 12" MAXIMUM FROM 27" TO 80" ABOVE THE GROUND OR FINISHED FLOOR.
- PROTRUDING OBJECTS SHALL NOT REDUCE THE REQUIRED CLEAR WIDTH OF AN ACCESSIBLE ROUTE OR MANEUVERING SPACE.
- ANY OBSTRUCTION OVERHANGING A PEDESTRIAN WAY SHALL BE A MINIMUM OF 80" ABOVE THE WALKING SURFACE AS MEASURED TO THE BOTTOM OF THE OBSTRUCTION. GUARDRAILS OR OTHER BARRIERS SHALL BE PROVIDED WHERE THE VERTICAL CLEARANCE IS LESS THAN 80". SUCH GUARDRAILS SHALL BE LOCATED 27" MAX ABOVE FINISHED FLOOR.

8. THE BOTTOM 10" OF ALL DOORS (EXCEPT SLIDING) SHALL HAVE A SMOOTH UNINTERRUPTED SURFACE TO ALLOW THE DOOR TO BE OPENED BY A WHEELCHAIR FOOTREST WITHOUT CREATING A TRAP OR HAZARDOUS CONDITION WHERE NARROW FRAME DOORS ARE USED, A 10" HIGH SMOOTH PANEL SHALL BE INSTALLED ON THE PUSH SIDE OF THE DOOR. WHICH WILL ALLOW THE DOOR TO BE OPENED BY A WHEELCHAIR FOOTREST. SURFACES ALONG THIS AREA MUST BE WITHIN 1/16" OF THE SAME PLANE AS THE OTHER. CAVITITES CREATED BY KICK PLATES MUST BE CAPPED.

TOILET ROOM FIXTURES AND ACCESSORIES

THE ADJACENT WALL.

UNDERNEATH LAVATORY.

CONTINIOUS PAPER FLOW.

MAXIMUM OF 19" MEASURED TO THE TOP OF THE TOILET SEAT.

1. THE HEIGHT OF ACCESSIBLE WATER CLOSETS SHALL BE A MINIMUM OF 17" AND A

PROVIDE 17" MINIMUM - 18" MAXIMUM FROM THE CENTERLINE OF THE WATER CLOSET TO

TOILET AND URINAL FLUSH CONTROLS SHALL BE OPERABLE WITH ONE HAND AND SHALL

THE FLUSH VALVES SHALL BE MOUNTED ON THE OPEN (WIDE) SIDE OF THE TOILET STALL.

TOILET AND URINAL FLUSH CONTROLS SHALL BE NO MORE THAN 44" ABOVE THE FLOOR.

4. WHERE URINALS ARE PROVIDED, AT LEAST ONE SHALL HAVE A CLEAR SPACE 30" WIDE BY 48"

AMBULATORY STALLS ARE REQUIRED WHERE 6 OR MORE STALLS ARE PROVIDED WITHIN A

COMPARTMENTS SHALL BE 60" DEEP MIN. AND 35"MIN - 37" MAX WIDE. COMPARTMENT

LAVATORY TO ALLOW FORWARD APPROACH. SUCH CLEAR SPACE SHALL ADJOIN OR

7. LAVATORIES SHALL BE MOUNTED WITH A CLEARANCE OF AT LEAST 29" FROM THE FLOOR TO

THE BOTTOM OF THE APRON WITH 27" MINIMUM KNEE CLEARANCE UNDER THE FRONT LIP

CLEARANCE SHALL BE SAME WIDTH AND A MINIMUM OF 9 INCHES HIGH FROM THE FLOOR

MULTIPLE ACCOMODATION TOILET ROOM OR WHERE THE COMBINATION OF URINALS AND

LONG IN FRONT OF THE URINAL. AT LEAST ONE URINAL WITH 13 1/2" MIN. RIM PROJECTION

THE FORCE REQUIRED TO ACTIVATE CONTROLS SHALL BE NO GREATER THAN 5 LBS.

FROM THE WALL AND A MAXIMUM OF 17" ABOVE THE FLOOR SHALL BE INSTALLED.

DOORS SHALL NOT SWING INTO THE MINIMUM REQUIRED COMPARTMENT AREA.

6. A CLEAR FLOOR SPACE 30" WIDE BY 48" LONG SHALL BE PROVIDED IN FRONT OF A

OVERLAP AN ACCESSIBLE ROUTE AND SHALL EXTEND INTO KNEE AND TOE SPACE

EXTENDING A MINIMUM OF 30" IN WIDTH WITH 8" MINIMUM DEPTH AT THE TOP. TOE

AND A MINIMUM OF 17"-19"MAXIMUM DEEP FROM THE FRONT OF THE LAVATORY.

8. HOT WATER AND DRAIN PIPES UNDER LAVATORIES SHALL BE INSULATED OR OTHERWISE

9. MIRRORS LOCATED ABOVE LAVATORIES OR COUNTERTOPS SHALL HAVE BOTTOM OF

10. LOCATE PAPER TOWEL DISPENSERS, SANITARY NAPKIN DISPENSERS, AND WASTE

RECEPTACLES WITH ALL OPERABLE PARTS NOT MORE THAN 40" FROM THE FLOOR.

11. LOCATE TOILET TISSUE DISPENSERS ON THE WALL 7-9" FROM THE FRONT OF THE WATER

MIN. ABOVE FINISHED FLOOR AND SHALL NOT BE LOCATED BEHIND GRAB BARS.

POSITION, MAY ENCROACH INTO THE TURNING SPACE BY 12" MAX

MULTIPLE ACCOMMODATION TOILET ROOMS

ANGLE OF 90 DEGREES FROM ITS CLOSED POSITION.

ONE SIDE AND 24"MINIMUM ON THE OTHER SIDE.

5. GRAB BARS SHALL NOT ROTATE WITHIN THEIR FITTINGS.

6. GRAB BARS SHALL BE DESIGNED TO SUPPORT A 250 POUND FORCE.

7. NO OBJECT TO BE MOUNTED WITHIN 1 1/2" BELOW OR 12" ABOVE ANY GRAB BAR.

OF THE LOWEST BRAILLE CELLS TO BE 48" MINIMUM ABOVE FINISHED FLOOR.

AND THE GRAB BARS SHALL BE 1-1/2".

SHARP OR ABRASIVE ELEMENTS.

11B-304.3.2 SHALL BE PROVIDED.

SIDE OPENING DOORS.

GRAB BARS

<u>SIGNAGE</u>

COVERED. THERE SHALL BE NO SHARP OR ABRASIVE SURFACES UNDER LAVATORIES.

REFLECTIVE SURFACE 40" MAX. ABOVE FINISHED FLOOR: MIRRORS MOUNTED ELSEWHERE

SHALL HAVE BOTTOM EDGE OF REFLECTIVE SURFACE 35" MAX. ABOVE FINISHED FLOOR.

CLOSET TO THE CENTERLINE OF THE DISPENSER. THE OUTLET OF THE DISPENSER SHALL BE 19"

DISPENSERS SHALL NOT BE OF A TYPE THAT CONTROLS DELIVERY OR THAT DOES NOT ALLOW

12. DOORS CANNOT SWING INTO THE REQUIRED CLEAR FLOOR SPACE AT ANY FIXTURE OTHER THAN THE DOOR TO THE ACESSIBLE WATER CLOSET COMPARTMENT, A DOOR, IN ANY

13. CLEARANCE AROUND WATER CLOSET SHALL BE 60" WIDE x 56" DEEP PROVIDED IN FRONT

14. SANITARY NAPKIN DISPOSAL UNITS, IF PROVIDED, SHALL COMPLY WITH SECTION 11B-309.4 AND SHALL BE WALL MOUNTED AND LOCATED ON THE SIDE WALL BETWEEN THE REAR WALL

OF THE TOILET AND THE TOILET PAPER DISPENSER, ADJACENT TO THE TOILET PAPER

DISPENSER. THE DISPOSAL UNIT SHALL BE LOCATED BELOW THE GRAB BAR WITH THE OPENING OF THE DISPOSAL UNIT 19 INCHES MINIMUM ABOVE THE FINISH FLOOR.

1. A CLEAR SPACE, MEASURED FROM THE FLOOR TO A HEIGHT OF 27" ABOVE THE FLOOR, WITHIN THE SANITARY FACILITY ROOM, OF SUFFICIENT SIZE TO INSCRIBE A CIRCLE OF A DIAMETER NOT LESS THAN 60 INCHES, OR A T SHAPED SPACE IN ACCORDANCE WITH

2. CLEARANCE AROUND A WATER CLOSET SHALL BE 60" MIN. MEASURED PERPENDICULAR

48" LONG CLEAR SPACE IN FRONT OF WATER CLOSET SHALL BE PROVIDED IF THE

FROM THE SIDE WALL AND 56" MIN. MEASURED PERPENDICULAR FROM THE REAR WALL. A

COMPARTMENT HAS AN END OPENING DOOR (FACING THE WATER CLOSET). A 60" LONG

SIDE. GRAB BARS SHALL NOT PROJECT MORE THAN 3" INTO CLEAR SPACE SPECIFIED ABOVE.

CLOSING DEVICE, AND A CLEAR UNOBSTRUCTED OPENING WIDTH OF 32" WHEN LOCATED

CLEAR SPACE SHALL BE PROVIDED IN COMPARTMENT WHEN DOOR IS LOCATED AT THE

3. WATER CLOSET COMPARTMENT SHALL BE EQUIPPED WITH DOOR THAT HAS AN AUTOMATIC

AT THE END, AND 34" WHEN LOCATED AT SIDE, WHEN THE DOOR IS POSITIONED AT AN

4. EXCEPT FOR DOOR OPENINGS, A CLEAR UNOBSTRUCTED ACCESS NOT LESS THAN 44" SHALL BE PROVIDED TO ALL WATER CLOSET COMPARTMENTS DESIGNED FOR USE BY THE DISABLED. THE SPACE IMMEDIATELY IN FRONT OF A WATER CLOSET COMPARTMENT SHALL BE NOT LESS

THAN 48" AS MEASURED AT RIGHT ANGLES TO THE COMPARTMENT DOOR IN ITS CLOSED

5. THE WATER CLOSET AND DOOR MANEUVERING CLEARANCE CANNOT OVERLAP IN THE

6. STALL DOORS TO BE HINGED 4" MAXIMUM OPPOSITE THE WATER CLOSET FOR FRONT OR

7. STALL DOORS CANNOT SWING INTO THE REQUIRED CLEAR AREA AT THE WATER CLOSET.

1. GRAB BARS SHALL BE LOCATED ON ONE SIDE AND THE BACK OF THE PHYSICALLY DISABLED TOILET STALL OR COMPARTMENT AND SHALL BE SECURELY ATTACHED 33" MINIMUM-36"

MAXIMUM, MEASURED TO THE TOP OF GRIPING SURFACE, ABOVE AND PARALLEL TO THE

2. GRAB BARS AT THE SIDE SHALL BE AT LEAST 42" LONG WITH THE FRONT END POSITIONED

3. THE DIAMETER OR WIDTH OF THE GRIPPING SURFACES OF A GRAB BAR WITH CIRCULAR

CROSS SECTIONS SHALL HAVE AN OUTSIDE DIAMETER OF 1 1/4"MIN AND 2" MAXIMUM.

DIMENSION OF 2" MAXIMUM AND A PERIMETER DIMENSION OF 4" MIN AND 4.8" MAXIMUM.

IF THE GRAB BARS ARE MOUNTED ADJACENT TO A WALL, THE SPACE BETWEEN THE WALL

4. GRAB BARS, AND ANY WALL OR OTHER SURFACE ADJACENT TO IT, SHALL BE FREE OF ANY

1. BASELINE OF THE HIGHEST LINE OF RAISED CHARACTER TO BE 60" MAXIMUM AND BASELINE

2. TACTILE ROOM IDENTIFICATION SIGNS SHALL BE LOCATED SO THAT A CLEAR FLOOR SPACE

OF 18" MIN. x 18" MIN. CENTERED ON SIGN IS PROVIDED BEYOND THE ARC OF ANY DOOR

GRAB BARS WITH NON CIRCULAR CROSS SECTIONS SHALL HAVE A CROSS SECTION

54"MINIMUM FROM THE BACK OF THE STALL AND WITH THE FRONT END POSITIONED 24"

MINIMUM IN FRONT OF THE WATER CLOSET. THE SIDE GRAB BAR SHALL BE LOCATED 12"

MAXIMUM FROM THE REAR WALL. GRAB BARS AT THE BACK SHALL NOT BE LESS THAN 36" LONG AND SHALL EXTEND FROM THE CENTERLINE OF THE WATER CLOSET 12" MINIMUM ON

8. A DOOR PULL SHALL BE PLACED ON BOTH SIDES OF THE DOOR NEAR THE LATCH.

OF THE WATER CLOSET, NO OTHER FIXTURES CAN BE LOCATED WITHIN THIS AREA. A MIN. 60" WIDE AND 48" DEEP MANEUVERING SPACE SHALL BE PROVIDED IN FRONT OF THE WATER

TOP EDGE OF MIRRORS SHOULD BE 74" HIGH TO BE USEABLE BY AMBULATORY PEOPLE,

WATER CLOSETS TOTALS SIX OR MORE FIXTURES. AMBULATORY ACCESSIBLE

NOT REQUIRE TIGHT GRASPING, PINCHING, OR TWISTING OF THE WRIST. CONTROLS FOR


- 9. THE MAXIMUM EFFORT TO OPERATE DOORS SHALL NOT EXCEED 5 LBS. FOR EXTERIOR DOORS AND 5 LBS. FOR INTERIOR DOORS. SUCH PULL OR PUSH EFFORT BEING APPLIED AT RIGHT ANGLES TO HINGED DOORS AND AT THE CENTER PLANE OF SLIDING OR FOLDING DOORS. COMPENSATING DEVICES OR AUTOMATIC DOOR OPERATORS MAY BE UTILIZED TO MEET THE ABOVE STANDARDS. WHEN FIRE DOORS ARE REQUIRED, THE MAXIMUM EFFORT TO OPERATE THE DOOR MAY NOT EXCEED 15 LBS.
- 10. DOOR CLOSERS REQUIRE AT LEAST 5 SECONDS TO CLOSE FROM AN OPEN POSITION OF 90 DEGREES TO 12 DEGREES FROM THE LATCH
- 11. EACH GRADE-LEVEL EXTERIOR EXIT DOOR SHALL BE IDENTIFIED BY A TACTILE SIGN WITH THE WORD "EXIT". EACH EXIT DOOR THAT LEADS DIRECTLY TO GRADE-LEVEL EXTERIOR EXIT BY MEANS OF STAIRWAY OR RAMP IS IDENTIFIED BY A TACTILE SIGN THAT STATES "EXIT STAIR DOWN," "EXIT RAMP DOWN," "EXIT STAIR UP," OR "EXIT RAMP UP" AS APPROPRIATE. EACH EXIT DOOR THAT LEADS DIRECTLY TO GRADE-LEVEL EXTERIOR EXIT BY MEANS OF AN EXIT ENCLOSURE OR EXIT PASSAGEWAY IS IDENTIFIED BY A TACTILE EXIT SIGN WITH THE WORDS "EXIT ROUTE". EACH ACCESS DOOR FROM AN INTERIOR ROOM OR AREA TO A CORRIDOR OR HALLWAY THAT IS REQUIRED TO HAVE A VISUAL EXIT SIGN IS IDENTIFIED BY A TACTILE EXIT SIGN WITH THE WORDS "EXIT ROUTE". EACH DOOR THROUGH AN HORIZONTAL EXIT IS IDENTIFIED BY A TACTILE EXIT SIGN WITH THE WORDS "TO EXIT".
- 12. VISION LIGHTS MUST HAVE BOTTOM OF AT LEAST ONE GLAZED PANEL LOCATED 43" MAX. ABOVE FLOOR FINISH.

ADDITIONAL REQUIREMENTS

- 1. THE TOP OF THE BOX OF THE OPERATING HANDLE OF SWITCHES INTENDED TO BE USED BY OCCUPANTS OF A ROOM OR AREA TO CONTROL LIGHTING AND RECEPTACLE OUTLETS, APPLIANCES, OR COOLING, HEATING AND VENTILATING EQUIPMENT, SHALL COMPLY WITH SECTION 11B-308 EXCEPT THE LOW REACH SHALL BE MEASURED TO THE BOTTOM OF THE OUTLET BOX AND THE HIGH REACH SHALL BE MEASURED TO THE TOP OF THE OUTLET BOX.
- 2. ELECTRICAL RECEPTACLE OUTLETS ON BRANCH CIRCUITS OF 30 AMPERES OR LESS AND COMMUNICATION SYSTEM RECEPTACLES SHALL COMPLY WITH SECTION 11B-308 EXCEPT THE LOW REACH SHALL BE MEASURED TO THE BOTTOM OF THE OUTLET BOX AND THE HIGH REACH SHALL BE MEASURED TO THE TOP OF THE OUTLET BOX.

- 3. HIGHEST OPERABLE PART OF FIRE ALARM INITIATING DEVICES (BOXES) SHALL BE LOCATED NO LESS THAN 42" AND NOT MORE THAN 48" MEASURED VERTICALLY FROM ABOVE THE LEVEL OF THE ADJACENT FLOOR, WORKING PLATFORM, GROUND SURFACE, OR SIDEWALK TO THE HIGHEST POINT OF THE ACTIVATING HANDLE OR LEVER OF THE
- 4. INTERNATIONAL SYMBOL OF ACCESSIBILITY SHALL BE THE STANDARD USED TO IDENTIFY FACILITIES THAT ARE ACCESSIBLE TO AND USABLE BY PHYSICALLY DISABLED PERSONS. THE SYMBOL SPECIFIED ABOVE SHALL CONSIST OF A WHITE FIGURE ON BLUE BACKGROUND. THE BLUE SHALL BE EQUAL TO COLOR NO. 15090 IN FEDERAL STANDARD 595C.
- 5. ALL CONTROLS TO BE 15" MIN. TO 48" MAX., REGARDLESS OF APPROACH. WHERE A HIGH FORWARD REACH IS OVER AN OBSTRUCTION, THE CLEAR FLOOR SPACE SHALL EXTEND BENEATH THE ELEMENT FOR A DISTANCE NOT LESS THAN THE REQUIRED REACH DEPTH OVER THE OBSTRUCTION. THE MAX. HIGH FORWARD REACH SHALL BE 48" MAX WHERE THE REACH DEPTH IS 20"MAX. WHERE THE REACH DEPTH EXCEEDS 20" THE HIGH FORWARD REACH SHALL BE 44" MAX. AND THE REACH DEPTH SHALL BE 25" MAX. WHERE A CLEAR FLOOR SPACE ALLOWS FOR A PARALLEL APPROACH AND THE HIGH SIDE REACH IS OVER AN OBSTRUCTION THE HEIGHT OF THE OBSTRUCTION SHALL BE 34" MAX AND THE DEPTH SHALL BE 24" MAX. THE HIGH SIDE REACH SHALL BE 48" MAX FOR A REACH DEPTH OF 10" MAX. WHERE THE REACH DEPTH EXCEEDS 10" THE HIGH SIDE REACH SHALL BE 46" MAX WITH A REACH DEPTH OF 24" MAX.
- ACCESSIBLE PORTIONS OF SERVICE COUNTERS TO BE 28"-34" HIGH, 36" MIN. WIDE AND MUST EXTEND THE SAME DEPTH AS THE ADJACENT COUNTERSPACE.
- WHERE LOCKERS ARE PROVIDED FOR THE PUBLIC, AT LEAST 5% BUT NO FEWER THAN 1 OF EACH TYPE SHALL BE ACCESSIBLE.

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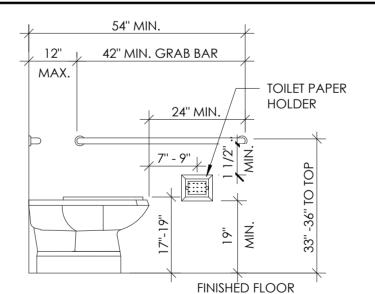


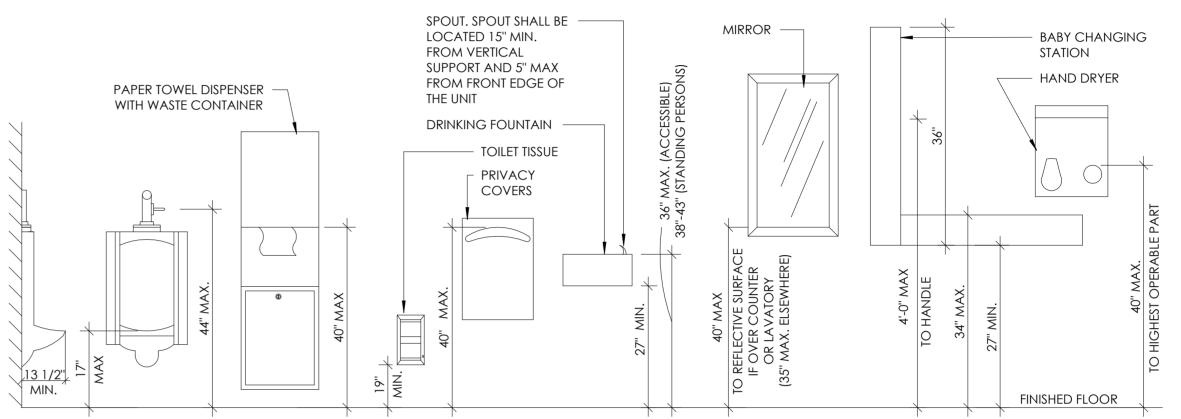A3 \ MOUNTING HEIGHT REQUIREMENTS T-3 / SCALE: 3/4" = 1'-0"

CLEAR, LEVEL CLEAR, LEVEL INT. DOORS FLOOR SPACE CLEAR, LEVEL ← FLOOR SPACE 24" MIN. CLR 1.5% MAX SLOPE FLOOR SPACE 109 NIM 1.5% MAX SLOPE EXT. DOORS 1.5% MAX SLOPI IN ANY MIN. DIRECTION **PULL SIDE** PULL SIDE PULL SIDE 48" MIN. WHEN **PUSH SIDE** PUSH SIDE | **PUSH SIDE** 48" MIN. WHEN DOOR HAS A DOOR HAS A **PROVIDE THIS** LATCH & 22" MIN. CLOSER **ADDITIONAL** CLOSER SPACE IF DOOR IS EQUIPPED WITH **BOTH A LATCH** AND A CLOSER FRONT APPROACH HINGE SIDE APPROACH LATCH SIDE APPROACH

DOOR PERMITTED

B3 \ REQUIRED CLEARANCES T-3 / SCALE: 1/2" = 1'-0"



- MOUNT TOILET PAPER DISPENSER WITHIN 7-9" OF SEAT FRONT TO CENTERLINE AND 19" MIN AFF. ALLOW AT LEAST 1 1/2" CLEAR BELOW GRAB BAR.
- PROVIDE FLUSH CONTROLS ON WIDE SIDE OF TOILET.
- 3. FLUSH CONTROLS SHALL NOT OBSTRUCT GRAB BARS WITHIN 1 1/2" BELOW OR 12" ABOVE.
- FLUSH CONTROLS SHALL NOT REQUIRE GRASPING, PINCHING OR TWISTING TO OPERATE AND SHALL NOT REQUIRE GREATER THAN 5# OF FORCE.
- 5. FLUSH CONTROLS SHALL BE OPERABLE WITH ONE HAND.
- 6. FAUCET CONTROLS SHALL NOT REQUIRE GRASPING, PINCHING OR TWISTING TO OPERATE AND SHALL NOT REQUIRE GREATER THAN 5# OF FORCE.
- 7. SELF CLOSING FAUCET VALVES SHALL REMAIN OPEN FOR A MIN OF 10
- SECONDS.
- 9. PROVIDE 5/8" U-SHAPED HANDLE ON INSIDE AND OUTSIDE OF TOILET
- COMPARTMENT DOOR NEAR THE LATCH.

D3 \ RESTROOM CLEARANCES

 Γ -3 / scale: 1" = 1'-0"

10. COMPARTMENTS SHALL BE ARRANGED FOR LEFT-HAND OR RIGHT-HAND APPROACH TO THE WATER CLOSET

12" MIN. 24" MIN. 36" MIN. 6" MAX -42" MIN. 60" MIN.

PROJECT:

SeaWorld San Diego

Restroom Remodel

500 Sea World Dr. San Diego, CA 92109



DESCRIPTION: DATE:

CONCEPT 02/07/23

- ENTRANCES AND DOORS ALL PRIMARY ENTRANCES AND EXTERIOR GROUND FLOOR EXIT DOORS TO BUILDINGS AND FACILITIES SHALL BE MADE ACCESSIBLE TO THE PHYSICALLY DISABLED.
- ALL ACCESSIBLE ENTRANCES SHALL BE IDENTIFIED WITH ONE STANDARD INTERNATIONAL SYMBOL OF ACCESSIBILITY SIGN AND WITH ADDITIONAL DIRECTIONAL SIGNS IDENTIFYING THE LOCATION OF NEAREST ACCESSIBLE ENTRANCE, AS REQUIRED, VISIBLE FROM APPROACHING PEDESTRIAN WAYS.
- EVERY REQUIRED ENTRANCE OR PASSAGE DOORWAY SHALL BE OF A SIZE AS TO PERMIT THE INSTALLATION OF A DOOR NOT LESS THAN 36 INCHES IN WIDTH, AND NOT LESS THAN 80" IN HEIGHT. DOORS SHALL BE CAPABLE OF OPENING AT LEAST 90 DEGREES AND SHALL BE MOUNTED SO THAT THE CLEAR WIDTH OF THE DOORWAY IS NOT LESS THAN 32".
- LATCHING AND LOCKING DOORS THAT ARE HAND ACTIVATED AND WHICH ARE IN A PATH OF TRAVEL, SHALL BE OPERABLE WITH A SINGLE EFFORT BY LEVER TYPE HARDWARE, PANIC BARS, PUSH-PULL ACTIVATING BARS, OR OTHER HARDWARE DESIGNED TO PROVIDE PASSAGE WITHOUT REQUIRING THE ABILITY TO GRASP, PINCH OR TWIST THE OPENING HARDWARE AND MUST BE OPERABLE WITH ONE HAND.
- THE OPERABLE PARTS OF LEVER HAND ACTIVATED DOOR OPENING HARDWARE SHALL BE MOUNTED BETWEEN 34" MINIMUM AND 44" MAXIMUM ABOVE THE FLOOR AND NOT REQUIRE MORE THAN 5 POUNDS OF FORCE TO OPERATE.
- THE FLOOR OR LANDING LENGTH ON EACH SIDE OF AN ENTRANCE OR A PASSAGE DOOR SHALL BE LEVEL AND CLEAR AT LEAST 60" IN THE DIRECTION OF THE DOOR SWING AND AT LEAST 48" OPPOSITE THE DIRECTION OF THE DOOR SWING AS MEASURED AT RIGHT ANGLES TO THE FACE OF THE DOOR IN THE CLOSED POSITION. THE WIDTH OF THE LEVEL AND CLEAR AREA ON THE SIDE WHICH THE DOOR SWINGS SHALL EXTEND A MINIMUM OF 24" PAST THE STRIKE EDGE OF THE DOOR FOR DOORS WITH LATCH SIDE APPROACH AND 36" FOR DOORS REQUIRING HINGE SIDE APPROACH. REFER TO DETAIL B3 ON THIS DRAWING FOR ADDITIONAL CLEARANCE REQUIREMENTS.
- THE FLOOR OR LANDING SHALL NOT BE MORE THAN 1/2" LOWER THAN THE THRESHOLD OF THE DOORWAY. CHANGES IN LEVEL BETWEEN 1/4" AND 1/2" SHALL BE BEVELED WITH A SLOPE NO GREATER THAN 1:2.

SANITARY FACILITIES (GENERAL)

- 1. ALL DOORWAYS LEADING TO SANITARY FACILITIES SHALL HAVE 32" CLEAR, UNOBSTRUCTED
- 2. ALL SINKS, FAUCET CONTROLS, AND OPERATING MECHANISMS SHALL BE OPERABLE WITH ONE HAND AND SHALL NOT REQUIRE TIGHT GRASPING, PINCHING, OR TWISTING OF THE WRIST. THE FORCE REQUIRED TO ACTIVATE CONTROLS SHALL BE NO GREATER THAN 5 LBS. LEVER-OPERATED, PUSH TYPE, AND ELECTRONICALLY CONTROLLED MECHANISMS ARE EXAMPLES OF ACCEPTABLE DESIGNS. SELF-CLOSING VALVES ARE ALLOWED IF THE FAUCET REMAINS OPEN FOR AT LEAST 10 SECONDS.
- 3. LAVATORIES SHALL BE MOUNTED WITH A MINIMUM DISTANCE OF 18" FROM A WALL OR WITH THE RIM AND/OR COUNTER SURFACE NO HIGHER THAN 34" ABOVE THE FLOOR.

PARTITION TO THE CENTER OF THE FIXTURE. ACCESSIBLE LAVATORIES SHALL BE MOUNTED

TO SWING OVER 4" MAX. AT TOILET HATCHED COMPARTMENT 18" MIN PORTION OF WITHIN A MULTI-FOR 60" MANEUVERING ACCOMMODATION DEEP SPACE **FACILITY** = = = = = =CLR. OPENING ALTERNATE DOOR LOCATION, FOR SIDE OPENING DOOR, SEE/C3 CENTERLINE OF ROLL PAPER HOLDER WITHOUT STOPS CONTROLS FOR WATER CLOSETS SHALL BE ON THE OPEN SIDE WALL, LAVATORY, OR TOILET PARTITION (WHERE OCCURS) 18" MAX 8. RESTROOM ACCESSORIES - HIGHEST OPERABLE PART SHALL BE 40" MAX. AFF.


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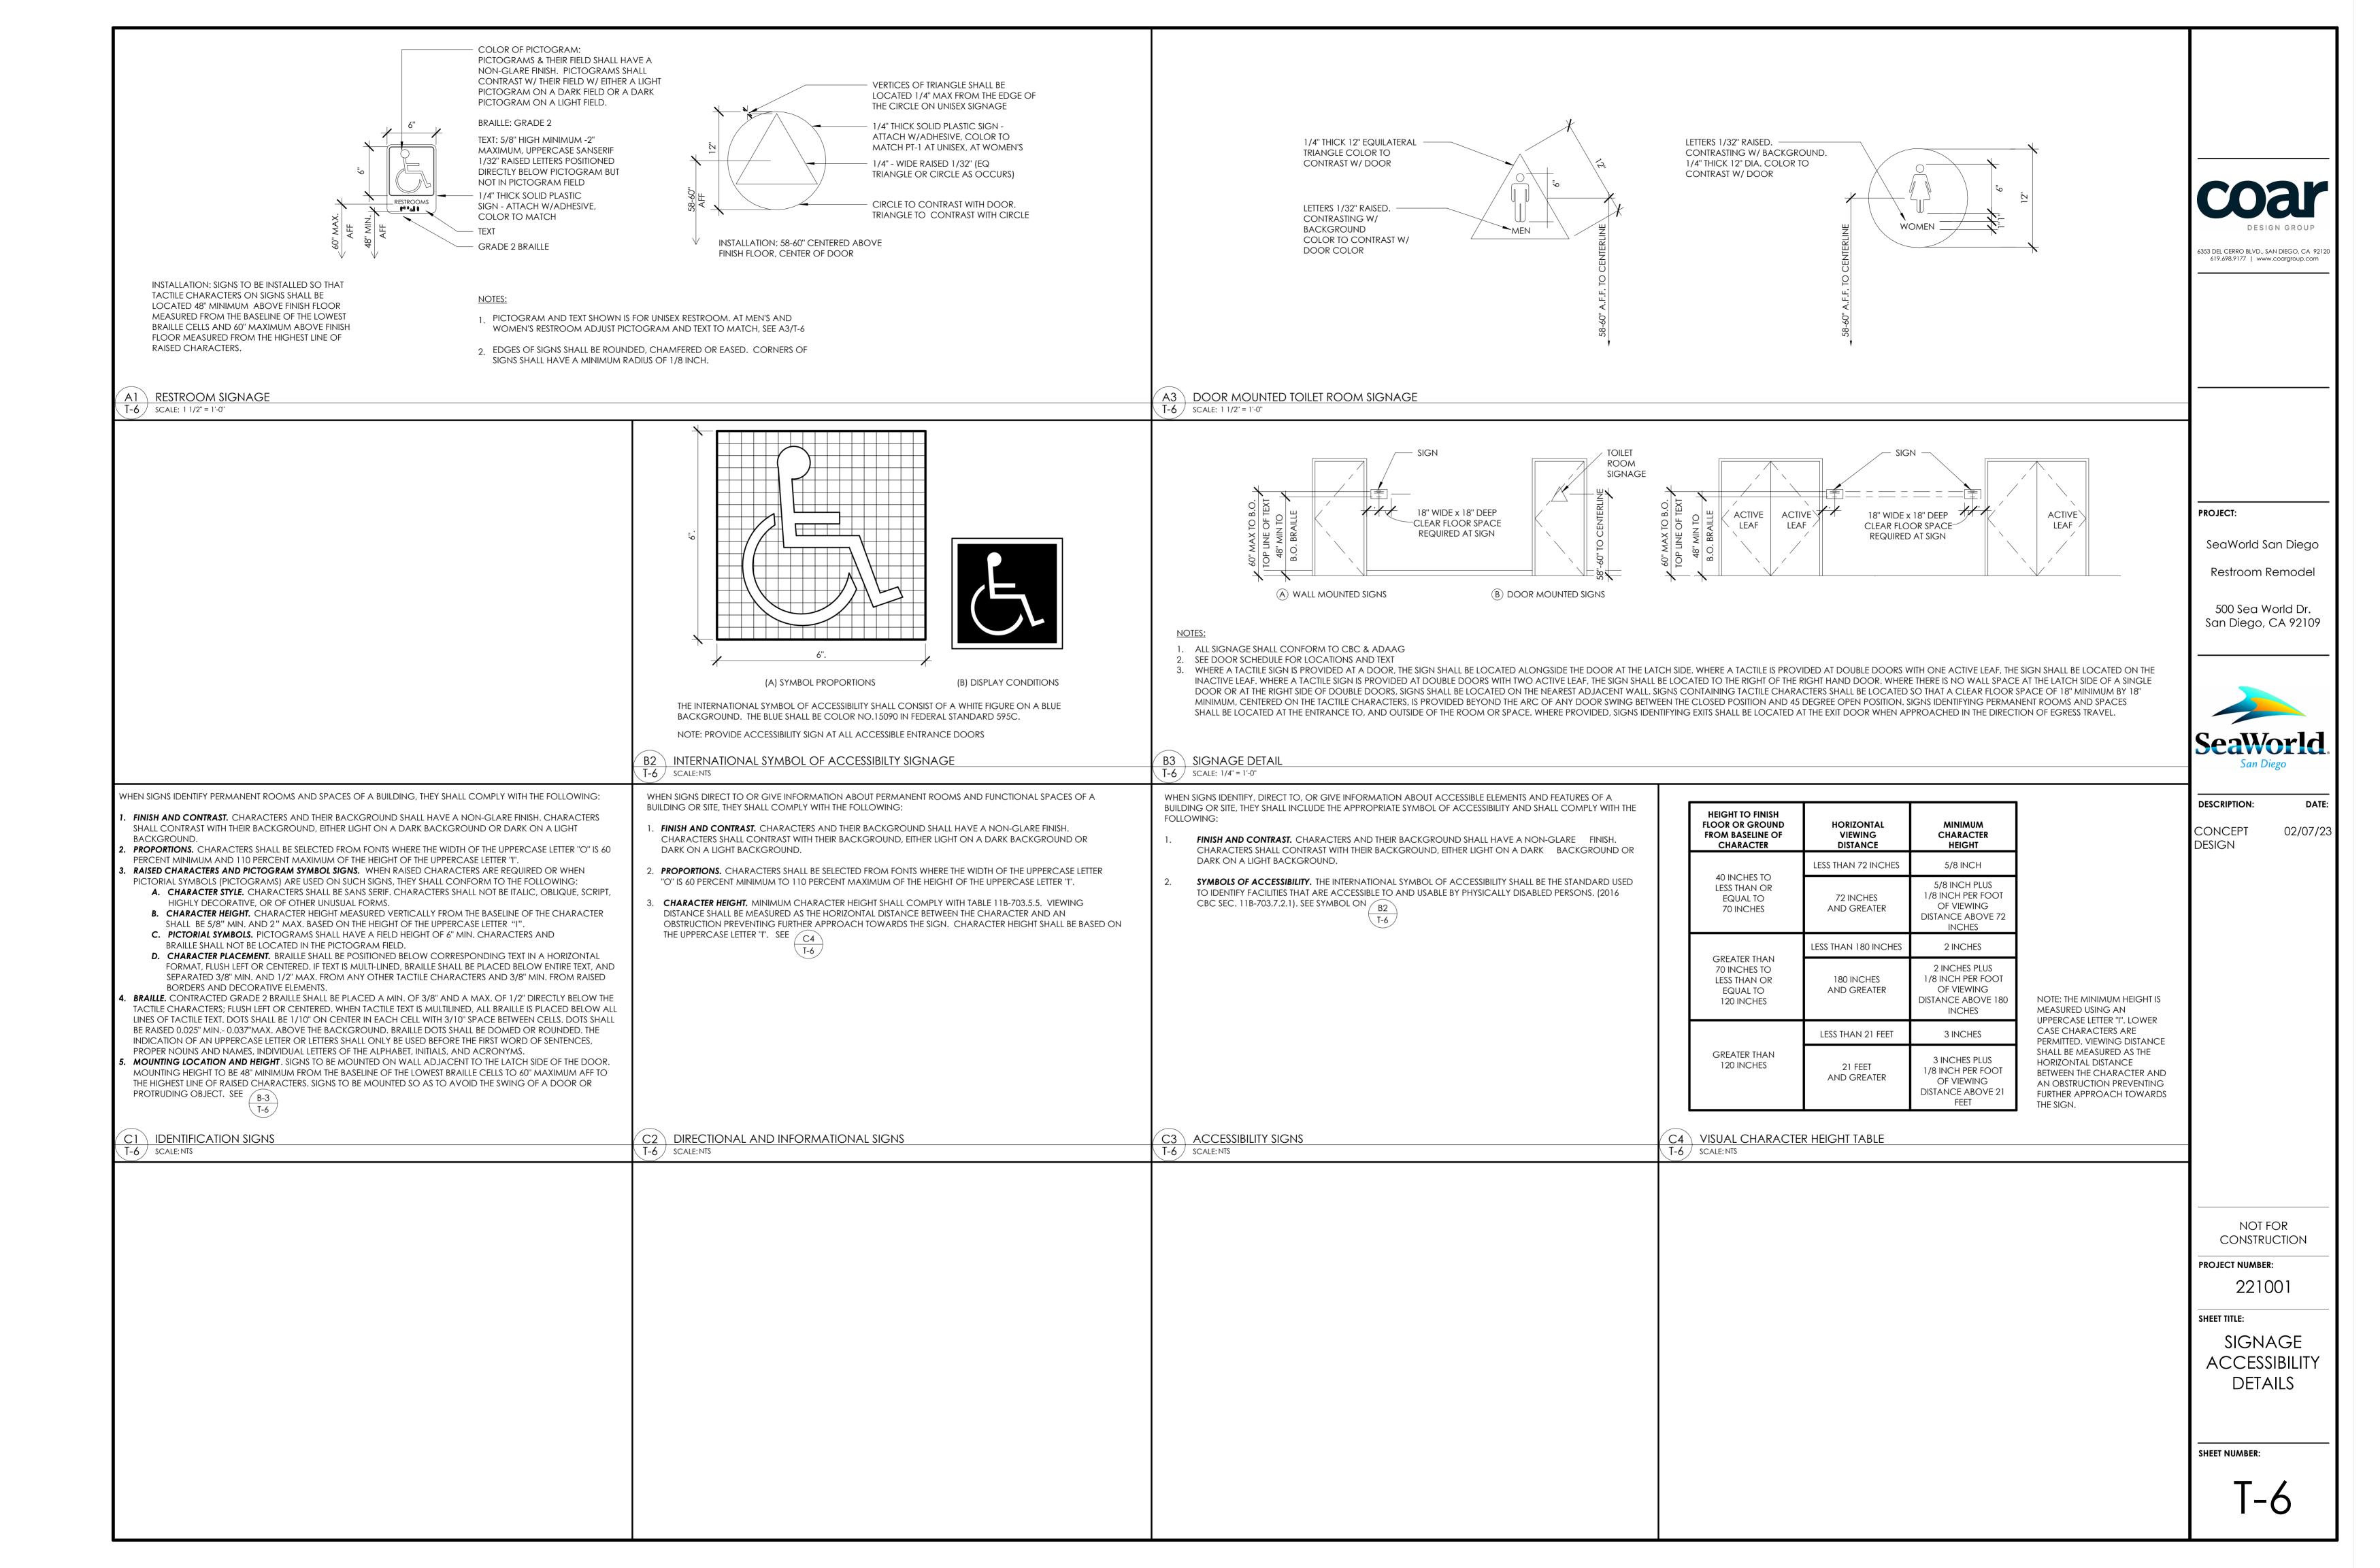
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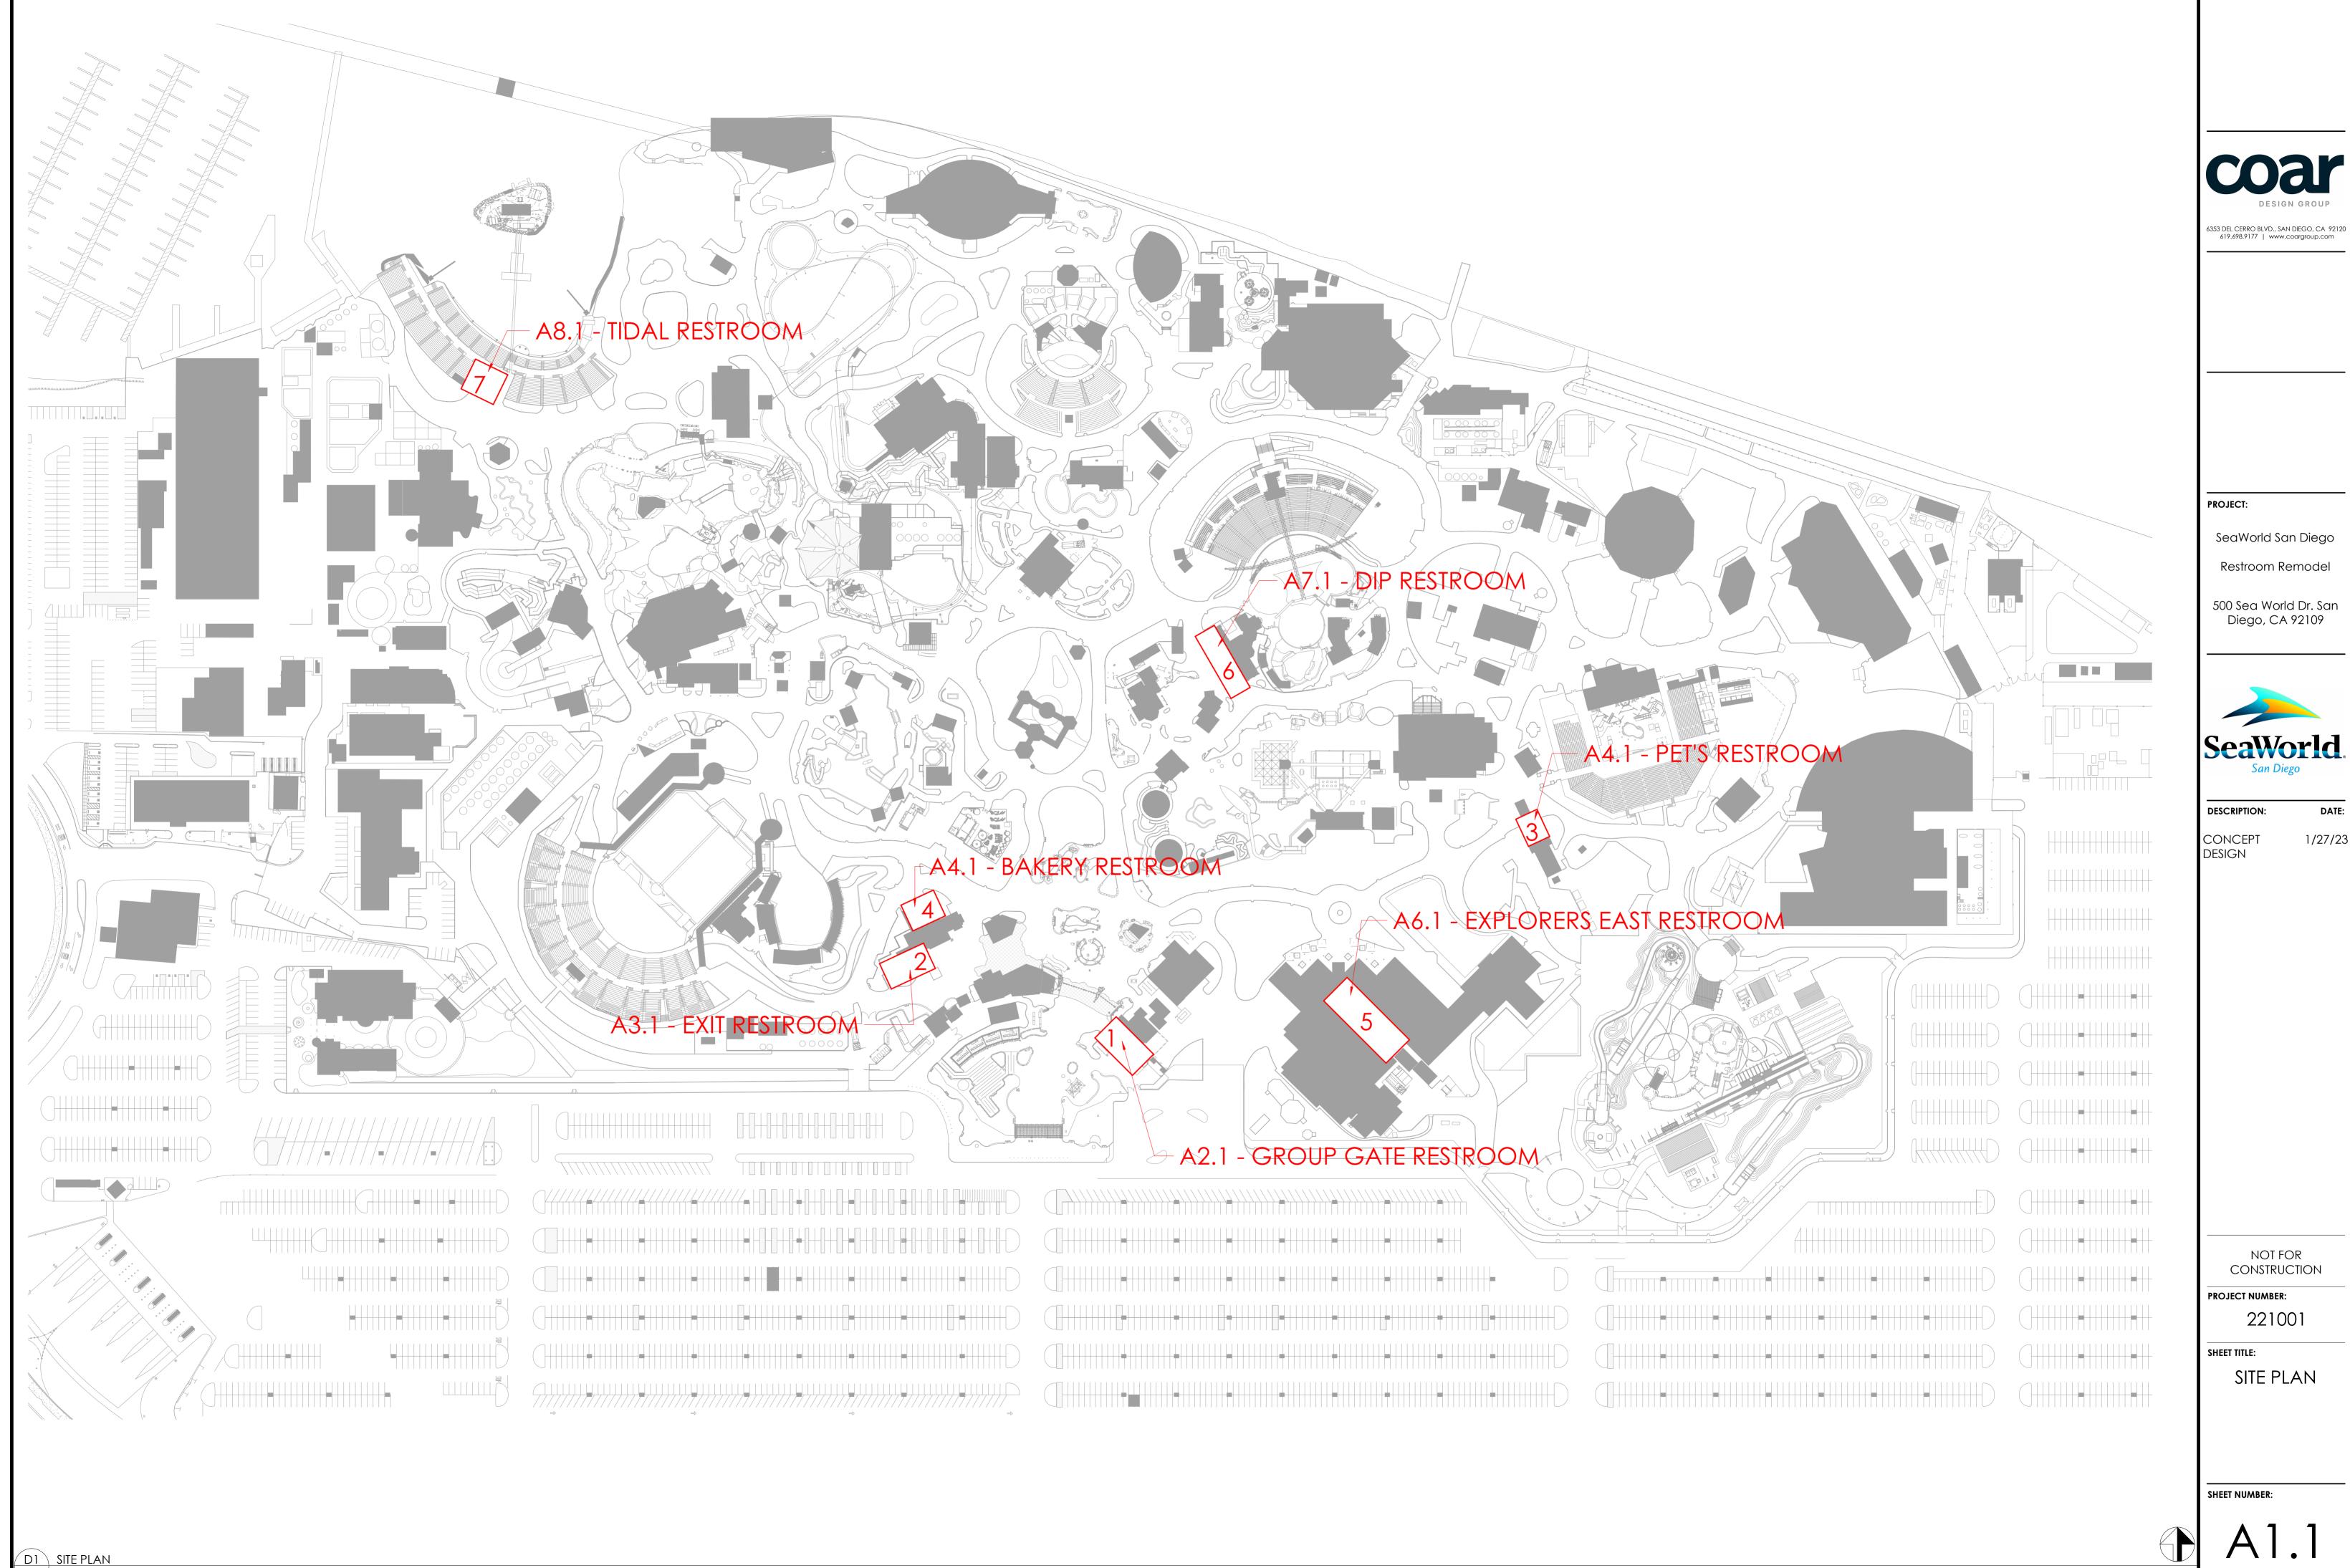
ACCESSIBILITY DETAILS

SHEET NUMBER:


DISABLED ACCESS REQUIREMENTS SCALE: 1/8" = 1'-0"





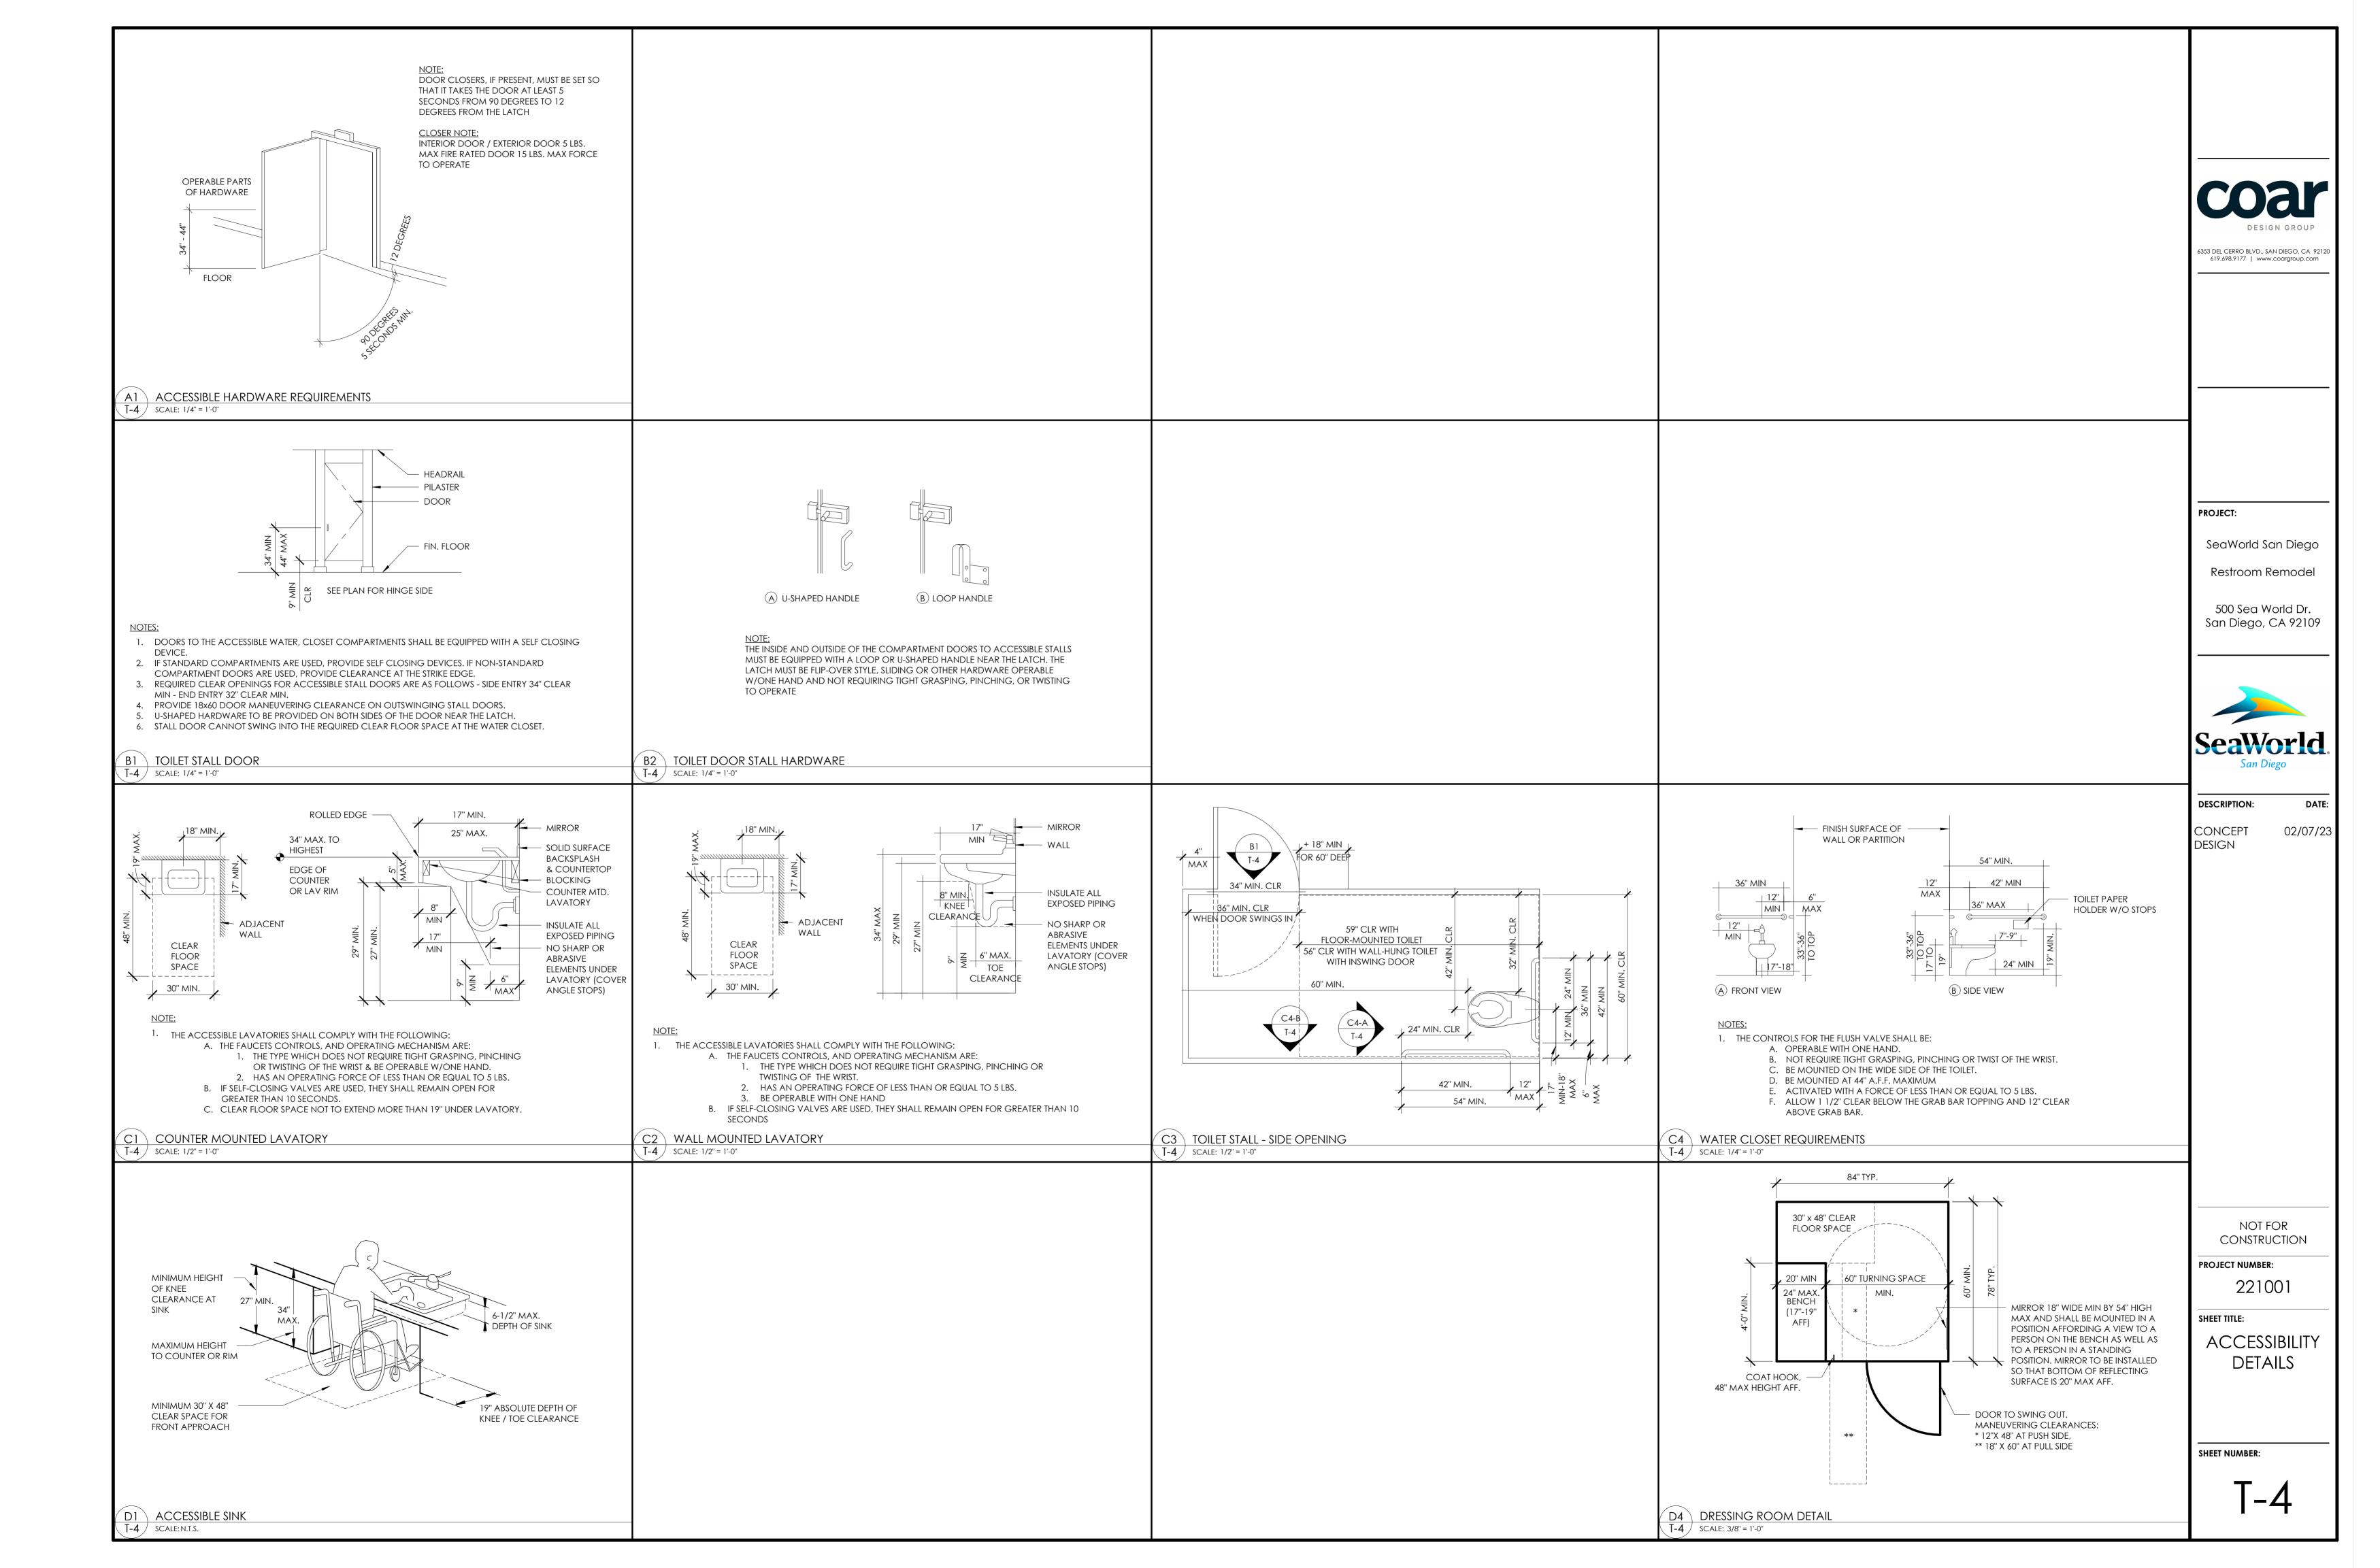

A1.1 SCALE: 1" = 100'-0"

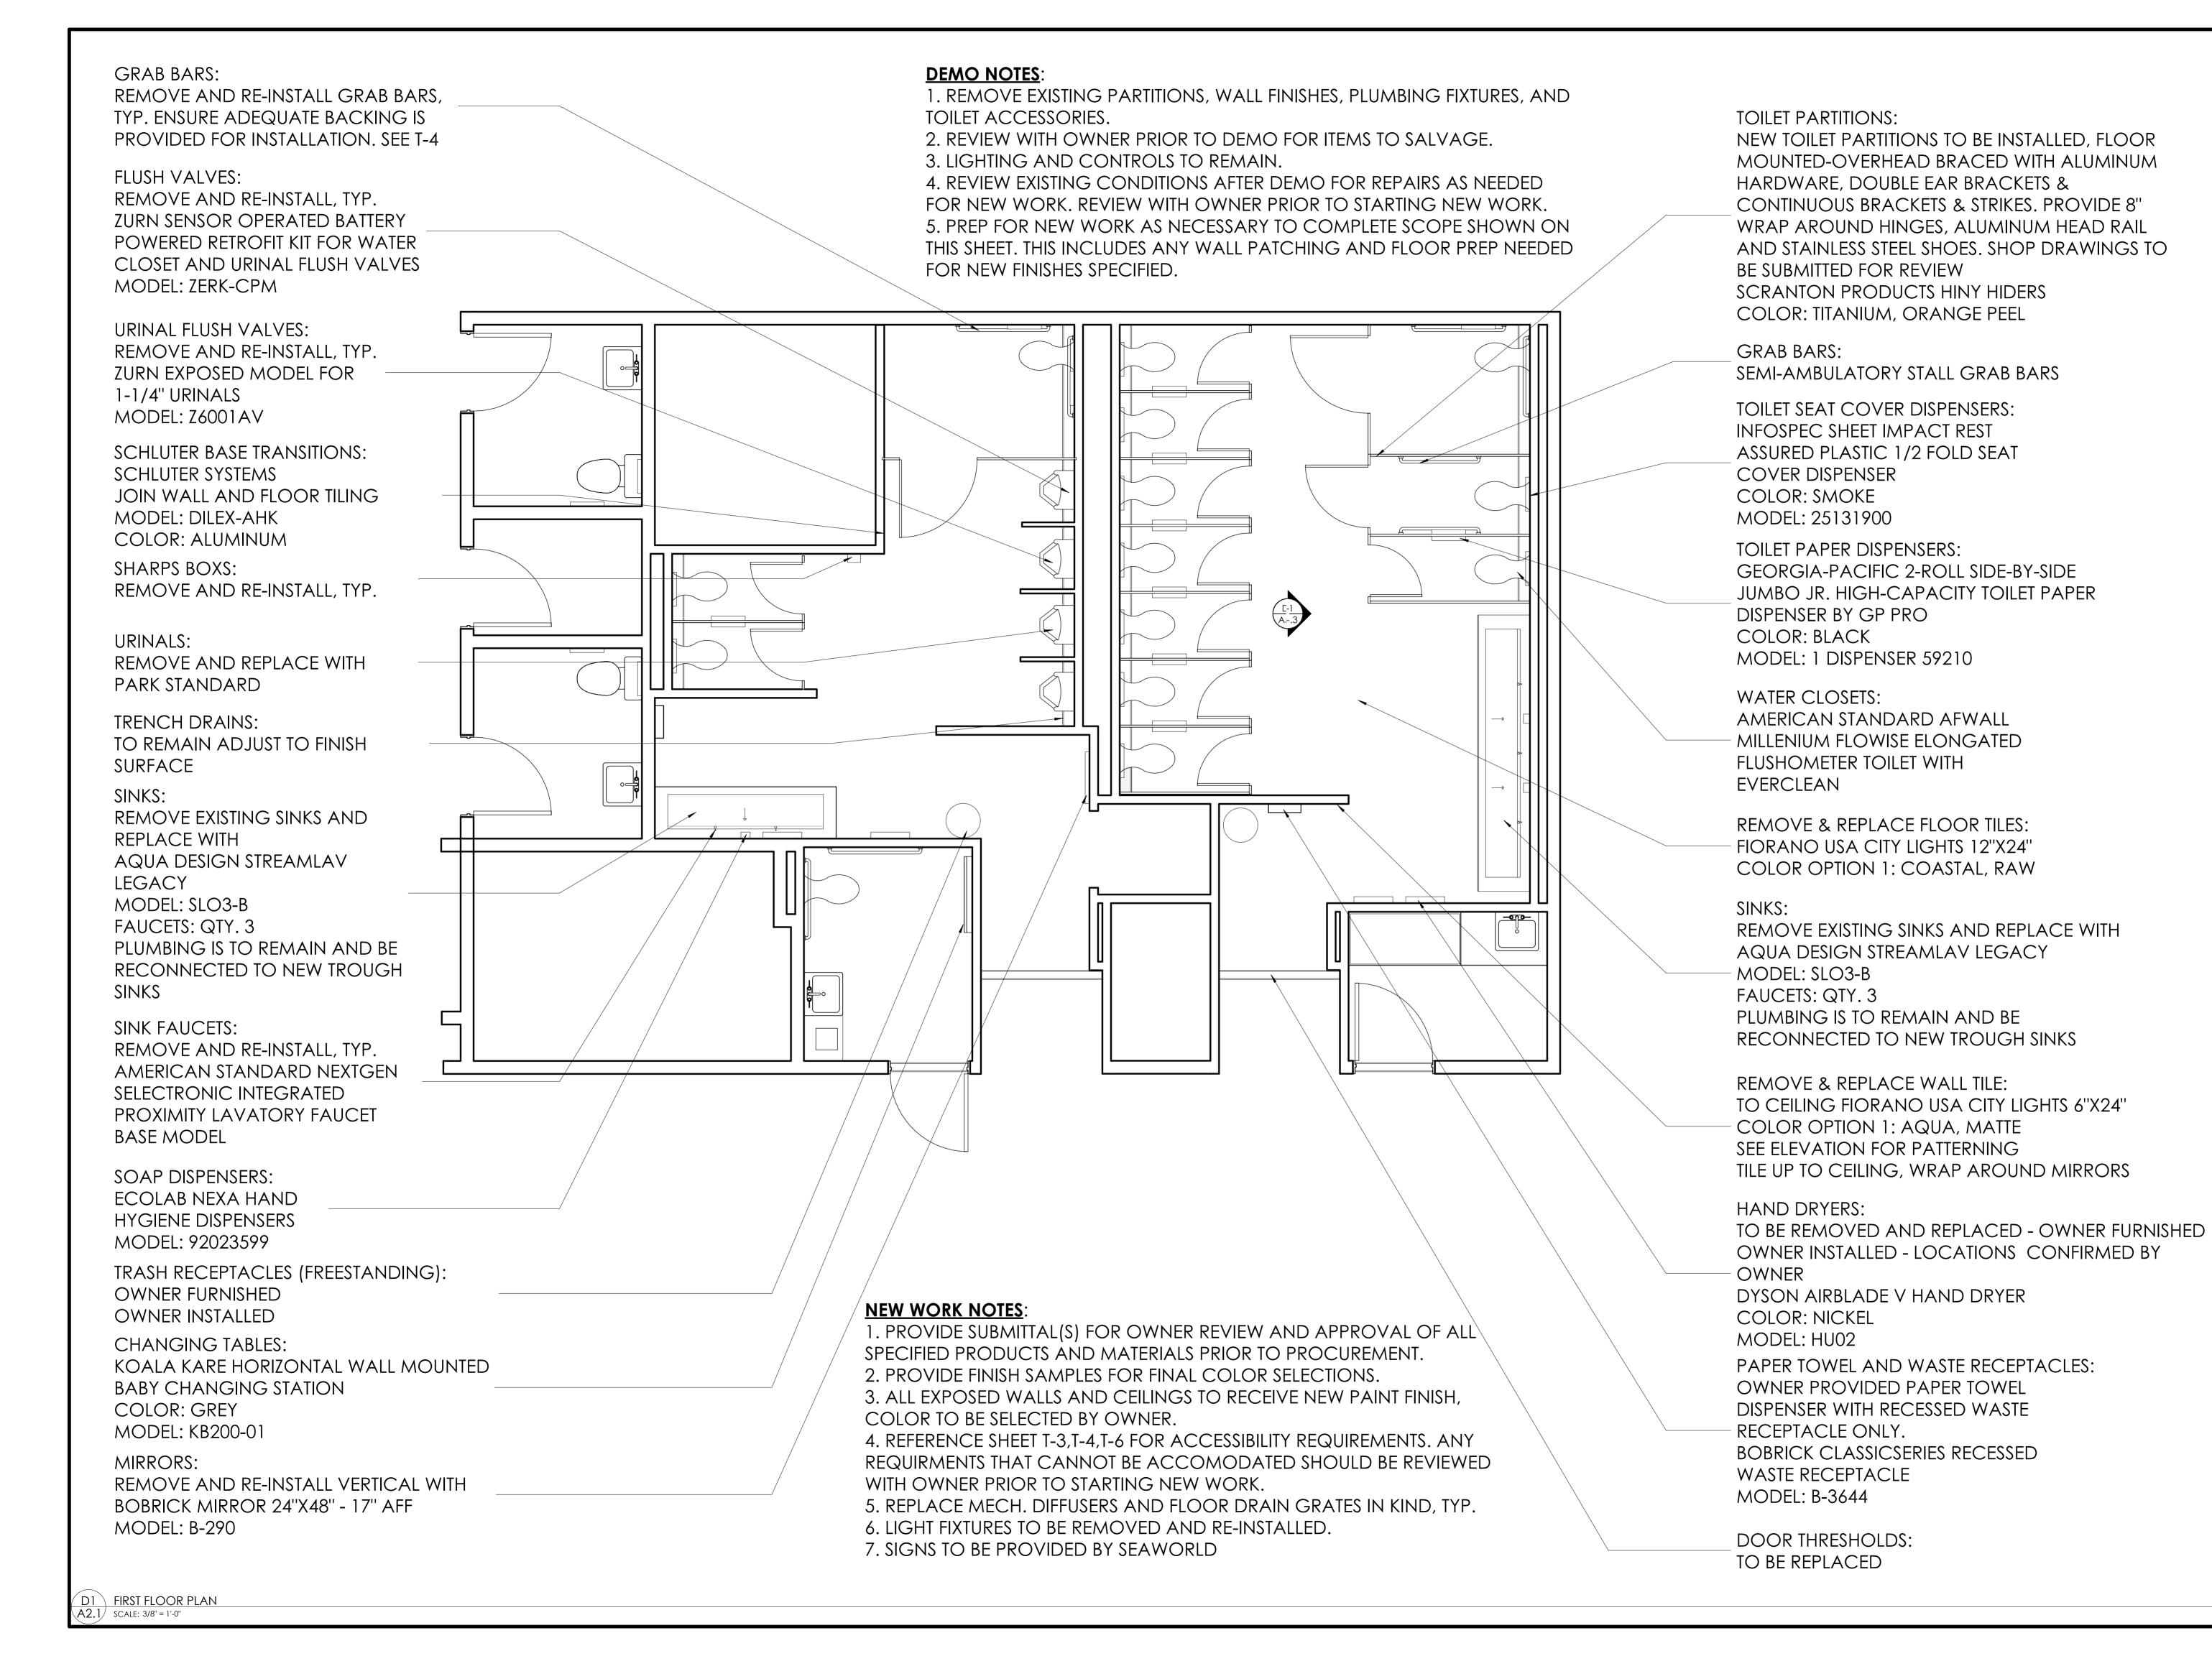

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PROJECT:

SeaWorld San Diego

Group Gate Restroom Remodel

500 Sea World Dr. San Diego, CA 92109



DESCRIPTION:

CONCEPT


02/07/23


NOT FOR CONSTRUCTION

PROJECT NUMBER: 221001

SHEET TITLE:

GROUP GATE RESTROOM SCOPE OF WORK

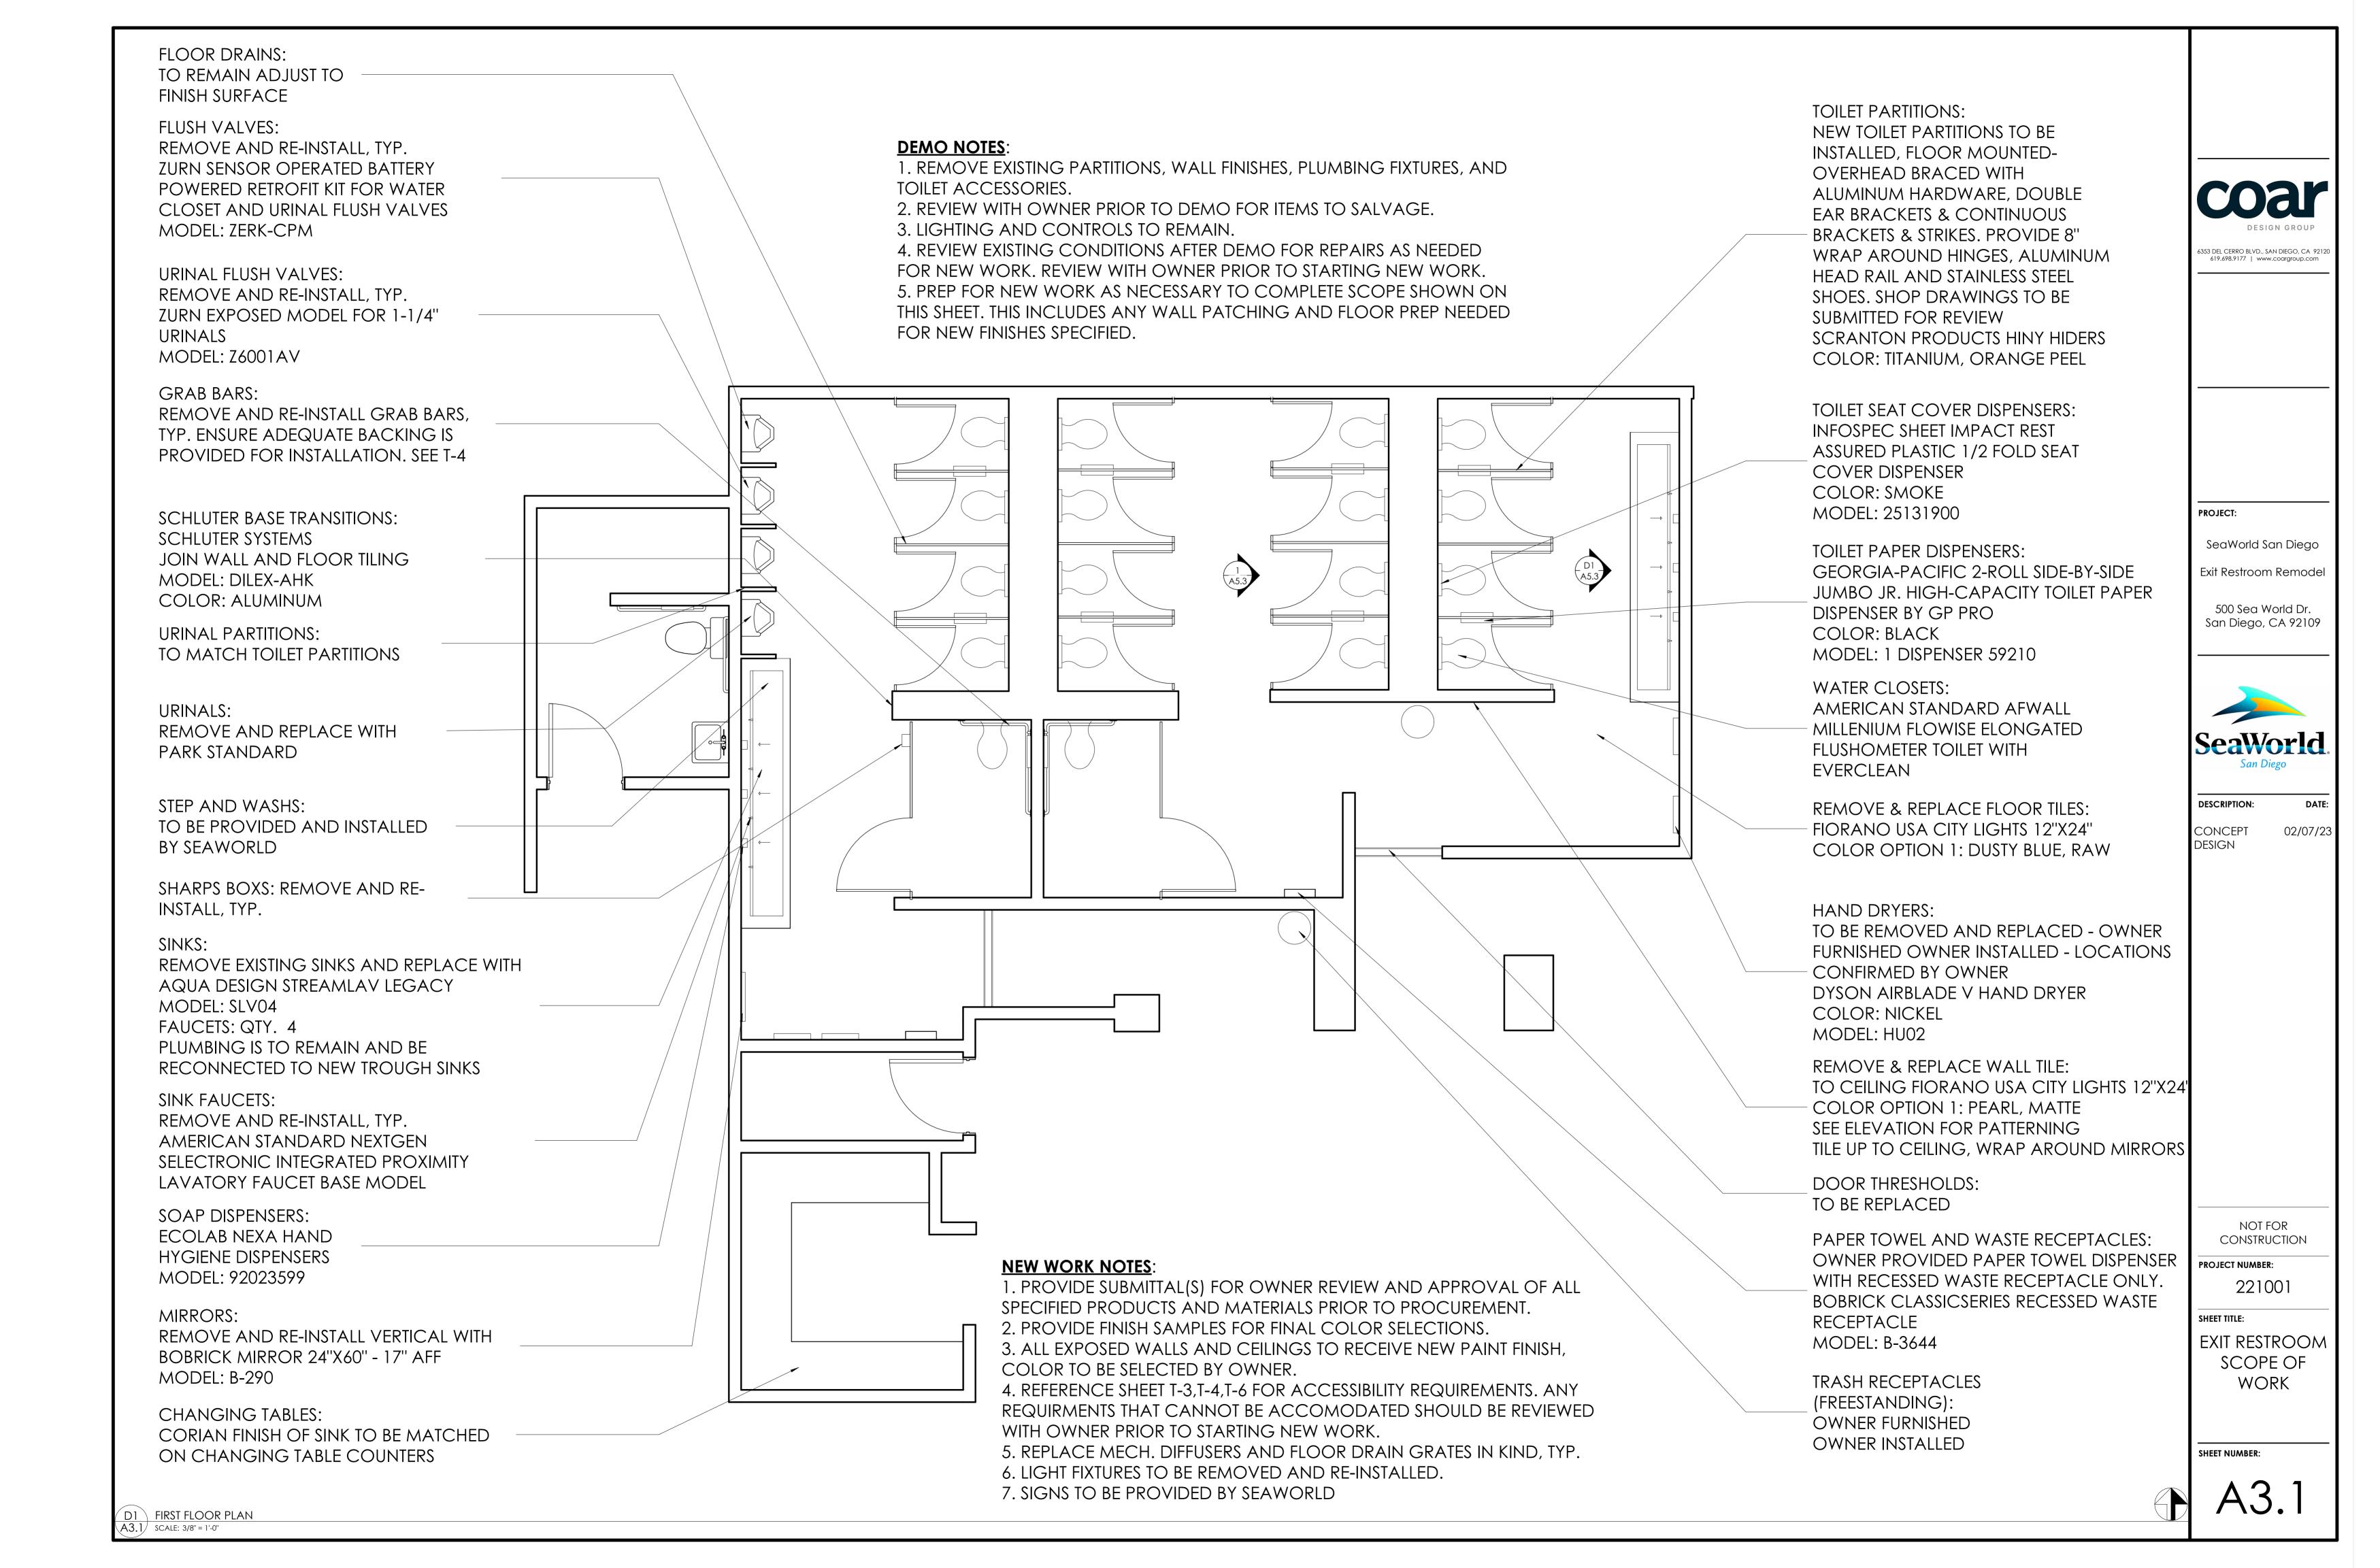

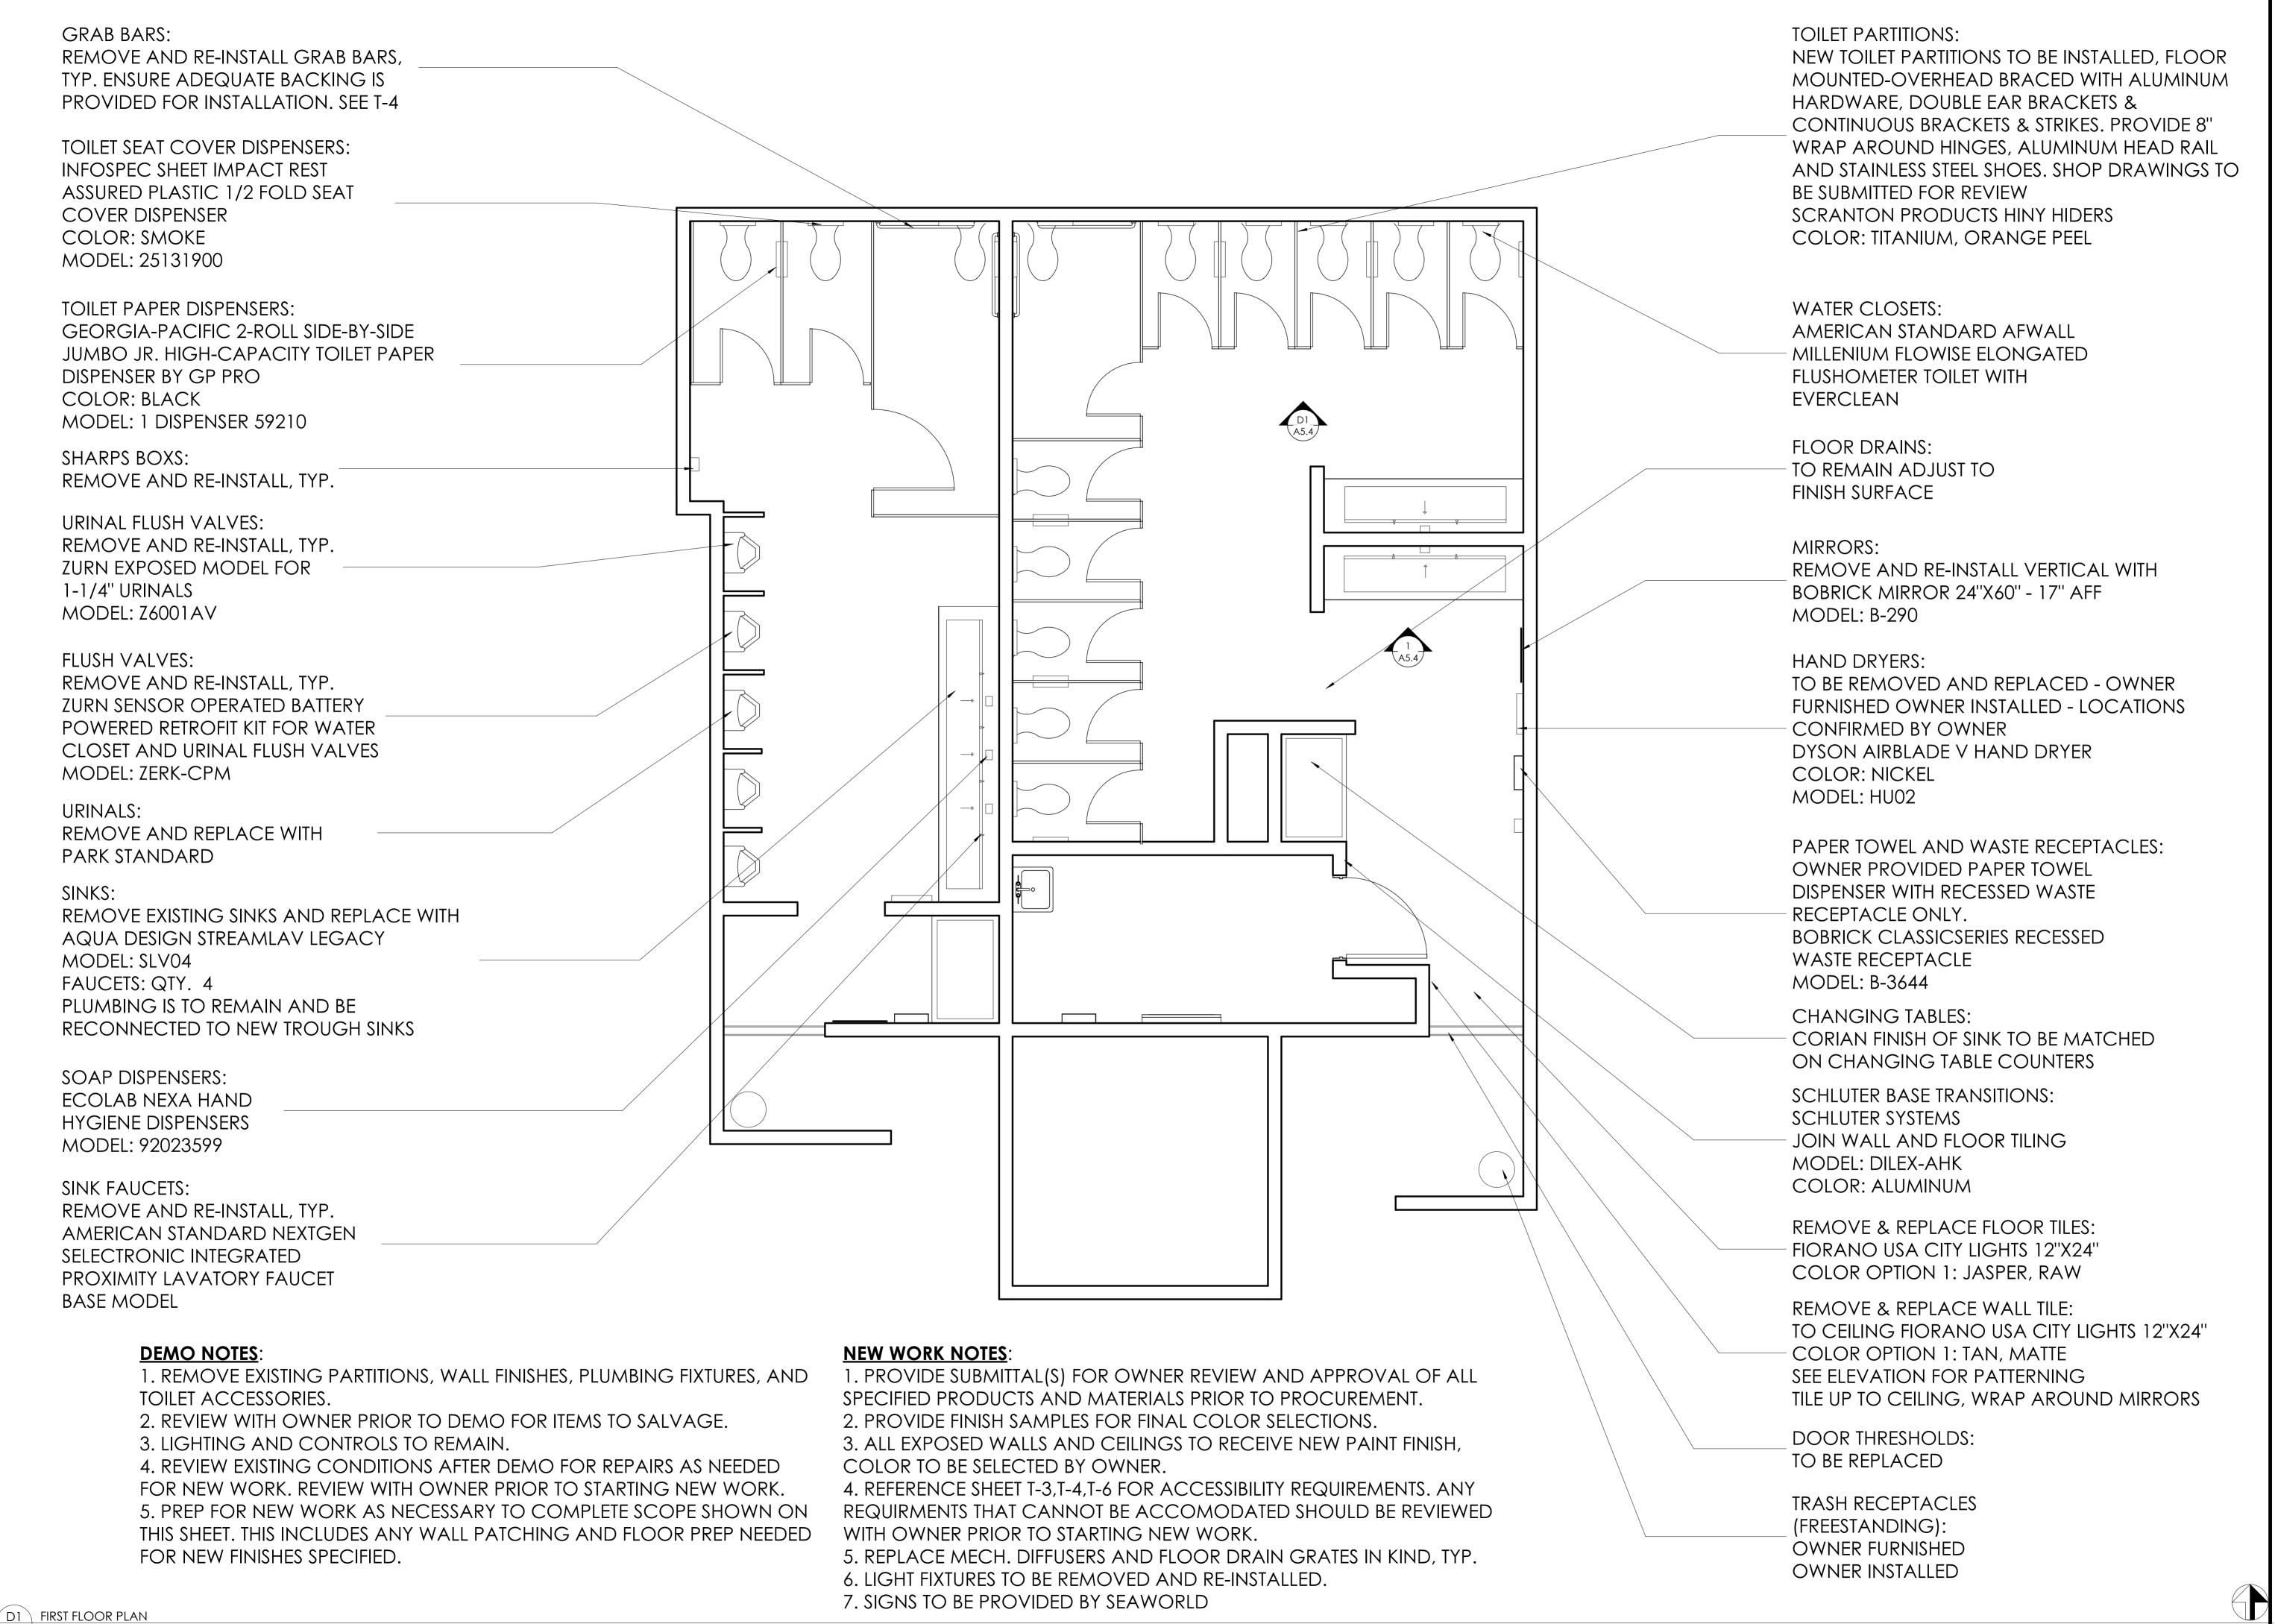

A4.1 SCALE: 3/8'' = 1'-0''

COAL DESIGN GROUP

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PROJECT:

SeaWorld

Pets Restroom Remode

500 Sea World Dr. San Diego, CA 92109



DESCRIPTION:

ONCEDT

CONCEPT

02/07/23

NOT FOR CONSTRUCTION

PROJECT NUMBER: 221001

ET TITLE:

SHEET TITLE:
PETS

RESTROOM SCOPE OF WORK

SHEET NUMBER:

A4.1

TOILET SEAT COVER DISPENSERS: INFOSPEC SHEET IMPACT REST ASSURED PLASTIC 1/2 FOLD SEAT COVER DISPENSER COLOR: SMOKE MODEL: 25131900 **TOILET PAPER DISPENSERS:** GEORGIA-PACIFIC 2-ROLL SIDE-BY-SIDE JUMBO JR. HIGH-CAPACITY TOILET PAPER DISPENSER BY GP PRO COLOR: BLACK MODEL: 1 DISPENSER 59210 GRAB BARS: REMOVE AND RE-INSTALL GRAB BARS, TYP. ENSURE ADEQUATE BACKING IS PROVIDED FOR INSTALLATION. SEE T-4 URINAL FLUSH VALVES: REMOVE AND RE-INSTALL, TYP. ZURN EXPOSED MODEL FOR 1-1/4" URINALS MODEL: Z6001AV FLUSH VALVES: REMOVE AND RE-INSTALL, TYP. ZURN SENSOR OPERATED BATTERY POWERED RETROFIT KIT FOR WATER CLOSET AND URINAL FLUSH VALVES MODEL: ZERK-CPM FLOOR DRAINS: TO REMAIN ADJUST TO FINISH SURFACE URINALS: REMOVE AND REPLACE WITH PARK STANDARD HAND DRYERS: TO BE REMOVED AND REPLACED - OWNER FURNISHED OWNER INSTALLED - LOCATIONS CONFIRMED BY OWNER DYSON AIRBLADE V HAND DRYER COLOR: NICKEL MODEL: HU02 PAPER TOWEL AND WASTE RECEPTACLES: OWNER PROVIDED PAPER TOWEL DISPENSER WITH RECESSED WASTE RECEPTACLE ONLY. BOBRICK CLASSICSERIES RECESSED WASTE RECEPTACLE MODEL: B-3644 TRASH RECEPTACLES (FREESTANDING): OWNER FURNISHED OWNER INSTALLED DOOR THRESHOLDS: TO BE REPLACED

DEMO NOTES:

1. REMOVE EXISTING PARTITIONS, WALL FINISHES, PLUMBING FIXTURES, AND TOILET ACCESSORIES.

2. REVIEW WITH OWNER PRIOR TO DEMO FOR ITEMS TO SALVAGE.

3. LIGHTING AND CONTROLS TO REMAIN.

4. REVIEW EXISTING CONDITIONS AFTER DEMO FOR REPAIRS AS NEEDED FOR NEW WORK. REVIEW WITH OWNER PRIOR TO STARTING NEW WORK.

5. PREP FOR NEW WORK AS NECESSARY TO COMPLETE SCOPE SHOWN ON THIS SHEET. THIS INCLUDES ANY WALL PATCHING AND FLOOR PREP NEEDED FOR NEW FINISHES SPECIFIED.

SINKS:

REMOVE EXISTING SINKS AND REPLACE WITH

AQUA DESIGN STREAMLAV LEGACY

MODEL: SLV04

FAUCETS: QTY. 3

PLUMBING IS TO REMAIN AND BE

RECONNECTED TO NEW TROUGH SINKS

SOAP DISPENSERS: ECOLAB NEXA HAND HYGIENE DISPENSERS MODEL: 92023599

SINK FAUCETS:

REMOVE AND RE-INSTALL, TYP.

AMERICAN STANDARD NEXTGEN

SELECTRONIC INTEGRATED

PROXIMITY LAVATORY FAUCET

BASE MODEL

TOILET PARTITIONS:
NEW TOILET PARTITIONS TO BE INSTALLED, FLOOR
MOUNTED-OVERHEAD BRACED WITH ALUMINUM
HARDWARE, DOUBLE EAR BRACKETS &
CONTINUOUS BRACKETS & STRIKES. PROVIDE 8"
WRAP AROUND HINGES, ALUMINUM HEAD RAIL
AND STAINLESS STEEL SHOES. SHOP DRAWINGS TO
BE SUBMITTED FOR REVIEW
SCRANTON PRODUCTS HINY HIDERS
COLOR: TITANIUM, ORANGE PEEL

WATER CLOSETS:
AMERICAN STANDARD AFWALL
MILLENIUM FLOWISE ELONGATED
FLUSHOMETER TOILET WITH
EVERCLEAN

SCHLUTER BASE TRANSITIONS:
SCHLUTER SYSTEMS
JOIN WALL AND FLOOR TILING
MODEL: DILEX-AHK
COLOR: ALUMINUM

REMOVE & REPLACE FLOOR TILES:
FIORANO USA CITY LIGHTS 12"X24"
COLOR OPTION 1: COASTAL, RAW

REMOVE & REPLACE WALL TILE:
TO CEILING FIORANO USA CITY LIGHTS 12"X24"
COLOR OPTION 1: PEARL, MATTE
SEE ELEVATION FOR PATTERNING
TILE UP TO CEILING, WRAP AROUND MIRRORS

CHANGING TABLES:

CORIAN FINISH OF SINK TO BE MATCHED
ON CHANGING TABLE COUNTERS

PROJECT:

SeaWorld San Diego

Bakery Restroom Remodel

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500 Sea World Dr. San Diego, CA 92109



DESCRIPTION:

NICEDT

CONCEPT DESIGN

PT 1/30/23

NEW WORK NOTES:

1. PROVIDE SUBMITTAL(S) FOR OWNER REVIEW AND APPROVAL OF ALL SPECIFIED PRODUCTS AND MATERIALS PRIOR TO PROCUREMENT.

2. PROVIDE FINISH SAMPLES FOR FINAL COLOR SELECTIONS.

3. ALL EXPOSED WALLS AND CEILINGS TO RECEIVE NEW PAINT FINISH, COLOR TO BE SELECTED BY OWNER.

4. REFERENCE SHEET T-3,T-4,T-6 FOR ACCESSIBILITY REQUIREMENTS. ANY REQUIRMENTS THAT CANNOT BE ACCOMODATED SHOULD BE REVIEWED WITH OWNER PRIOR TO STARTING NEW WORK.

5. REPLACE MECH. DIFFUSERS AND FLOOR DRAIN GRATES IN KIND, TYP.

6. LIGHT FIXTURES TO BE REMOVED AND RE-INSTALLED.

7. SIGNS TO BE PROVIDED BY SEAWORLD

NOT FOR CONSTRUCTION

PROJECT NUMBER: 221001


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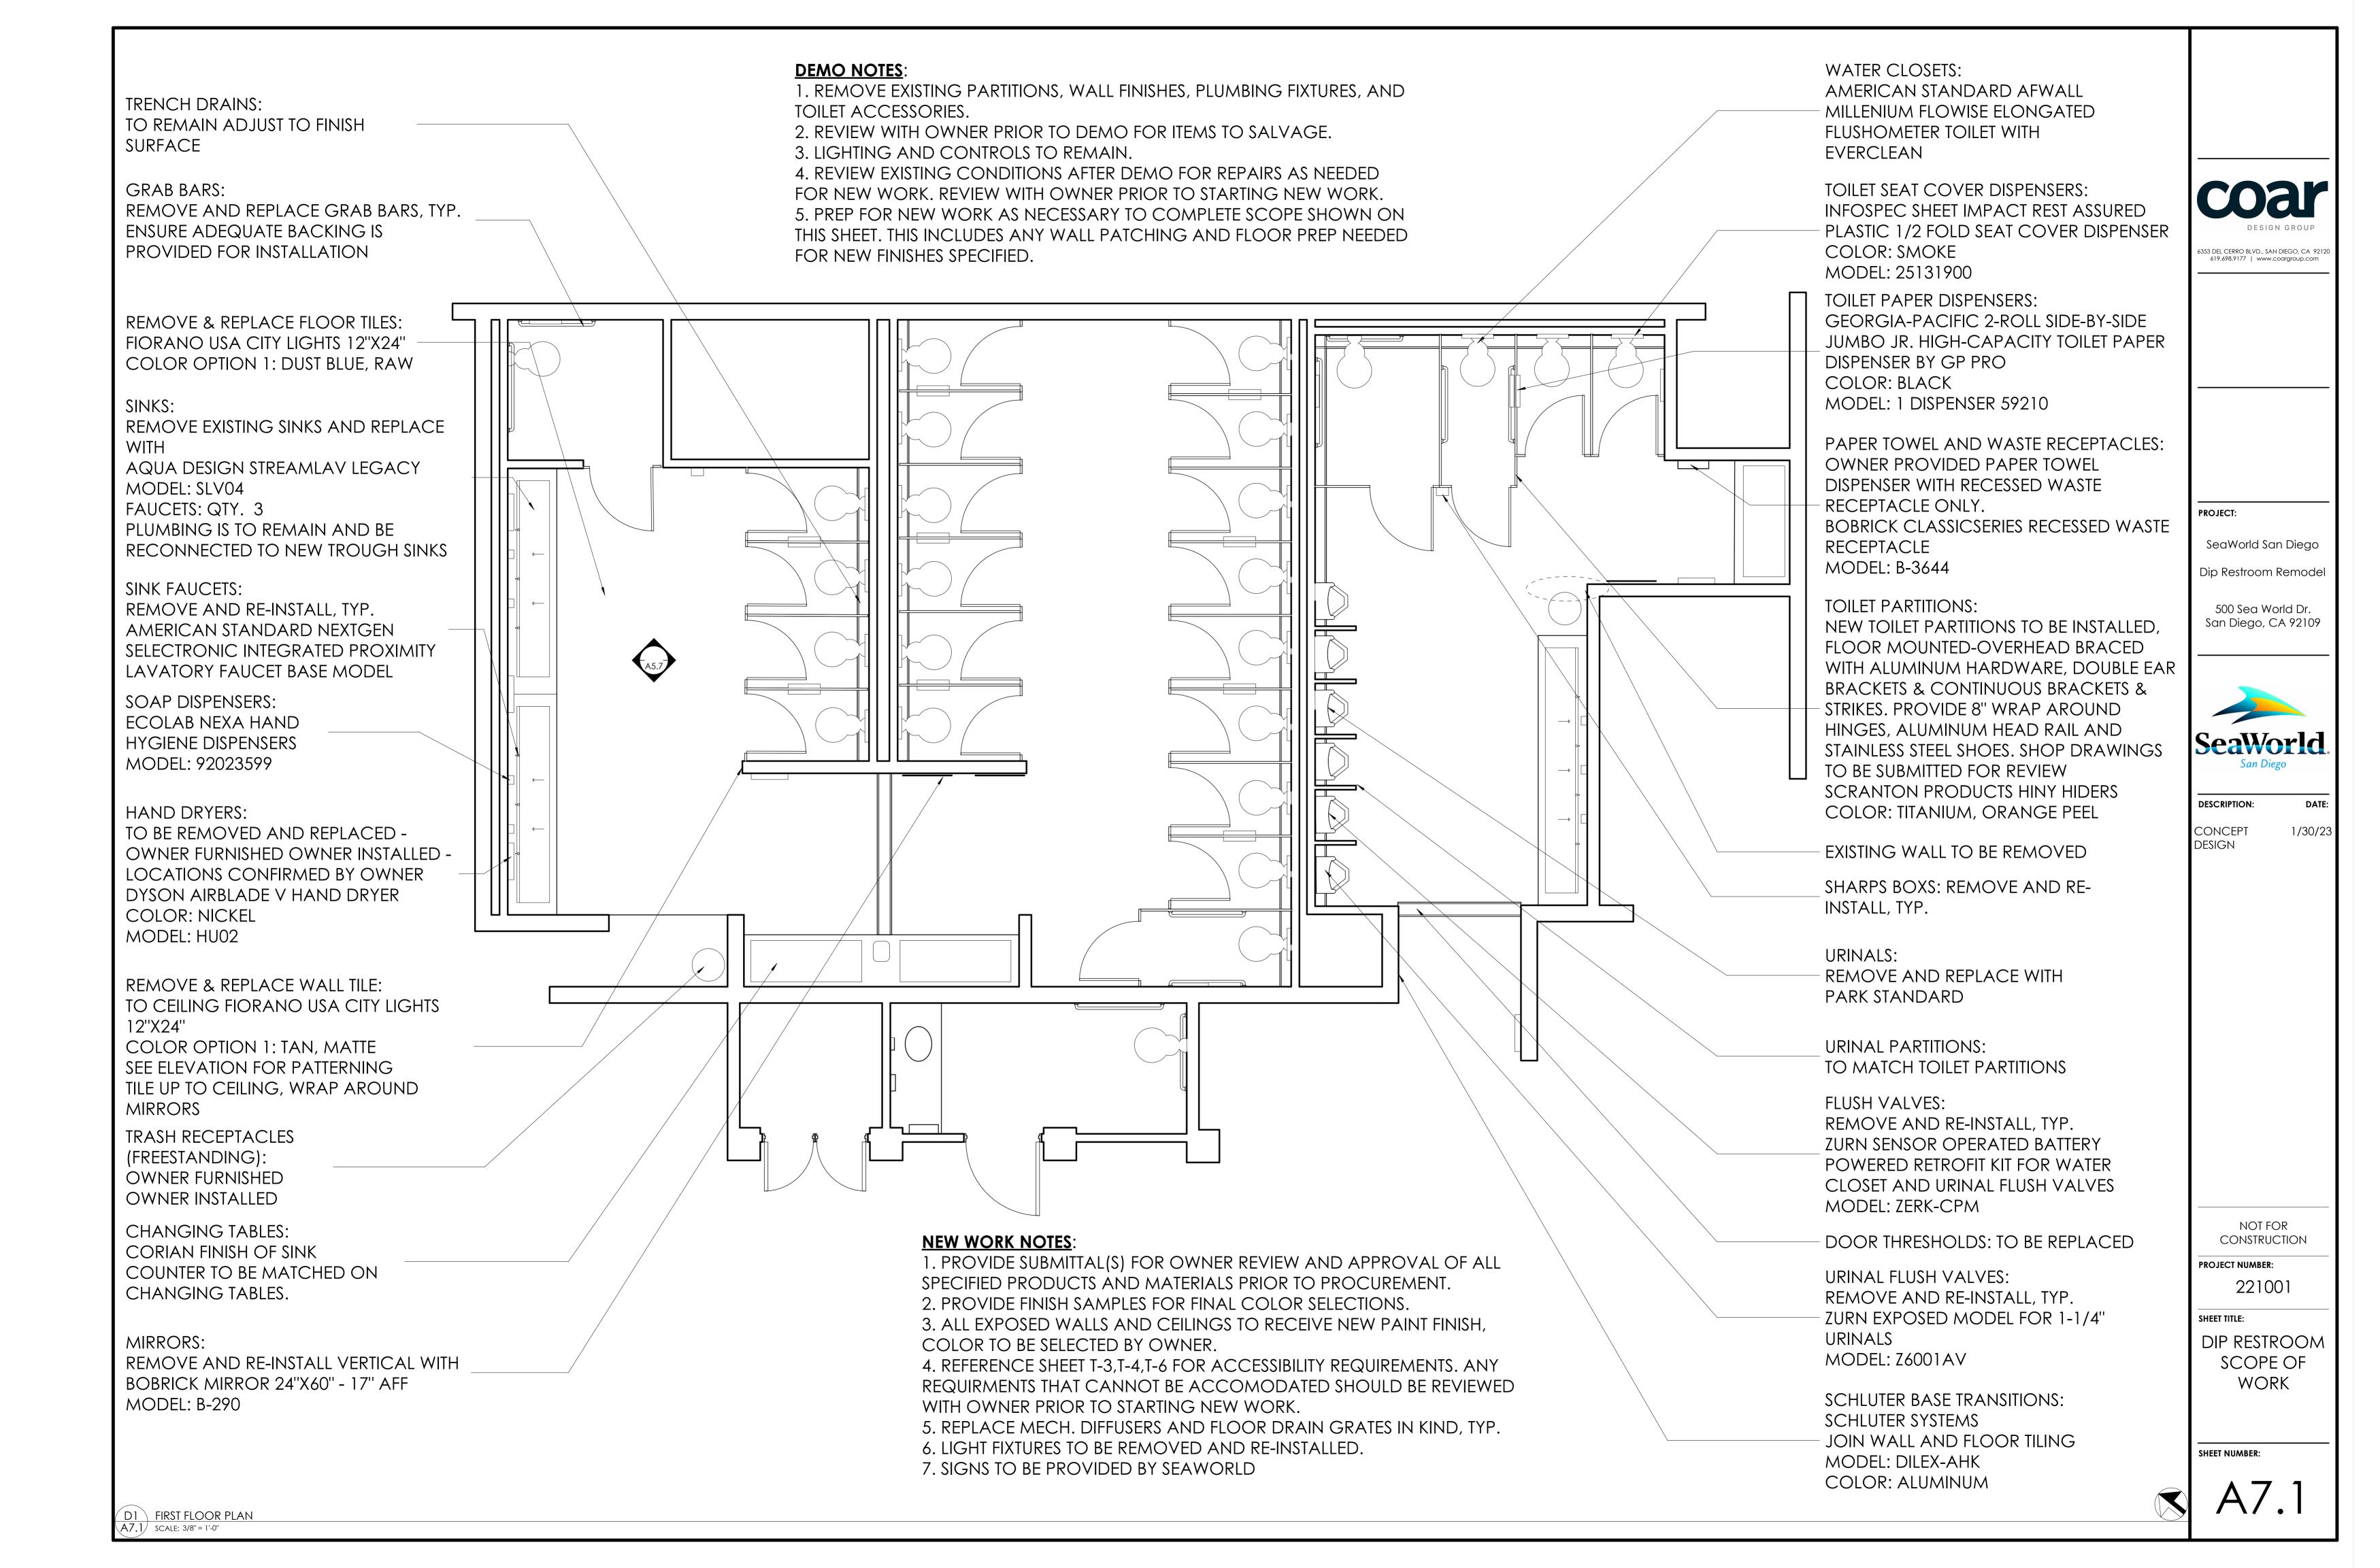
BAKERY RESTROOM SCOPE OF WORK


SHEET NUMBER:

A5.1

D1 FIRST FLOOR PLAN
A5.1 SCALE: 3/8" = 1'-0"



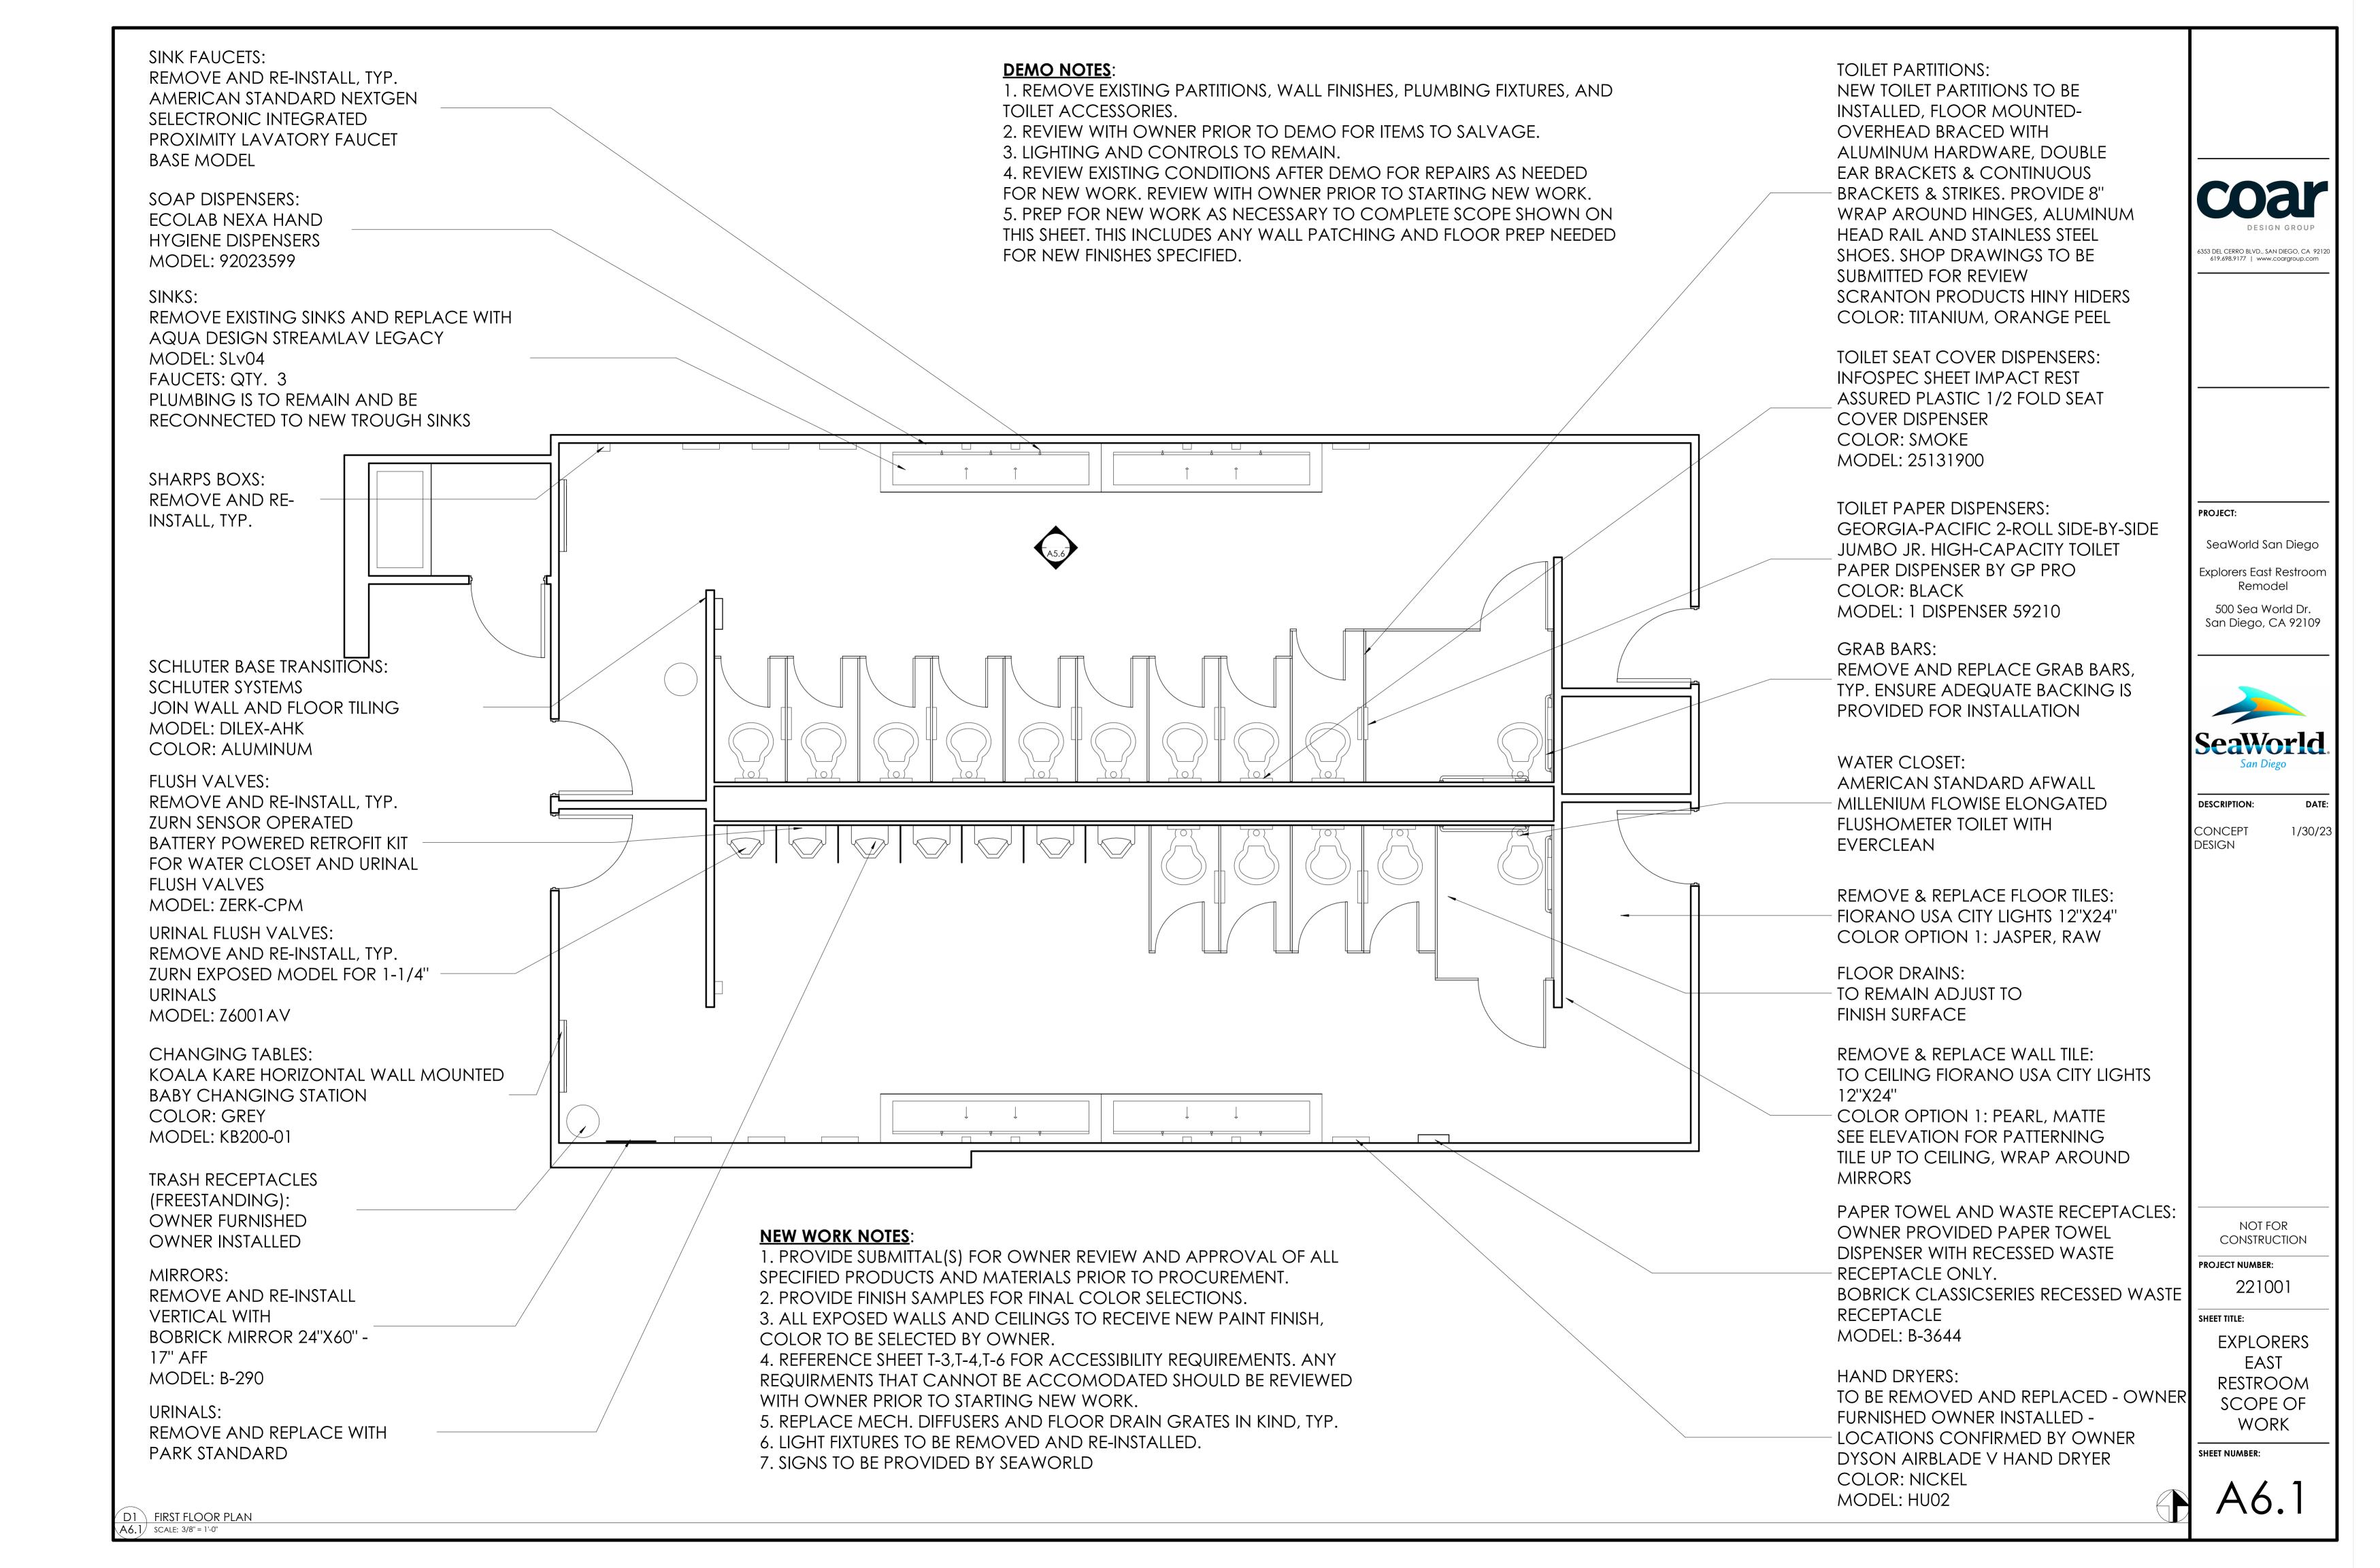

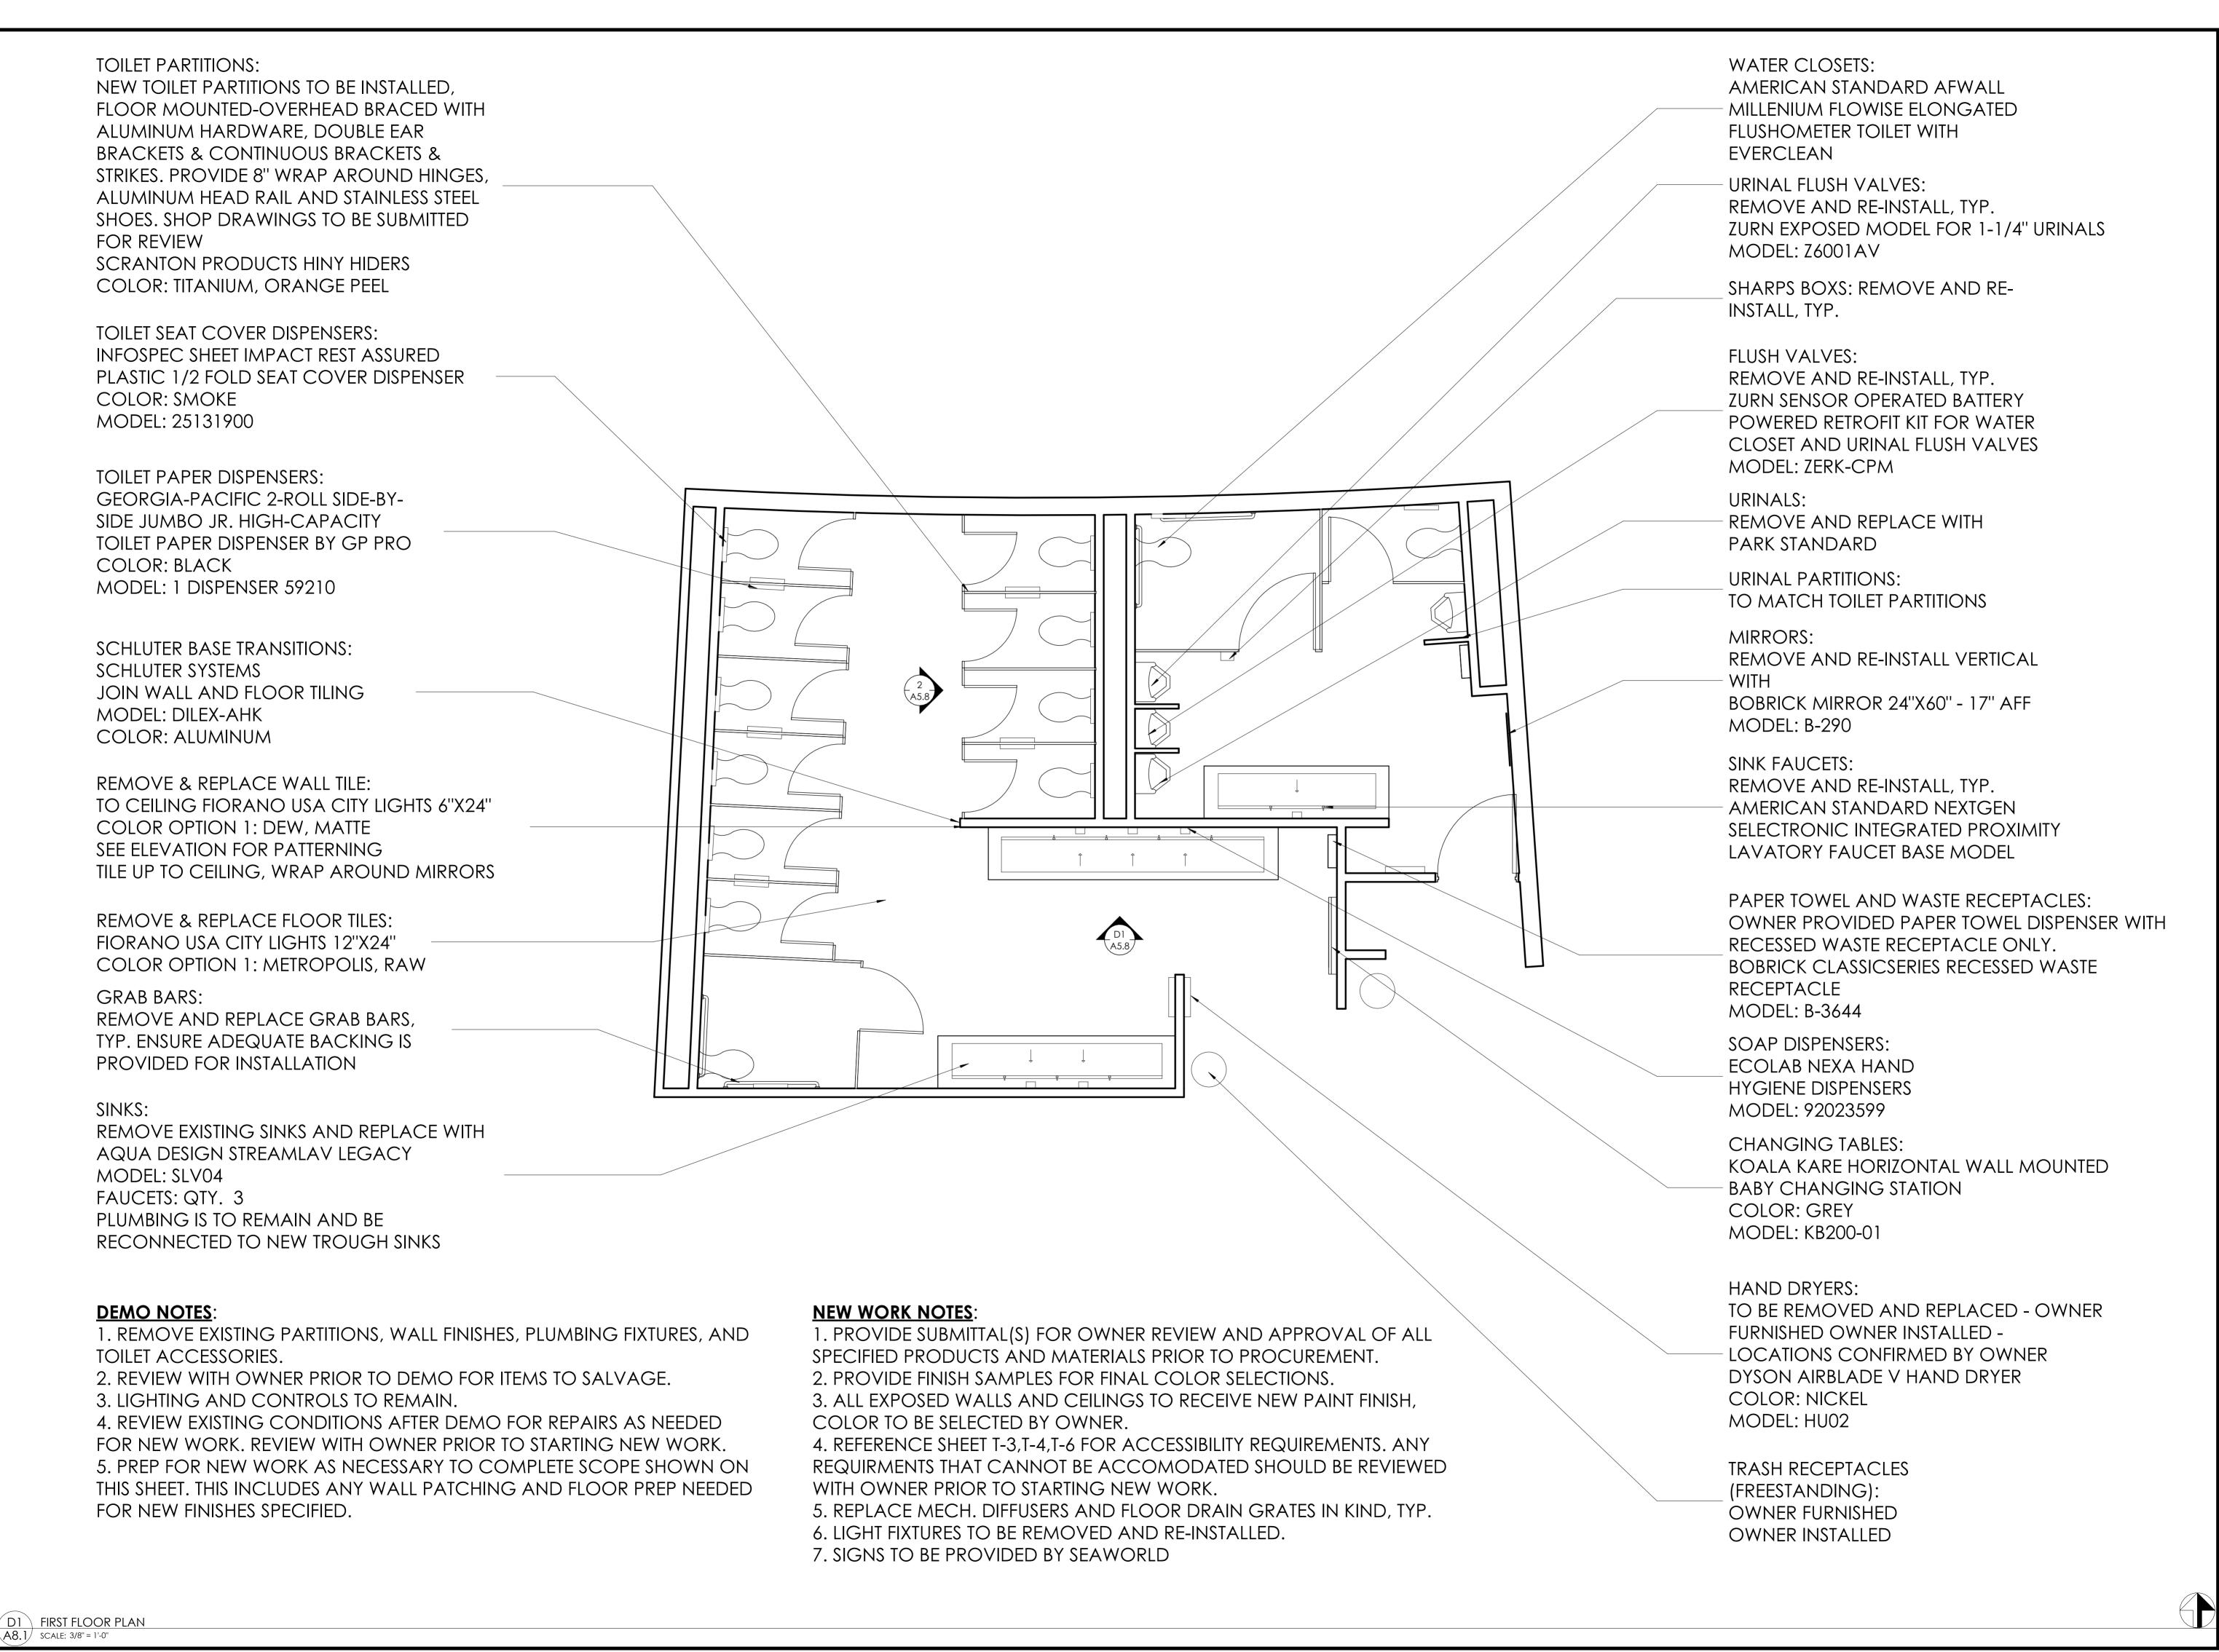

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PROJECT:

SeaWorld San Diego

Tidal Restroom Remode

500 Sea World Dr. San Diego, CA 92109



DESCRIPTION:

CONCEPT DESIGN

1/30/23

NOT FOR CONSTRUCTION

221001

PROJECT NUMBER:

SHEET TITLE:

RESTROOM SCOPE OF WORK

TIDAL

	RESTROOM 1: GROUP GATE	RESTROOM 2: EXIT	RESTROOM 3: PETS	RESTROOM 4: BAKERY	RESTROOM 5: EXPLORERS EAST	RESTROOM 6: DIP	RESTROOM 7: TIDAL	
LUSH VALVES	MANUFACTURER: ZURN COLOR: N/A MODEL: ZERK-CPM	MANUFACTURER: ZURN COLOR: N/A MODEL: ZERK-CPM	MANUFACTURER: ZURN COLOR: N/A MODEL: ZERK-CPM	MANUFACTURER: ZURN COLOR: N/A MODEL: ZERK-CPM	MANUFACTURER: ZURN COLOR: N/A MODEL: ZERK-CPM	MANUFACTURER: ZURN COLOR: N/A MODEL: ZERK-CPM	MANUFACTURER: ZURN COLOR: N/A MODEL: ZERK-CPM	
RINAL FLUSH VALVES	MANUFACTURER: ZURN COLOR: N/A MODEL: Z6001AV	MANUFACTURER: ZURN COLOR: N/A MODEL: Z6001AV	MANUFACTURER: ZURN COLOR: N/A MODEL: Z6001AV	MANUFACTURER: ZURN COLOR: N/A MODEL: Z6001AV	MANUFACTURER: ZURN COLOR: N/A MODEL: Z6001AV	MANUFACTURER: ZURN COLOR: N/A MODEL: Z6001AV	MANUFACTURER: ZURN COLOR: N/A MODEL: Z6001AV	
RAB BARS	MANUFACTURER: REMOVE, SALVAGE, AND RE-INSTALL COLOR: N/A MODEL: N/A	MANUFACTURER: REMOVE, SALVAGE, AND RE-INSTALL COLOR: N/A MODEL: N/A	MANUFACTURER: REMOVE, SALVAGE, AND RE-INSTALL COLOR: N/A MODEL: N/A	MANUFACTURER: REMOVE, SALVAGE, AND RE-INSTALL COLOR: N/A MODEL: N/A	MANUFACTURER: REMOVE, SALVAGE, AND RE-INSTALL COLOR: N/A MODEL: N/A	MANUFACTURER: REMOVE, SALVAGE, AND RE-INSTALL COLOR: N/A MODEL: N/A	MANUFACTURER: REMOVE, SALVAGE, AND RE-INSTALL COLOR: N/A MODEL: N/A	
OVE BASE TILES	SEE FINISH SCHEDULE	SEE FINISH SCHEDULE	SEE FINISH SCHEDULE	SEE FINISH SCHEDULE	SEE FINISH SCHEDULE	SEE FINISH SCHEDULE	SEE FINISH SCHEDULE	
INKS	MANUFACTURER: AQUA DESIGN STREAMLAV VIEW COLOR: TO BE SELECTED MODEL: SLV04	MANUFACTURER: AQUA DESIGN STREAMLAV VIEW COLOR: TO BE SELECTED MODEL: SLV04	MANUFACTURER: AQUA DESIGN STREAMLAV VIEW COLOR: TO BE SELECTED MODEL: SLV04	MANUFACTURER: AQUA DESIGN STREAMLAV VIEW COLOR: TO BE SELECTED MODEL: SLV04	MANUFACTURER: AQUA DESIGN STREAMLAV VIEW COLOR: TO BE SELECTED MODEL: SLV04	MANUFACTURER: AQUA DESIGN STREAMLAV VIEW COLOR: TO BE SELECTED MODEL: SLV04	MANUFACTURER: AQUA DESIGN STREAMLAV VIEW COLOR: TO BE SELECTED MODEL: SLV04	6353 [
OAP DISPENSERS	MANUFACTURER: ECOLAB COLOR: N/A MODEL: 92023599	MANUFACTURER: ECOLAB COLOR: N/A MODEL: 92023599	MANUFACTURER: ECOLAB COLOR: N/A MODEL: 92023599	MANUFACTURER: ECOLAB COLOR: N/A MODEL: 92023599	MANUFACTURER: ECOLAB COLOR: N/A MODEL: 92023599	MANUFACTURER: ECOLAB COLOR: N/A MODEL: 92023599	MANUFACTURER: ECOLAB COLOR: N/A MODEL: 92023599	
CHANGING TABLES	MANUFACTURER: KOALA KARE COLOR: GREY MODEL: KB200-01	N/A	N/A	MANUFACTURER: KOALA KARE COLOR: GREY MODEL: KB200-01	MANUFACTURER: KOALA KARE COLOR: GREY MODEL: KB200-01	N/A	MANUFACTURER: KOALA KARE COLOR: GREY MODEL: KB200-01	
OILET PARTITIONS	MANUFACTURER: SCRANTON PRODUCTS COLOR: TITANIUM, ORANGE PEEL MODEL: HINY HIDERS	MANUFACTURER: SCRANTON PRODUCTS COLOR: TITANIUM, ORANGE PEEL MODEL: HINY HIDERS	MANUFACTURER: SCRANTON PRODUCTS COLOR: TITANIUM, ORANGE PEEL MODEL: HINY HIDERS	MANUFACTURER: SCRANTON PRODUCTS COLOR: TITANIUM, ORANGE PEEL MODEL: HINY HIDERS	MANUFACTURER: SCRANTON PRODUCTS COLOR: TITANIUM, ORANGE PEEL MODEL: HINY HIDERS	MANUFACTURER: SCRANTON PRODUCTS COLOR: TITANIUM, ORANGE PEEL MODEL: HINY HIDERS	MANUFACTURER: SCRANTON PRODUCTS COLOR: TITANIUM, ORANGE PEEL MODEL: HINY HIDERS	
OILET SEAT COVERS	MANUFACTURER: INFOSPEC COLOR: SMOKE MODEL: 25131900	MANUFACTURER: INFOSPEC COLOR: SMOKE MODEL: 25131900	MANUFACTURER: INFOSPEC COLOR: SMOKE MODEL: 25131900	MANUFACTURER: INFOSPEC COLOR: SMOKE MODEL: 25131900	MANUFACTURER: INFOSPEC COLOR: SMOKE MODEL: 25131900	MANUFACTURER: INFOSPEC COLOR: SMOKE MODEL: 25131900	MANUFACTURER: INFOSPEC COLOR: SMOKE MODEL: 25131900	
OILET PAPER DISPENSERS	MANUFACTURER: GEORGIA-PACIFIC COLOR: BLACK MODEL: 1 DISPENSER 59210	MANUFACTURER: GEORGIA-PACIFIC COLOR: BLACK MODEL: 1 DISPENSER 59210	MANUFACTURER: GEORGIA-PACIFIC COLOR: BLACK MODEL: 1 DISPENSER 59210	MANUFACTURER: GEORGIA-PACIFIC COLOR: BLACK MODEL: 1 DISPENSER 59210	MANUFACTURER: GEORGIA-PACIFIC COLOR: BLACK MODEL: 1 DISPENSER 59210	MANUFACTURER: GEORGIA-PACIFIC COLOR: BLACK MODEL: 1 DISPENSER 59210	MANUFACTURER: GEORGIA-PACIFIC COLOR: BLACK MODEL: 1 DISPENSER 59210	
ATER CLOSETS	MANUFACTURER: AMERICAN STANDARD COLOR: N/A MODEL: AFWALL MILLENNIUM FLOWISE ELONGATED FLUSHOMETER TOILET WITH EVERCLEAN MANUFACTURER: COLOR: N/A MODEL: AFWALL MILLENNIUM FLOWISE ELONGATED FLUSHOMETER TOILET WITH EVERCLEAN MANUFACTURER:		MANUFACTURER: AMERICAN STANDARD COLOR: N/A MODEL: AFWALL MILLENNIUM FLOWISE ELONGATED FLUSHOMETER TOILET WITH EVERCLEAN	MANUFACTURER: AMERICAN STANDARD COLOR: N/A MODEL: AFWALL MILLENNIUM FLOWISE ELONGATED FLUSHOMETER TOILET WITH EVERCLEAN	MANUFACTURER: AMERICAN STANDARD COLOR: N/A MODEL: AFWALL MILLENNIUM FLOWISE ELONGATED FLUSHOMETER TOILET WITH EVERCLEAN	MANUFACTURER: AMERICAN STANDARD COLOR: N/A MODEL: AFWALL MILLENNIUM FLOWISE ELONGATED FLUSHOMETER TOILET WITH EVERCLEAN	MANUFACTURER: AMERICAN STANDARD COLOR: N/A MODEL: AFWALL MILLENNIUM FLOWISE ELONGATED FLUSHOMETER TOILET WITH EVERCLEAN	PRO
LOOR TILES	SEE FINISH SCHEDULE	SEE FINISH SCHEDULE	SEE FINISH SCHEDULE	SEE FINISH SCHEDULE	SEE FINISH SCHEDULE	SEE FINISH SCHEDULE	SEE FINISH SCHEDULE	Se
AND DRYERS	MANUFACTURER: DYSON AIRBLADE COLOR: NICKEL MODEL: HU02	MANUFACTURER: DYSON AIRBLADE COLOR: NICKEL MODEL: HU02	MANUFACTURER: DYSON AIRBLADE COLOR: NICKEL MODEL: HU02	MANUFACTURER: DYSON AIRBLADE COLOR: NICKEL MODEL: HU02	MANUFACTURER: DYSON AIRBLADE COLOR: NICKEL MODEL: HU02	MANUFACTURER: DYSON AIRBLADE COLOR: NICKEL MODEL: HU02	MANUFACTURER: DYSON AIRBLADE COLOR: NICKEL MODEL: HU02	R
ALL TILES	SEE FINISH SCHEDULE	SEE FINISH SCHEDULE	SEE FINISH SCHEDULE	SEE FINISH SCHEDULE	SEE FINISH SCHEDULE	SEE FINISH SCHEDULE	SEE FINISH SCHEDULE	
VASTE RECEPTACLES	MANUFACTURER: BOBRICK COLOR: N/A MODEL: B-3644	MANUFACTURER: BOBRICK COLOR: N/A MODEL: B-3644	MANUFACTURER: BOBRICK COLOR: N/A MODEL: B-3644	MANUFACTURER: BOBRICK COLOR: N/A MODEL: B-3644	MANUFACTURER: BOBRICK COLOR: N/A MODEL: B-3644	MANUFACTURER: BOBRICK COLOR: N/A MODEL: B-3644	MANUFACTURER: BOBRICK COLOR: N/A MODEL: B-3644	
RASH RECEPTACLES	FREESTANDING OWNER FURNISHED OWNER INSTALLED	FREESTANDING OWNER FURNISHED OWNER INSTALLED	FREESTANDING OWNER FURNISHED OWNER INSTALLED	FREESTANDING OWNER FURNISHED OWNER INSTALLED	FREESTANDING OWNER FURNISHED OWNER INSTALLED	FREESTANDING OWNER FURNISHED OWNER INSTALLED	FREESTANDING OWNER FURNISHED OWNER INSTALLED	
								Se
								DESC
NOTES	2		2		2	2		CON

	FLOOR TILES					WALL TILES					CEILING PAINT		NOTES
	MANUF.	STYLE	SIZE	COLOR	FINISH	MANUF.	STYLE	SIZE	COLOR	FINISH	MANUF.	COLOR	
RESTROOM 1: GROUP GATE	SEE OWNERS DESIGN PACKET FOR TILE COLOR AND PATTERN						SEE OWNERS DESIGN PACKET FOR TILE COLOR AND PATTERN SHERWIN-WILL						1
RESTROOM 2: EXIT	SEE OWNERS DESIGN PACKET FOR TILE COLOR AND PATTERN					SEE OWNERS DESIGN PACKET FOR TILE COLOR AND PATTERN SHERWIN-WILLIAMS						SW-7757 HIGH REFLECTIVE WHITE SEMI-GLOSS	1
RESTROOM 3: PETS	SEE OWNERS DESIGN PACKET FOR TILE COLOR AND PATTERN					SEE OWNERS DESIGN PACKET FOR TILE COLOR AND PATTERN SHERWIN-WILL						SW-7757 HIGH REFLECTIVE WHITE SEMI-GLOSS	1
RESTROOM 4: BAKERY	SEE OWNERS DESIGN PACKET FOR TILE COLOR AND PATTERN					SEE OWNERS DESIGN PACKET FOR TILE COLOR AND PATTERN SHERV					SHERWIN-WILLIAMS	SW-7757 HIGH REFLECTIVE WHITE SEMI-GLOSS	1
RESTROOM 5: EXPLORERS EAST	SEE OWNERS DESIGN PACKET FOR TILE COLOR AND PATTERN						SEE OWNERS DESIGN PACKET FOR TILE COLOR AND PATTERN SHERWIN-WILLIAM					SW-7757 HIGH REFLECTIVE WHITE SEMI-GLOSS	1
RESTROOM 6: DIP	SEE OWNERS DESIGN PACKET FOR TILE COLOR AND PATTERN					SEE OWNERS DESIGN PACKET FOR TILE COLOR AND PATTERN SHERWIN-WILLIAMS						SW-7757 HIGH REFLECTIVE WHITE SEMI-GLOSS	1
RESTROOM 7: TIDAL	SEE OWNERS DESIGN PACKET FOR TILE COLOR AND PATTERN					SEE OWNERS DESIGN PACKET FOR TILE COLOR AND PATTERN SHERWIN-WILLIAM					SHERWIN-WILLIAMS	SW-7757 HIGH REFLECTIVE WHITE SEMI-GLOSS	1

NOTES:

1. SCHLUTER SYSTEM TO CONNECT FLOOR AND WALL TILING

2. GRAB BARS FOR SEMI AMBULATORY RESTROOMS, BOBRICK B-5806, 1/4" DIAMETER STAINLESS STEEL GRAB BARS WITH SNAP FLANGE



NOT FOR CONSTRUCTION

PROJECT NUMBER: 221001

SHEET TITLE:

SCHEDULES