
PUZ-A24NHA7 PUZ-A30NHA7 PUY-A24NHA7 PUY-A30NHA7 PUZ-A24NHA7-BS PUZ-A30NHA7-BS PUY-A24NHA7-BS PUY-A30NHA7-BS

SYMBOL	NAME	SYMBOL	NAME	SYMBOL	NAME
TB1	Terminal Block (Power Supply, Indoor/Outdoor)	TH33	Thermistor (Comp. Surface)	SW5	Switch 〈Function Switch, Model Select〉
MC	Motor for Compressor	LEV-A, LEV-B	Linear Expansion Valve	SW6	Switch (Model Select)
MF1	Fan Motor	DCL	Reactor	SW7	Switch 〈Function Switch〉
21S4	Solenoid Valve 〈4-Way Valve〉	CY1, CY2	Capacitor	SW8	Switch 〈Function Switch〉
63H	High Pressure Switch	P. B.	Power Circuit Board	SW9	Switch 〈Function Switch〉
TH3	Thermistor \(\lambda\) Liquid \(\rangle\)	C. B.	Controller Circuit Board	SWP	Switch (Pump Down)
TH4	Thermistor (Discharge)	F1, F2	Fuse (T10AL250V)	CNM	Connector (Connection for Option)
TH6	Thermistor (2-Phase Pipe)	F3, F4	Fuse (T6.3AL250V)	CN31	Connector (Emergency Operation)
TH7	Thermistor (Ambient)	SW1	Switch \( Manual Defrost, Defect History	CNDM	Connector (Connection for Option)
TH8	Thermistor 〈Heat Sink〉		Record Reset, Refrigerant Address	SV3/SS	Connector (Connection for Option)
TH32	Thermistor (Suction)	SW4	Switch 〈Function Switch〉		

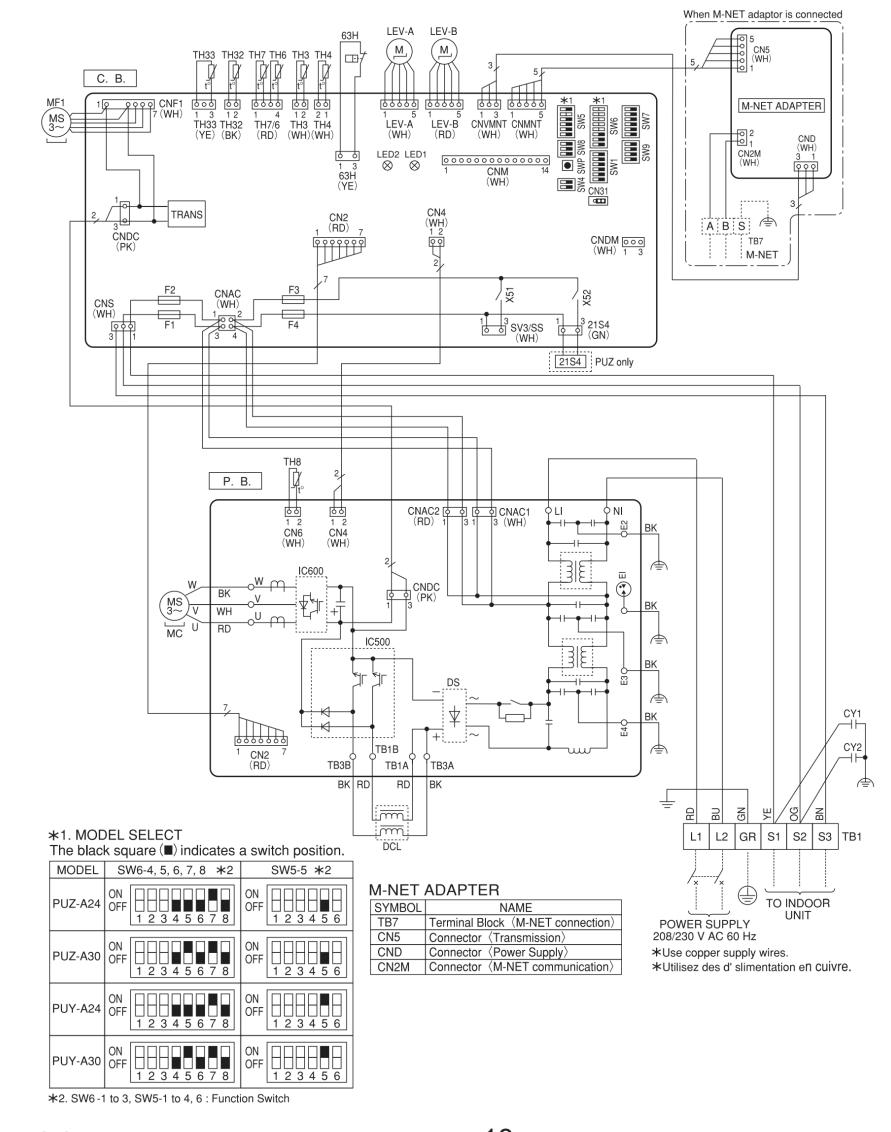


OCH636D 18

F1 E-501

432RCU01-2H & 432RCU02-3H SPLIT SYSTEM WIRING DIAGRAM

SCALE:NOT TO SCALE

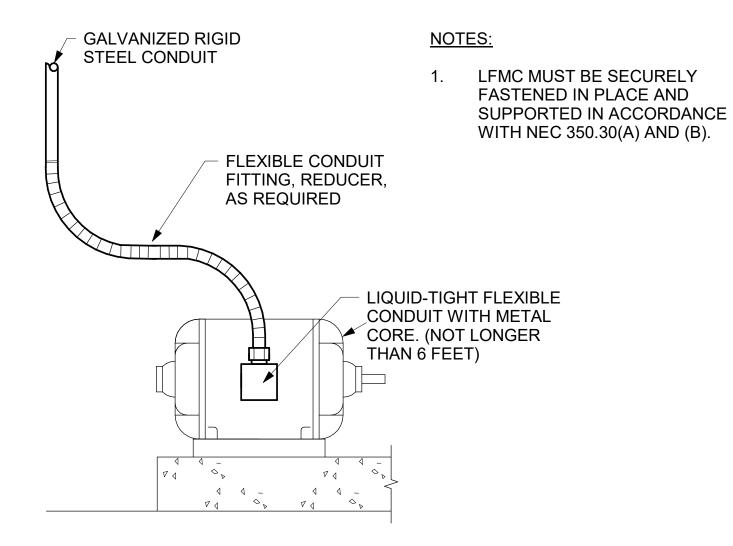

TYP. OVERHEAD CONDUIT SERVICE FOR SMALL AND MEDIUM SIZE MOTORS

SCALE: NO SCALE SHOWN

**GENERAL NOTES** 

- 1. FOR GENERAL NOTES, SYMBOLS, AND ABBREVIATIONS, REFER TO SHEET E-001.
- 2. REFER TO STRUCTURAL SHEET S-501 FOR ADDITIONAL REQUIREMENTS.

Sheet Title

**ELECTRICAL DETAILS** 

wg. No.

PLE2021-0432-0012D

Sht. No

E-501