


A
B
C
D
E

A
B
C
D
E

- NOTES:
- SEE SHEET 54.10 FOR TYPICAL POST TENSIONED GIRDER DETAILS AND SCHEDULES.
 - INDICATES POUR-STRIP, CAST NO EARLIER THAN 56 DAYS AFTER FINAL DECK.
 - SEE SHEET 53.50 FOR COLUMN SCHEDULE.
 - SEE 55.50 FOR TYPICAL CMU WALL DETAILS.
 - SEE 54.20 FOR TYPICAL CONCRETE JOIST DETAILS.
 - INDICATES C.G.S OF POST-TENSIONING TENDONS AT CONTROL POINT MEASURED FROM SLAB SOFFIT TYPICAL. SEE DETAIL 1/54.11 FOR TYPICAL LAYOUT OF CONTROL POINTS.
 - TYPICAL SLAB POST-TENSIONING PROFILES.
= 1.5" AT SLAB MID-SPAN U.N.O.
= 7" CENTERED OVER SUPPORTS U.N.O.

SECOND FLOOR SLAB REINFORCING SCHEDULE		
MARK	CALLOUT	REMARKS
(A)	#6x16'-0" @ 12" O.C. BOT.	
(B)	#5x12'-0" @ 12" O.C. BOT.	
(C)	#5 @ 12" O.C. ALT. TOP & BOT.	
(D)	5'-2" @ 6" O.C. TOP	
(E)	#5x15'-0" @ 12" O.C. TOP	
(F)	#6x23'-0" @ 12" O.C. BOT.	
(G)	5'-2" @ 12" O.C.	
(H)	#5 @ 12" O.C. TOP	
(I)	#4x4'-0" @ 12" O.C. TOP	
(J)	#5x6'-0" @ 12" O.C. TOP	
(K)	(5) #9x12'-0" @ 3" O.C.	@ SLAB MID-DEPTH
(L)	#10 @ 8" O.C. BOT.	
(M)	#4x9'-0" @ 12" O.C. BOT.	
(N)	#4 @ 12" O.C. TOP	
(O)	#4 @ 12" O.C. T&B	
(P)	#4 @ 8" O.C. TOP	
(Q)	(2) #9x20'-0" @ 3" O.C.	
(R)	(6) #10x20'-0" @ 3" O.C.	
(S)	(3) #9x20'-0" @ 3" O.C.	
(T)	#5 @ 12" O.C. T&B	

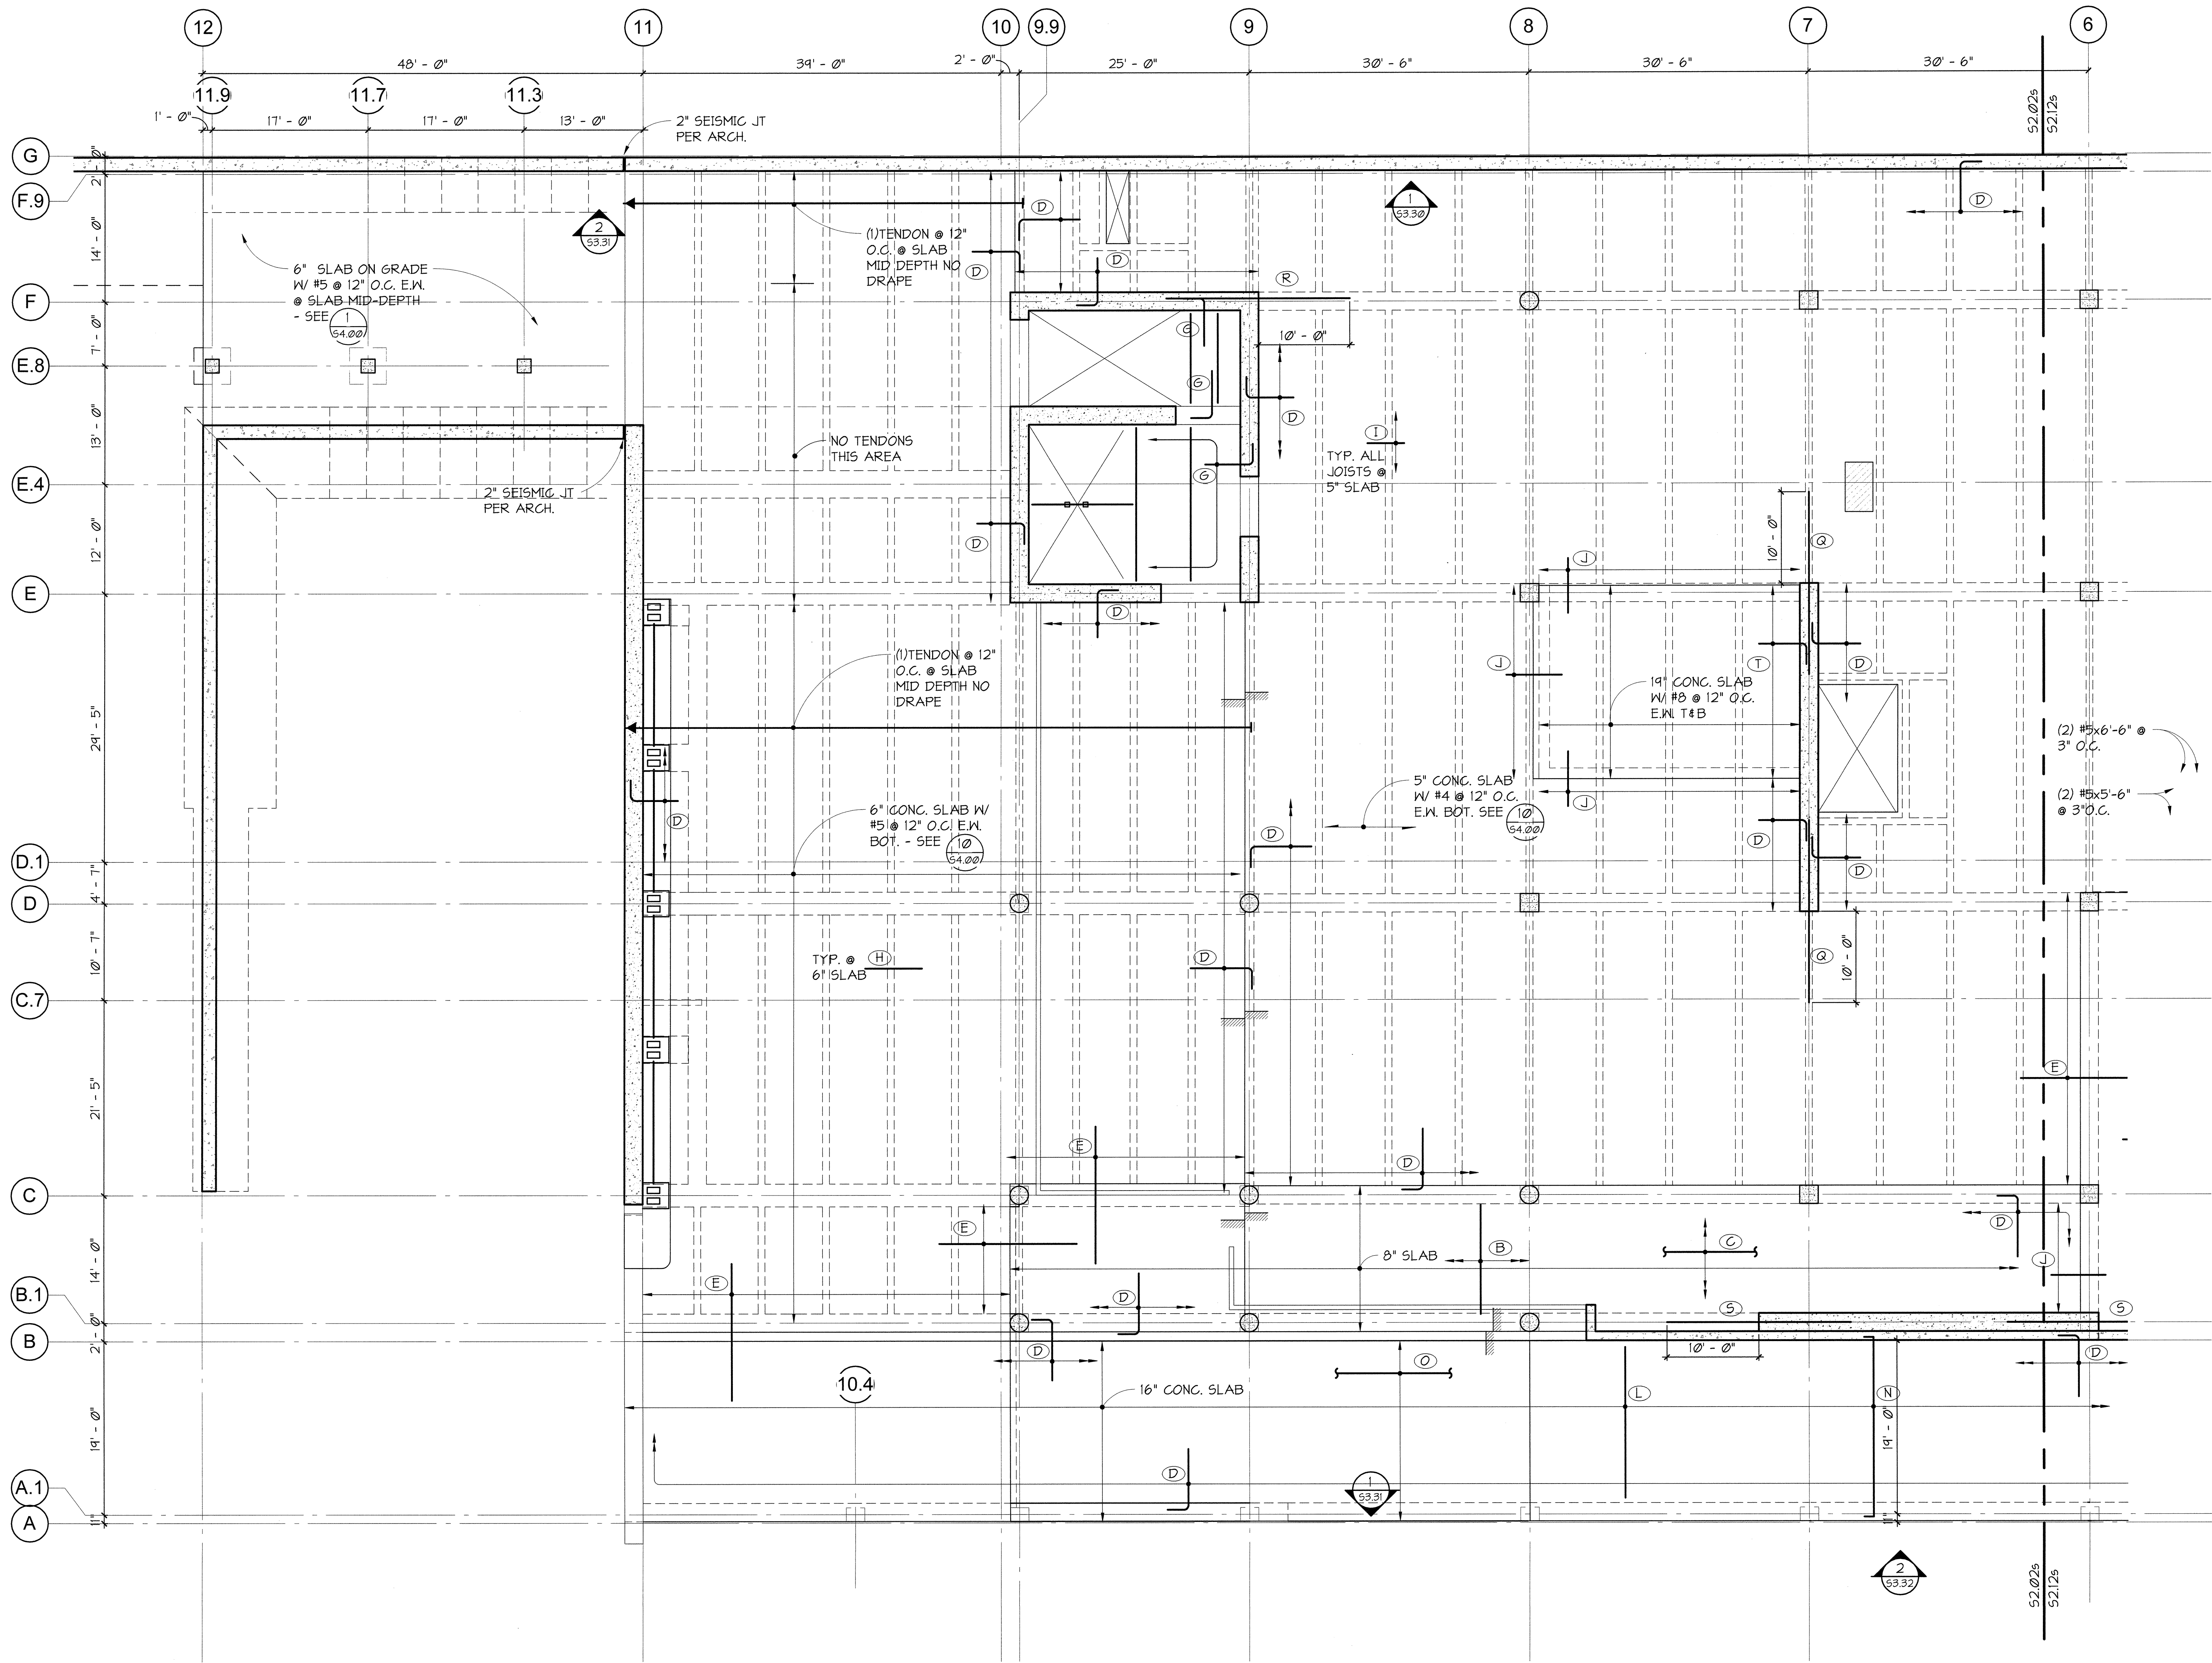


1 SECOND FLOOR SLAB PLAN - SOUTH
1/8" = 1'-0"



GIFFIN • BOLTE • JURGENS
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MultiCare
EMERGENCY DEPARTMENT & CANCER CENTER EXPANSION
TACOMA, WASHINGTON

Date 09-26-2008
Scale 1/8" = 1'-0"
Drawn By RSC
Job No. 4034

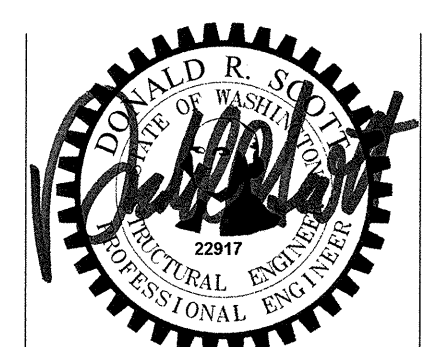SECOND FLOOR
SLAB PLAN -
SOUTH

S2
02s