

SSH JV

Milpitas Station Design Unit 023 Readiness for Construction Architectural


SVBX C700

Wednesday, July 10, 2013


HALF SIZE COPY





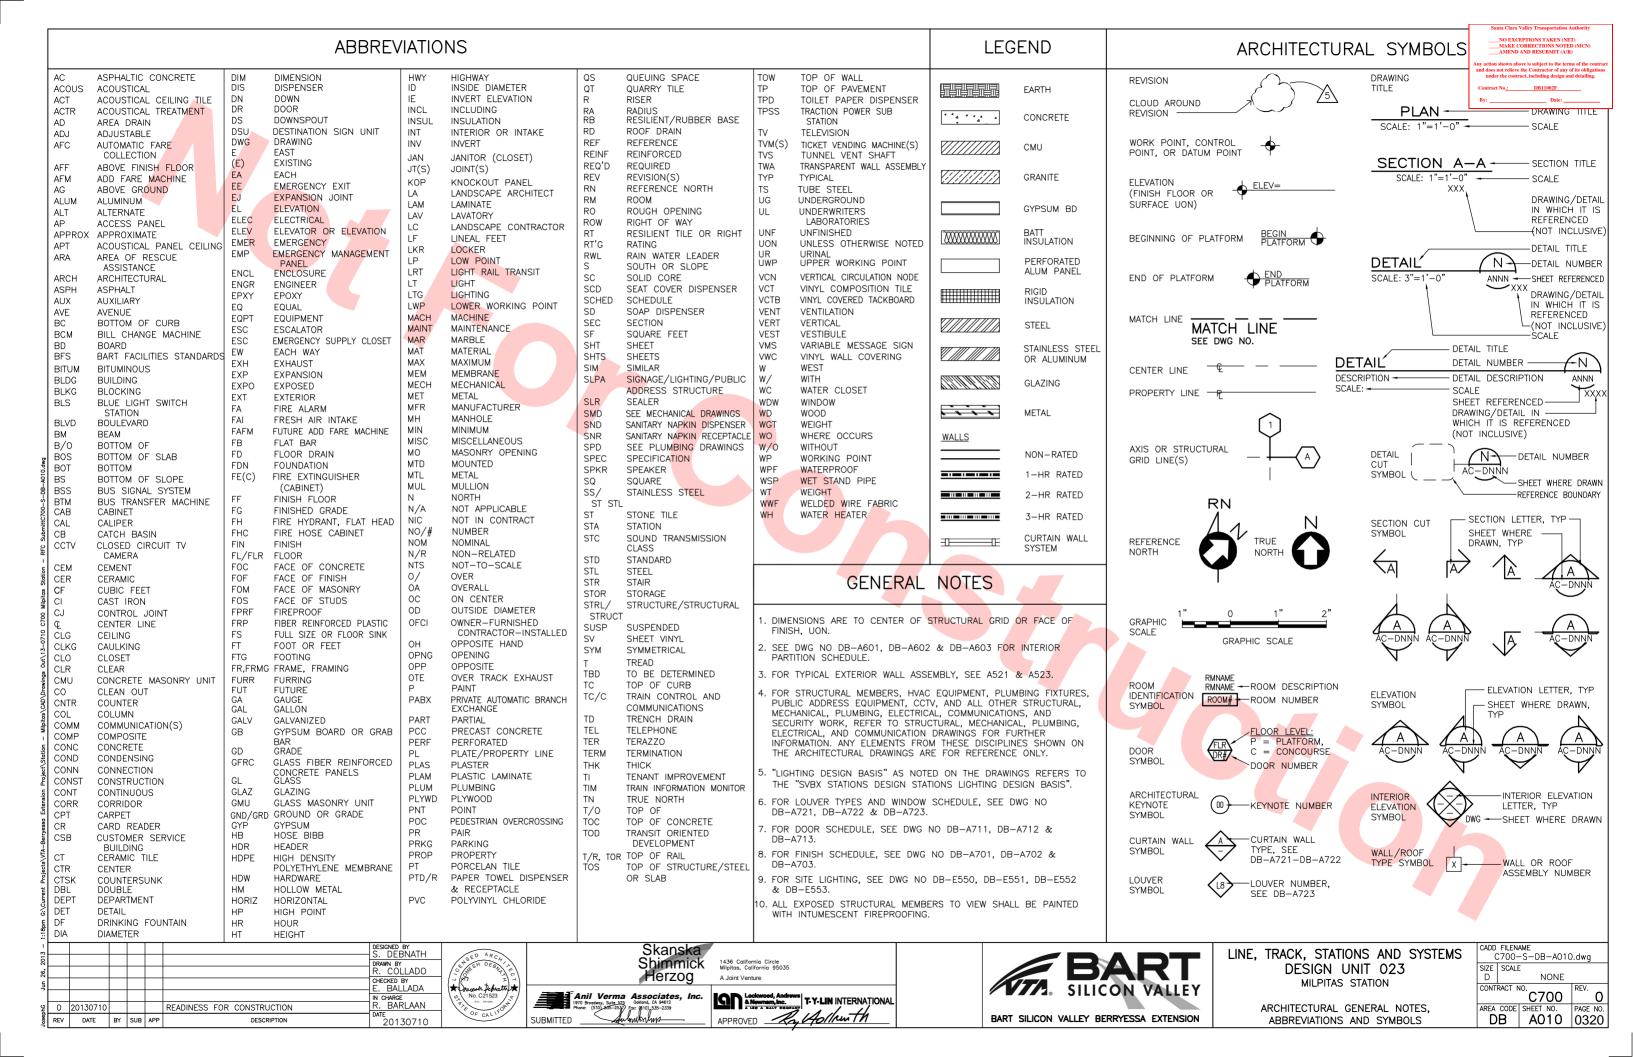

MASTER KI

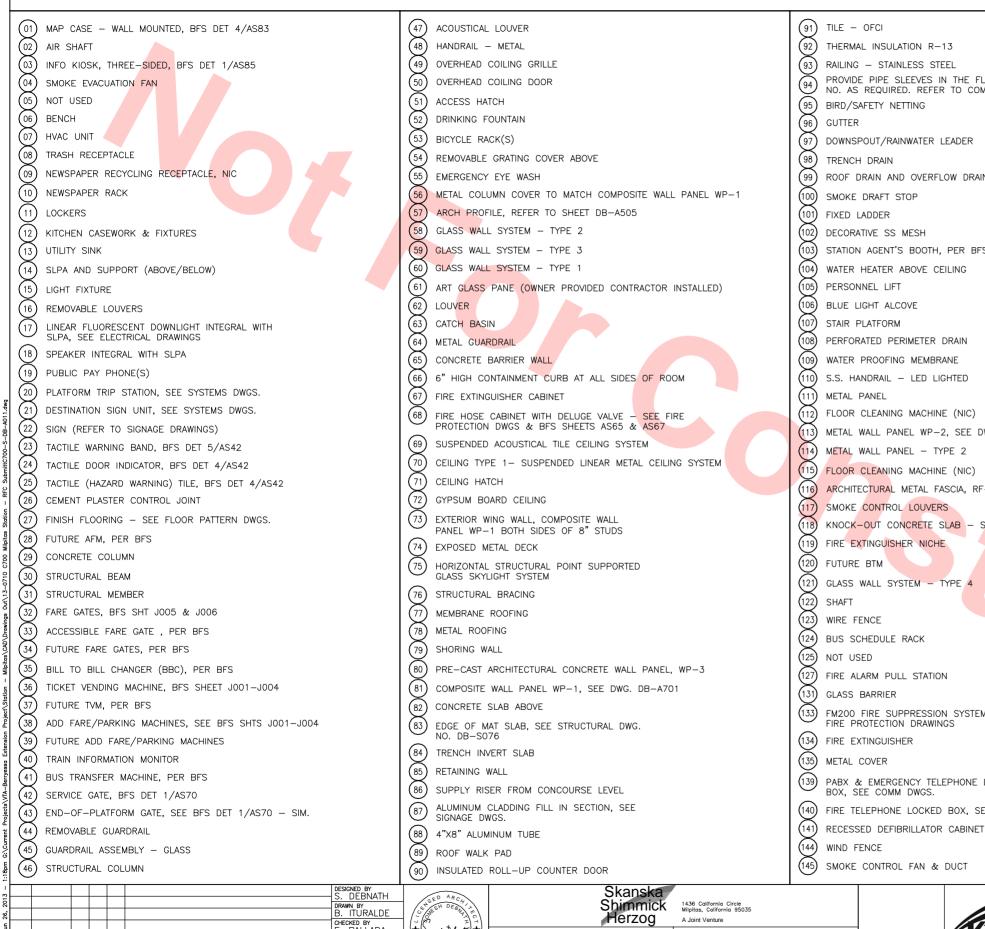

E	ΞΥ	NOTES
	(91)	TILE - OFCI
l	(92)	THERMAL INSULATION R-13
l	(93)	RAILING — STAINLESS STEEL
l	(94)	PROVIDE PIPE SLEEVES IN THE FLOOR SLAB. SIZE, SPACING AND
l	\times	NO. AS REQUIRED. REFER TO COMMUNICATION DRAWINGS
l	(95)	BIRD/SAFETY NETTING GUTTER
l	(96) (97)	DOWNSPOUT/RAINWATER LEADER
l	(98)	TRENCH DRAIN
l	(99)	ROOF DRAIN AND OVERFLOW DRAIN
l	(100)	SMOKE DRAFT STOP
l	(101)	FIXED LADDER
l	(102)	DECORATIVE SS MESH
l	(103)	STATION AGENT'S BOOTH, PER BFS
l	(104)	WATER HEATER ABOVE CEILING
l	(105)	PERSONNEL LIFT
l	(106)	BLUE LIGHT ALCOVE
l	(107)	STAIR PLATFORM
l	(108)	PERFORATED PERIMETER DRAIN
l	(109)	WATER PROOFING MEMBRANE
l	(110)	S.S. HANDRAIL — LED LIGHTED
l	(11)	METAL PANEL
	112	FLOOR CLEANING MACHINE (NIC)
	113	METAL WALL PANEL WP-2, SEE DWG. NO. DB-A701
	114	METAL WALL PANEL - TYPE 2
ı	115	FLOOR CLEANING MACHINE (NIC)
	(116)	ARCHITECTURAL METAL FASCIA, RF-1, SEE DWG. DB-A701
l	(117)	SMOKE CONTROL LOUVERS
l	(118)	KNOCK-OUT CONCRETE SLAB - SEE STRUCTURAL DRAWINGS
l	(119)	FIRE EXTINGUISHER NICHE
l	(120)	FUTURE BTM
l	(121)	GLASS WALL SYSTEM - TYPE 4
l	(122)	SHAFT
l	(123)	WIRE FENCE
l	(124)	BUS SCHEDULE RACK
l	(125)	NOT USED
l	(127)	FIRE ALARM PULL STATION
l	(131)	GLASS BARRIER
	(133)	FM200 FIRE SUPPRESSION SYSTEM — SEE FIRE PROTECTION DRAWINGS
	(134)	FIRE EXTINGUISHER
	(135)	METAL COVER
	139	PABX & EMERGENCY TELEPHONE LOCKED BOX, SEE COMM DWGS.
	(140)	FIRE TELEPHONE LOCKED BOX, SEE COMM DRAWINGS

BART SILICON VALLEY BERRYESSA EXTENSION

(146) DECORATIVE STAINLESS STEEL MESH METAL PANEL ACCENT BAND WP-1A, SEE DWG. DB-A701 (149) CONCRETE TOPPING COLORED GLASS BLOCK INSERT ADVERTISEMENT FRAME SPACE BICYCLE CHANNEL @ STAIRS #3 & #4 PER BFS CEILING TYPE 2- SUSPENDED 24"x60" METAL PLANK CEILING CEMENT PLASTER CEILING (155) CEMENT PLASTER FINISH CORRECTIONAL GRADE LIGHT FIXTURE LIGHT FIXTURE WITH OPEN CONDUIT (158) METAL VALANCE VARIABLE MESSAGE SIGN (TRAIN INFORMATION MONITOR) (161) LOW WALL VENT AND VENT DUCT SKYLIGHT SMOKE EVACUATION FAN (164) 24" SQ X 12" DEEP SUMP PIT PARKING VALIDATION MACHINE (PVM) RAIL LUBRICATOR ALCOVE (168) FARE GATE COMPRESSOR MAINTENANCE CATWALK EQUIPMENT ACCESS ROOF HATCH PERFORATED CORRUGATED STAINLESS STEEL PANEL EMERGENCY FAN DAMPER MONITORING WINDOW EMERGENCY FAN CONTROL PANEL FIRE HOSE CONNECTION - SEE FIRE PROTECTION DWGS. 8" WALL EXPANSION JOINT COVER SAFETY CHAIN (3 ROWS) ART TILE-PROVIDED & INSTALLED BY OTHERS

REMOVABLE FLOOR GRATING PUMP EXTRACTION EQUIPMENT HOIST ABOVE

VENT DUCT

(189) 8" WALL EXPANSION JOINT (190) 8" FLOOR EXPANSION JOINT

(191) SCUPPER DRAIN

(192) 8" ROOF EXPANSION JOINT

Santa Clara Valley Transportation Authority

NO EXCEPTIONS TAKEN (NET) MAKE CORRECTIONS NOTED (MCN) AMEND AND RESUBMIT (A/R)

and does not relieve the Contractor of any of its obligations under the contract, including design and detailing.

DB11002F


, TRACK, STATIONS AND SYSTEMS	CADD FILENAME C700-S-DB-A011.dwg
DESIGN UNIT 023 MILPITAS STATION	SIZE SCALE NONE
	C700 REV. O
MASTER KEY NOTES	AREA CODE SHEET NO. PAGE NO DB A011 0321







SUBMITTED




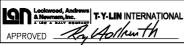




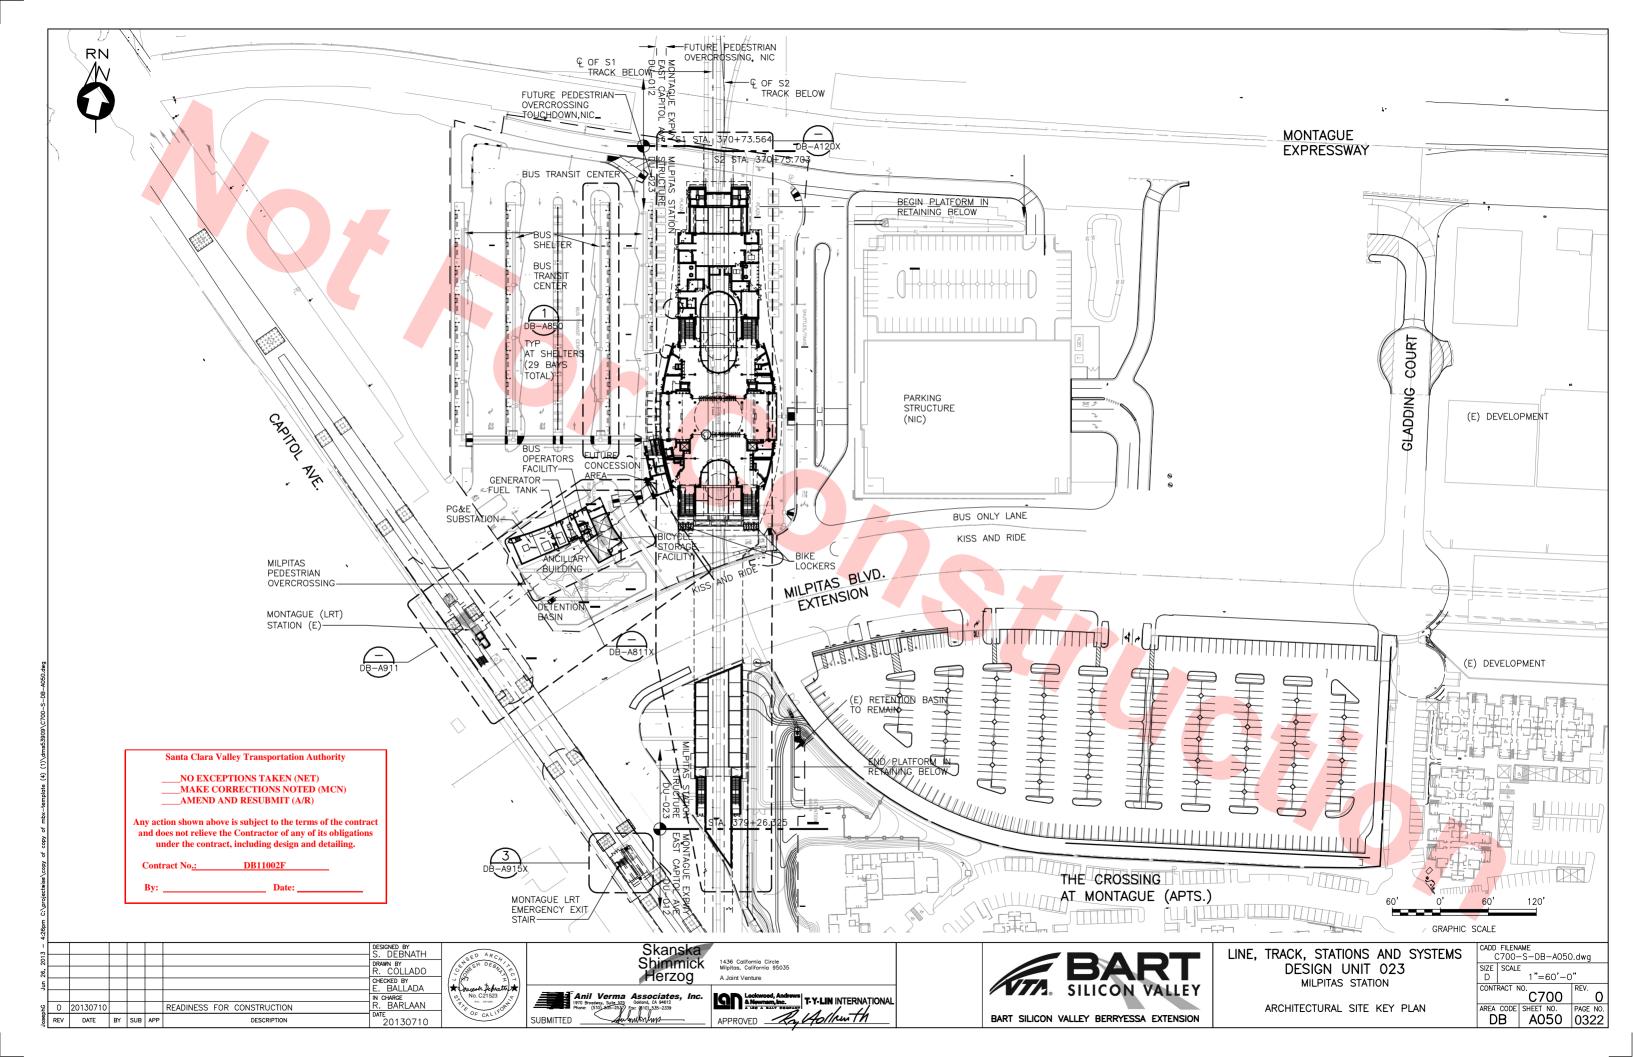

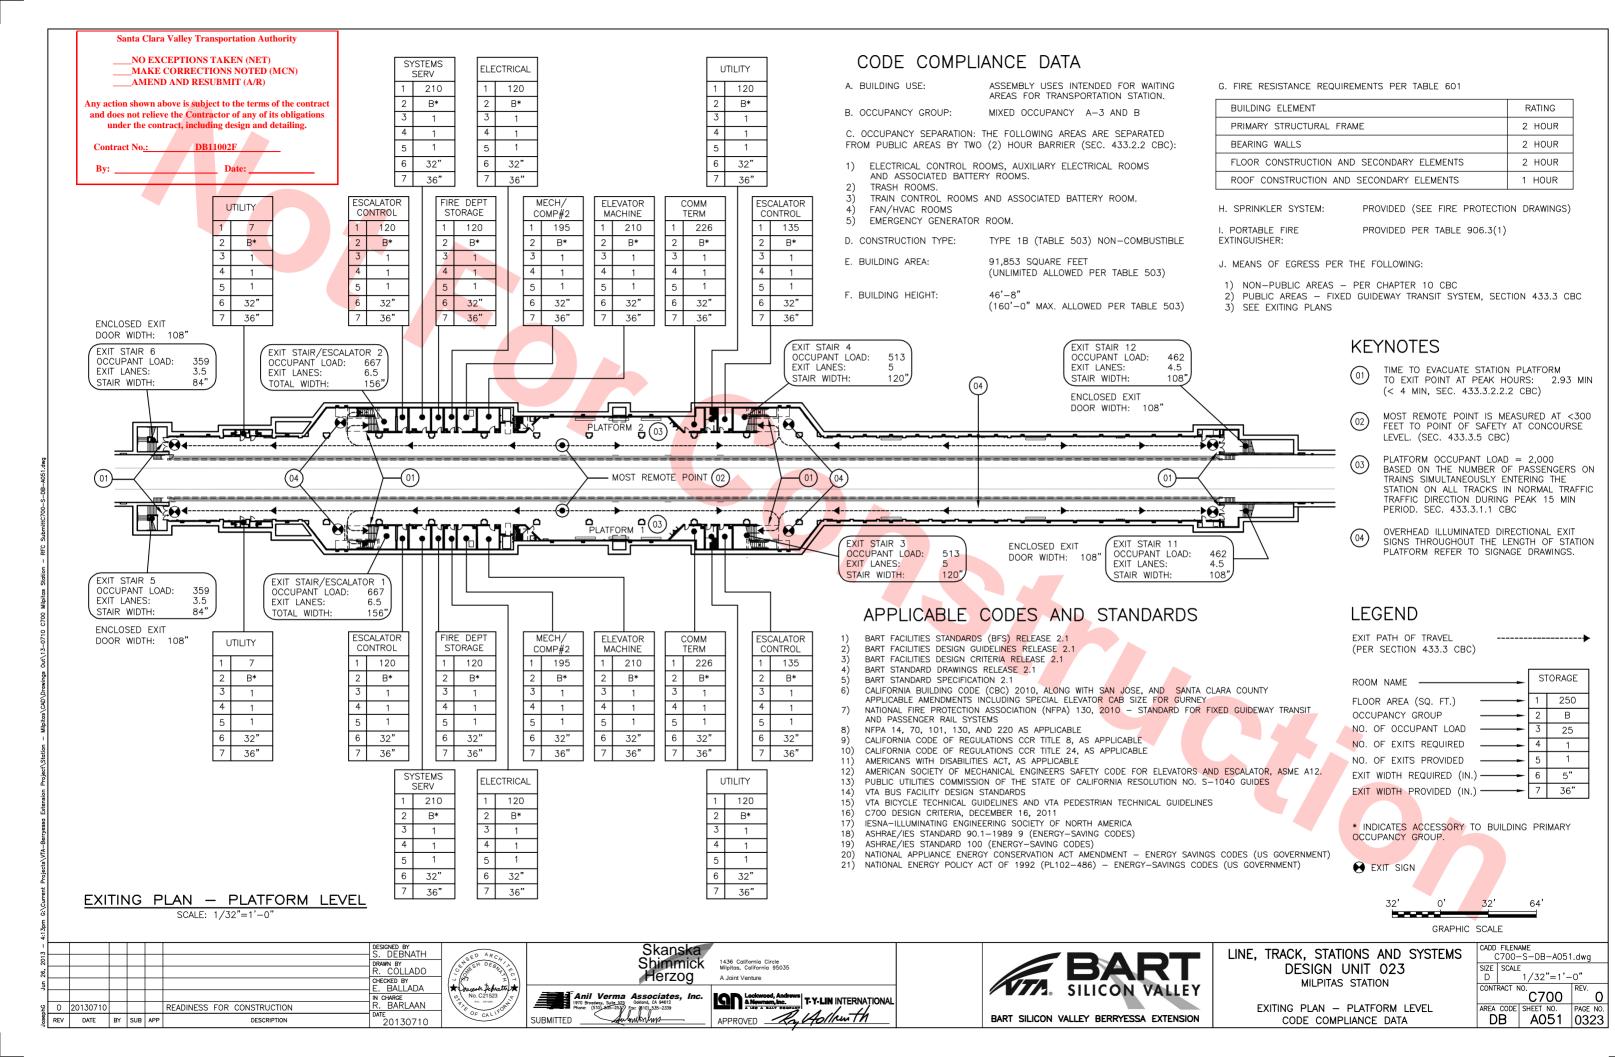

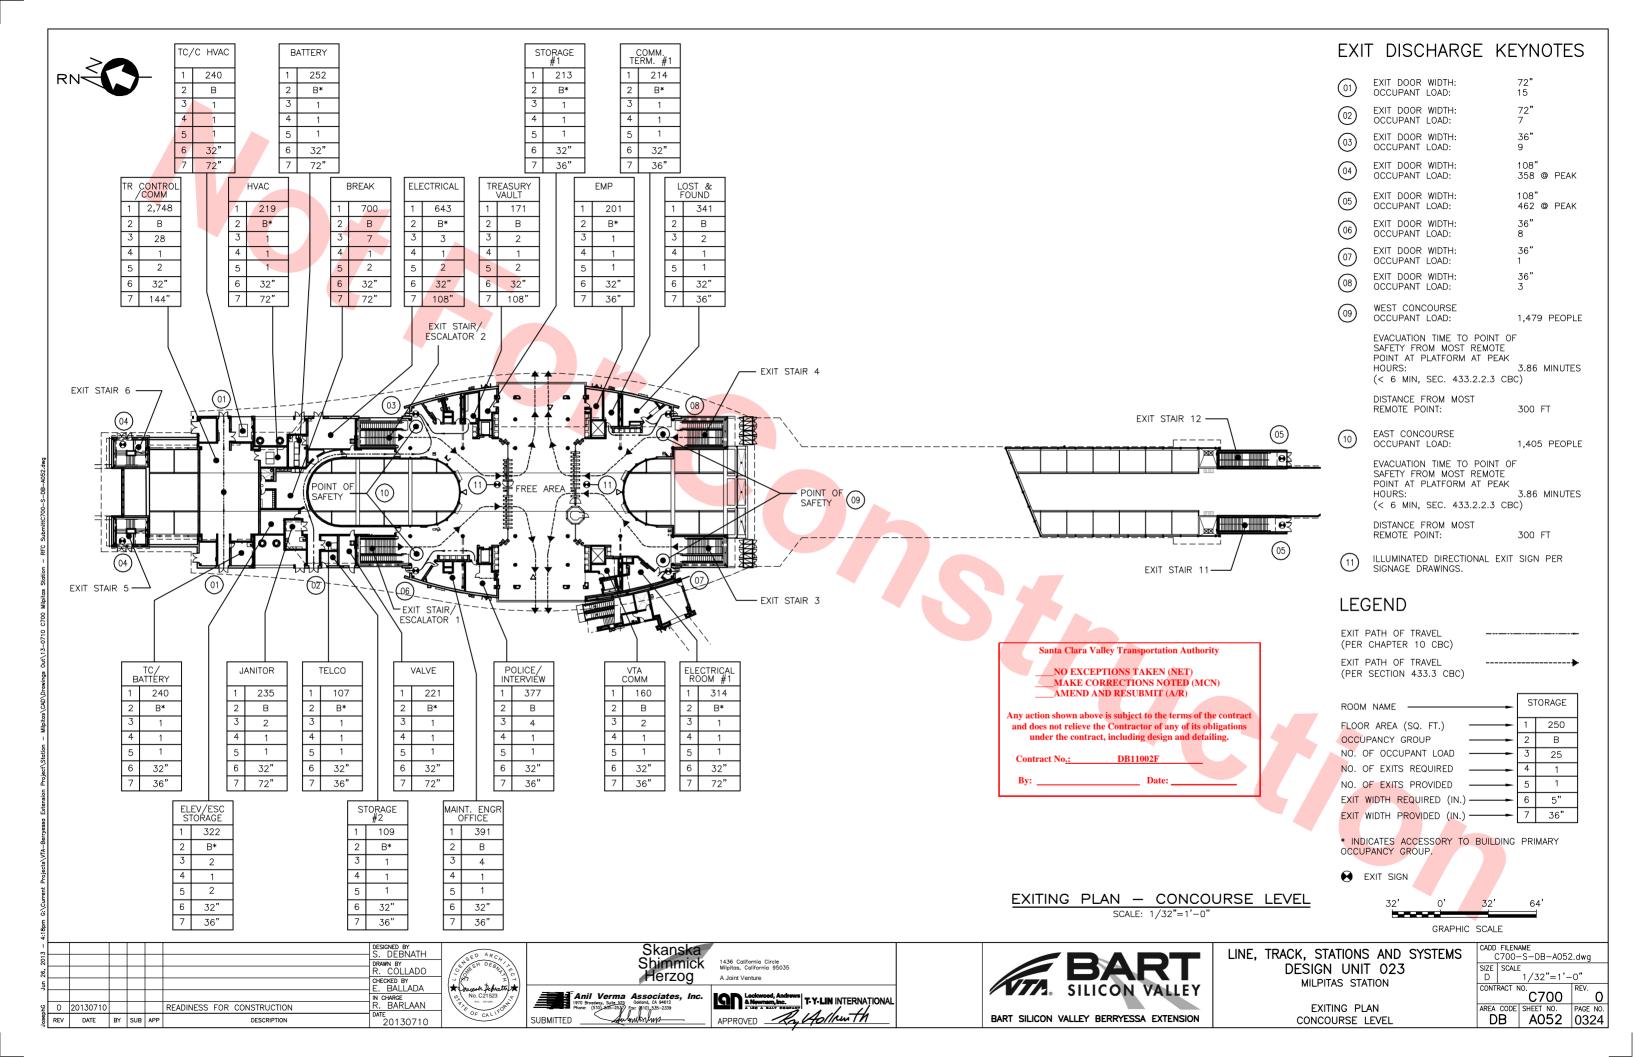



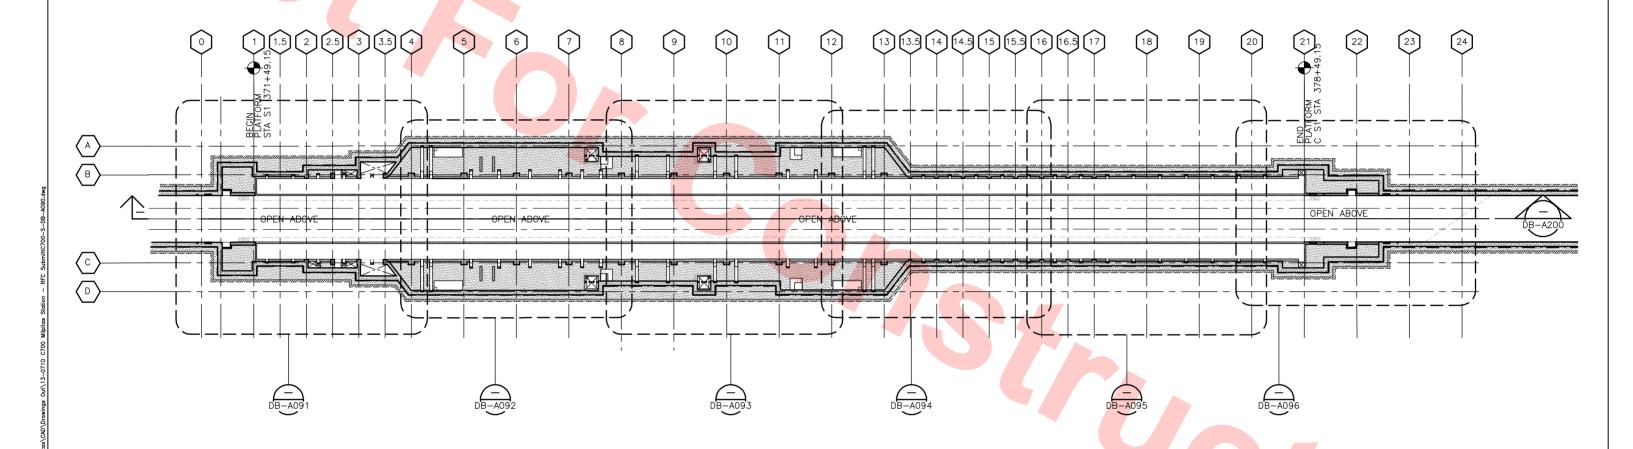

KEY PLAN -TRACK LEVEL SCALE: 1/32"=1'-0"


Santa Clara Valley Transportation Authority

NO EXCEPTIONS TAKEN (NET) MAKE CORRECTIONS NOTED (MCN)
AMEND AND RESUBMIT (A/R)


Any action shown above is subject to the terms of the contract

and does not relieve the Contractor of any of its obligations under the contract, including design and detailing.

DB11002F

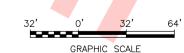

-1						
- 1						
2013						
56,						
Ę						
1						
ջ	0	20130710				READINESS FOR CONSTRUCTION
JosephG	REV	DATE	BY	SUB	APP	DESCRIPTION

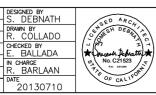


SUBMITTED

CHECKED BY E. BALLADA



1436 California Circle Milpitas, California 95035 A Joint Venture

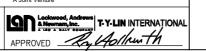






LINE, TRACK, STATIONS AND SYSTEMS DESIGN UNIT 023


MILPHAS STATION	CC
KEY PLAN	AR
TRACK LEVEL	


S		FILEN. C700-	AME -S-DB-AOS	0.d	lwg
	SIZE D	SCALE	1/32"=1'	-0'	,,
		RACT N	C700	RI	EV. 0
		CODE B	SHEET NO. AO90		AGE NO. 1326

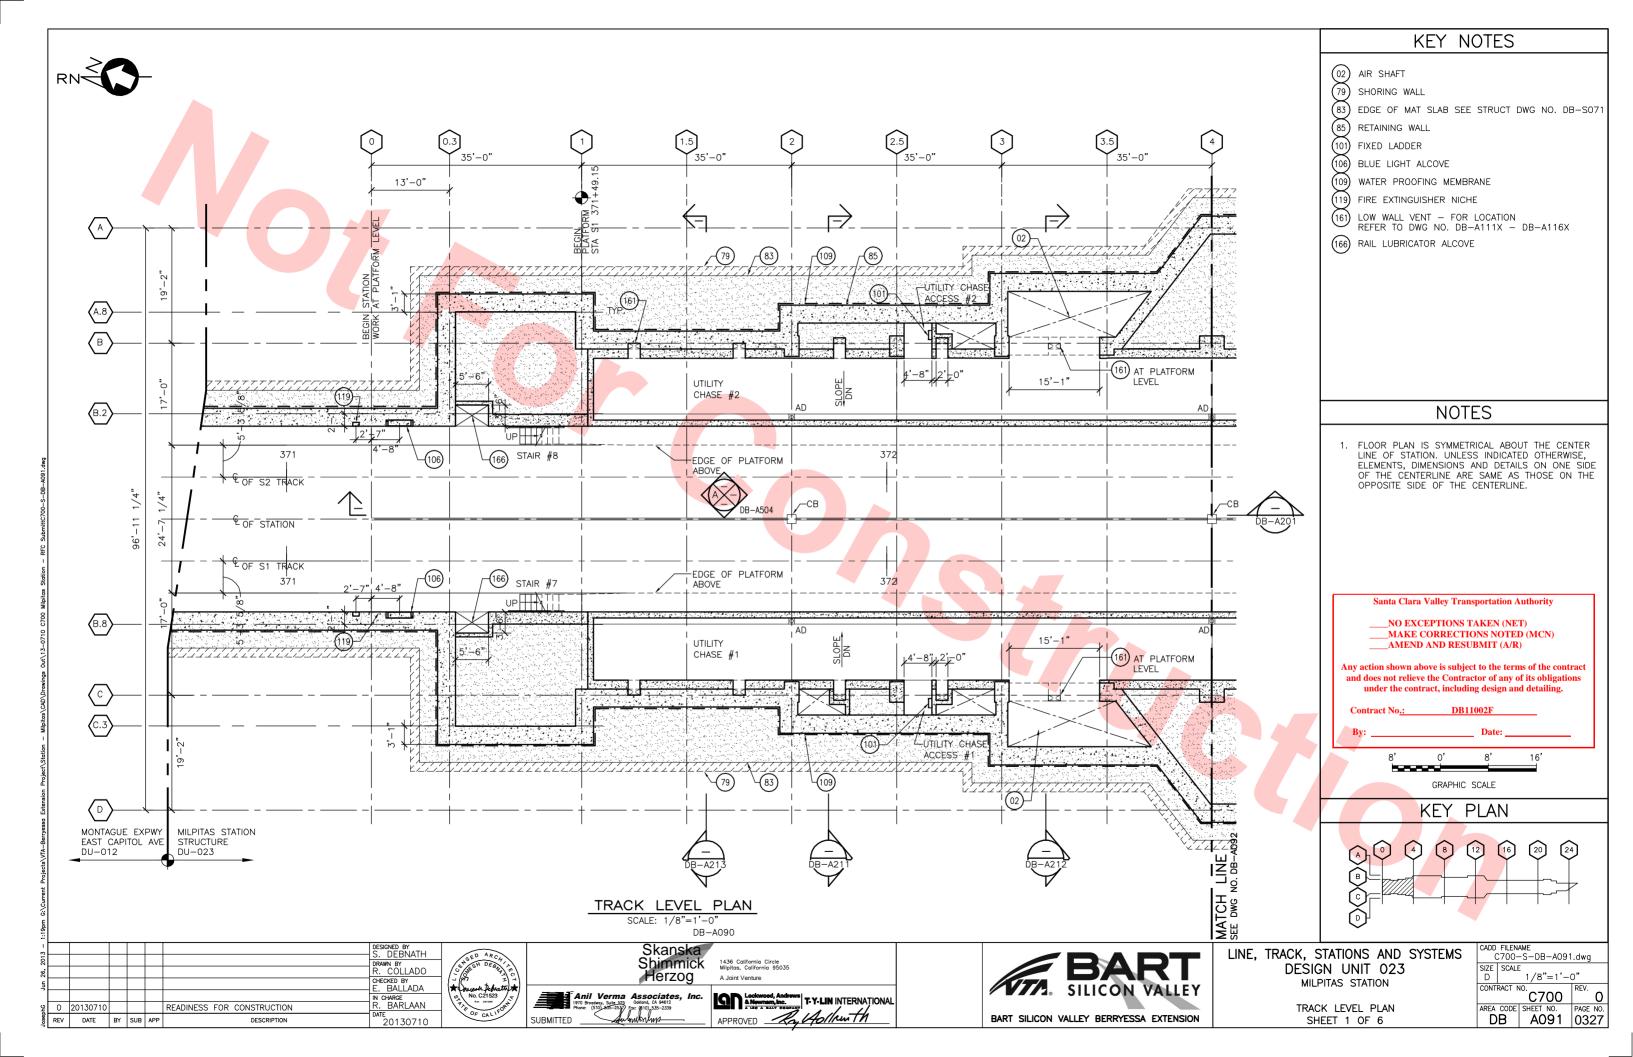


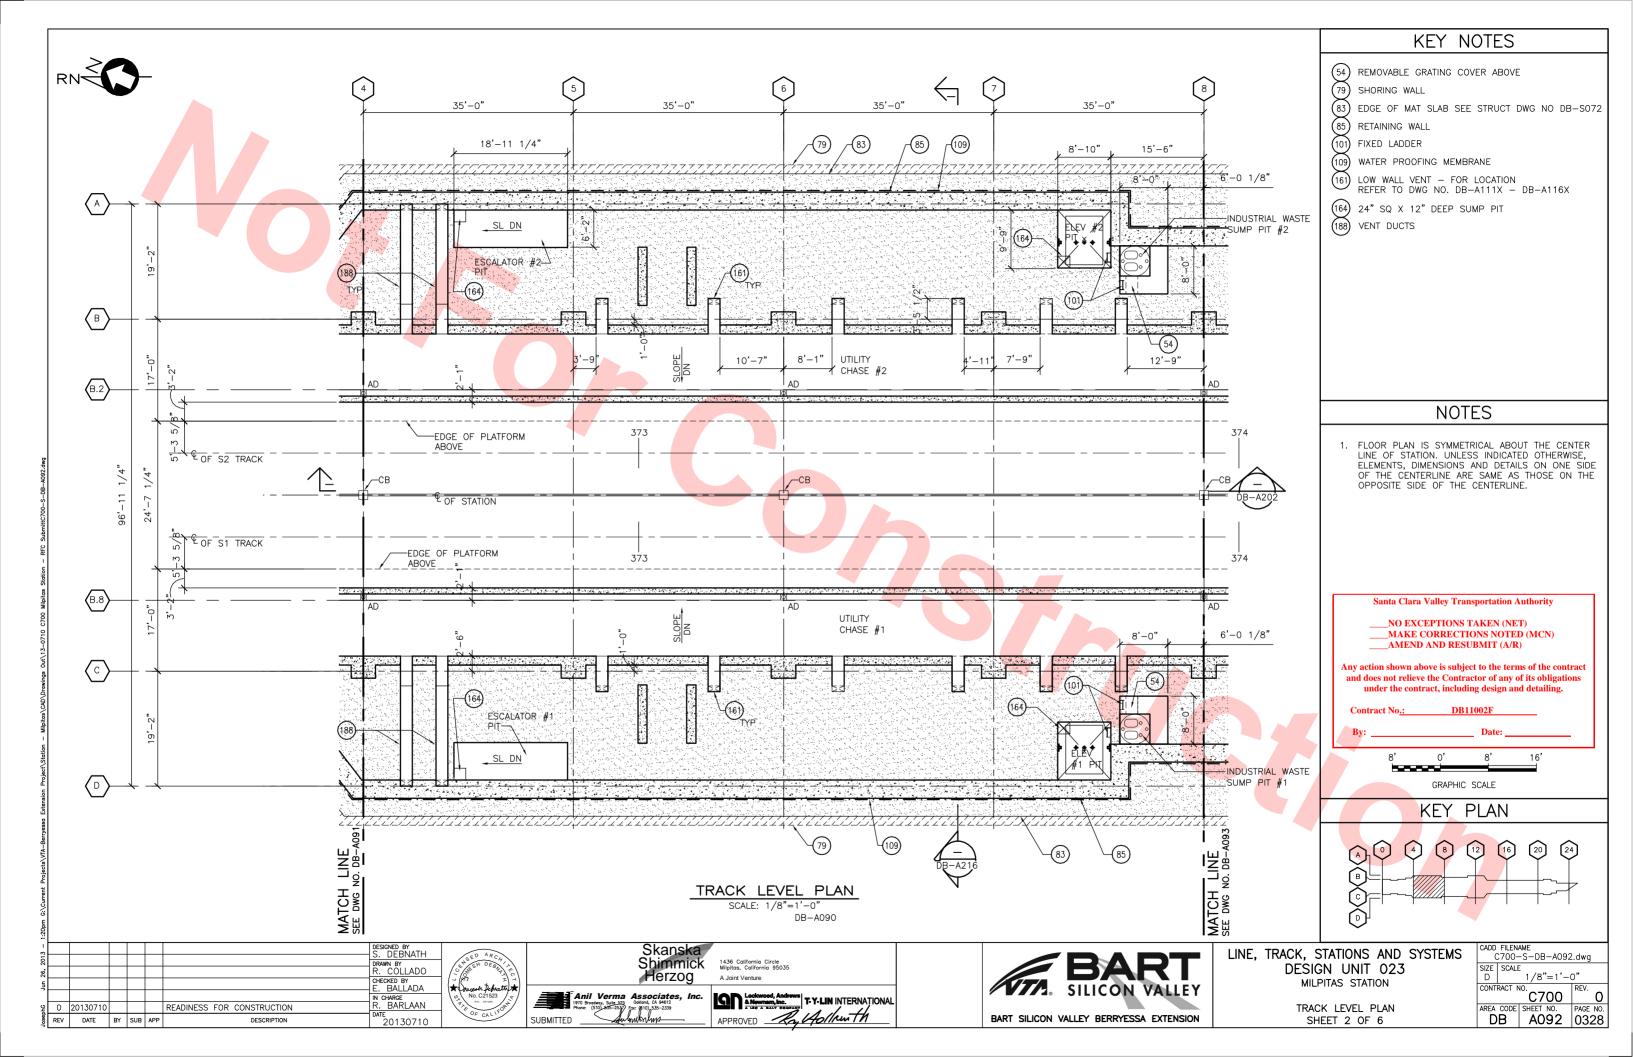

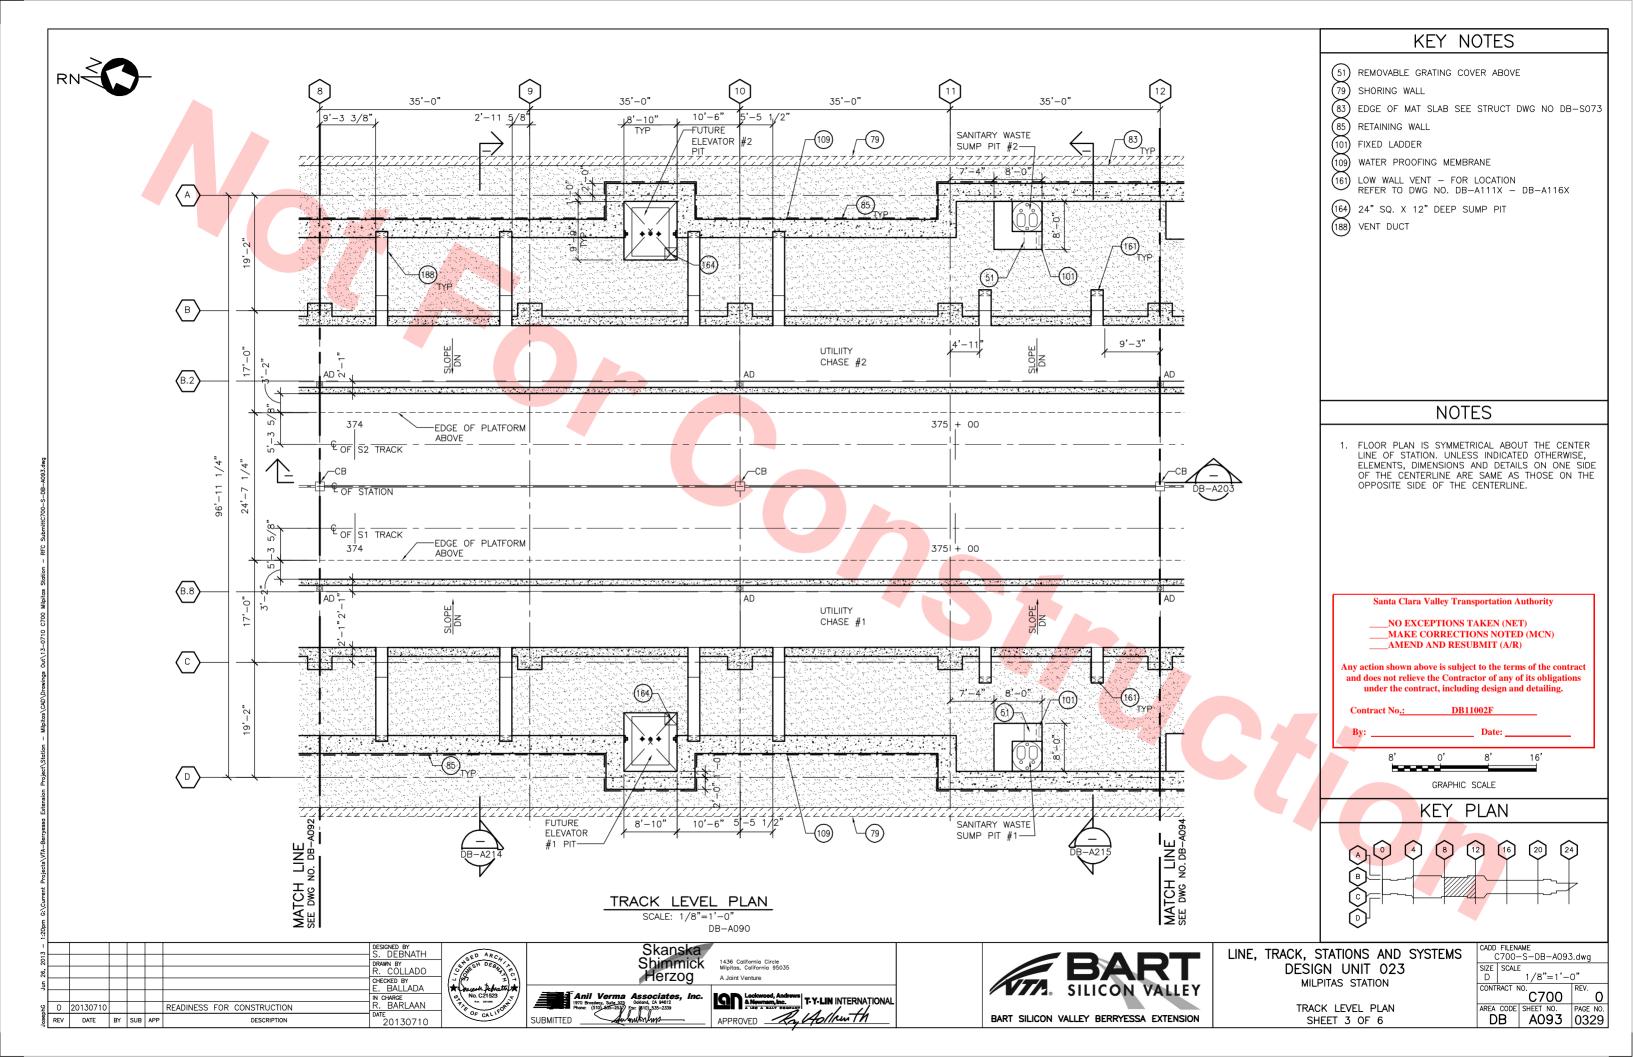

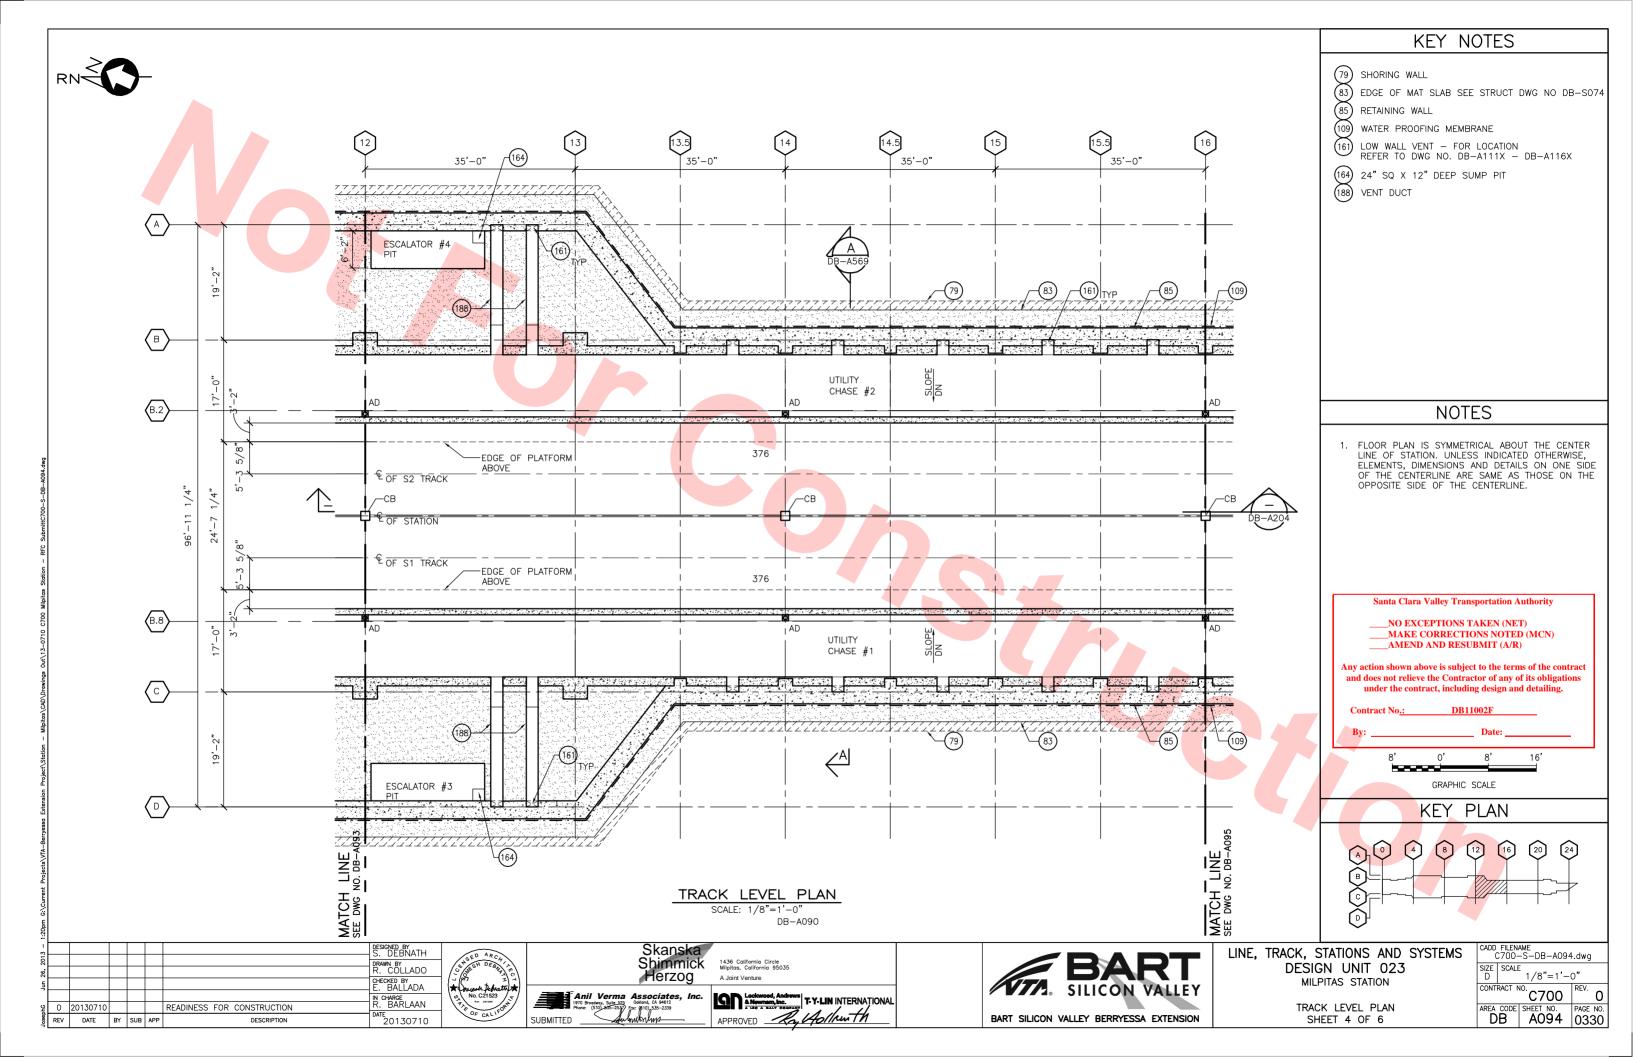

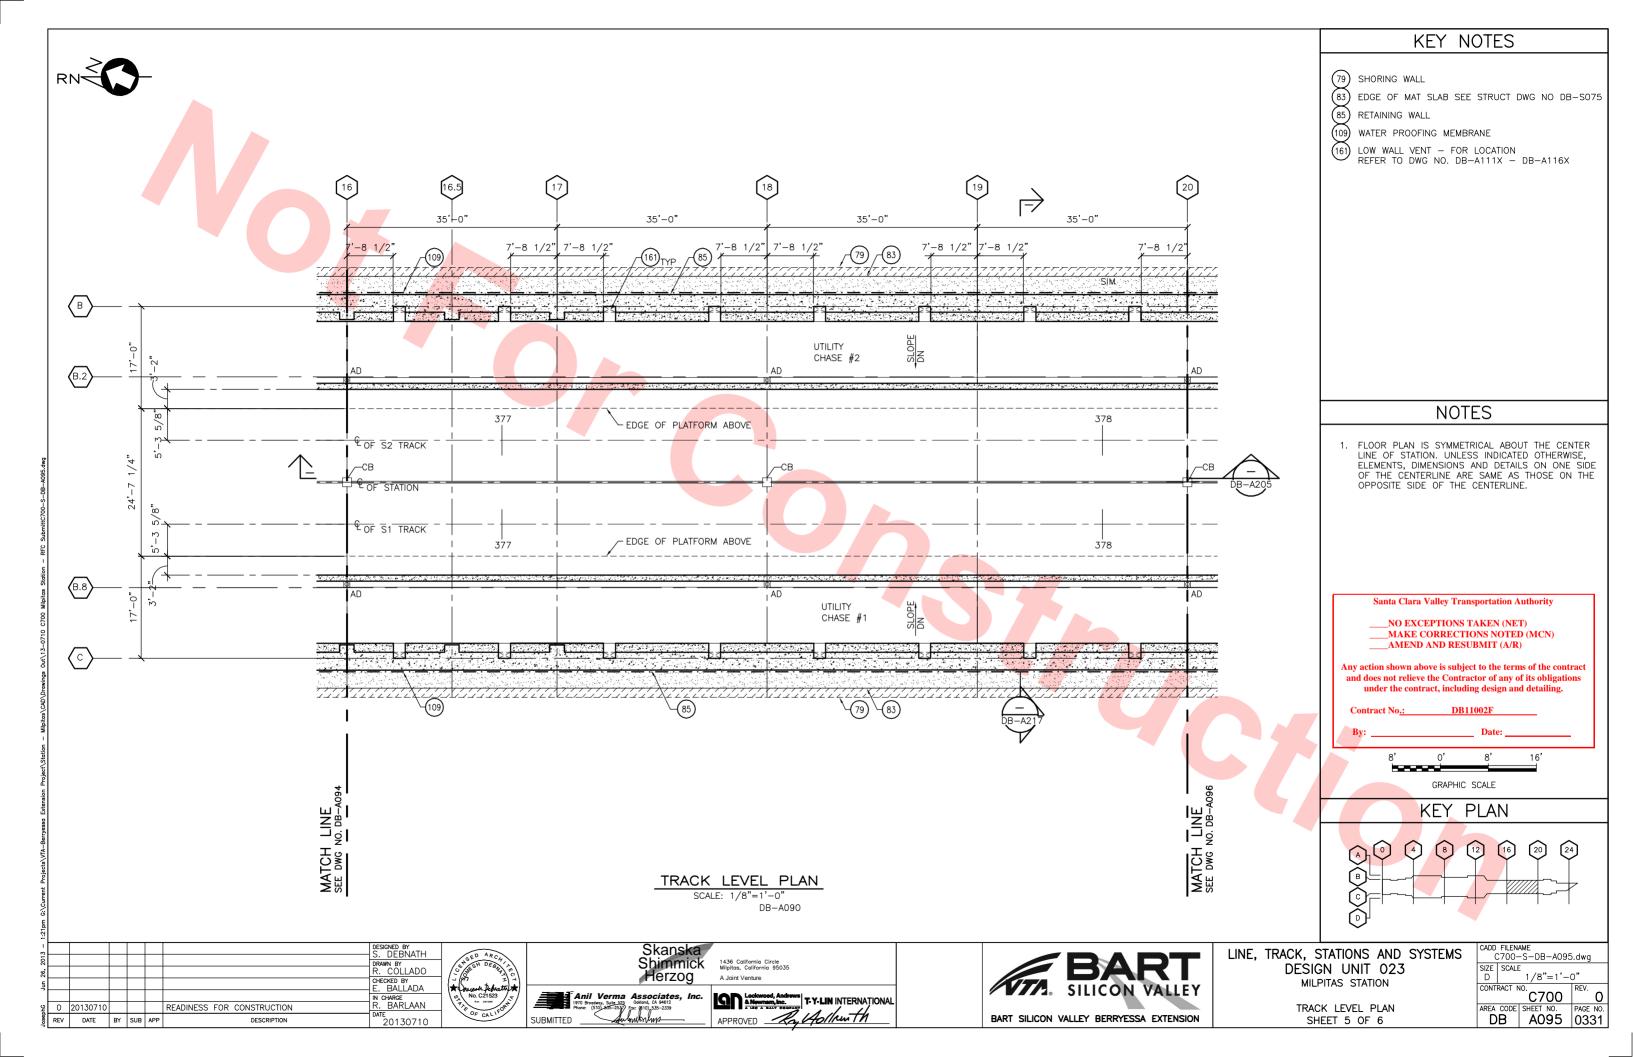

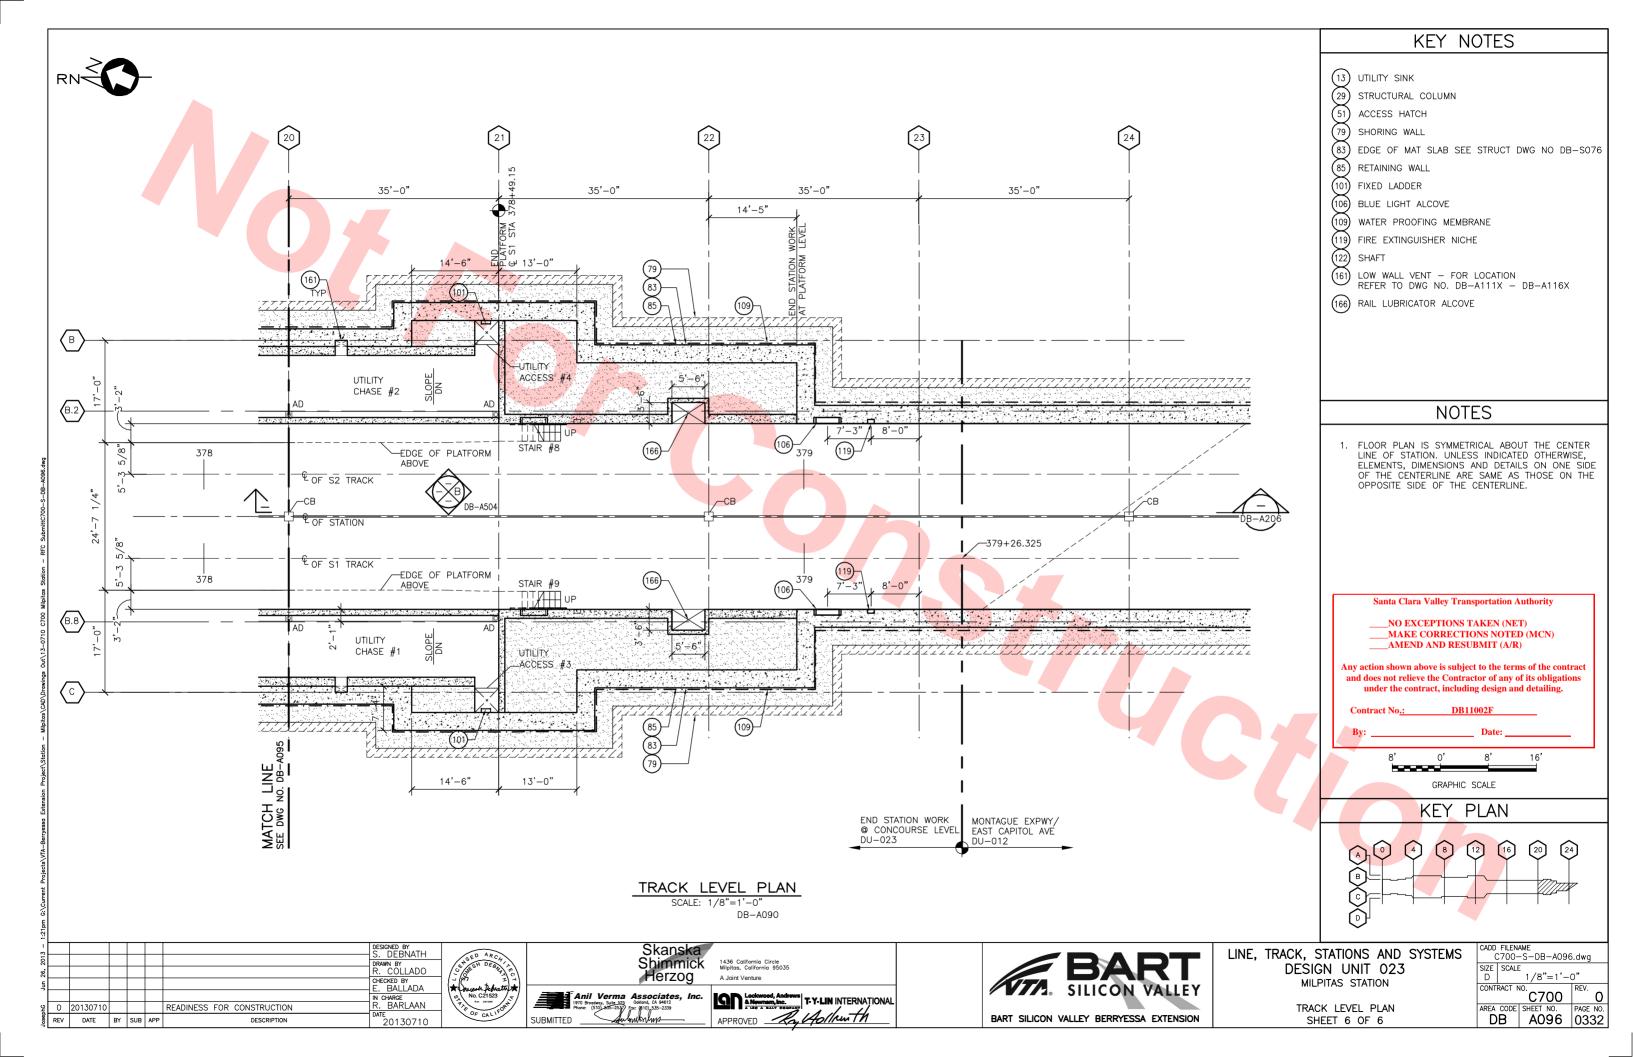




Santa Clara Valley Transportation Authority

___NO EXCEPTIONS TAKEN (NET)
___MAKE CORRECTIONS NOTED (MCN)
__AMEND AND RESUBMIT (A/R)

Any action shown above is subject to the terms of the contract and does not relieve the Contractor of any of its obligations under the contract, including design and detailing.

ontract No.: DB11002F

By: _____ Date: __

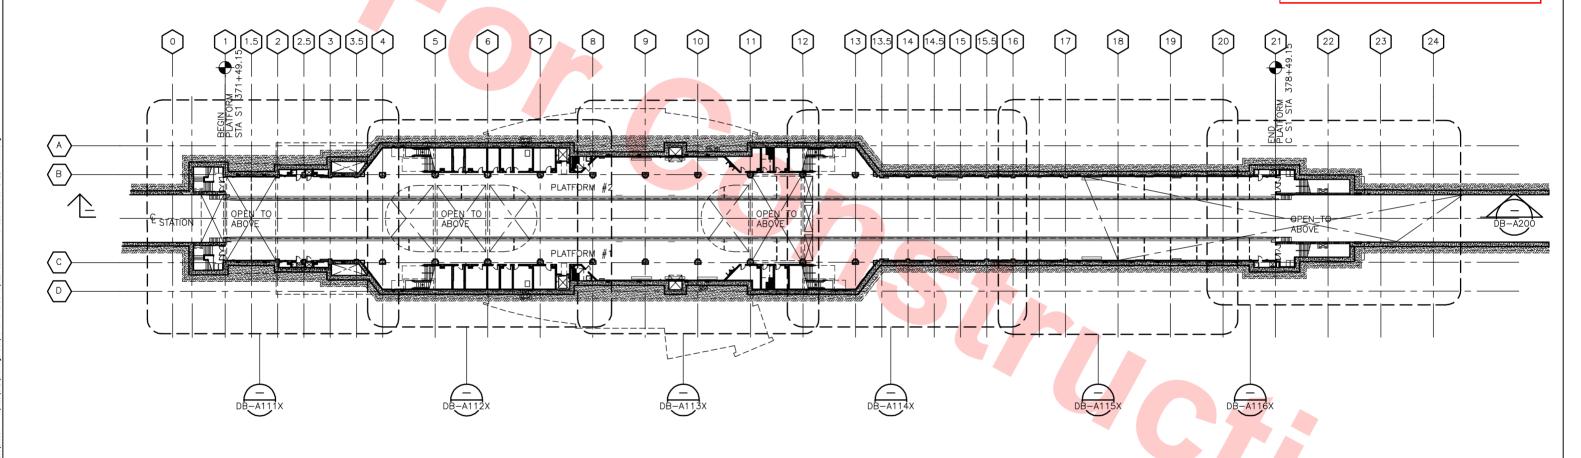


KEY PLAN - PLATFORM LEVEL

SCALE: 1/32"=1'-0"

NOTE:

FOR RETAINING WALL DRAIN LINE LOCATION, SEE DWG NOS. DB-A117 DB-A118 & DB-A119

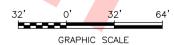


_								_
13							DESIGNED BY S. DEBNATH	
20							DRAWN BY	
56,							R. COLLADO	L
5							CHECKED BY E. BALLADA	1
1	0	20130710				READINESS FOR CONSTRUCTION	IN CHARGE	1
ž						REPLACES C700-S-DB-A100, REV. P	R. BARLAAN	
Josep	REV	DATE	BY	SUB	APP	DESCRIPTION	20130710	



SUBMITTED

Skanska	1436 California Circle
Shimmick	Milpitas, California 950
Herzog	A Joint Venture
Anil Verma Associates, Inc. 70 Broodway, Suite 255 Ookland, CA 94612 none: (510) 505-2337 Fax: (510) 535-2339	Lockwood, Ar & Nownam, in

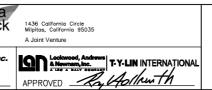




LINE, TRACK, STATIONS AND SYSTEMS


DESIGN UNIT 023


MILPITAS STATION


KEY PLAN PLATFORM LEVEL


//S		FILEN. 700-	AME S-DB-A110	X.dwg
	SIZE D	SCALE	1/32"=1'-	-0"
	CONT	RACT N	^{10.} C700	REV. O
	AREA	CODE	SHEET NO.	PAGE NO.
		ט	71107	0333

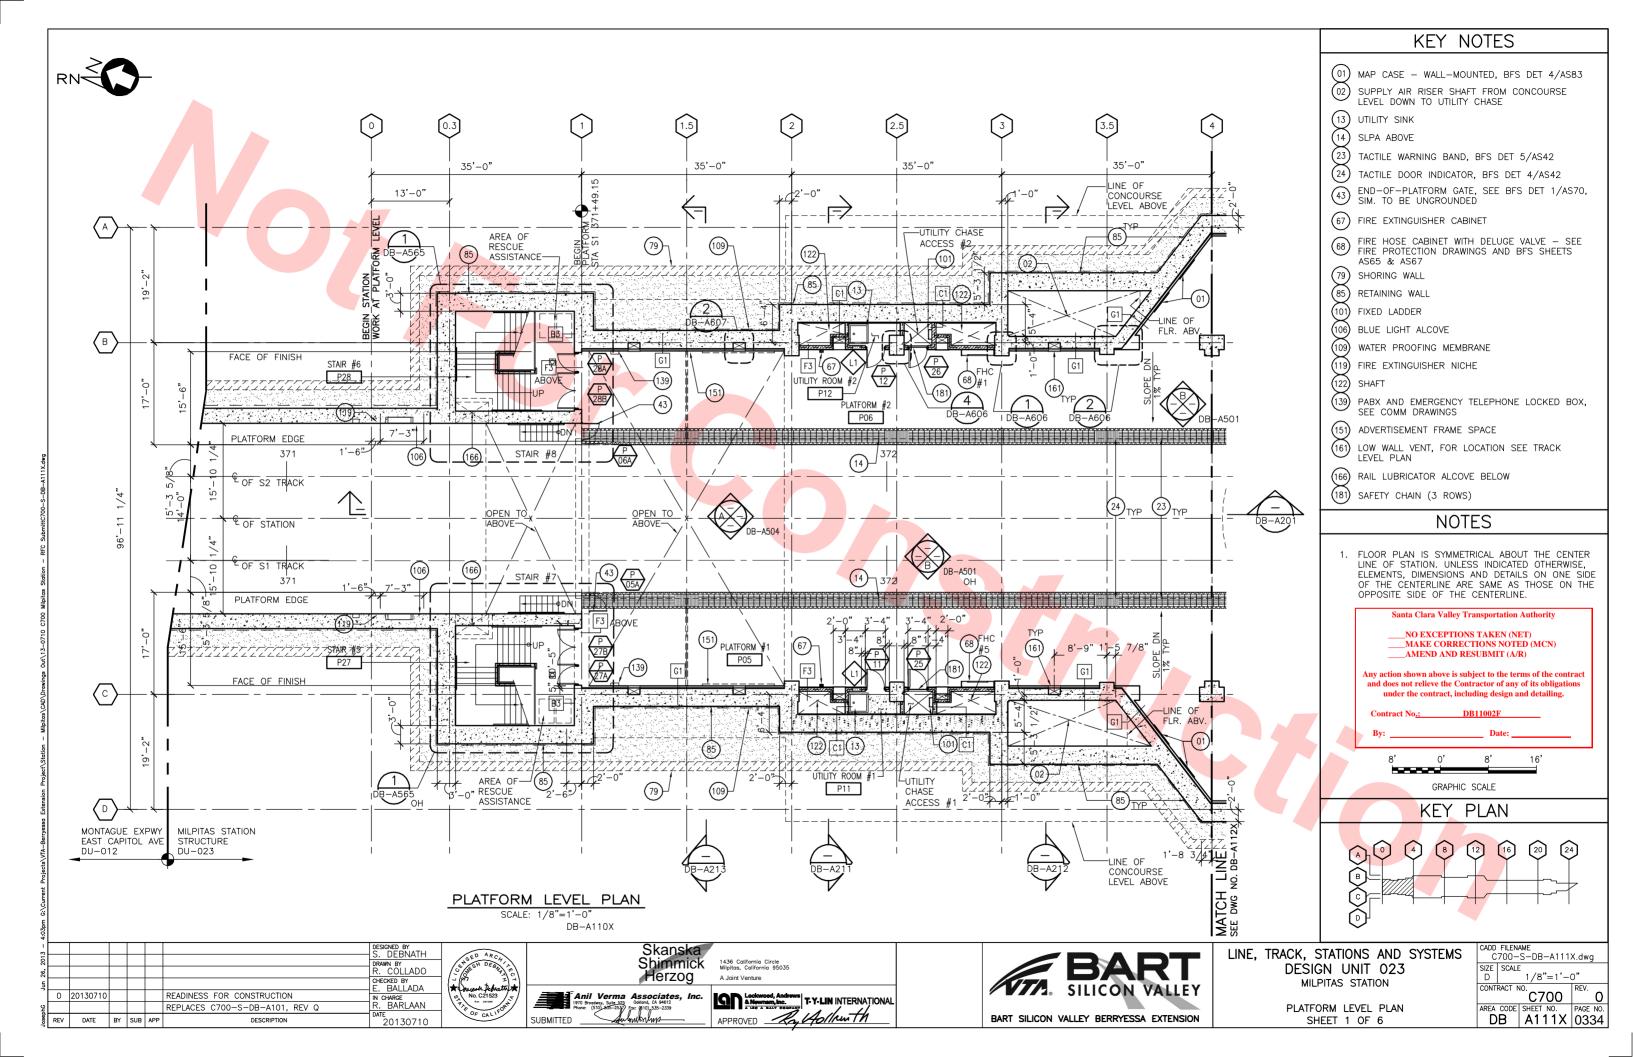


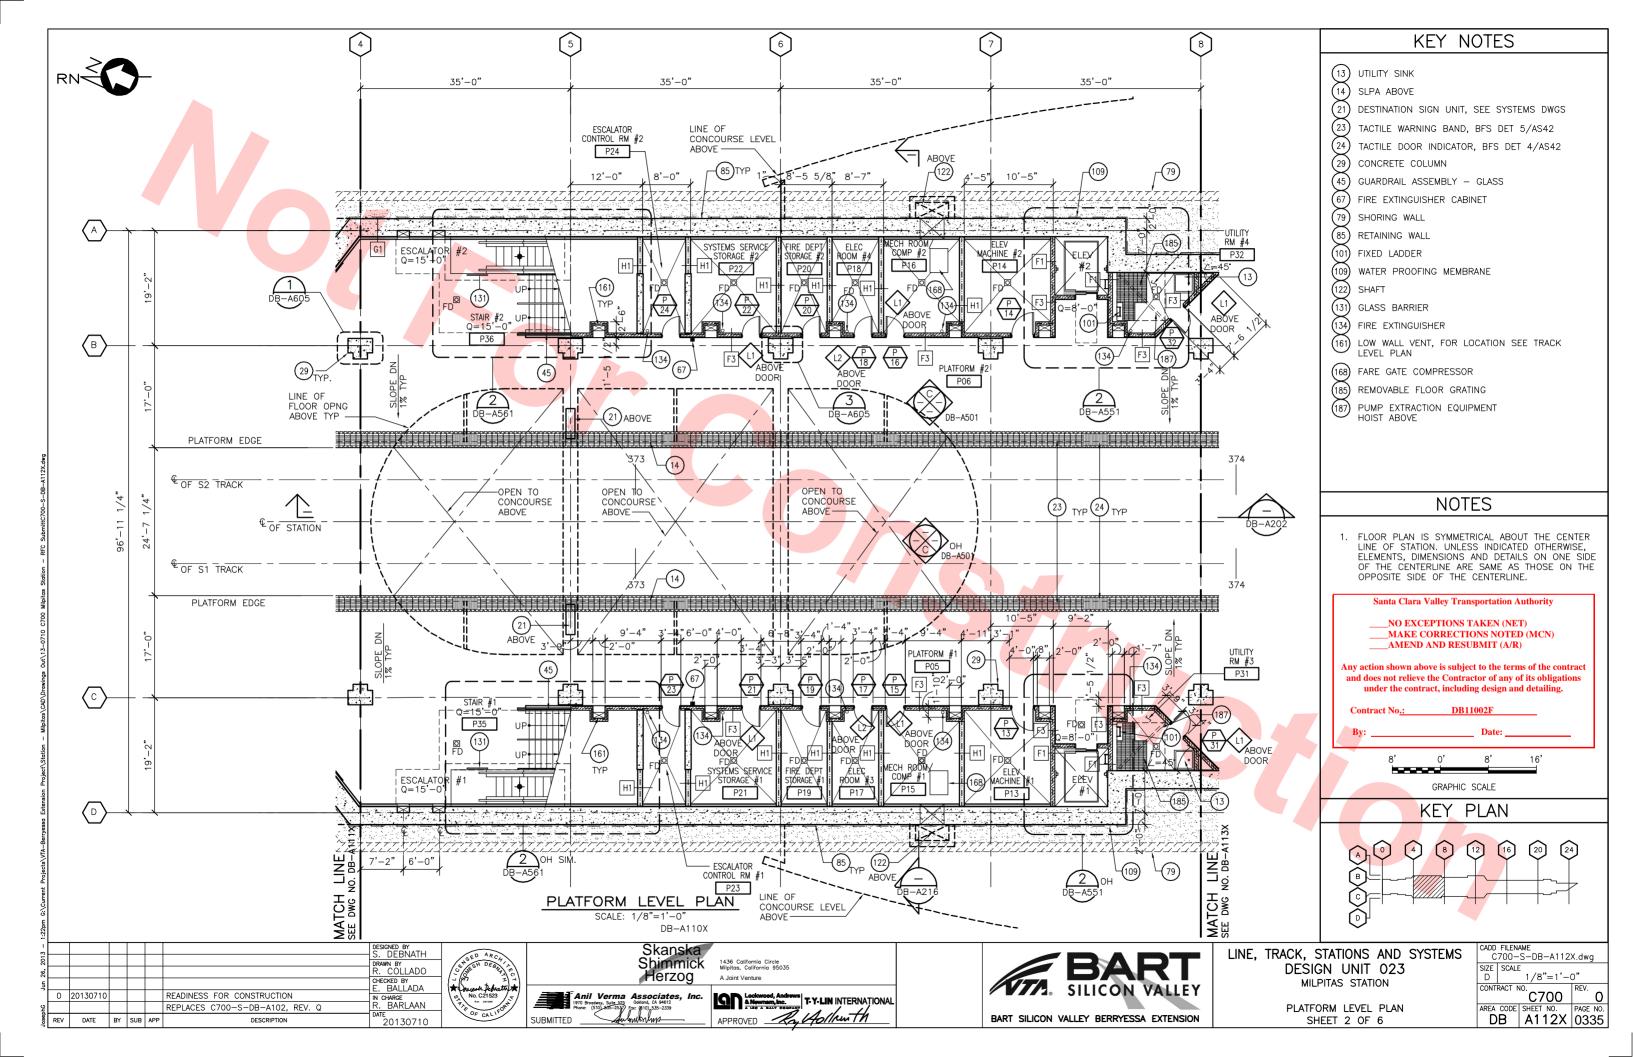


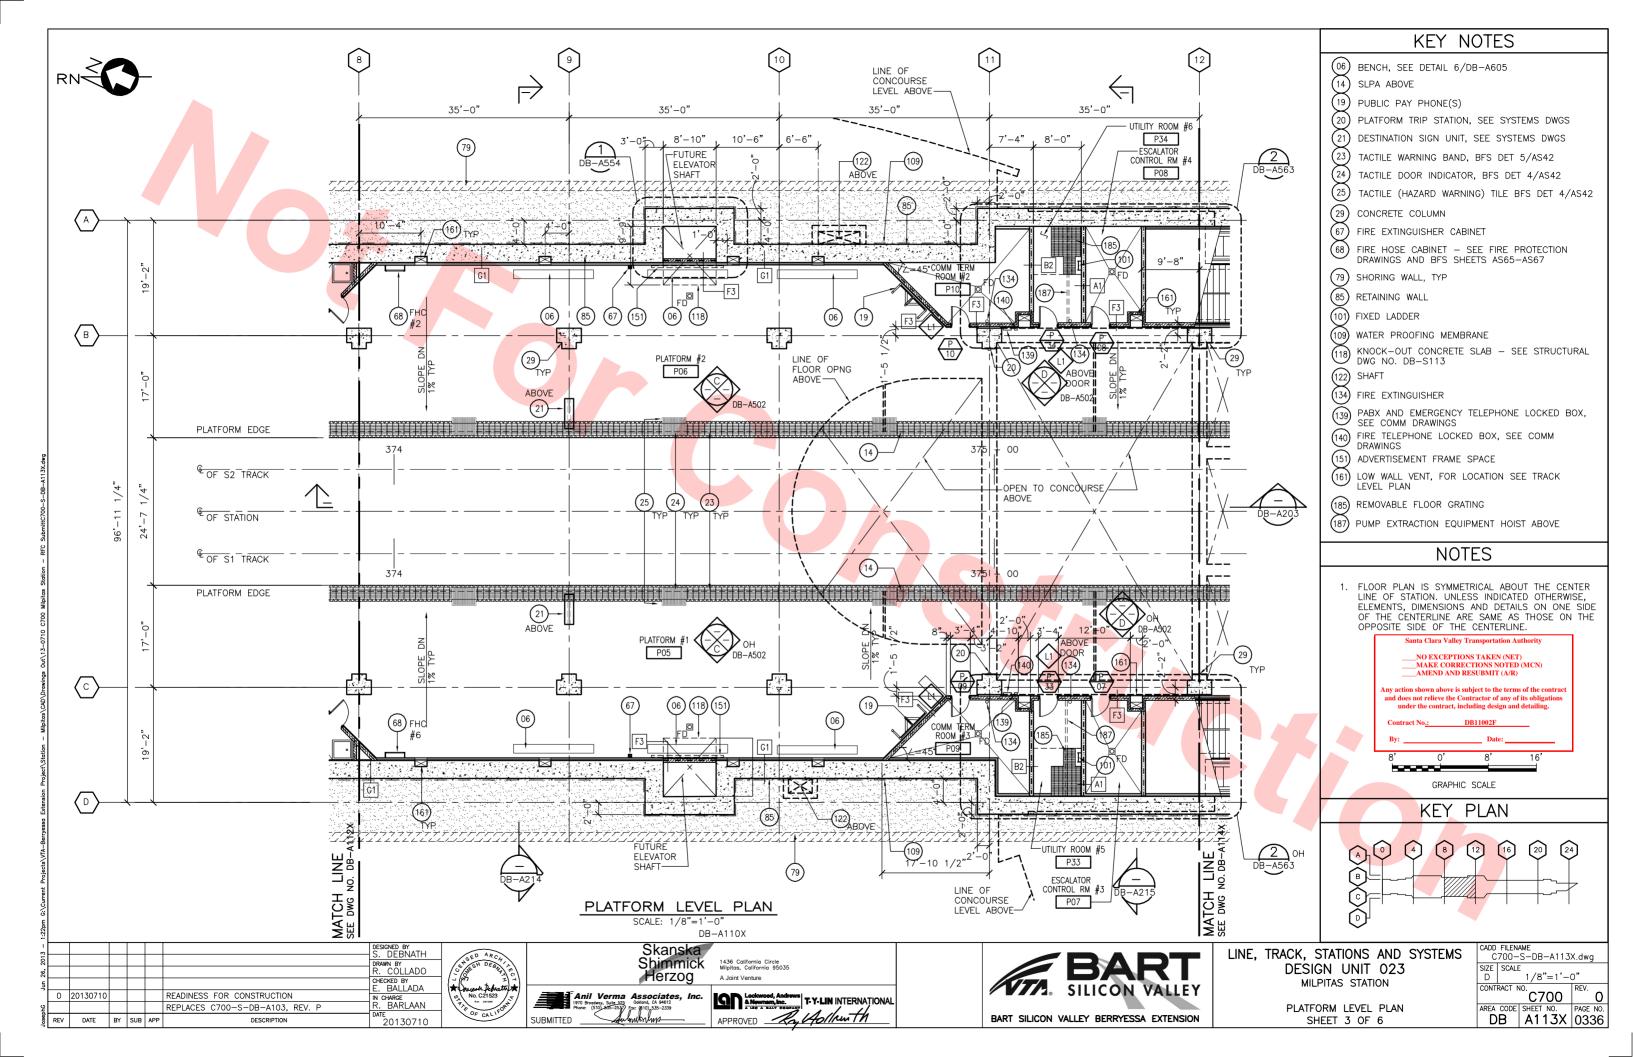


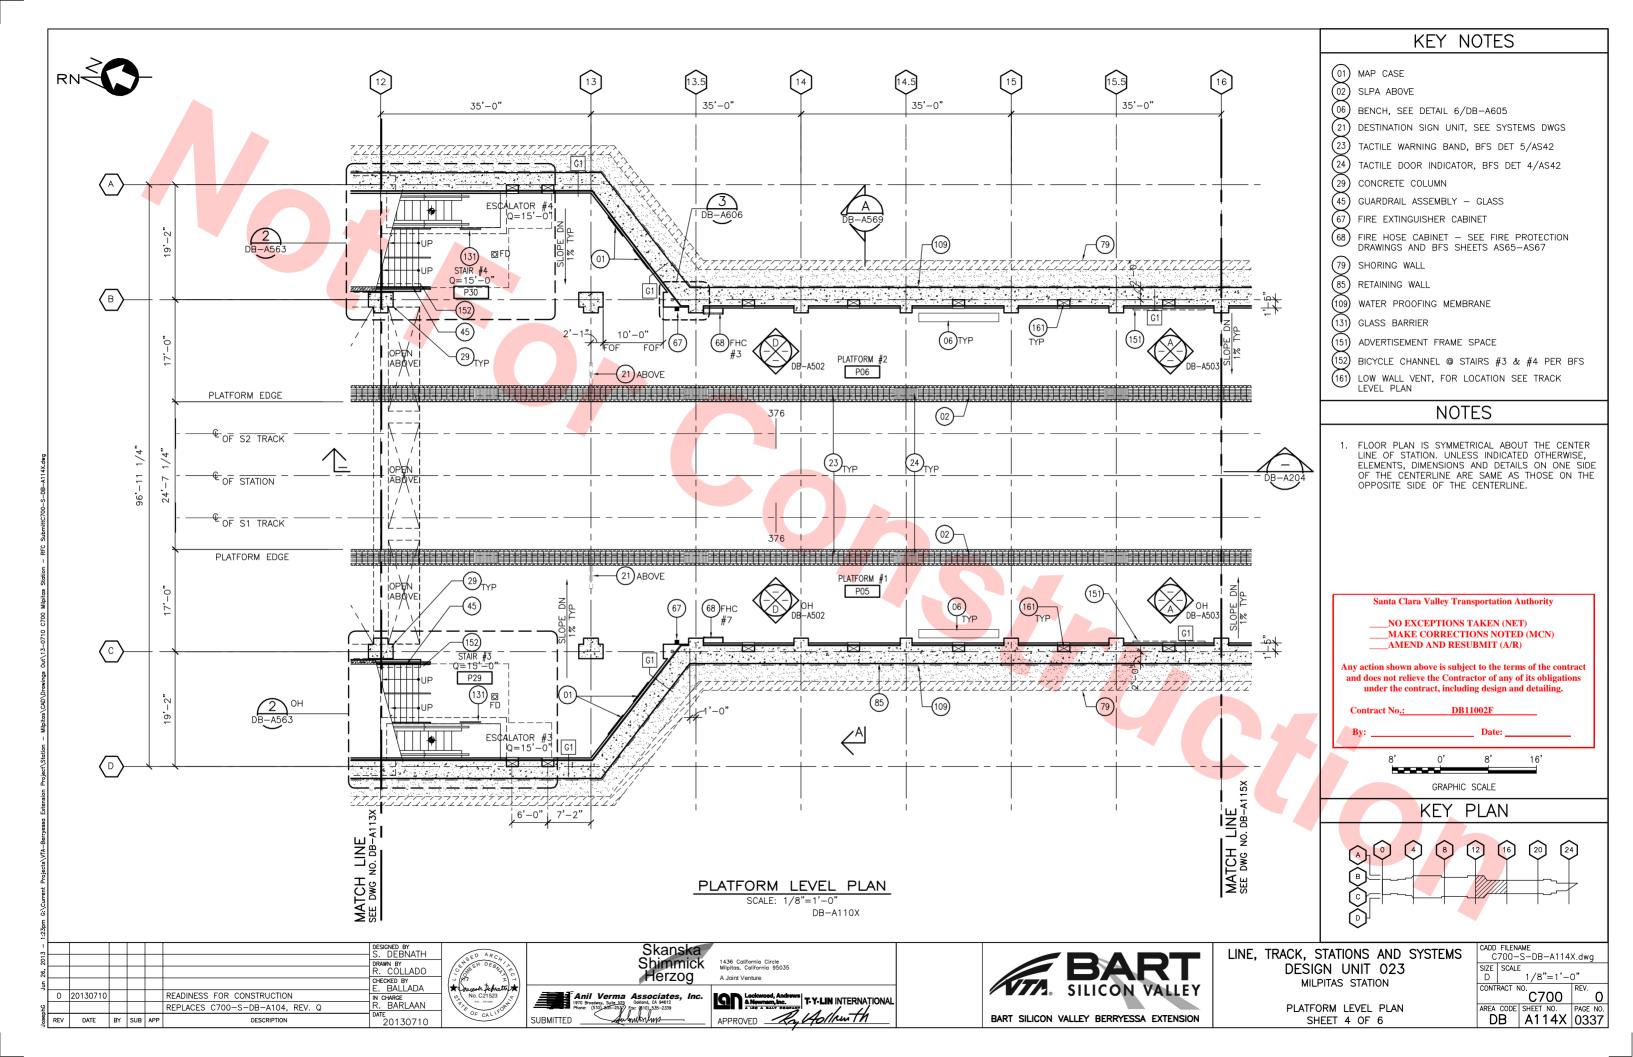


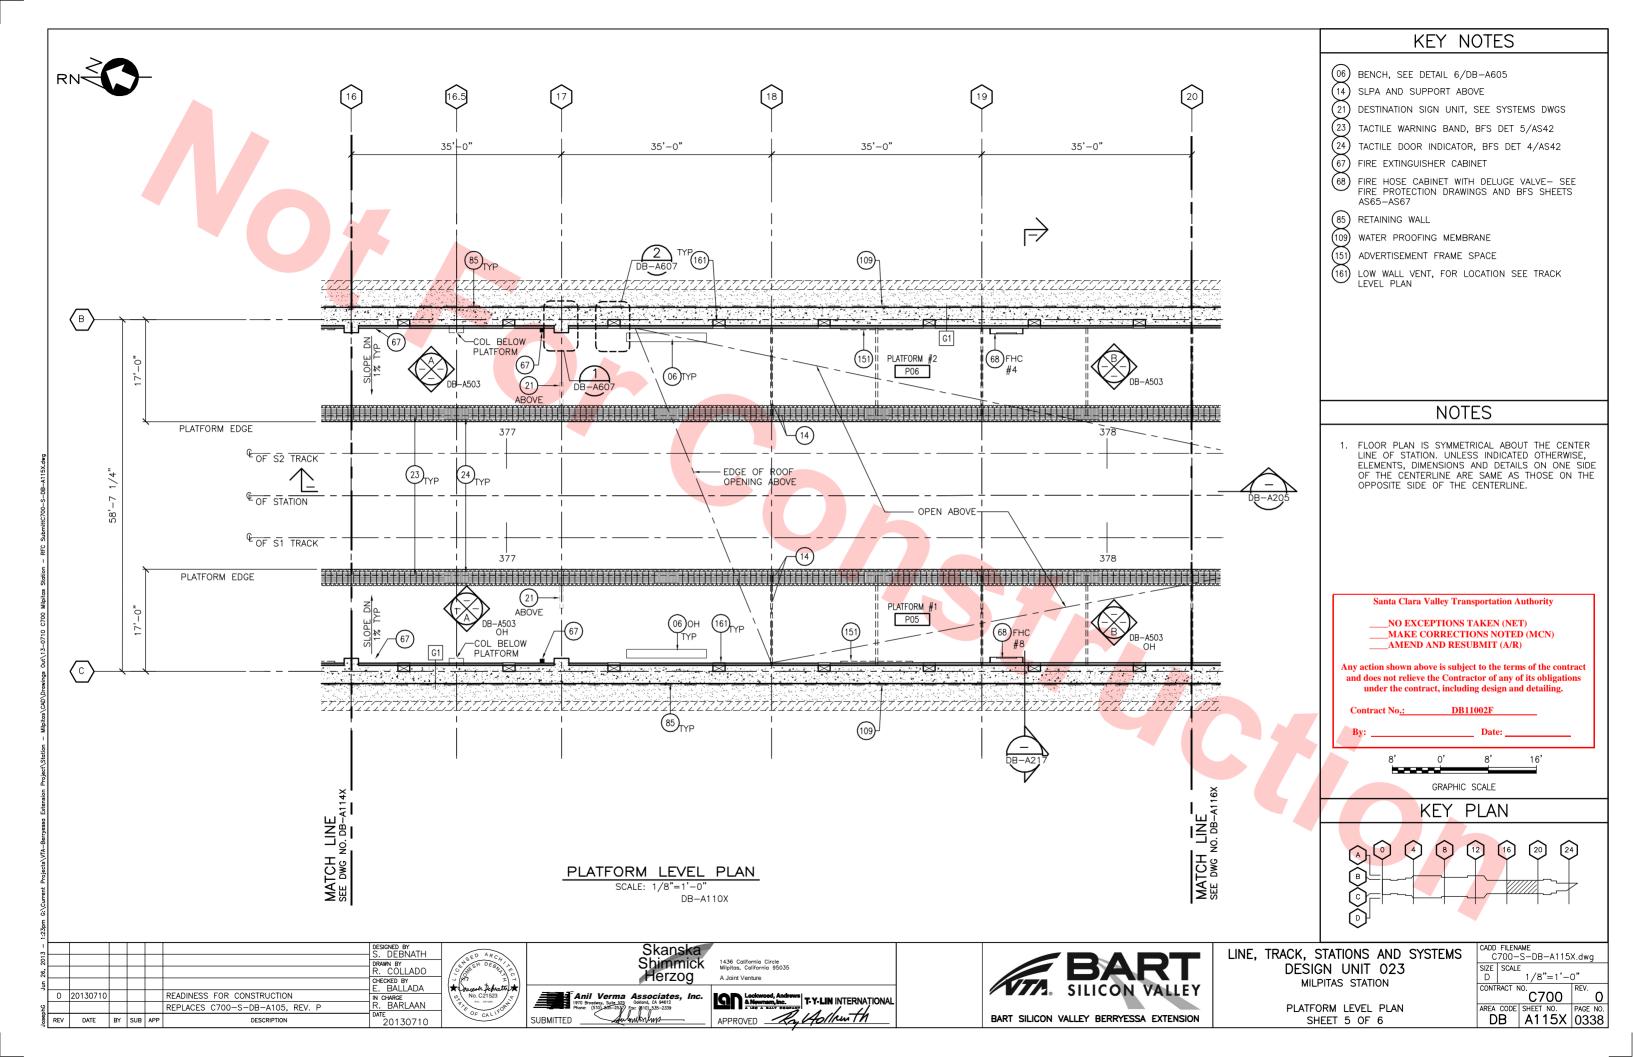

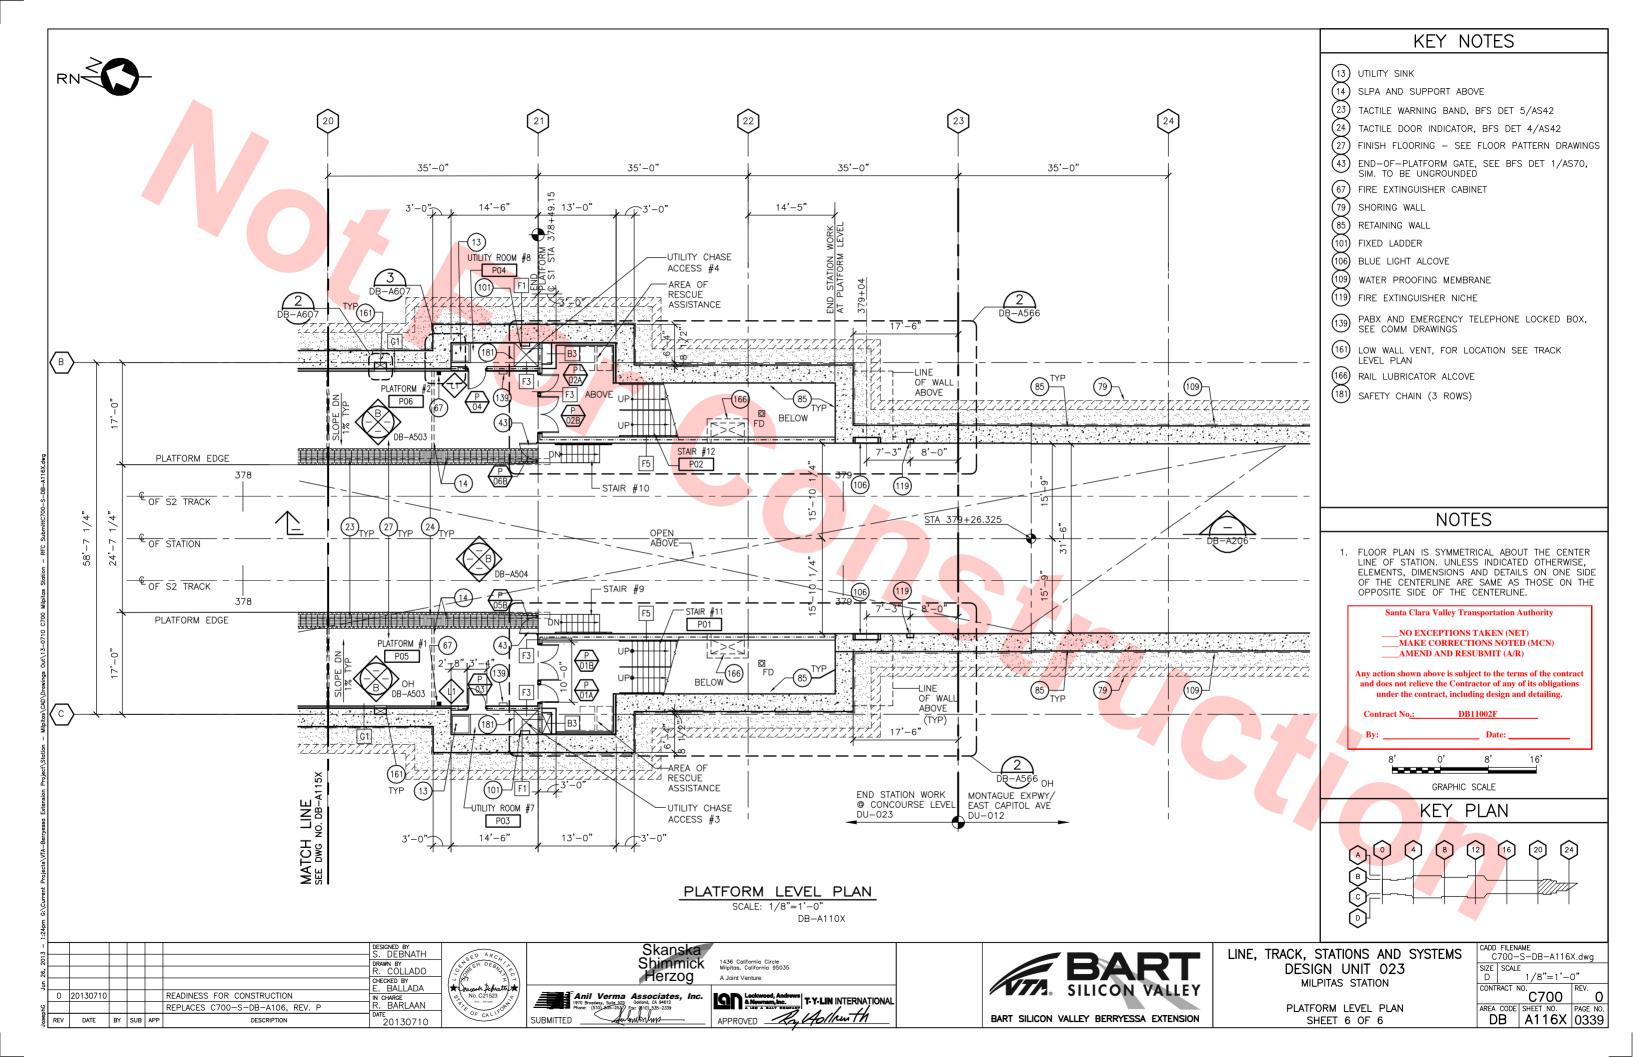


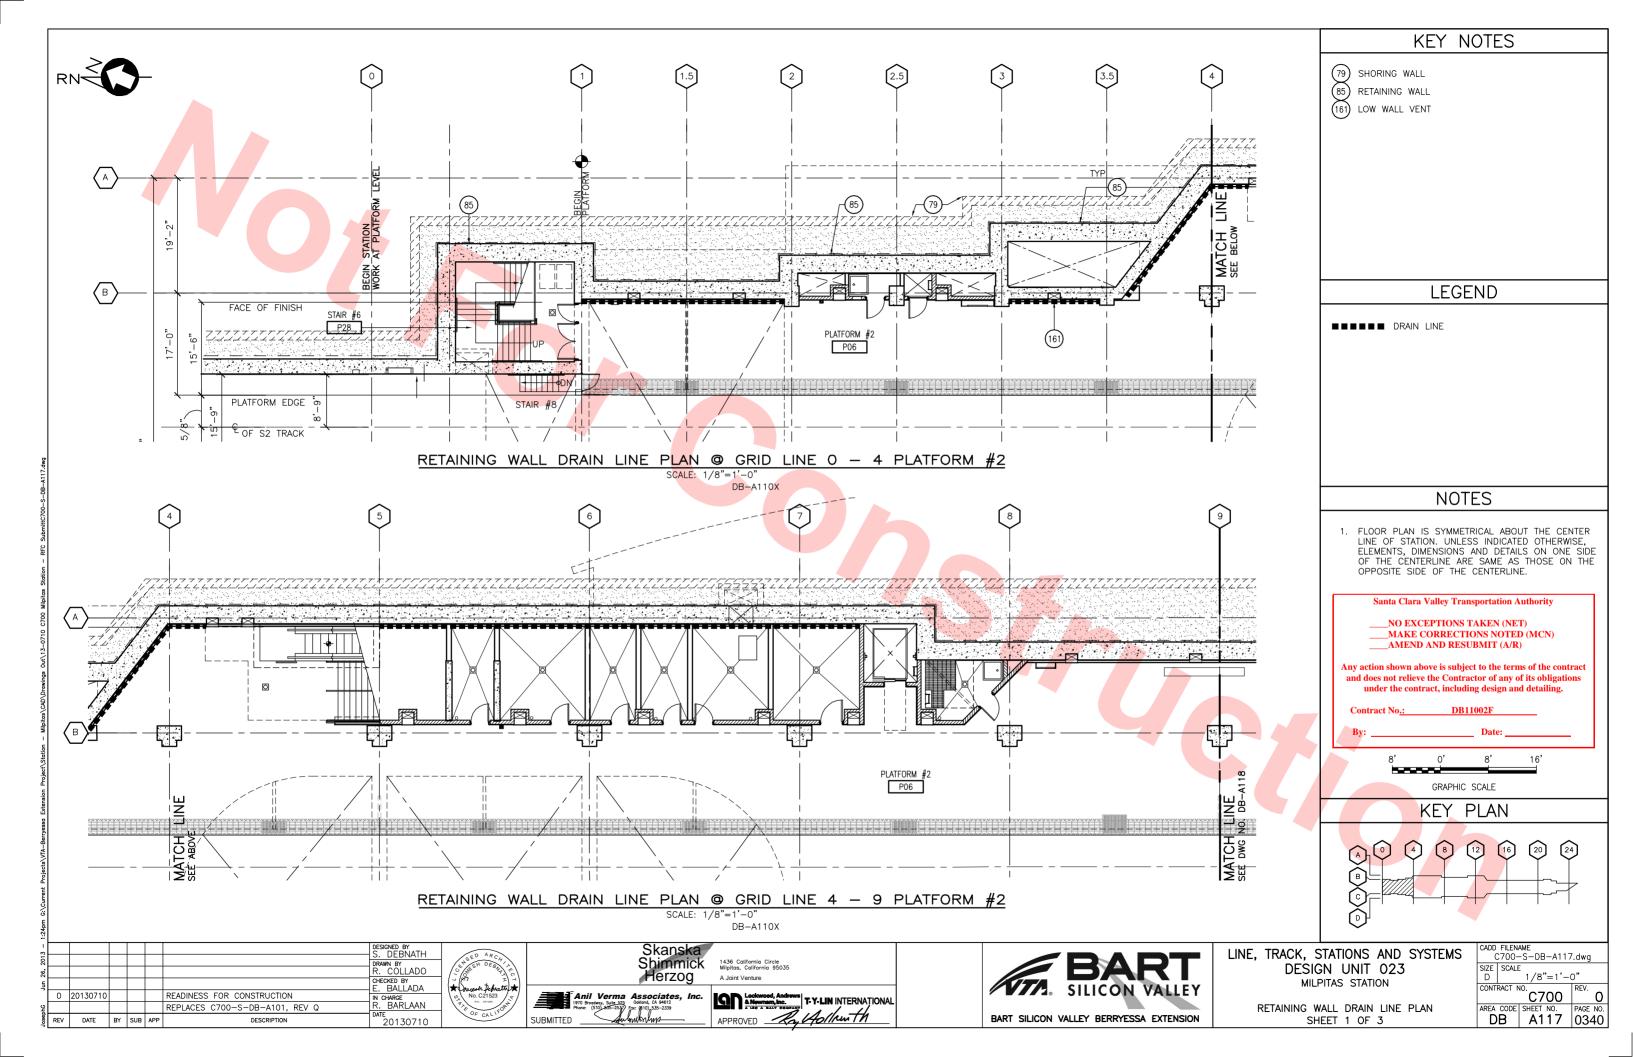

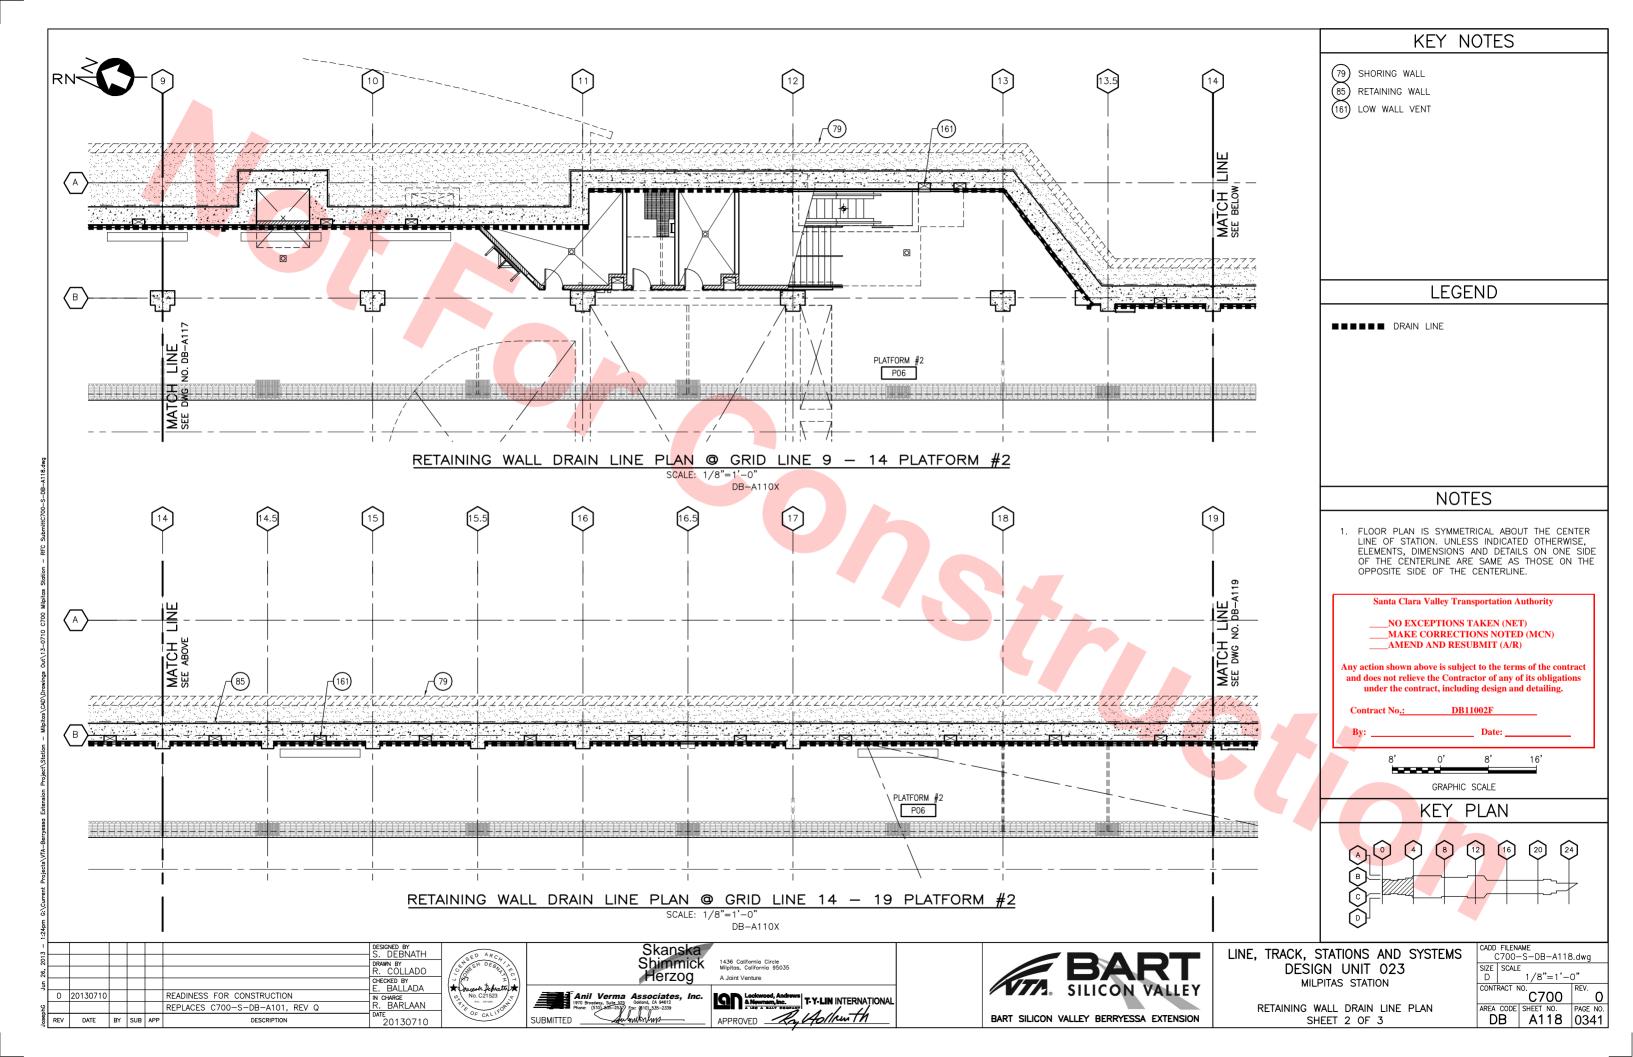

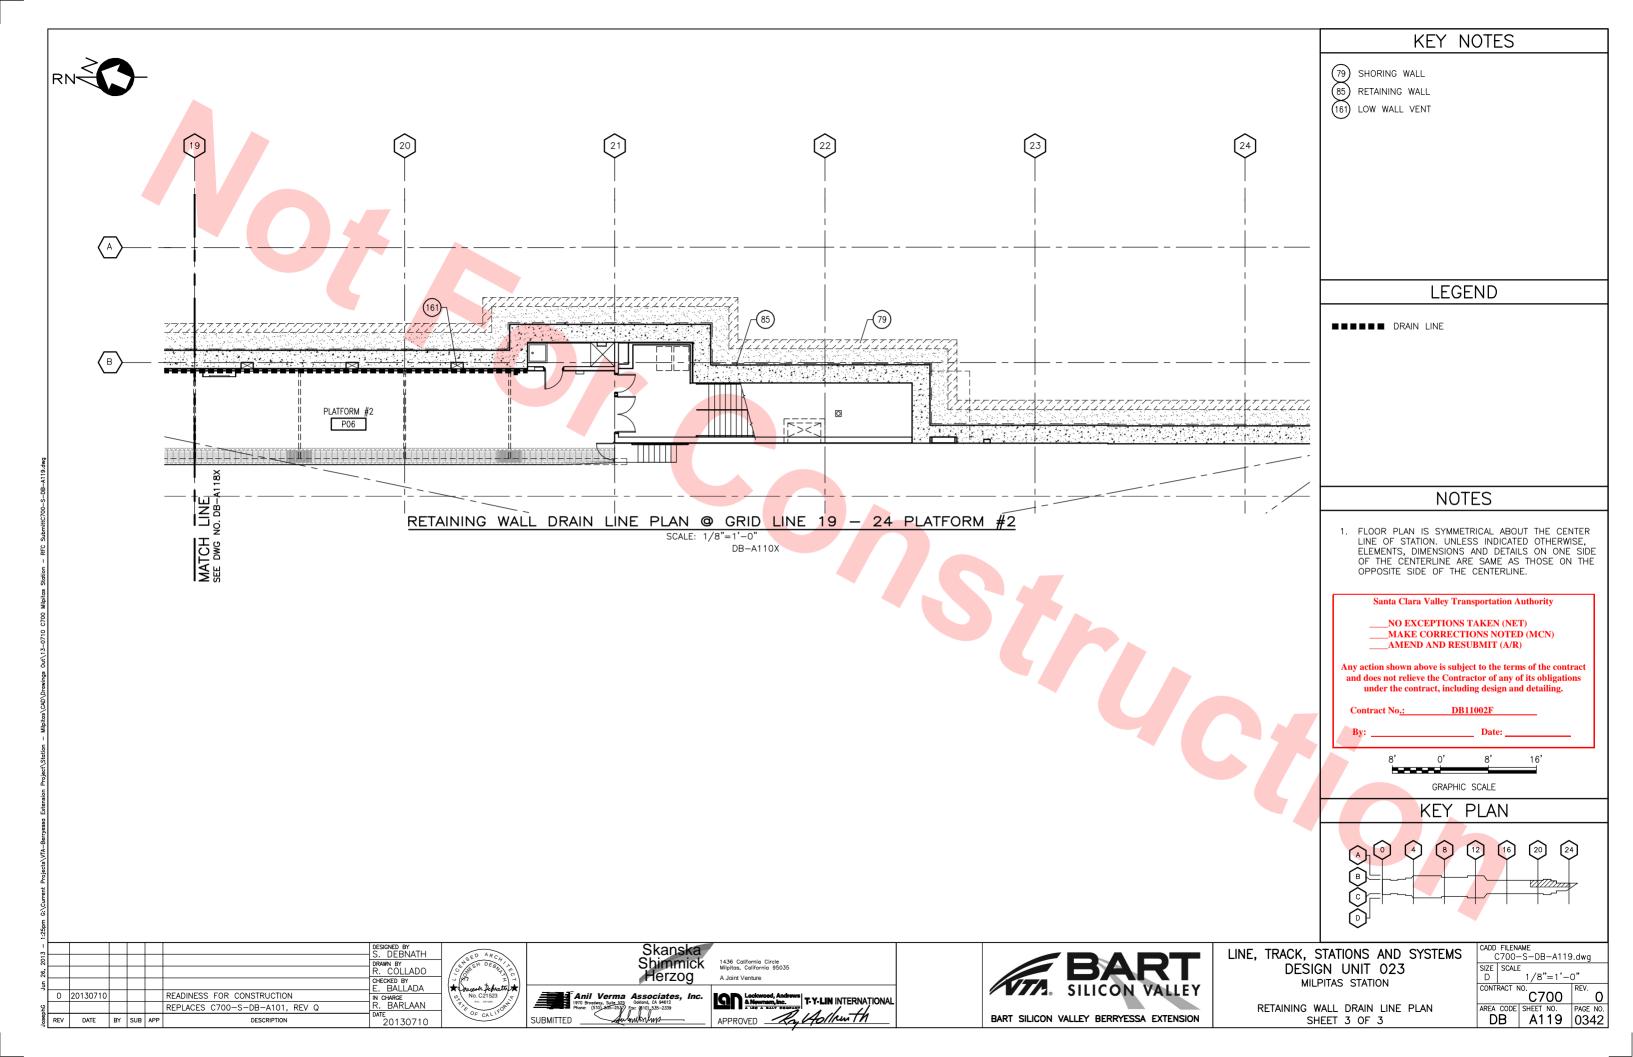



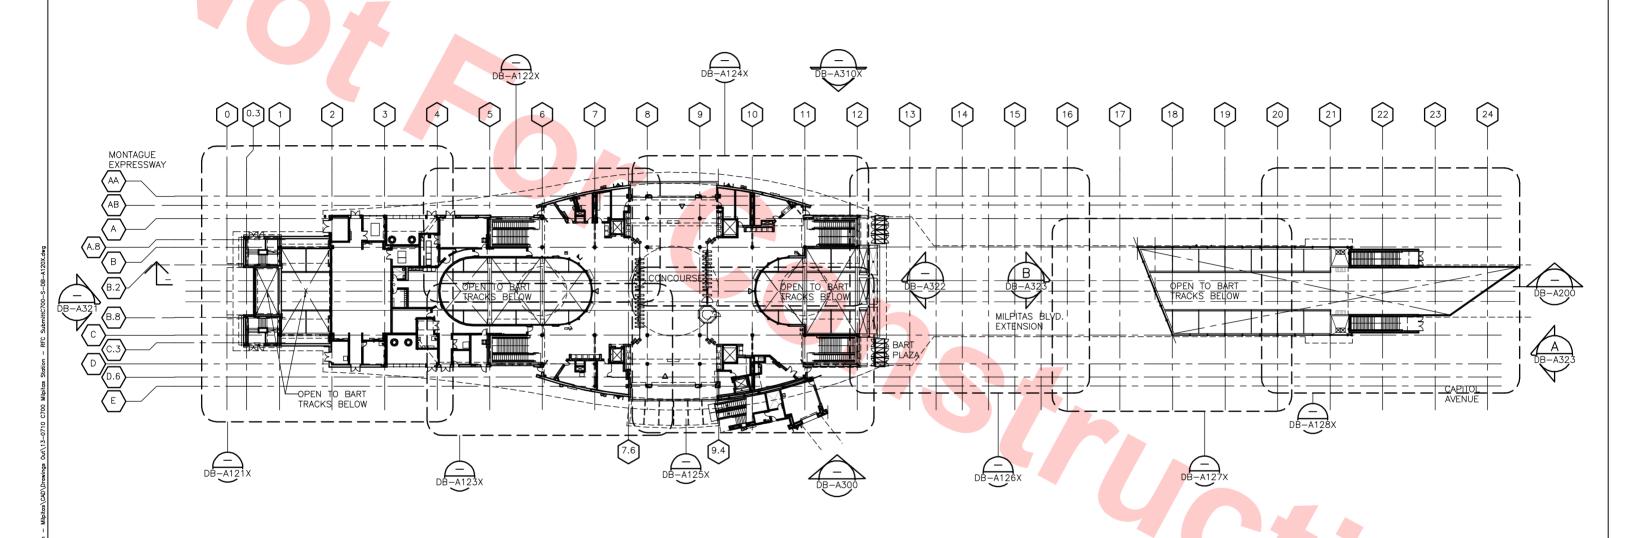


KEY PLAN - CONCOURSE LEVEL SCALE: 1/32"=1'-0"

DB-A050

Santa Clara Valley Transportation Authority

___NO EXCEPTIONS TAKEN (NET)
__MAKE CORRECTIONS NOTED (MCN)
__AMEND AND RESUBMIT (A/R)


Any action shown above is subject to the terms of the contract and does not relieve the Contractor of any of its obligations under the contract, including design and detailing.

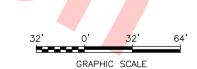

						DESIGNED BY S. DEBNATH
						DRAWN BY
						R. COLLADO
						CHECKED BY E. BALLADA
0	20130710				READINESS FOR CONSTRUCTION	IN CHARGE
					REPLACES C700-S-DB-A110, REV.P	R. BARLAAN
REV	DATE	BY	SUB	APP	DESCRIPTION	DATE 20130710





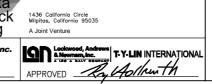





LINE, TRACK, STATIONS AND SYSTEM DESIGN UNIT 023 MILPITAS STATION

KEY PLAN	
CONCOURSE LEVEL	

EMS		FILEN 700-		-A120	X.dwg	,
	SIZE D	SCALE		"=1'-	0"	
	CONT	RACT N	^{10.} C7	00	REV.	(
	AREA	CODE	SHEET	NO.	PAGE	١
	D	В	A12	20X	034	4

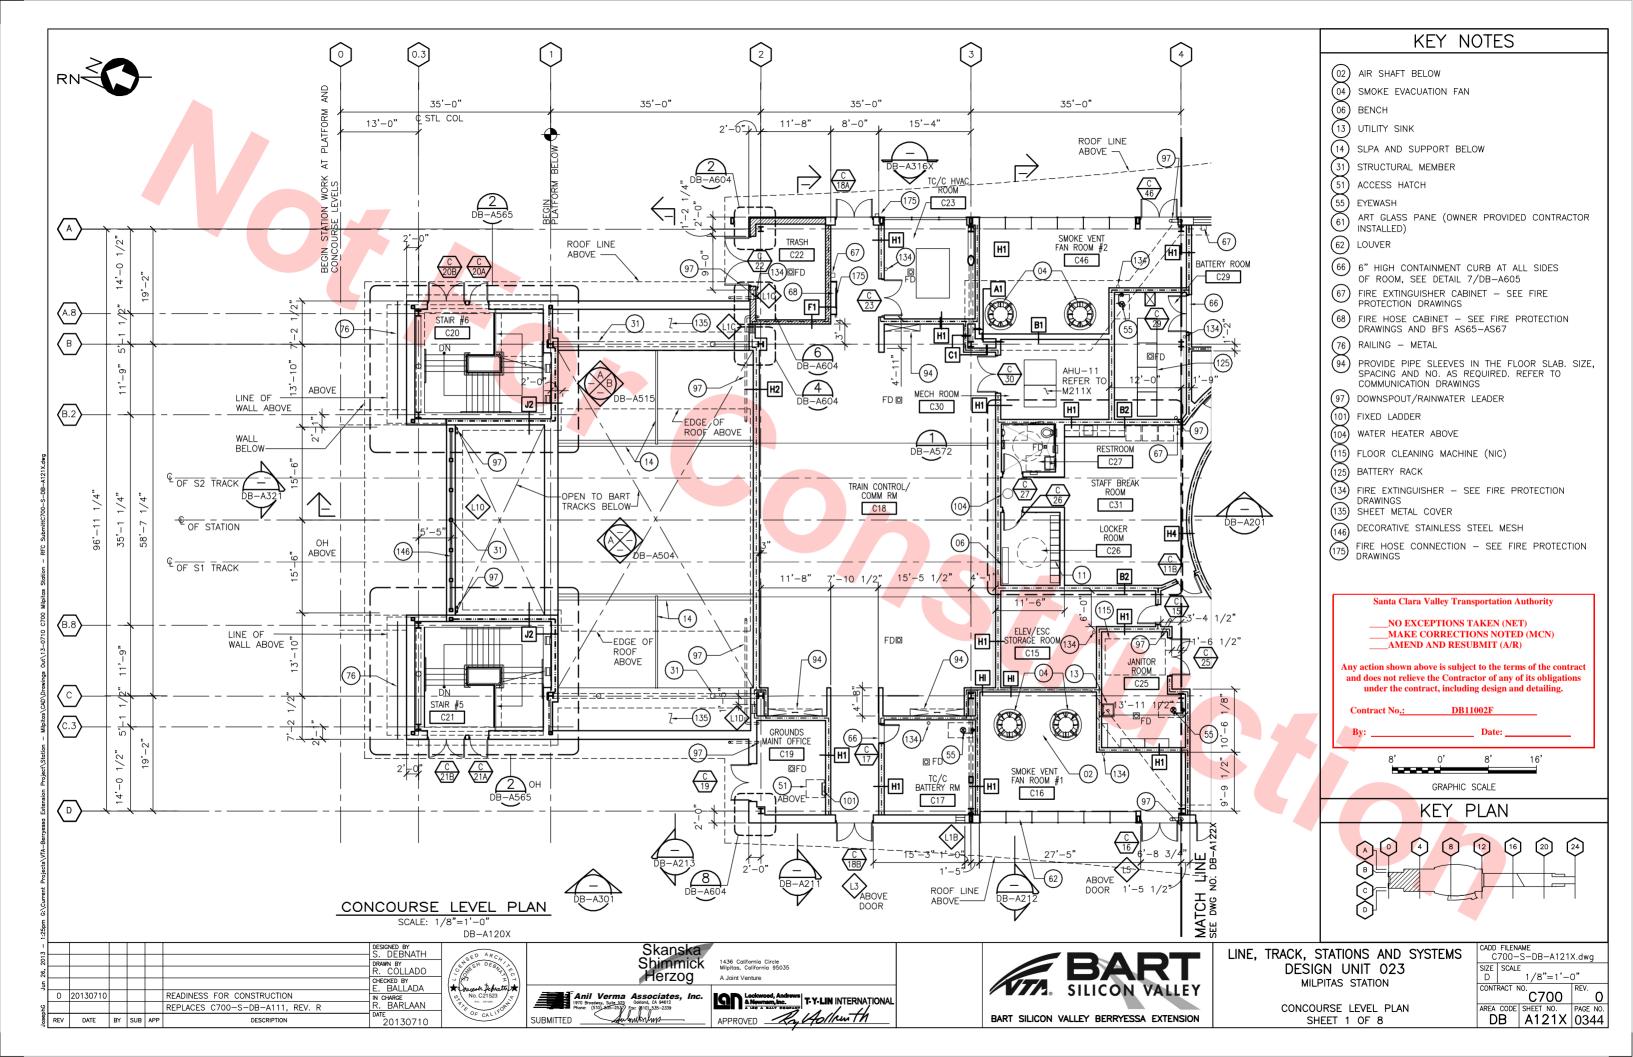

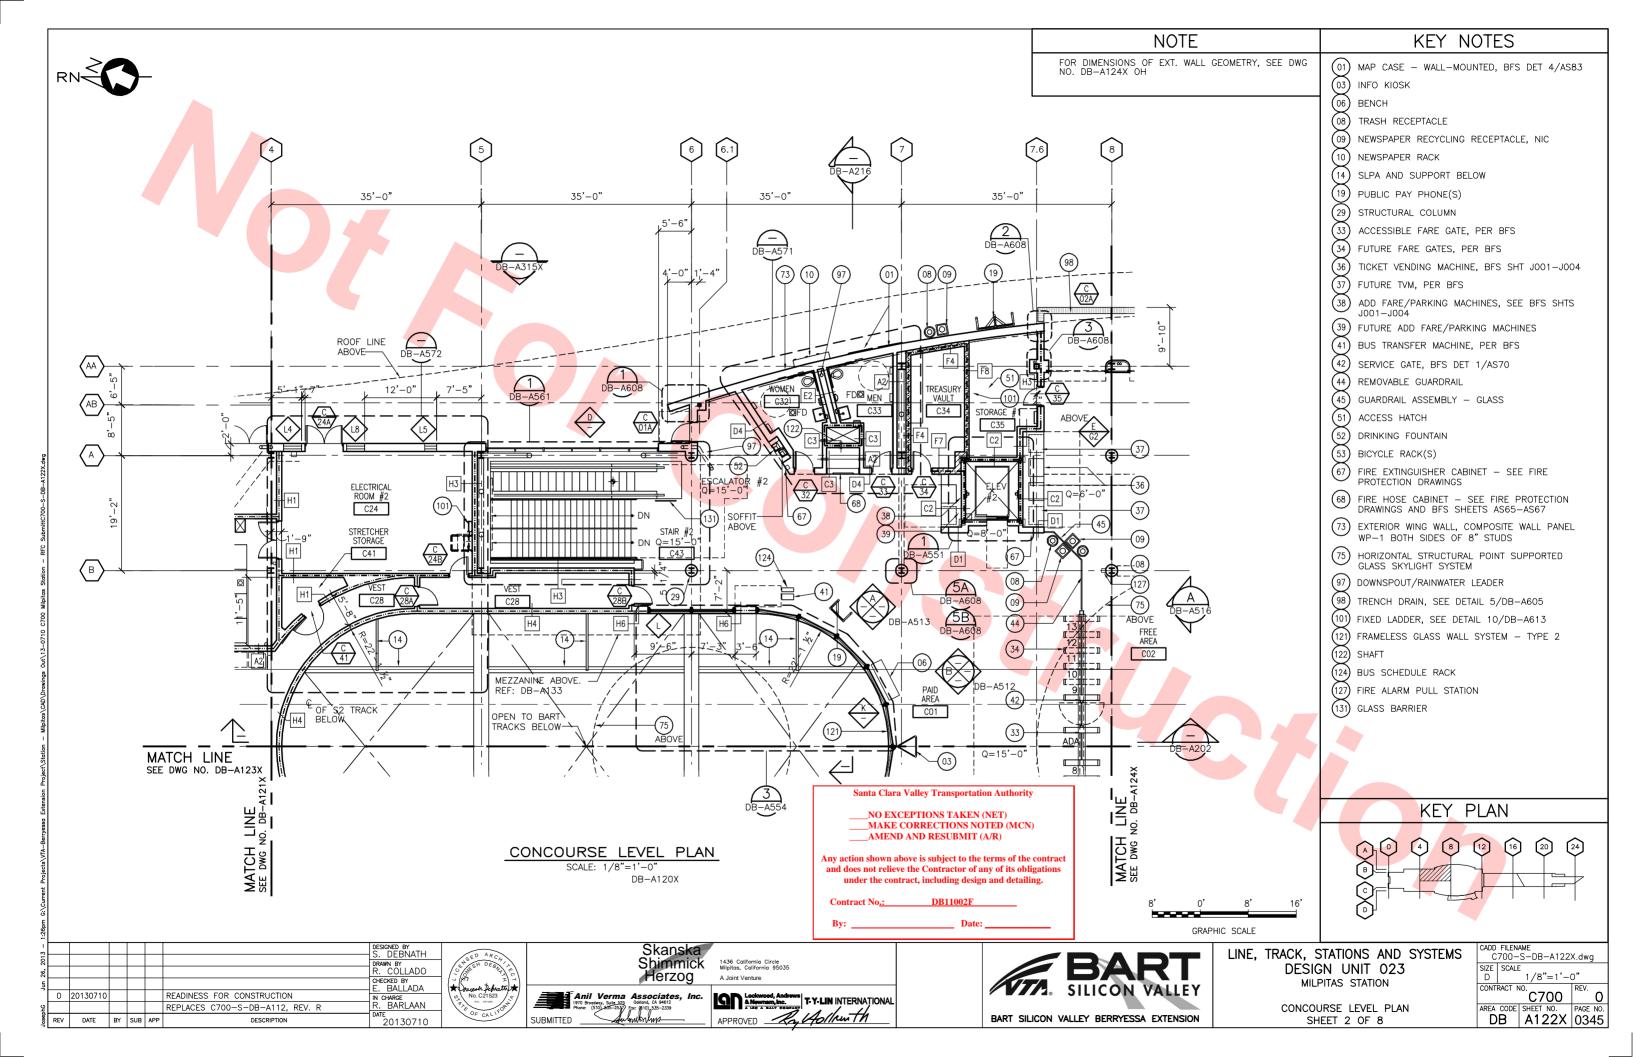

NOTES KEY NOTES (01) MAP CASE - WALL-MOUNTED, BFS DET 4/AS83 FOR DIMENSIONS OF EXTERIOR WALL INFO KIOSK - THREE-SIDED, BFS DET 1/AS85 GEOMETRY, SEE DWG NO. DB-A114X, SIM BENCH FOR FINISH FLOORING - SEE FLOOR PATTERN DRAWINGS ON DWG NO. DB-A450 TRASH RECEPTACLE (09) NEWSPAPER RECYCLING RECEPTACLE, NIC NEWSPAPER RACK (14) SLPA BELOW PUBLIC PAY PHONE(S) (29) STRUCTURAL COLUMN \leftarrow FARE GATES, BFS SHT J005 & J006 35'-0" 35'-0" 35'-0" BILL TO BILL CHANGER (BBC), PER BFS 10'-9" MATCH LINE CENTER POINT SEE DWG NO. DB-A122X TICKET VENDING MACHINE, BFS SHT J001-J004 (37) FUTURE TVM, PER BFS OPEN TO BART PAID AREA POINT OF H4 38) ADD FARE/PARKING MACHINES, SEE BFS SHTS TRACKS BELOW ARC (03) C01i J001-J004 OF S1 TRACK BELOW MEZZANINE ABOVE 75) ABOVE Q = 15' - 0"(39) FUTURE ADD FARE/PARKING MACHINE AREA TO BE REVIEWED REF; DB-A133 -(HATCHED AREA) BUS TRANSFER MACHINE, PER BFS DB-A51,2 (44) REMOVABLE GUARDRAIL 2'-11 1/2" 12'-7" GUARDRAIL ASSEMBLY - GLASS 75) ABOVE HANDRAIL - METAL CX 12A B-A551 ACCESS HATCH C11 (120) (52) DRINKING FOUNTAIN 1 DB-A514 Q=8'-0" (53) BICYCLE RACK(S) FIRE EXTINGUISHER CABINET — SEE FIRE PROTECTION DRAWINGS C13 C02 18'-6" SOFFIT FIRE HOSE CABINET - SEE FIRE PROTECTION ABOVE-DRAWINGS AND BFS SHEETS AS65-AS67 012 C14 (73) EXTERIOR WING WALL, COMPOSITE WALL PANEL C05 WP-1 BOTH SIDES OF 8" STUDS HORIZONTAL STRUCTURAL POINT SUPPORTED GLASS SKYLIGHT SYSTEM (97) DOWNSPOUT/RAINWATER LEADER (98) TRENCH DRAIN, SEE DETAIL 5/DB-A605 11'-0 3/8' FIXED LADDER CO8 INTERVIEW RM L-1A) _ _ _ ABOVE DB-A56 DB-A608 OH FUTURE BTM DOOR (121) FRAMELESS GLASS WALL SYSTEM - TYPE 2 ROOF LINE (122) SHAFT ABOVE-MAINT. ENGR (124) BUS SCHEDULE RACK (10) (101) (51) -OEFICE C10 GLASS BARRIER (165) PARKING VALIDATION MACHINE (PVM) (08) (09) (19) (98)-Santa Clara Valley Transportation Authority ENTRY-NO EXCEPTIONS TAKEN (NET) CANOPY MAKE CORRECTIONS NOTED (MCN) ABOVE AMEND AND RESUBMIT (A/R) 23'-8" 11'-4" 27'-9" Any action shown above is subject to the terms of the contract KEY PLAN LINE No. DB. and does not relieve the Contractor of any of its obligations under the contract, including design and detailing. CONCOURSE LEVEL PLAN MATCH SEE DWG N DB11002F SCALE: 1/8"=1'-0'DB-A120X GRAPHIC SCALE DESIGNED BY S. DEBNATH CADD FILENAME C700-S-DB-A123X.dwg Skanska LINE, TRACK, STATIONS AND SYSTEMS Shimmick SIZE | SCALE | 1/8"=1'-0" RAWN BY DESIGN UNIT 023 Herzog MILPITAS STATION BALLADA C700 READINESS FOR CONSTRUCTION 0 20130710 Anil Verma Associates, Inc Leckwood, Andrews

8. Newmam, Inc.
1.19 - DALY COMPANY

T-Y-LIN INTERNATIONAL CHARGE BARLAAN REPLACES C700-S-DB-A113, REV. R CONCOURSE LEVEL PLAN , Asthenth APPROVED ____ BART SILICON VALLEY BERRYESSA EXTENSION DB A123X 0346 REV DATE BY SUB APP SUBMITTED SHEET 3 OF 8


DESCRIPTION


20130710


KEY NOTES MAP CASE - WALL-MOUNTED, BFS DET 4/AS83 INFO KIOSK - THREE-SIDED, BFS DET 1/AS85 (06) BENCH (08) TRASH RECEPTACLE (09) NEWSPAPER RECYCLING RECEPTACLE, NIC NEWSPAPER RACK (14) SLPA AND SUPPORT BELOW (19) PUBLIC PAY PHONE(S) 35'-0" 35'-0" 35'-0" 35'-0" (29) STRUCTURAL COLUMN 11'-0" 11'-4" 4'-9" 5'-6" (32) FARE GATES, BFS SHT J005 & J006 AROVE -ROOF LINE (09)(08) ABOVE BILL TO BILL CHANGER (BBC), PER BFS 98 TICKET VENDING MACHINE, BFS SHT J001-J004 DB-A609 FUTURE TVM, PER BFS ADD FARE/PARKING MACHINE, SEE BFS SHTS EDGE OF - SOFFIT ABOVE J001-J004 (39) FUTURE ADD FARE/PARKING MACHINE EMP RM C36 TRAIN INFORMATION MONITOR СОММ BUS TRANSFER MACHINE, PER BFS TERM #1 FOUND C37 C38 (45) GUARDRAIL ASSEMBLY - GLASS HANDRAIL - METAL OVERHEAD COILING DOOR DB-A56 BICYCLE RACK(S) FIRE EXTINGUISHER CABINET - SEE FIRE PROTECTION DRAWINGS EDGE OF EQ. EQ. D1 9 (73) EXTERIOR WING WALL, COMPOSITE WALL PANEL SOFFIT ABOVE 5A DB-A608 WP-1 BOTH SIDES OF 8" STUDS -67 SOFFIT ABOVE STAIR #4 (131) HORIZONTAL STRUCTURAL POINT SUPPORTED GLASS SKYLIGHT SYSTEM <u>/5B</u> C45 (48) (97) DOWNSPOUT/RAINWATER LEADER DB-A608 **(** (98) TRENCH DRAIN, SEE DETAIL 5/DB-A605 14'-5 1/2" KNOCK-OUT CONCRETE SLAB - SEE STRUCTURAL (45)-(29) (121) GLASS WALL SYSTEM TYPE 2 Q=15'-0" Q=15'-0" MEZZ. ABOVE (124) BUS SCHEDULE RACK B-A60 (131) GLASS BARRIER DS-A133 (141) RECESSED DEFIBRILLATOR CABINET 4|| (32) (165) PARKING VALIDATION MACHINE (PVM) DB-A512 SLAB OF S2 TRACK BELOW PAID ARFA OPEN TO BART TRACKS BELOW ARITA C03 C02 MATCH LINE CENTER POINT OF SEE DWG NO. DB-A125X ARC GRAPHIC SCALE Santa Clara Valley Transportation Authority MATCH LINE SEE DWG NO. DB-A KEY PLAN NO EXCEPTIONS TAKEN (NET) MAKE CORRECTIONS NOTED (MCN) AMEND AND RESUBMIT (A/R) (12) CONCOURSE LEVEL PLAN Any action shown above is subject to the terms of the contract SCALE: 1/8"=1'-0" and does not relieve the Contractor of any of its obligations DB-A120X under the contract, including design and detailing. DB11002F DESIGNED BY S. DEBNATH CADD FILENAME C700-S-DB-A124X.dwg Skanska LINE, TRACK, STATIONS AND SYSTEMS SIZE | SCALE | 1/8"=1'-0" Shimmick RAWN BY **DESIGN UNIT 023** Herzog MILPITAS STATION . BALLADA C700 READINESS FOR CONSTRUCTION 0 20130710 Anil Verma Associates, Inc Leckwood, Andrews


8. Newmam, Inc.
1.19 - DALY COMPANY

T-Y-LIN INTERNATIONAL CHARGE BARLAAN REPLACES C700-S-DB-A114, REV. P CONCOURSE LEVEL PLAN APPROVED Ro, GOTTHENTH BART SILICON VALLEY BERRYESSA EXTENSION DB A124X 0347 REV DATE BY SUB APP SUBMITTED SHEET 4 OF 8 DESCRIPTION 20130710

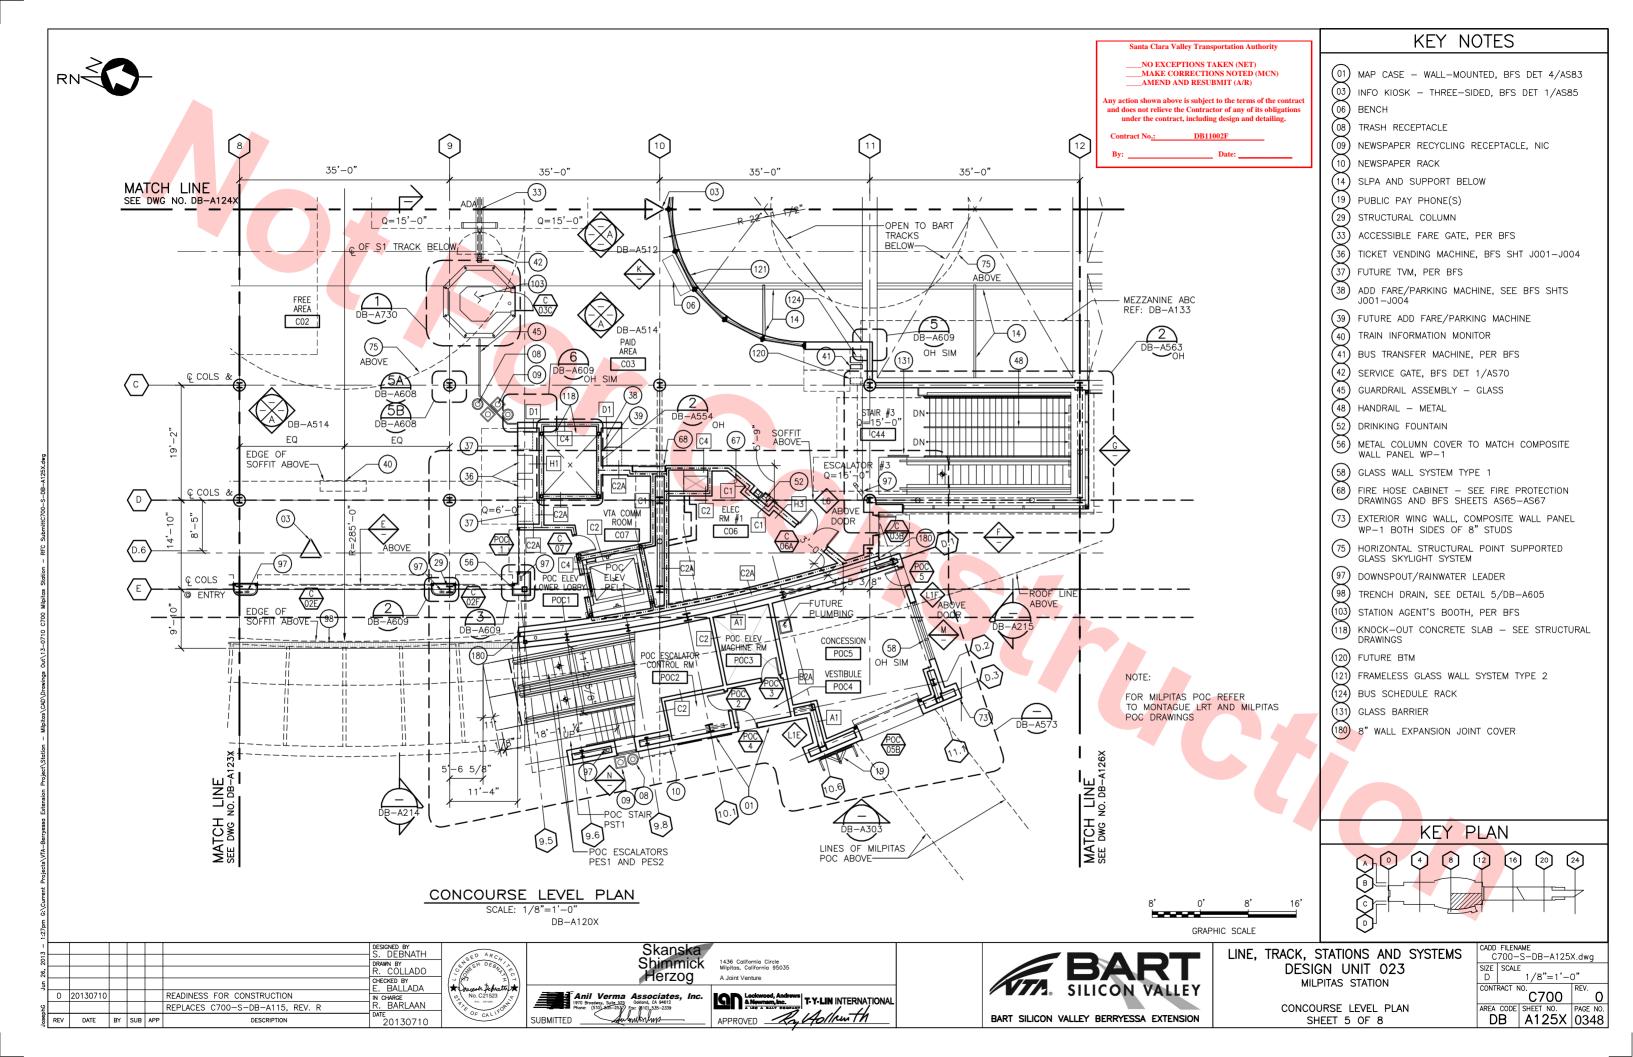


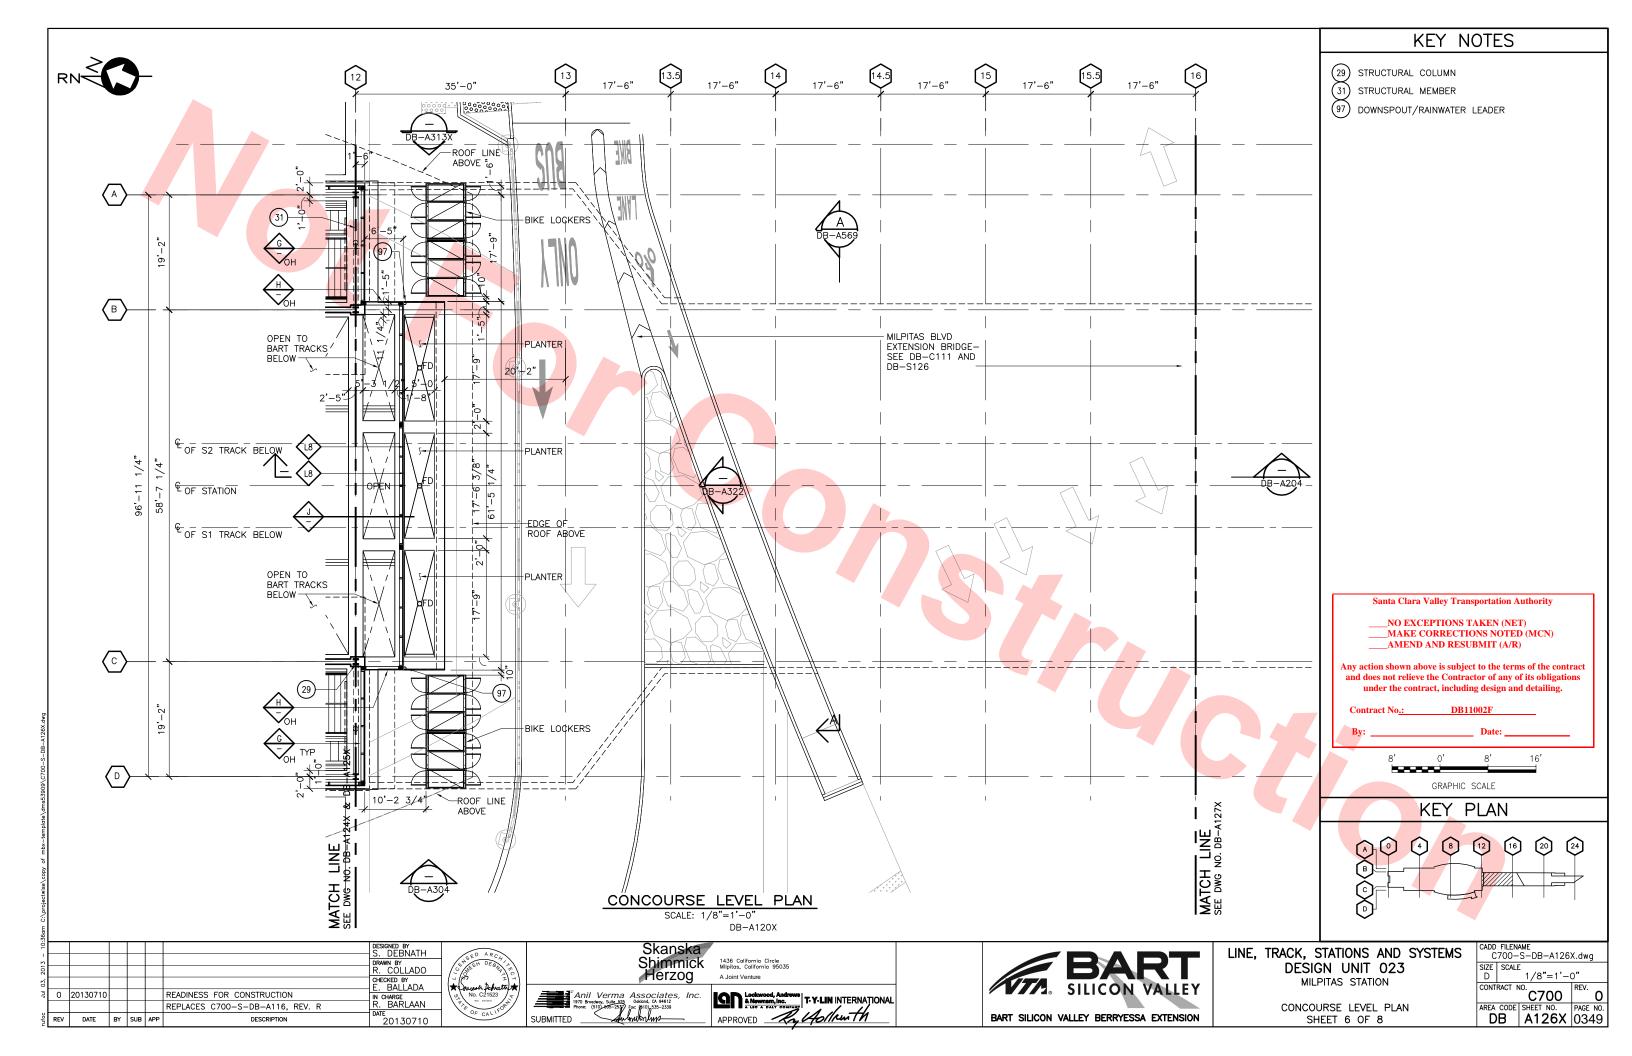

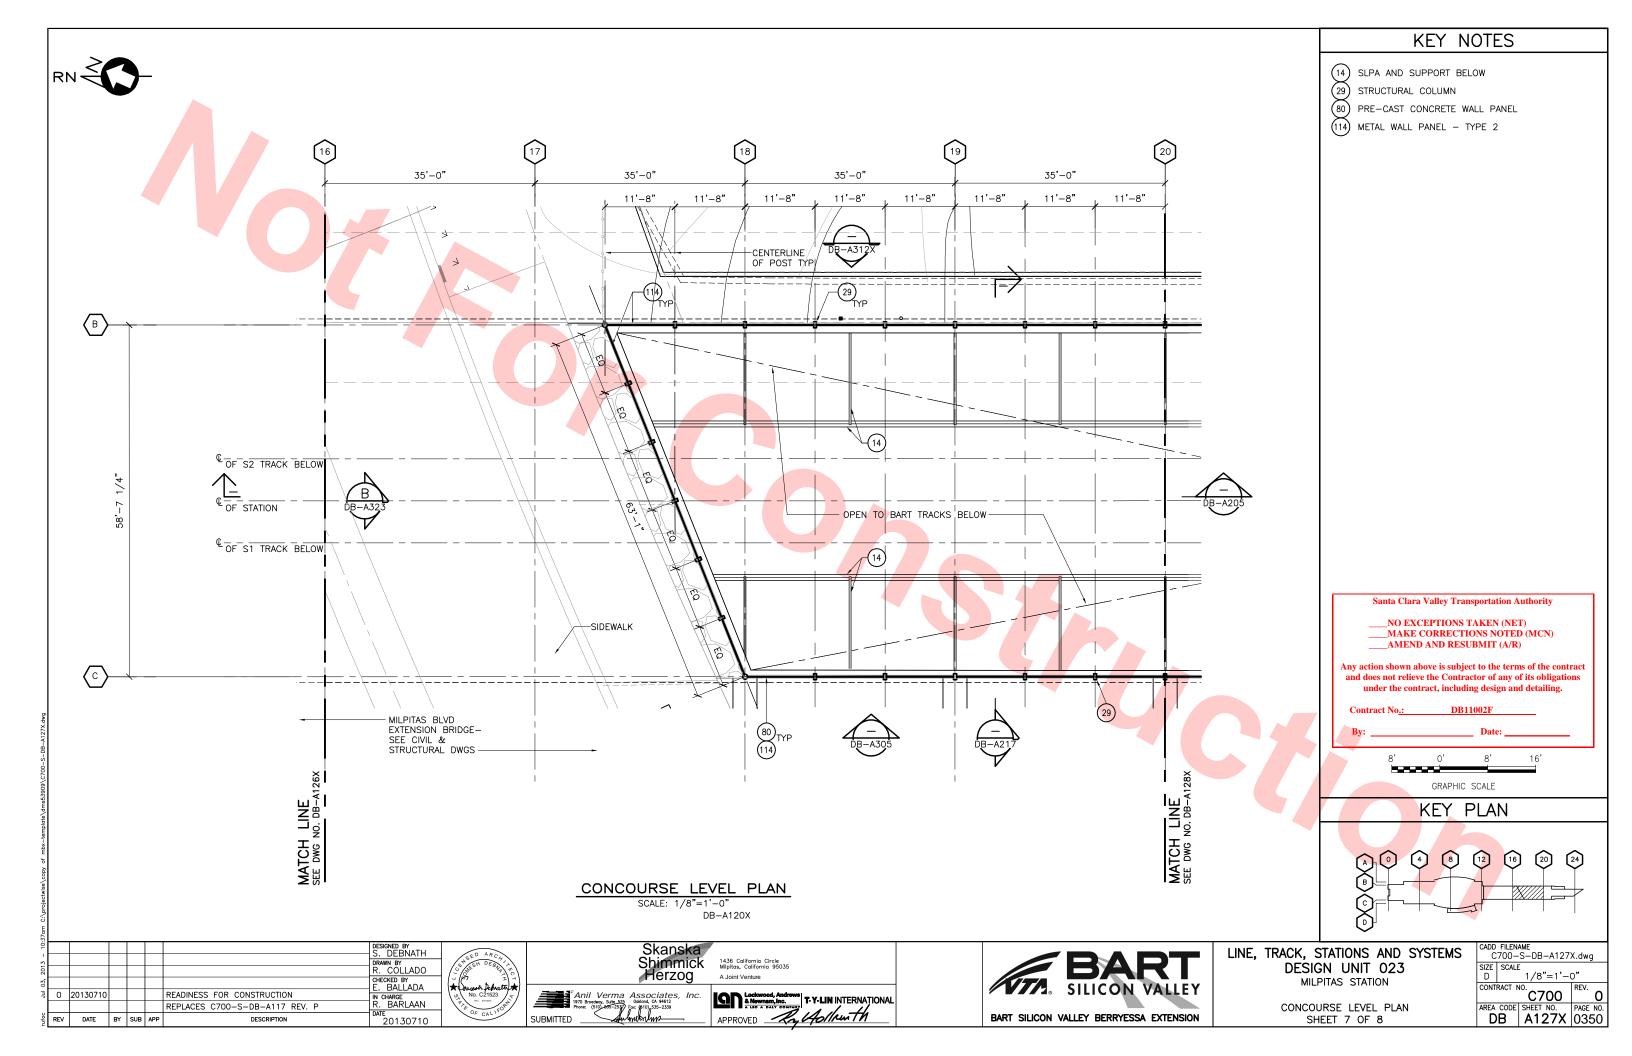

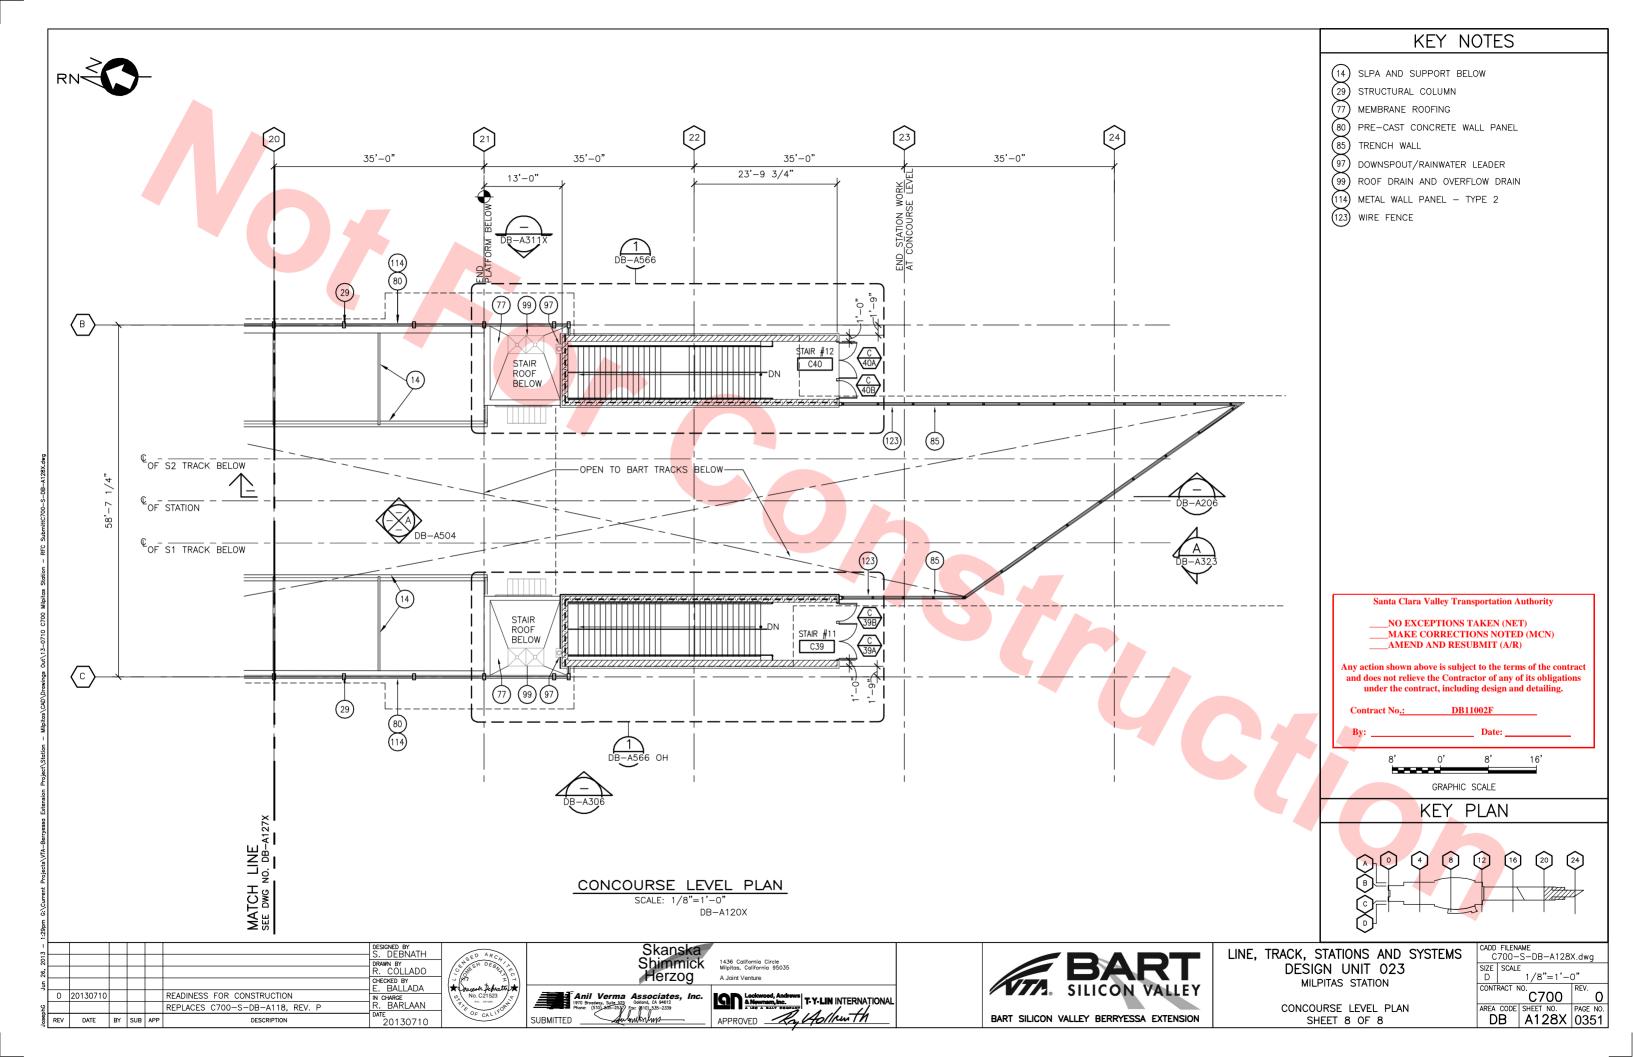



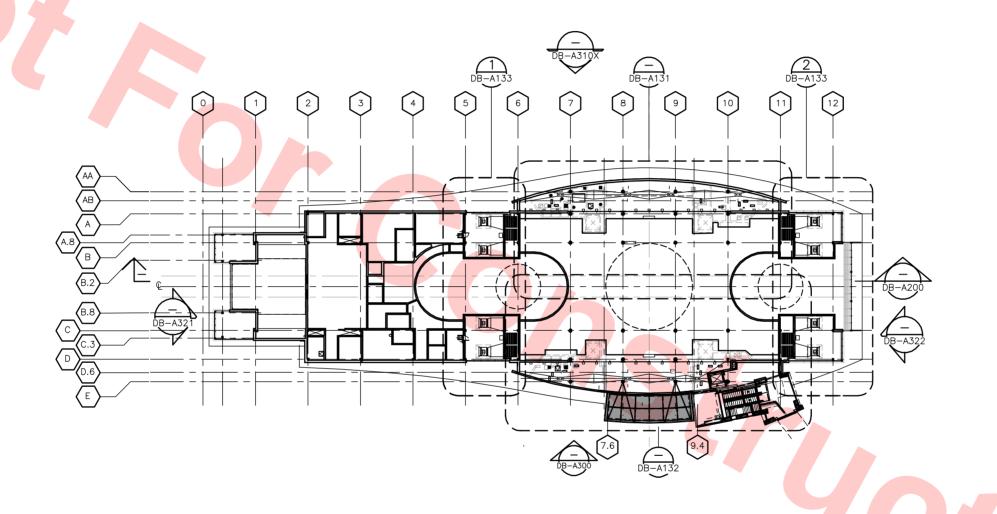


Santa Clara Valley Transportation Authority

___NO EXCEPTIONS TAKEN (NET)
__MAKE CORRECTIONS NOTED (MCN)
__AMEND AND RESUBMIT (A/R)

Any action shown above is subject to the terms of the contract and does not relieve the Contractor of any of its obligations under the contract, including design and detailing.

KEY PLAN-MEZZANINE LEVEL

SCALE: 1/32"=1'-0"

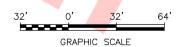

13 -							DESIGNED BY S. DEBNATH
201							DRAWN BY
56,							R. COLLADO
Jun							CHECKED BY E. BALLADA
					l		IN CHARGE
ဖွ	0	20130710				READINESS FOR CONSTRUCTION	R. BARLAAN
JosephG	REV	DATE	BY	SUB	APP	DESCRIPTION	DATE 20130710



O An	Sk
SED ARCA	Shi
Chie To To To	He
Sween Dehath *	<i>y.</i>
No. C21523	Anil Verma Associa
OF CALIFORN	1970 Broadway, Suite 525 Oakland, CA 9- Phone: (510) 535-2537 Fax: (610) 535-
OF CALL	SUBMITTED Submitships








LINE, TRACK, STATIONS AND SYSTEM DESIGN UNIT 023 MILPITAS STATION


KEY	PL	AN
MEZZANIN	١E	LEVE


MS		FILEN. C700-	AME -S-DB-	-A130	.dwg	
	SIZE D	SCALE	1/32":	=1'-	0"	
	CONT	RACT N	^{10.} C70	00	REV.	0
	AREA	CODE	SHEET N	0.	PAGE	NO.
	l D	В	A13	3O I	035	52

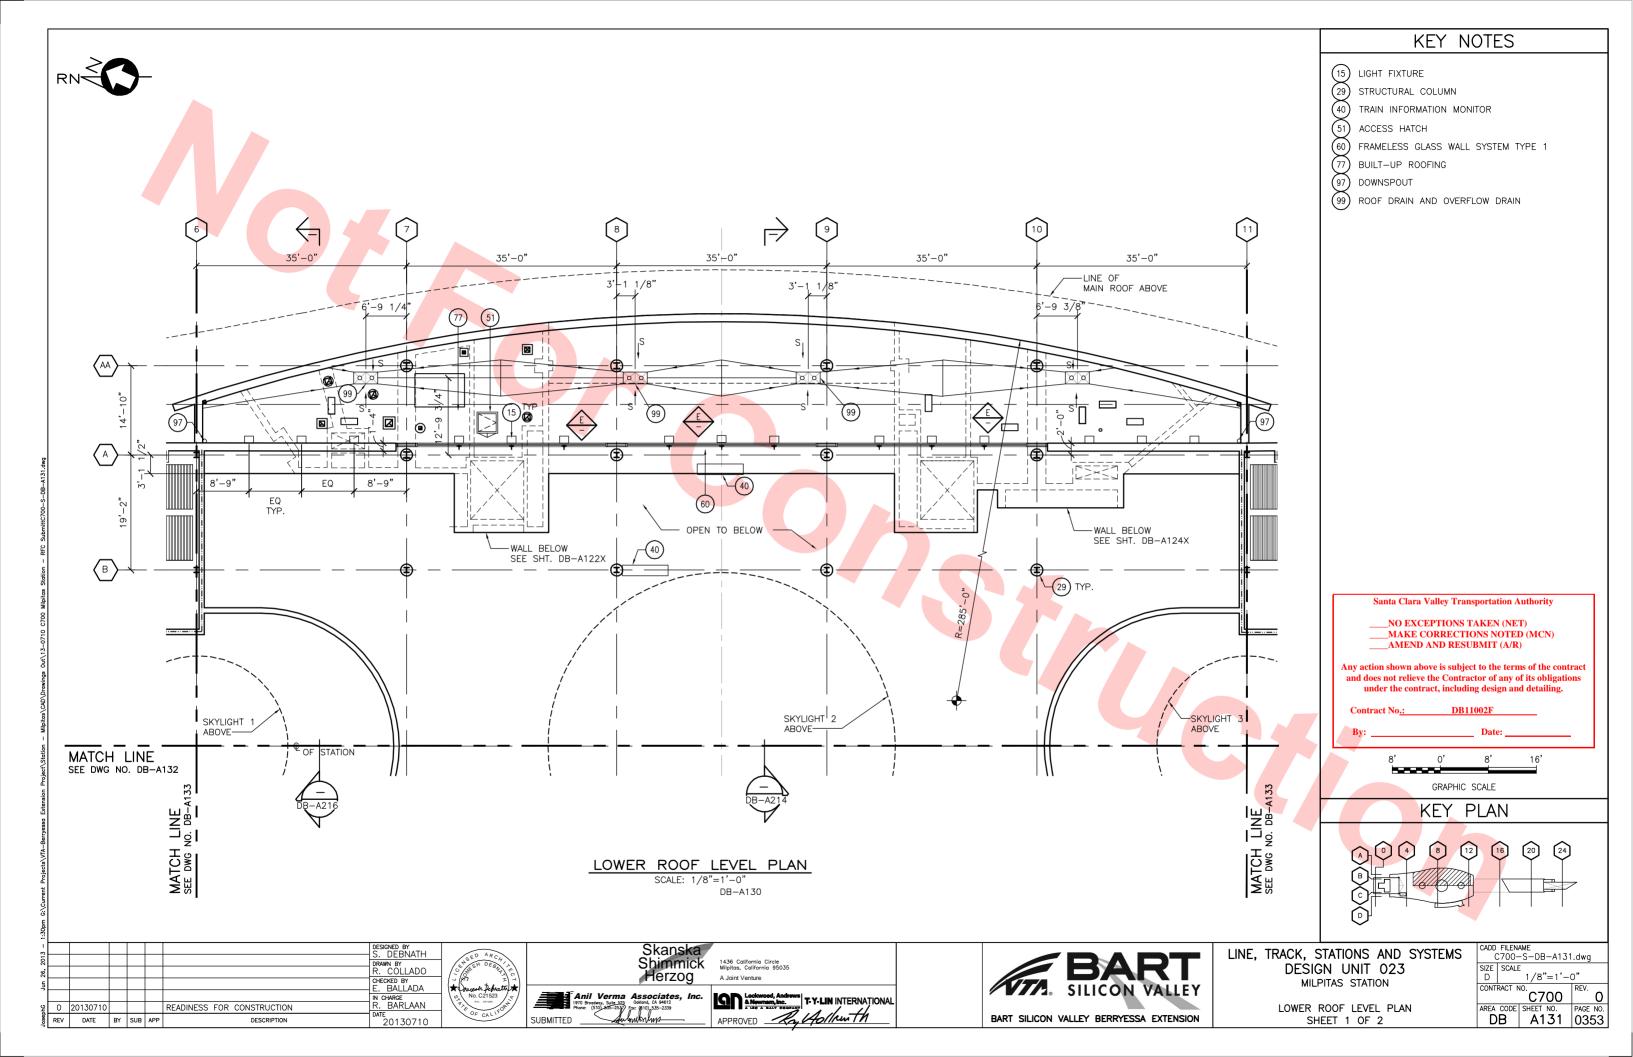


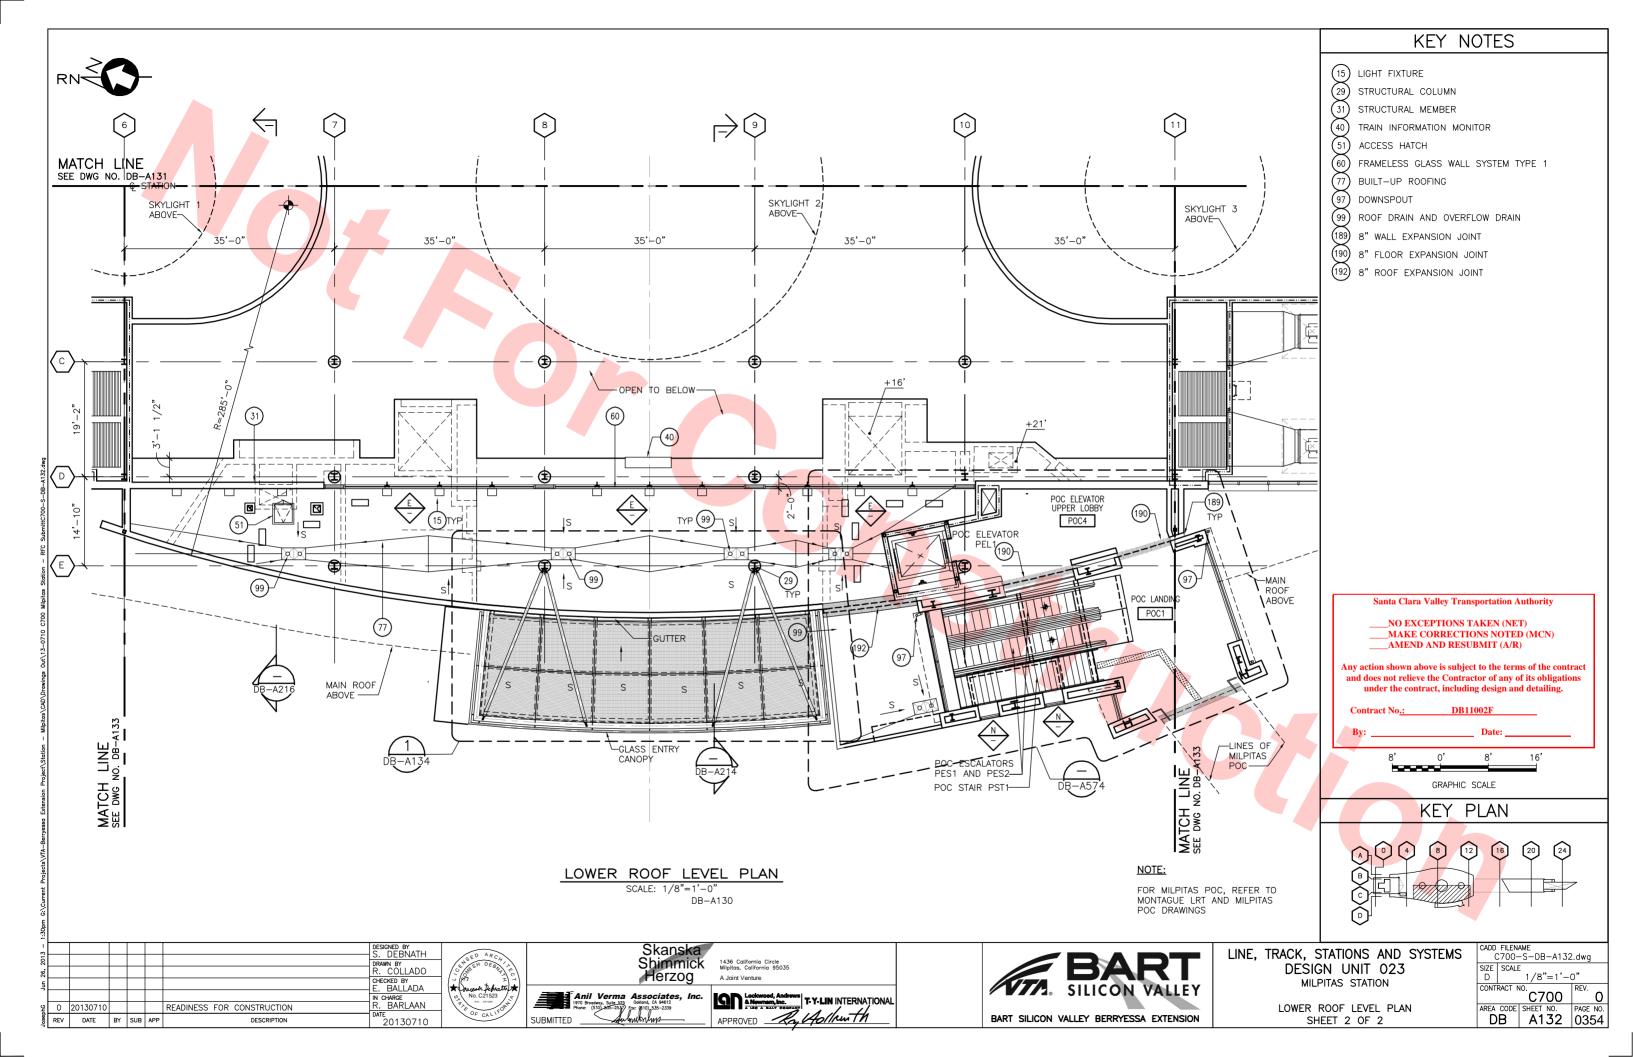


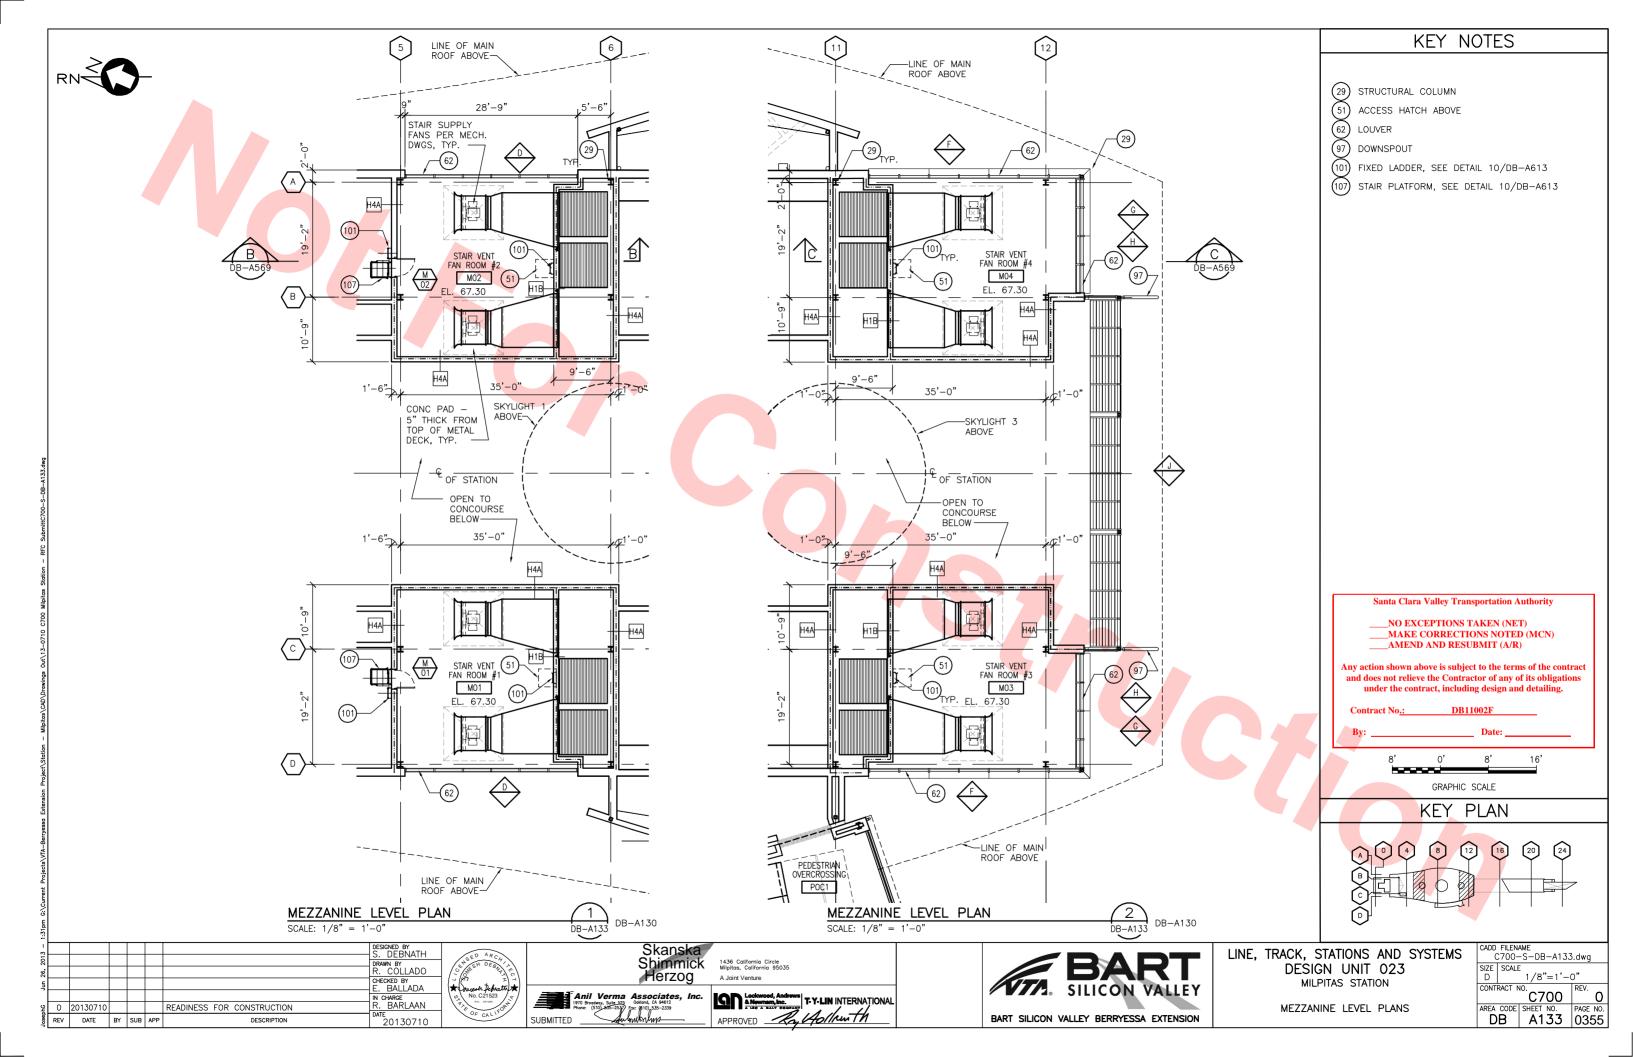

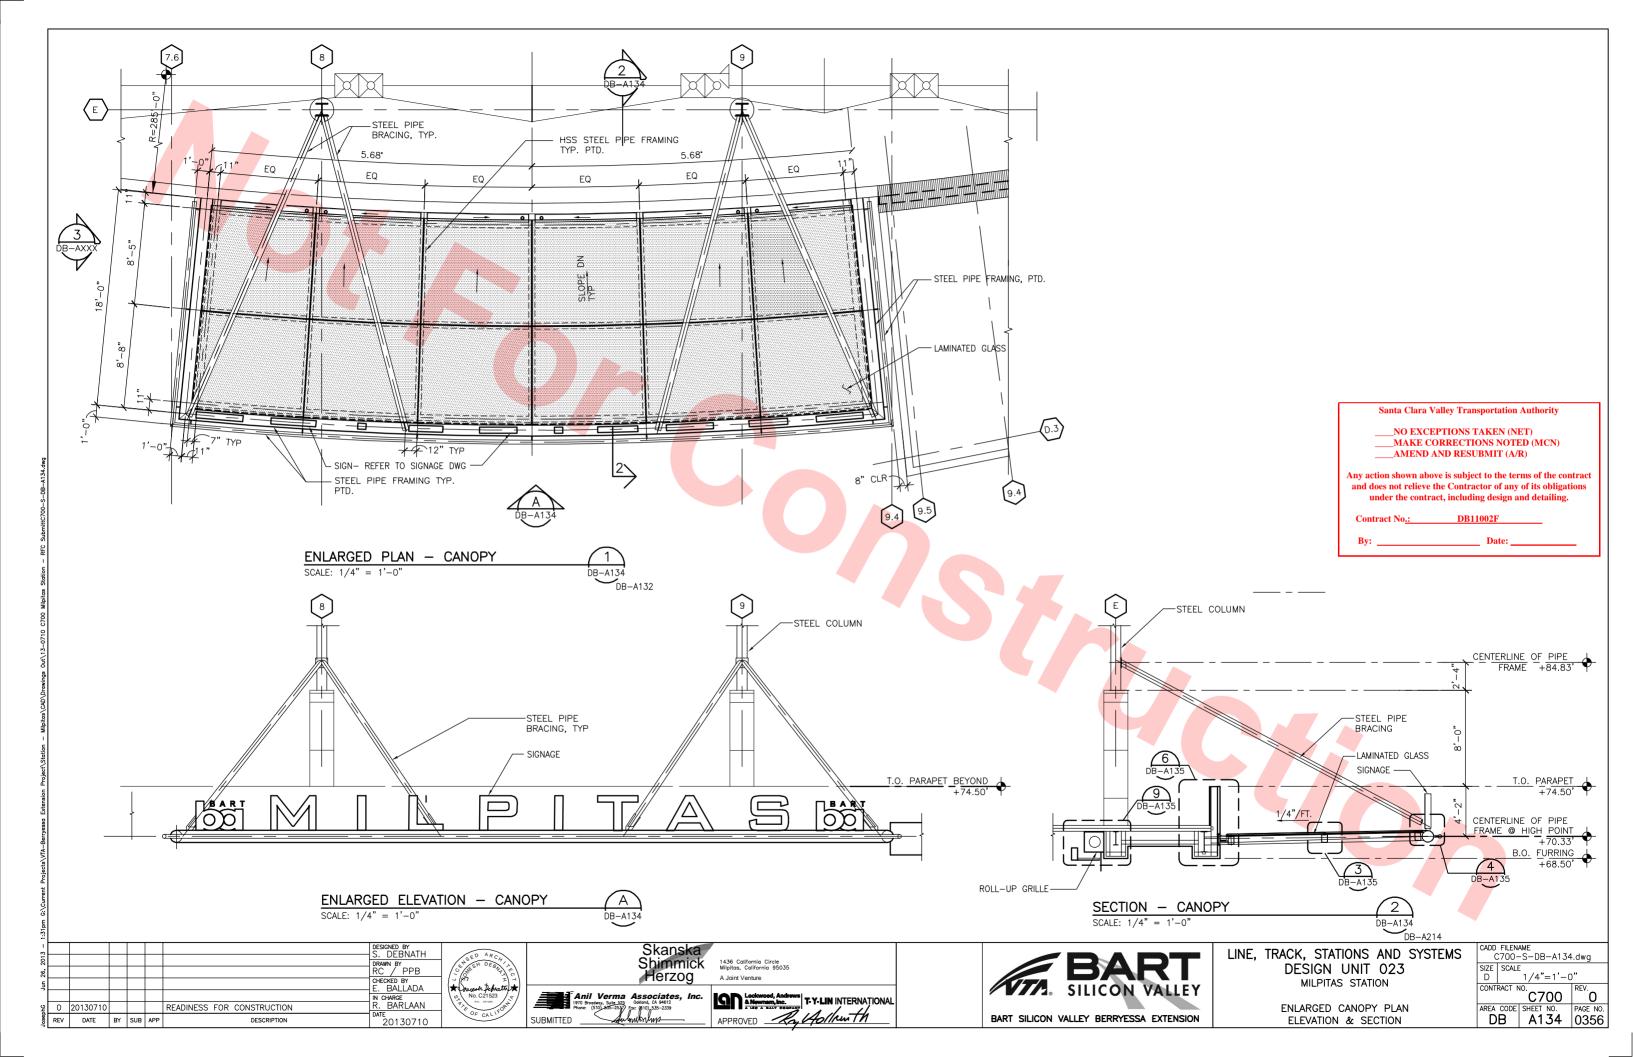


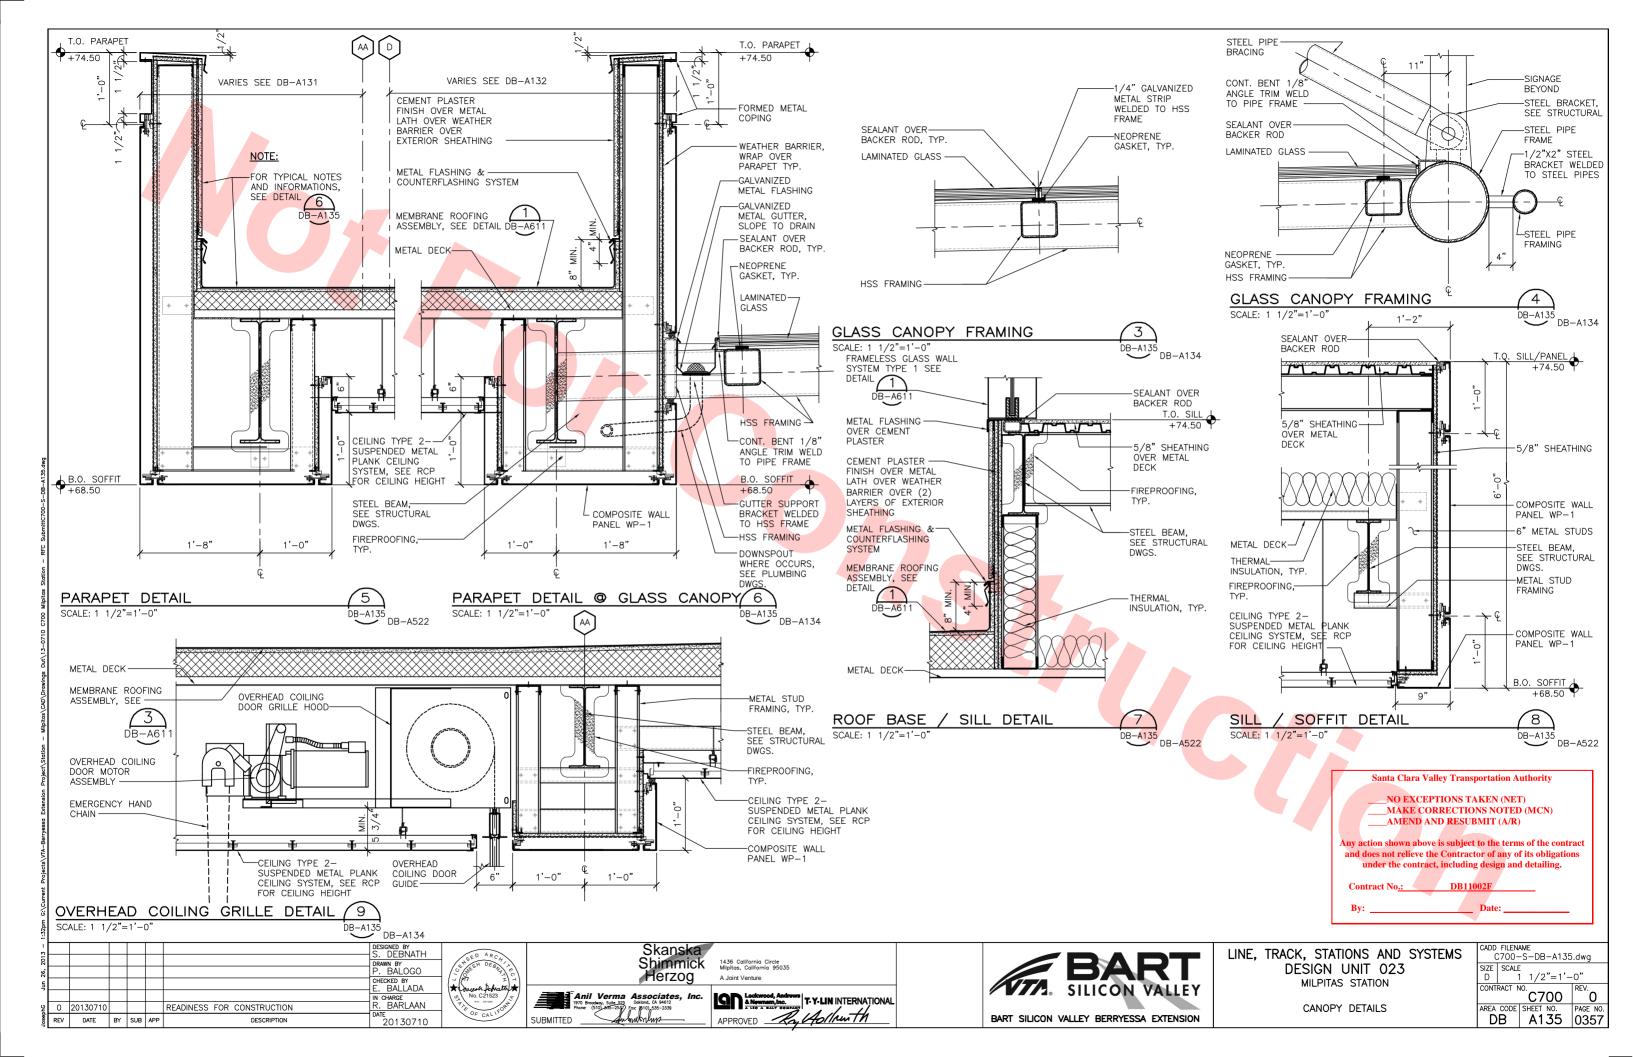

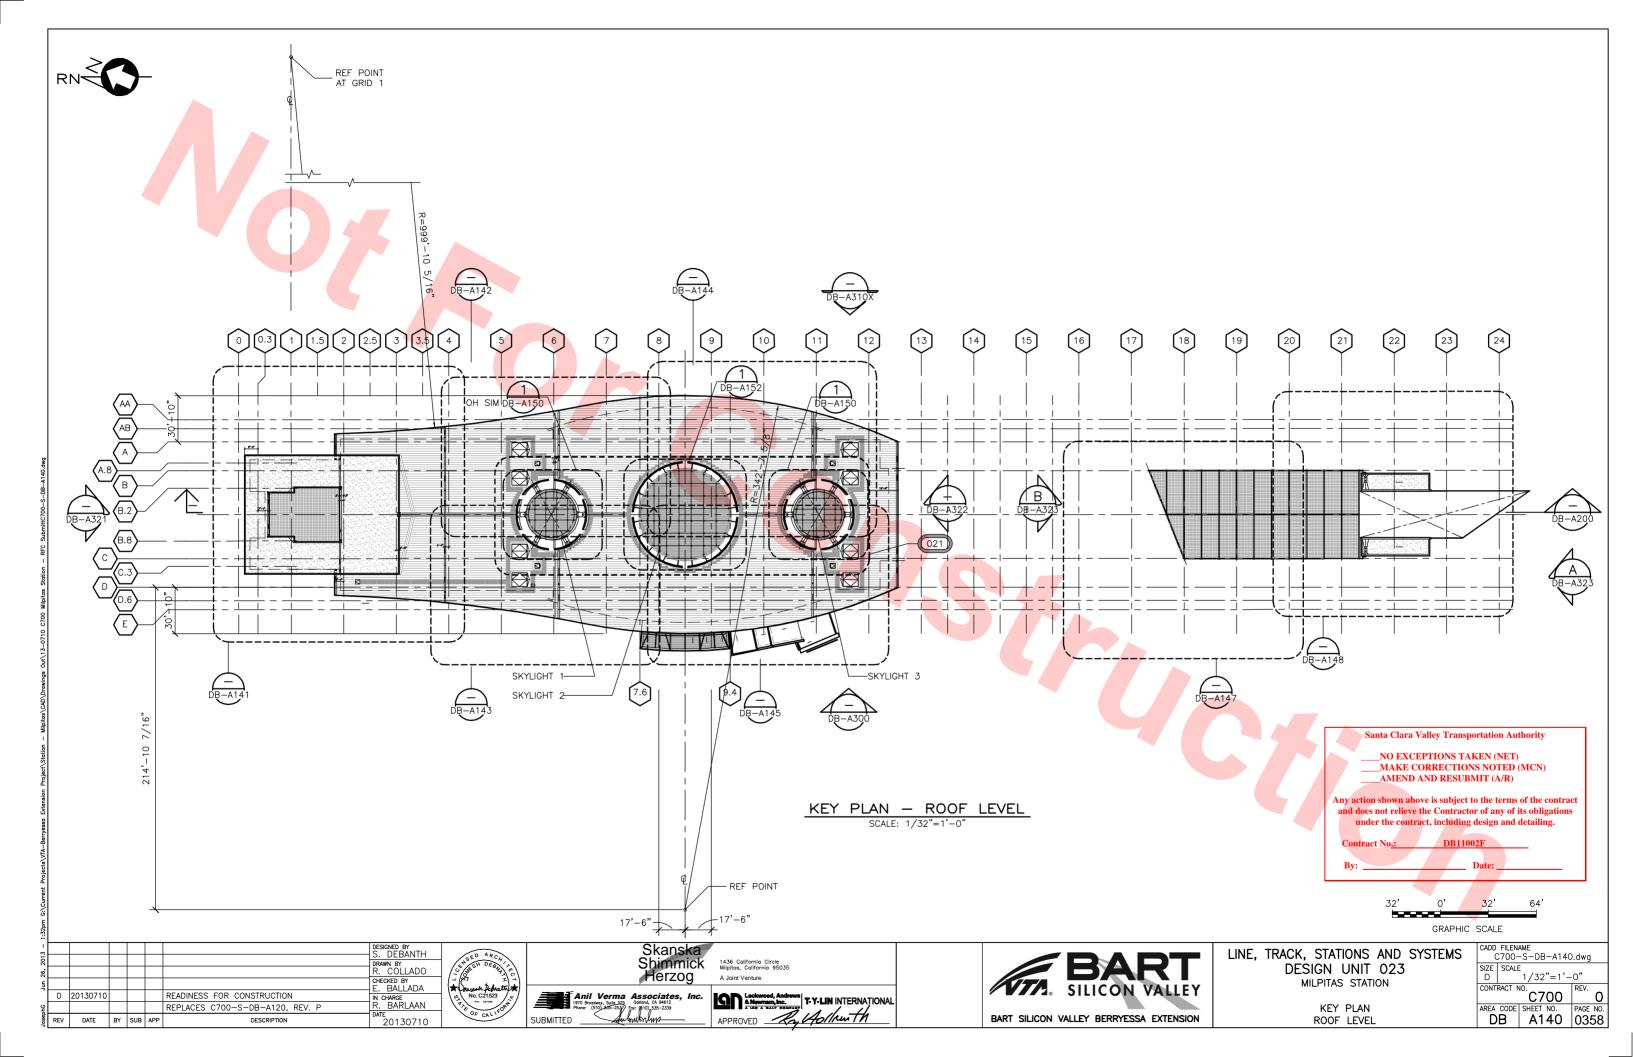

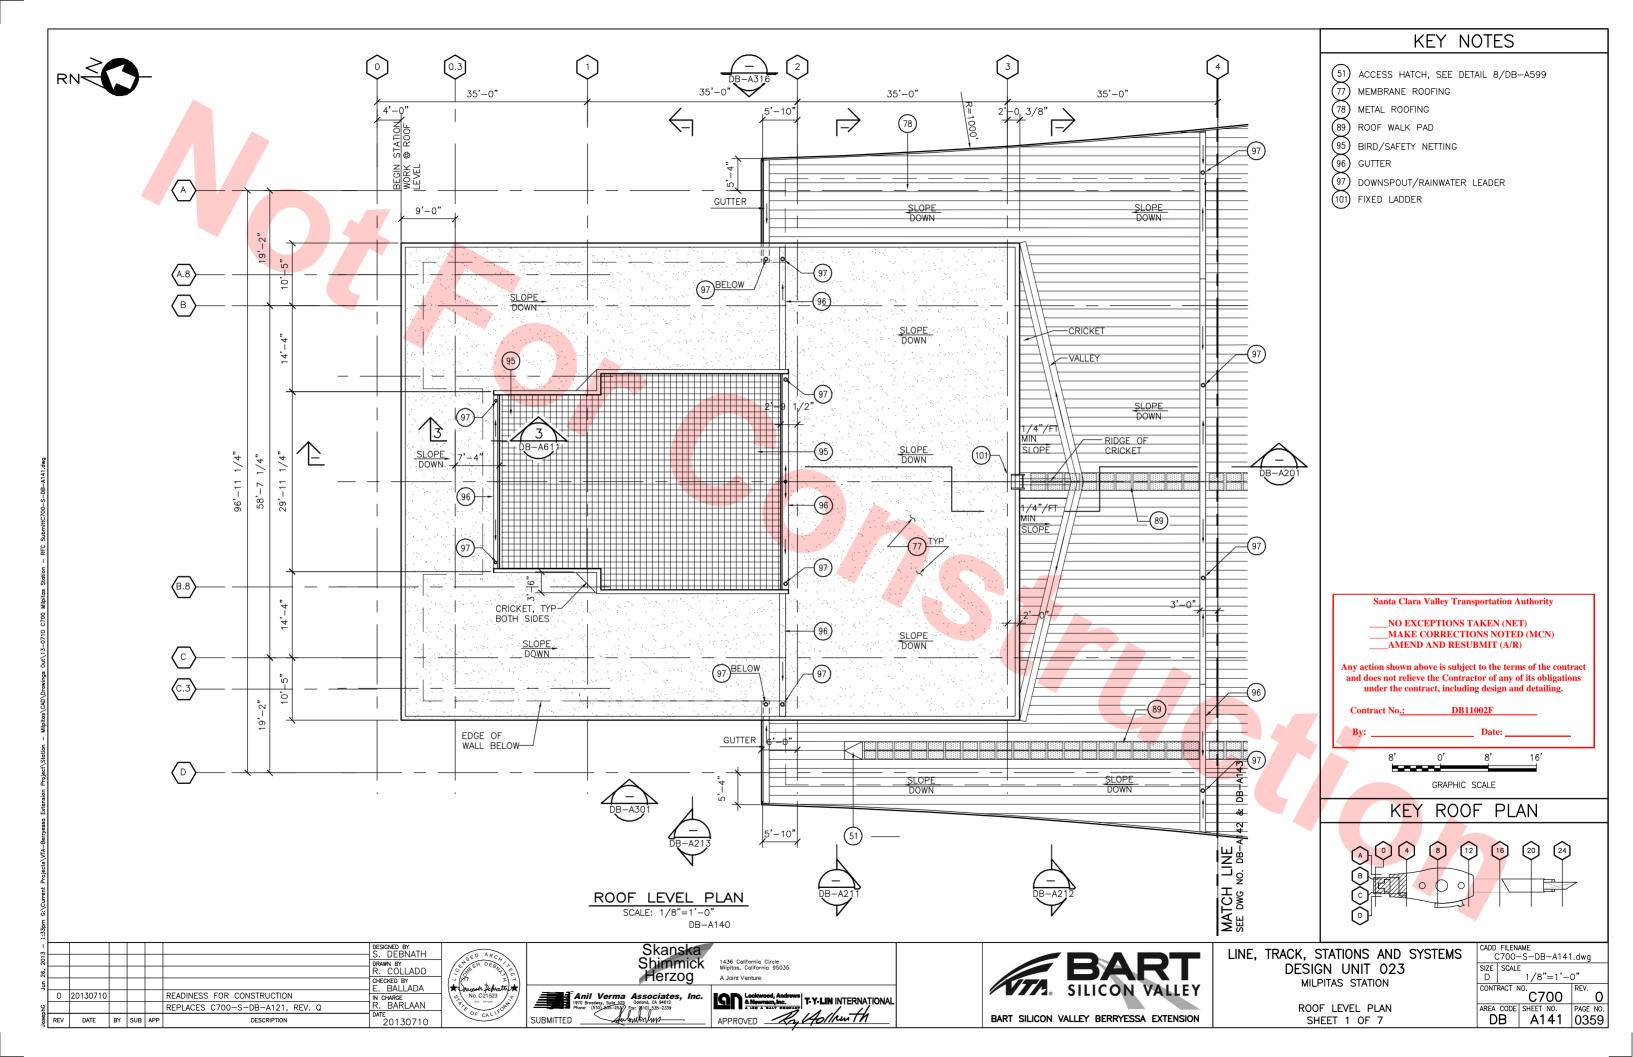



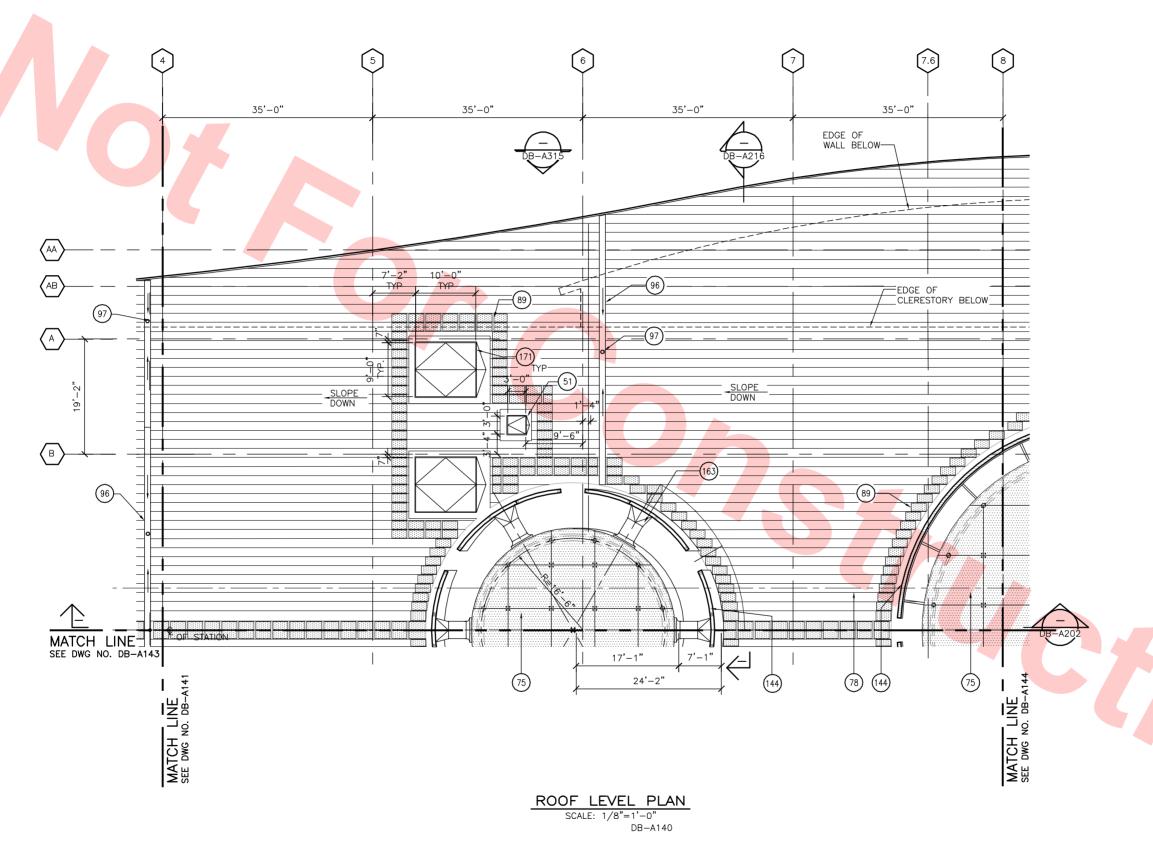

KEY NOTES

51) ACCESS HATCH, SEE DETAIL 8/DB-A599

(75) HORIZONTAL STRUCTURAL POINT SUPPORTED GLASS SKYLIGHT SYSTEM

78) METAL ROOFING

89) ROOF WALK PAD

96) GUTTER

(97) DOWNSPOUT

(144) WIND FENCE

(163) SKYLIGHT SMOKE EVACUATION FAN

EQUIPMENT ACCESS ROOF HATCH, SEE DWG NO 4/DB-A610

Santa Clara Valley Transportation Authority

____NO EXCEPTIONS TAKEN (NET)
____MAKE CORRECTIONS NOTED (MCN)
___AMEND AND RESUBMIT (A/R)


Any action shown above is subject to the terms of the contract and does not relieve the Contractor of any of its obligations under the contract, including design and detailing.

Contract No.: DB11002F

8' 0' 8' 16'

GRAPHIC SCALE

KEY ROOF PLAN

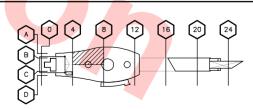

	ı						
2							DESIGNED BY S. DEBNATH
3							DRAWN BY
5							R. COLLADO
5							CHECKED BY E. BALLADA
	0	20130710				READINESS FOR CONSTRUCTION	IN CHARGE
2						REPLACES C700-S-DB-A122, REV. R	R. BARLAAN
	REV	DATE	BY	SUB	APP	DESCRIPTION	DATE 20130710









LINE, TRACK, STATIONS AND SYSTEMS

DESIGN UNIT 023

MILPITAS STATION

ROOF LEVEL PLAN SHEET 2 OF 7


3	CADD FILENAME C700-S-DB-A142.dwg									
	SIZE D	SCALE		"=1'-	0"					
	CONT	RACT N	^{10.} C7	00	REV. O					
	AREA	CODE	SHEET A1	NO. 42	PAGE NO. 0360					


KEY NOTES (51) ACCESS HATCH, SEE DETAIL 8/DB-A599 HORIZONTAL STRUCTURAL POINT SUPPORTED GLASS SKYLIGHT SYSTEM (78) METAL ROOFING (89) ROOF WALK PAD (96) GUTTER 35'-0" 35'-0" 35'-0" 35'-0" (97) DOWNSPOUT (144) WIND FENCE (163) SKYLIGHT SMOKE EVACUATION FAN EQUIPMENT ACCESS ROOF HATCH, SEE DWG NO. 4/DB-A610 MATCH LINE SEE DWG NO. DB-A142 SLOPE NOTE FOR DIMENSIONS OF ROOF GEOMETRY, SEE DWG DB-A140, SIM - EDGE OF Santa Clara Valley Transportation Authority CLERESTORY BELOW ___NO EXCEPTIONS TAKEN (NET) ___MAKE CORRECTIONS NOTED (MCN) AMEND AND RESUBMIT (A/R) Any action shown above is subject to the terms of the contract and does not relieve the Contractor of any of its obligations under the contract, including design and detailing. EDGE OF WALL BELOW-GLASS CANOPY GRAPHIC SCALE BELOW-SEE 1 DB-A134 KEY ROOF PLAN ROOF LEVEL PLAN SCALE: 1/8"=1'-0" DB-A140 DESIGNED BY S. DEBNATH CADD FILENAME C700-S-DB-A143.dwg Skanska LINE, TRACK, STATIONS AND SYSTEMS Shimmick 1436 California Circle Milpitas, California 95035 RAWN BY R. COLLADO DESIGN UNIT 023 SIZE | SCALE | 1/8"=1'-0" Herzog A Joint Venture MILPITAS STATION CHECKED BY E. BALLADA C700 REV.
C700 PAGE NO.
DB A143 0361 READINESS FOR CONSTRUCTION 0 20130710 Lockwood, Andrews & Newman, Inc.


A Newman, Inc.


LUG - BAY COMPANY


T-Y-LIN INTERNATIONAL CHARGE . BARLAAN REPLACES C700-S-DB-A123, REV. R ROOF LEVEL PLAN APPROVED Ry Hollauth BART SILICON VALLEY BERRYESSA EXTENSION REV DATE BY SUB APP DESCRIPTION SUBMITTED SHEET 3 OF 7 20130710

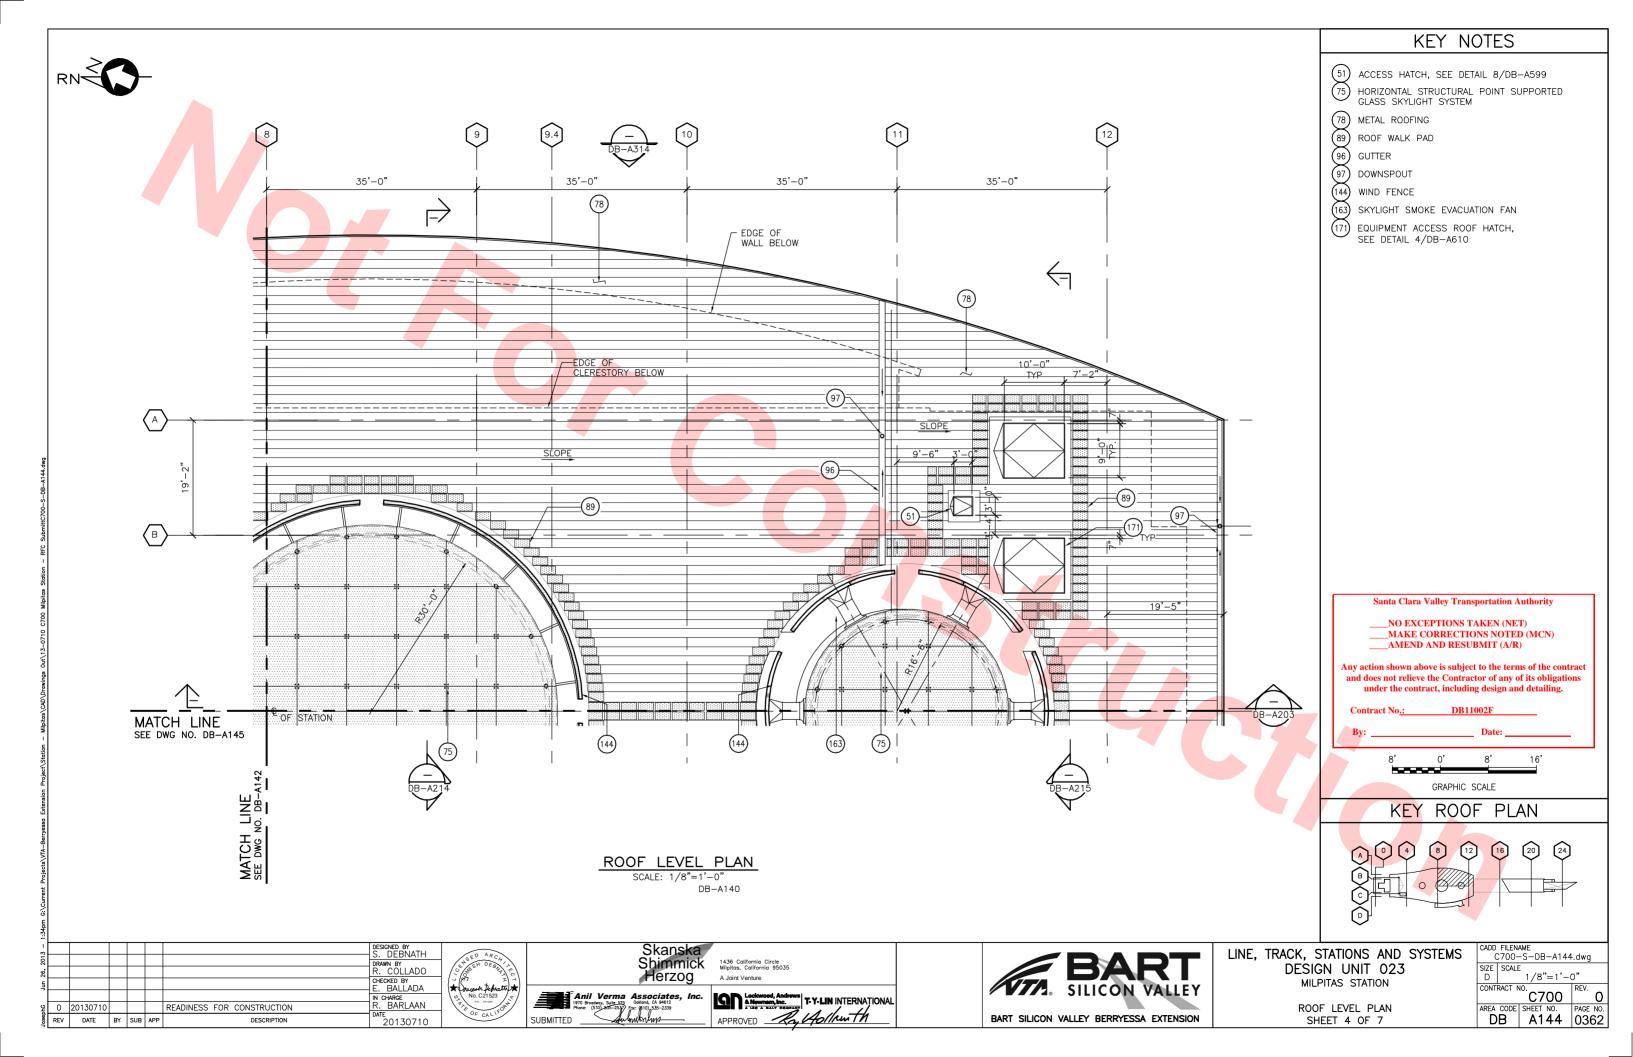


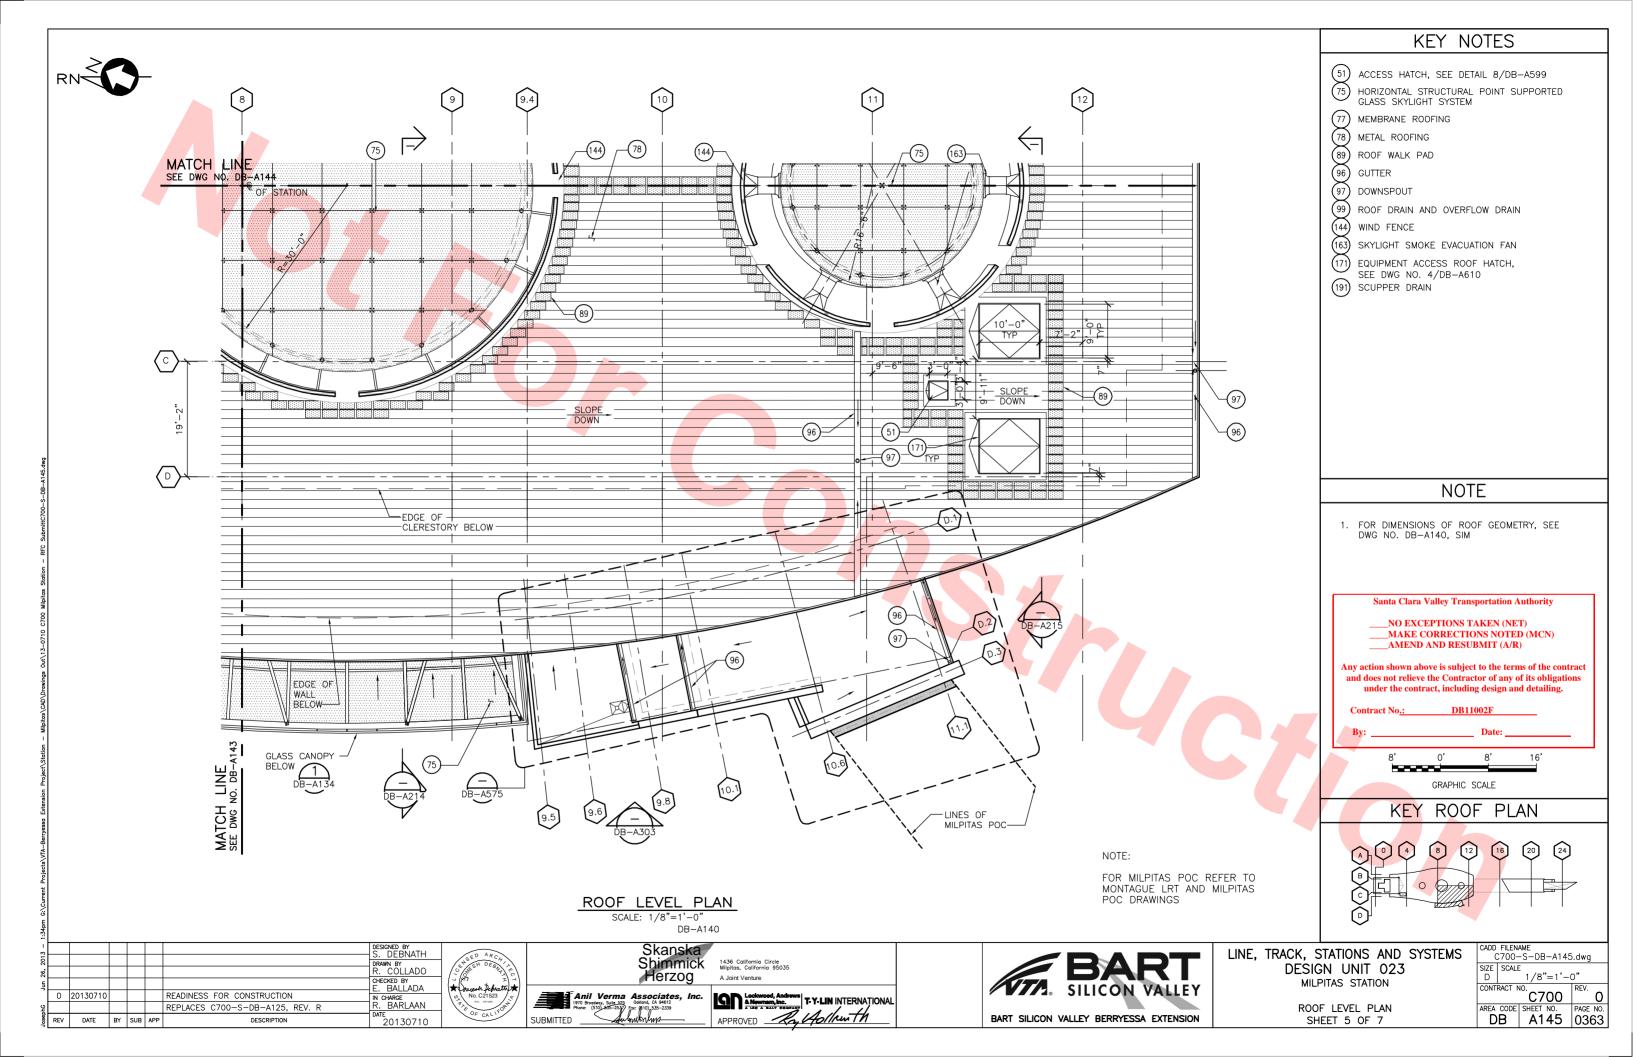


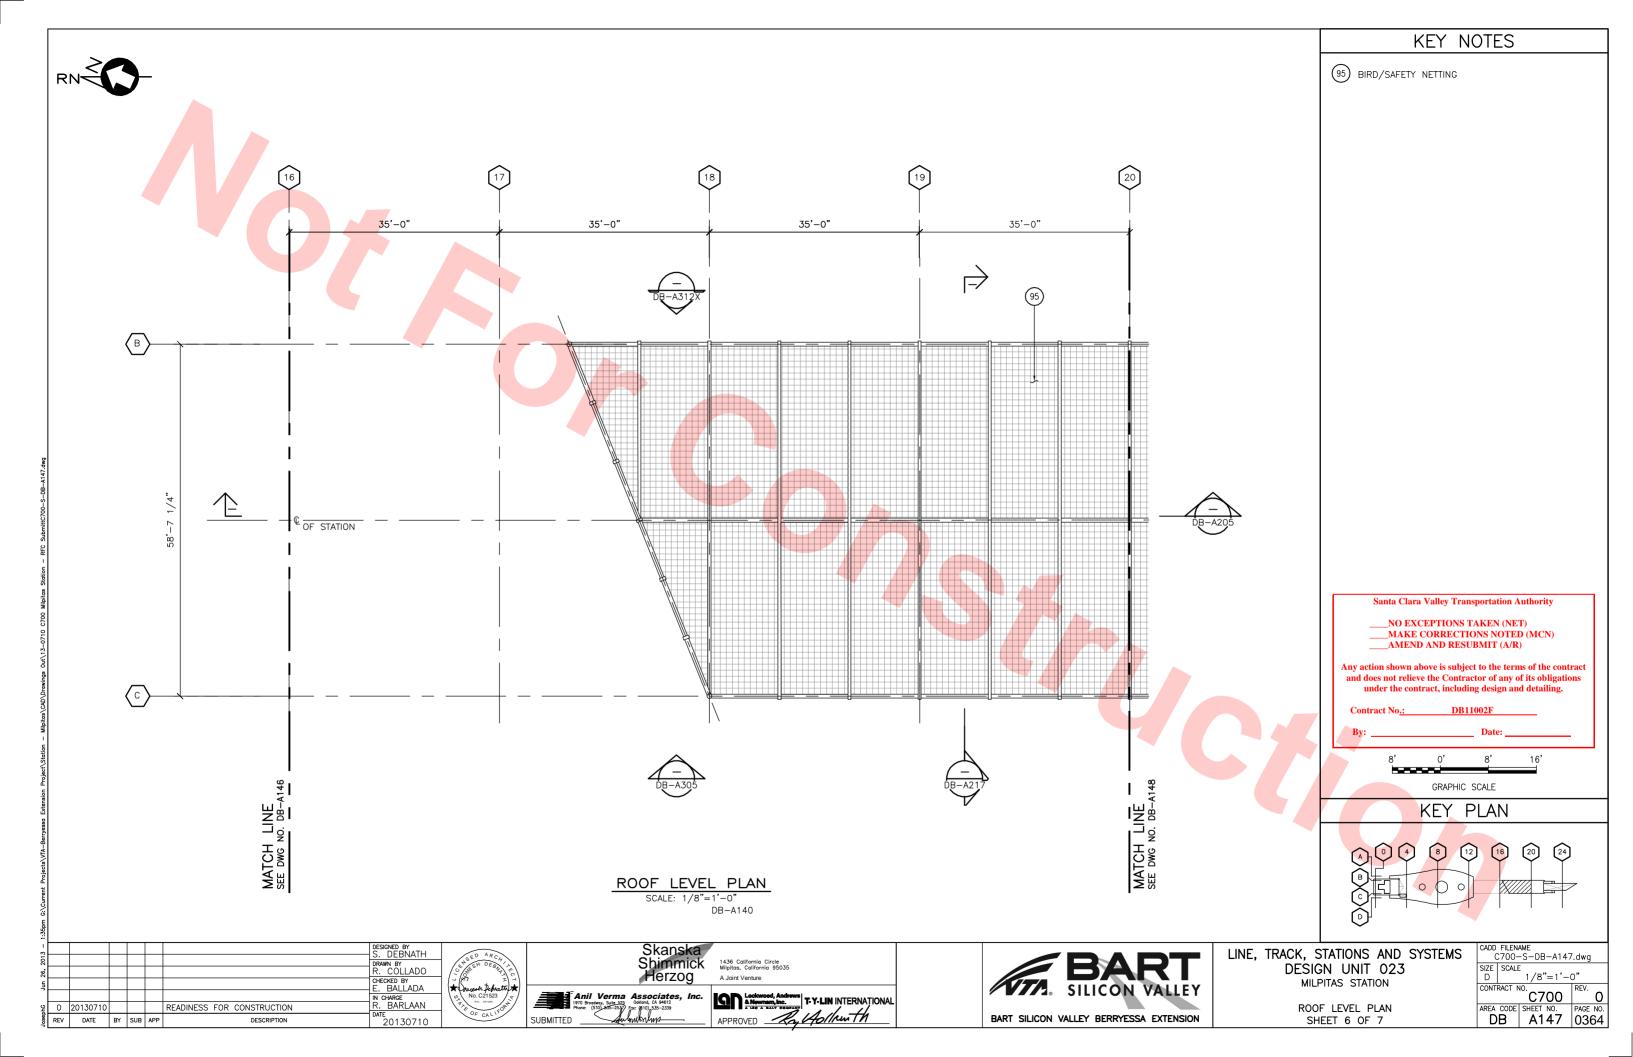


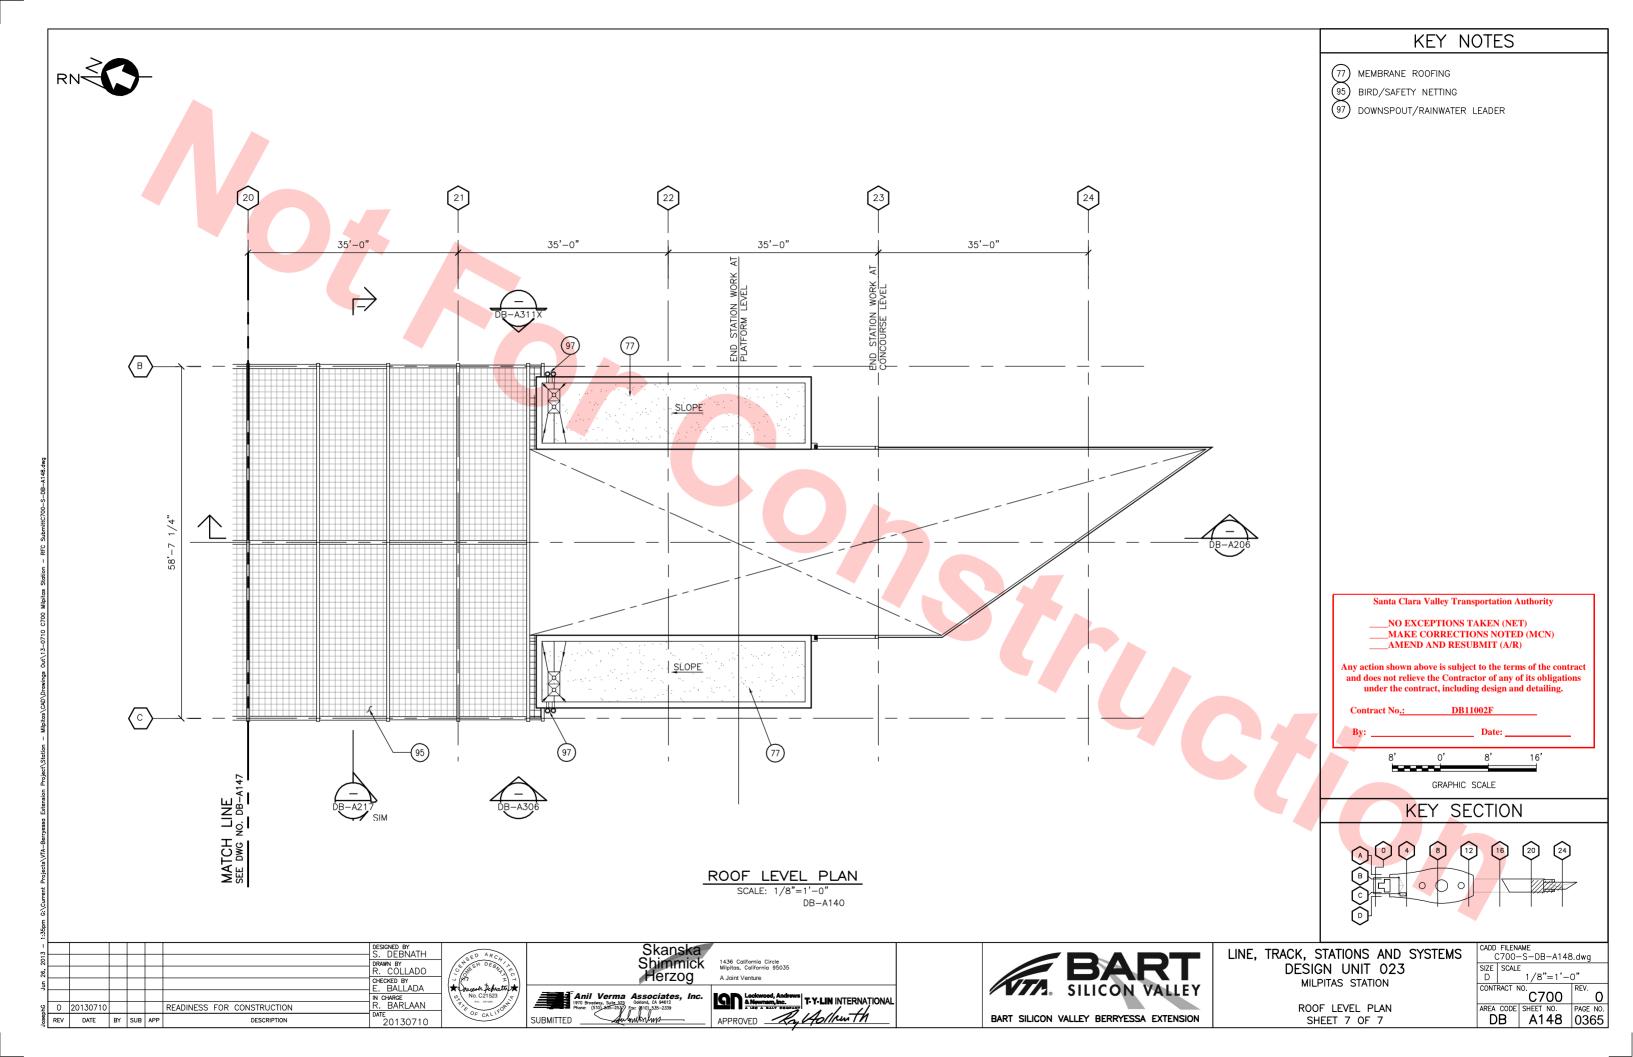


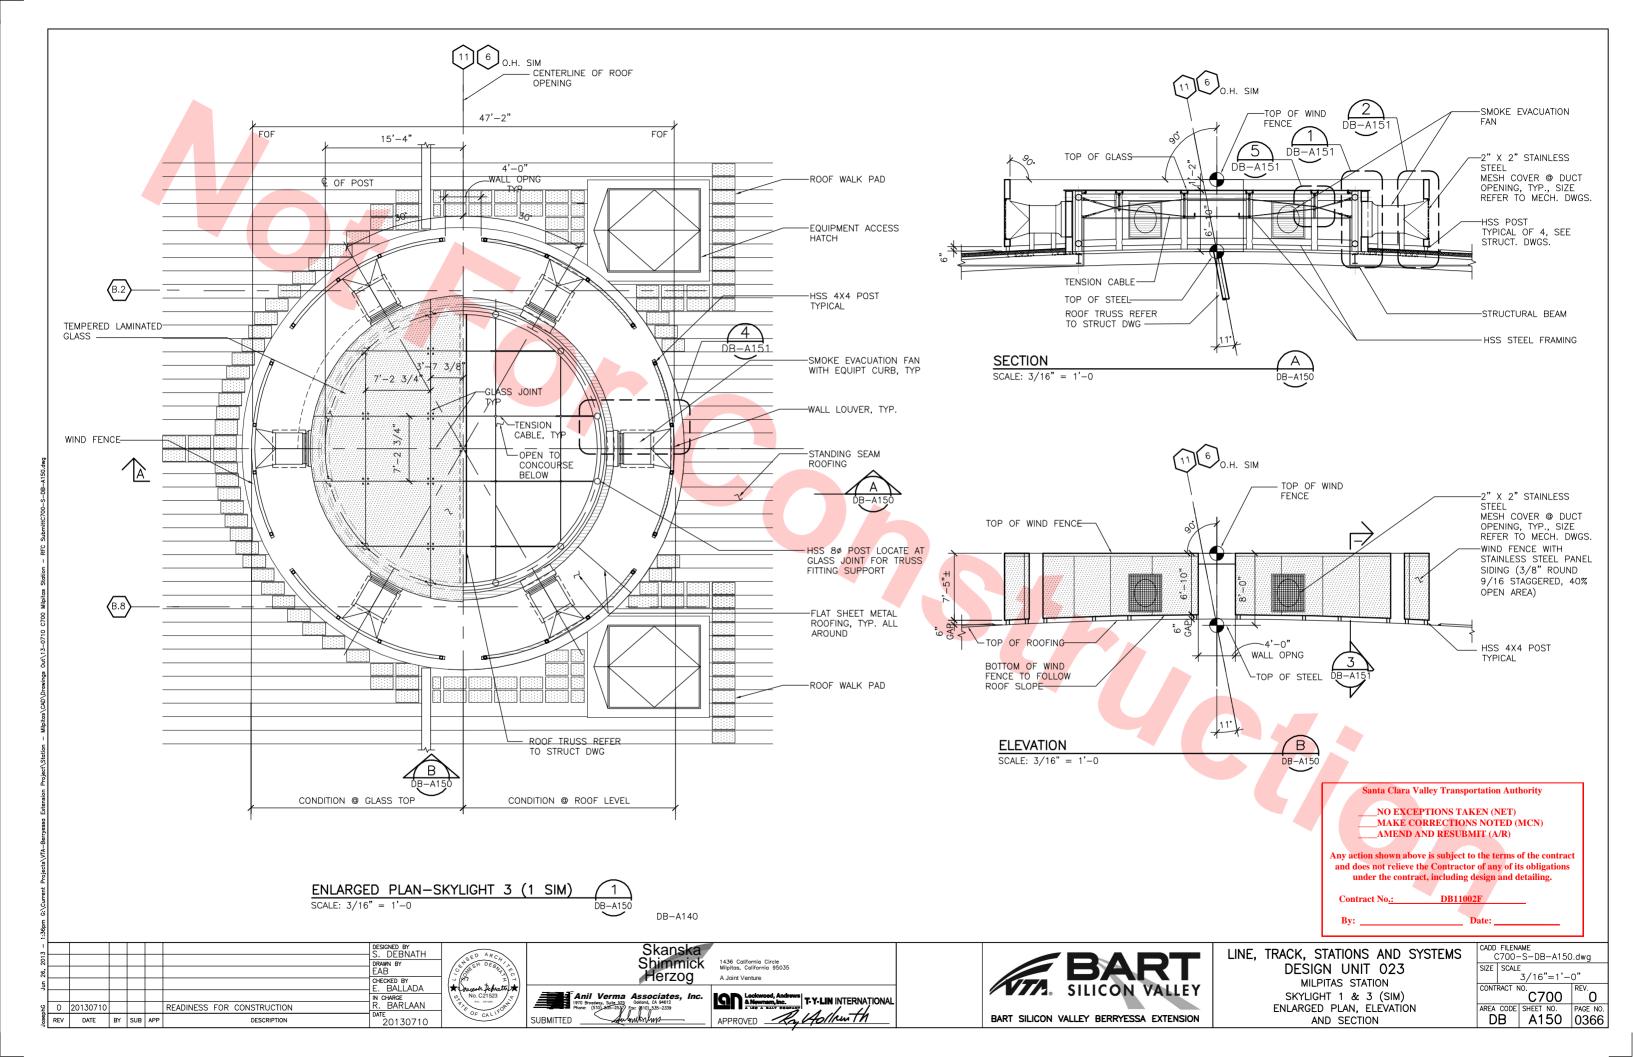


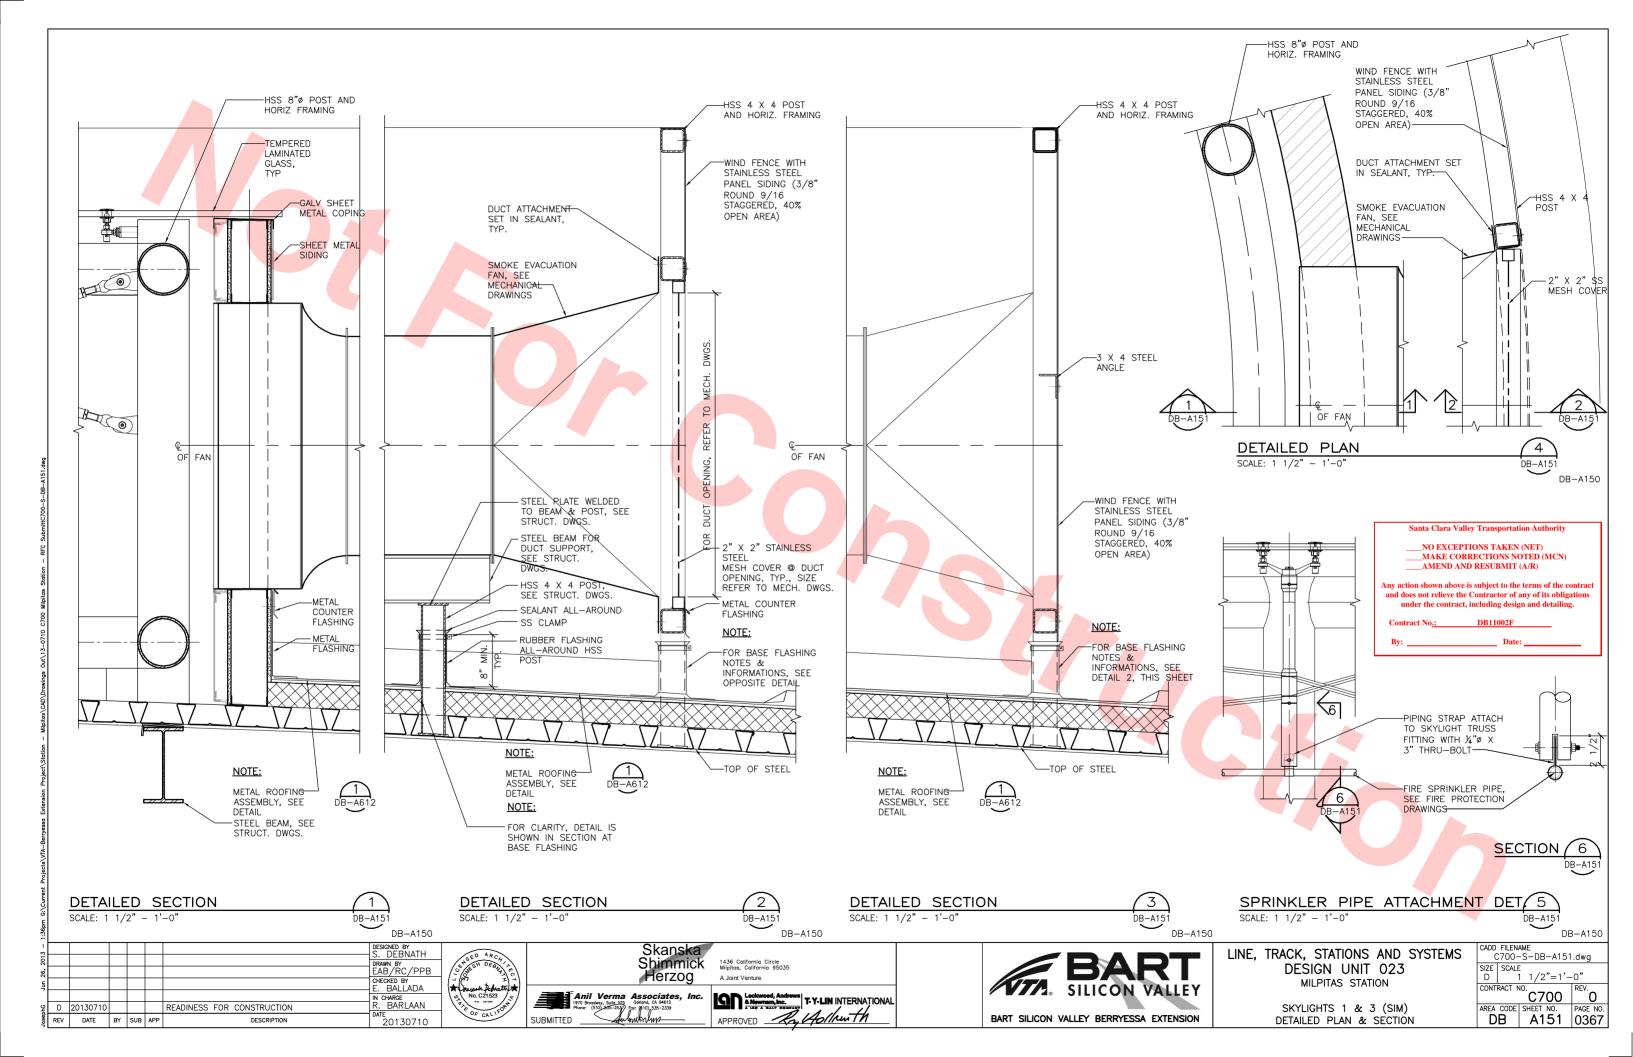

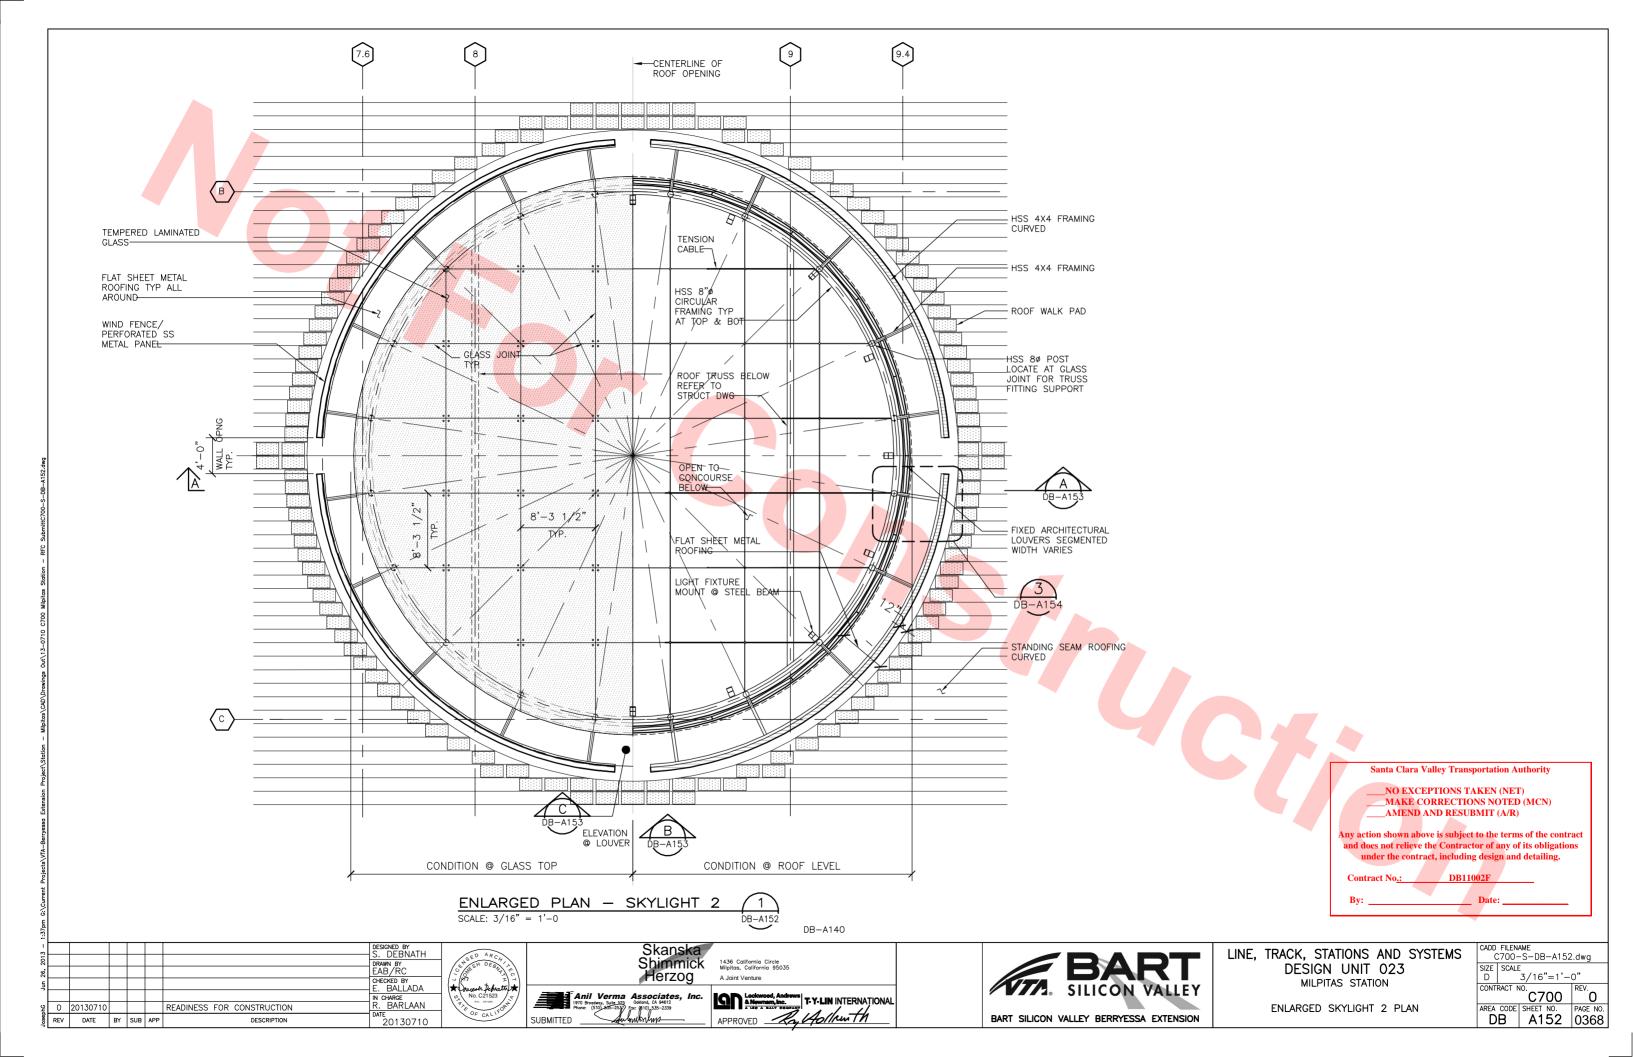

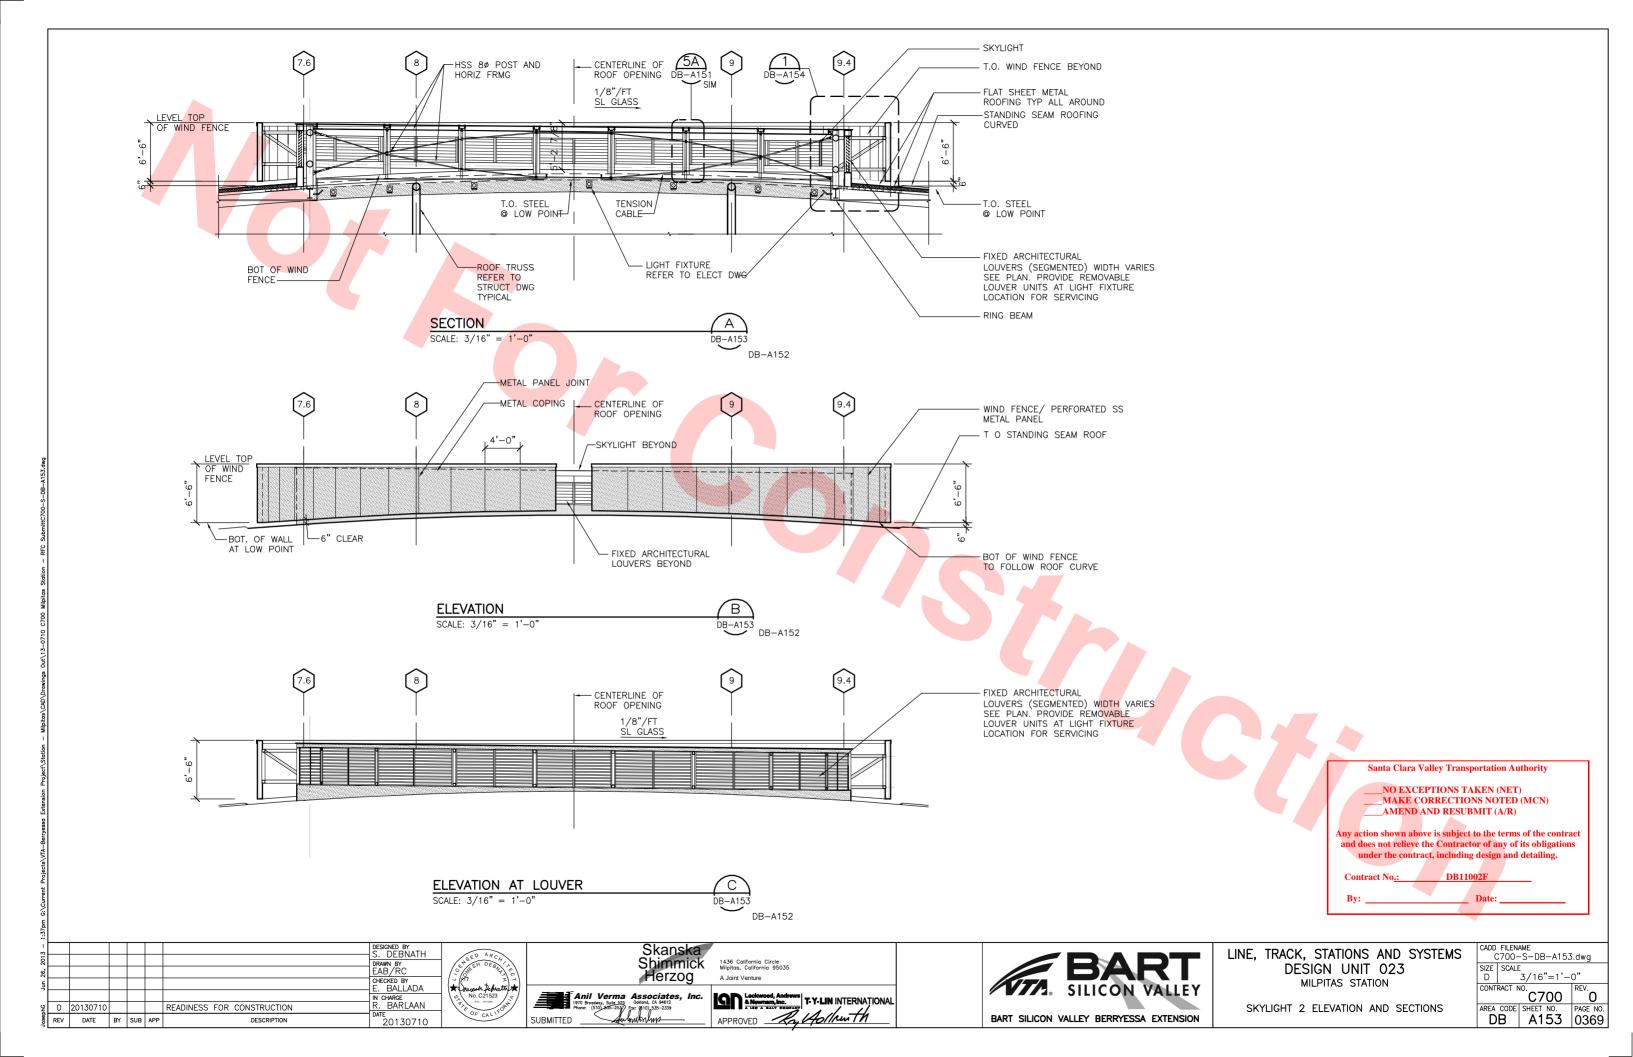

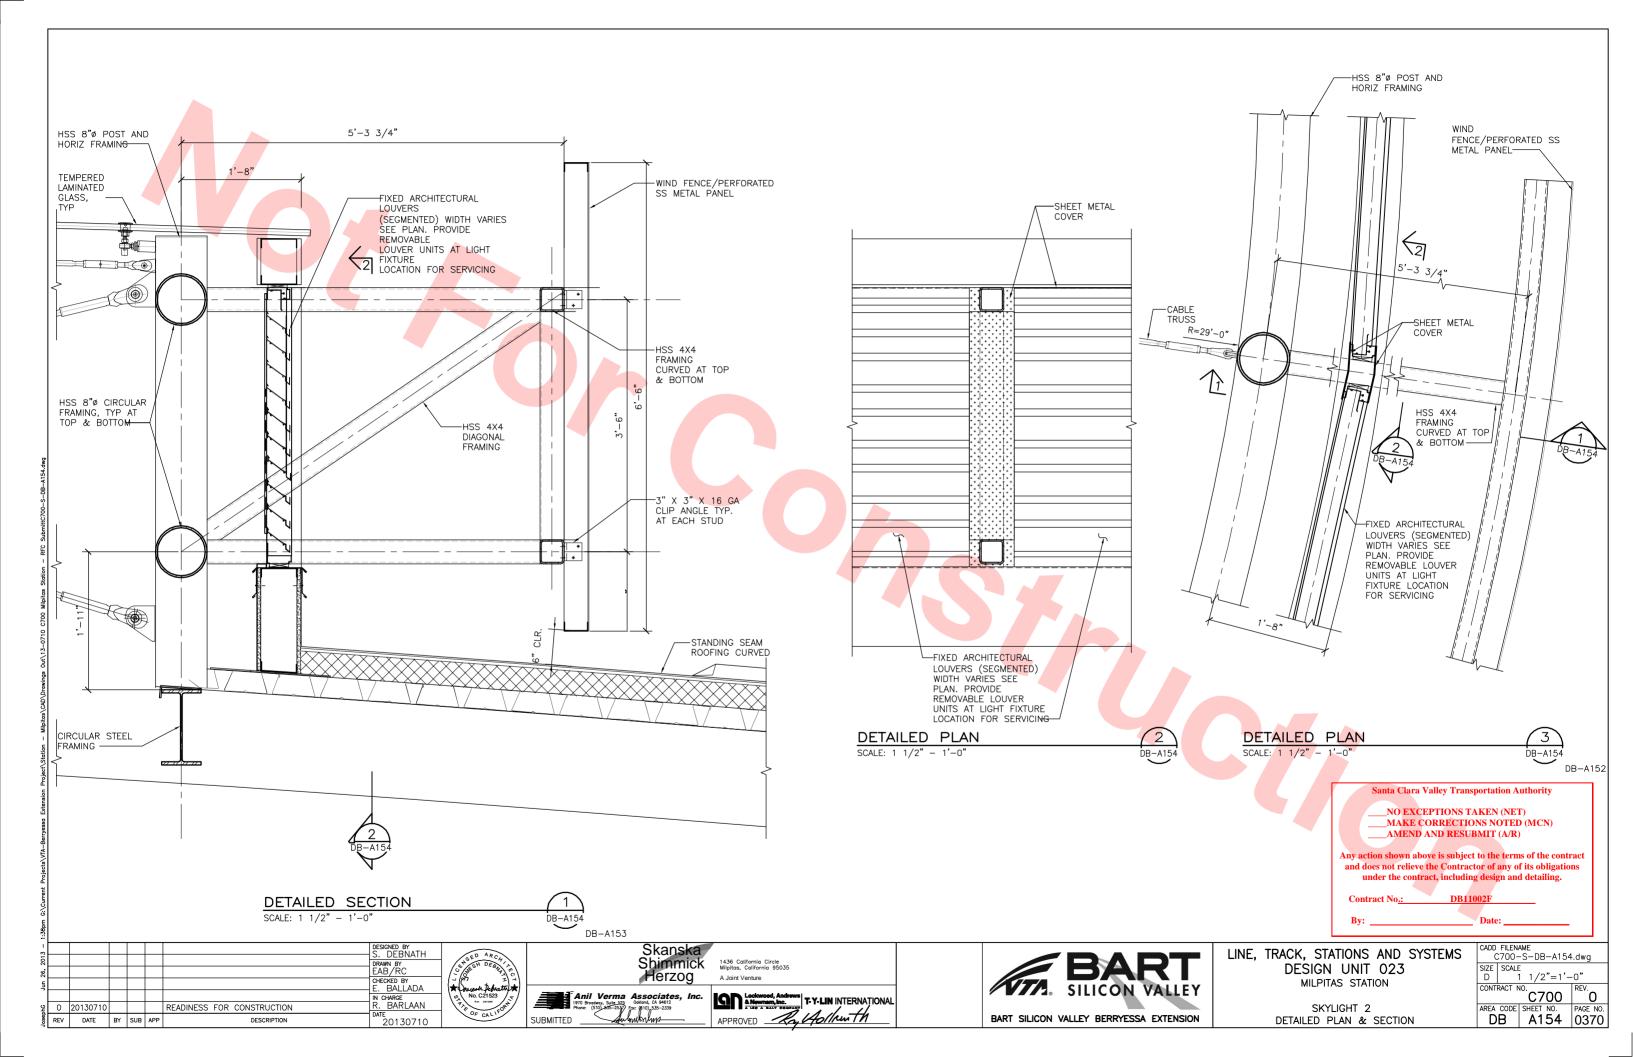

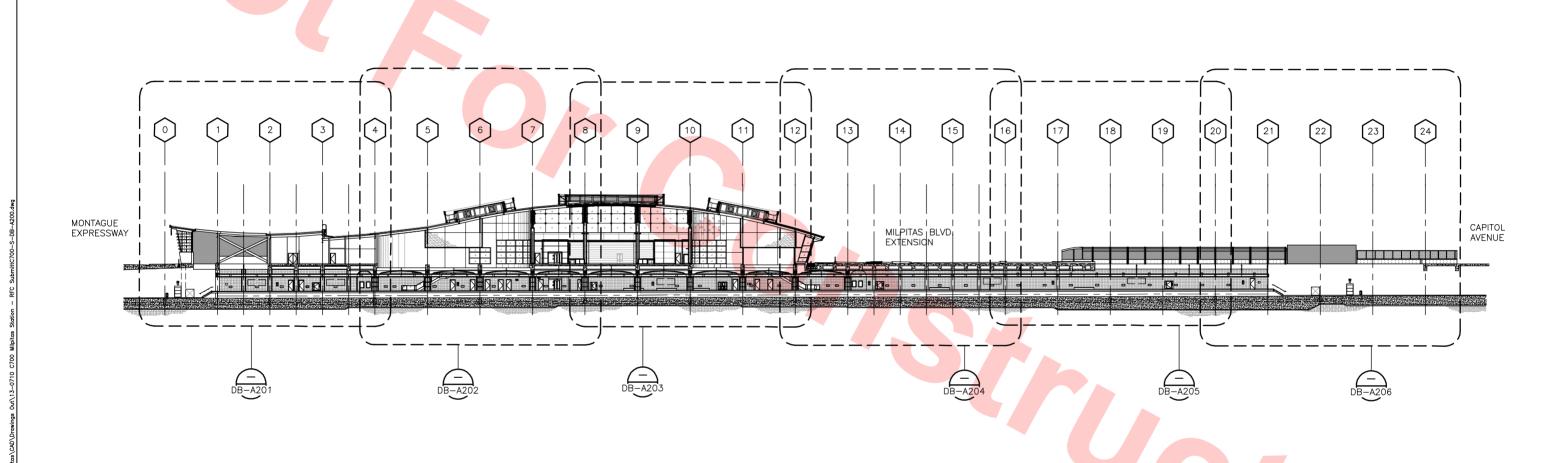

KEY LONGITUDINAL SECTION

SCALE: 1/32"=1'-0"

DB-A090 DB-A110X DB-A120X DB-A130 DB-A140 DB-A400 DB-A410

Santa Clara Valley Transportation Authority

NO EXCEPTIONS TAKEN (NET) MAKE CORRECTIONS NOTED (MCN) AMEND AND RESUBMIT (A/R)

Any action shown above is subject to the terms of the contract and does not relieve the Contractor of any of its obligations under the contract, including design and detailing.

3								
,							DESIGNED BY S. DEBNATH	
7,							DRAWN BY R. COLLADO	
7 III							CHECKED BY E. BALLADA	
							IN CHARGE	
2	0	20130710				READINESS FOR CONSTRUCTION	R. BARLAAN	
200	REV	DATE	BY	SUB	APP	DESCRIPTION	DATE 20130710	



Skanska	
Shimmick	1436 California Circle Milpitas, California 95035
Herzog	A Joint Venture
Verma Associates, Inc.	Lockwood, Andrews T-Y-LIN INTERNAT
y, Suite 525 Oakland, CA 94612 1-555-2537 Fax: (610) 535-2339	A 180 A BALLY COMPANY
Awarden las	APPROVED Ray Apollow th
	•


1436 California Circle Milpitas, California 95035 Leckwood, Andrews a ... T.Y.LIN INTERNATIONAL



LINE, TRACK, STATIONS AND SYSTEMS
DESIGN UNIT 023
MILPITAS STATION

KEY	SECTION
LONG	SITUDINAL

S		FILEN. C700-		-A200	dwg.	
	SIZE D	SCALE	1/32	"=1'-	0"	
		RACT N	C7	REV.	0	
		CODE	SHEET A2	NO. .00	PAGE 037	

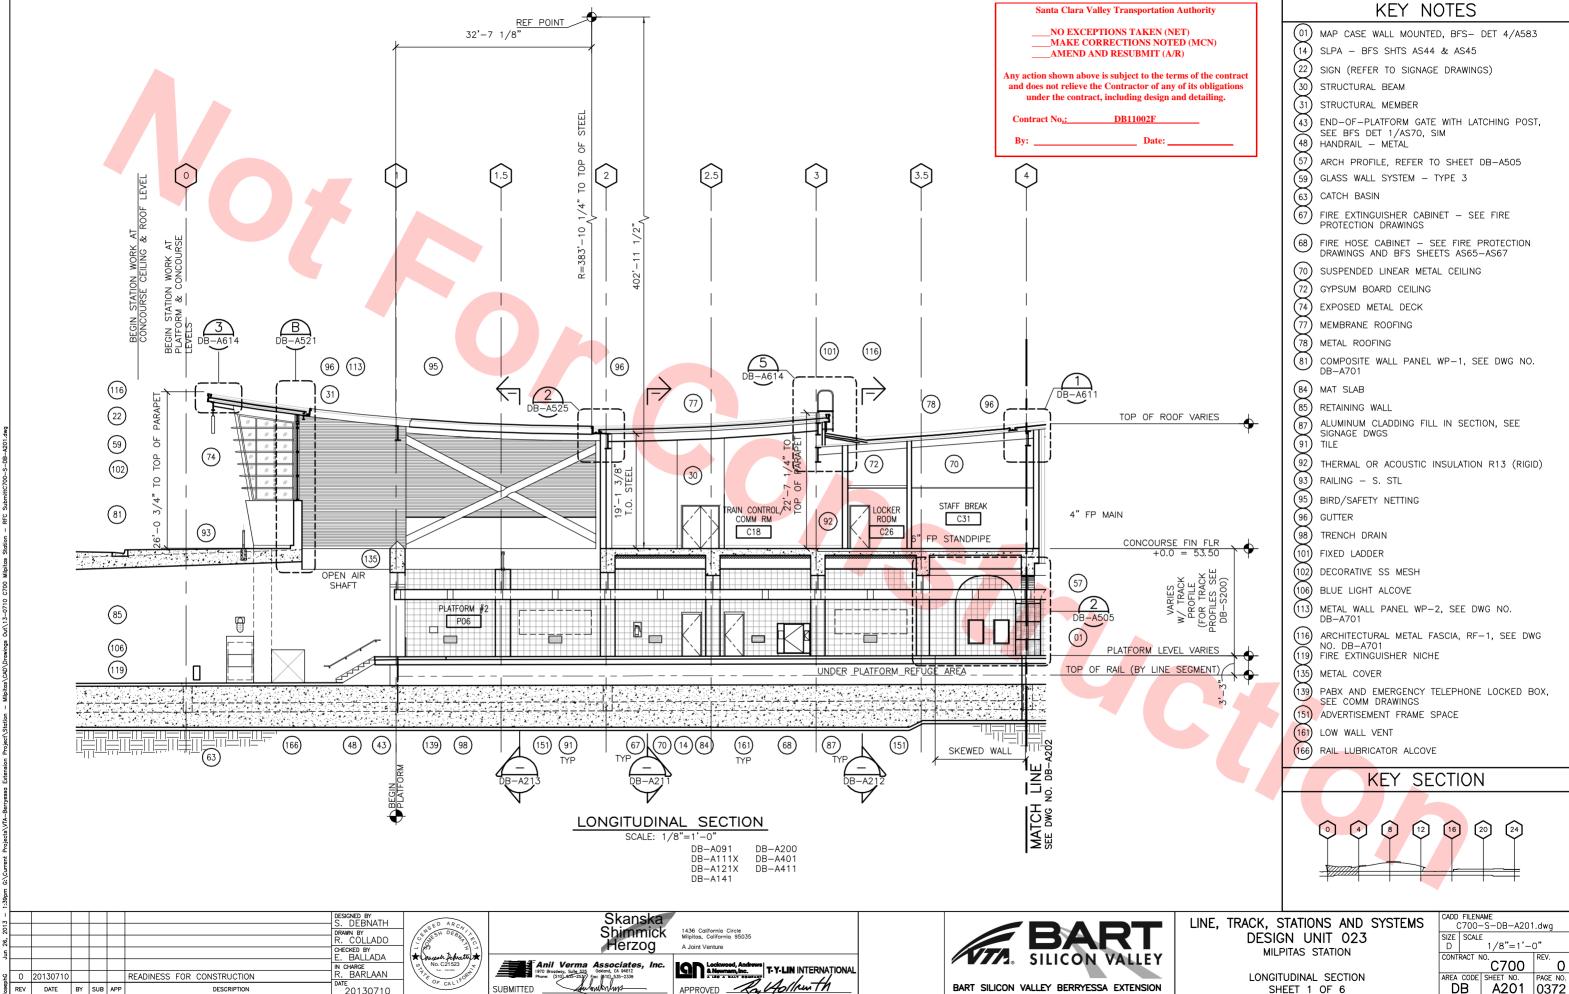


20130710


REV DATE BY SUB APP


BART SILICON VALLEY BERRYESSA EXTENSION


DB A201 0372


SHEET 1 OF 6

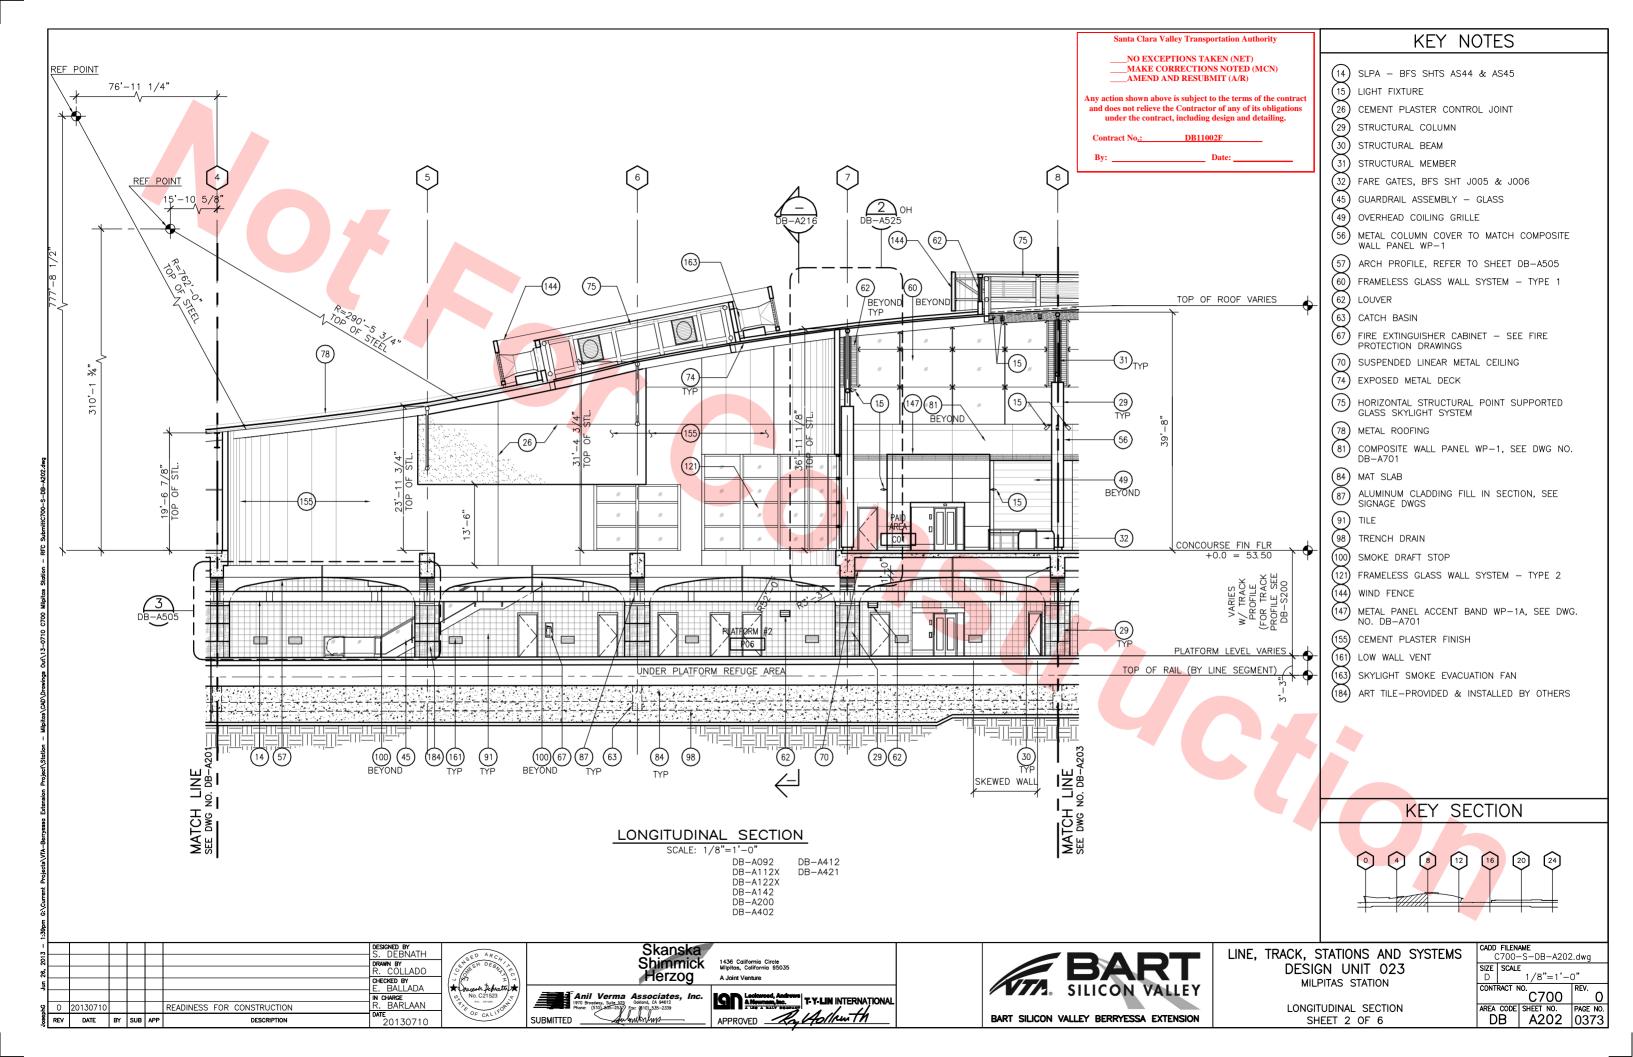


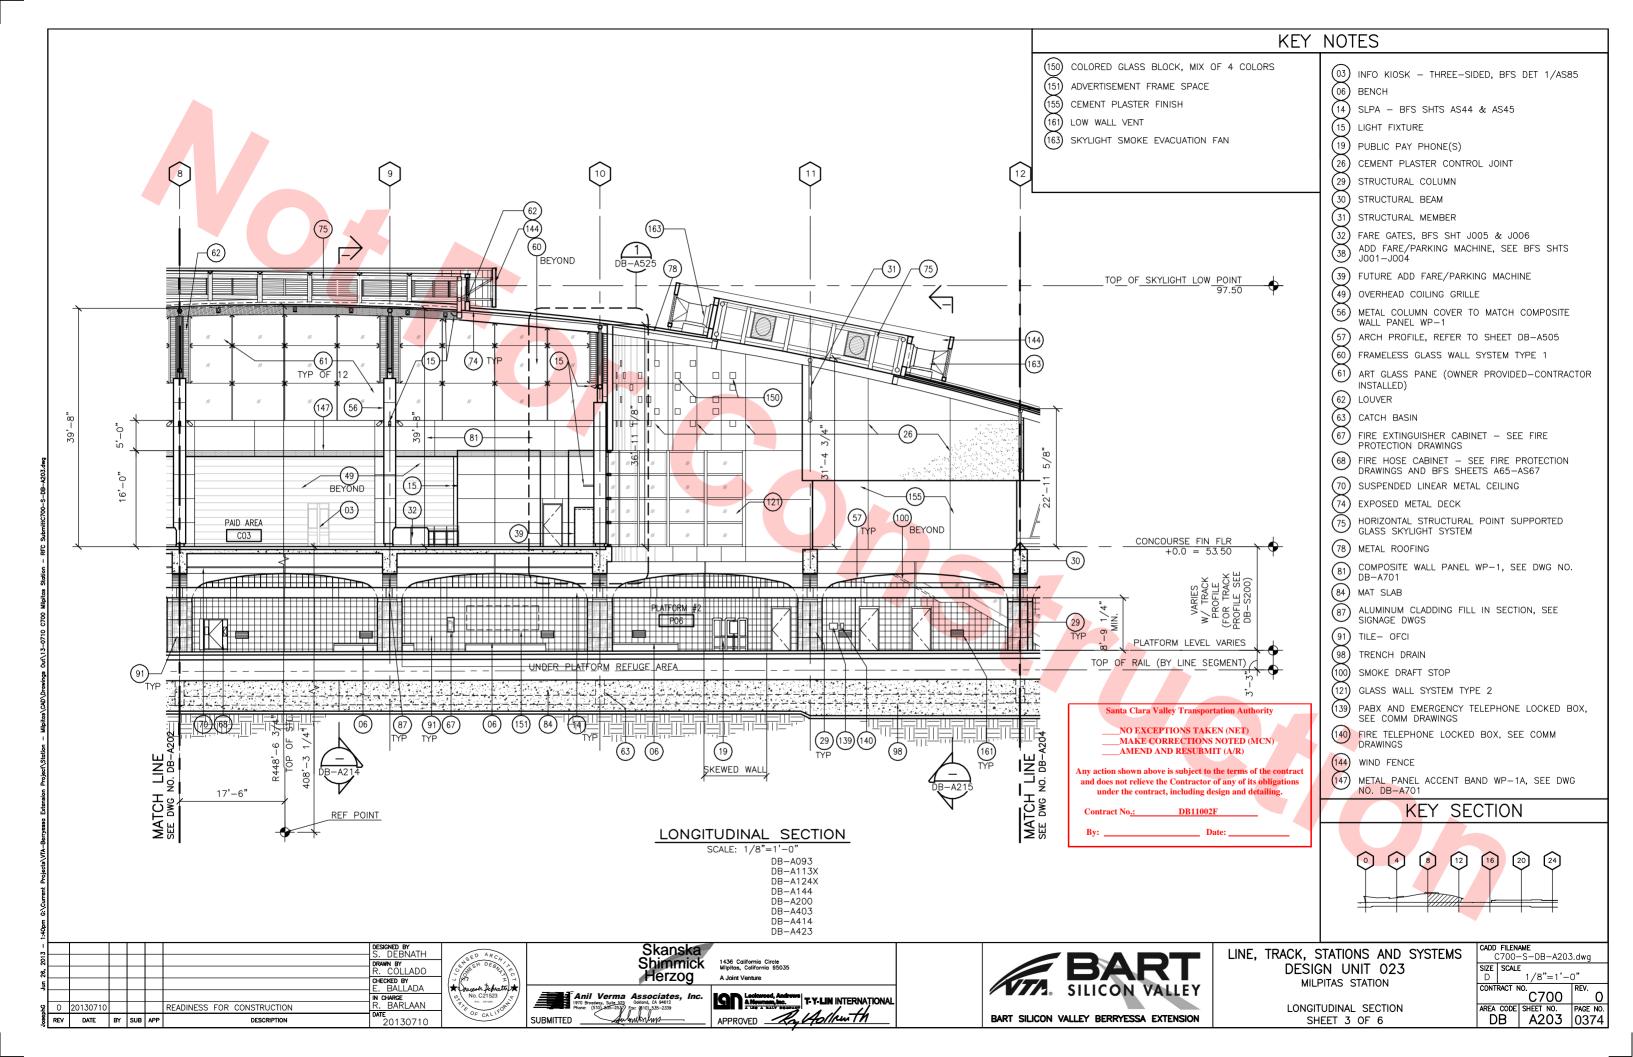

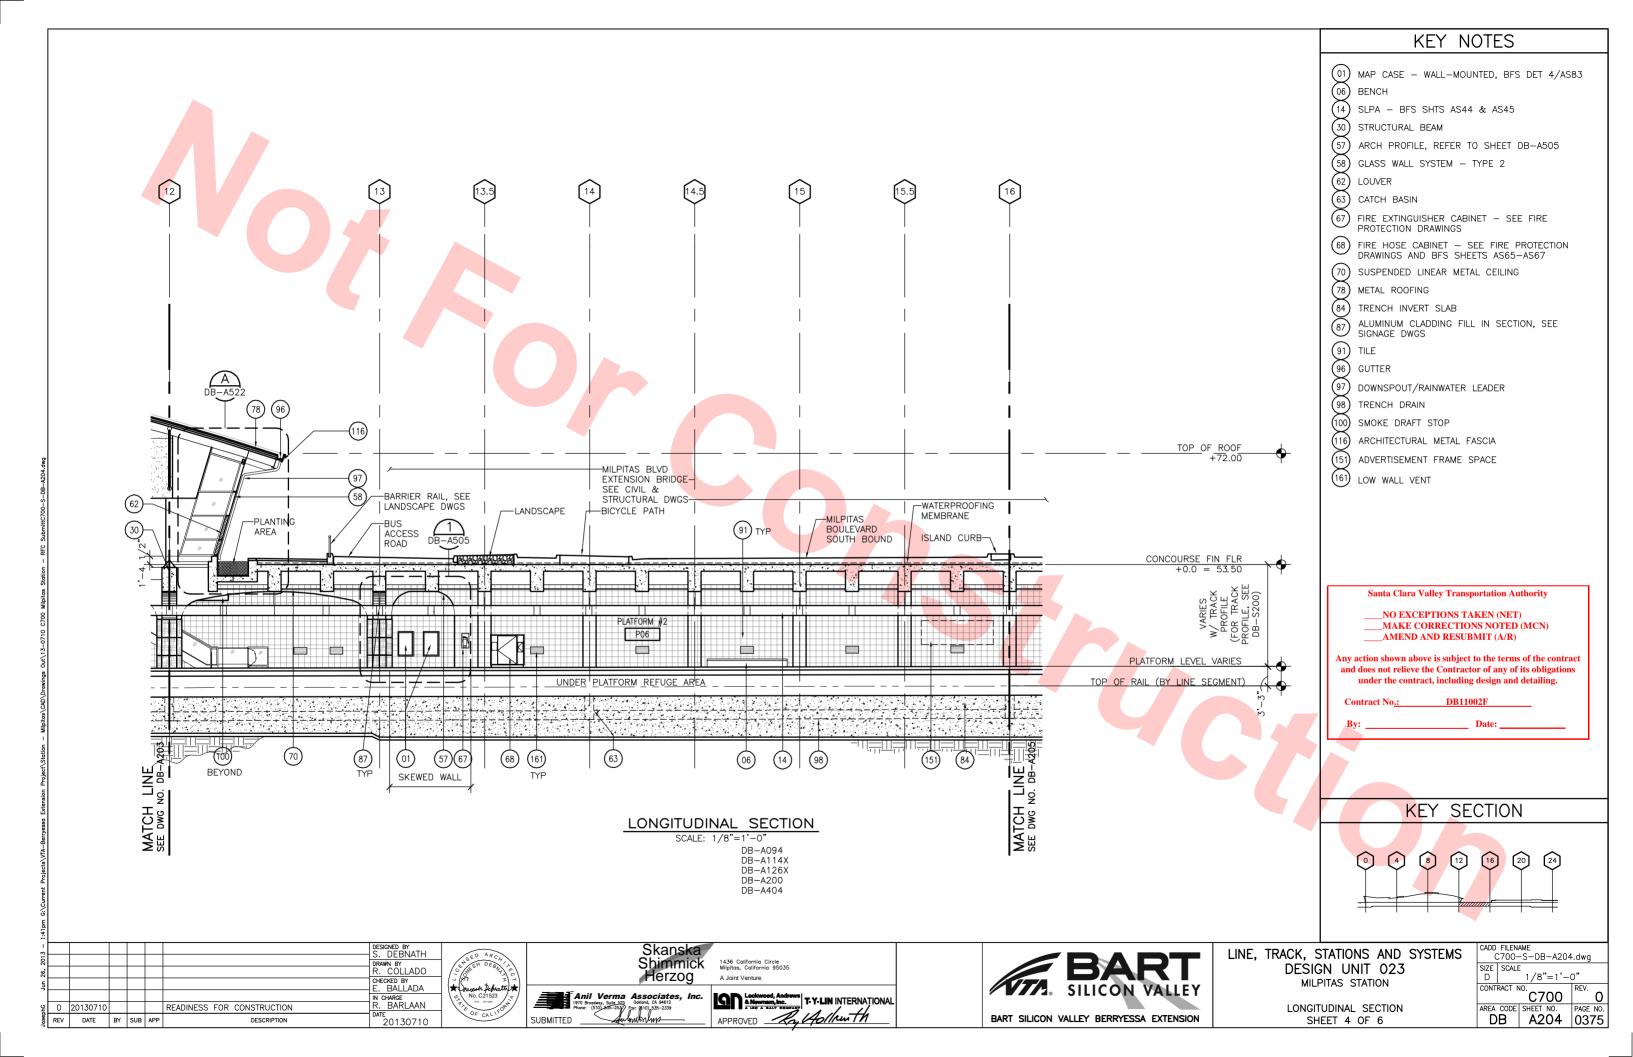

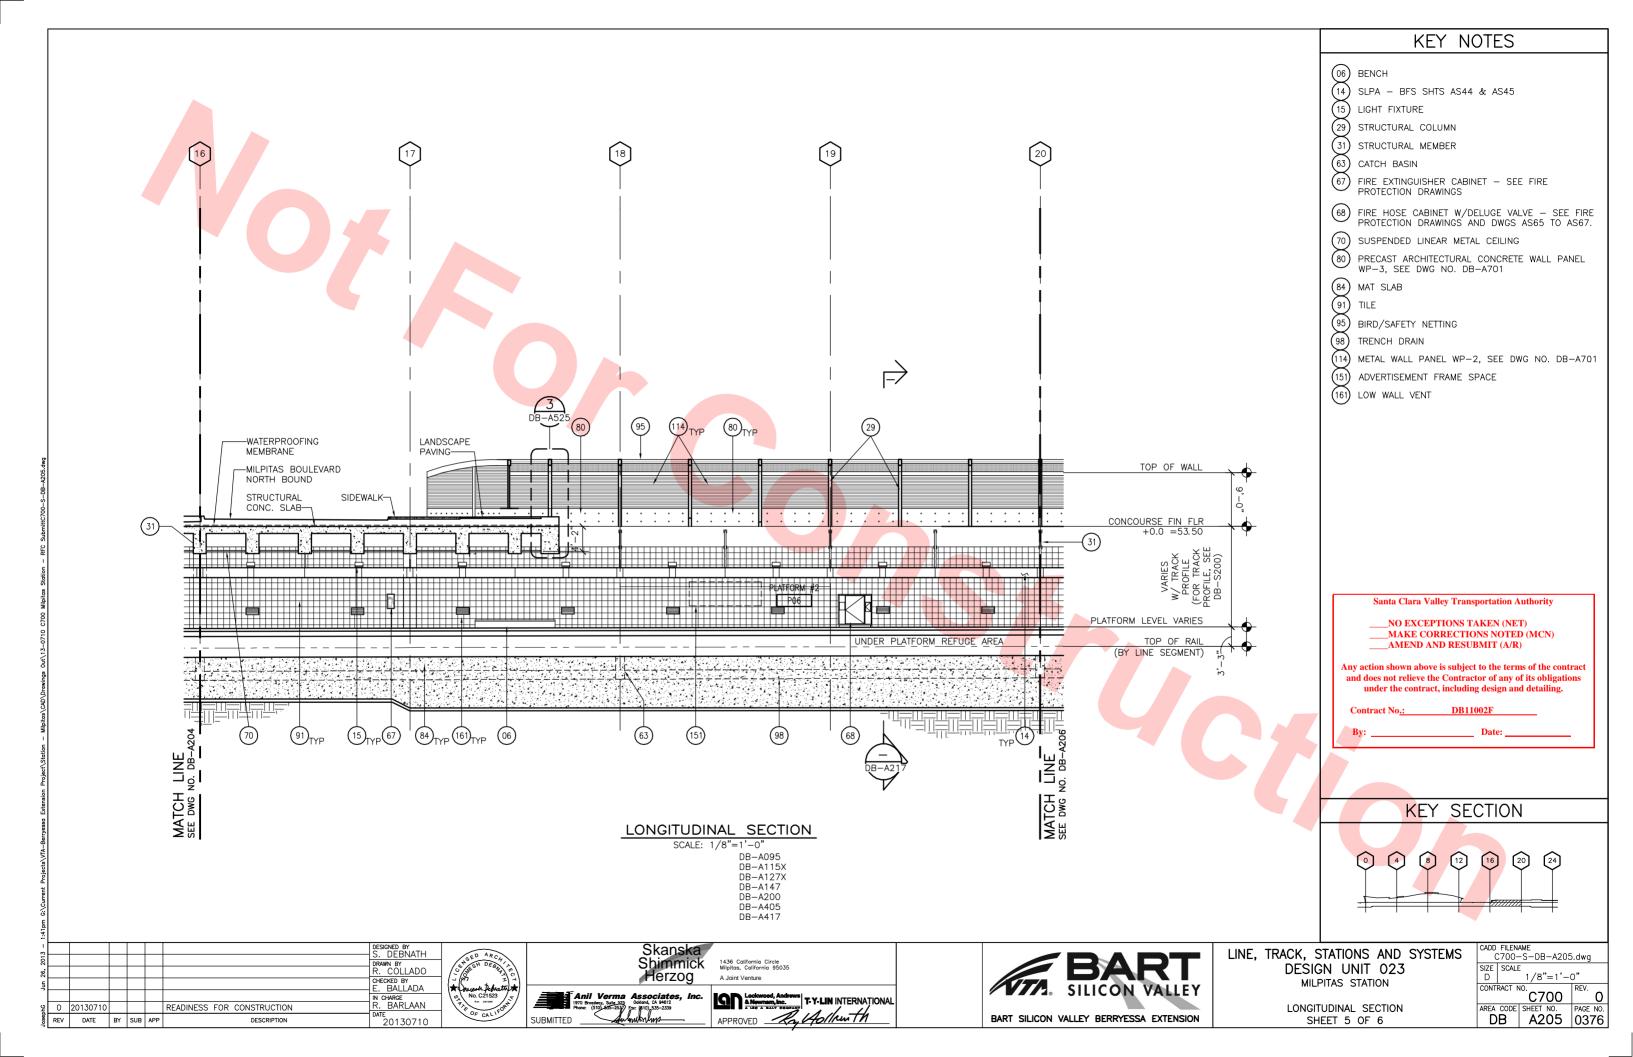

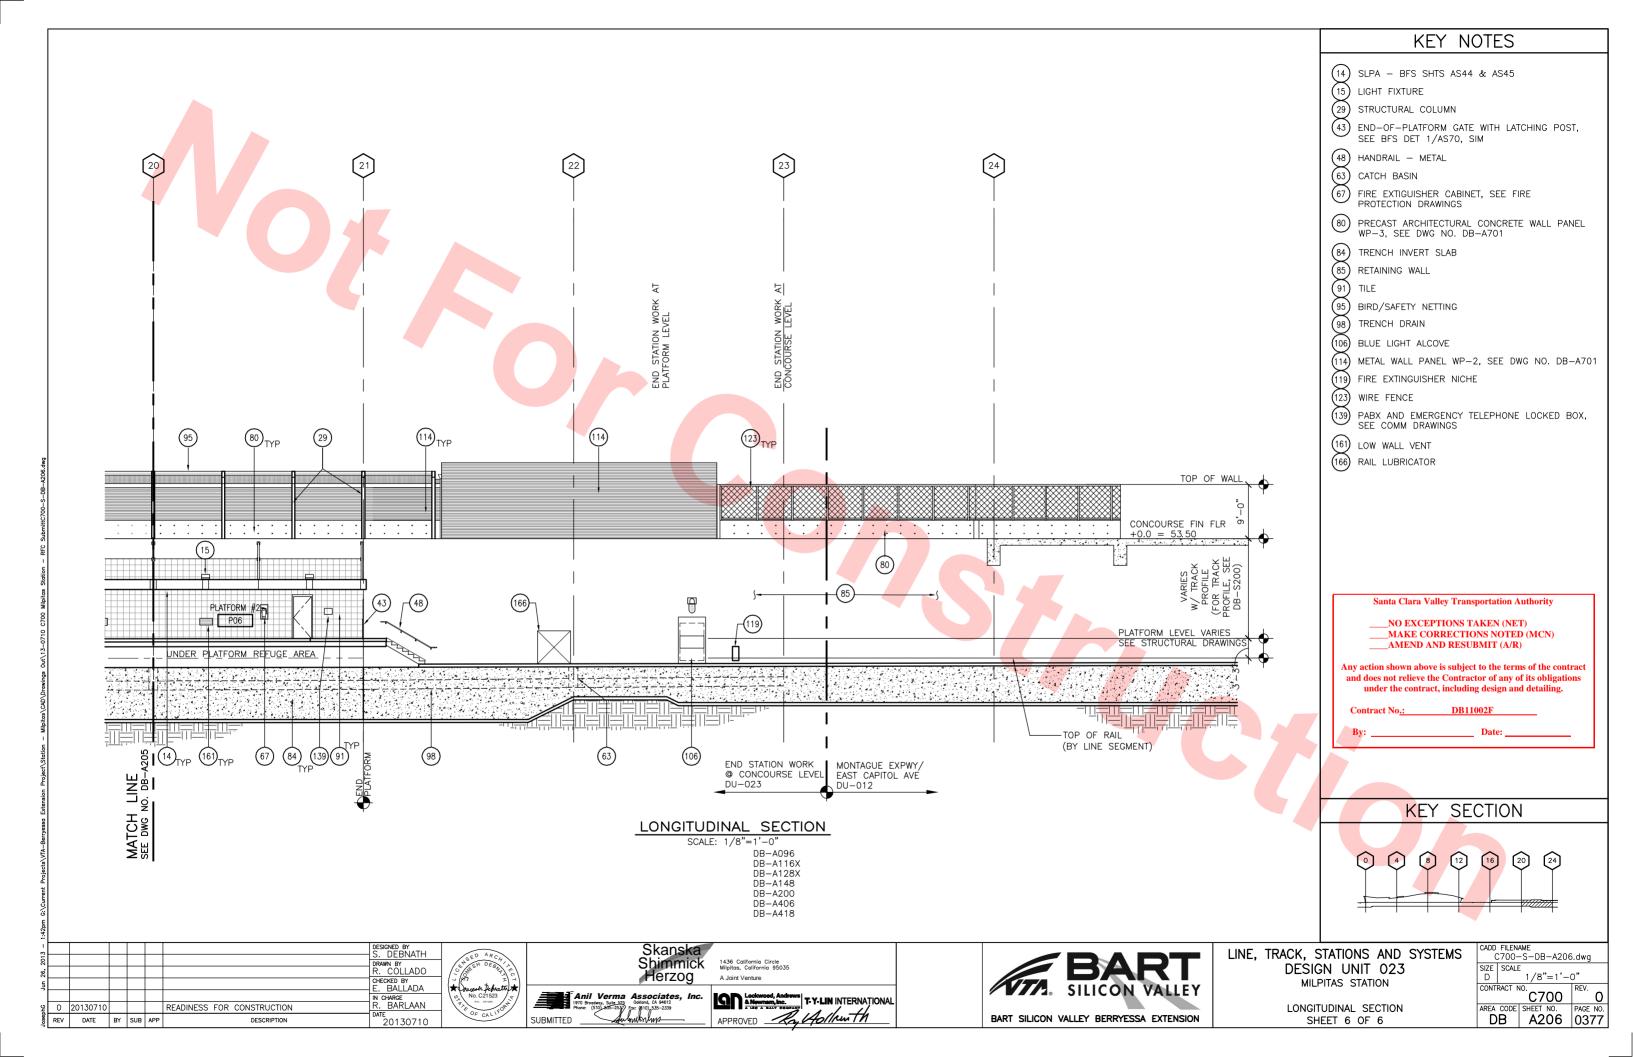

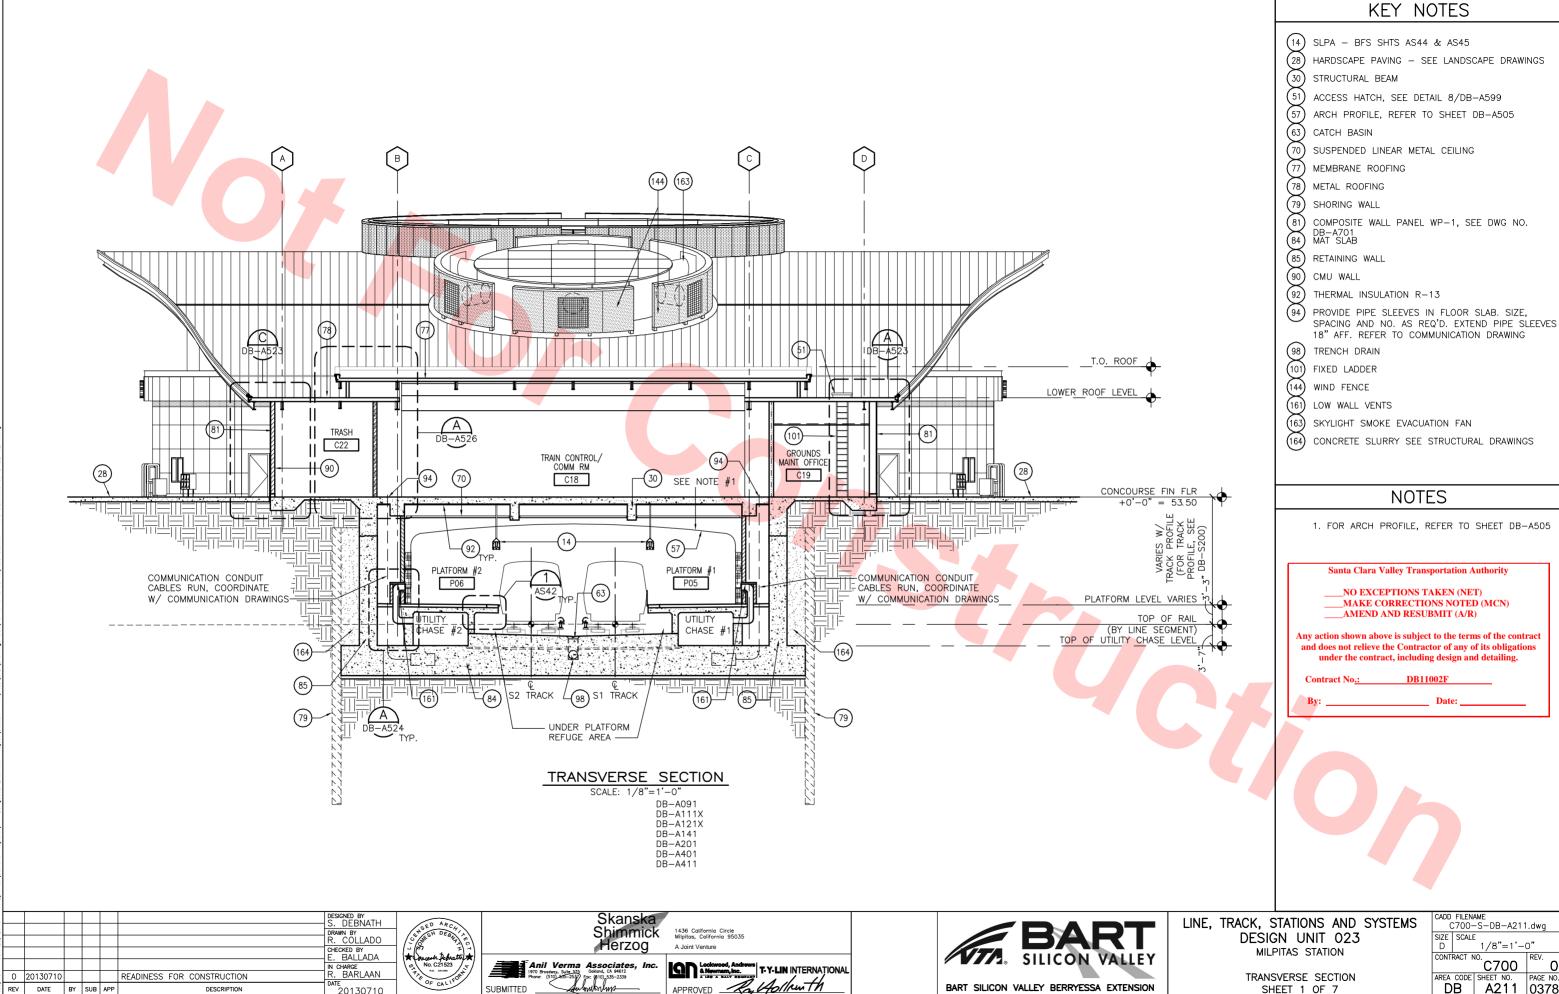


20130710


REV DATE BY SUB APP

BART SILICON VALLEY BERRYESSA EXTENSION

TRANSVERSE SECTION SHEET 1 OF 7

DB A211 0378

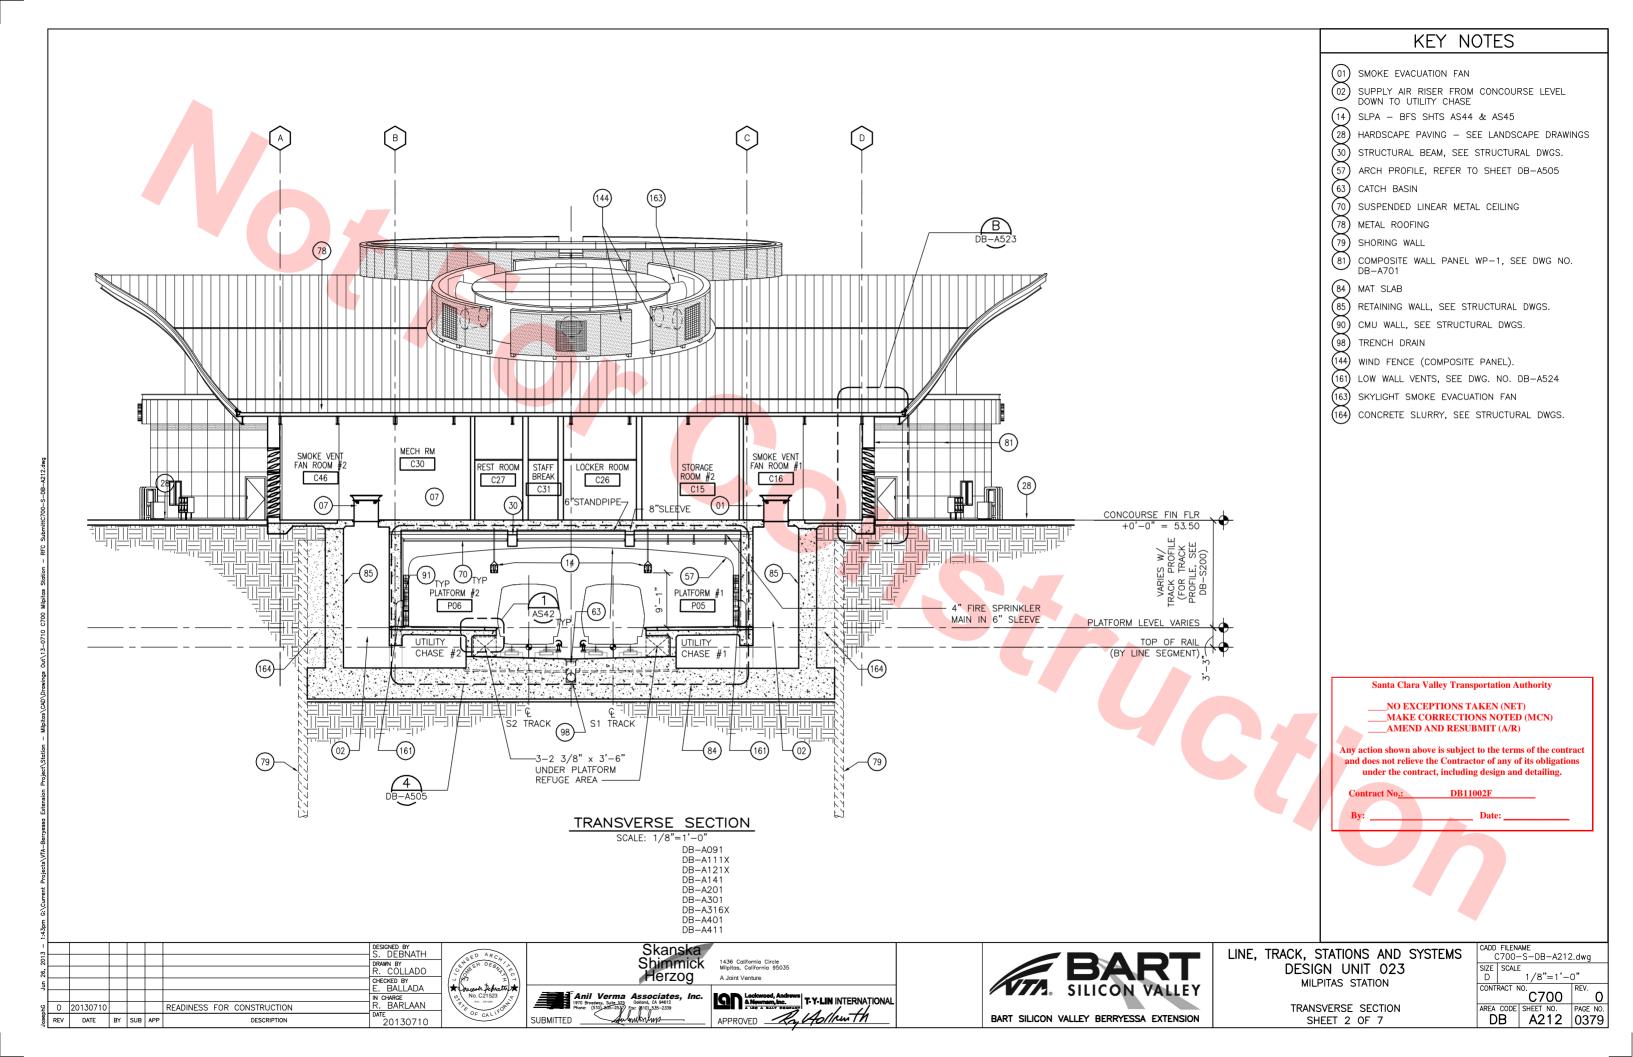

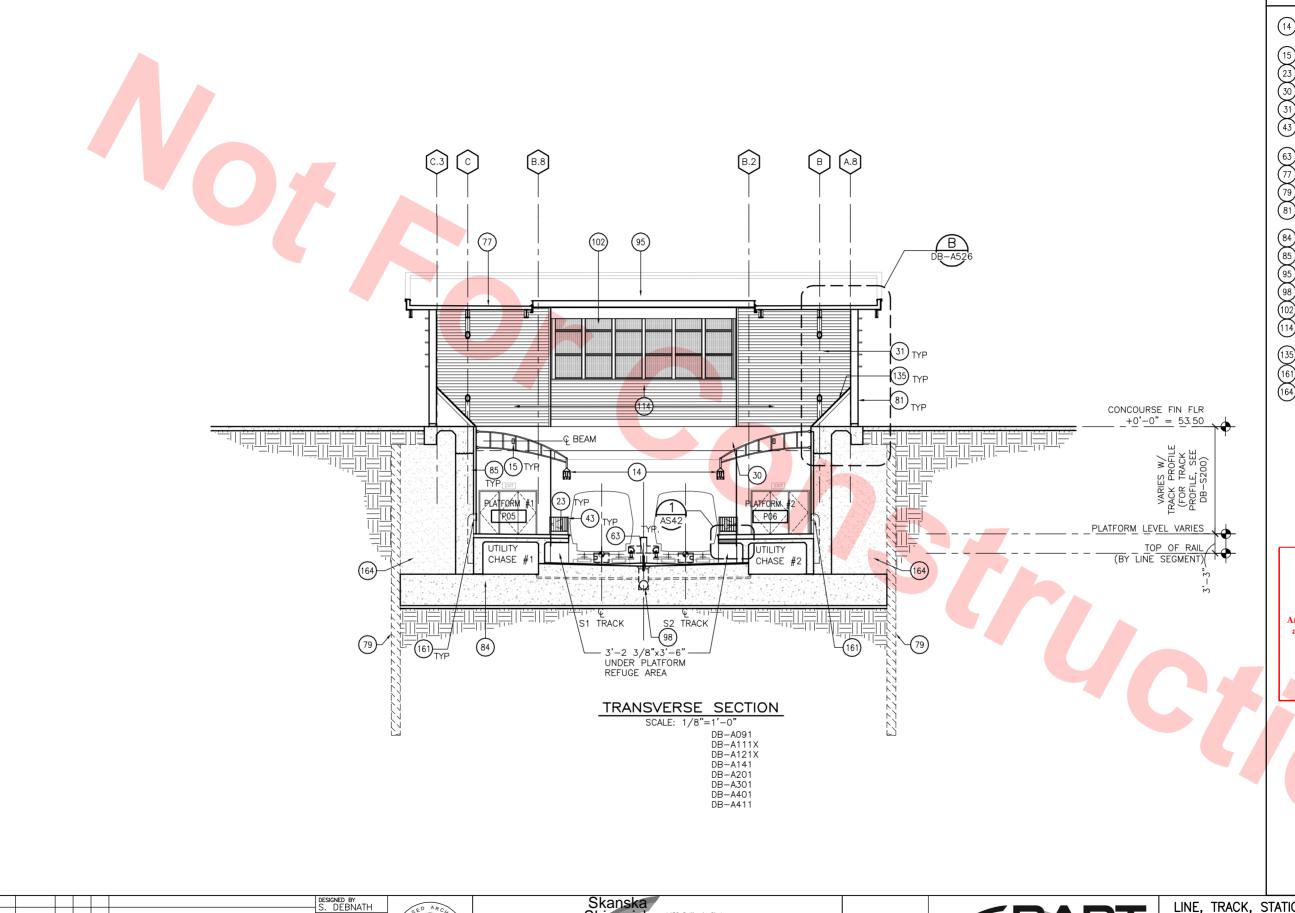

KEY NOTES

- SLPA SEE BFS SHTS AS44, AS45 AND SEE ELEC/COMM/SECURITY DWGS.
- (15) LIGHT FIXTURE
- (23) TACTILE WARNING BAND, BFS DET 5/AS42
- (30) STRUCTURAL BEAM
- (31) STRUCTURAL MEMBER
- END-OF-PLATFORM GATE WITH LATCHING POST, SEE BFS DET 1/AS70, SIM
- 63) CATCH BASIN

 77) MEMBRANE ROOFING
- (79) SHORING WALL
- (81) COMPOSITE WALL PANEL WP-1, SEE DWG NO. DB-A701
- (84) MAT SLAB
- (85) RETAINING WALL
- 95) BIRD/SAFETY NETTING
- 98) TRENCH DRAIN
- (102) DECORATIVE SS MESH
- METAL WALL PANEL WP-2, SEE DWG NO. DB-A701
- (135) SHEET COVER
- (161) LOW WALL VENTS

(164) CONCRETE SLURRY SEE STRUCTURAL DRAWINGS

Santa Clara Valley Transportation Authority

___NO EXCEPTIONS TAKEN (NET) ____MAKE CORRECTIONS NOTED (MCN) AMEND AND RESUBMIT (A/R)

Any action shown above is subject to the terms of the contract and does not relieve the Contractor of any of its obligations under the contract, including design and detailing.

osebuc	REV	DATE	BY	SUB	APP	DESCRIPTION	DATE 20130710
2	0	20130710				READINESS FOR CONSTRUCTION	R. BARLAAN
							IN CHARGE
un C							CHECKED BY E. BALLADA
97							R. COLLADO
5							DRAWN BY
1							DESIGNED BY S. DEBNATH
							










LINE, TRACK, STATIONS AND SYSTEMS DESIGN UNIT 023 MILPITAS STATION

> TRANSVERSE SECTION SHEET 3 OF 7

CADD FILENAME C700-S-DB-A213.dwg										
SIZE D	SCALE	'=1'-	ວ"							
CONT	RACT N	^{10.} C7	00	REV.	0					
AREA	CODE	SHEET		PAGE						
ט	В	A2	13	038	30					

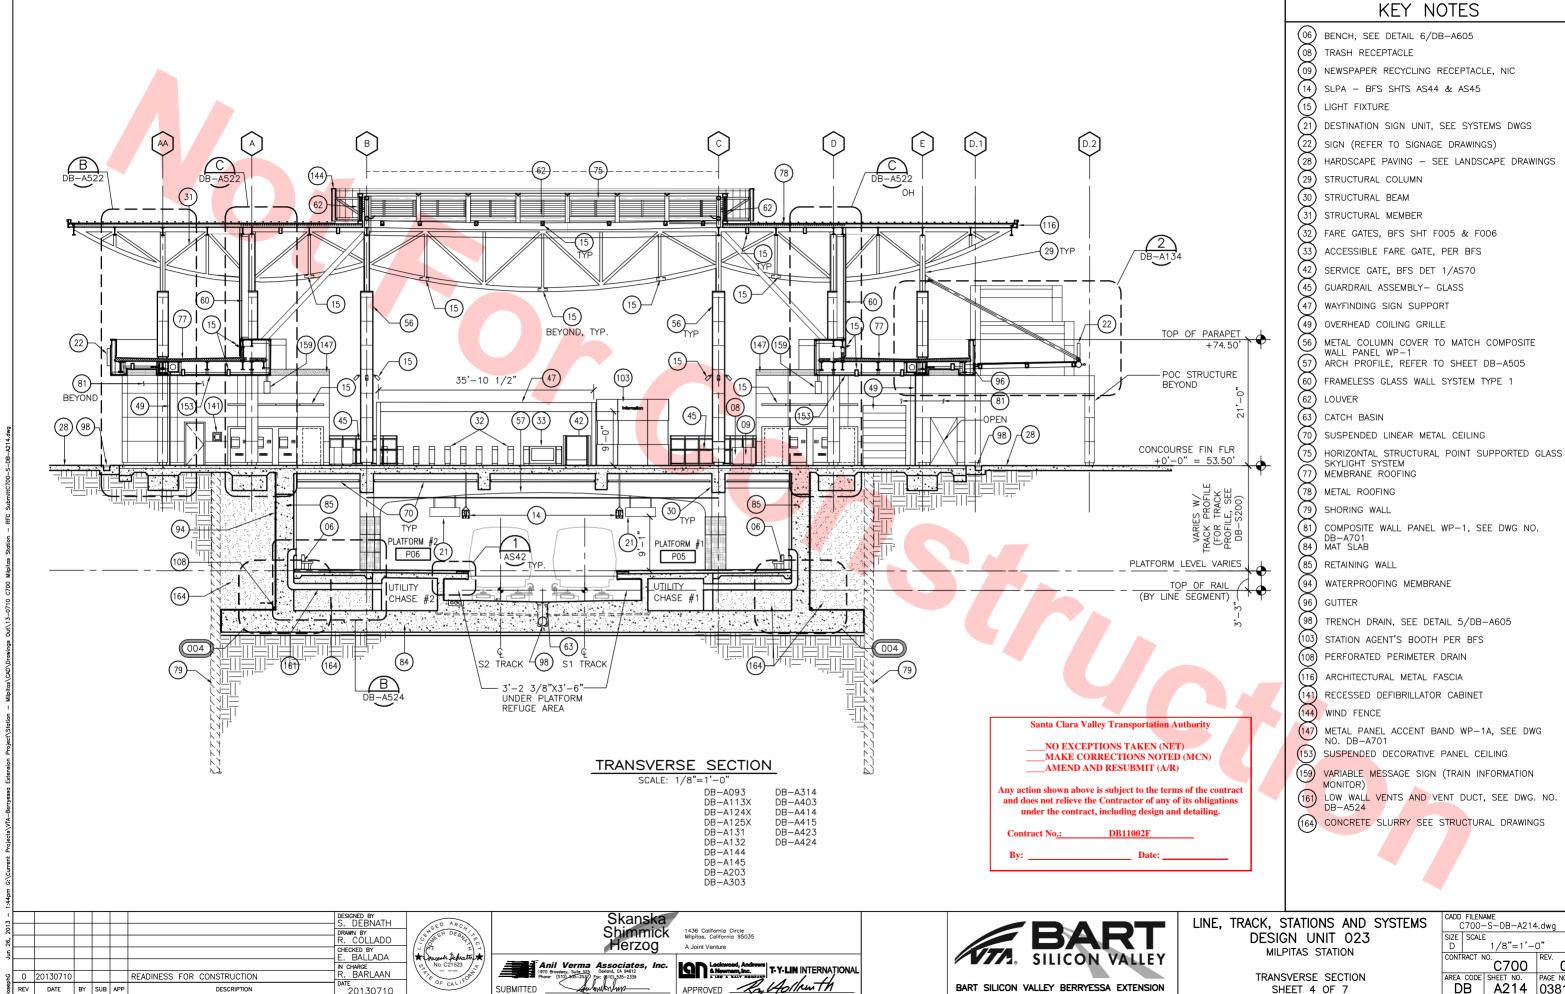


20130710


REV DATE BY SUB APP

BART SILICON VALLEY BERRYESSA EXTENSION

DB A214 0381


SHEET 4 OF 7

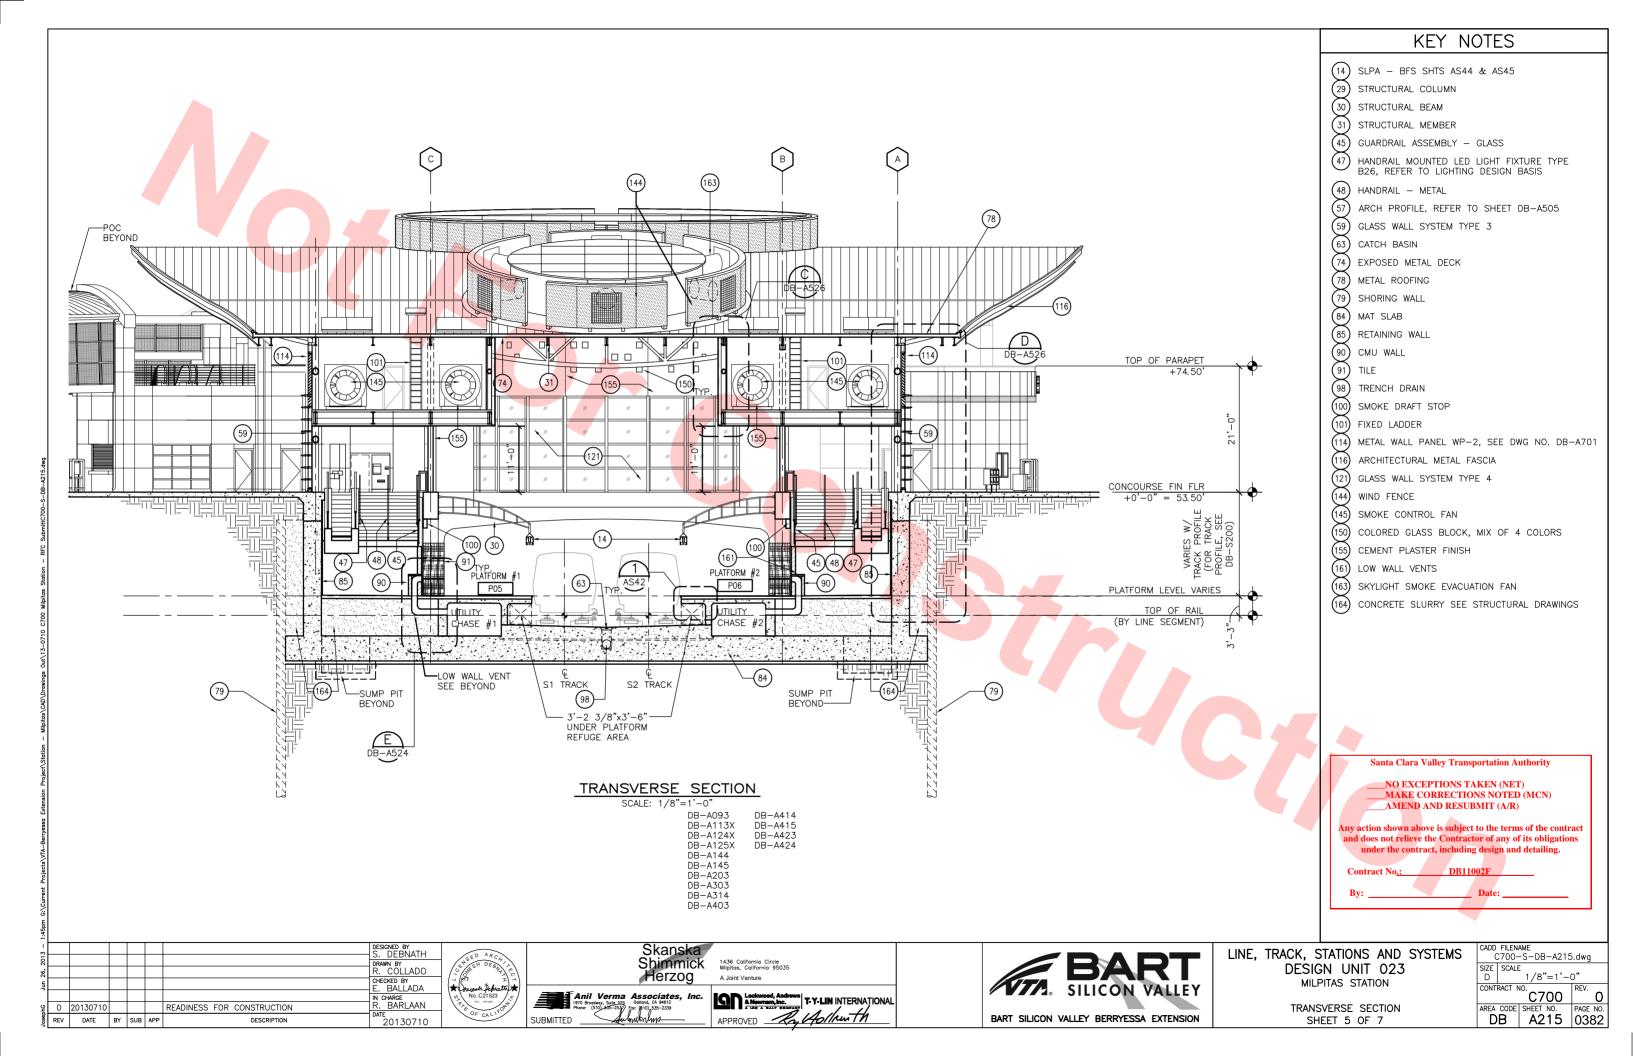

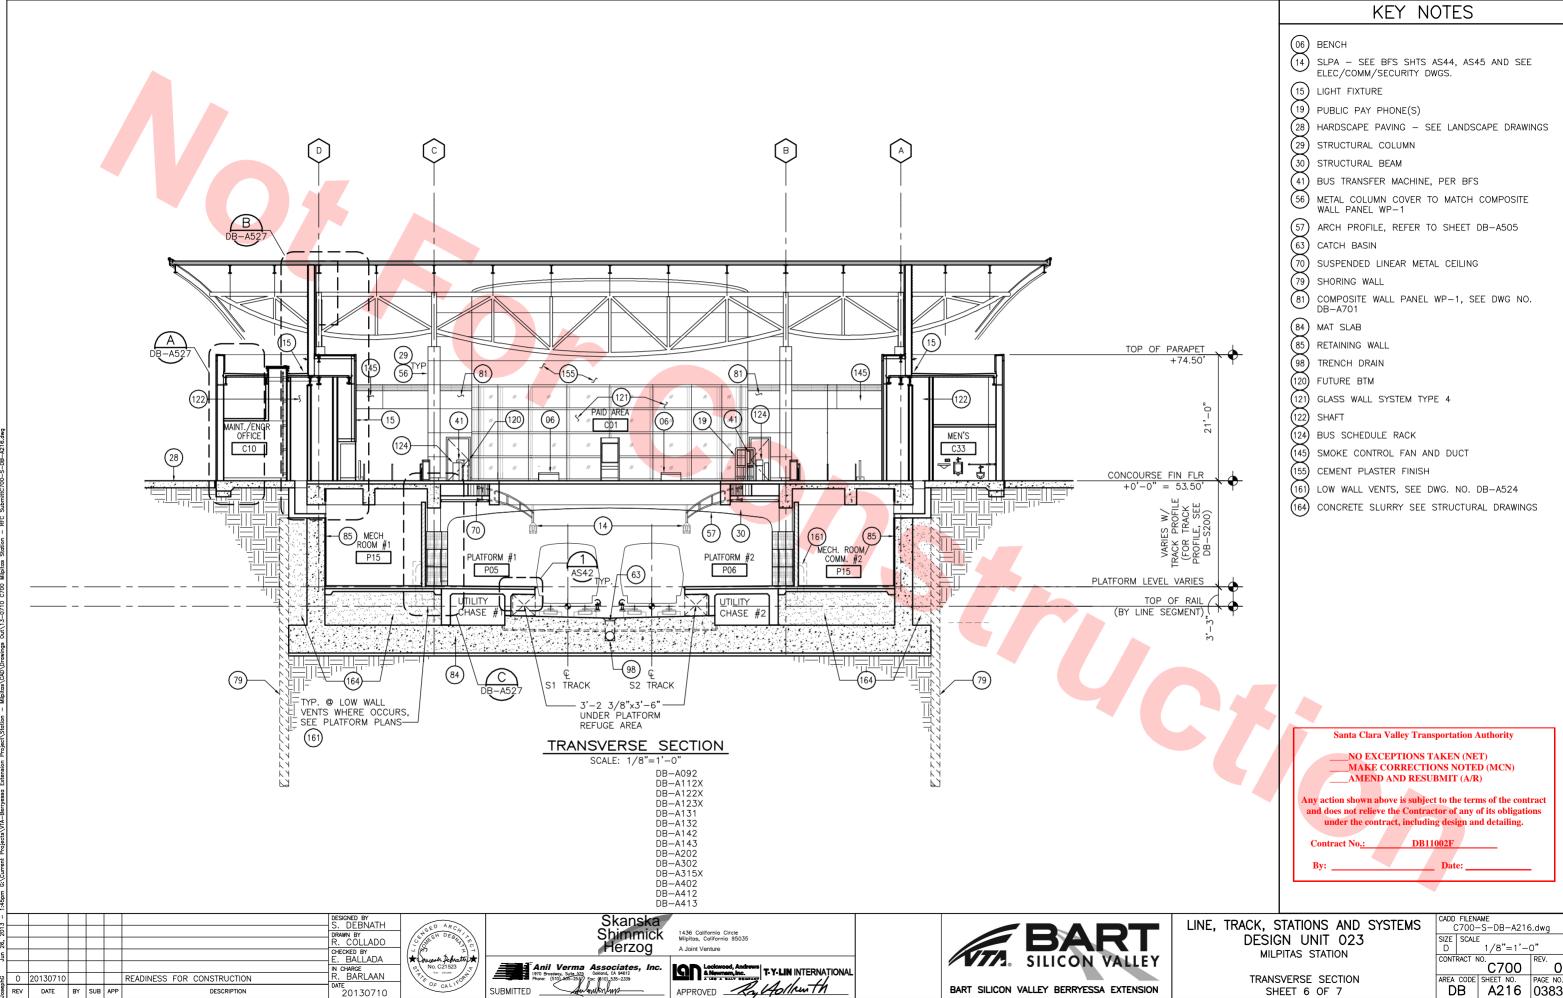

SHEET 6 OF 7

DB A216 0383

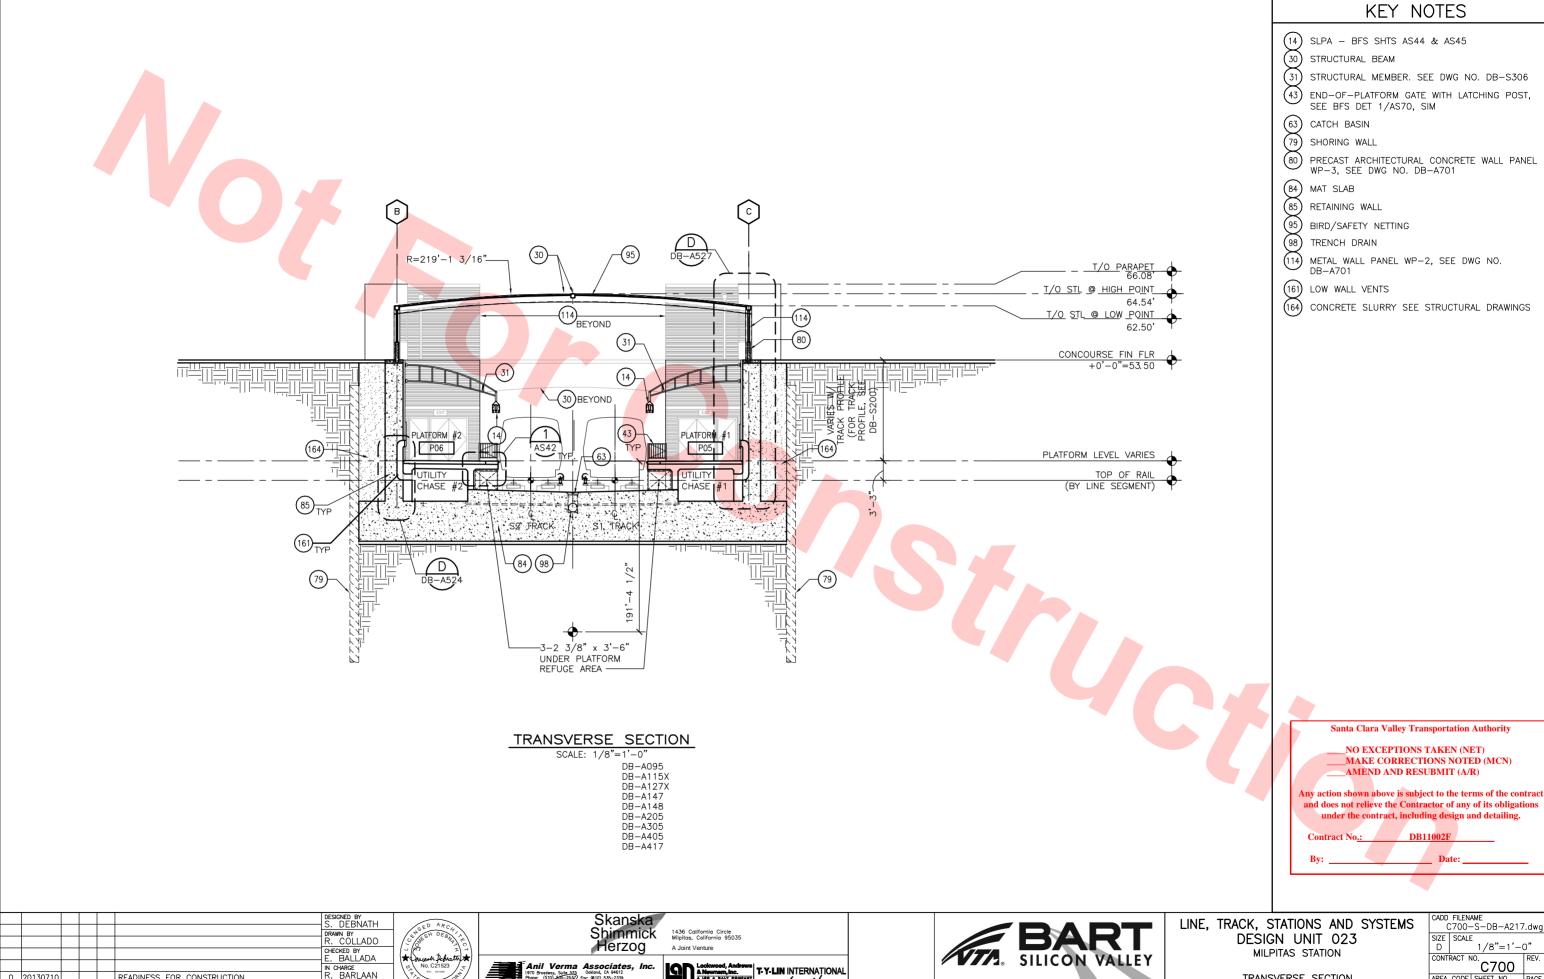

APPROVED Ry Gollanth

0 20130710 READINESS FOR CONSTRUCTION
REV DATE BY SUB APP DESCRIPTION

CHARGE . BARLAAN

20130710

SUBMITTED


CADD FILENAME C700-S-DB-A217.dwg SIZE | SCALE | 1/8"=1'-0"


TRANSVERSE SECTION SHEET 7 OF 7


BART SILICON VALLEY BERRYESSA EXTENSION


CONTRACT NO.
C700

AREA CODE SHEET NO. DB A217 0384

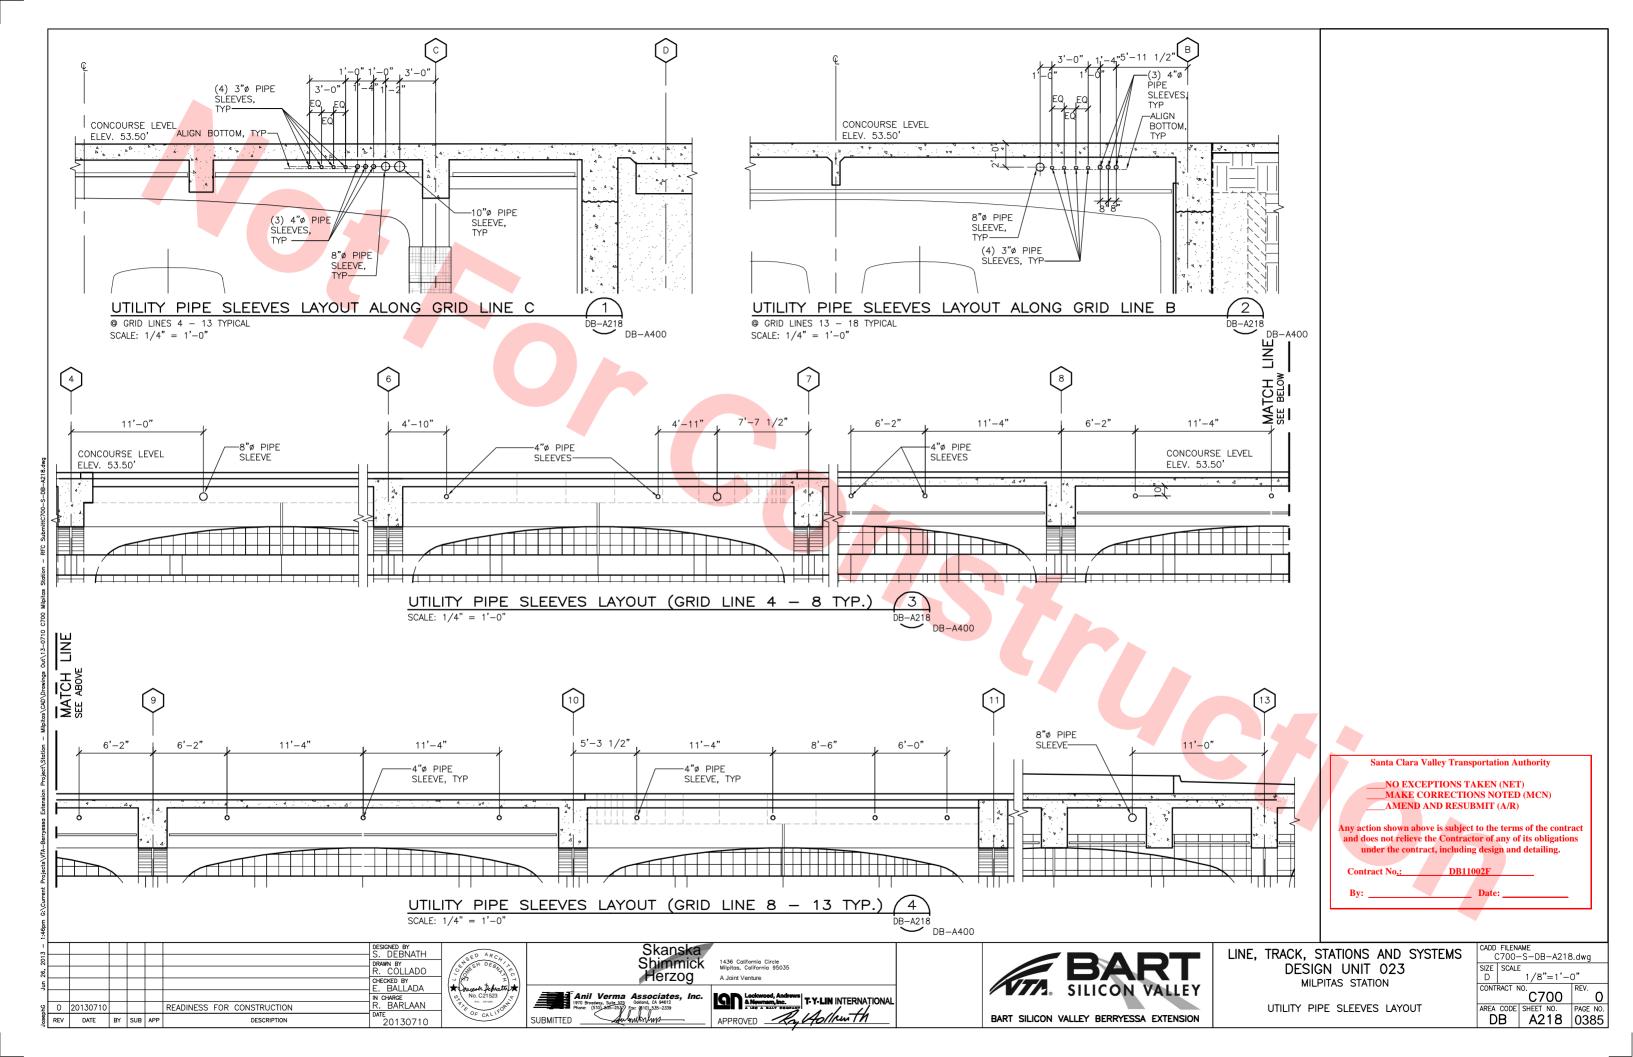

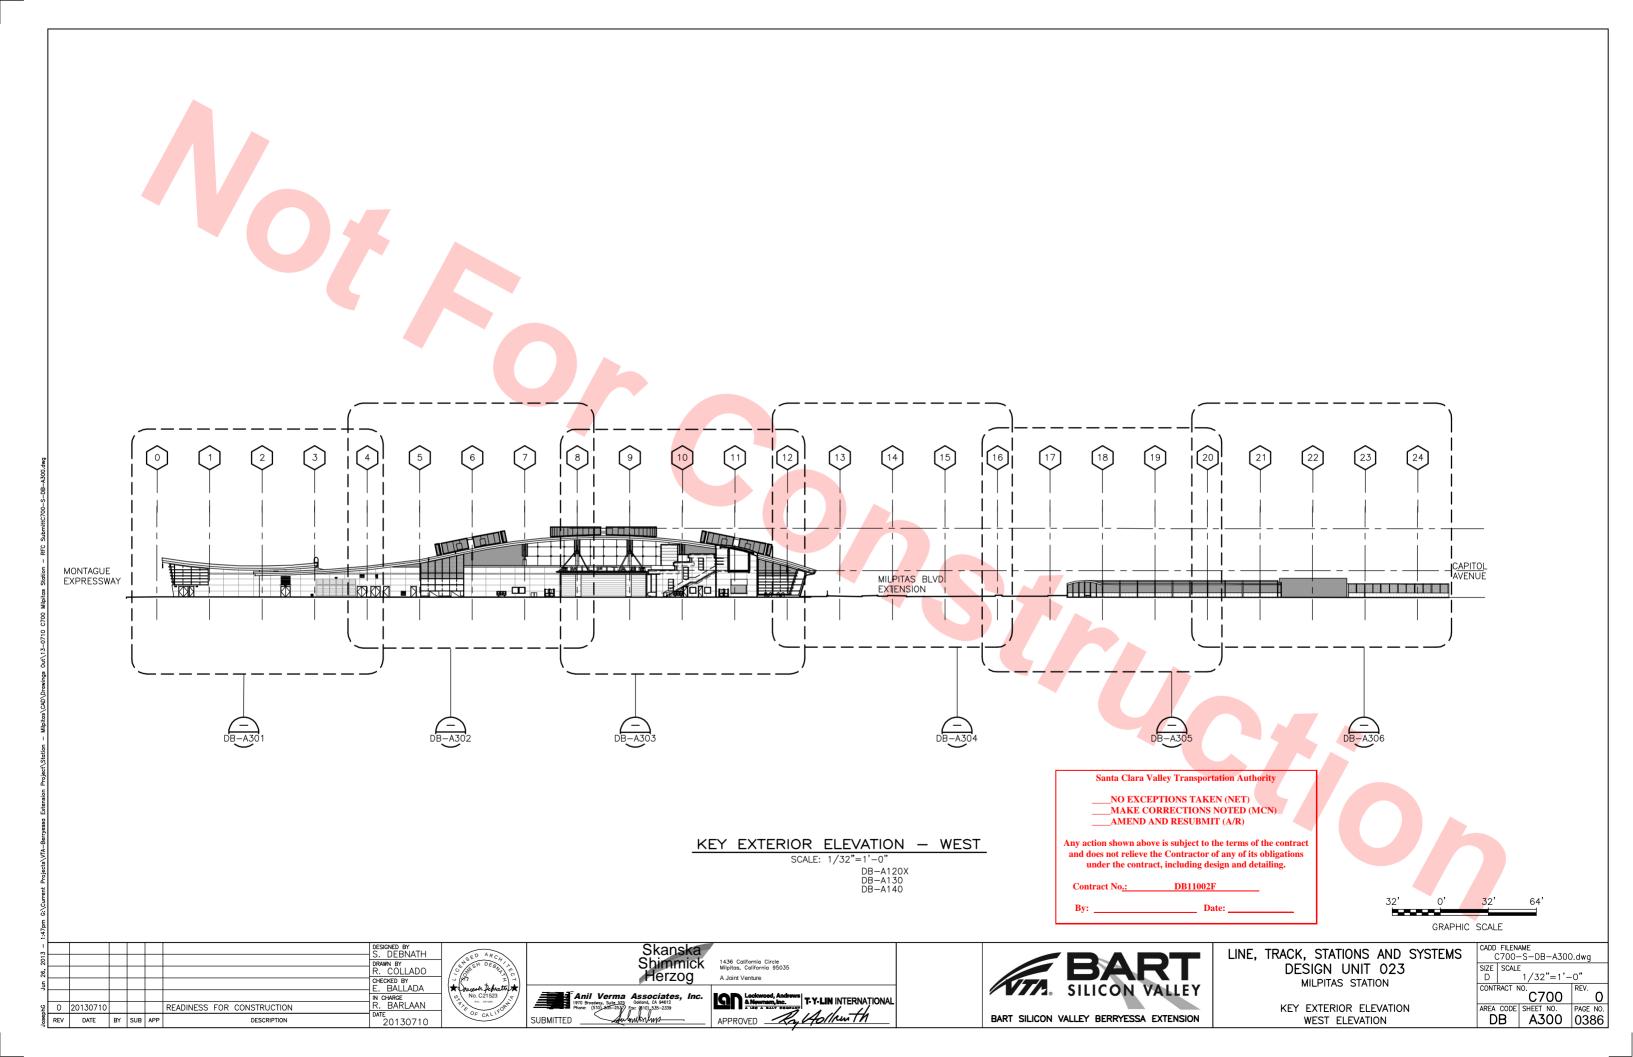

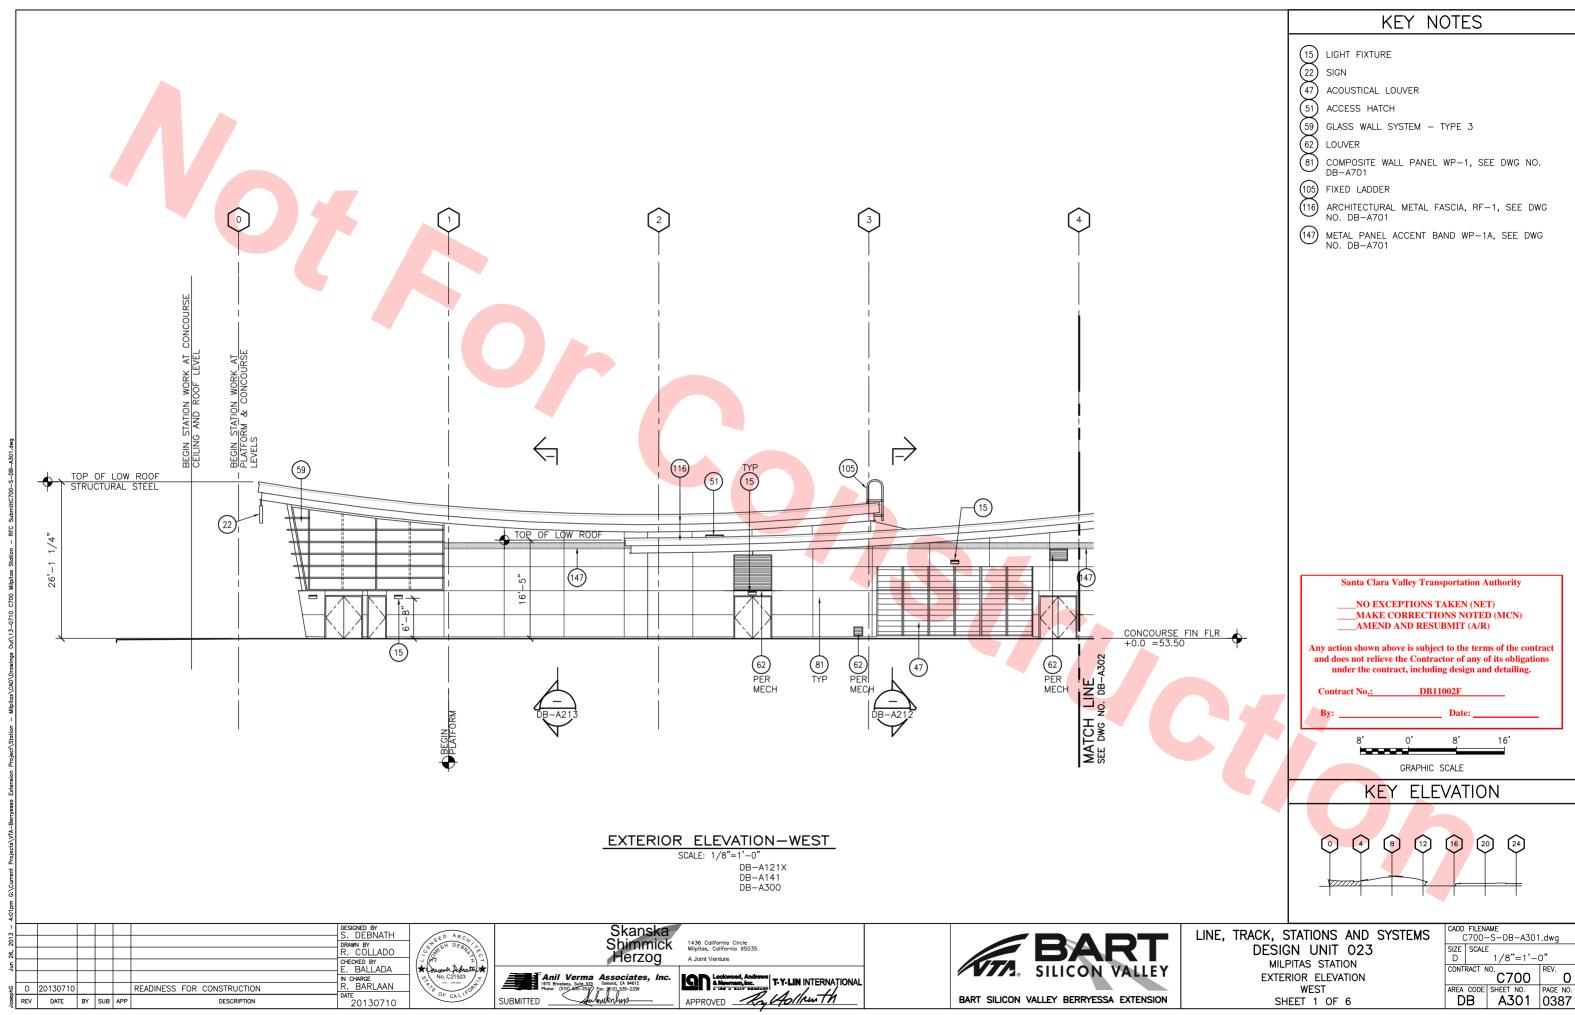


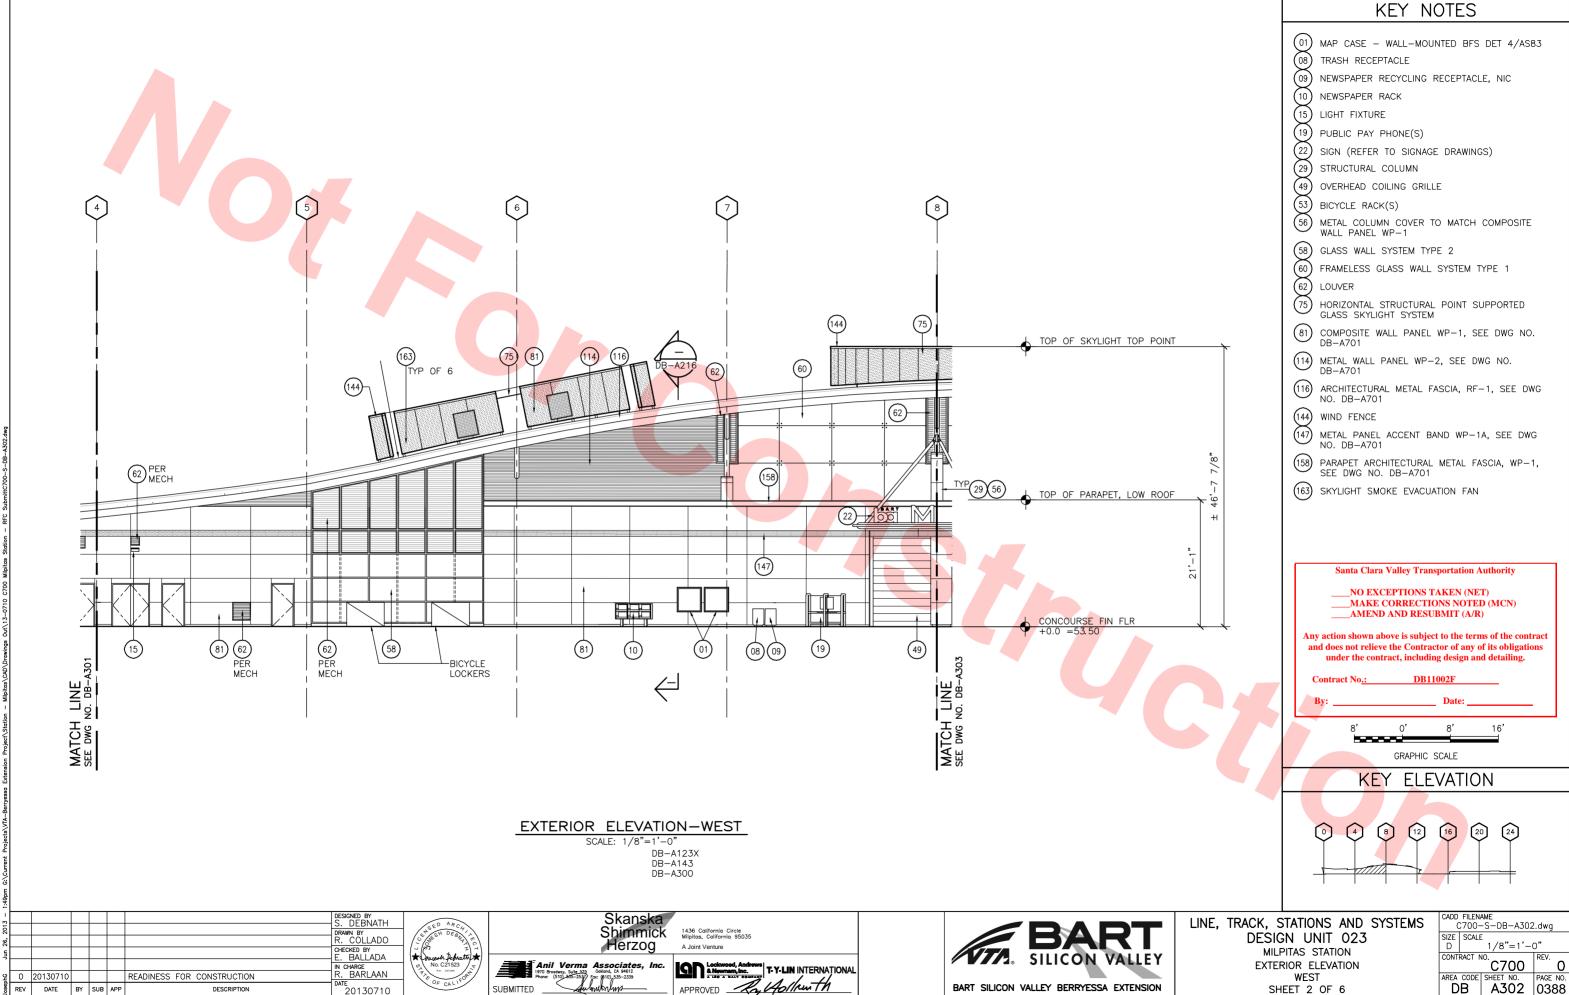



20130710


C700 REV. O AREA CODE SHEET NO. DB A302 0388


SHEET 2 OF 6

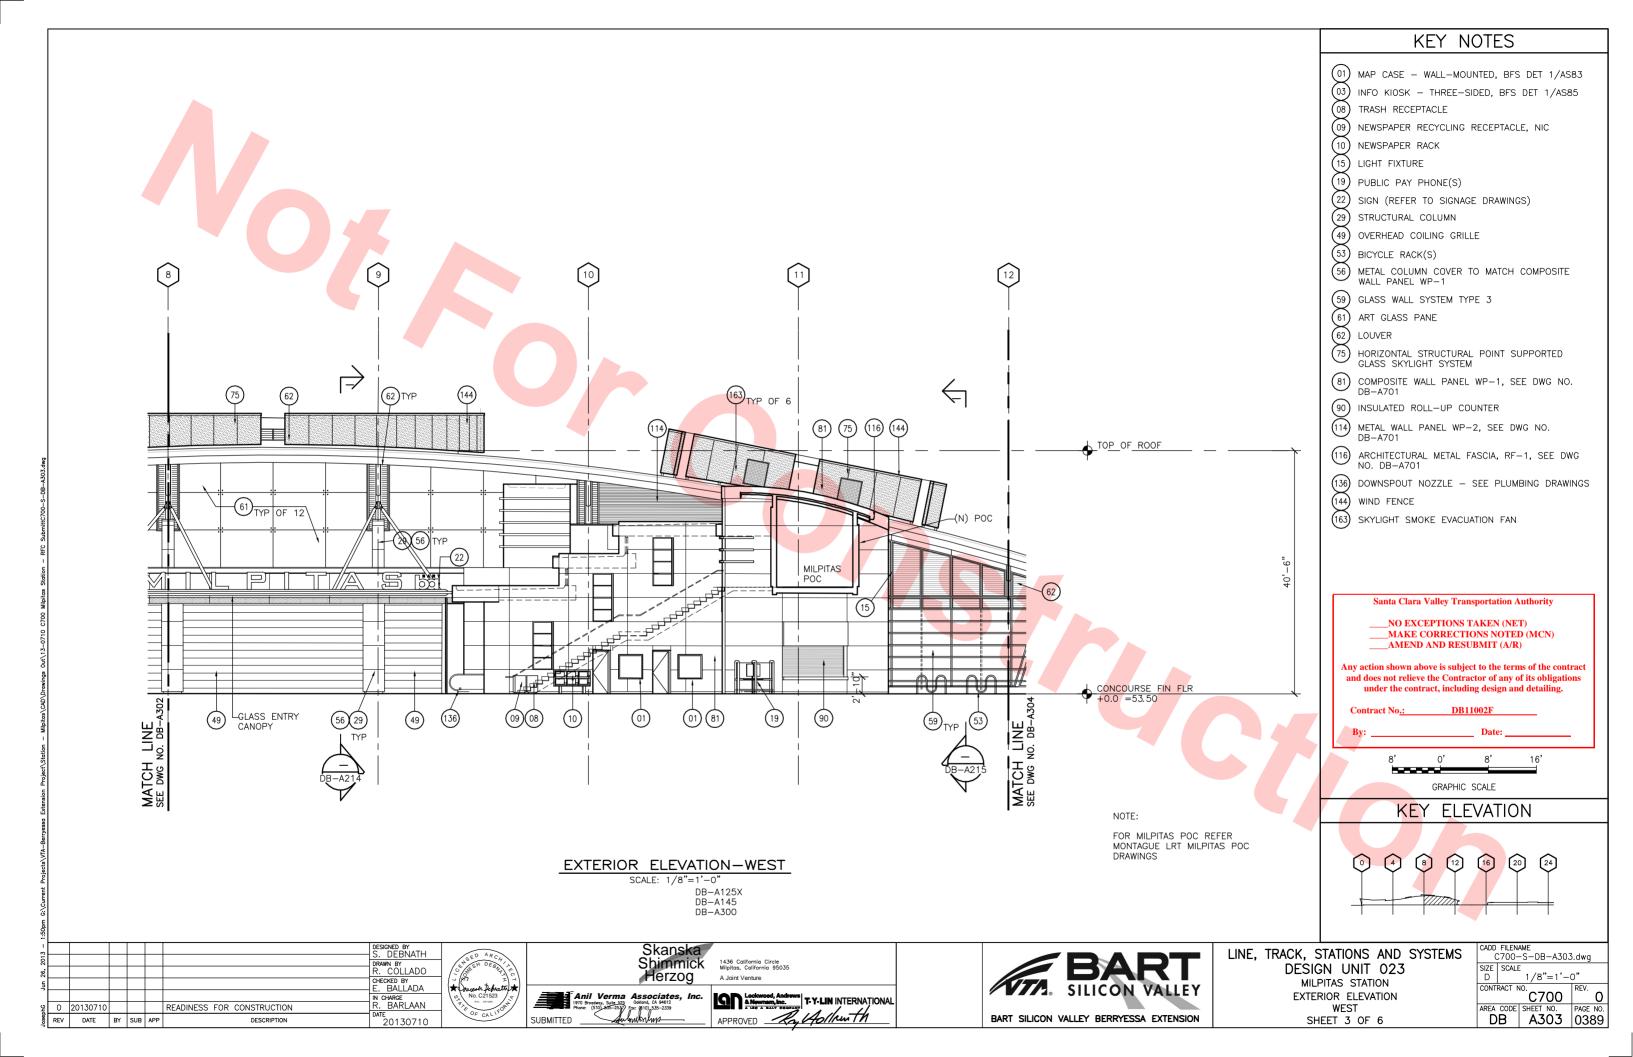

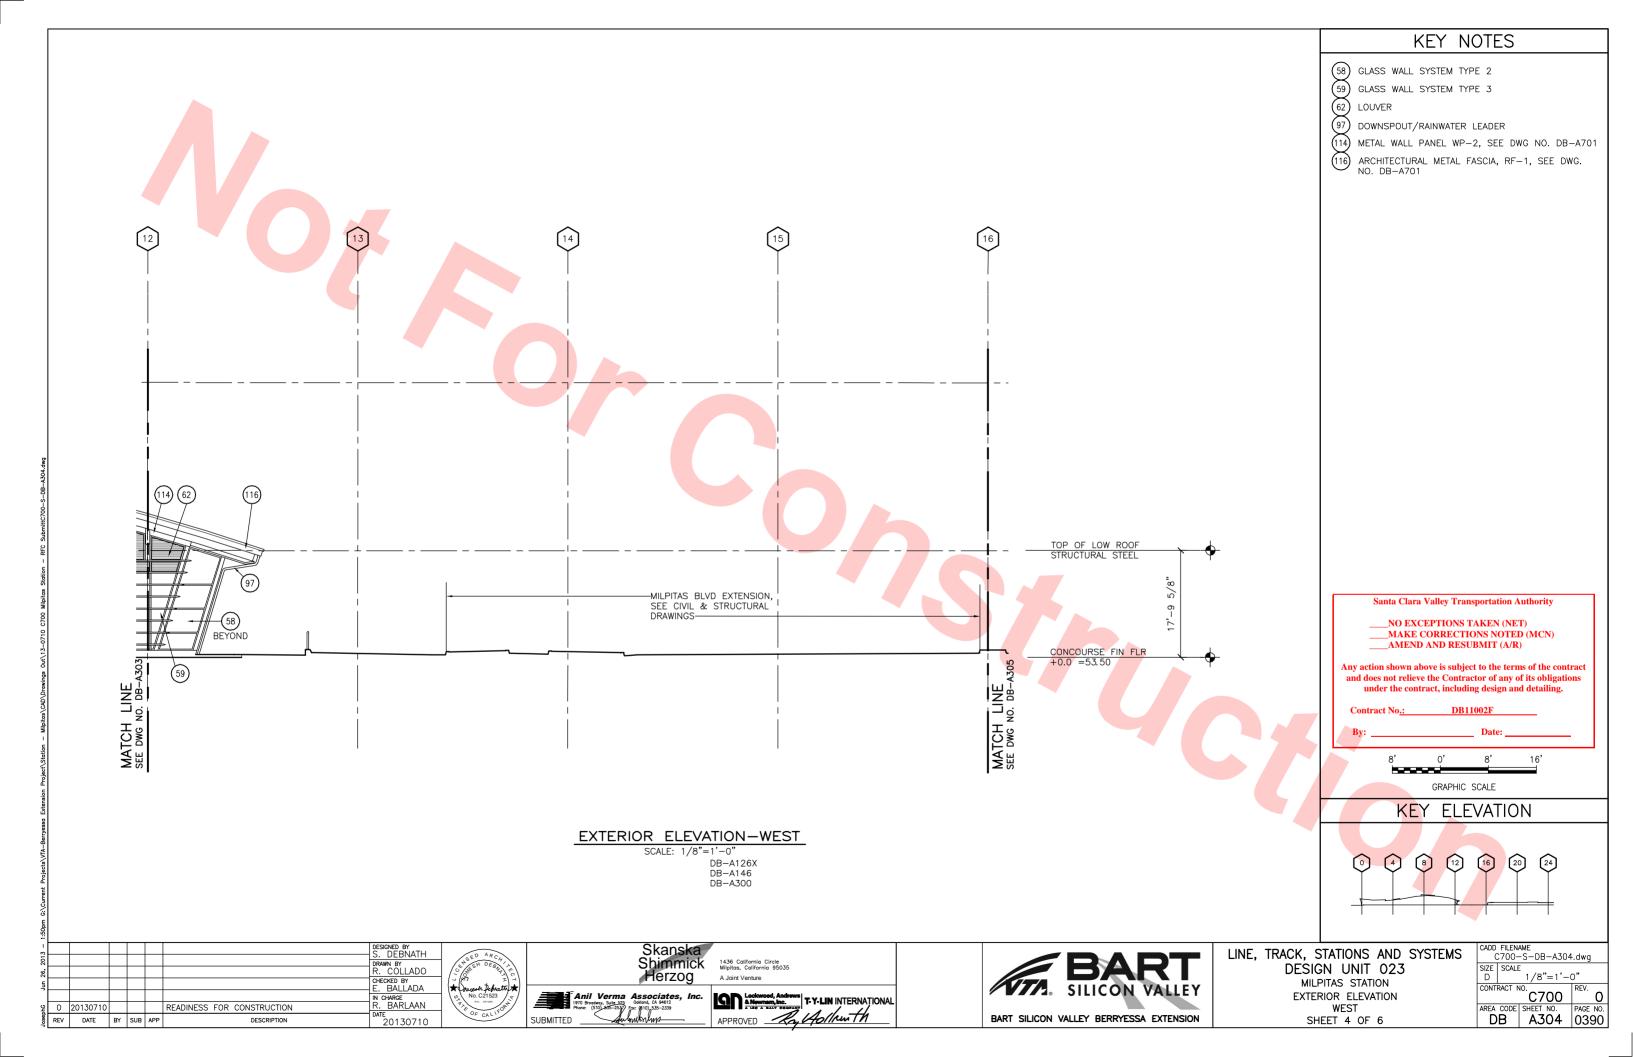


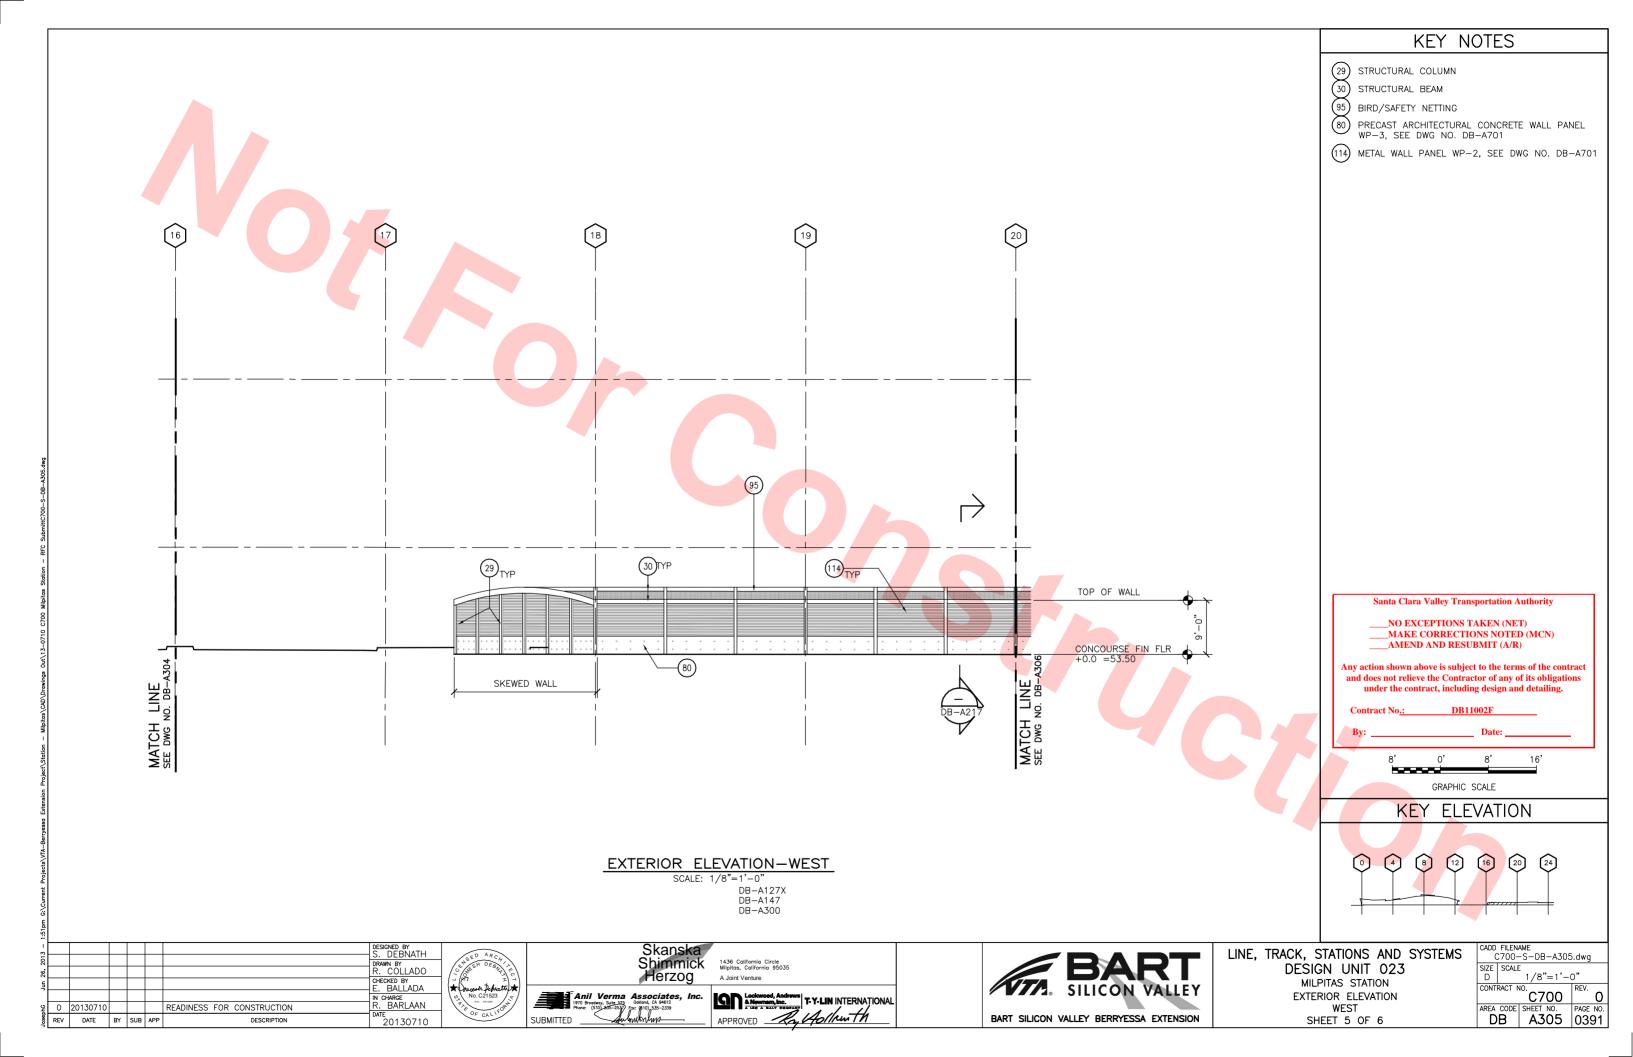


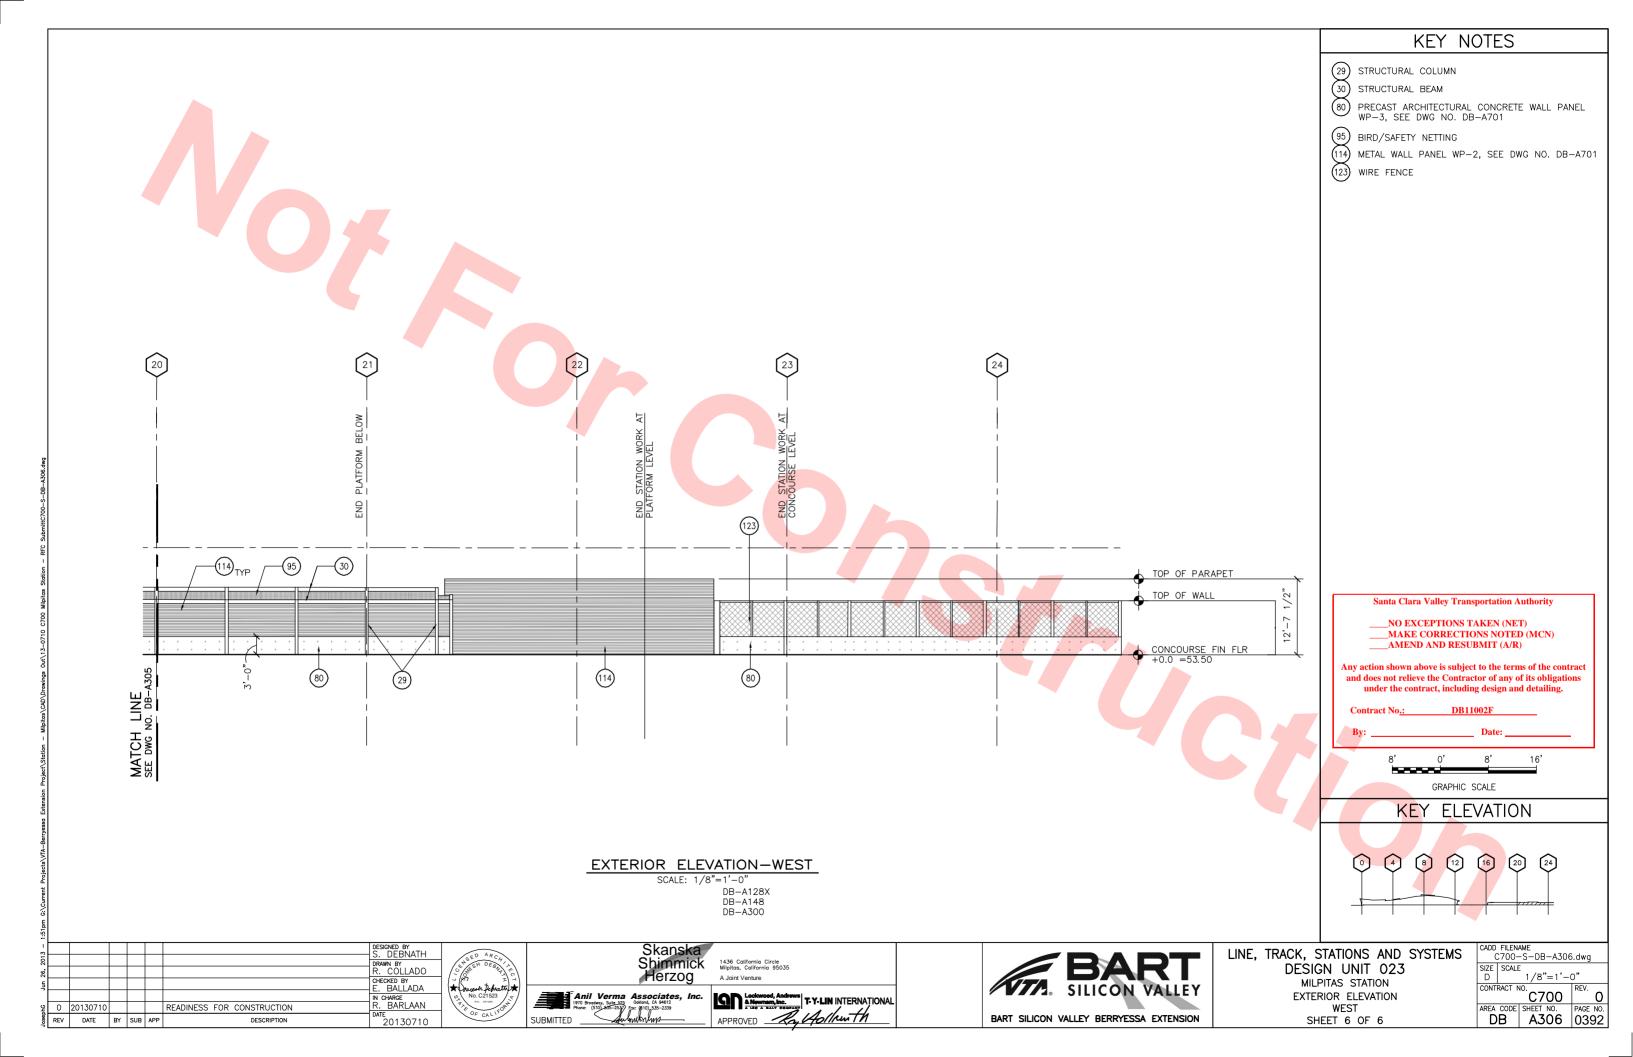


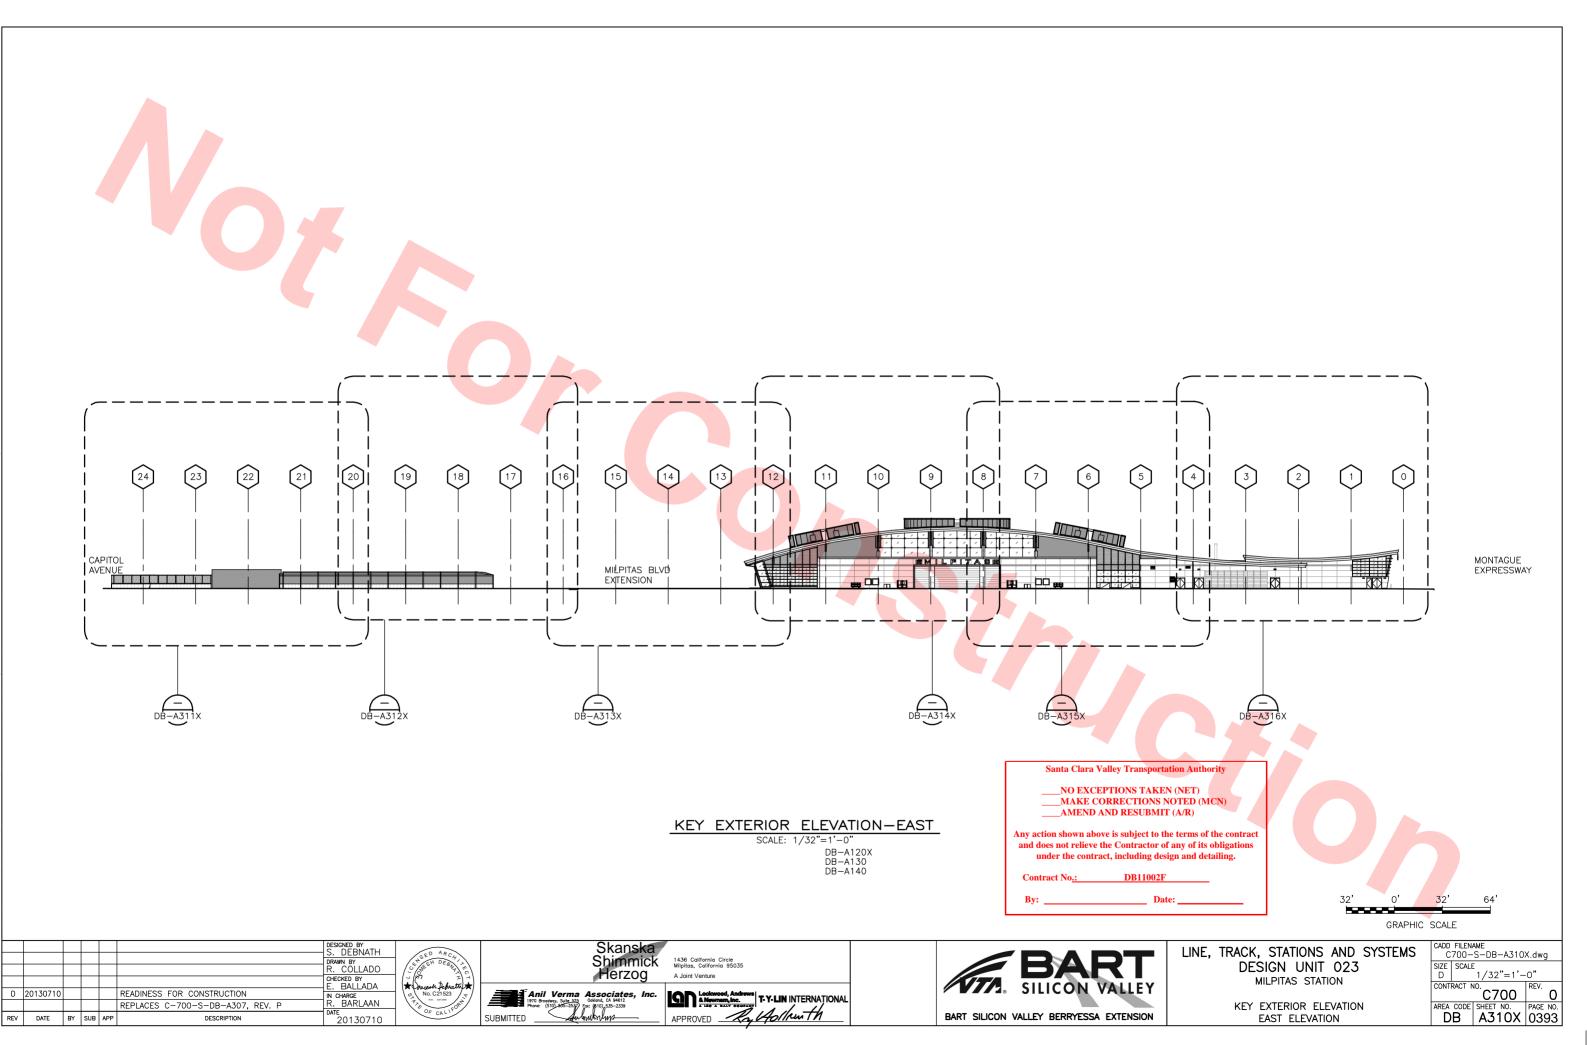



26, 2013 - 1:51pm G:\Current Projects\VTA-Berry

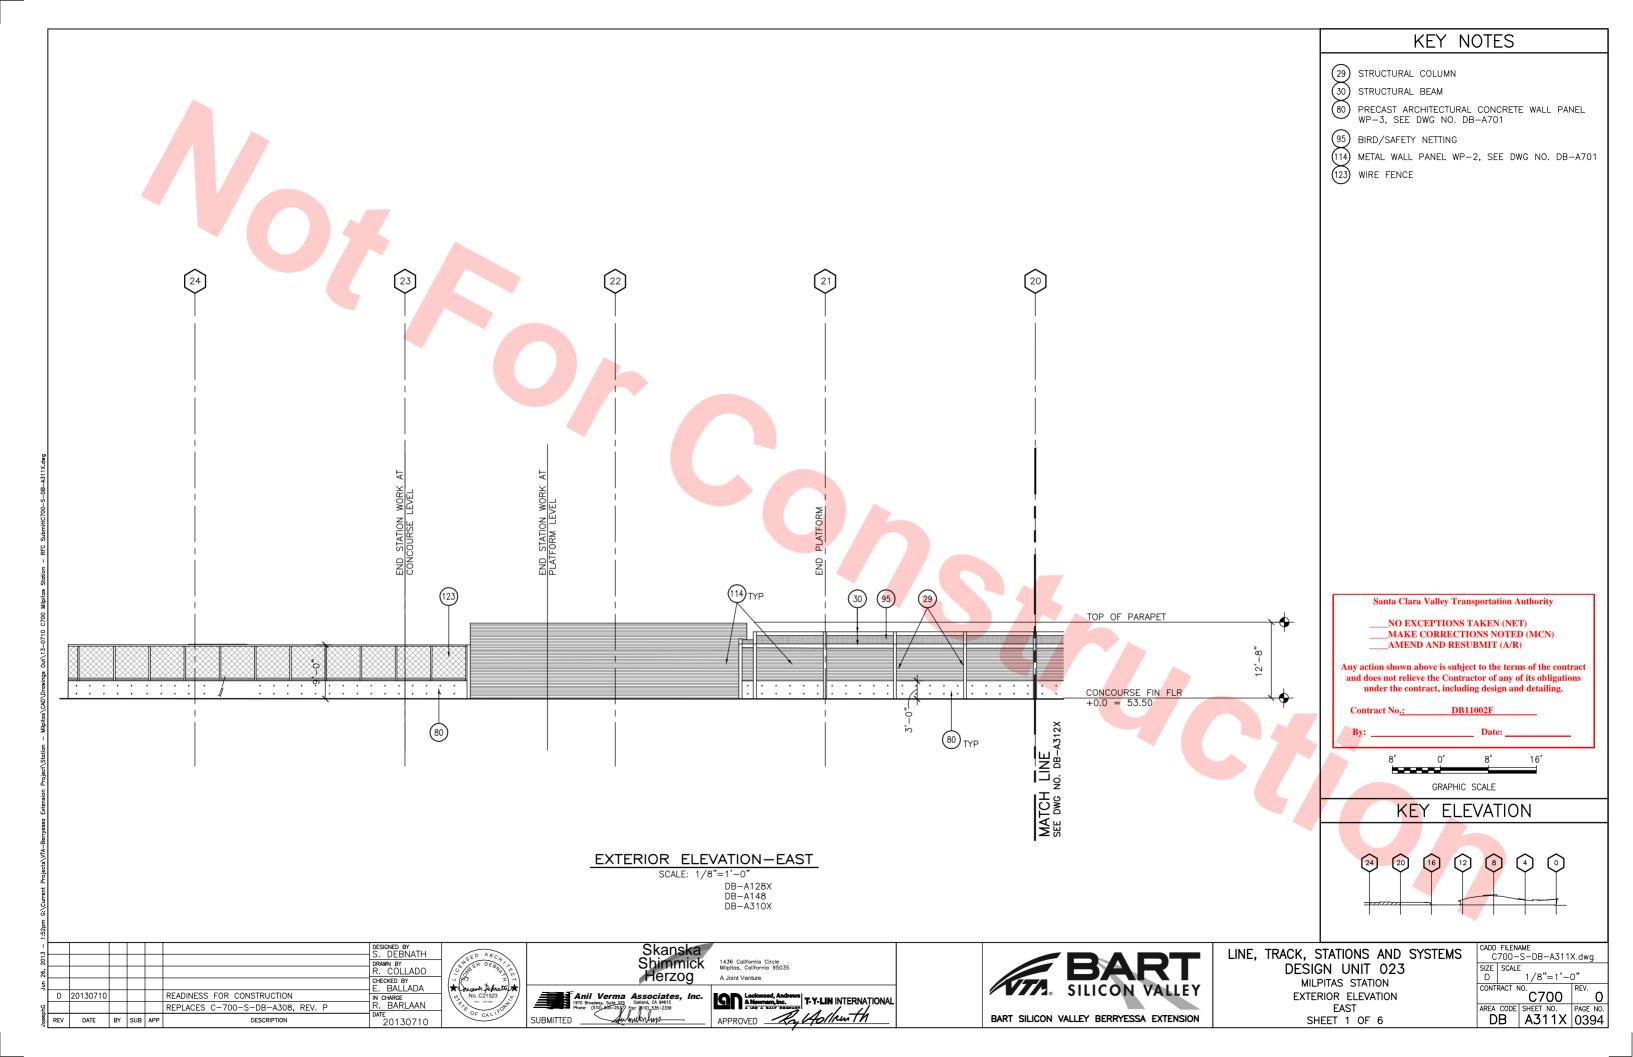


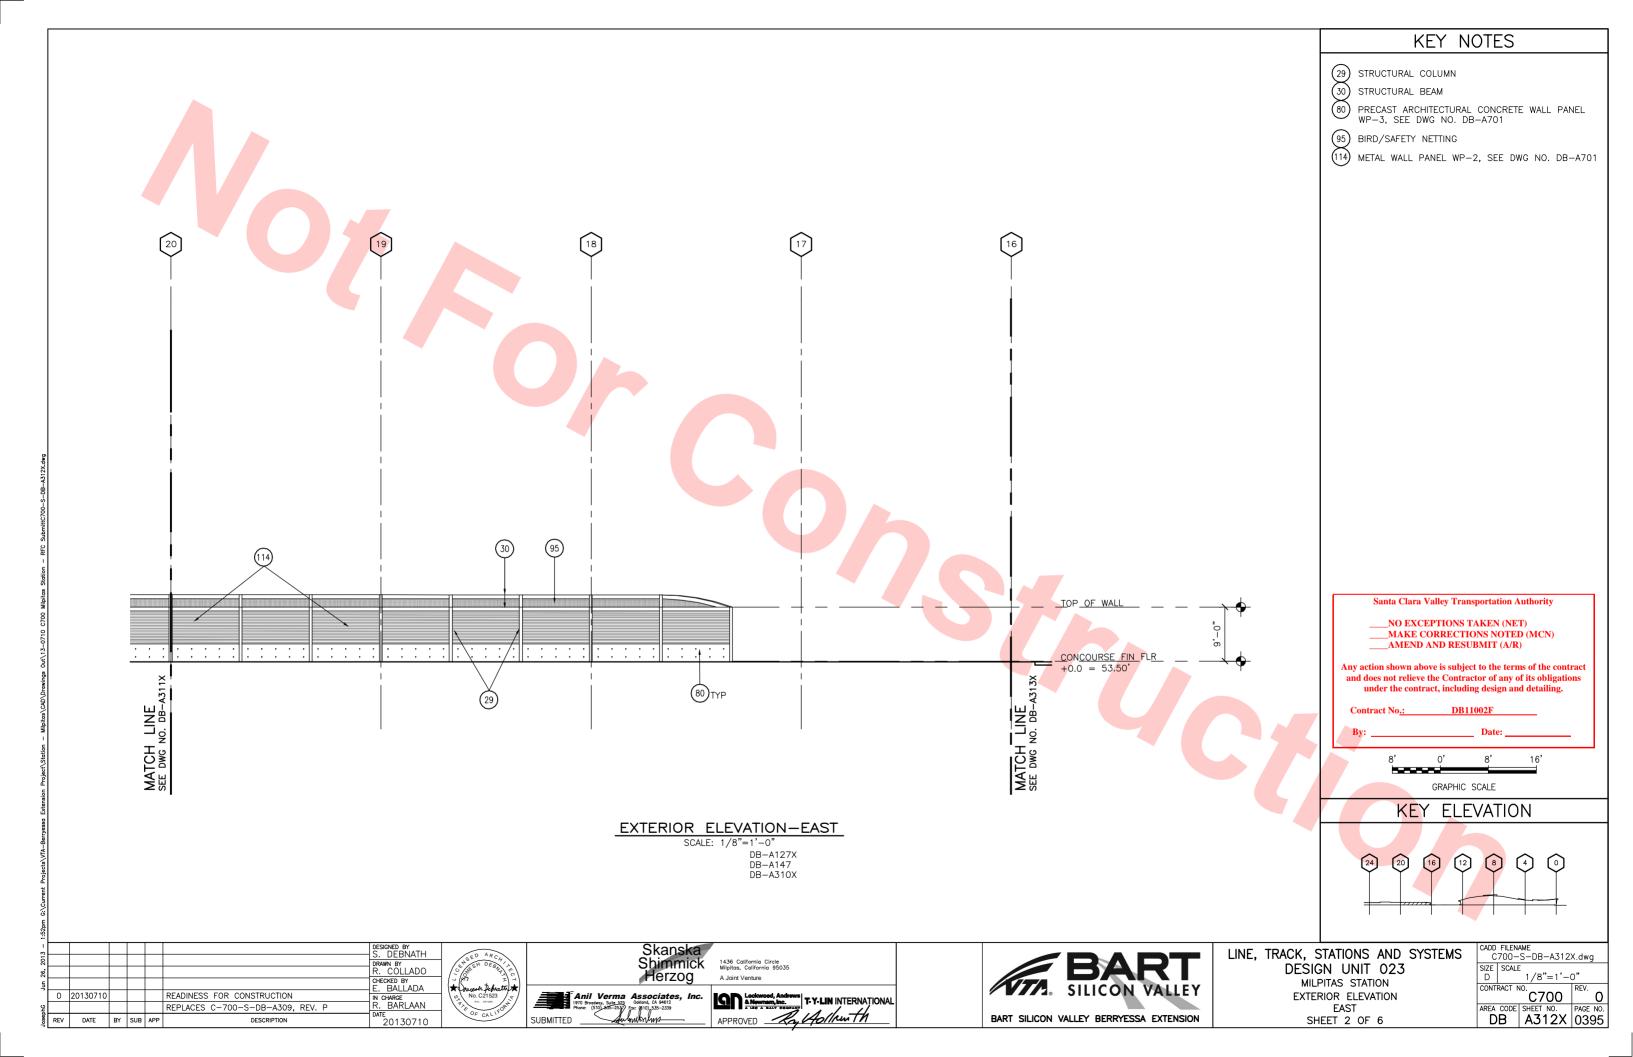

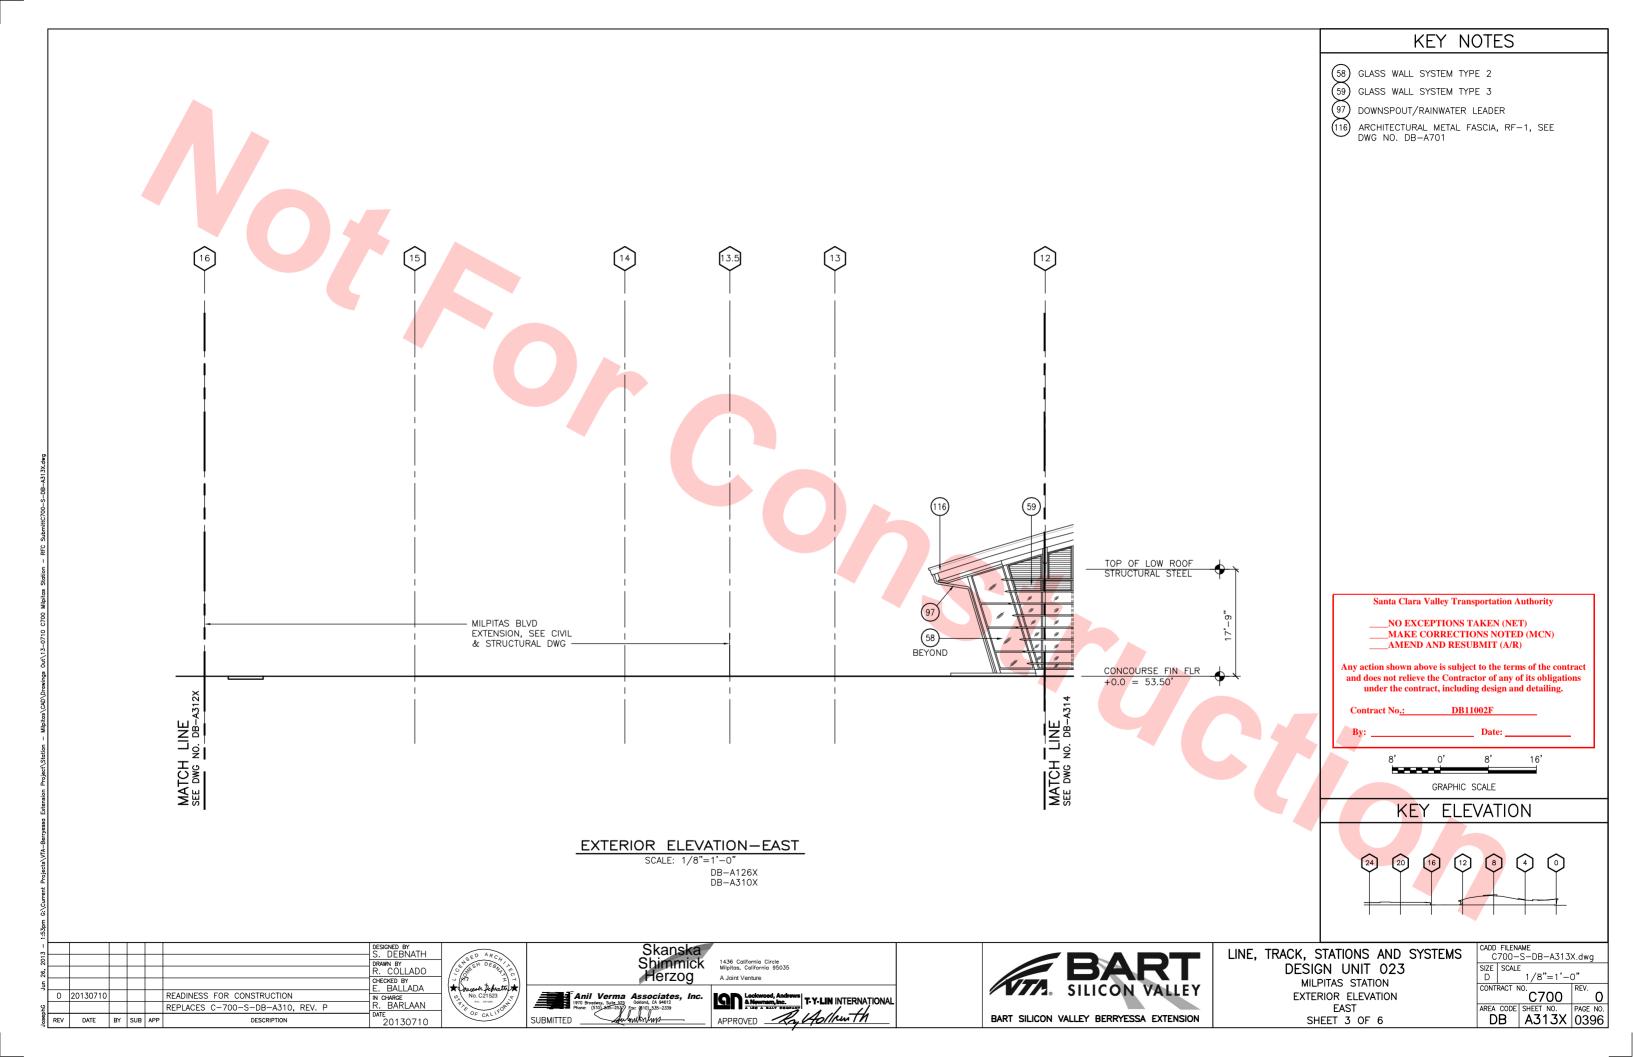

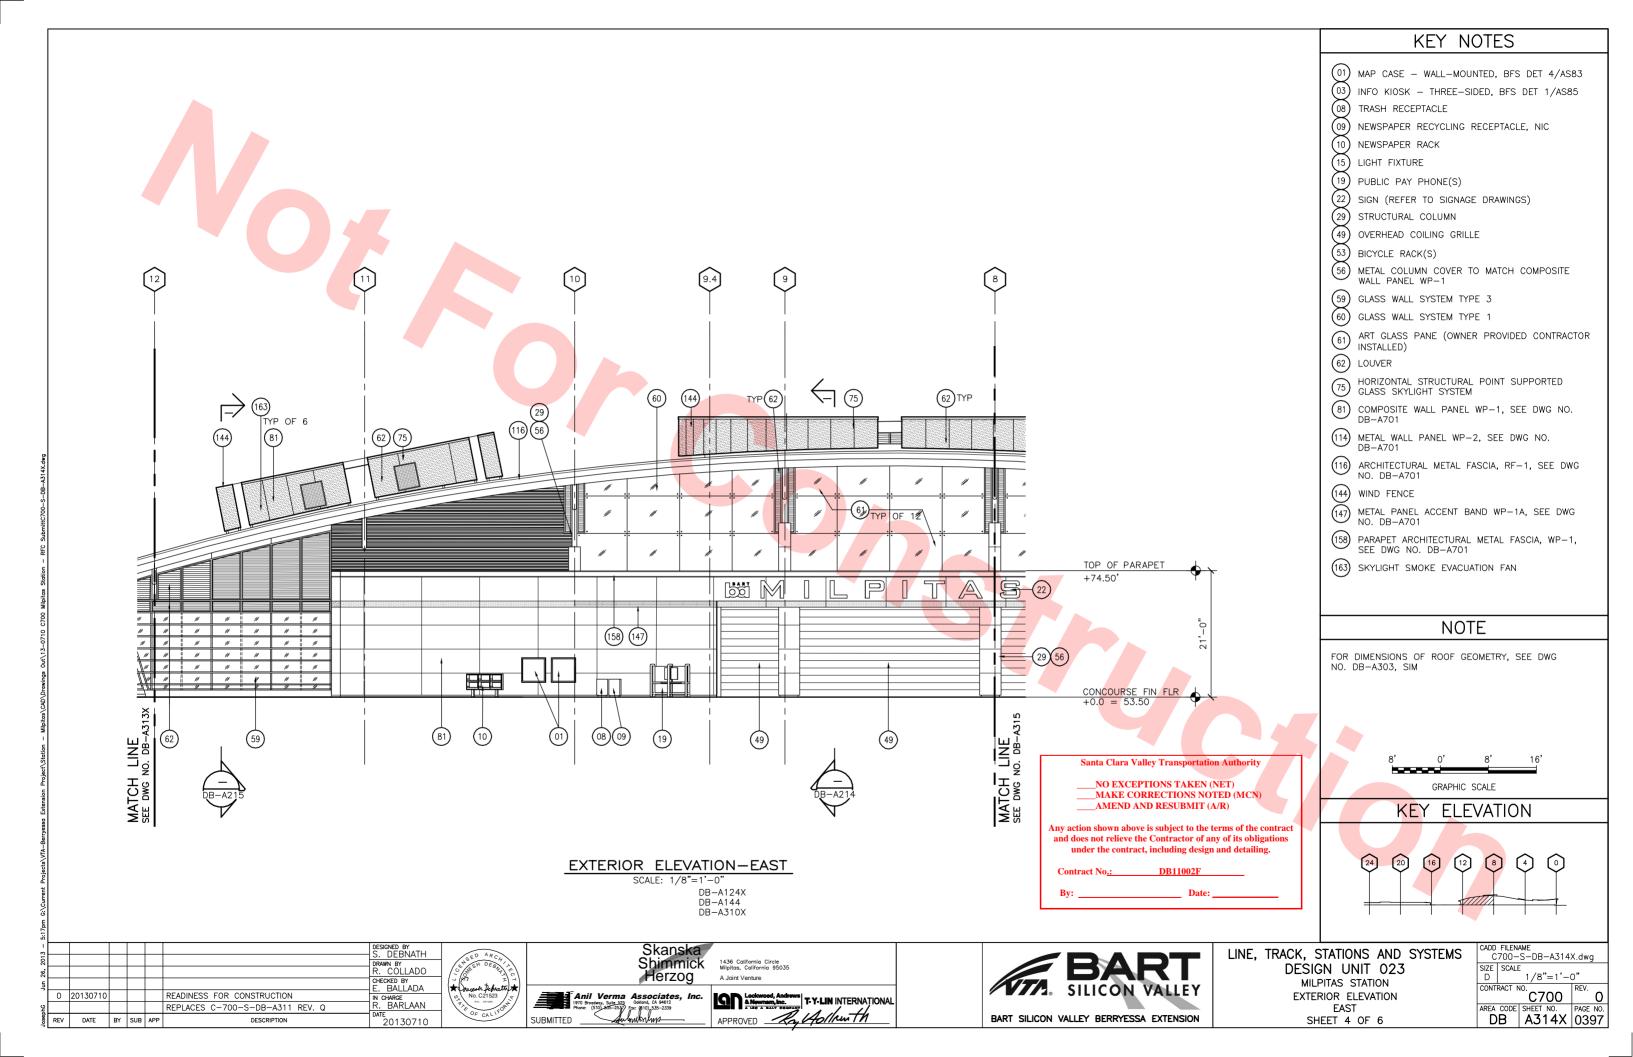

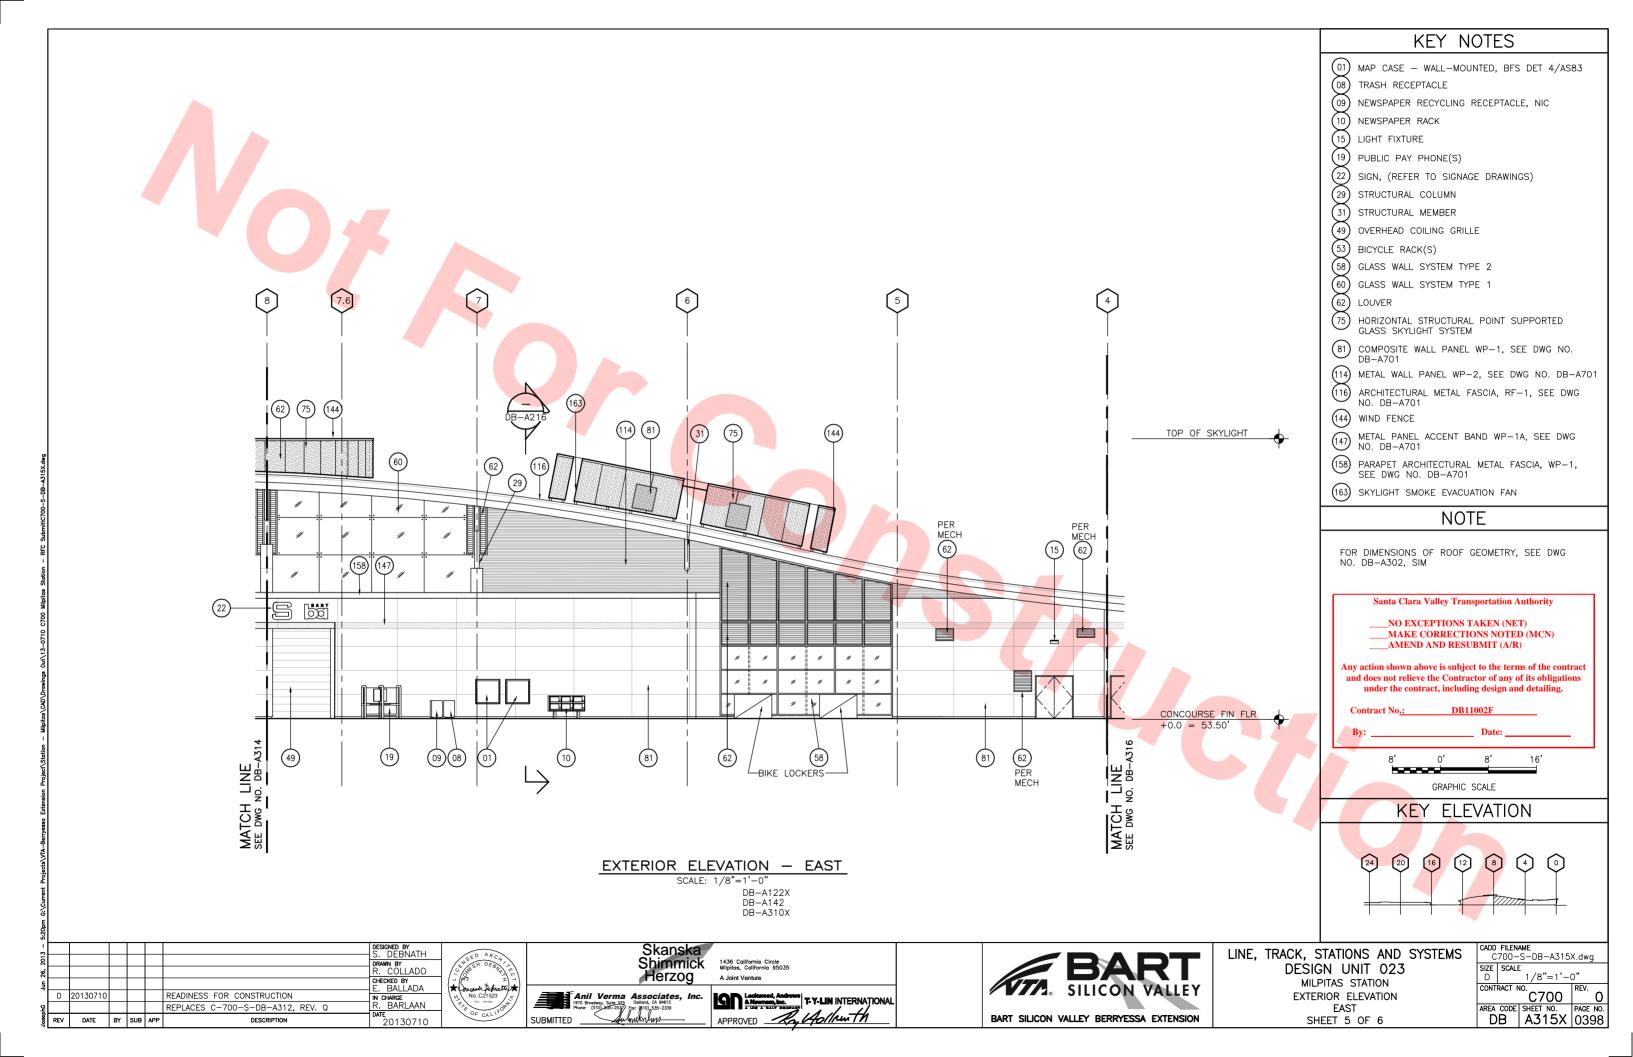


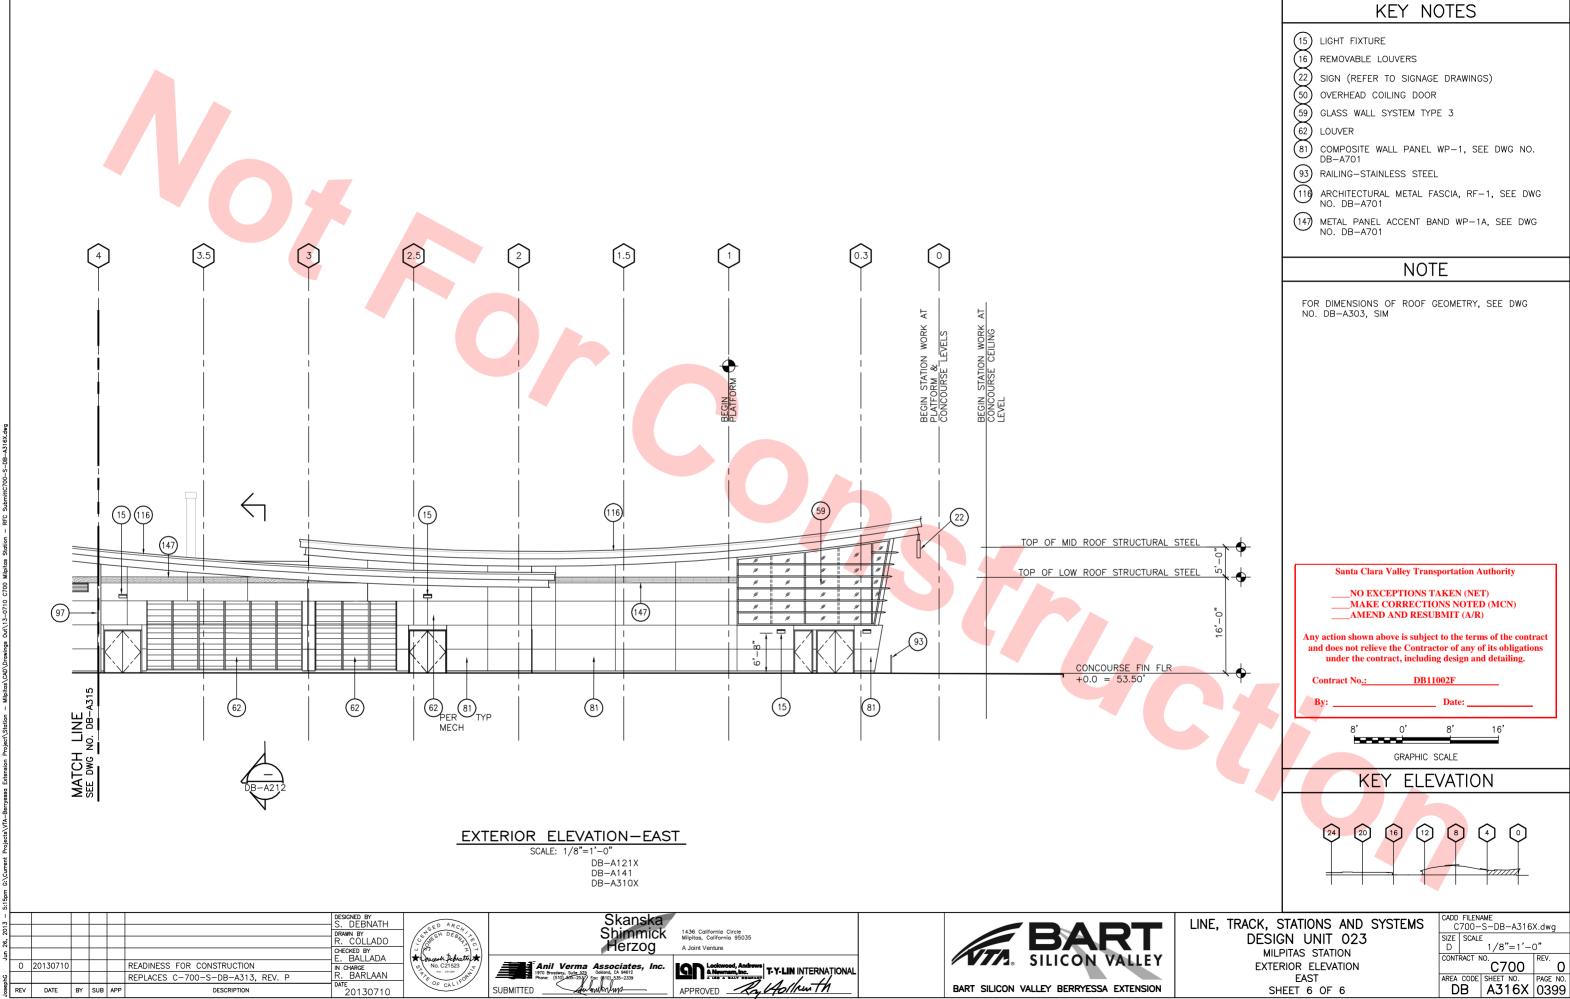

REV DATE BY SUB APP DESCRIPTION 20130710





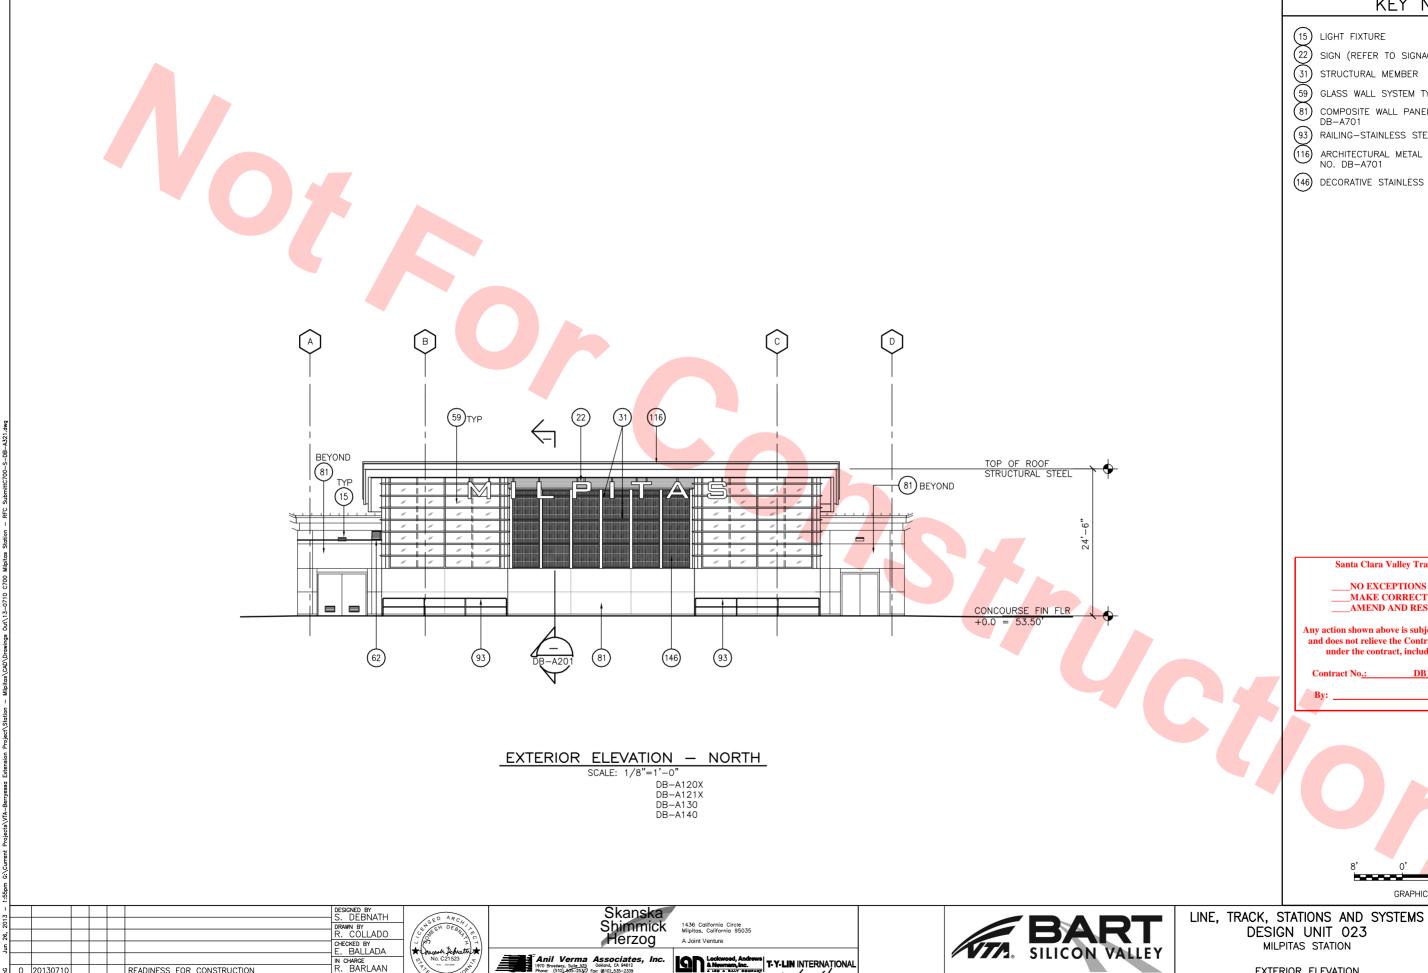

APPROVED Ry Hollren th

SUBMITTED

20130710

0 20130710 READINESS FOR CONSTRUCTION
REV DATE BY SUB APP DESCRIPTION

KEY NOTES

(15) LIGHT FIXTURE

22) SIGN (REFER TO SIGNAGE DRAWINGS)

(31) STRUCTURAL MEMBER

(59) GLASS WALL SYSTEM TYPE 3

81) COMPOSITE WALL PANEL WP-1, SEE DWG NO. DB-A701

(93) RAILING-STAINLESS STEEL

ARCHITECTURAL METAL FASCIA, RF-1, SEE DWG NO. DB-A701

(146) DECORATIVE STAINLESS STEEL MESH

Santa Clara Valley Transportation Authority

___NO EXCEPTIONS TAKEN (NET) ___MAKE CORRECTIONS NOTED (MCN) AMEND AND RESUBMIT (A/R)

Any action shown above is subject to the terms of the contract and does not relieve the Contractor of any of its obligations under the contract, including design and detailing.


GRAPHIC SCALE

CADD FILENAME C700-S-DB-A321.dwg

EXTERIOR ELEVATION CONCOURSE BUILDING NORTH

BART SILICON VALLEY BERRYESSA EXTENSION

SIZE | SCALE | D | 1/8"=1'-0" CONTRACT NO. C700 REV. O AREA CODE SHEET NO. DB A321 0400

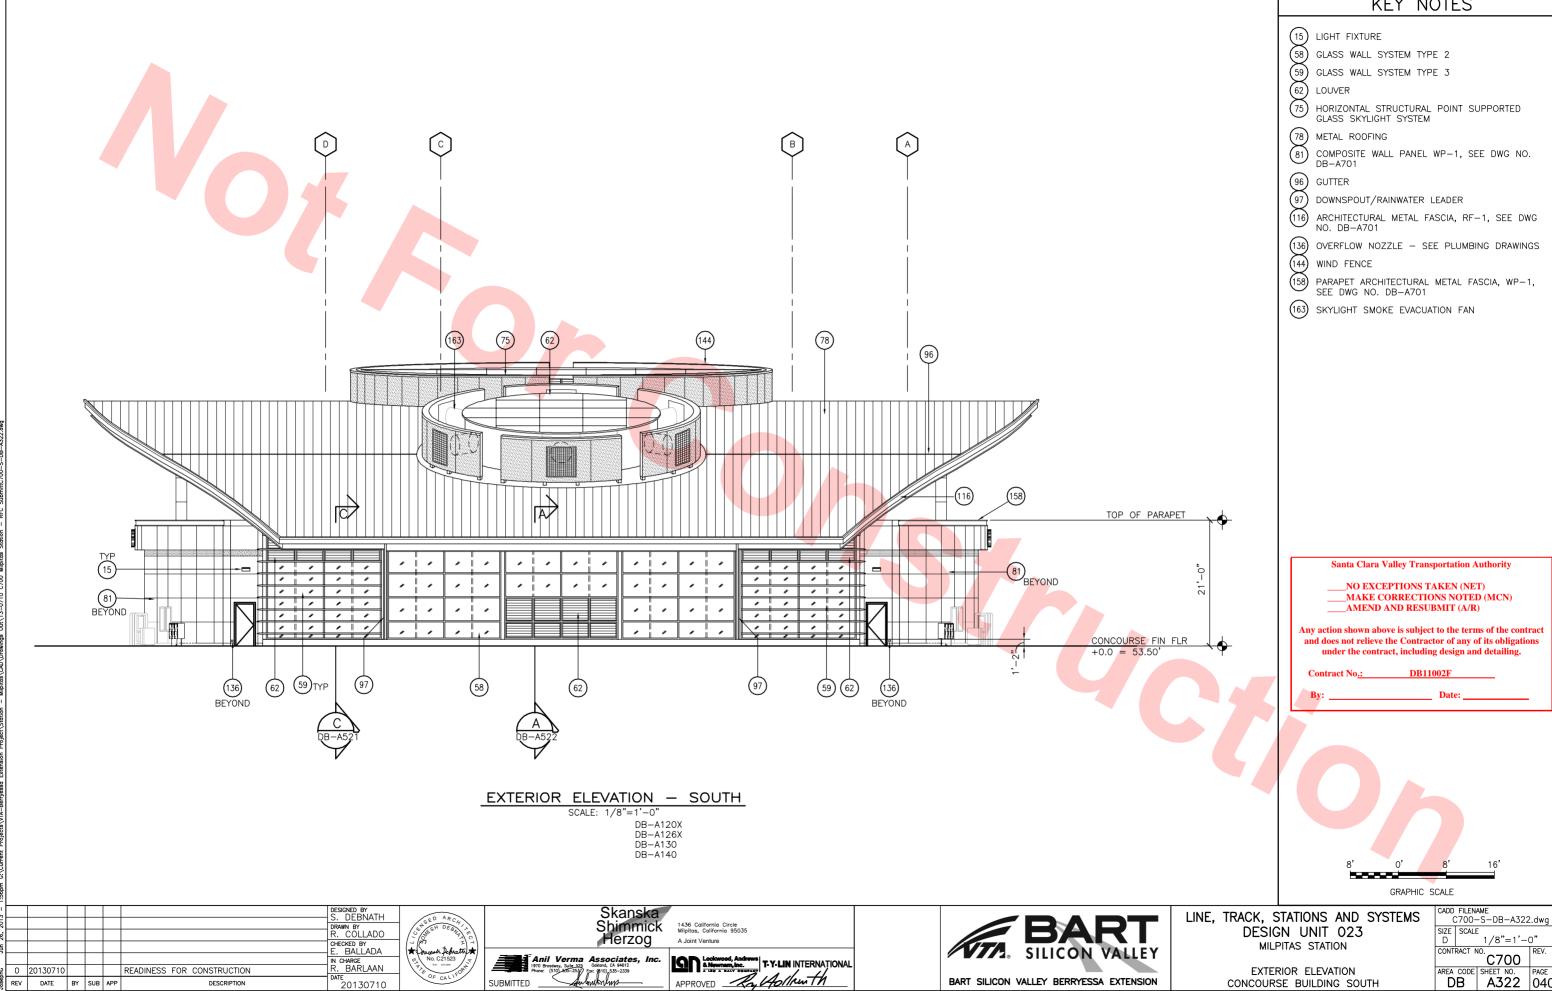

APPROVED Ry Hollruth

SUBMITTED

20130710

KEY NOTES


COMPOSITE WALL PANEL WP-1, SEE DWG NO.

___MAKE CORRECTIONS NOTED (MCN)

and does not relieve the Contractor of any of its obligations under the contract, including design and detailing.

BART SILICON VALLEY BERRYESSA EXTENSION

EXTERIOR ELEVATION CONCOURSE BUILDING SOUTH C700 AREA CODE SHEET NO. PAGE NO. DB A322 0401

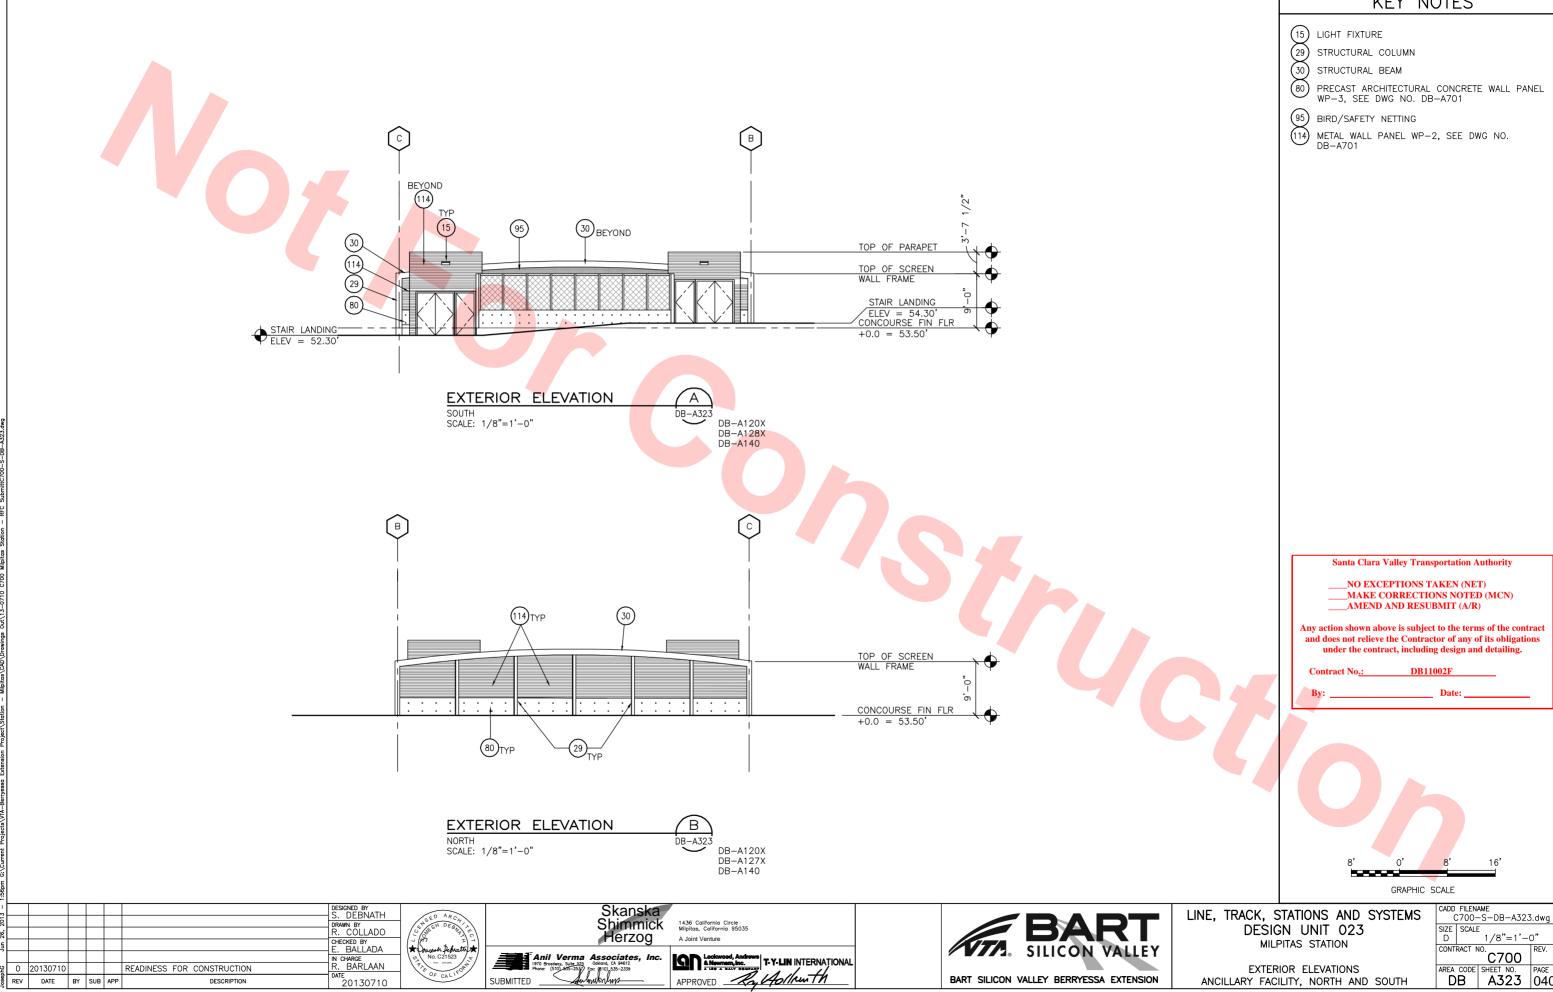

KEY NOTES


___MAKE CORRECTIONS NOTED (MCN)



ANCILLARY FACILITY, NORTH AND SOUTH

SIZE | SCALE | D | 1/8"=1'-0" CONTRACT NO. C700 REV. O AREA CODE SHEET NO. PAGE NO. DB A323 0402



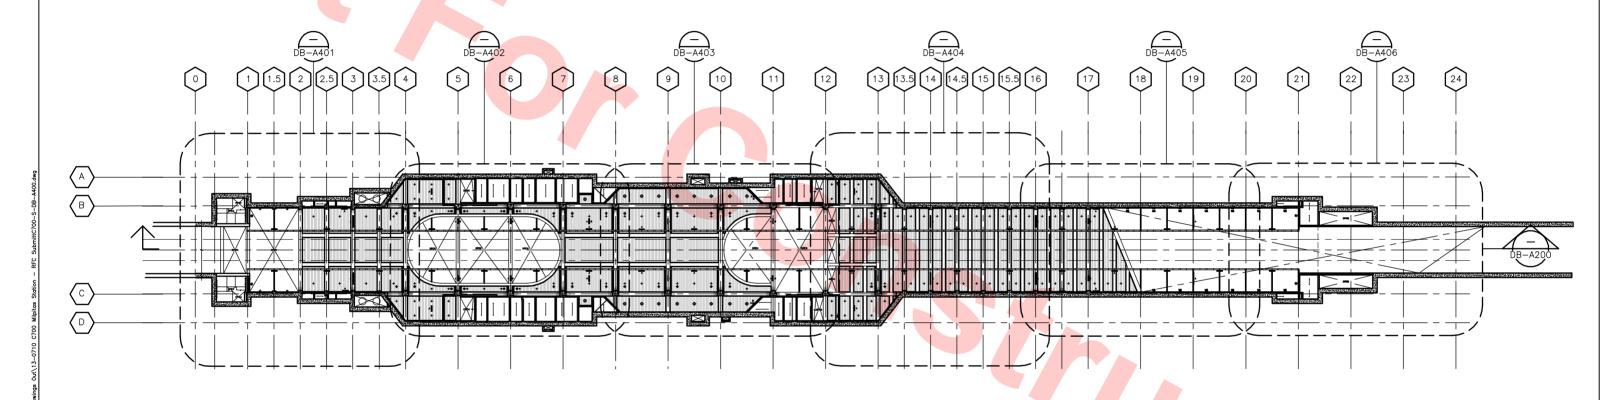

KEY PLAN — PLATFORM LEVEL REFLECTED CEILING PLAN

SCALE: 1/32"=1'-0"


NOTE: FOR U

FOR UTILITY PIPE SLEEVES LAYOUT SEE SHEET DB-A218

Santa Clara Valley Transportation Authority

___NO EXCEPTIONS TAKEN (NET)
__MAKE CORRECTIONS NOTED (MCN)
_AMEND AND RESUBMIT (A/R)

Any action shown above is subject to the terms of the contract and does not relieve the Contractor of any of its obligations under the contract, including design and detailing.

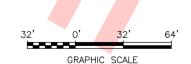

						DESIGNED BY S. DEBNATH	
1						DRAWN BY	
						R. COLLADO	
						CHECKED BY E. BALLADA	-
							. '
						IN CHARGE	
0	20130710				READINESS FOR CONSTRUCTION	R. BARLAAN	
REV	DATE	BY	SUB	APP	DESCRIPTION	DATE 00170710	
	J		1 555		S253(11 11014	20130710	



SUBMITTED

Skanska	
Shimmick	1436 California Circle Milpitas, California 95035
Herzog	A Joint Venture
Prma Associates, Inc. Suite 525 Ookland, CA 94612 55-2537) Fox: (\$10),535-2339	Lockwood, Andrews A Newmam, Inc. A Life A DALY COMPANY T-Y-LIN INTERNATIONAL
Submitneys	APPROVED Rollren Th



LINE, TRACK, STATIONS AND SYSTEMS

DESIGN UNIT 023


MILPITAS STATION


KEY PLAN


PLATFORM LEVEL


REFLECTED CEILING PLAN


STEMS	CADD FILENAME C700-S-DB-A400.dwg				
	SIZE D	SCALE		."=1'-	0"
	C700			REV.	
			SHEET		PAGE N
	D	В	A4	.00	0403

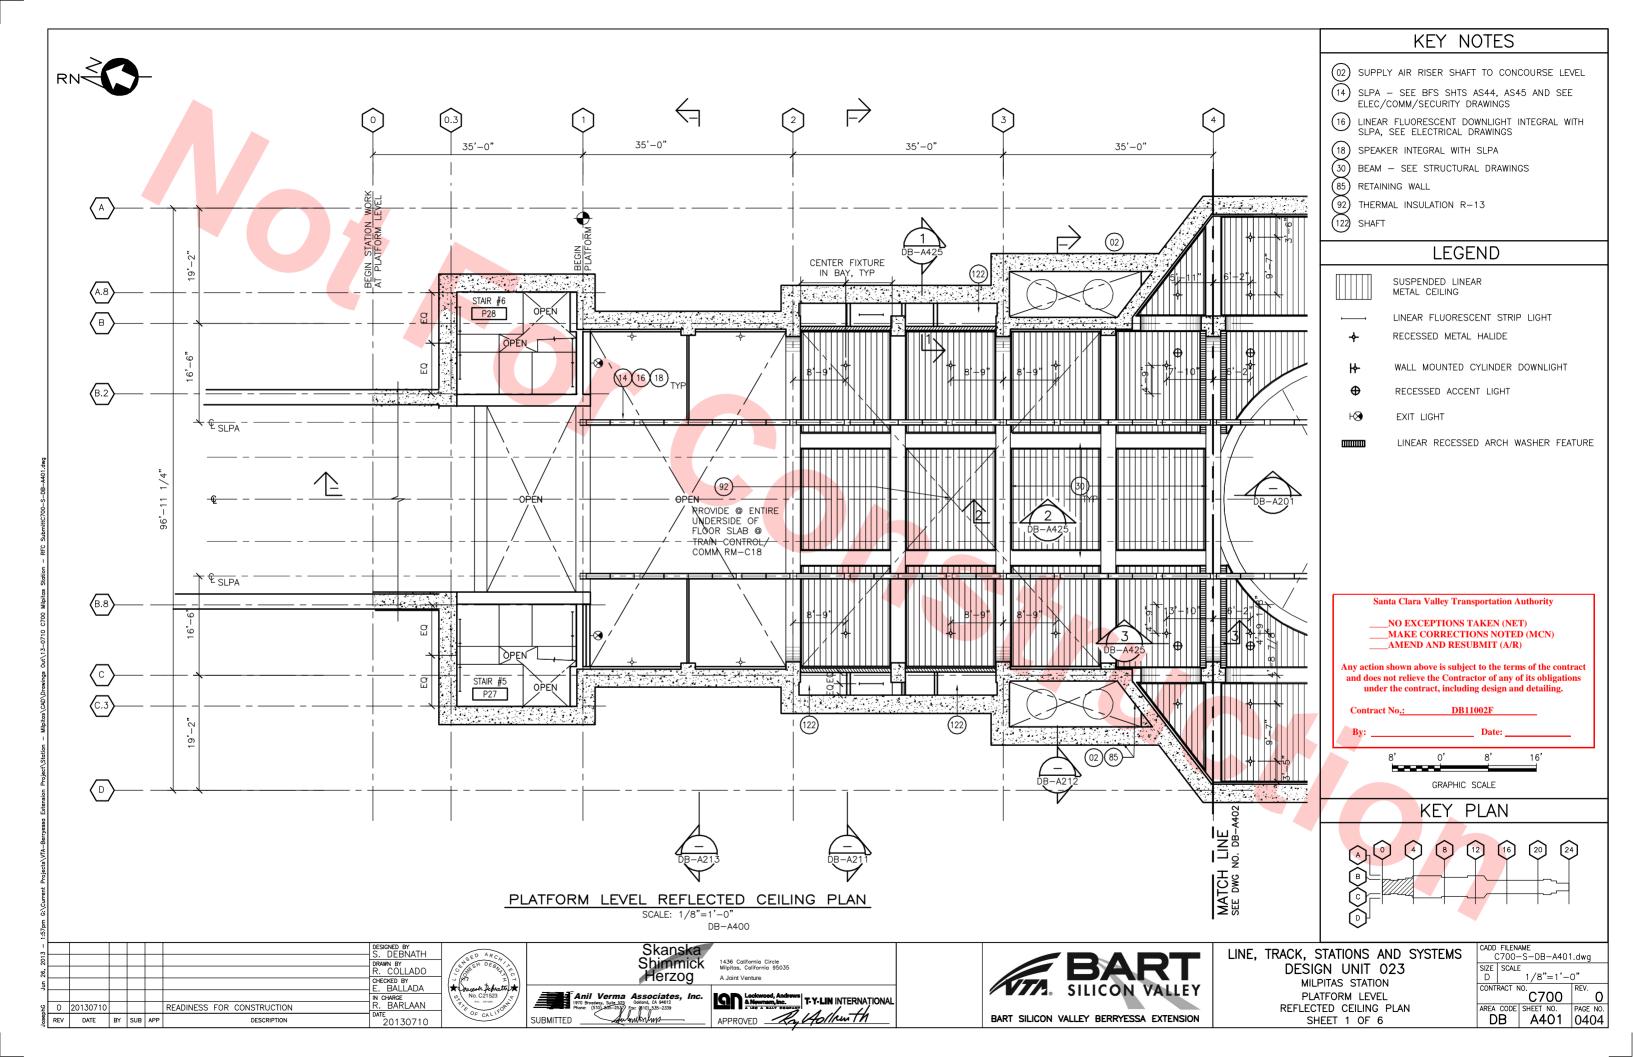


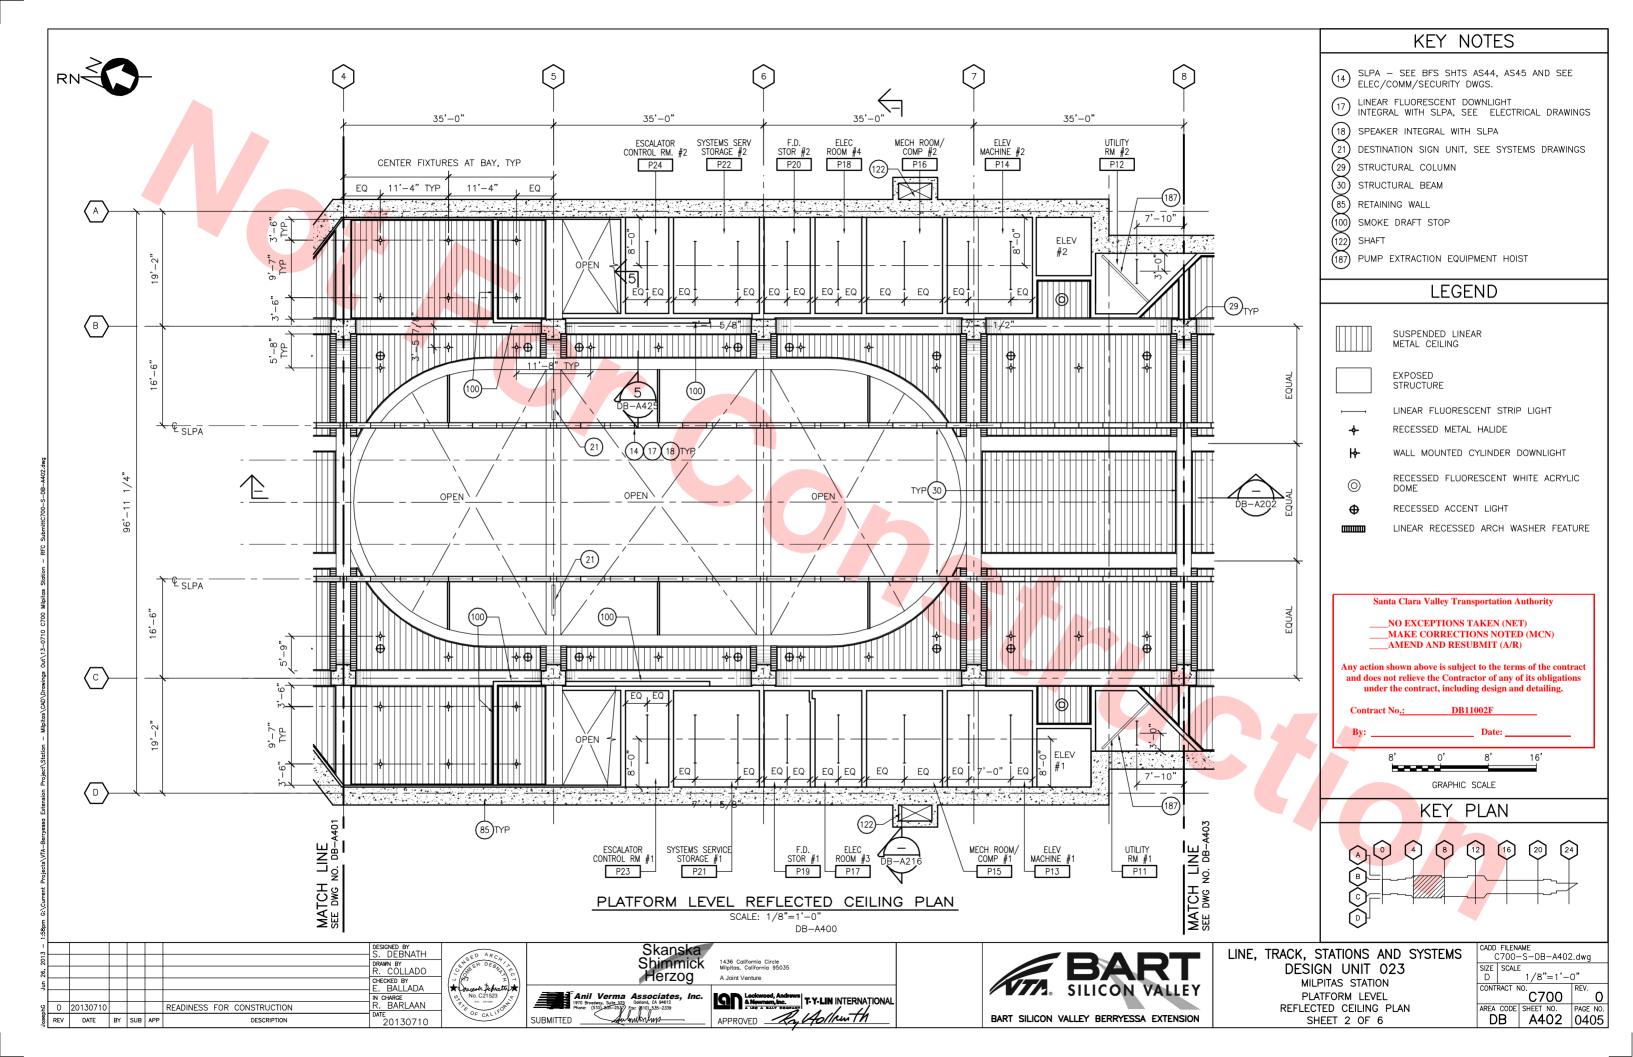

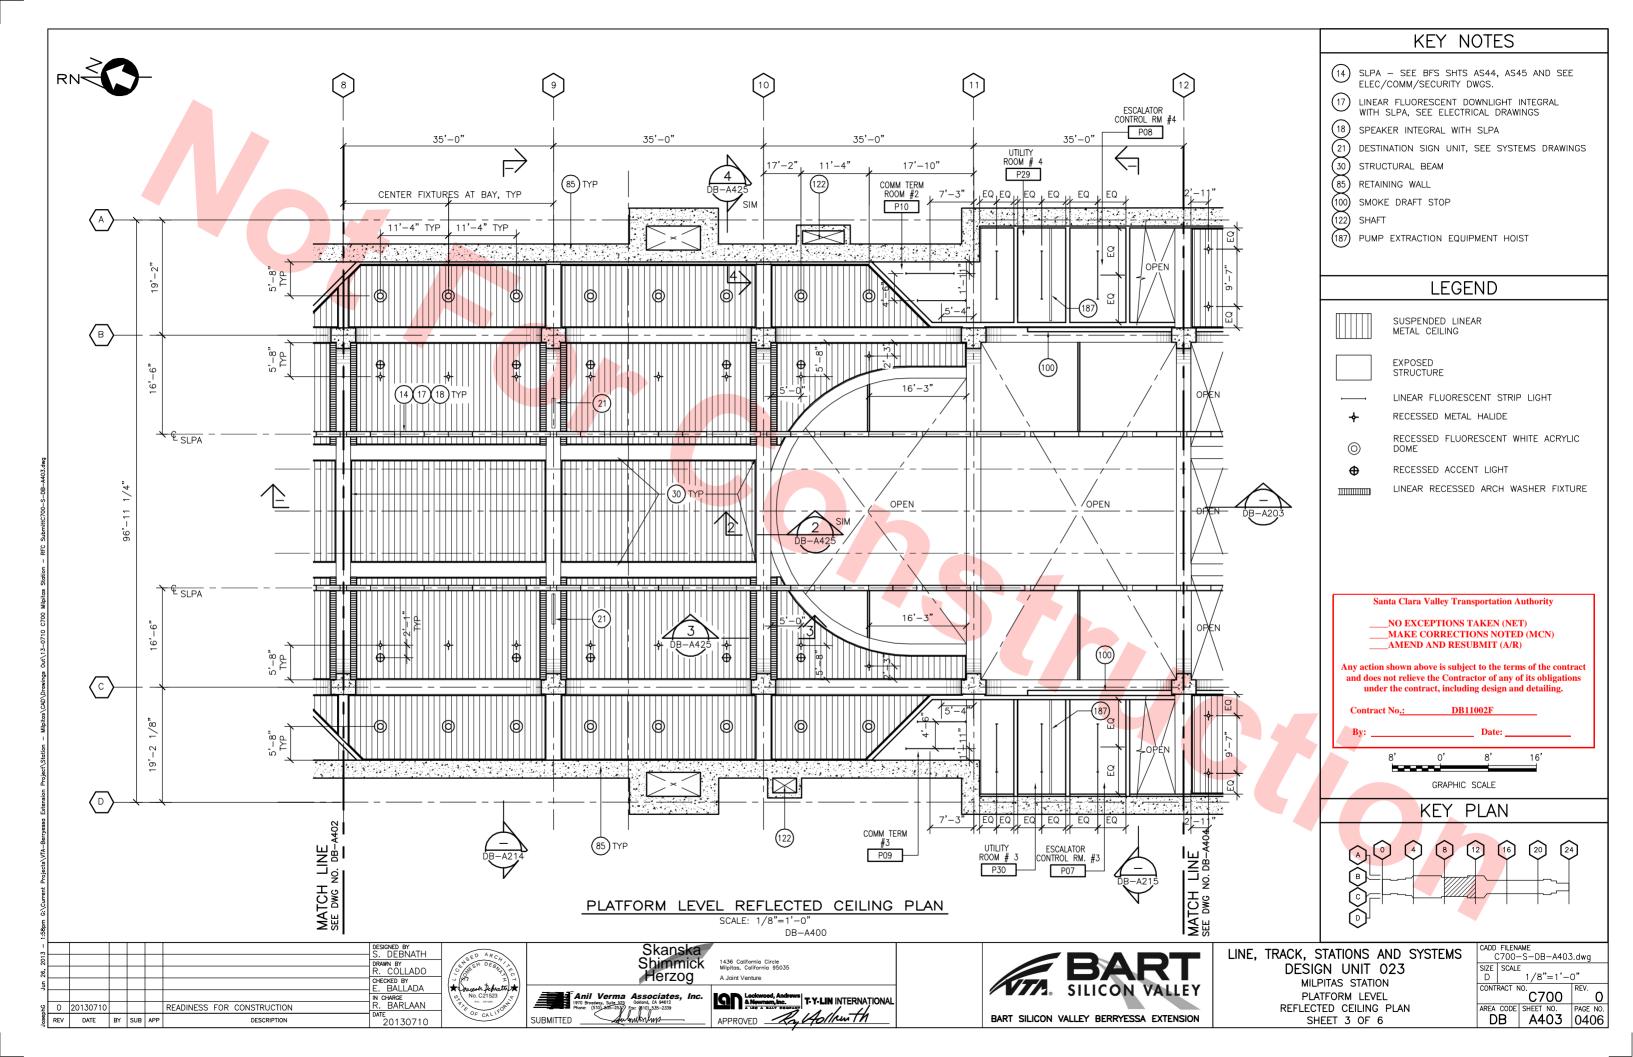


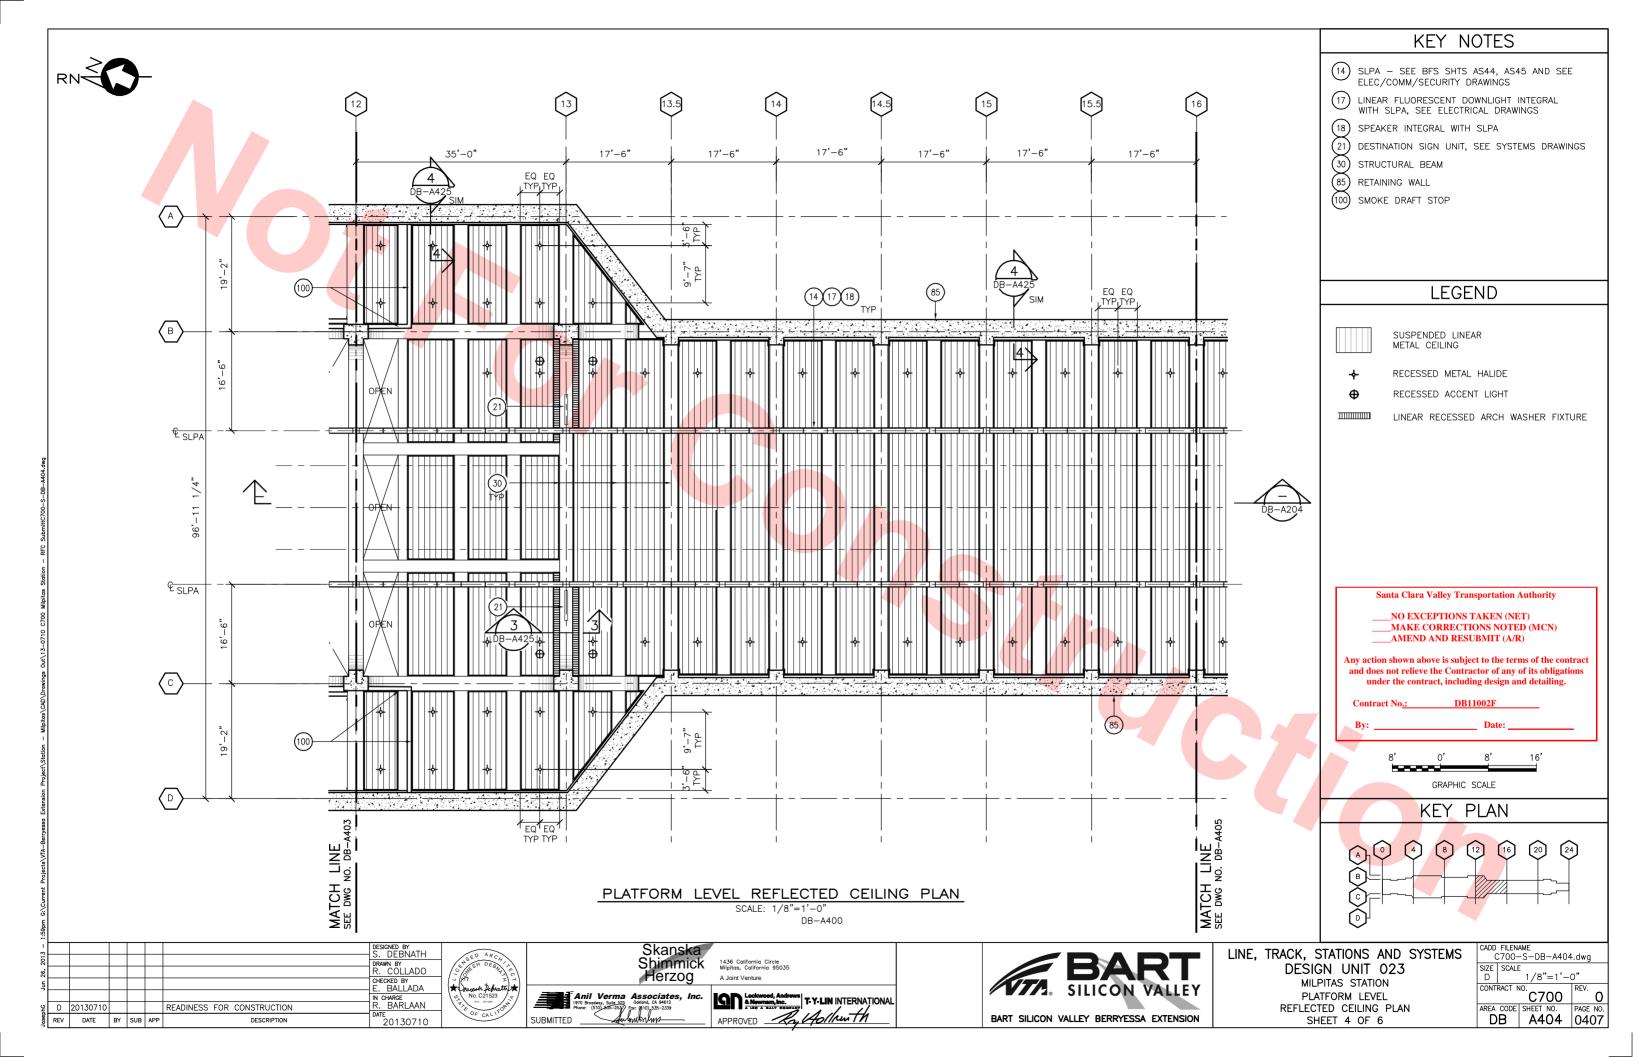

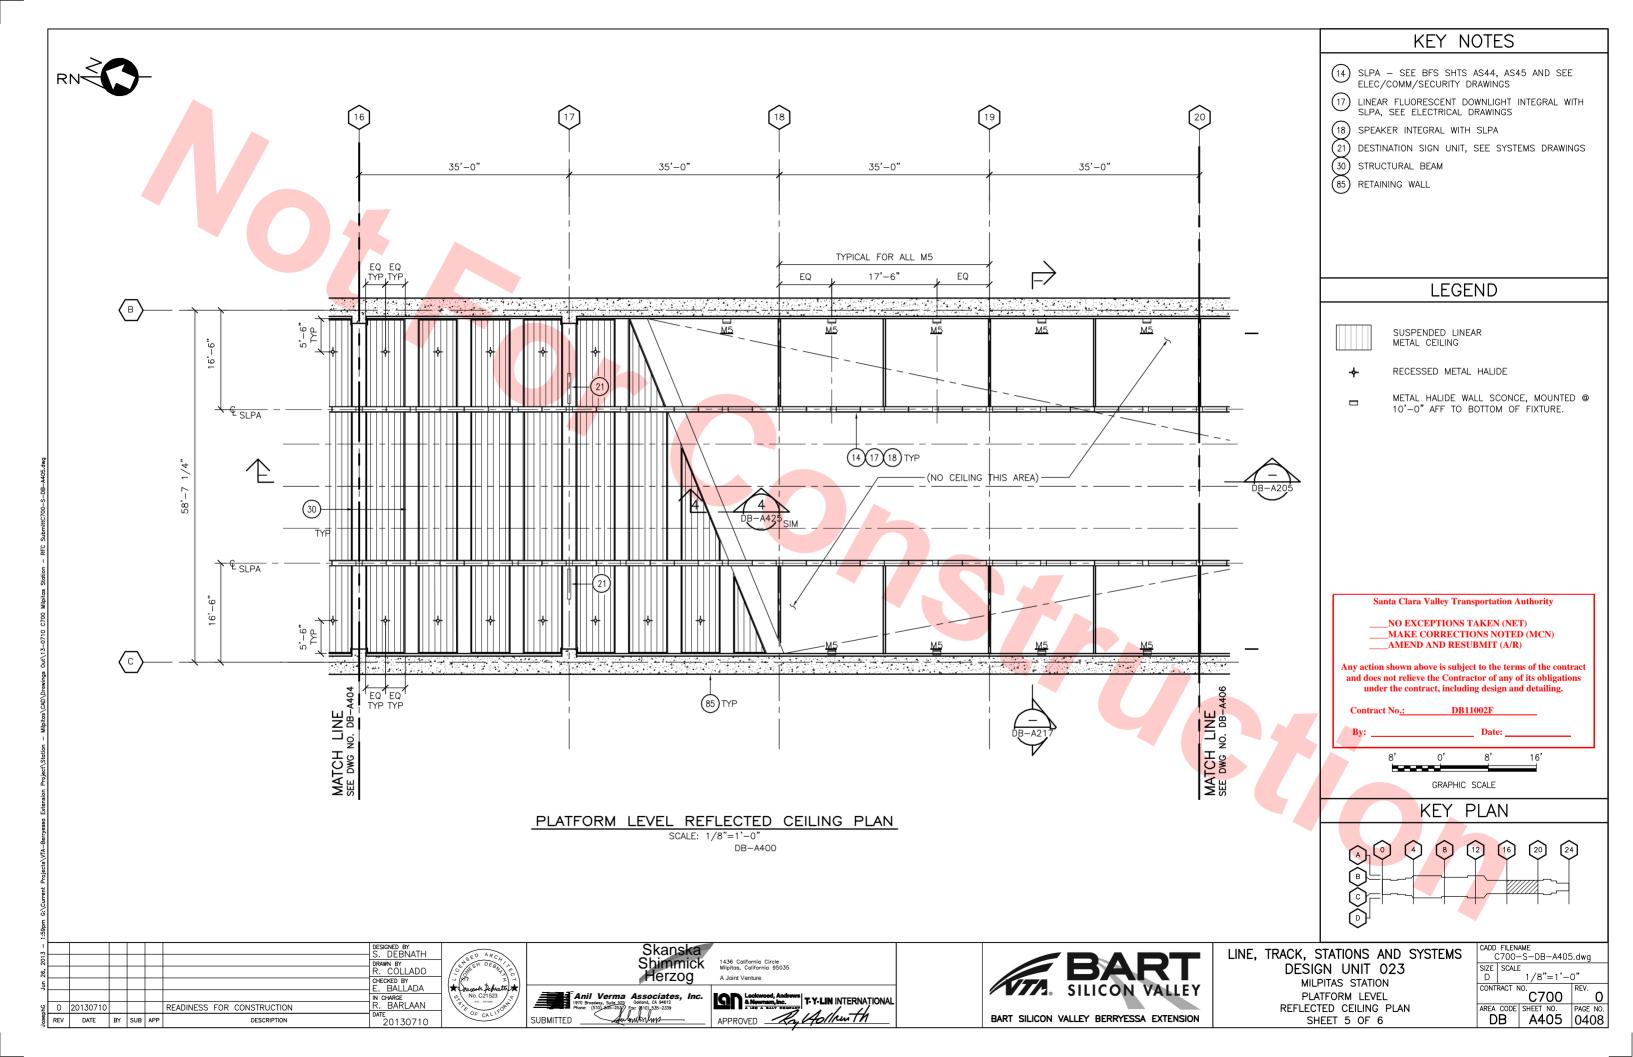

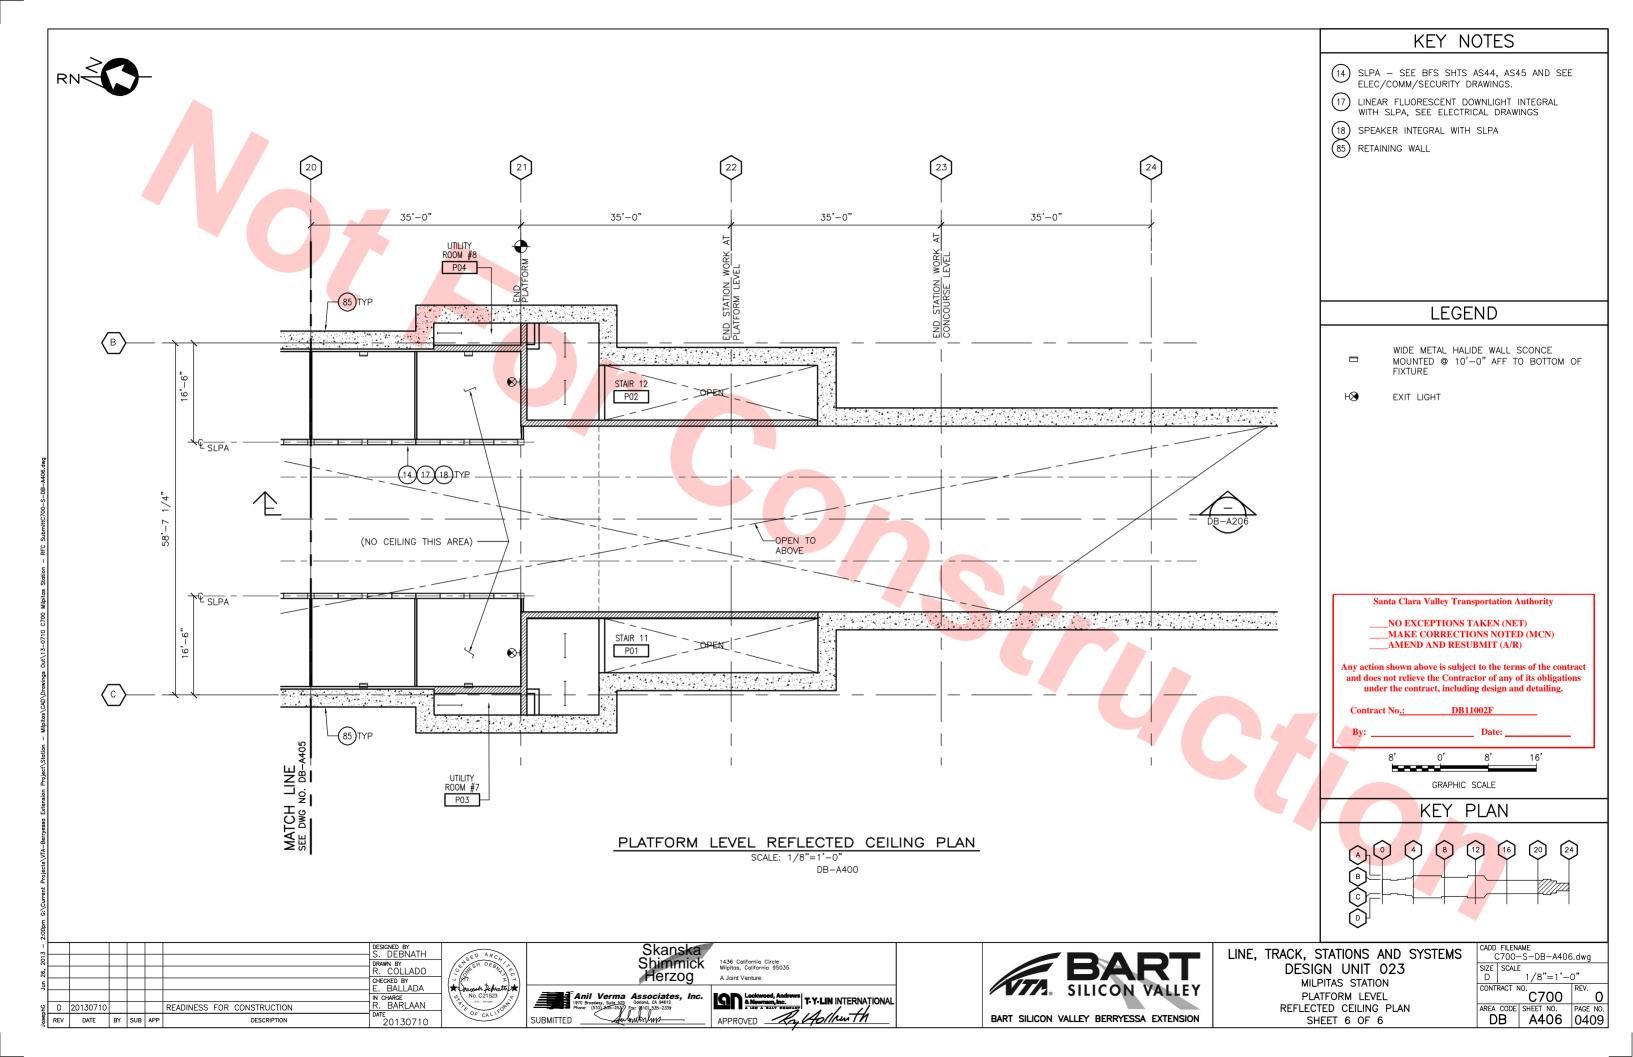



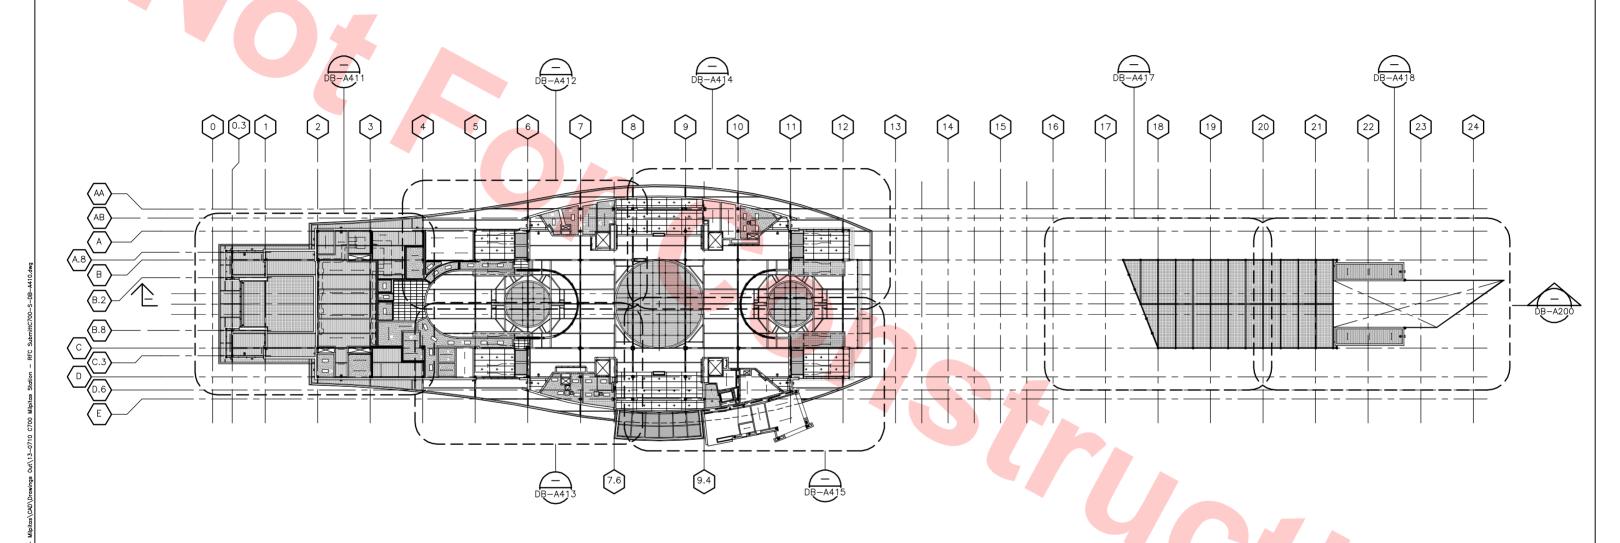

KEY PLAN - CONCOURSE LEVEL REFLECTED CEILING PLAN

SCALE: 1/32"=1'-0"


Santa Clara Valley Transportation Authority

___NO EXCEPTIONS TAKEN (NET)
__MAKE CORRECTIONS NOTED (MCN)
__AMEND AND RESUBMIT (A/R)

Any action shown above is subject to the terms of the contract and does not relieve the Contractor of any of its obligations under the contract, including design and detailing.

Contract No.: DB11002F

By: _____ Date: ______

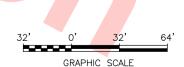

2							DESIGNED BY S. DEBNATH	
2							DRAWN BY	/
°							R. COLLADO	/-
un S							CHECKED BY E. BALLADA	(
							IN CHARGE	/,
Š	0	20130710				READINESS FOR CONSTRUCTION	R. BARLAAN	\
jesel	REV	DATE	BY	SUB	APP	DESCRIPTION	DATE 20130710	







LINE, TRACK, STATIONS AND SYSTEMS

DESIGN UNIT 023


MILPITAS STATION


KEY PLAN


CONCOURSE LEVEL


REFLECTED CEILING PLAN


IS		CADD FILENAME C700-S-DB-A410				
	SIZE SCA	LE 1/32"=1'-	-0"			
	CONTRACT	C700	REV.			
	AREA COD DB	SHEET NO. A410	PAGE NO 0410			
	SIZE SCA D CONTRACT	1/32"=1'- NO. C700 E SHEET NO.	-O" REV. PAGE N			

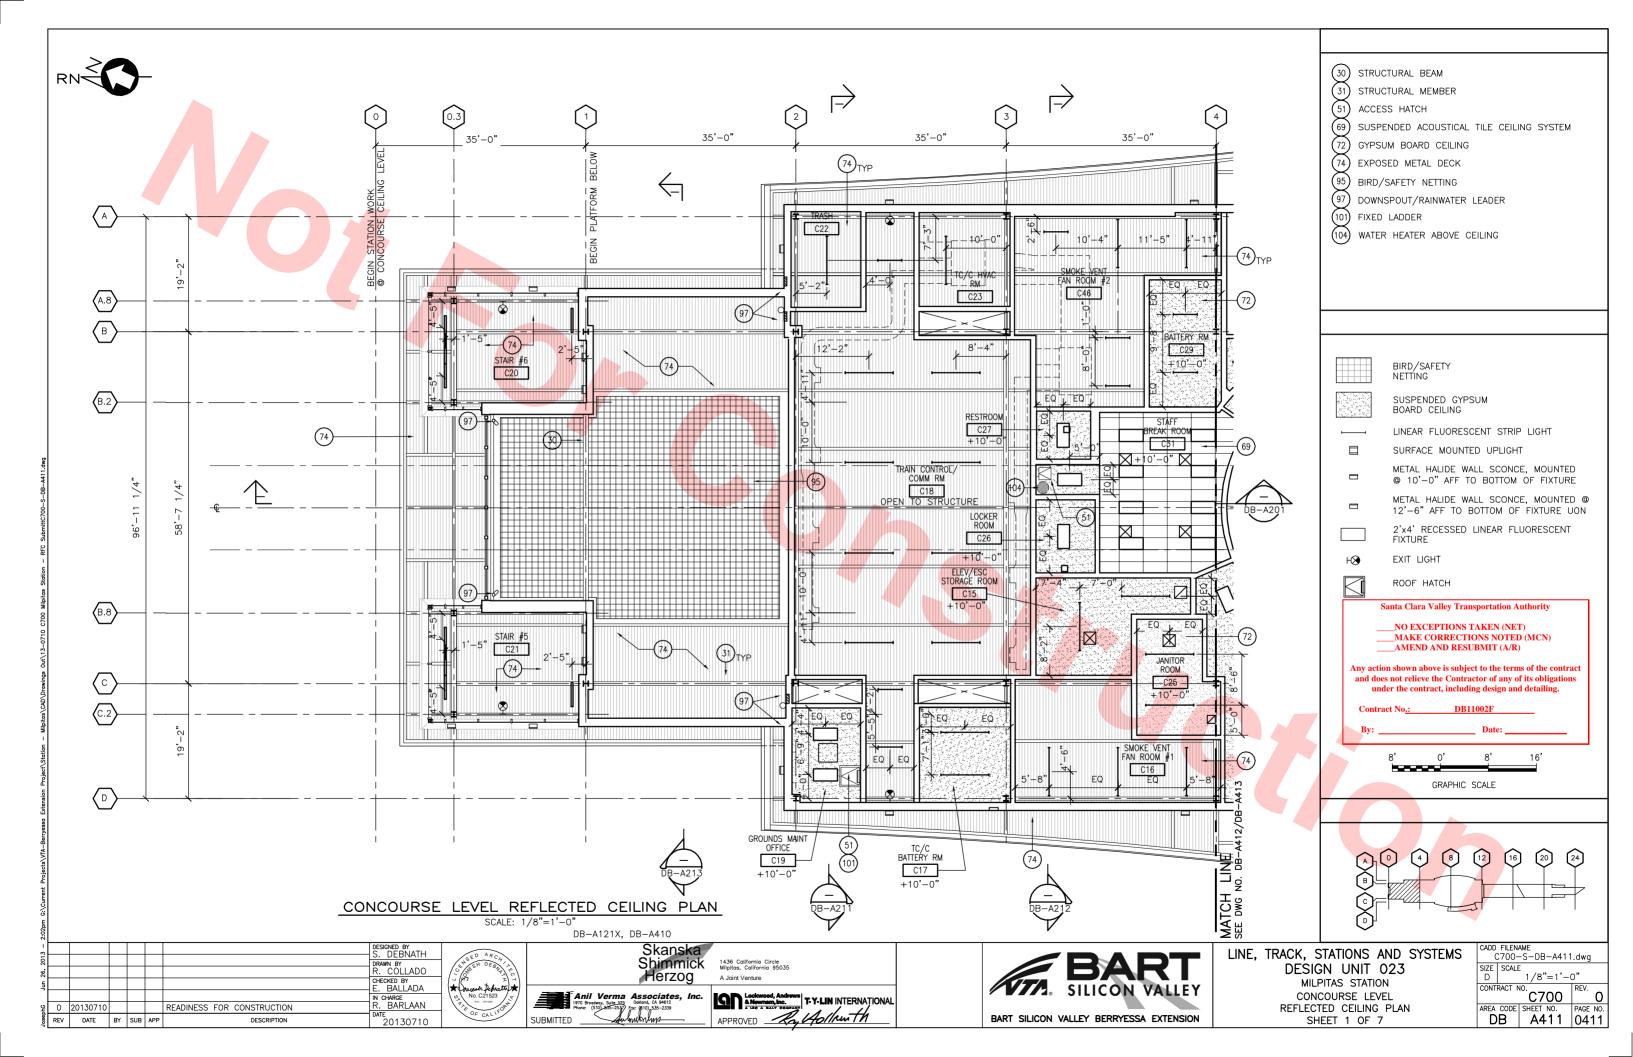


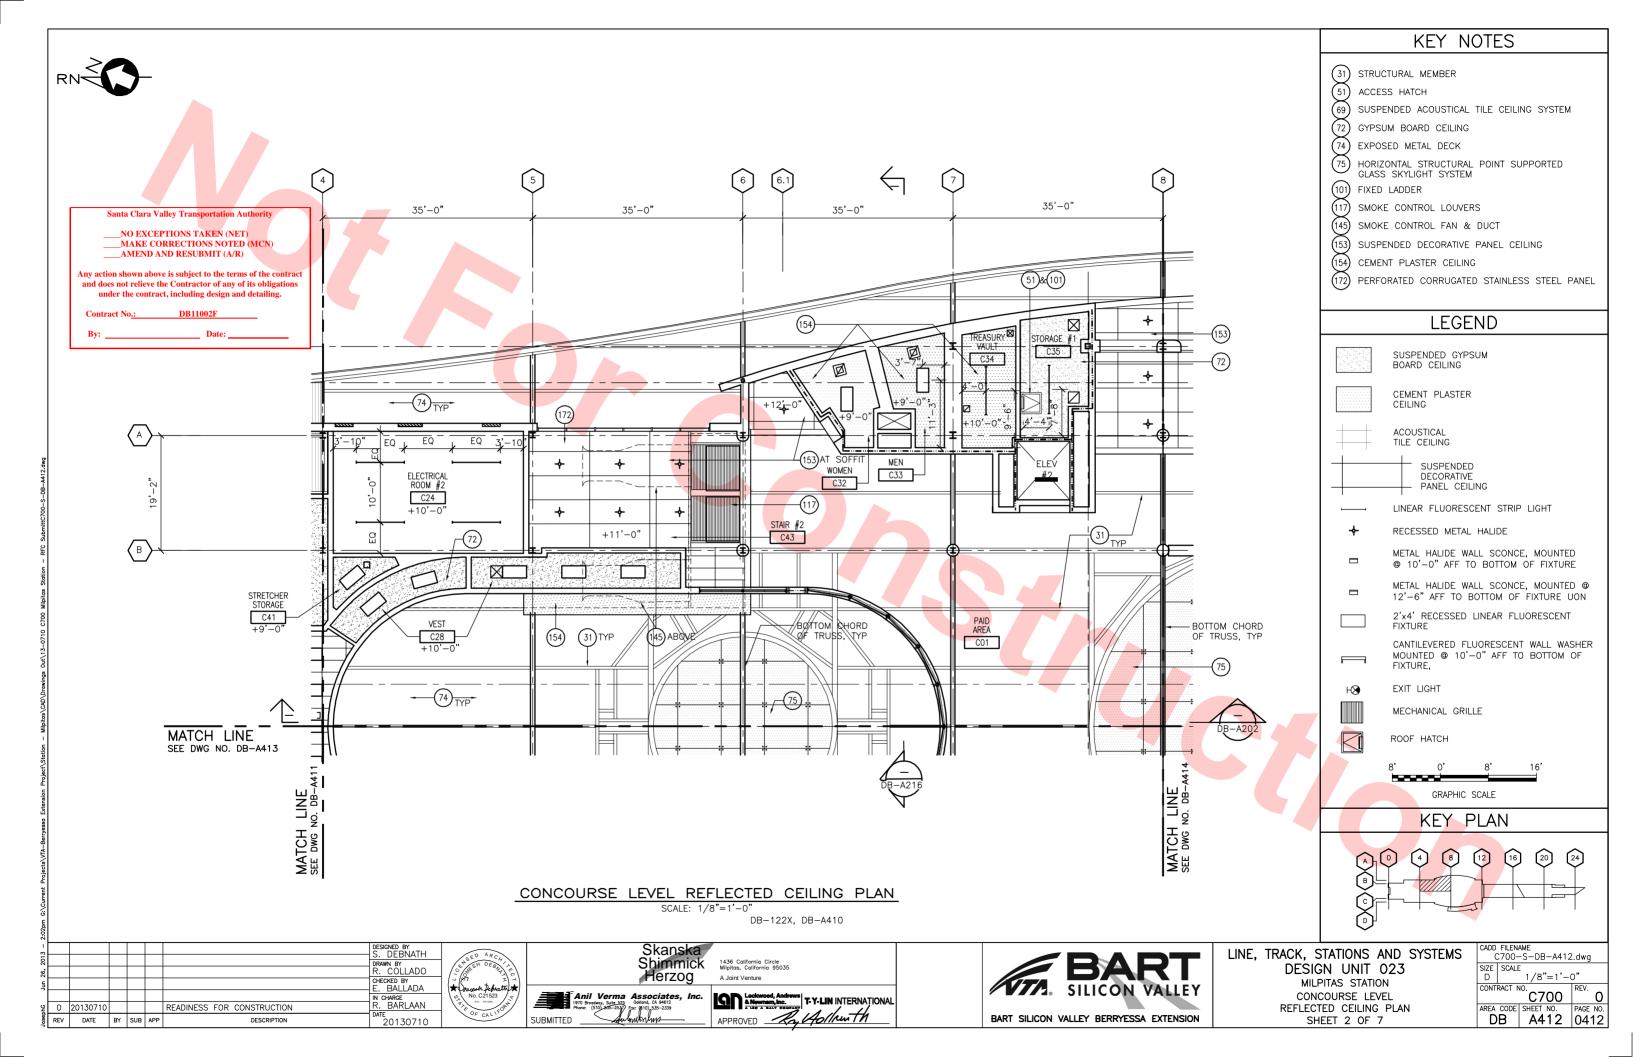


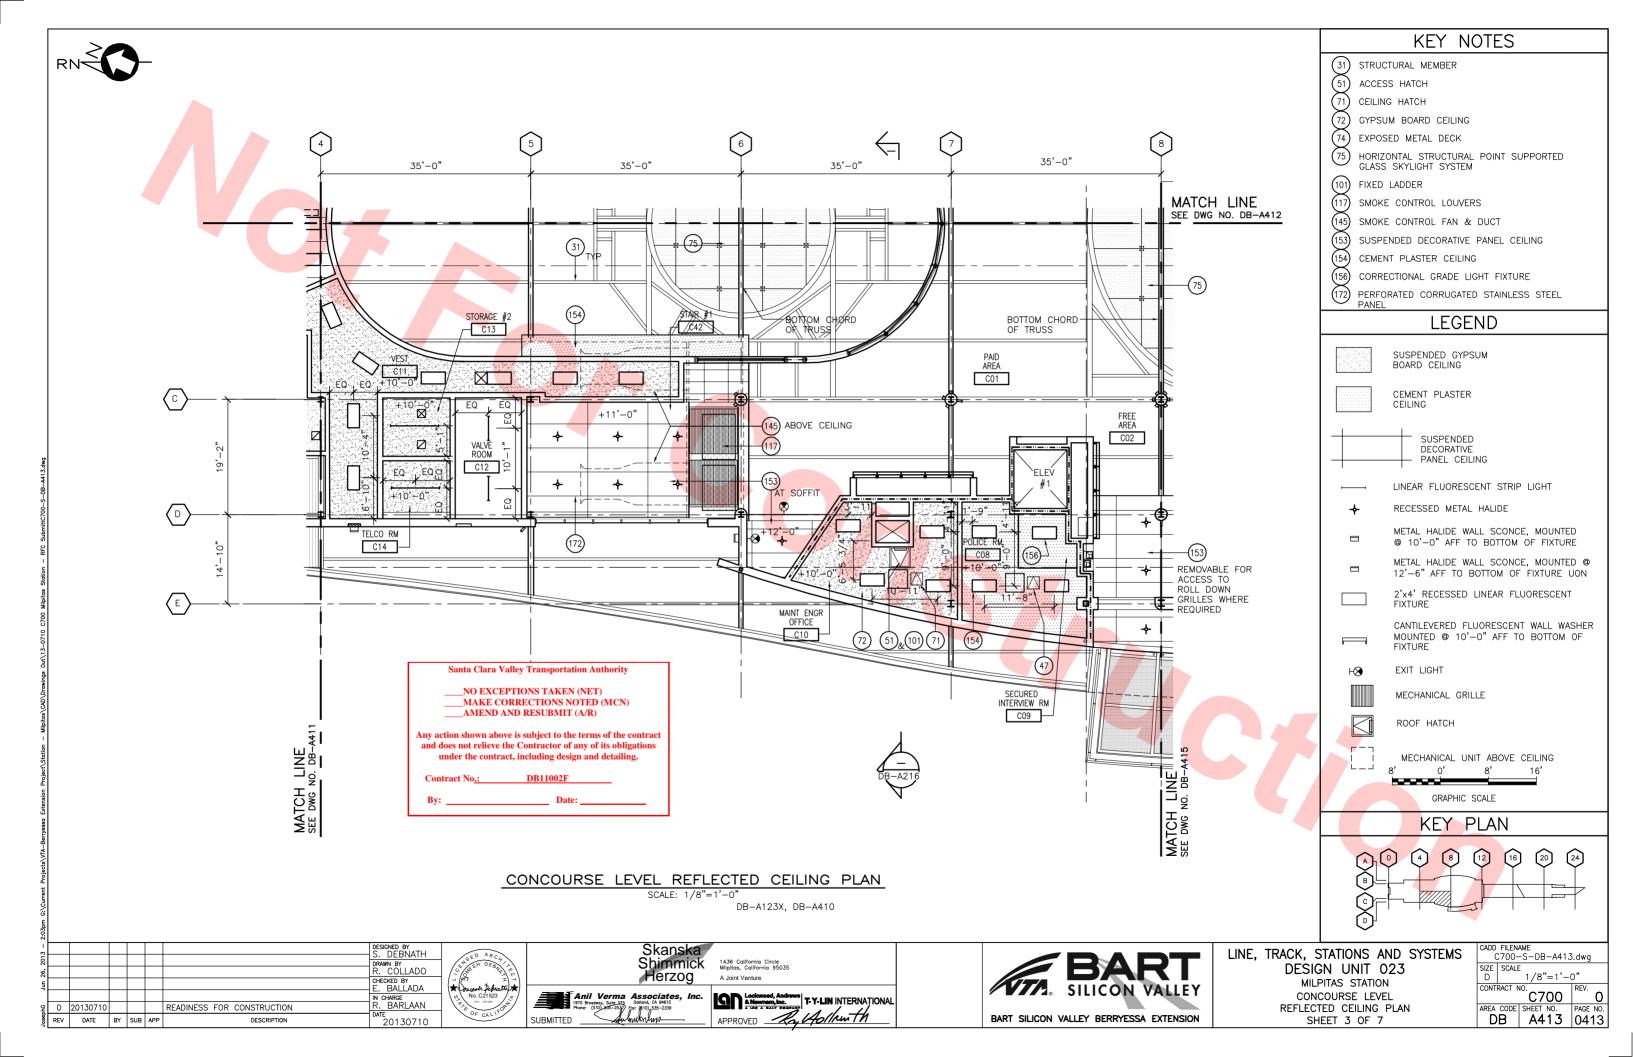

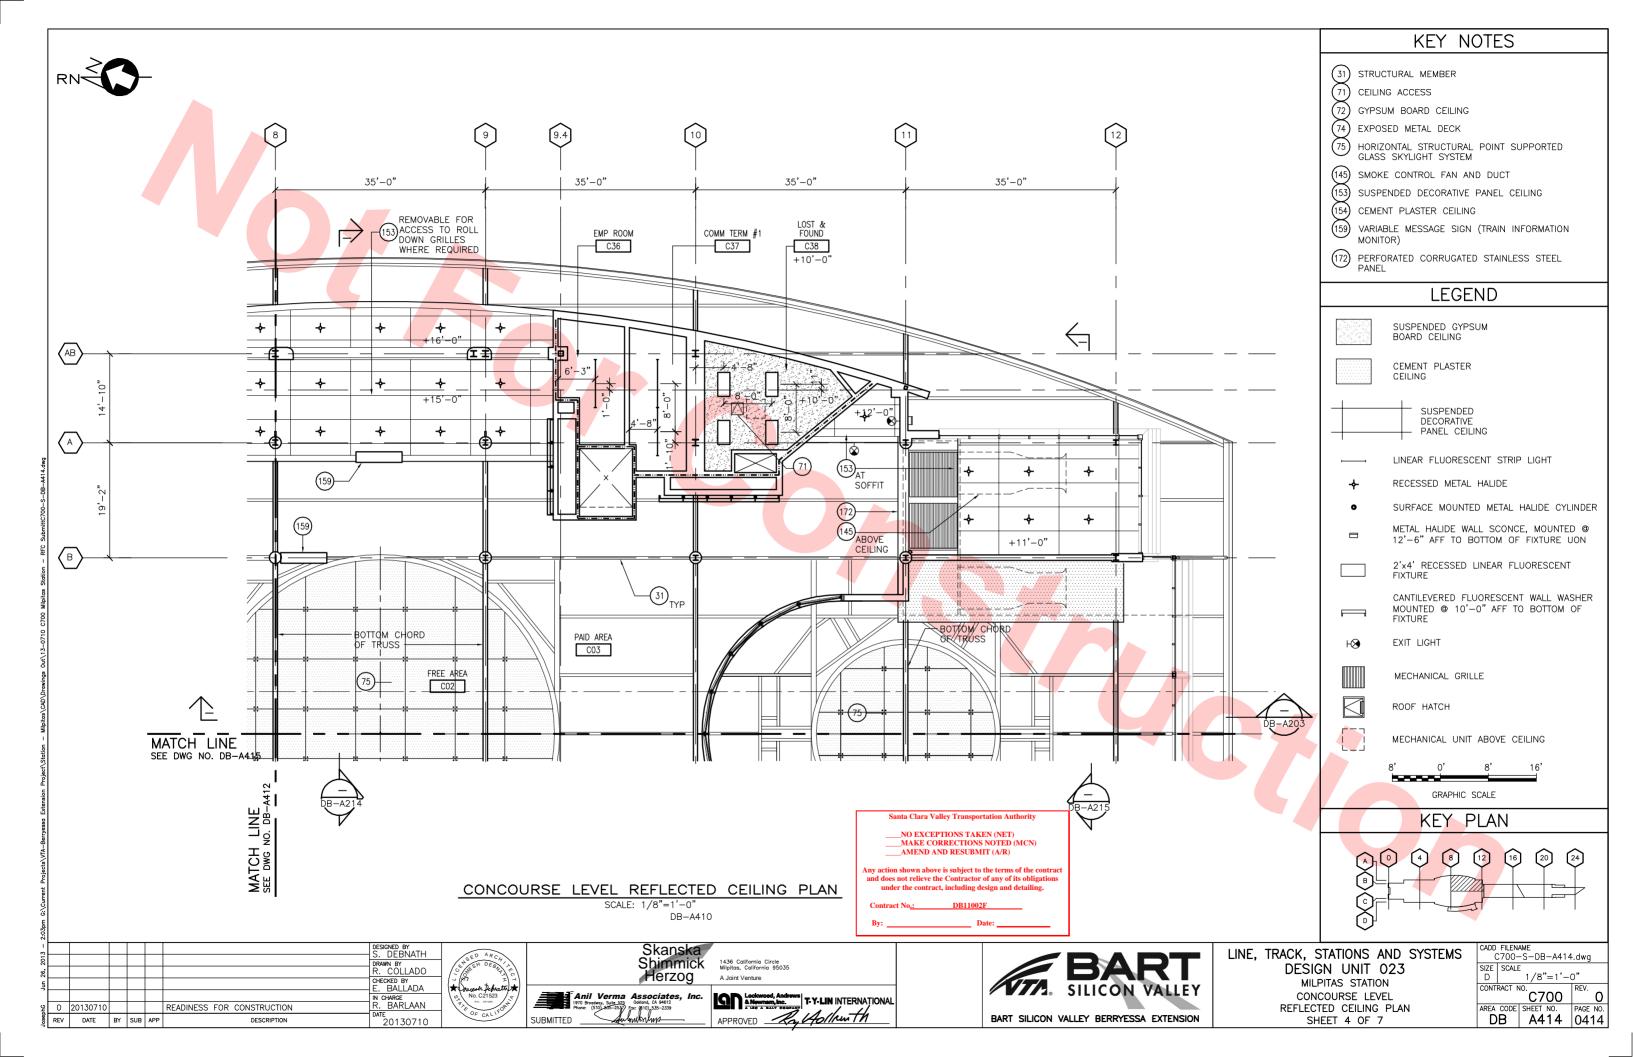


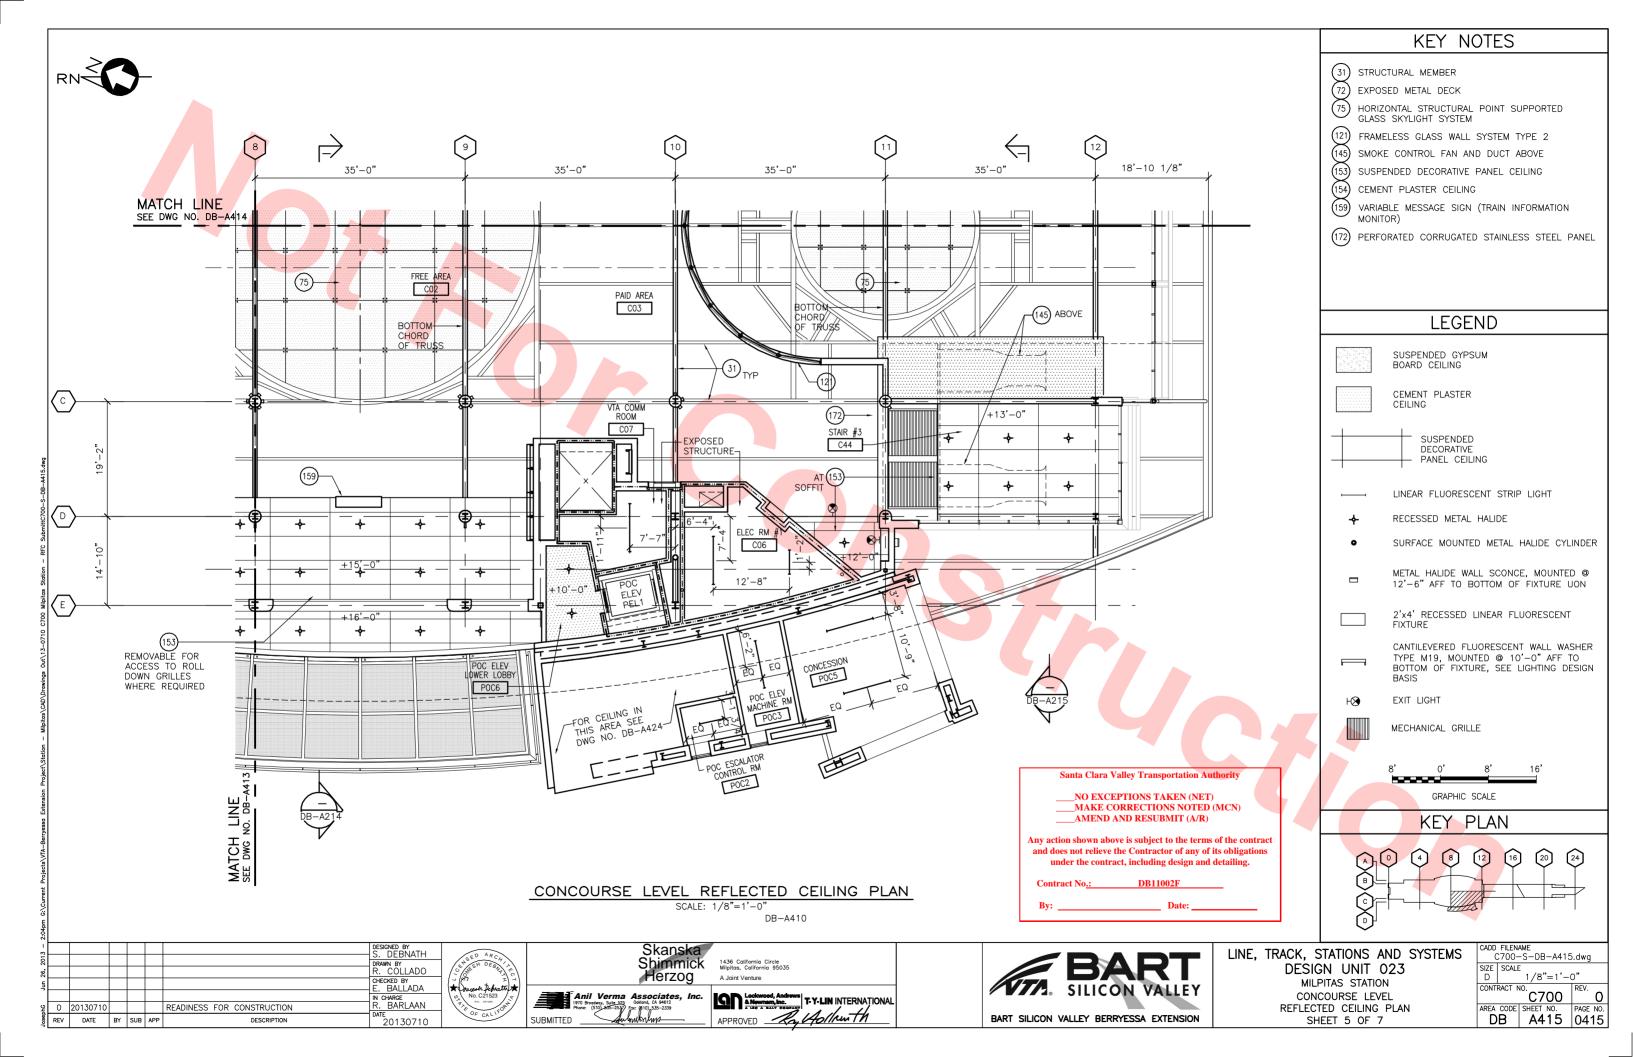

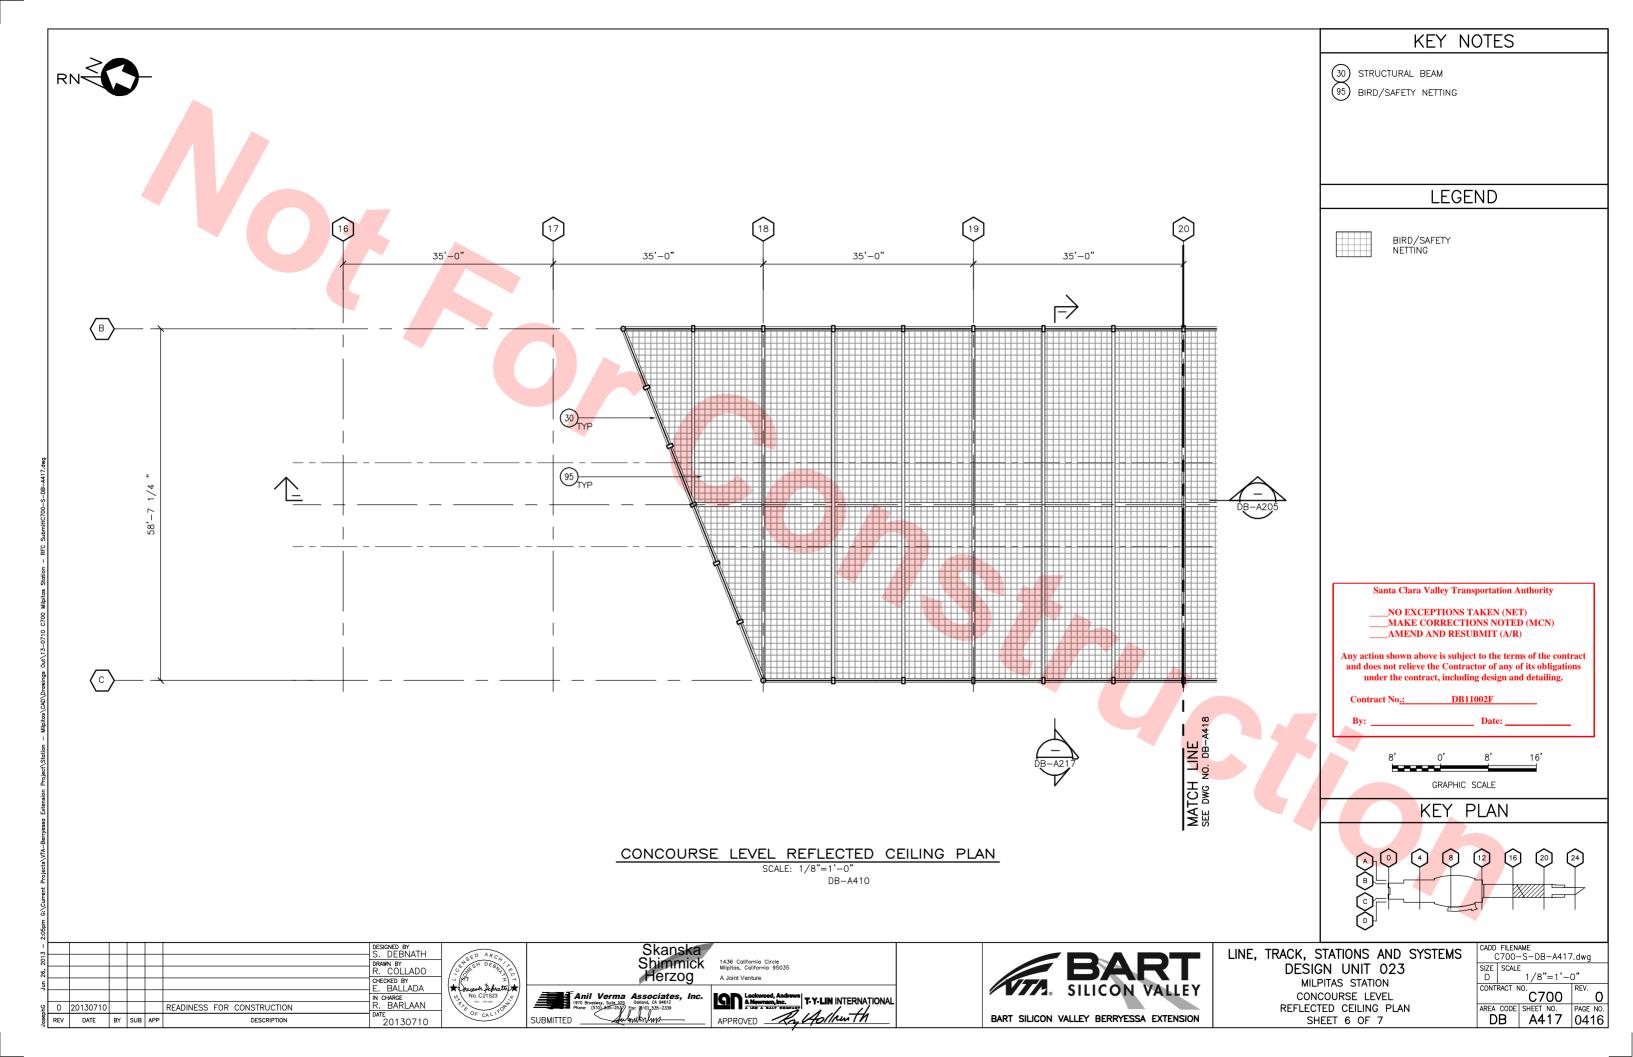

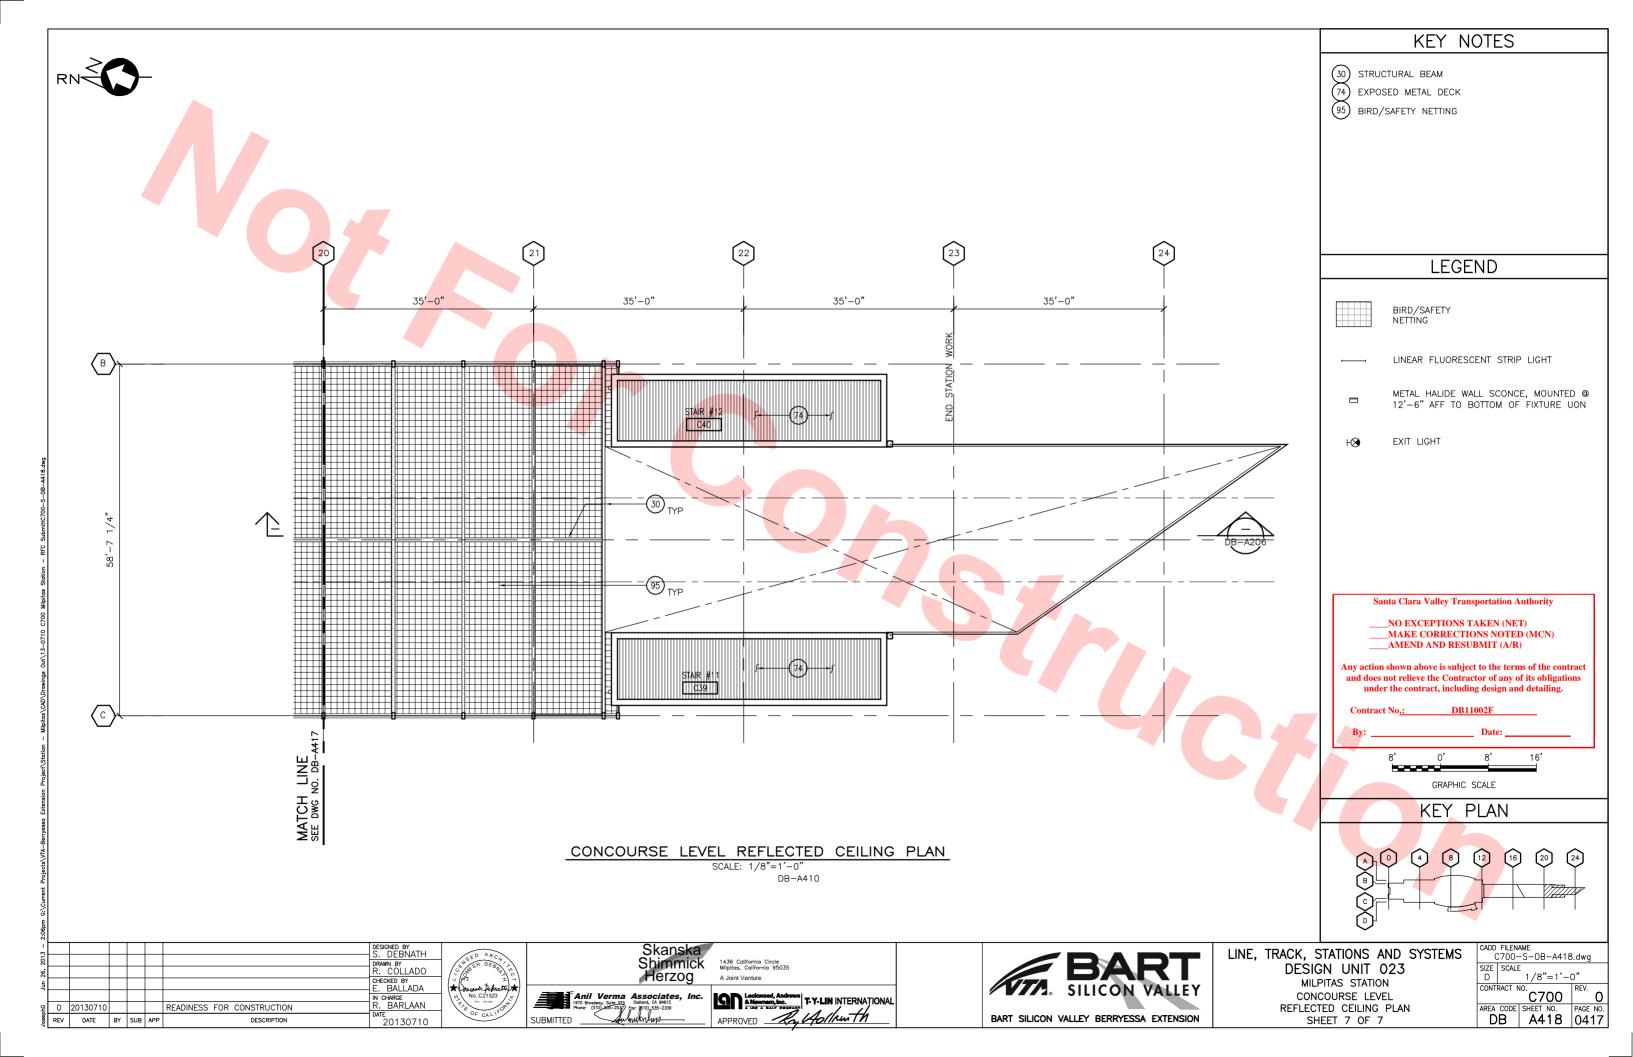



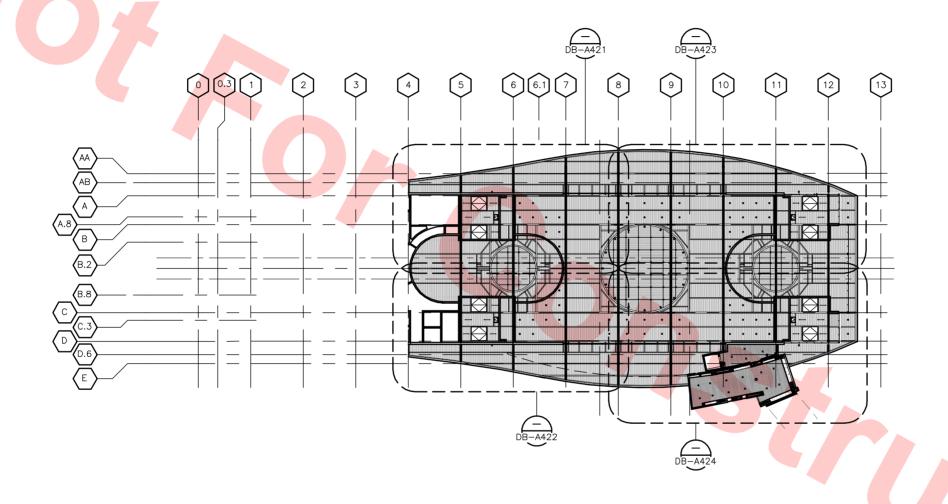


Santa Clara Valley Transportation Authority


___NO EXCEPTIONS TAKEN (NET) MAKE CORRECTIONS NOTED (MCN)
AMEND AND RESUBMIT (A/R)

Any action shown above is subject to the terms of the contract and does not relieve the Contractor of any of its obligations under the contract, including design and detailing.

KEY PLAN - CONCOURSE LEVEL HIGH CEILING - REFLECTED CEILING PLAN SCALE: 1/32"=1'-0"

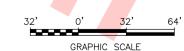

1											
201											
26,											
5											
ephG	0	20130710				READINESS FOR CONSTRUCTION					
ose	REV	DATE	BY	SUB	APP	DESCRIPTION					

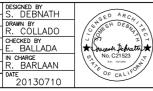

CHECKED BY E. BALLADA










LINE, TRACK, STATIONS AND SYSTEM DESIGN UNIT 023
MILPITAS STATION KEY PLAN CONCOURSE LEVEL HIGH CEILING

REFLECTED CEILING PLAN


MS		FILEN. C700-	AME -S-DB-A420).dwg
	SIZE D	SCALE	1/32"=1'-	0"
	CONT	RACT N	^{10.} C700	REV. O
		CODE B	SHEET NO. A420	PAGE NO 0418

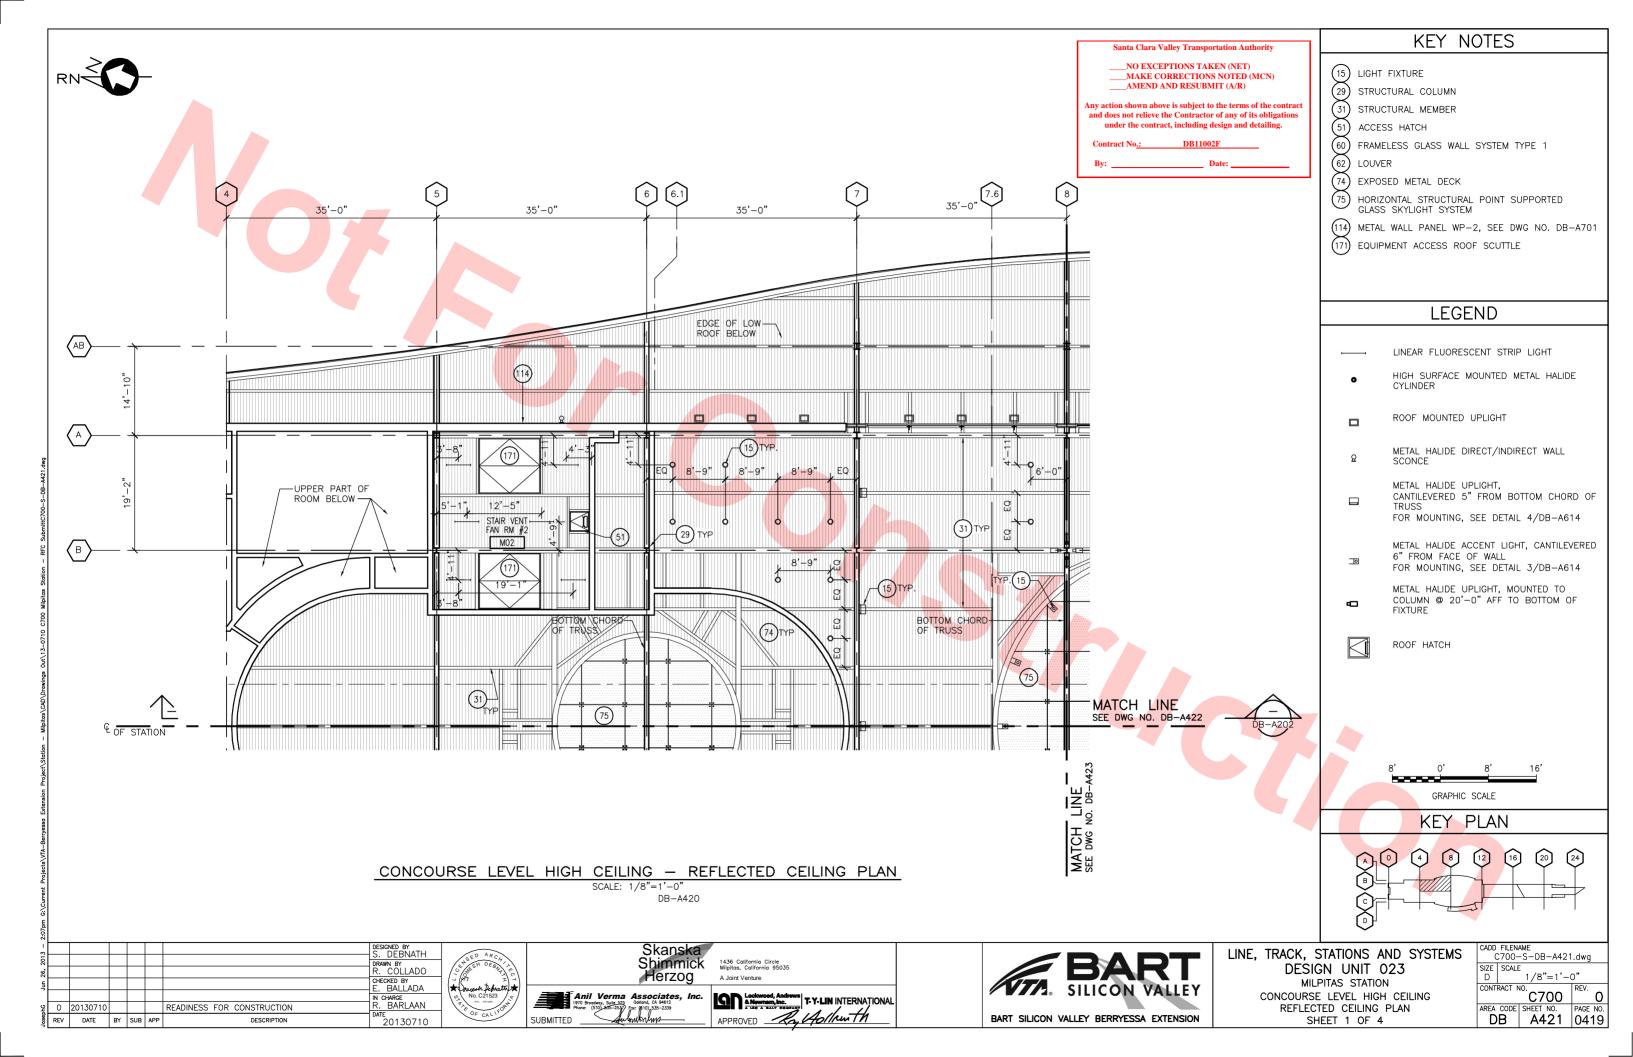

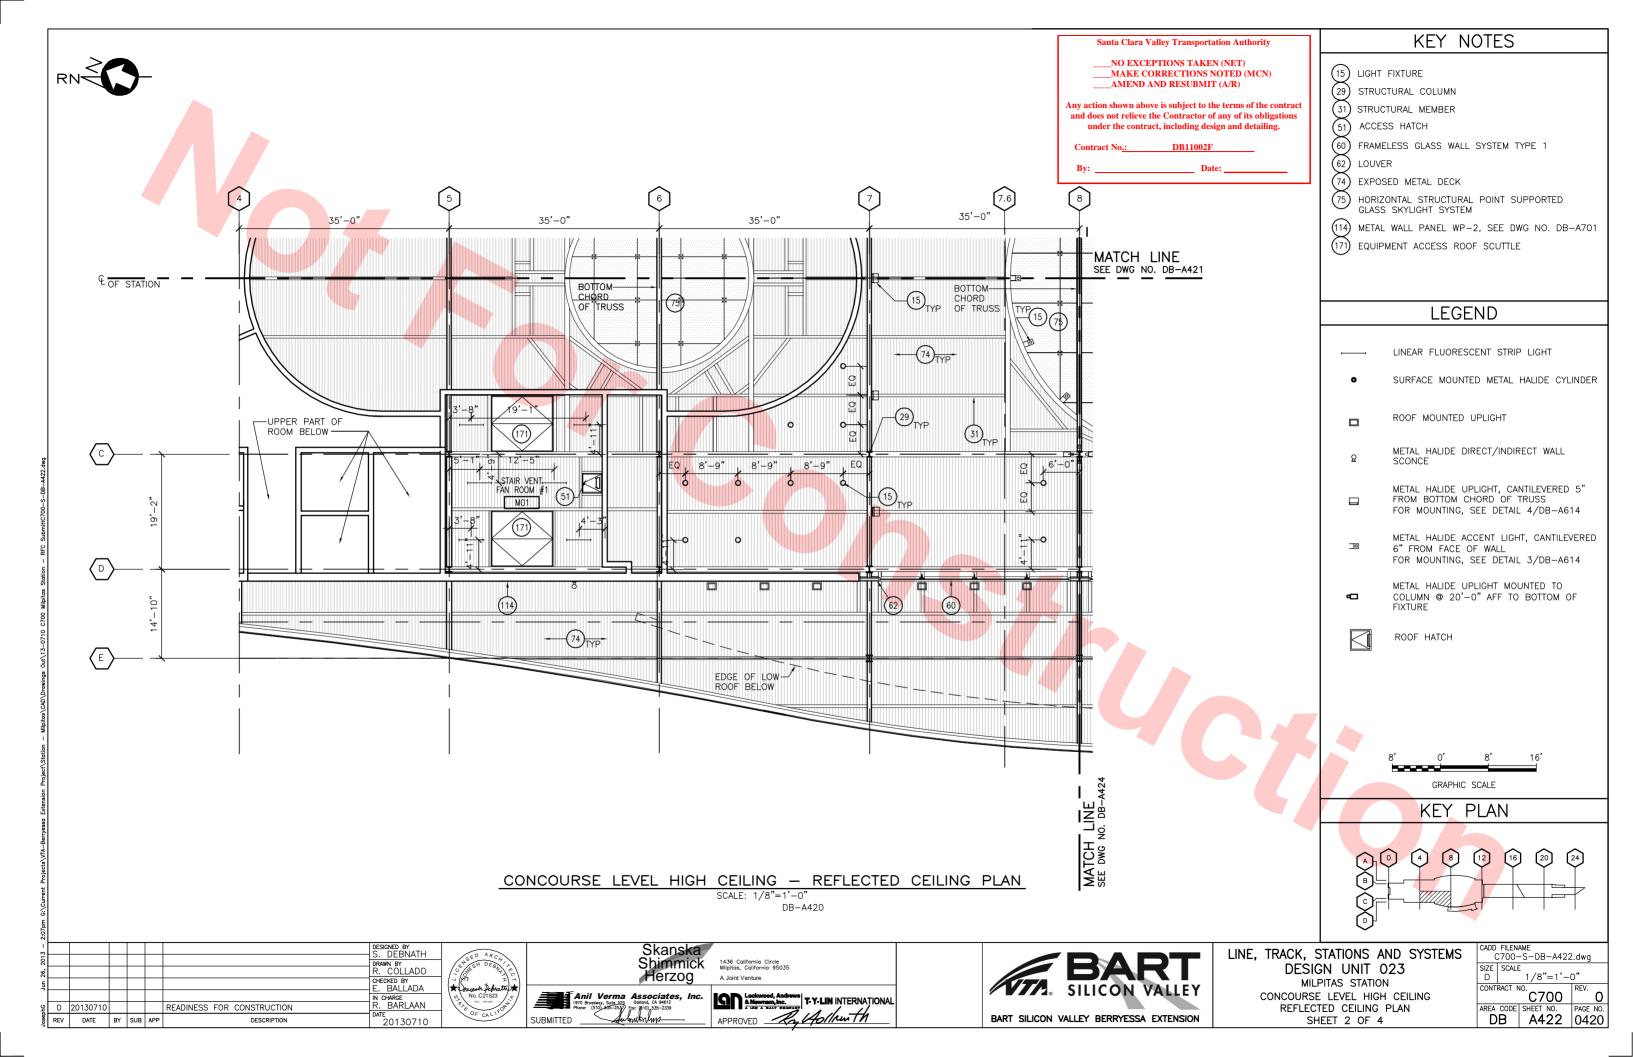

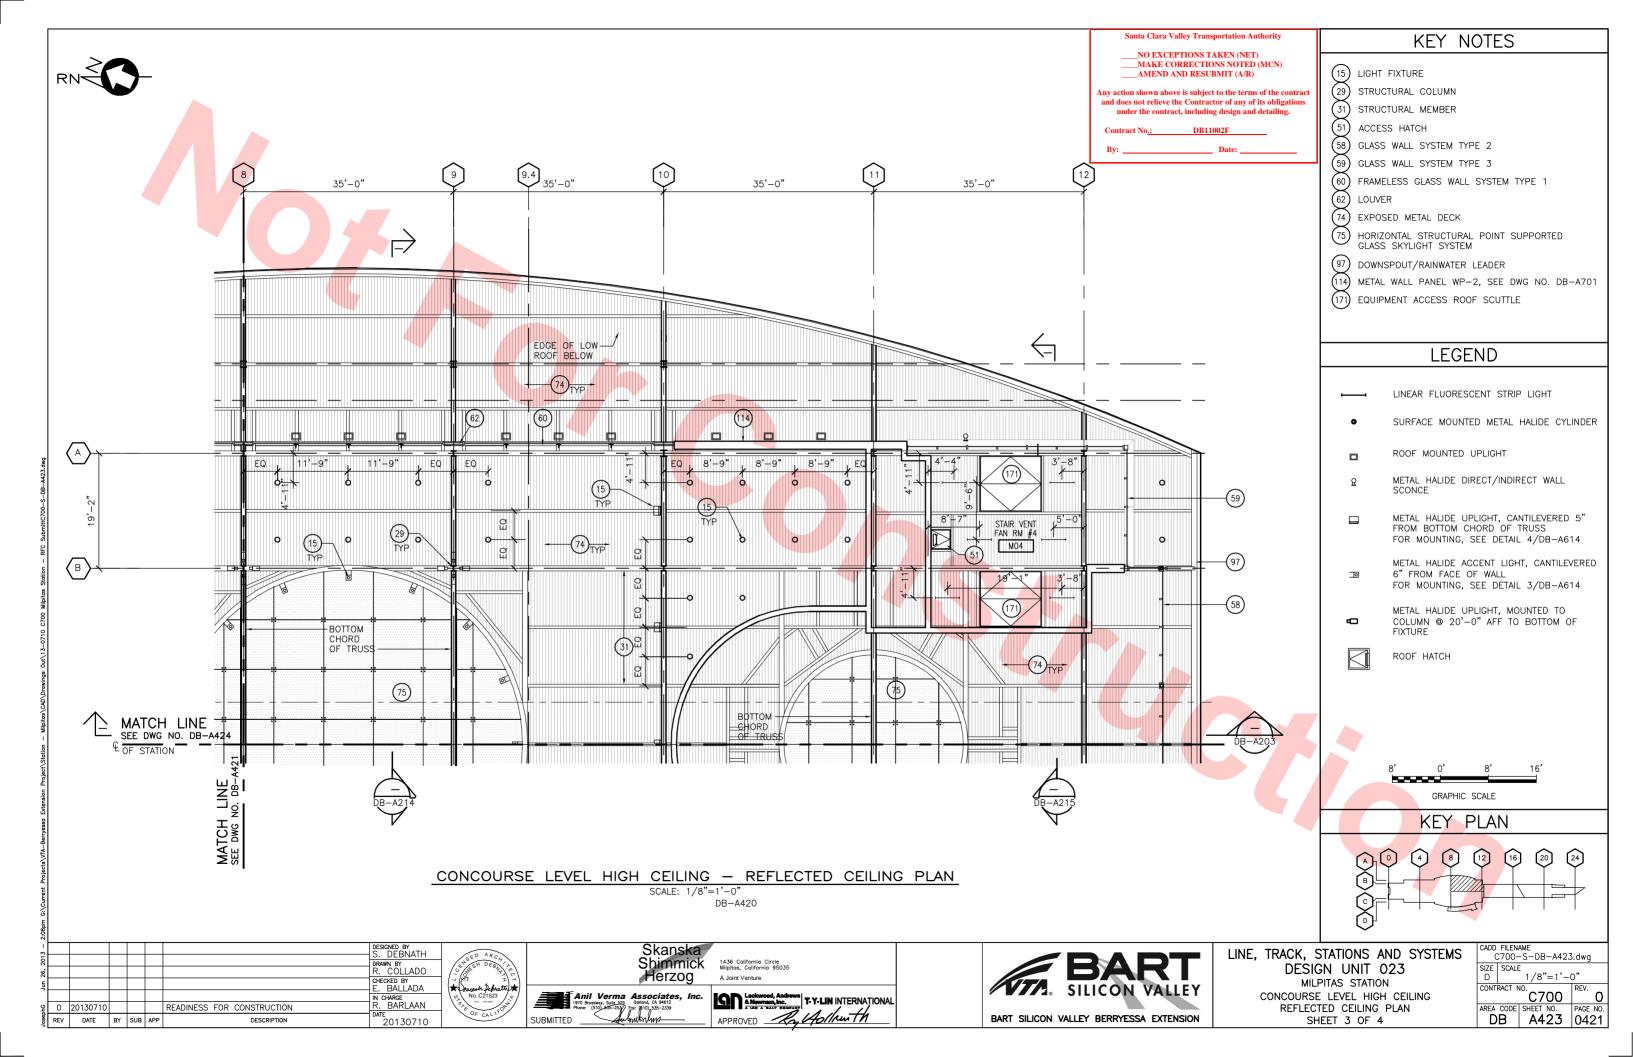



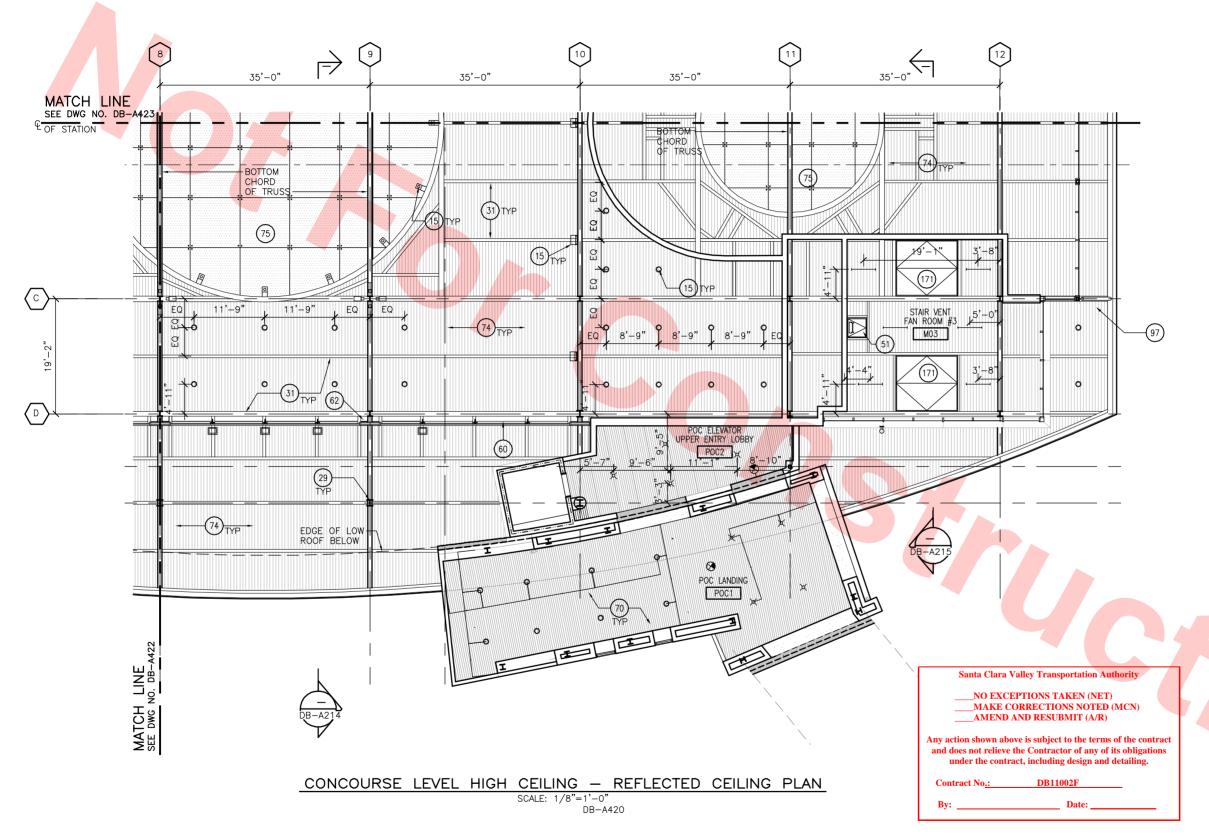

KEY NOTES


- (15) LIGHT FIXTURE
- (29) STRUCTURAL COLUMN
- (31) STRUCTURAL MEMBER
- (51) ACCESS HATCH (60) FRAMELESS GLASS WALL SYSTEM TYPE 1
- (62) LOUVER
- 70) CEILING TYPE 1 SUSPENDED LINEAR METAL PANEL
- (74) EXPOSED METAL DECK
- 75 HORIZONTAL STRUCTURAL POINT SUPPORTED GLASS SKYLIGHT SYSTEM
- 97) DOWNSPOUT/RAINWATER LEADER
- (114) METAL WALL PANEL WP-2, SEE DWG NO. DB-A701
- (171) EQUIPMENT ACCESS ROOF SCUTTLE

LEGEND

- LINEAR FLUORESCENT STRIP LIGHT
- RECESSED METAL HALIDE
- SURFACE MOUNTED METAL HALIDE CYLINDER
- ROOF MOUNTED UPLIGHT TYPE M12
- METAL HALIDE DIRECT/INDIRECT WALL Ω SCONCE
 - METAL HALIDE UPLIGHT, CANTILEVERED 5" FROM BOTTOM CHORD OF TRUSS FOR MOUNTING, SEE DETAIL 4/DB-A614
- METAL HALIDE ACCENT LIGHT, CANTILEVERED 6" FROM FACE OF WALL FOR MOUNTING, SEE DETAIL 3/DB-A614
- METAL HALIDE UPLIGHT, MOUNTED TO COLUMN @ 20'-0" AFF TO BOTTOM OF **FIXTURE**
- Ю EXIT LIGHT
 - ROOF HATCH


GRAPHIC SCALE

KEY PLAN

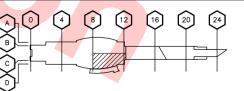

DESIGNED BY S. DEBNATH RAWN BY CHECKED BY E. BALLADA CHARGE BARLAAN 0 20130710 READINESS FOR CONSTRUCTION
REV DATE BY SUB APP DESCRIPTION 20130710



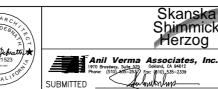






LINE, TRACK, STATIONS AND SYSTEMS DESIGN UNIT 023 MILPITAS STATION CONCOURSE LEVEL HIGH CEILING

REFLECTED CEILING PLAN


SHEET 4 OF 4

CADD FILENAME C700-S-DB-A424.dwg SIZE SCALE D 1/8"=1'-0" CONTRACT NO.
C700

AREA CODE SHEET NO. DB A424 0422

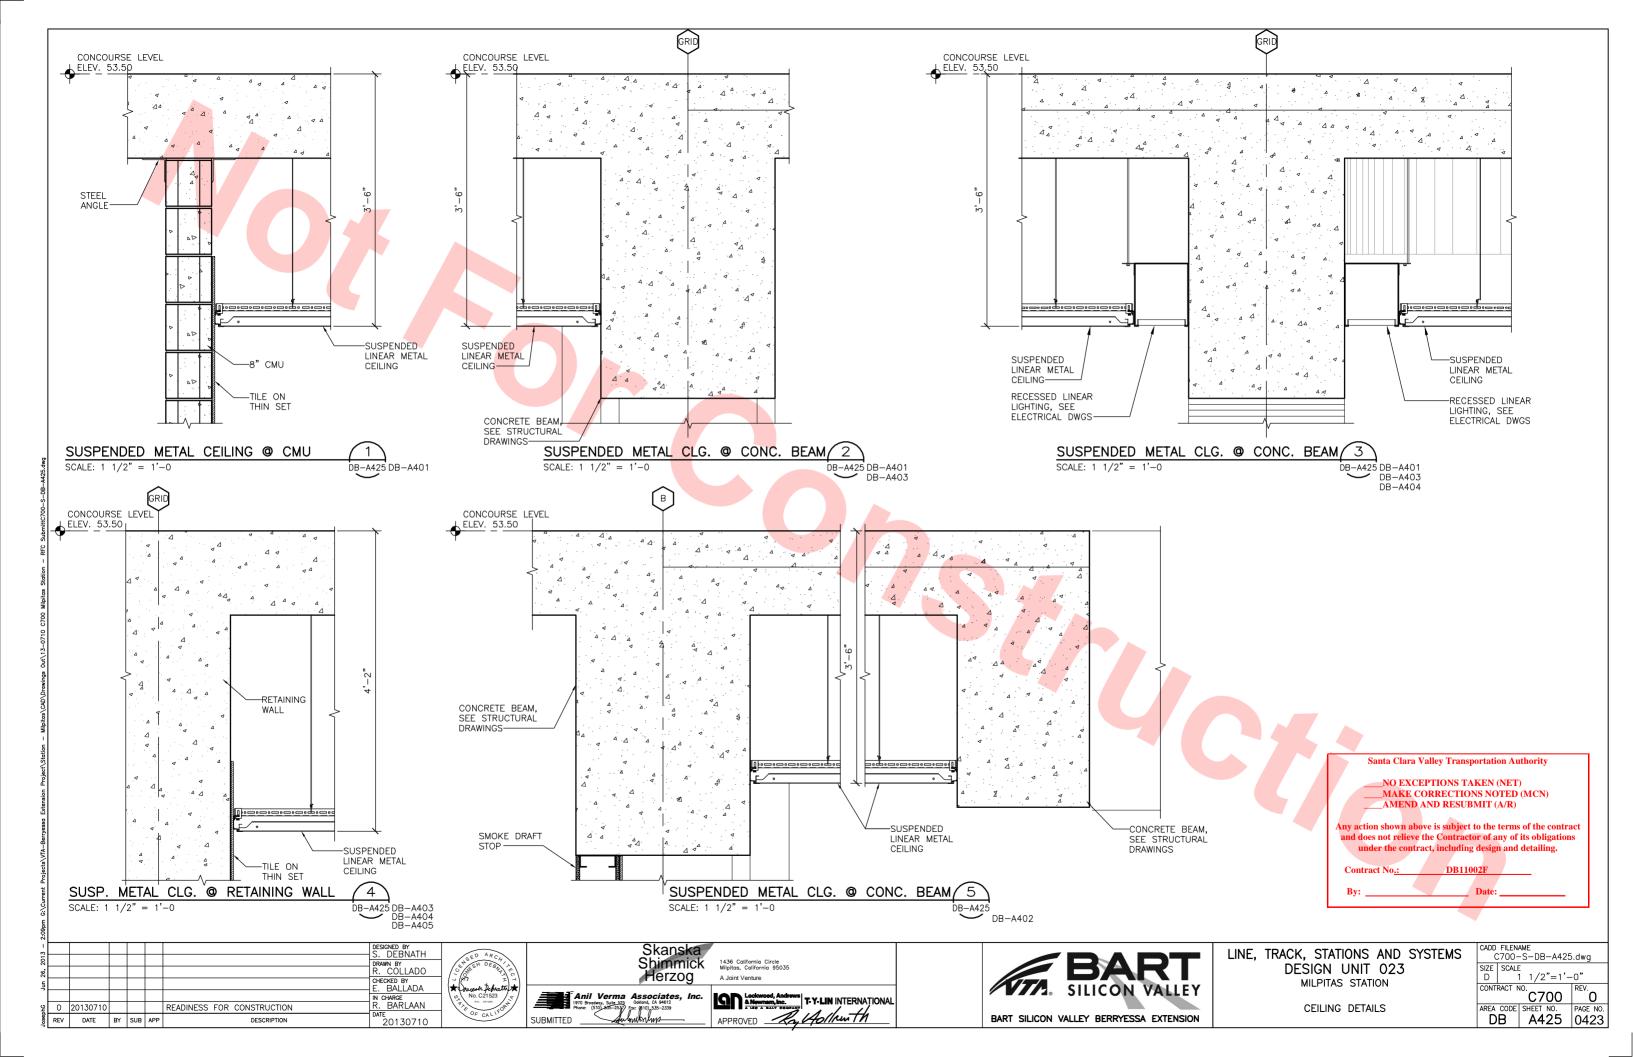



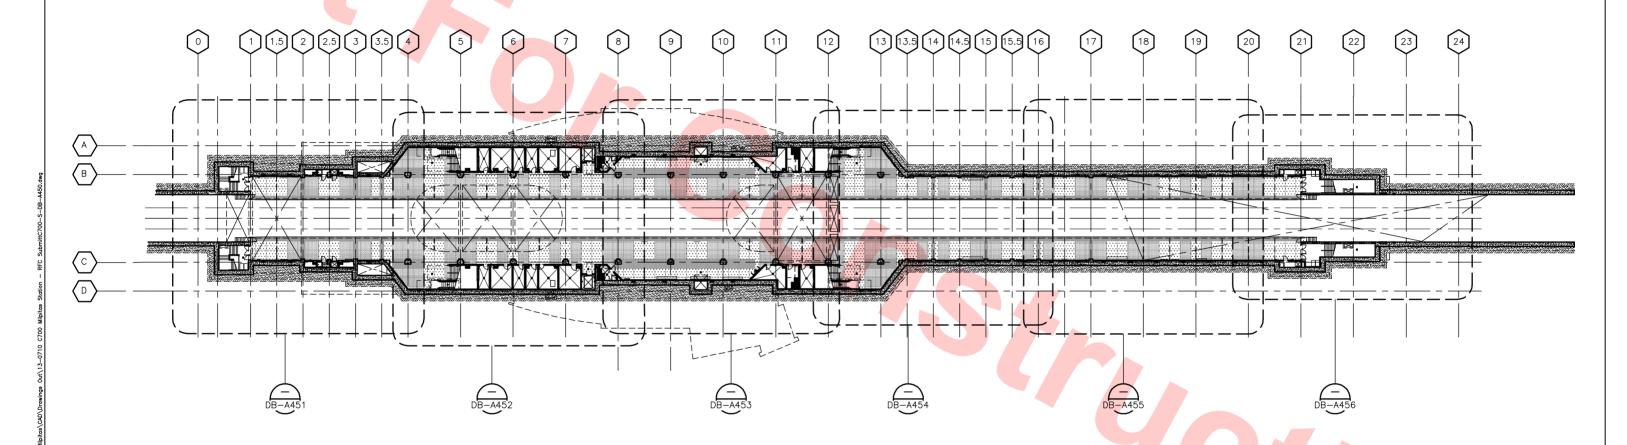

KEY FLOOR PATTERN PLAN — PLATFORM LEVEL SCALE: 1/32"=1'-0"

Santa Clara Valley Transportation Authority

___NO EXCEPTIONS TAKEN (NET)


MAKE CORRECTIONS NOTED (MCN)

AMEND AND RESUBMIT (A/R)

Any action shown above is subject to the terms of the contract and does not relieve the Contractor of any of its obligations under the contract, including design and detailing.

Contract No.: DB110

By: _____

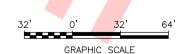

l							
						DESIGNED BY S. DEBNATH	4 T
						DRAWN BY	\neg
						R. COLLADO	
			igsquare			CHECKED BY E. BALLADA	
						IN CHARGE	\neg
0	20130710				READINESS FOR CONSTRUCTION	R. BARLAAN	1
REV	DATE	BY	SUB	APP	DESCRIPTION	DATE 201.30710	n l



Skanska	
Shimmick	1436 California Circle Milpitas, California 95035
Herzog	A Joint Venture
rma Associates, Inc. ile 525 Ookland, CA 946122537 Fax: (\$10),535-2339	Lockwood, Andrews & Newman, Inc. T-Y-LIN INTERNATIONAL AND SOMEWARD TO THE PROPERTY OF THE PR
Augustrum.	APPROVED Ro. Hollrenth



LINE, TRACK, STATIONS AND SYSTEMS

DESIGN UNIT 023


MILPITAS STATION


KEY PLAN


PLATFORM LEVEL


FLOOR PATTERN PLAN


//S	CADD (D.dwg		
	SIZE D	SCALE	1/32"=1'-	-0"
		RACT N	C700	REV.
	AREA	CODE	SHEET NO.	PAGE N
	D	В	A450	0424

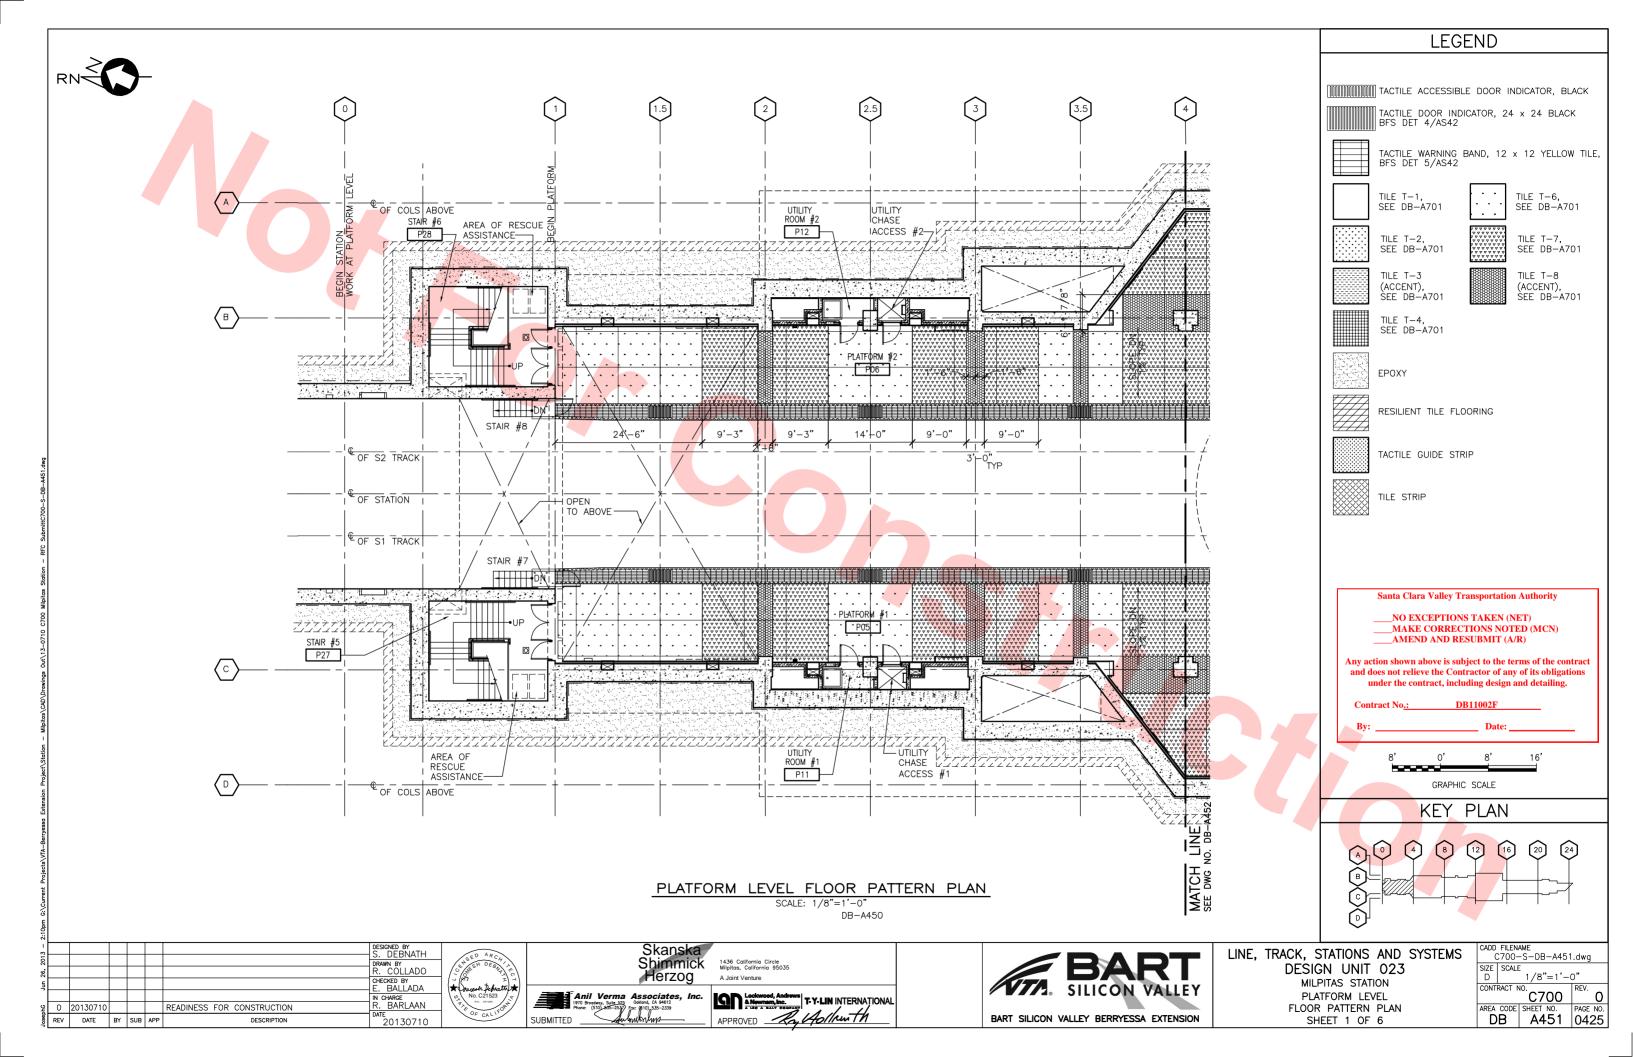


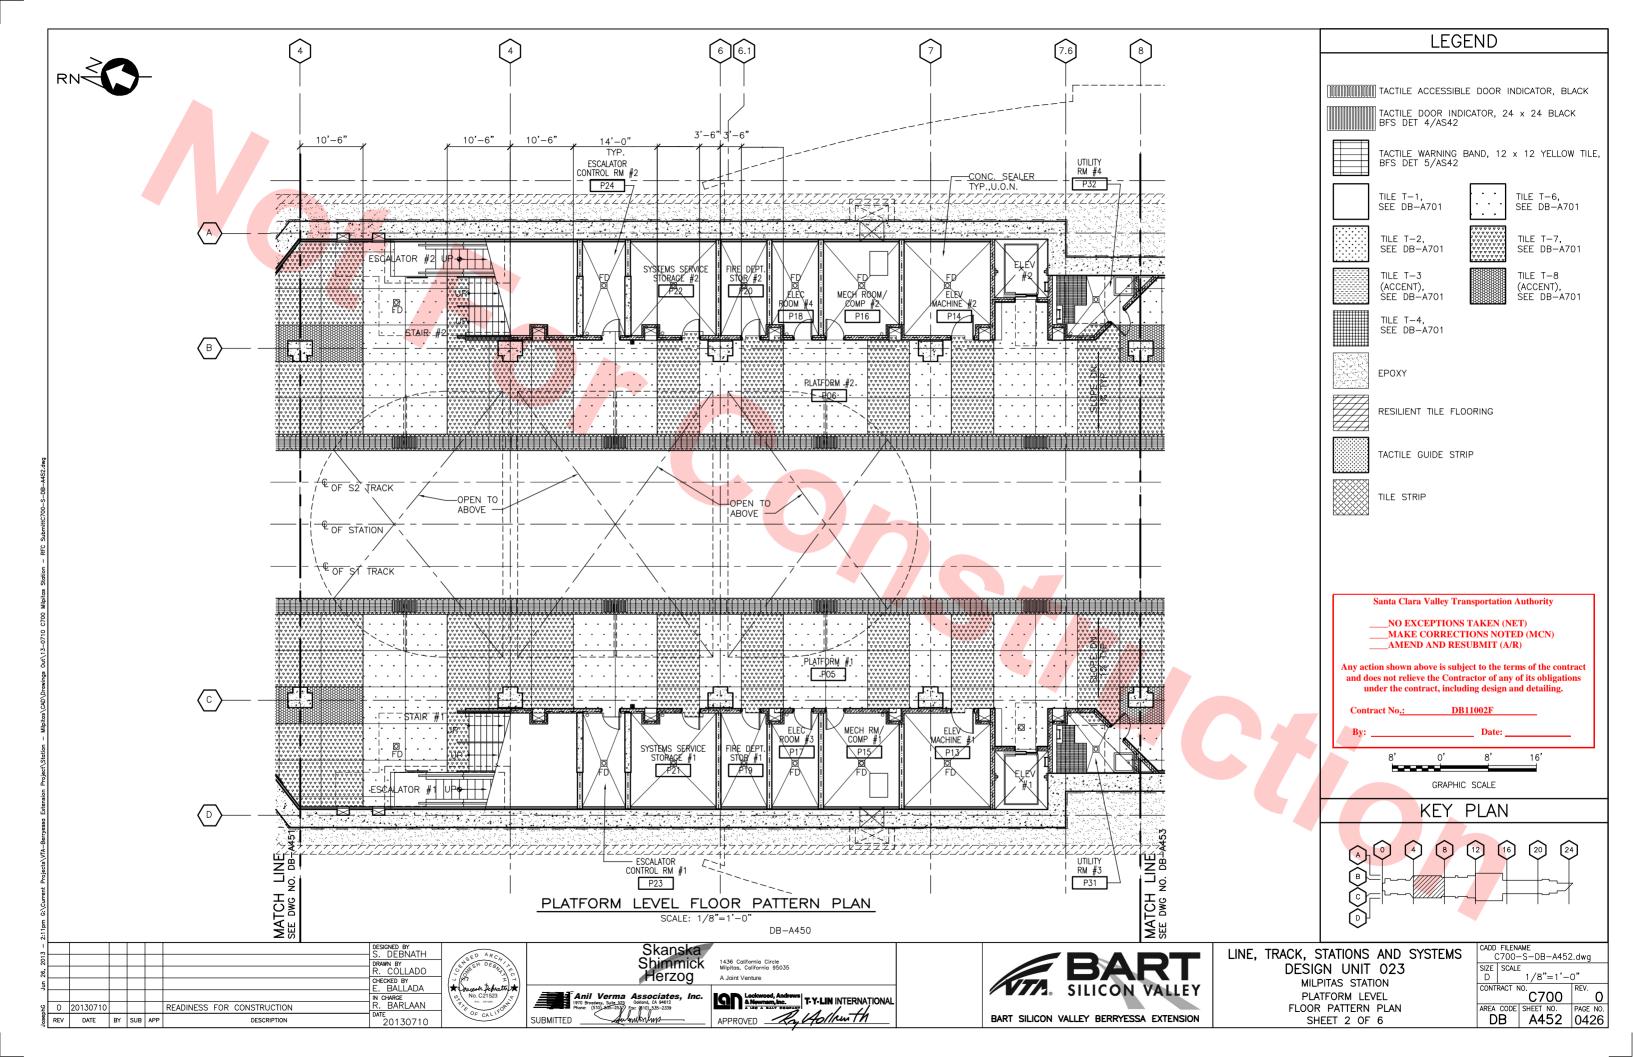

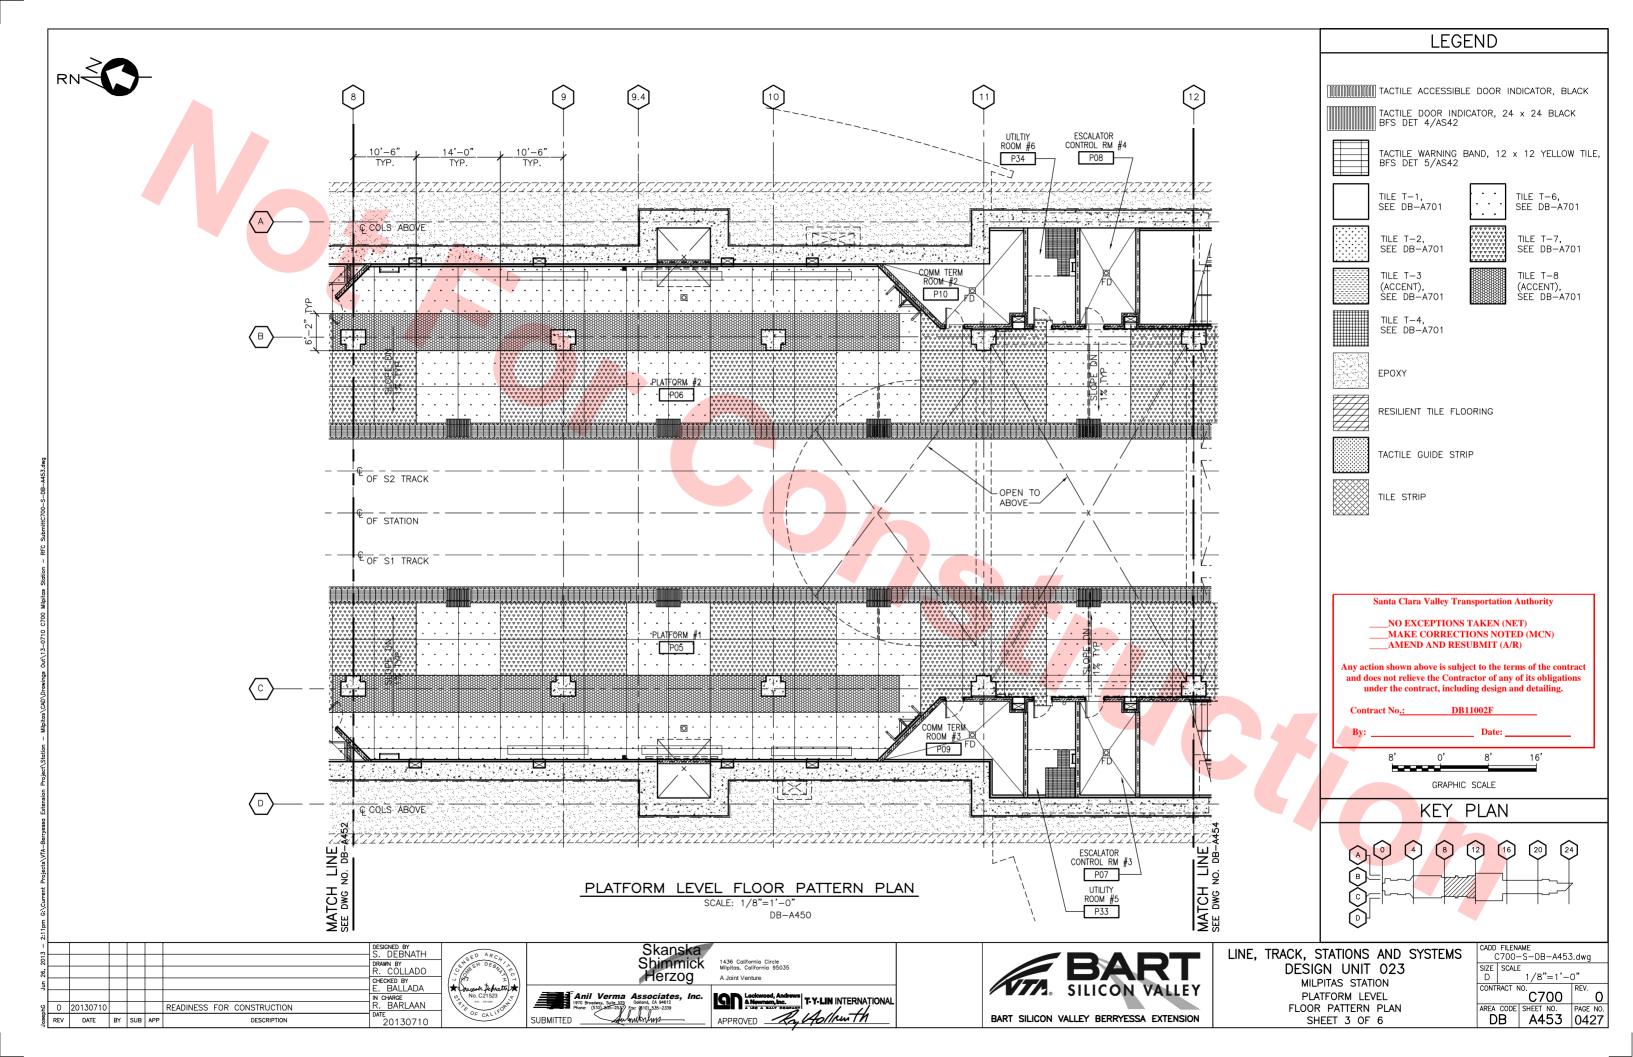


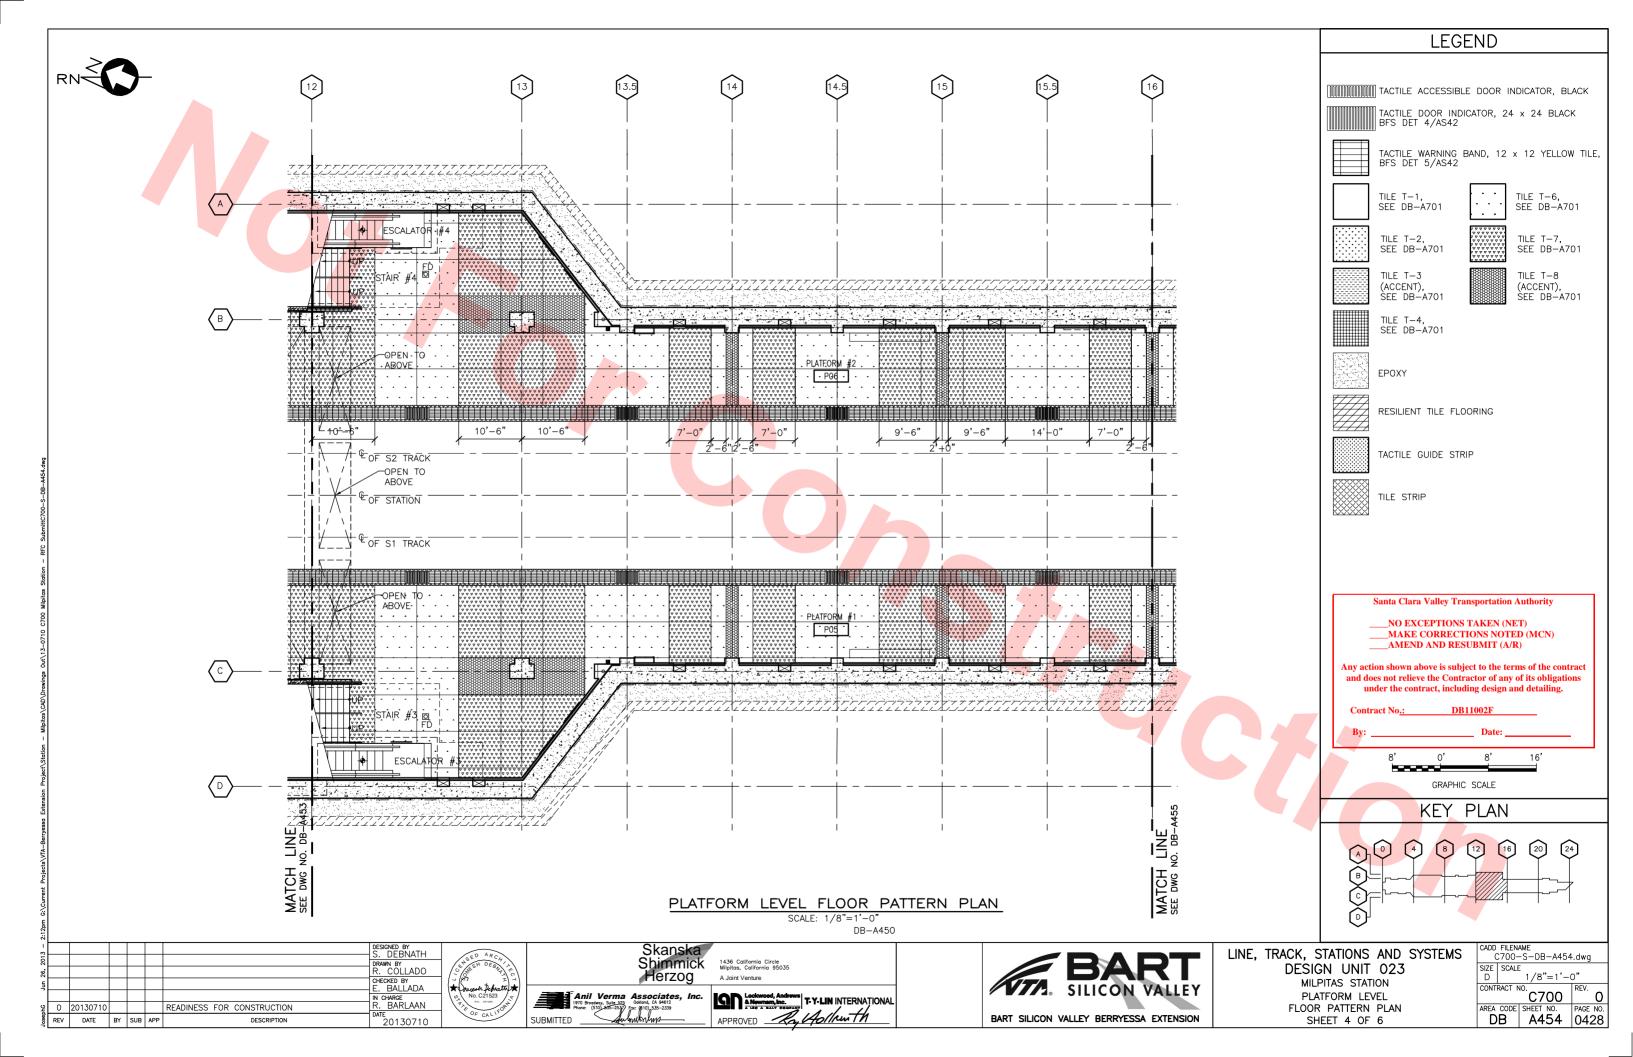

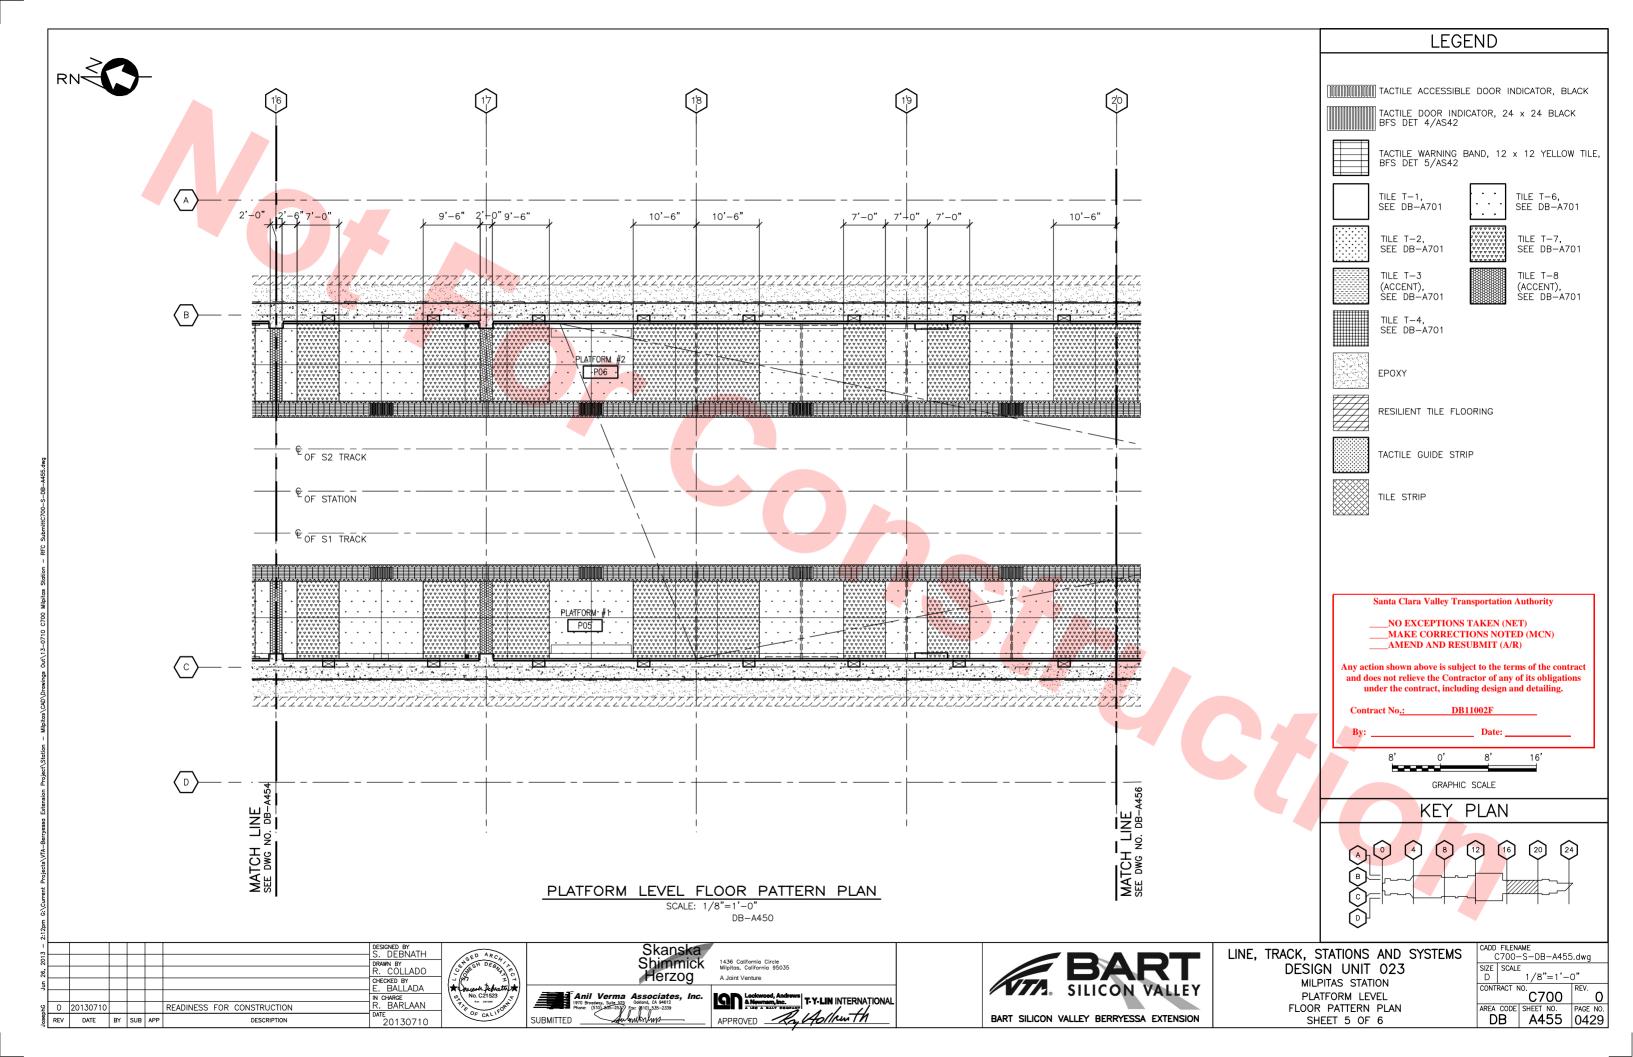

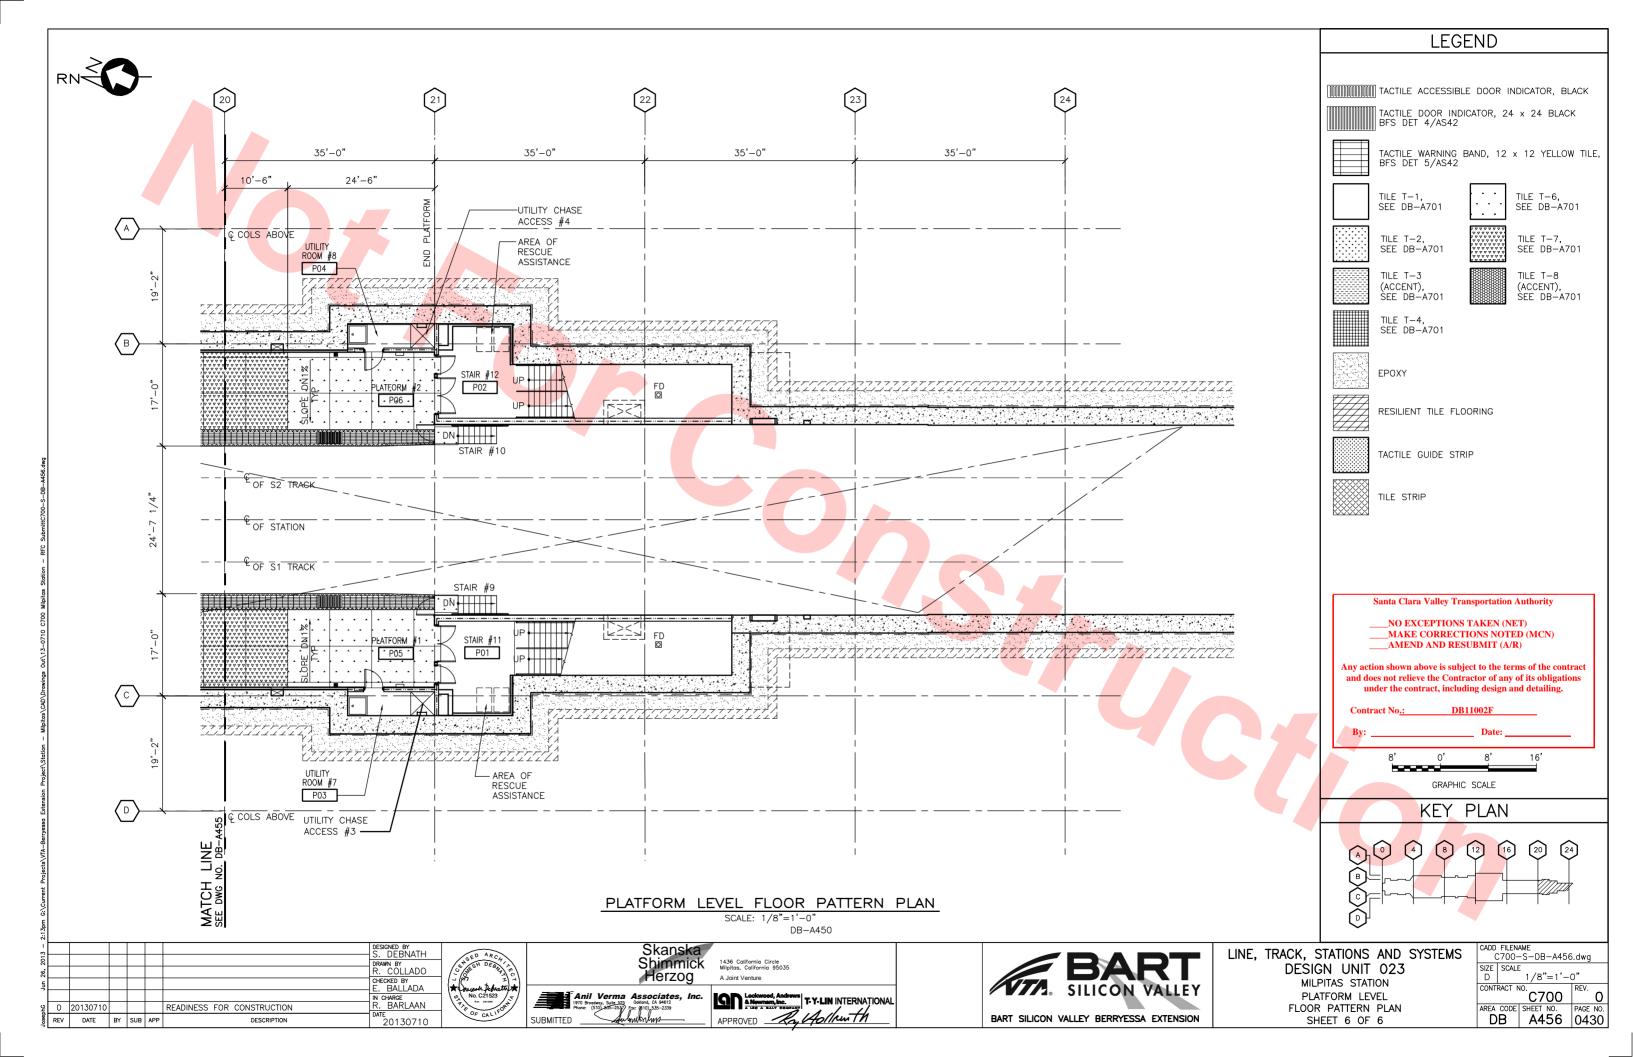



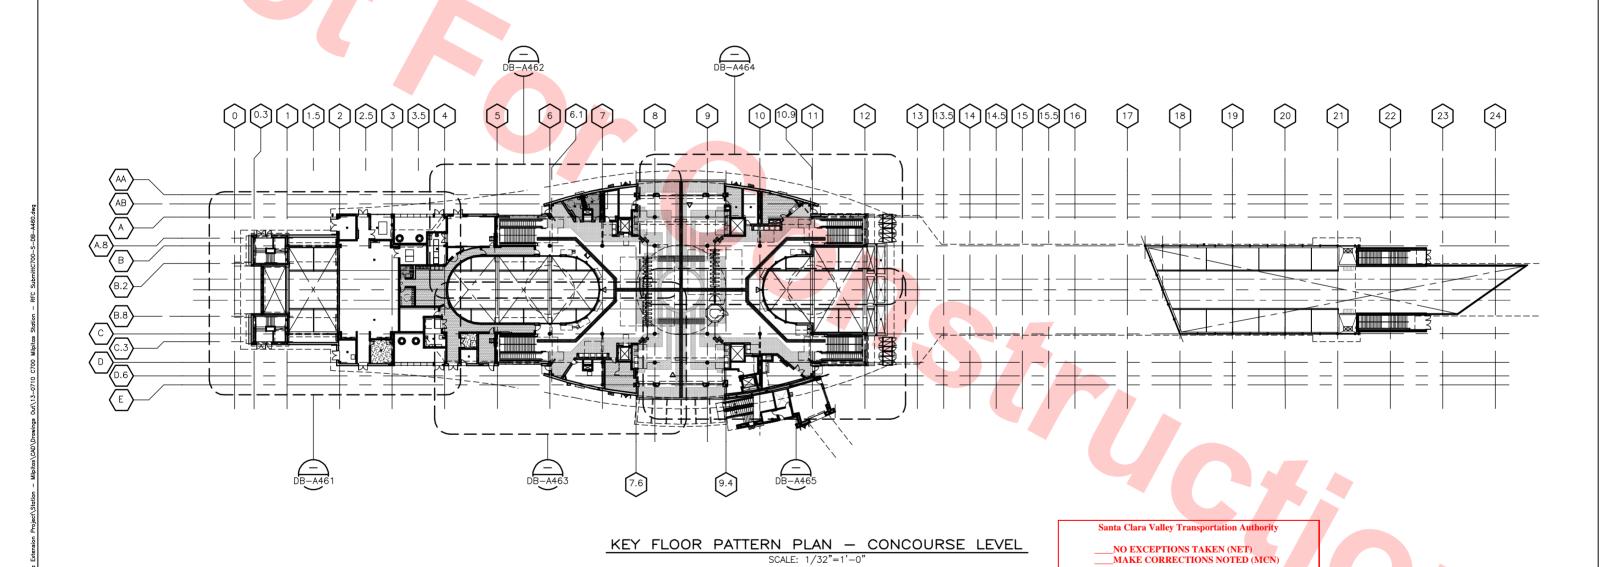

DESIGNED BY S. DEBNATH DRAWN BY R. COLLADO CHECKED BY E. BALLADA I CHARGE R. BARLAAN 20130710









___NO EXCEPTIONS TAKEN (NET)
___MAKE CORRECTIONS NOTED (MCN) AMEND AND RESUBMIT (A/R)

Any action shown above is subject to the terms of the contract and does not relieve the Contractor of any of its obligations under the contract, including design and detailing.


LINE, TRACK, STATIONS AND SYSTEM DESIGN UNIT 023 MILPITAS STATION

KEY PLAN CONCOURSE LEVEL FLOOR PATTERN PLAN

MS		FILEN		-A460	dwa
	SIZE	SCALE		71100	.u . g
	D	SCALE		"=1'-	0"
	CONT	RACT N	^{10.} \sim 7	00	REV.
					U
	AREA	CODE	SHEET		PAGE NO.
	D	В	A4	60	0431

GRAPHIC SCALE



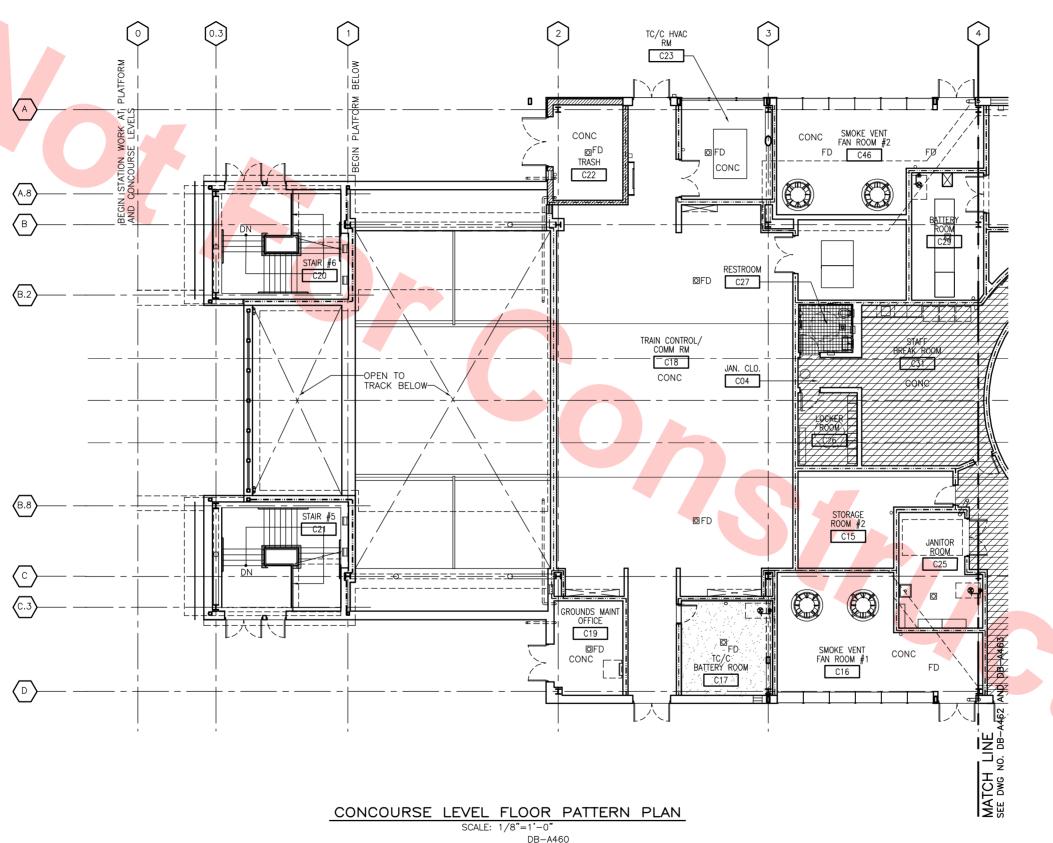

LEGEND TACTILE ACCESSIBLE DOOR INDICATOR, BLACK TACTILE DOOR INDICATOR, 24 x 24 BLACK BFS DET 4/AS42 TACTILE WARNING BAND, 12 x 12 YELLOW TILE, BFS DET 5/AS42 TILE T-6, SEE DB-A701 TILE T-1, SEE DB-A701 TILE T-7, SEE DB-A701 TILE T-2, SEE DB-A701 TILE T-3 TILE T-8 (ACCENT), (ACCENT), SEE DB-A701 SEE DB-A701 TILE T-4, SEE DB-A701 **EPOXY** RESILIENT TILE FLOORING TACTILE GUIDE STRIP TILE STRIP Santa Clara Valley Transportation Authority ___NO EXCEPTIONS TAKEN (NET) ___MAKE CORRECTIONS NOTED (MCN) AMEND AND RESUBMIT (A/R) Any action shown above is subject to the terms of the contract and does not relieve the Contractor of any of its obligations under the contract, including design and detailing. DB11002F GRAPHIC SCALE KEY PLAN (12)

DESIGNED BY S. DEBNATH RAWN BY R. COLLADO CHECKED BY E. BALLADA CHARGE . BARLAAN 0 20130710 READINESS FOR CONSTRUCTION
REV DATE BY SUB APP DESCRIPTION 20130710









LINE, TRACK, STATIONS AND SYSTEMS DESIGN MILPITAS CONCOUR


FLOOR PA


SHEET

ŀ
ŀ
l

CADD FILENAME								
(C700-S-DB-A461.dwg							
SIZE	SCALE							
D	1/8"=1'-0"							
CONT	REV.							
		C700	0					
AREA	CODE	SHEET NO.	PAGE NO.					
D	В	A461	0432					



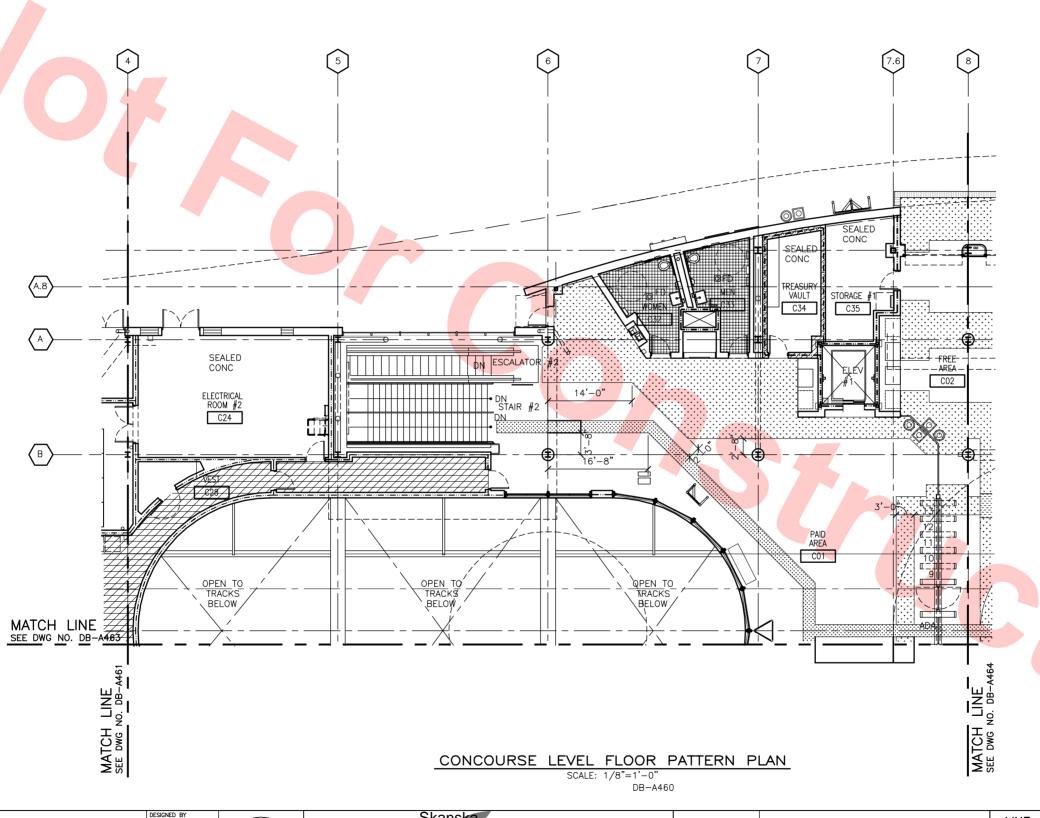

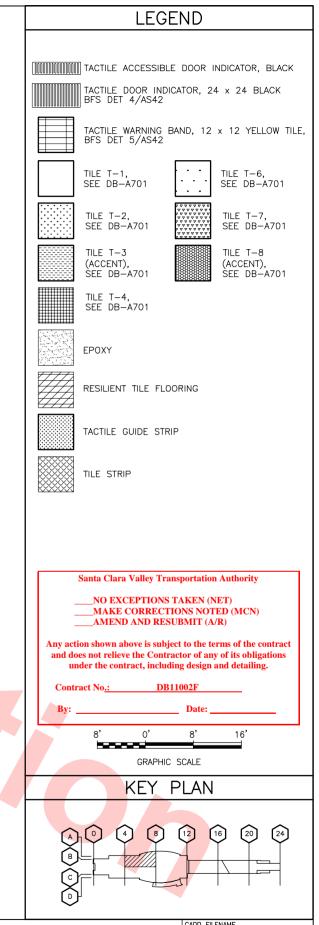

| DESIGNED BY | S. DEBNATH | DESIGNED BY | S. DEBNATH | DEAMN BY | R. COLLADO | CHECKED BY | E. BALLADA | IN CHARGE | R. BARLAAN | DATE | BY | SUB | APP | DESCRIPTION | DATE | 20130710 | CHECKED BY | C. BARLAAN | DATE | COLLADO | CHECKED BY | C. BARLAAN | DATE | COLLADO | CHECKED BY | C. BARLAAN | C. BARLAAN | DATE | COLLADO | CHECKED BY | C. BARLAAN | C



Skans
Shimm
Herzo

Anii Verma Associates,
Outerd, Ox 44112

SUBMITTED

SUBMITTED





LINE, TRACK, STATIONS AND SYSTEMS

DESIGN UNIT 023


MILPITAS STATION


CONCOURSE LEVEL
FLOOR PATTERN PLAN

SHEET 2 OF 5

3	C700-S-DB-A462.dwg						
	SIZE D	SCALE	1/8	"=1'-	ס"		
	CONT	RACT N	^{10.} C7	'00	REV.	0	
	_	CODE	SHEET	NO. -62	PAGE		
	U	D	A4	.02	043	3 3	



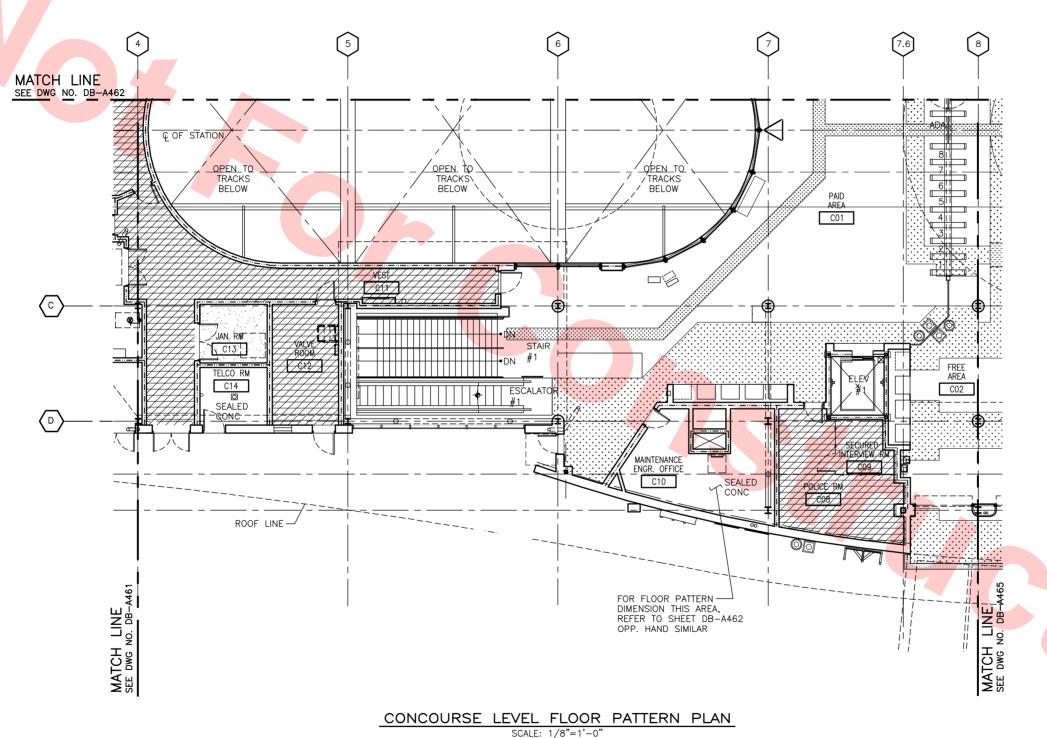


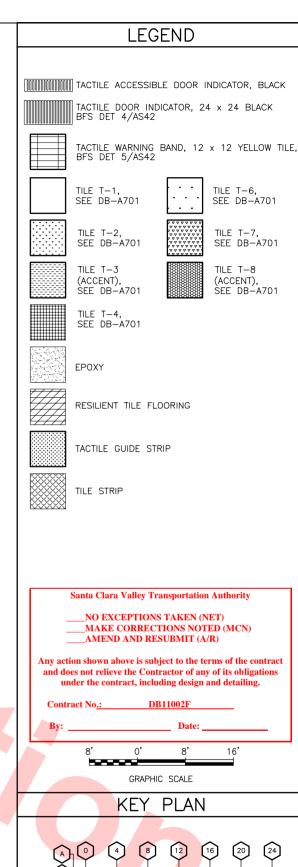

DB-A460

DESIGNED BY S. DEBNATH RAWN BY R. COLLADO . BALLADA 0 20130710 READINESS FOR CONSTRUCTION
REV DATE BY SUB APP DESCRIPTION CHARGE . BARLAAN 20130710



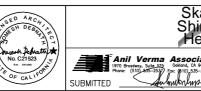





LINE, TRACK, STATIONS AND SYSTEMS C700-S-DESIGN UNIT 023 MILPITAS STATION CONCOURSE LEVEL


FLOOR PATTERN PLAN

SHEET 3 OF 5

C700-S-DB-A463.dwg				
D 1/8"=1'-0			o"	
C700			REV. O	
				PAGE NO. 0434
	SIZE D CONT	SIZE SCALE D CONTRACT N	SIZE SCALE D 1/8": CONTRACT NO. C70 AREA CODE SHEET I	SIZE D 1/8"=1'-(CONTRACT NO. C700 AREA CODE SHEET NO.

SIZE D	SC
CONT	RAC
AREA D	B



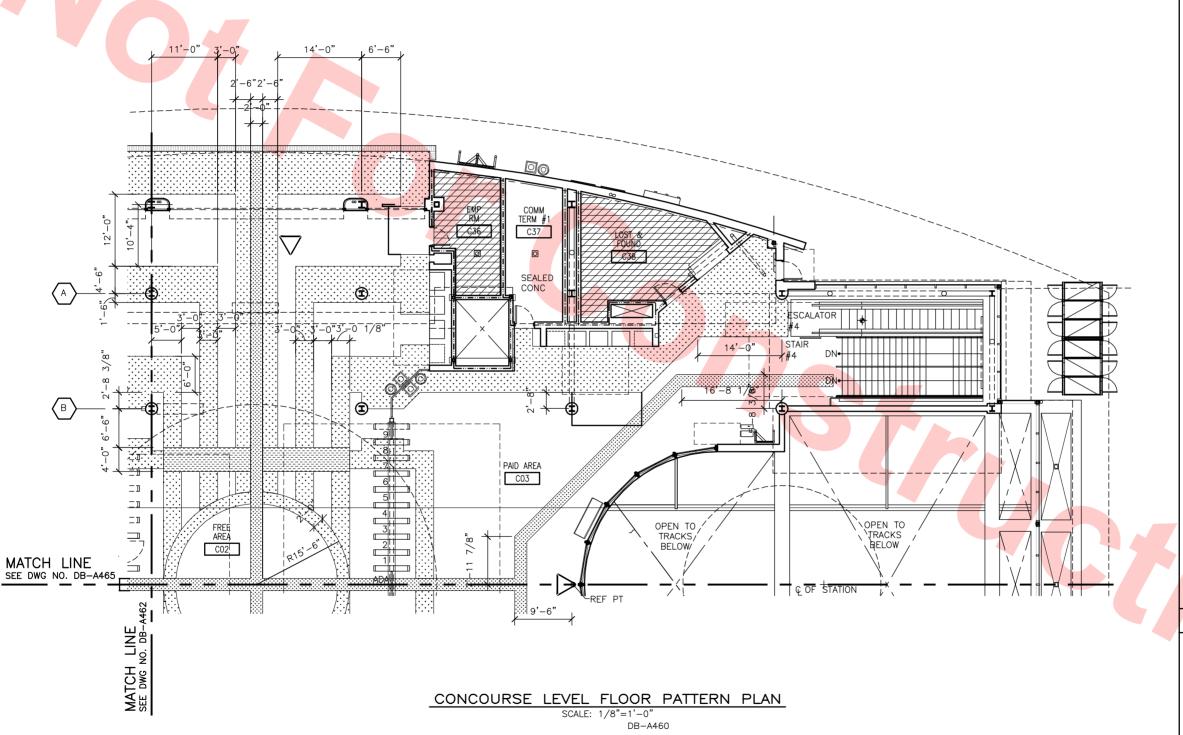


LEGEND TACTILE ACCESSIBLE DOOR INDICATOR, BLACK TACTILE DOOR INDICATOR, 24 x 24 BLACK BFS DET 4/AS42 TACTILE WARNING BAND, 12 x 12 YELLOW TILE, BFS DET 5/AS42 TILE T-1, SEE DB-A701 TILE T-6, SEE DB-A701 TILE T-7, SEE DB-A701 TILE T-2, SEE DB-A701 TILE T-3 TILE T-8 (ACCENT), SEE DB-A701 (ACCENT), SEE DB-A701 TILE T-4, SEE DB-A701 **EPOXY** RESILIENT TILE FLOORING TACTILE GUIDE STRIP TILE STRIP Santa Clara Valley Transportation Authority ___NO EXCEPTIONS TAKEN (NET) ___MAKE CORRECTIONS NOTED (MCN) AMEND AND RESUBMIT (A/R) Any action shown above is subject to the terms of the contract and does not relieve the Contractor of any of its obligations under the contract, including design and detailing.

DB11002F

GRAPHIC SCALE


KEY PLAN

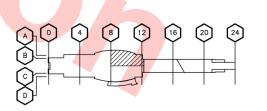

Ä۱							
ᄀ[DESIGNED BY
끄							S. DEBNATH
							DRAWN BY
ĸا							R. COLLADO
							CHECKED BY
틧							E. BALLADA
ı							IN CHARGE
일	0	20130710				READINESS FOR CONSTRUCTION	R. BARLAAN
SephG	REV	DATE	BY	SUB	400	DESCRIPTION	DATE
							20130710



SED ARCHY AMES TO SEE SHOOL SEE SHOO	Skanska Shirnmick Herzog	14 Mi
'」. 되기	ricizog	Α.
No. C21523 OF CALLED	Anil Verma Associates, Inc. 1970 Broodwy, Suite 525 Ookland, CA 94612 Phone: (510)-455-239) Fax: (\$10),335-2339	Ľ
OF CALL	SUBMITTED	AF

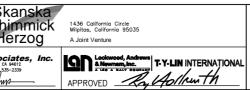




LINE, TRACK, STATIONS AND SYSTEM DESIGN UNIT 023 MILPITAS STATION CONCOURSE LEVEL FLOOR PATTERN PLAN

SHEET 4 OF 5

//S	CADD FILENAME C700-S-DB-A464.dwg					
	SIZE D	SCALE	1/8'	"=1'-	o"	
	CONT	RACT N		00	REV.	C
	AREA	CODE	SHEET A4	NO. -64	PAGE 043	NO 3.5



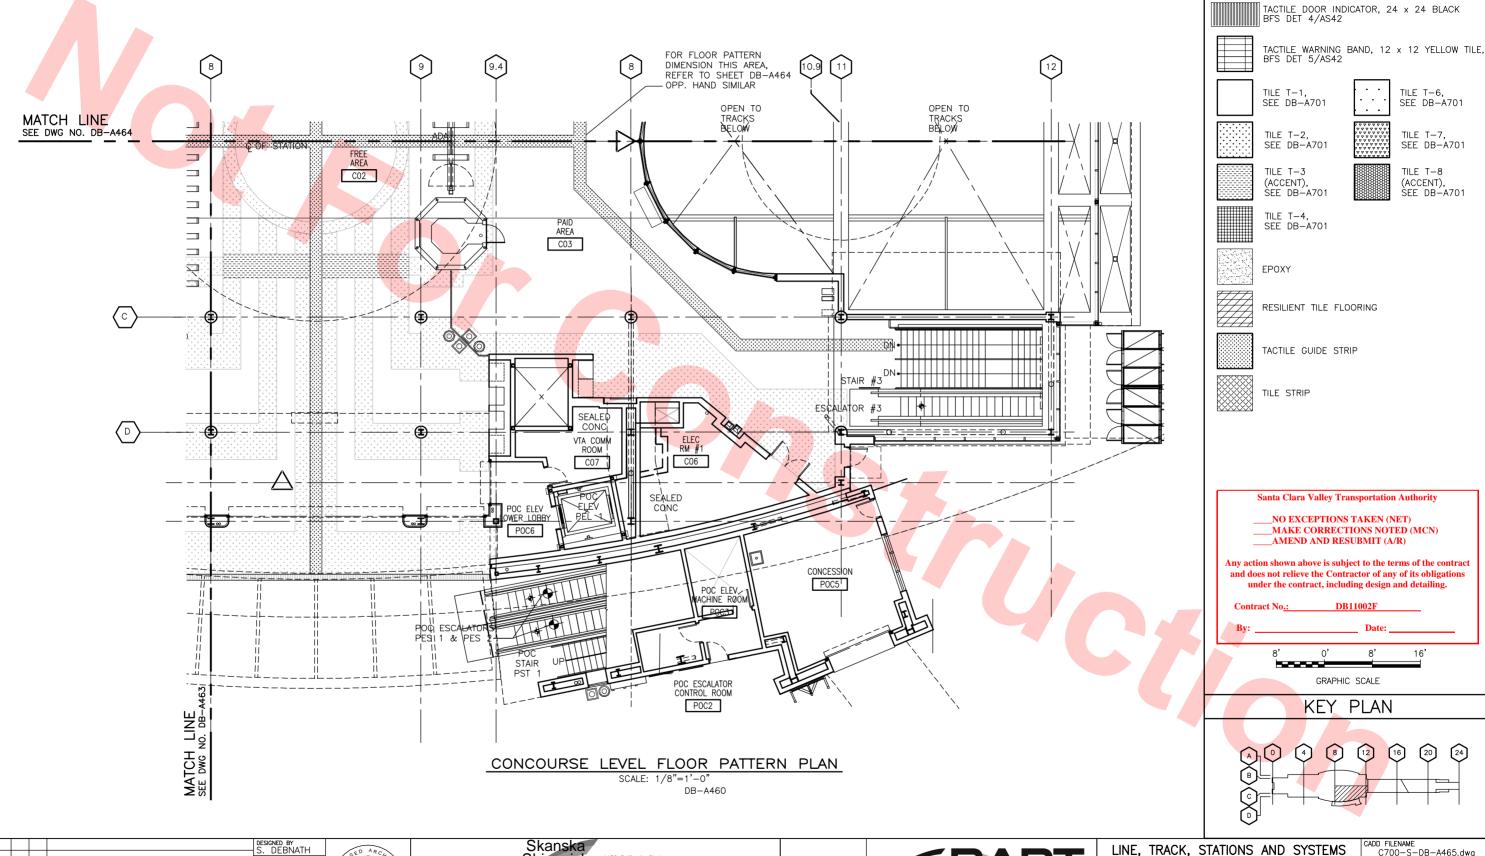

Shimmick

Herzog

Anil Verma Associates, Inc.
1970 Brookey, Suite, 525 Cooland, CA 94612
Phone: (\$10).635-2339 Fax: (\$10).535-2339

RAWN BY R. COLLADO

CHECKED BY E. BALLADA

0 20130710 READINESS FOR CONSTRUCTION
REV DATE BY SUB APP DESCRIPTION

CHARGE . BARLAAN

20130710

* Sween Jehrati *

SUBMITTED

1436 California Circle Milpitas, California 95035

Lockwood, Andrews & Newman, Inc.

A Newman, Inc.

A No. A D. COMPANY

T-Y-LIN INTERNATIONAL

APPROVED Ry Hollren th

A Joint Venture

BART SILICON VALLEY BERRYESSA EXTENSION

LINE, TRACK, STATIONS AND SYSTEMS DESIGN UNIT 023 MILPITAS STATION CONCOURSE LEVEL

FLOOR PATTERN PLAN

SHEET 5 OF 5

GRAPHIC SCALE

KEY PLAN

LEGEND

TACTILE ACCESSIBLE DOOR INDICATOR, BLACK

TILE T-6, SEE DB-A701


TILE T-7, SEE DB-A701


SEE DB-A701


TILE T-8


(ACCENT),


_						
ZΕ	SCALE					
)		1/8"=1'-	0″			
NTI	RACT N		REV.			
	C700 0					
EΑ	CODE	SHEET NO.	PAGE NO.			
D	В	A465	0436			

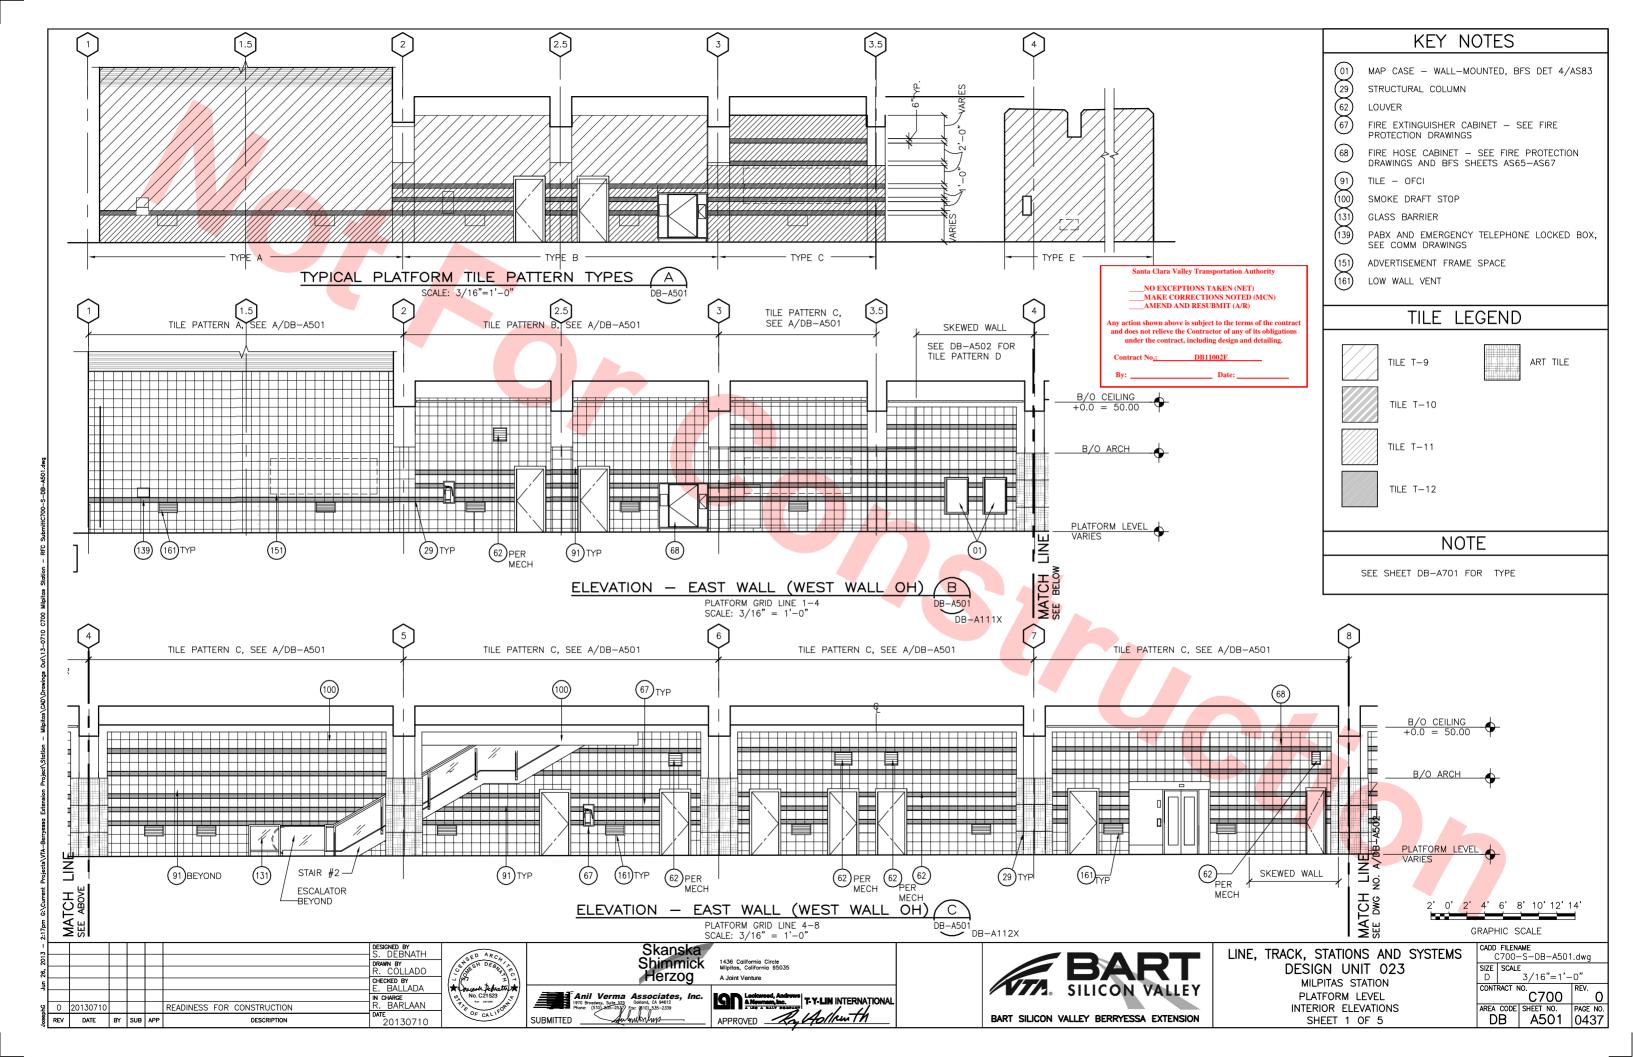


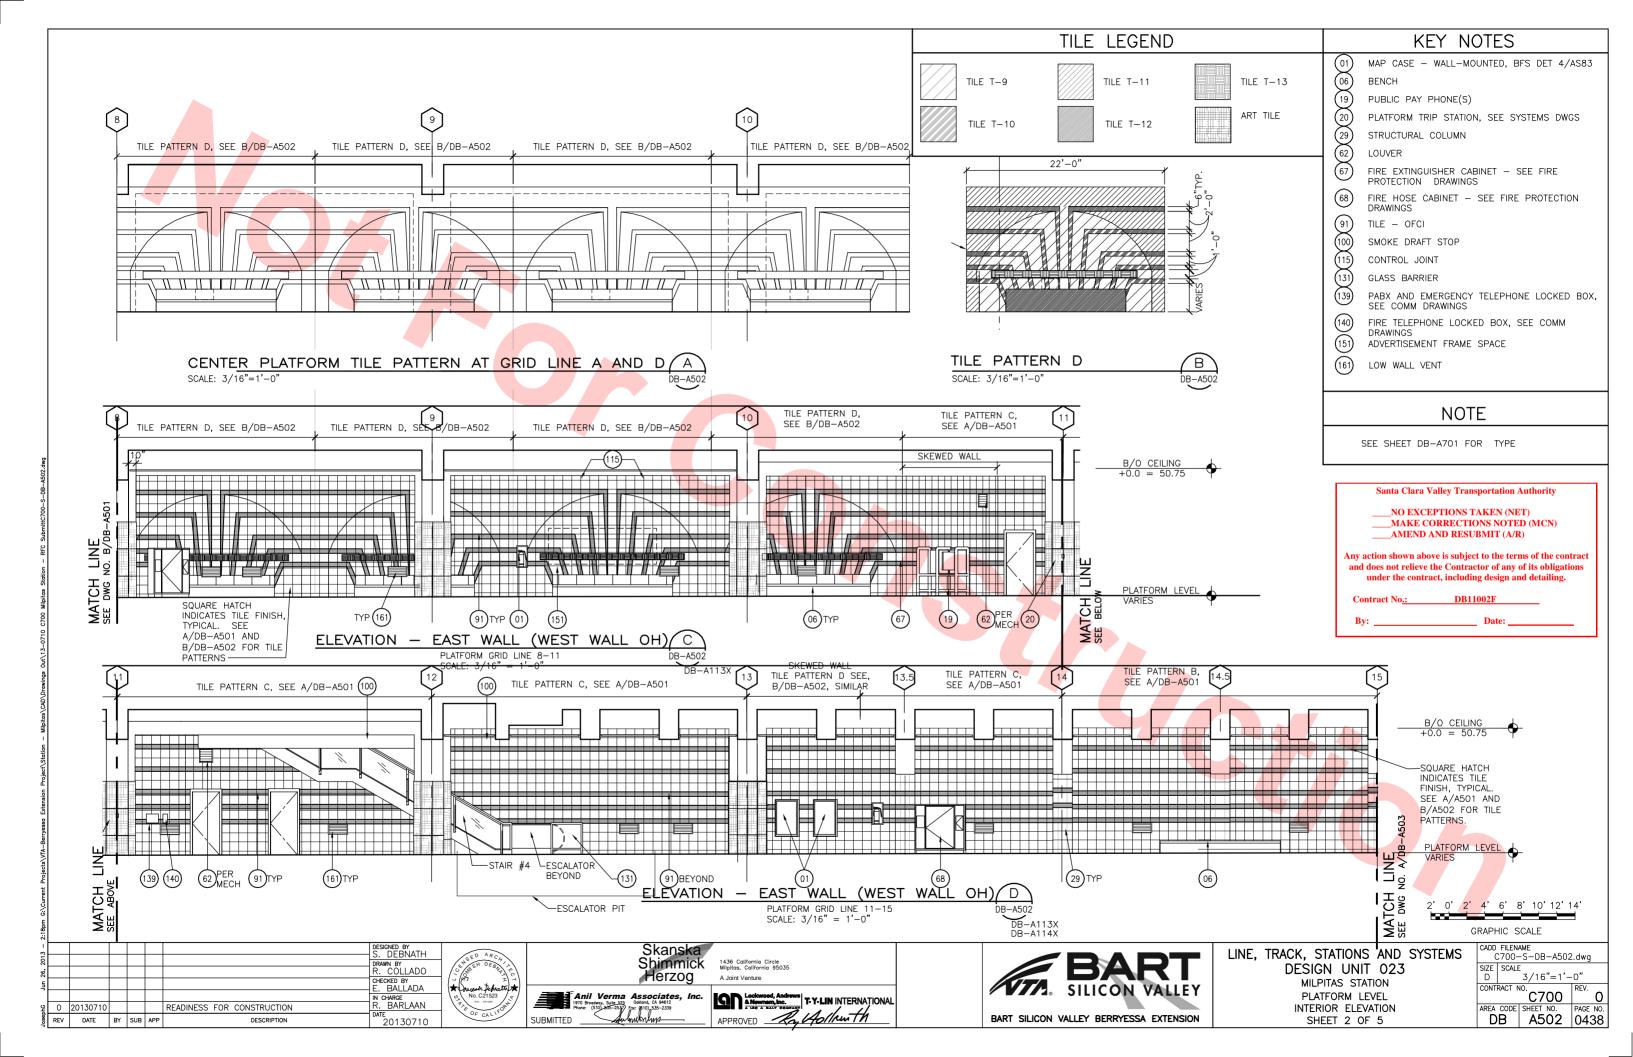


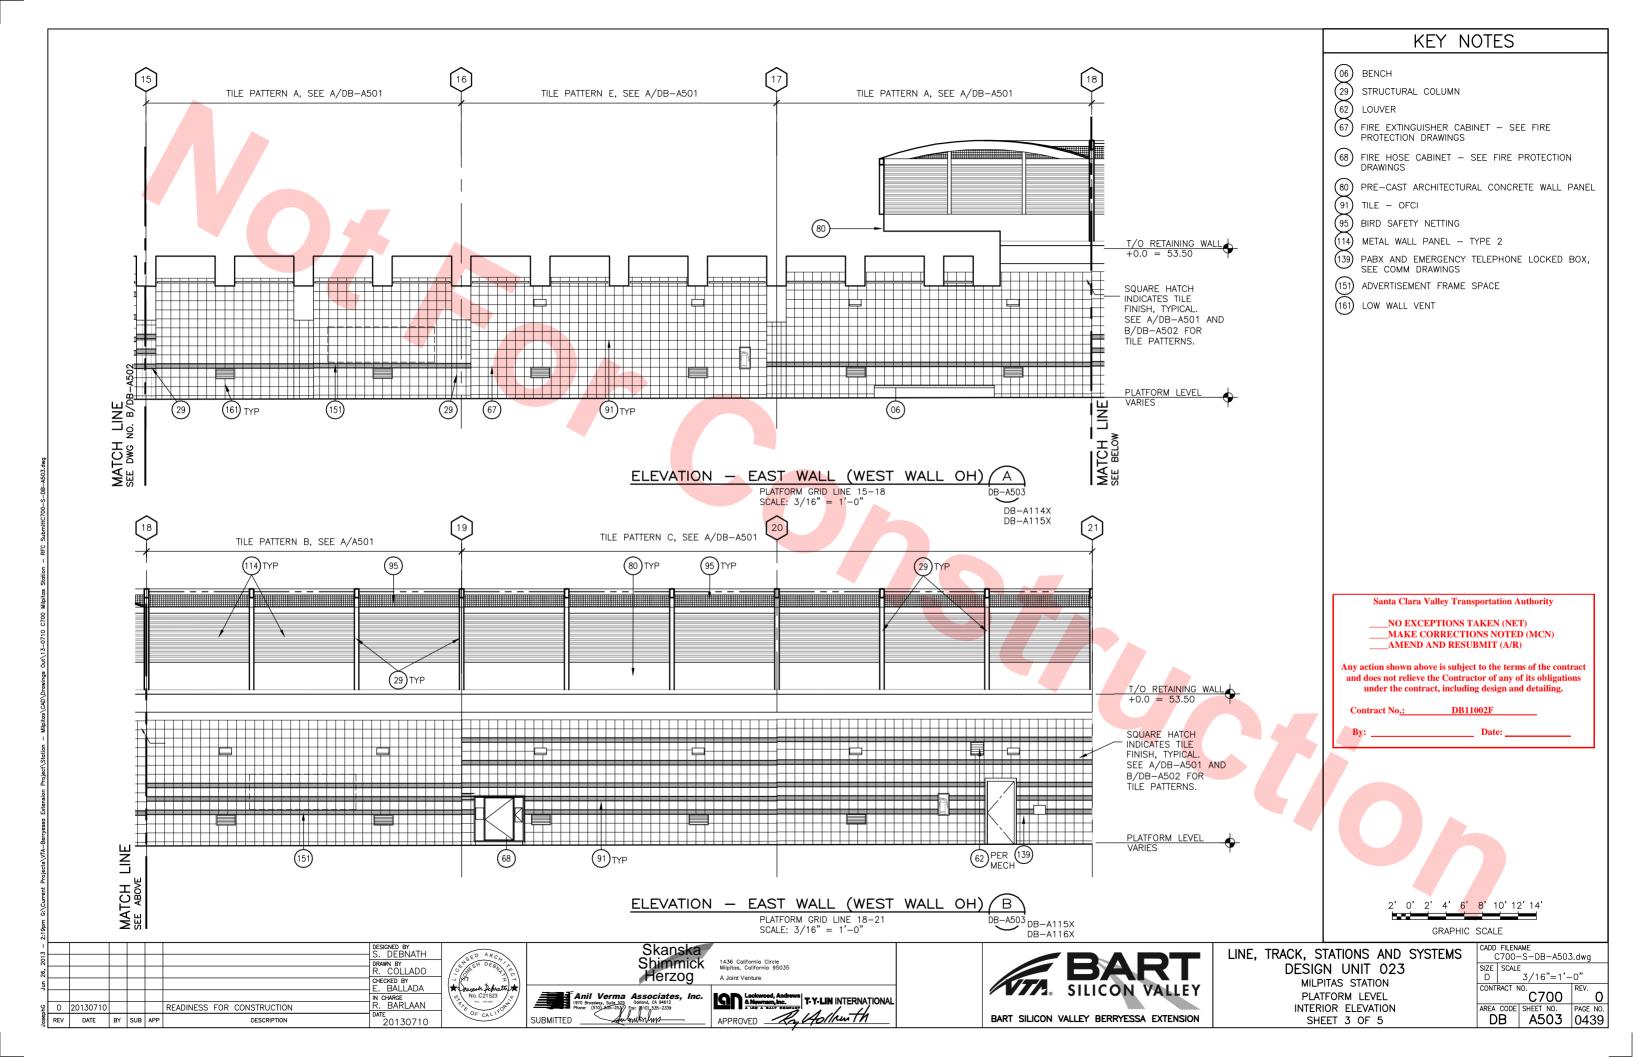


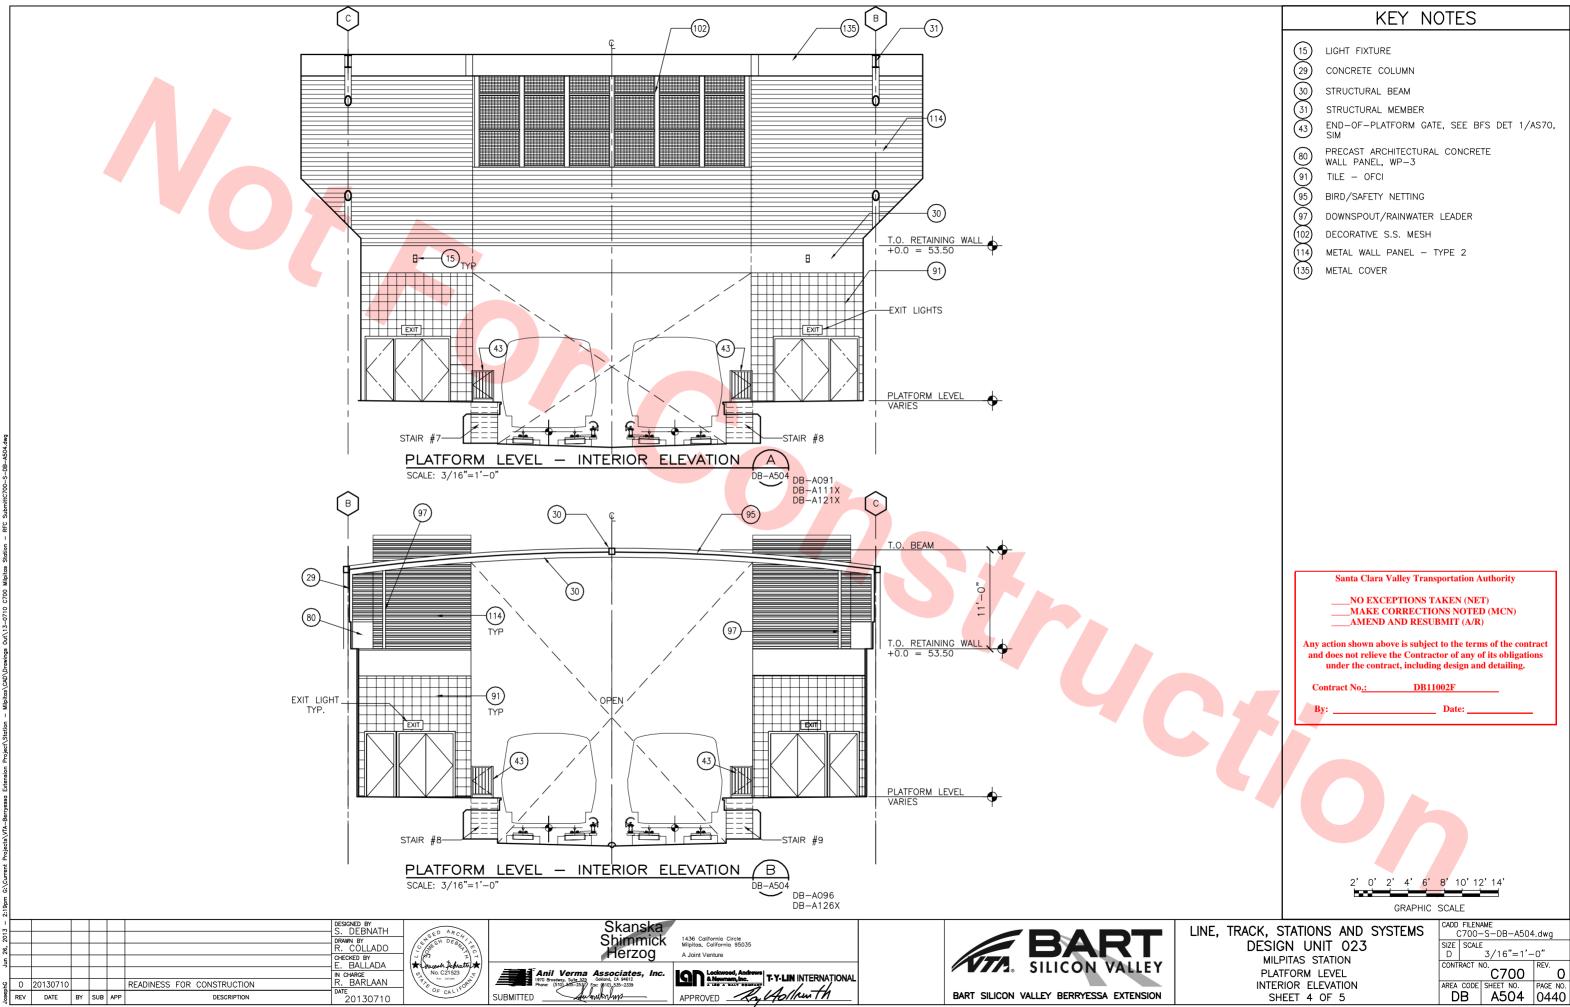


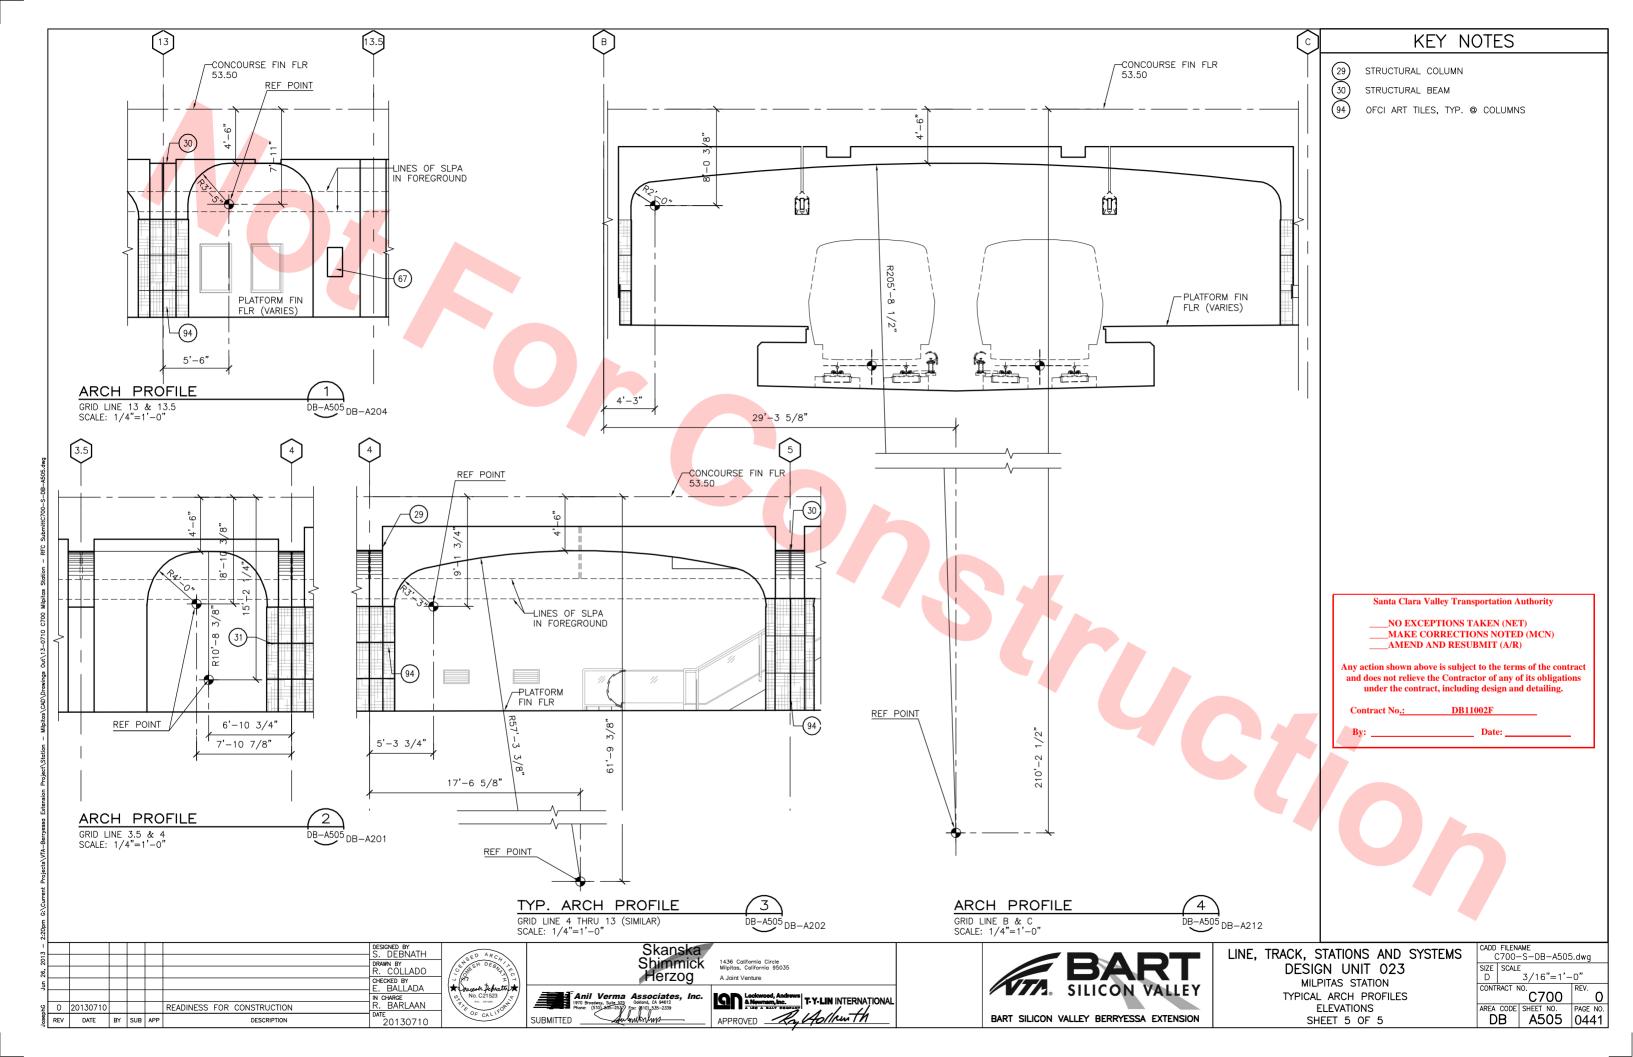


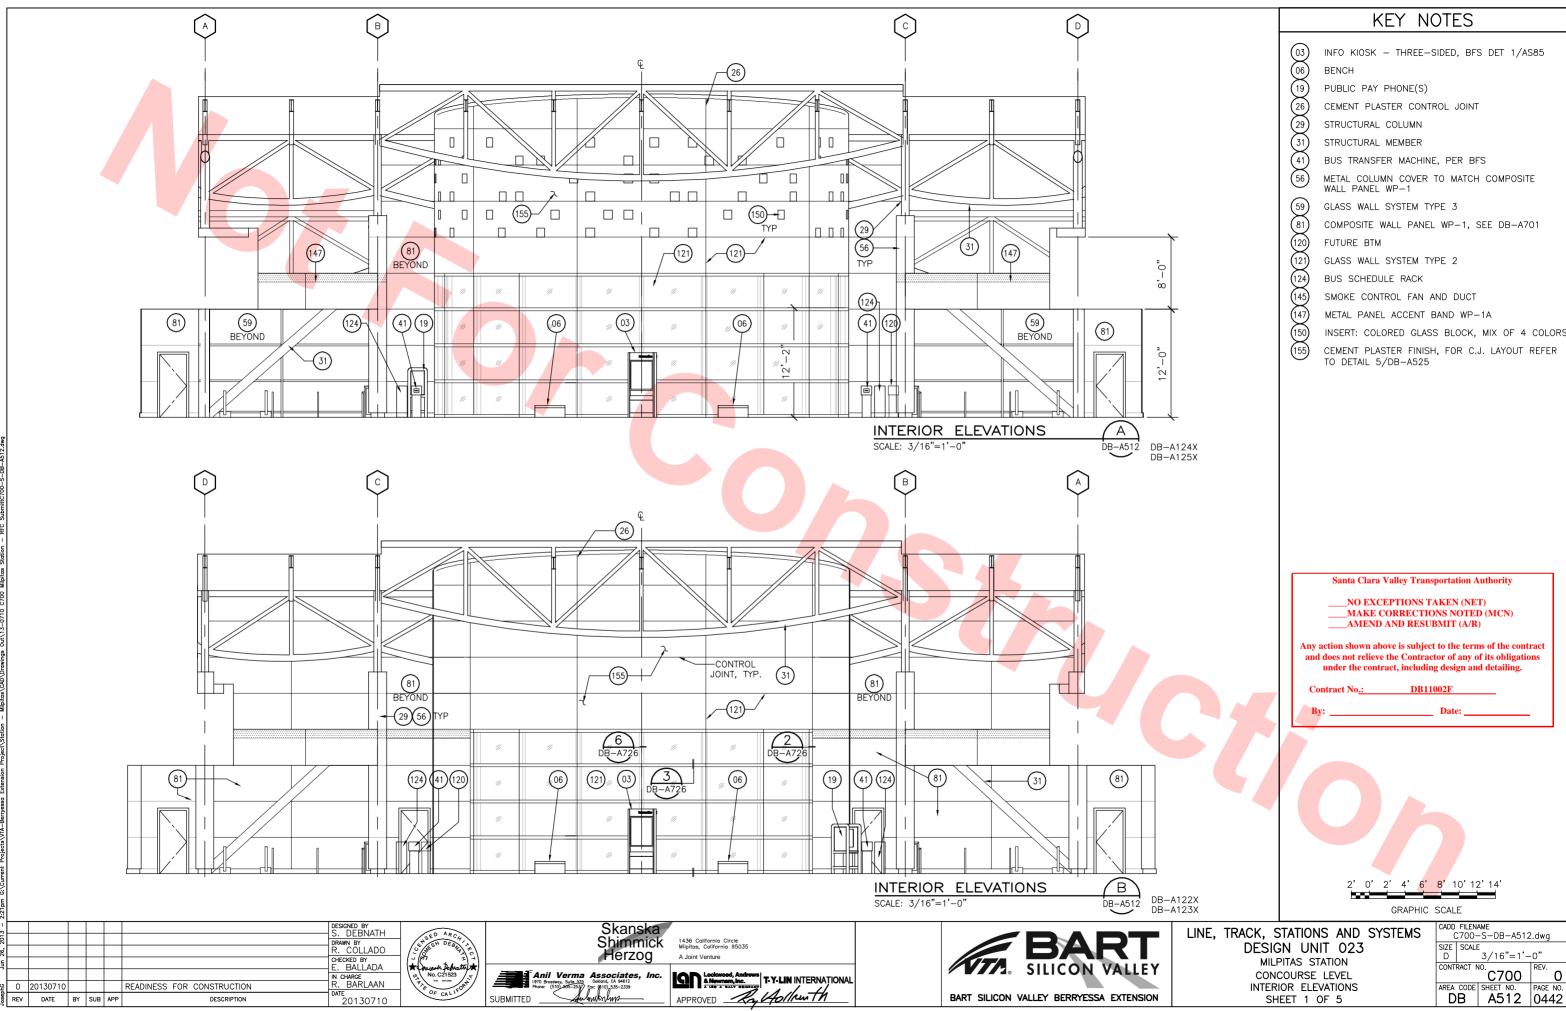


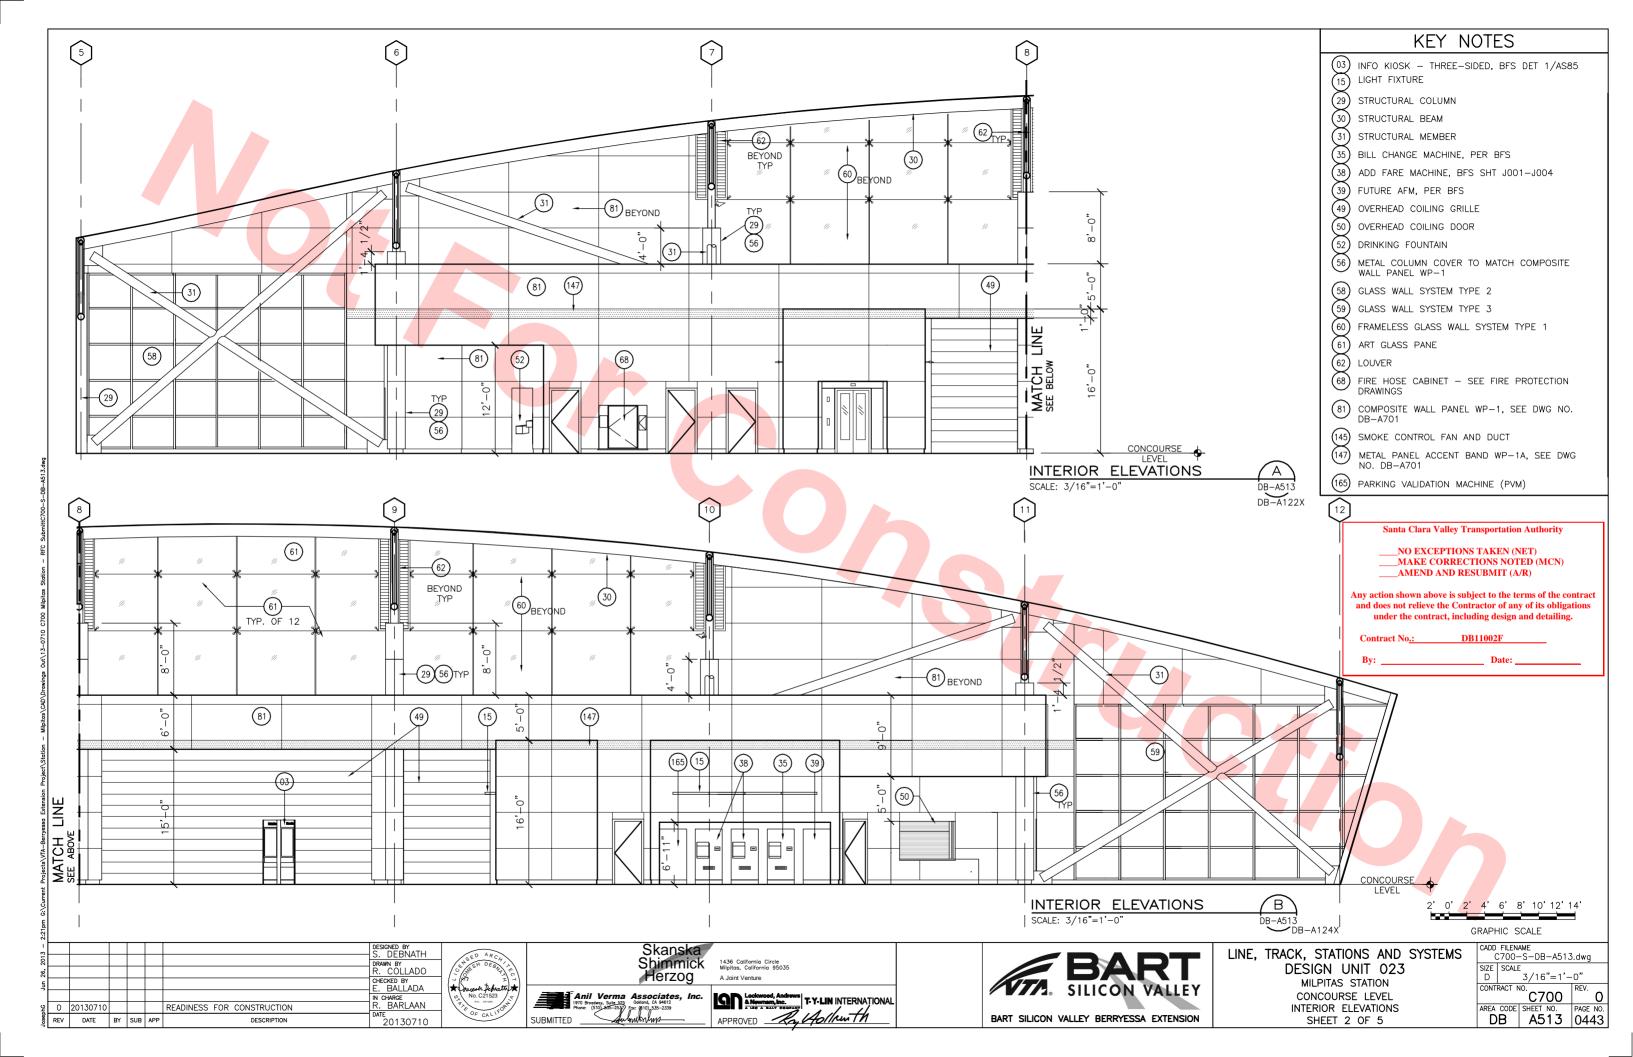


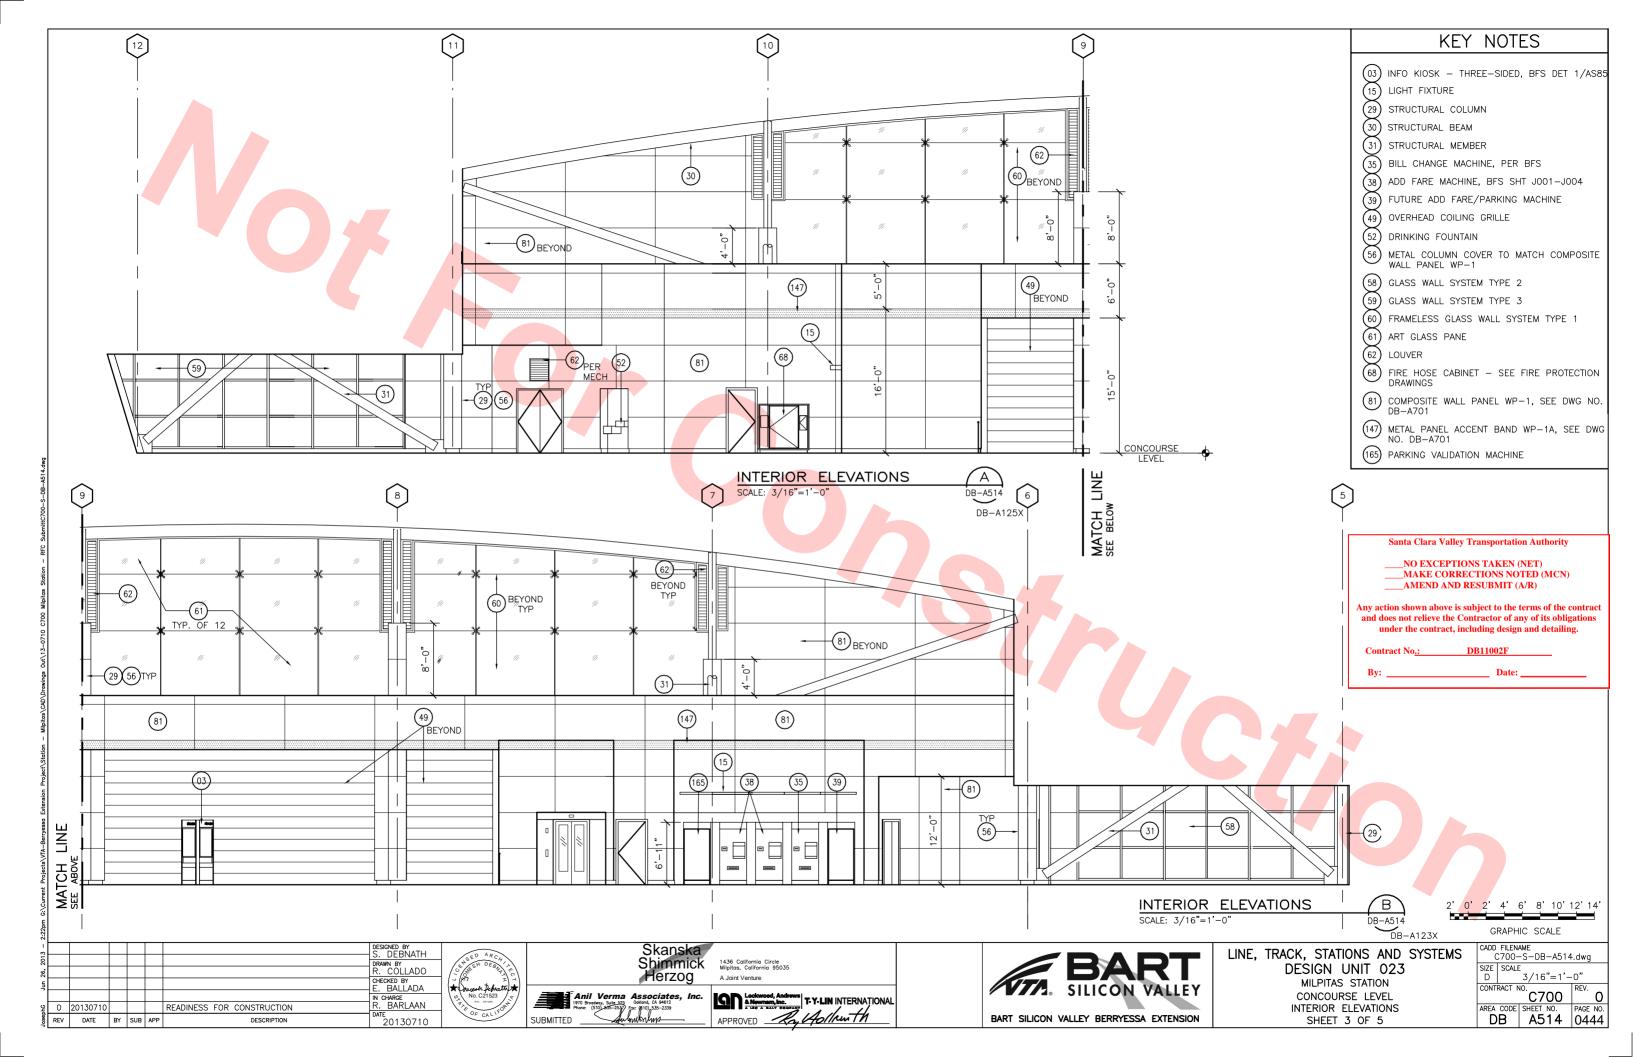


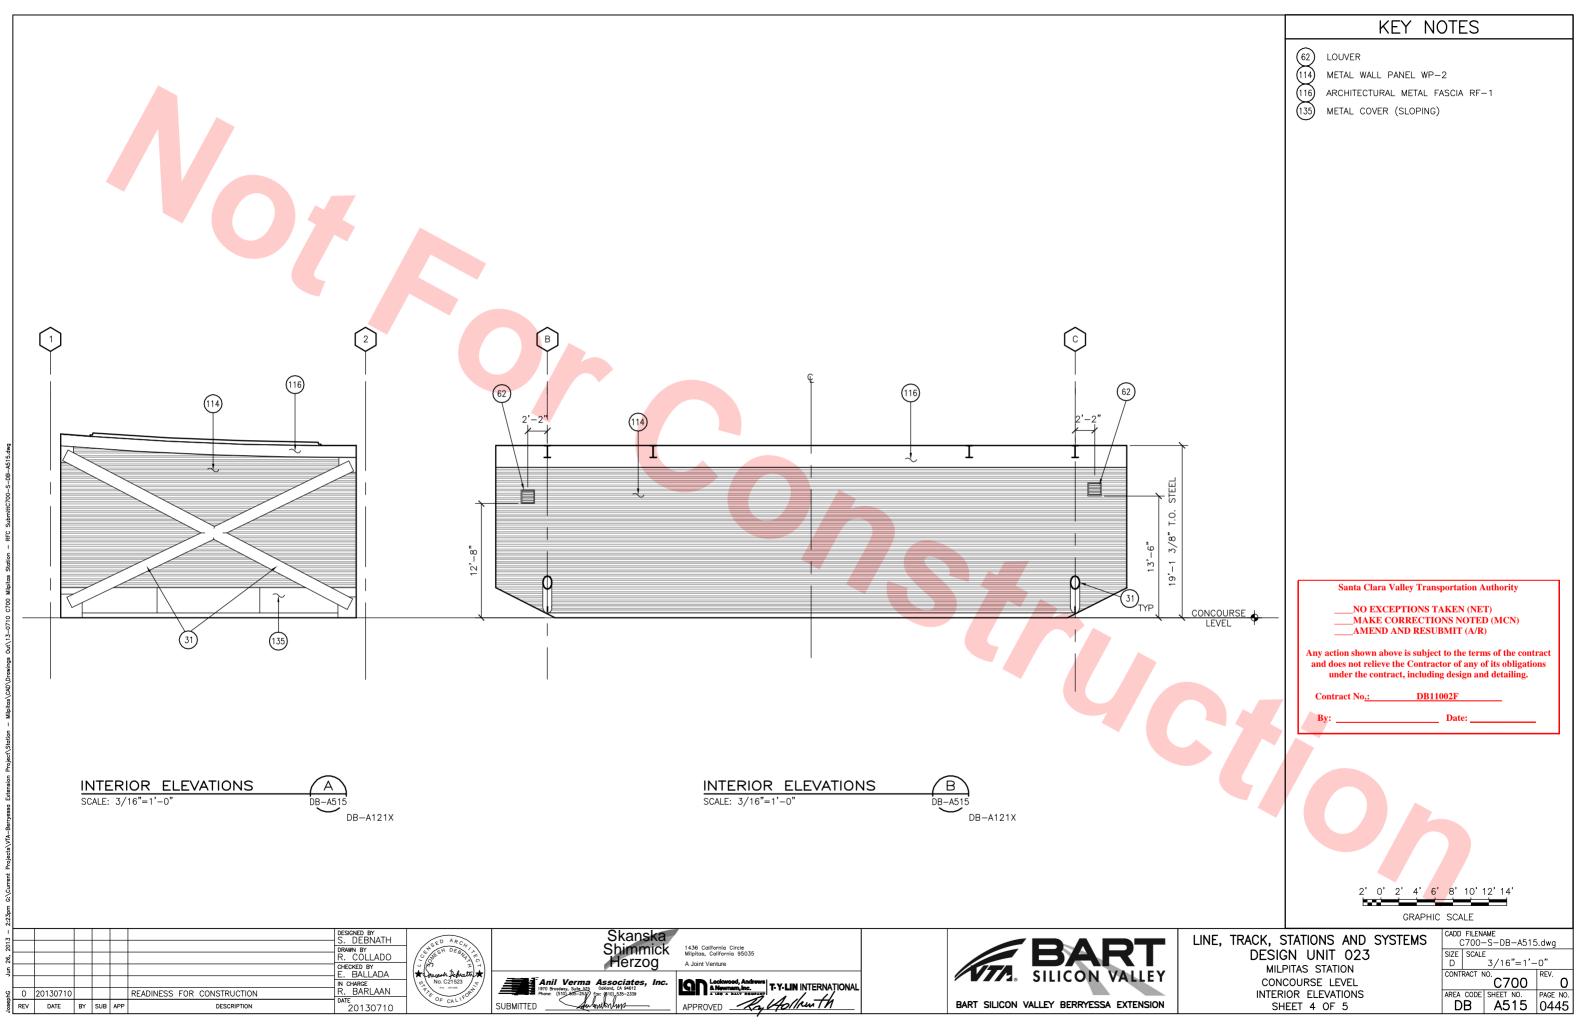


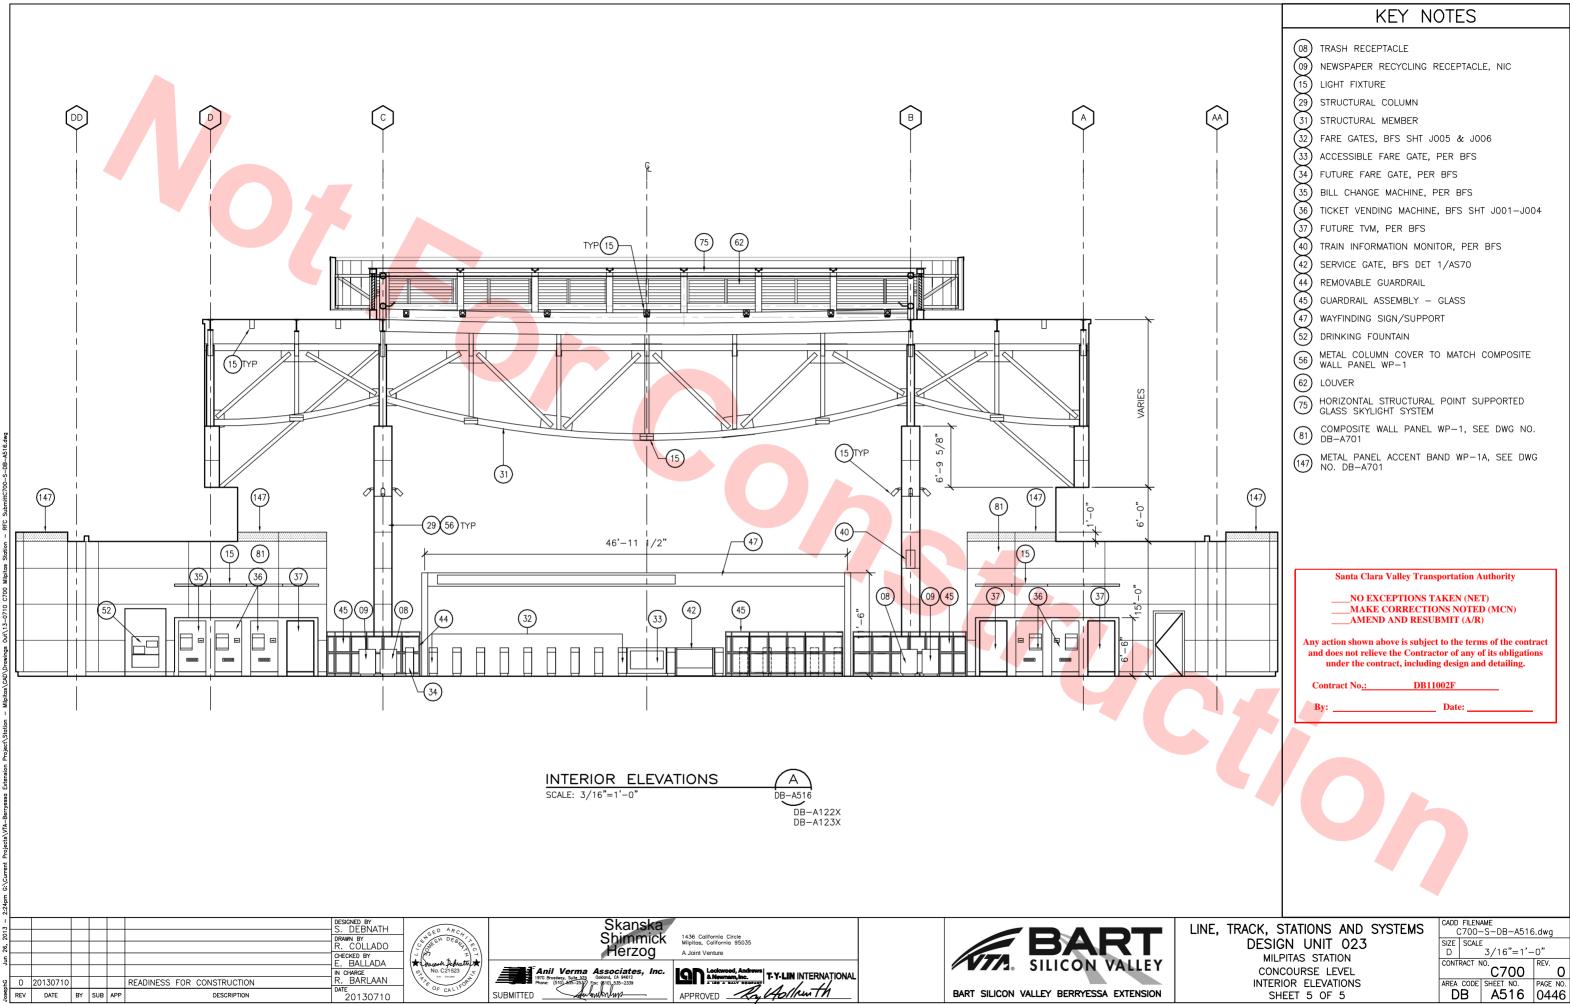


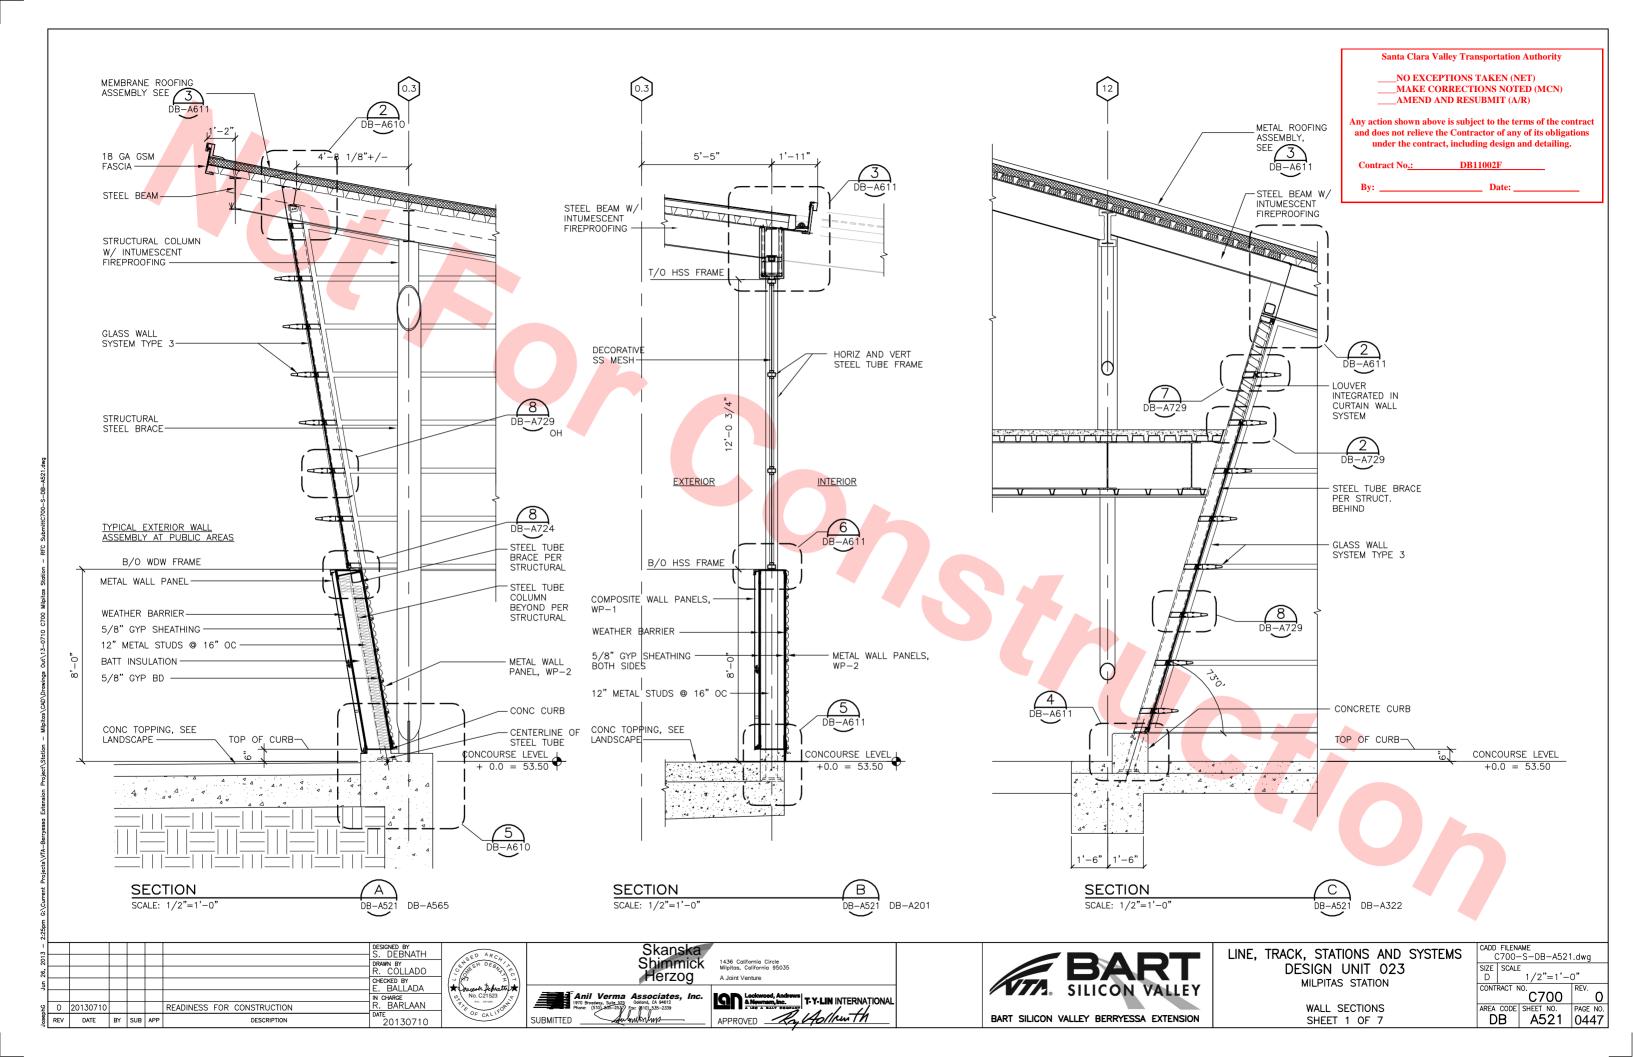


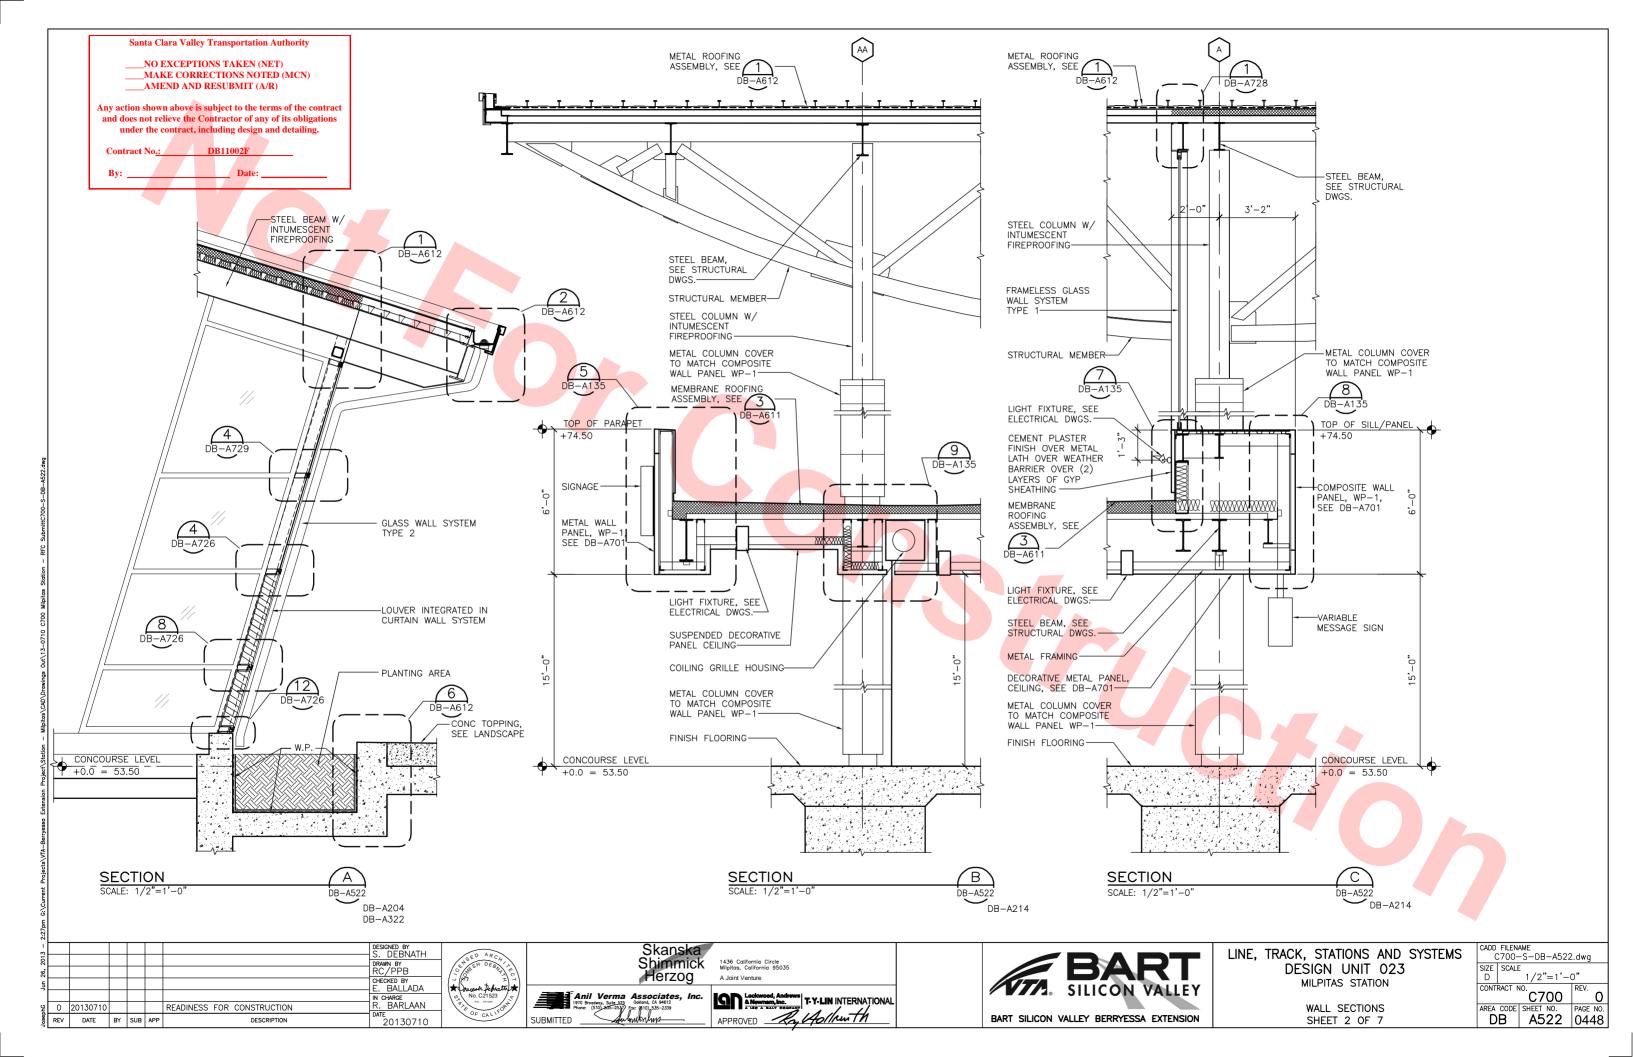


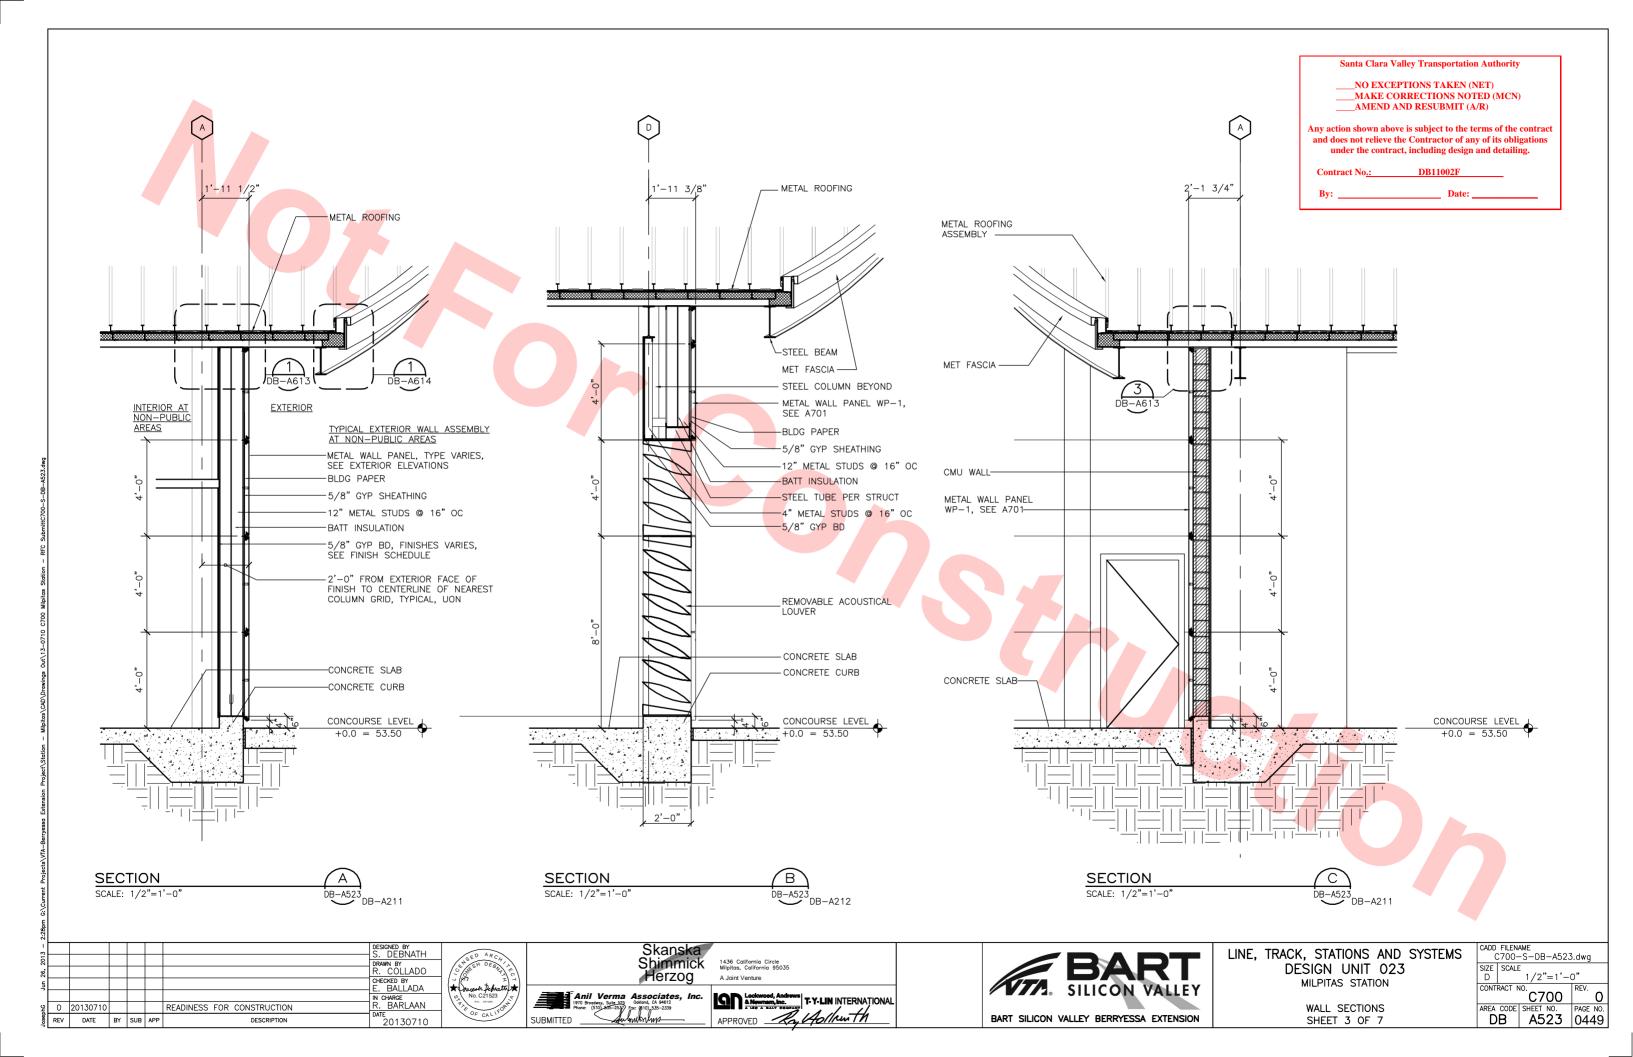


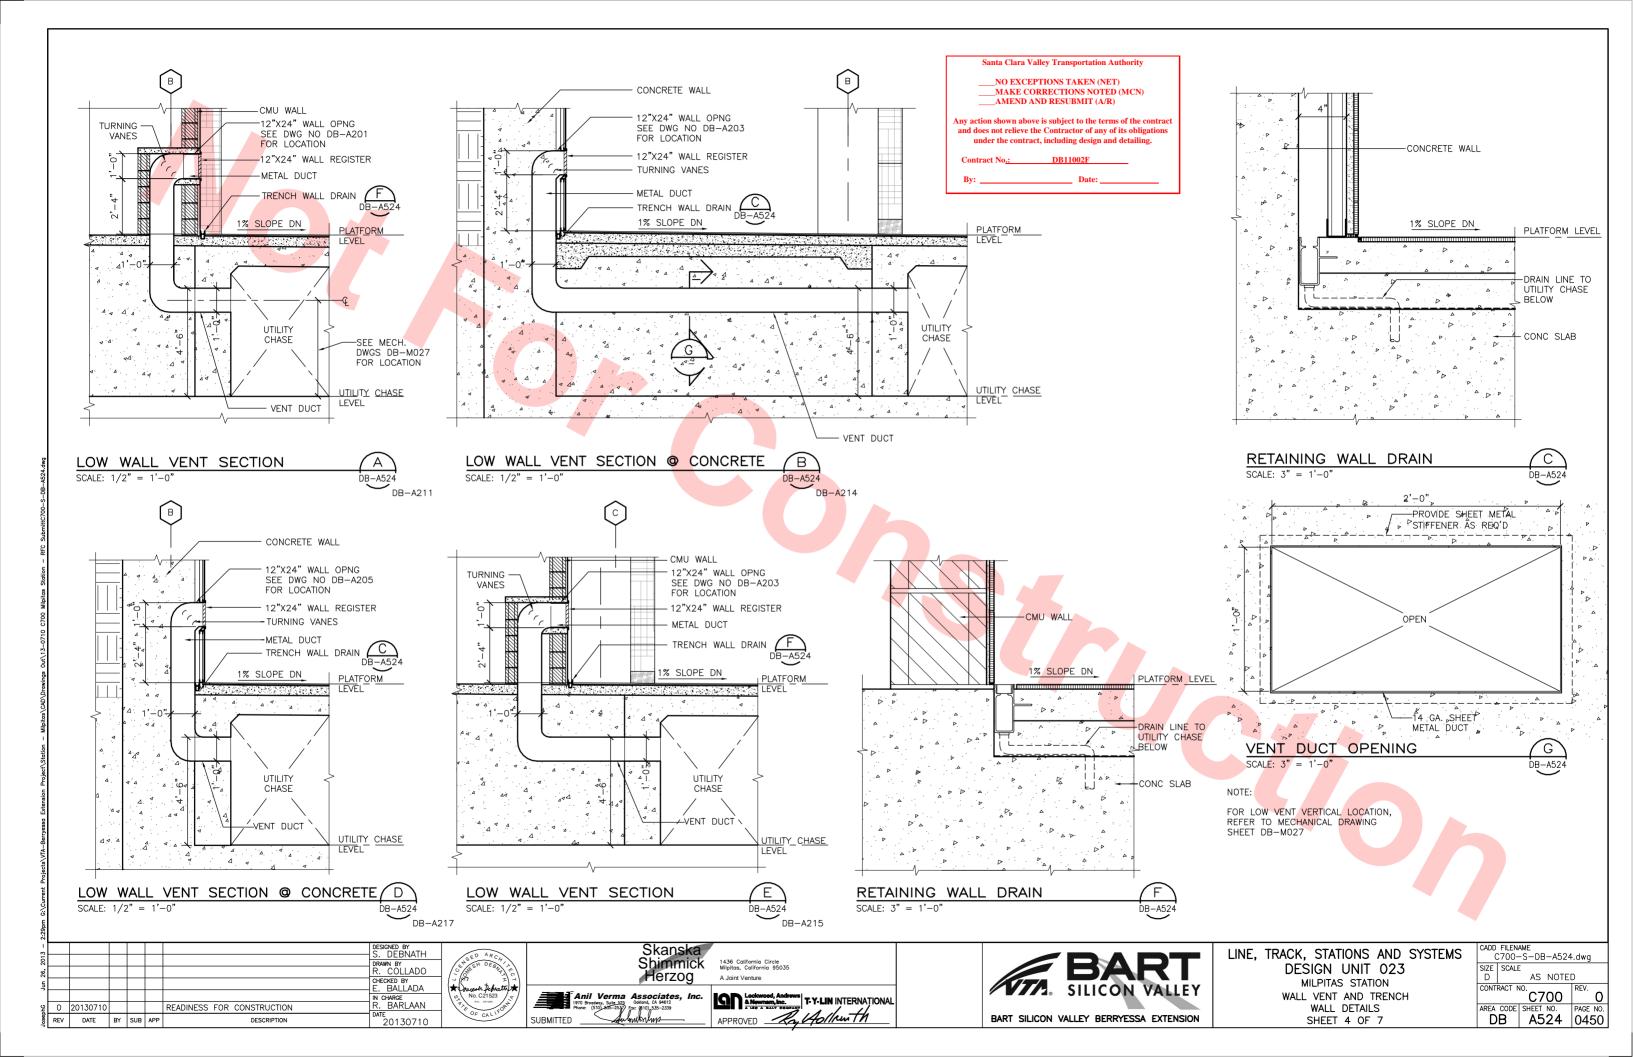


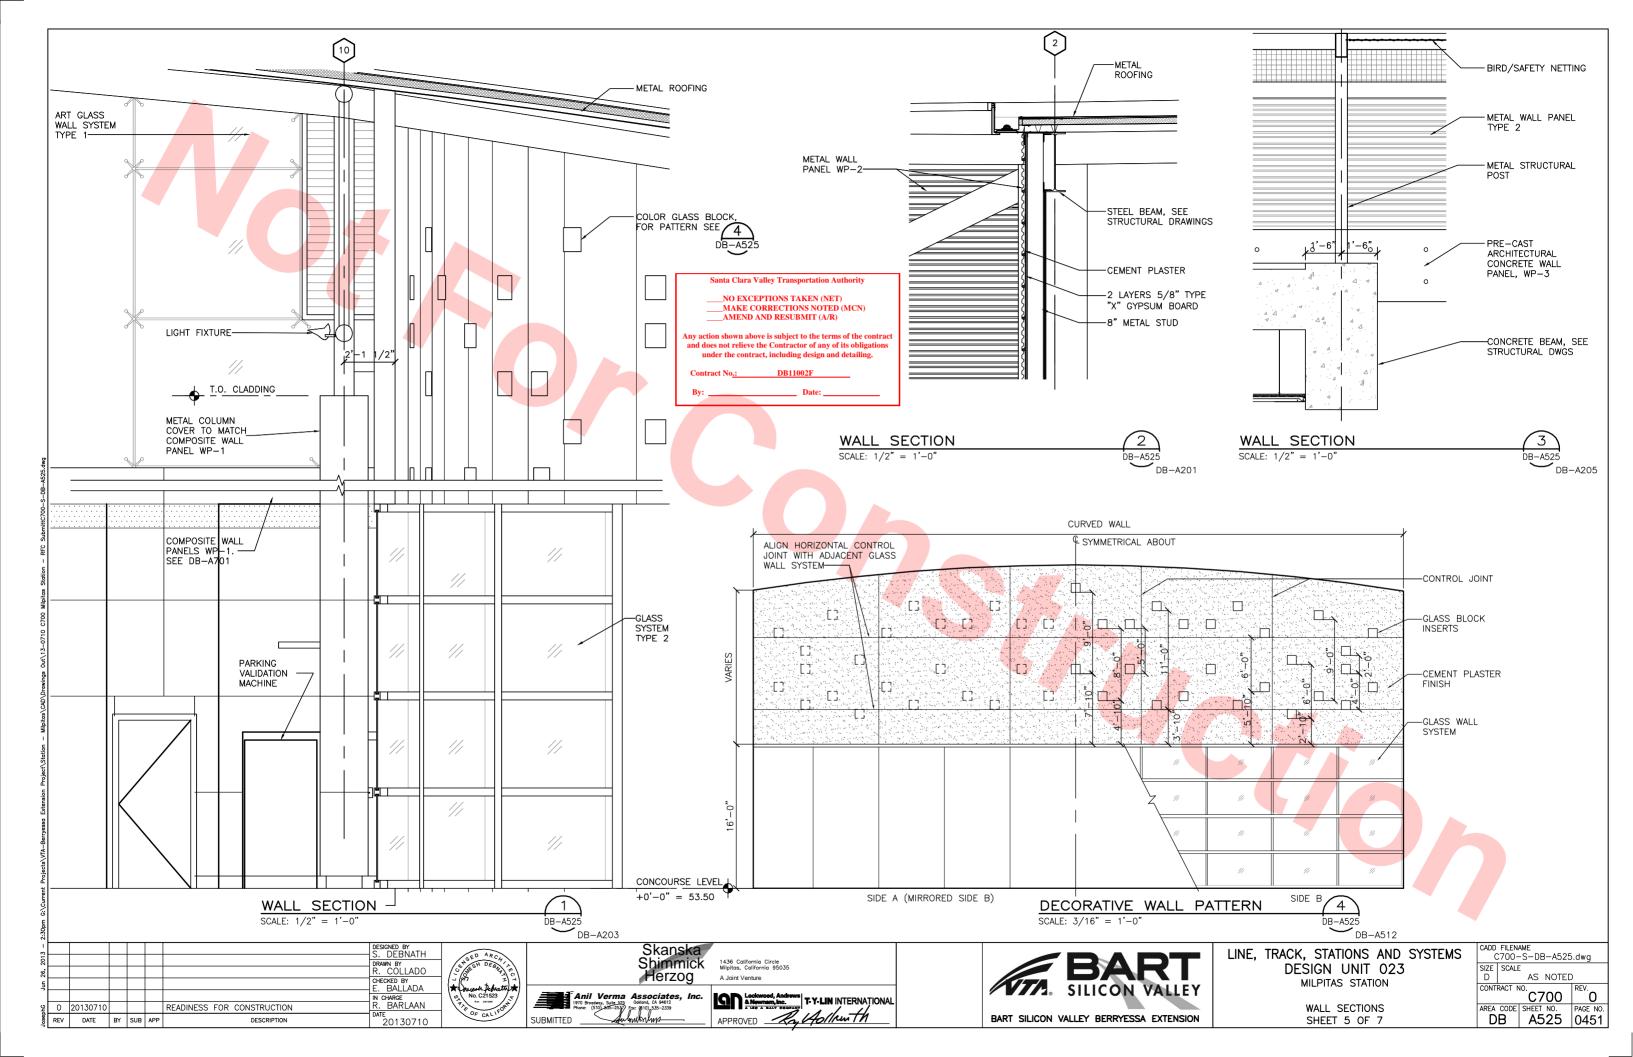


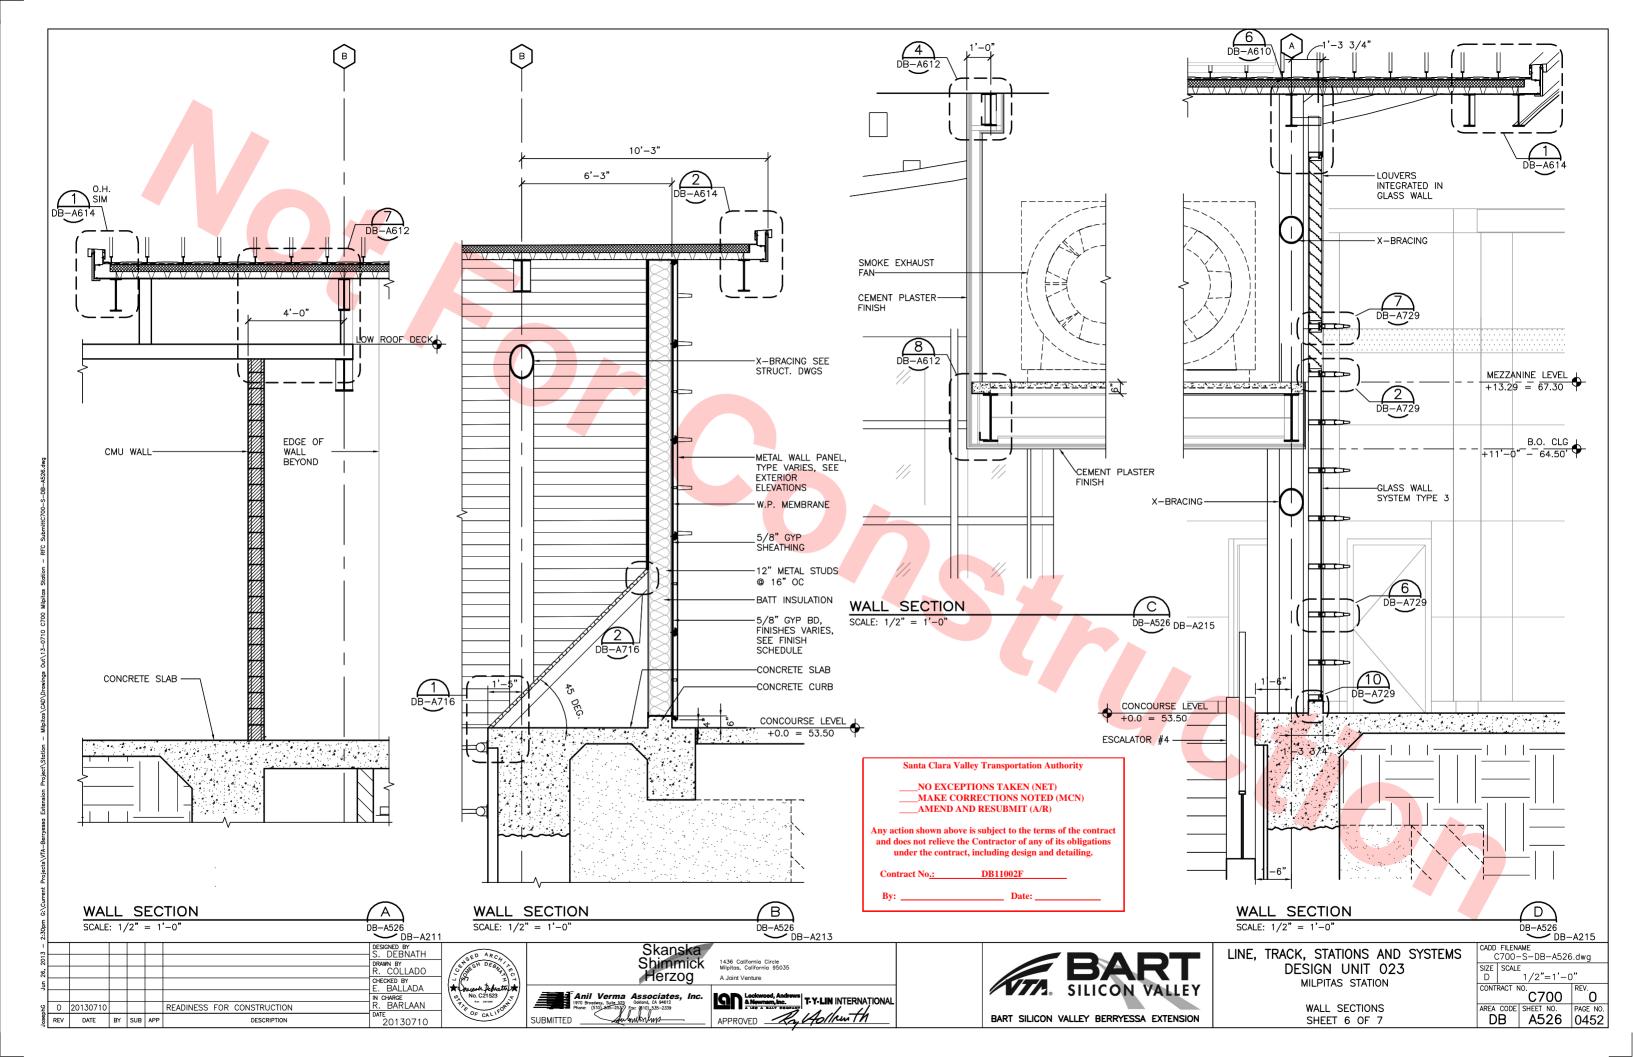

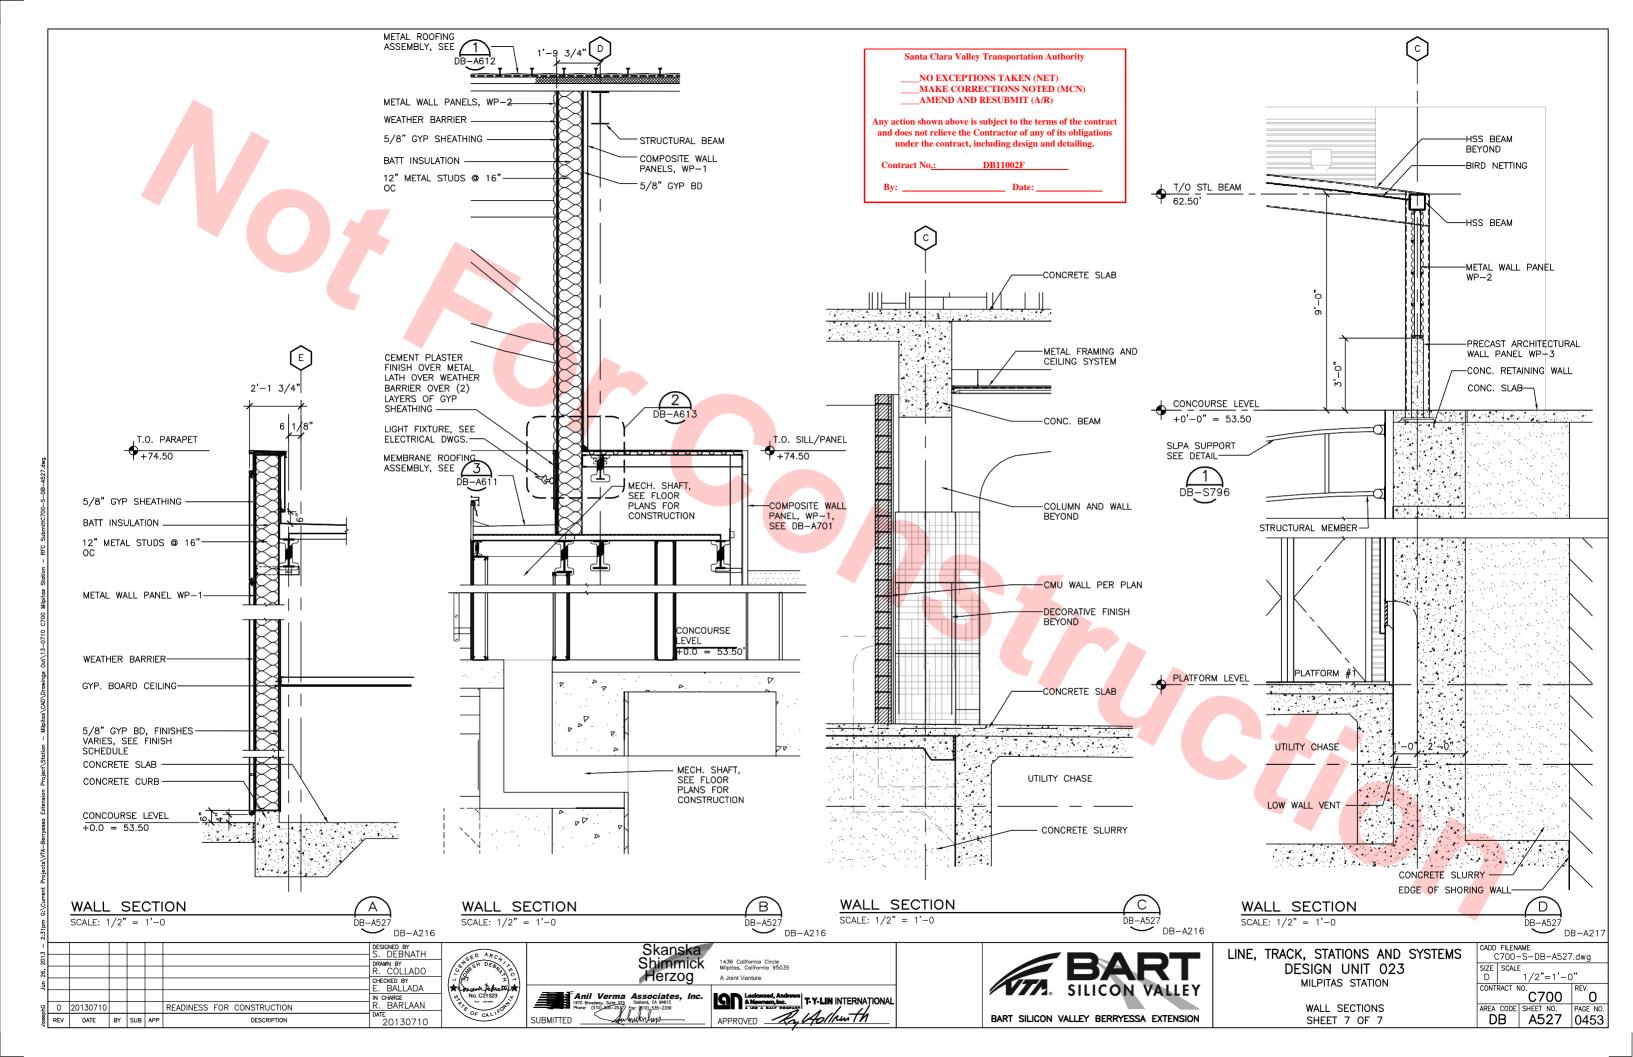

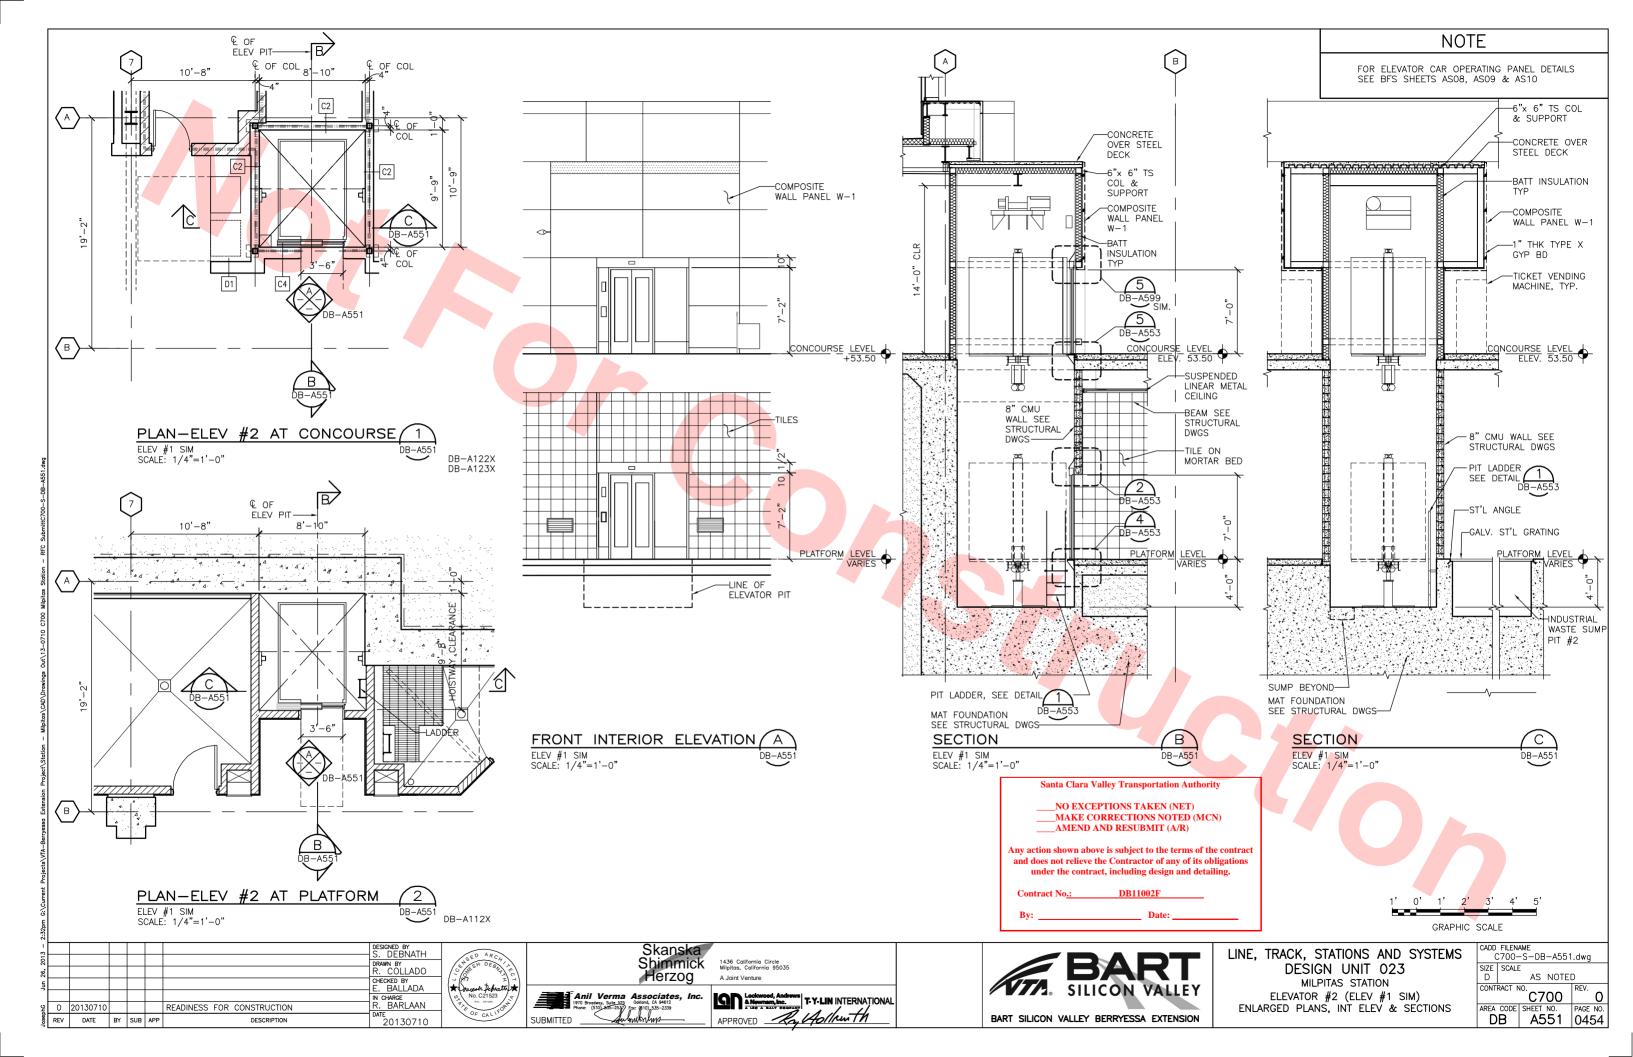

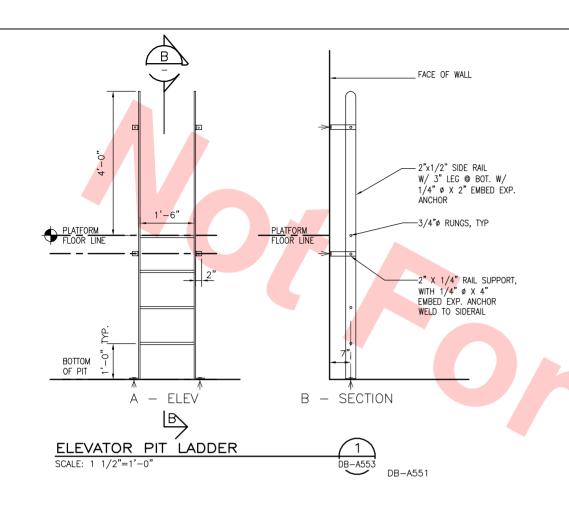

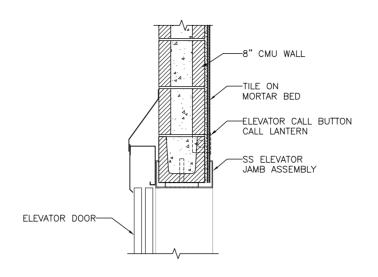

ELEVATOR HEAD @ PLATFORM LEVEL 2 SCALE: 1 1/2"=1'-0"

ELEVATOR DOOR-ELEVATOR LOBBY **HOISTWAY** FINISH FLOOR LINE ADJUSTABLE THRESHOLD BY ELEV MFR-SUPPORT ANGLE CONCRETE SLAB AND PIT WALL-44 44

ELEVATOR SILL @ PLATFORM LEVEL

SCALE: 1 1/2"=1'-0"

ELEVATOR DOOR-ELEVATOR LOBBY **HOISTWAY** FINISH FLOOR LINE ADJUSTABLE THRESHOLD BY ELEV MFR SUPPORT ANGLE- \triangle CONCRETE SLAB-8" CMU WALL-

ELEVATOR SILL @ CONCOURSE LEVEL SCALE: 1 1/2"=1'-0"

DB-A551

Santa Clara Valley Transportation Authority _NO EXCEPTIONS TAKEN (NET)


MAKE CORRECTIONS NOTED (MCN) AMEND AND RESUBMIT (A/R) Any action shown above is subject to the terms of the contract and does not relieve the Contractor of any of its obligations under the contract, including design and detailing.

DB11002F

DESIGNED BY S. DEBNATH DRAWN BY R. COLLADO CHECKED BY E. BALLADA 22 0 20130710 READINESS FOR CONSTRUCTION
REV DATE BY SUB APP DESCRIPTION I CHARGE R. BARLAAN 20130710





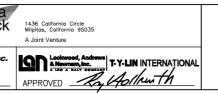




DB-A551


DB-A551


LINE, TRACK, STATIONS AND SYSTEM DESIGN UNIT 023 MILPITAS STATION


ELEVATOR DETAILS


MS	CADD FILENAME C700-S-DB-A553.dwg					
	SIZE D	SCALE	: 1 1/2	2"=1'-	-0"	
		RACT N	C7	00	REV.	
	AREA	CODE	SHEET	NO.	PAGE NO	
	D	В	A5	53	0455	

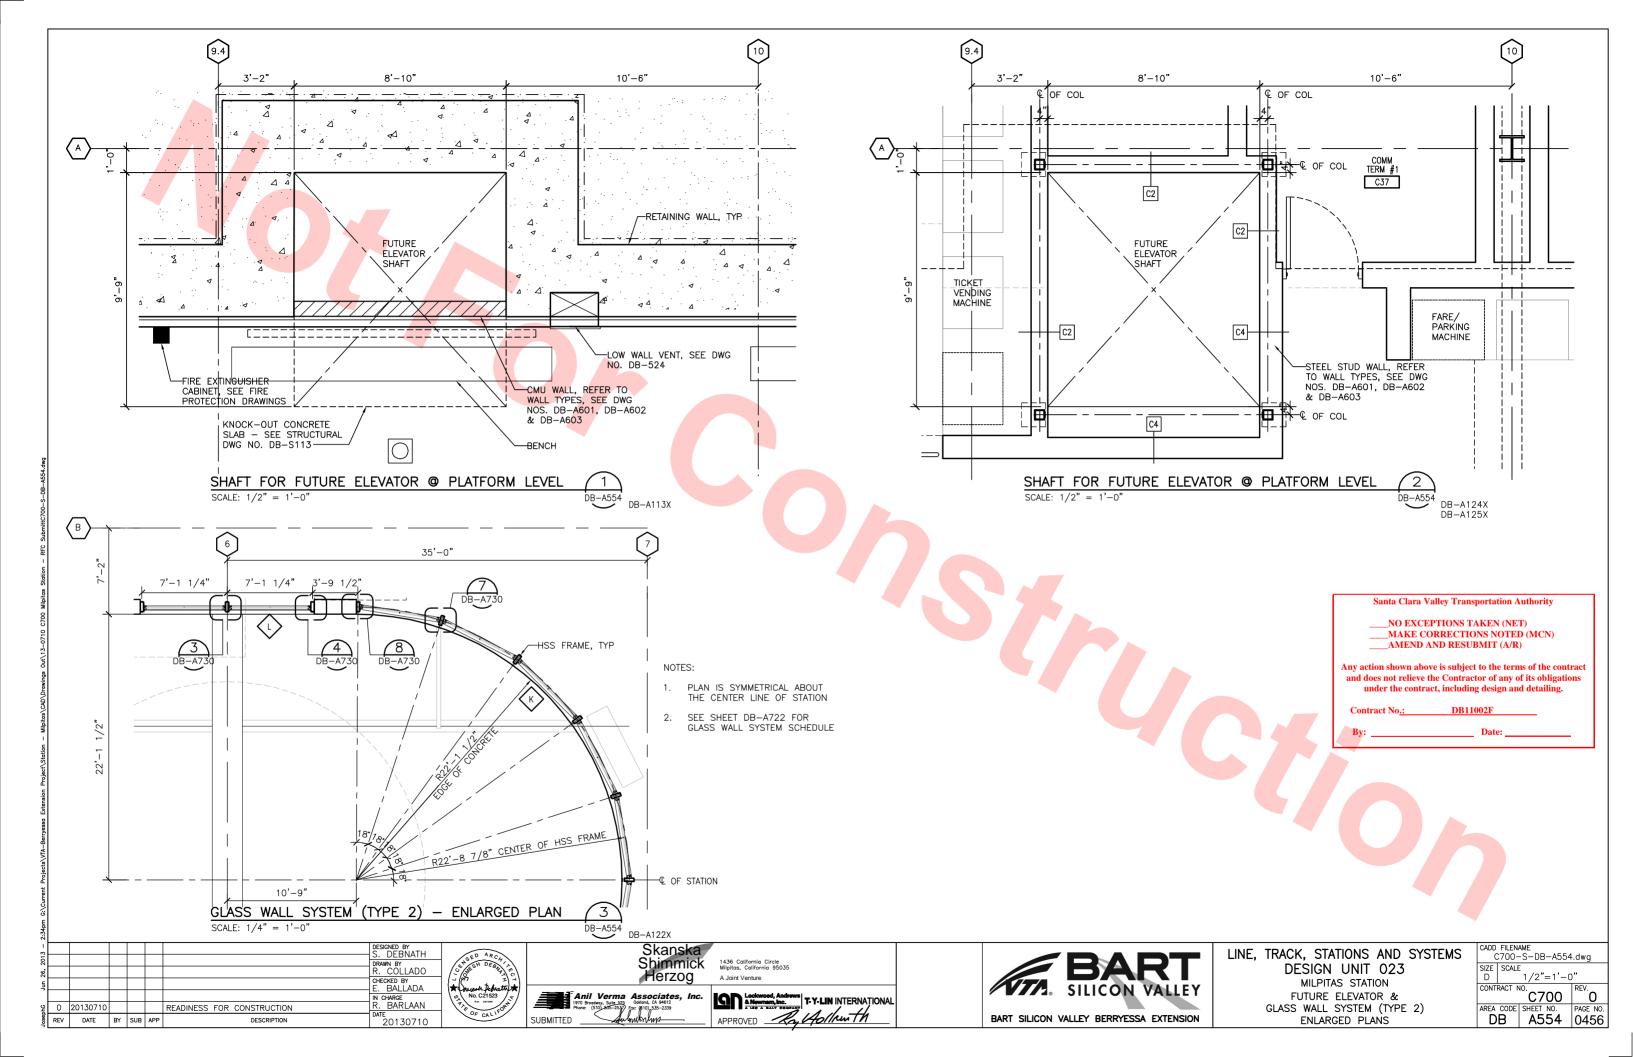


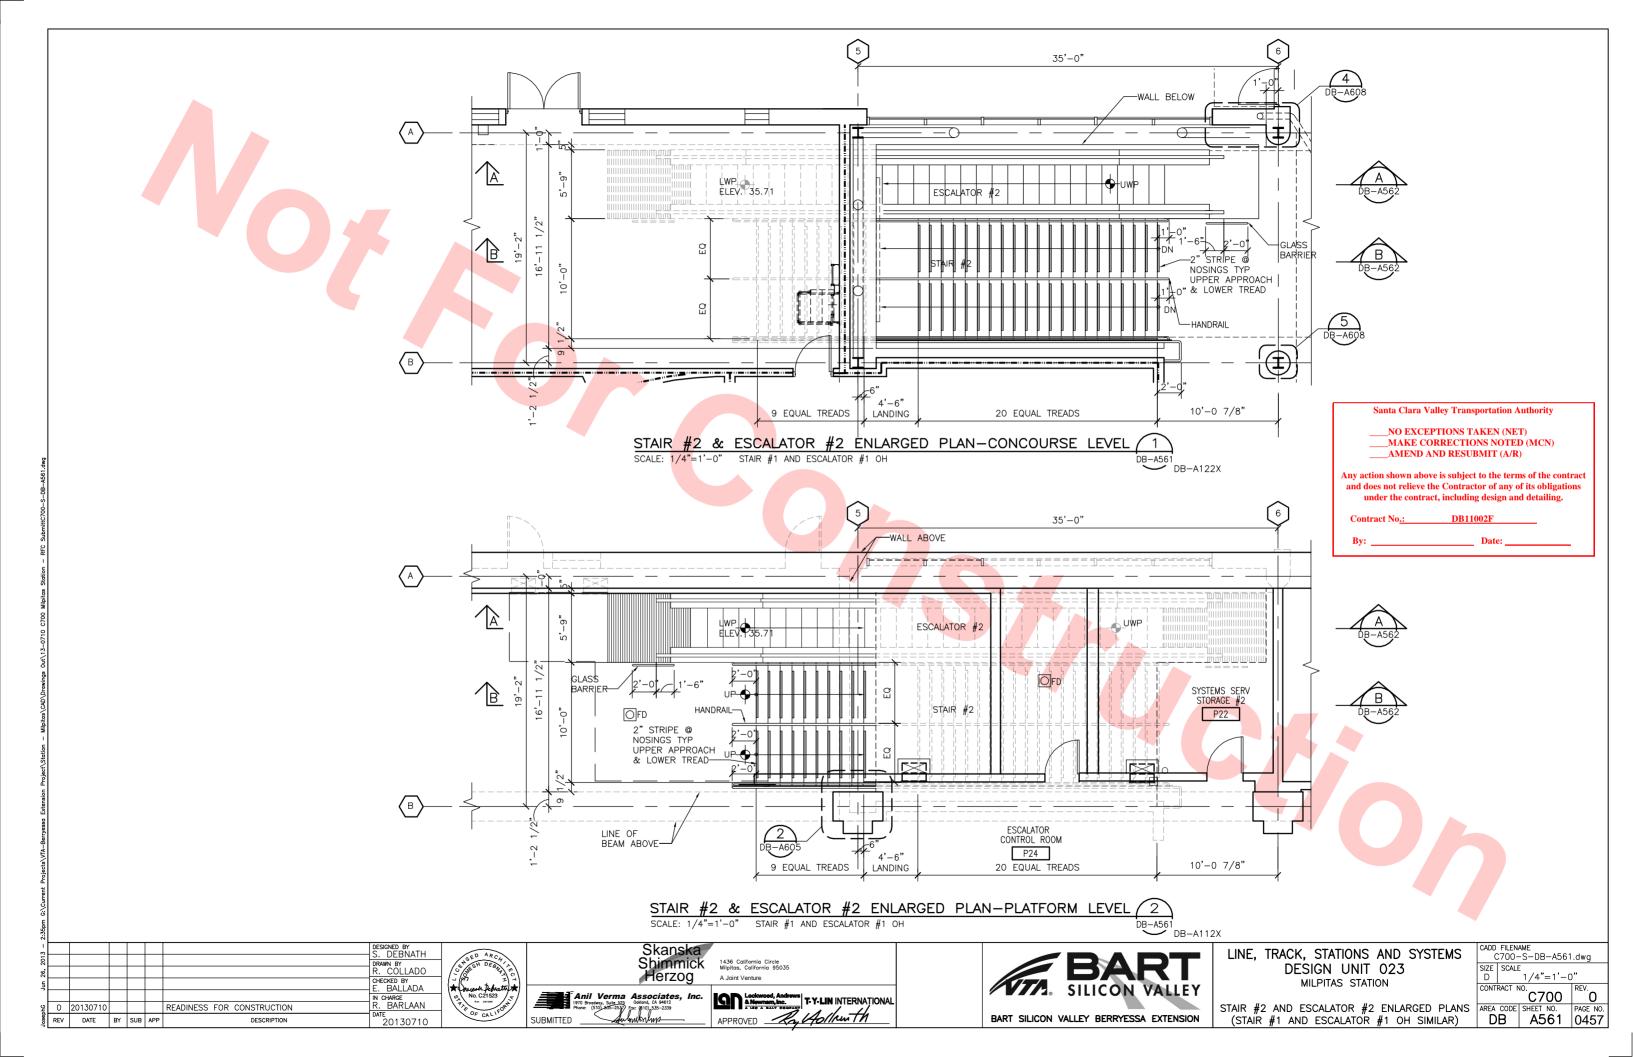


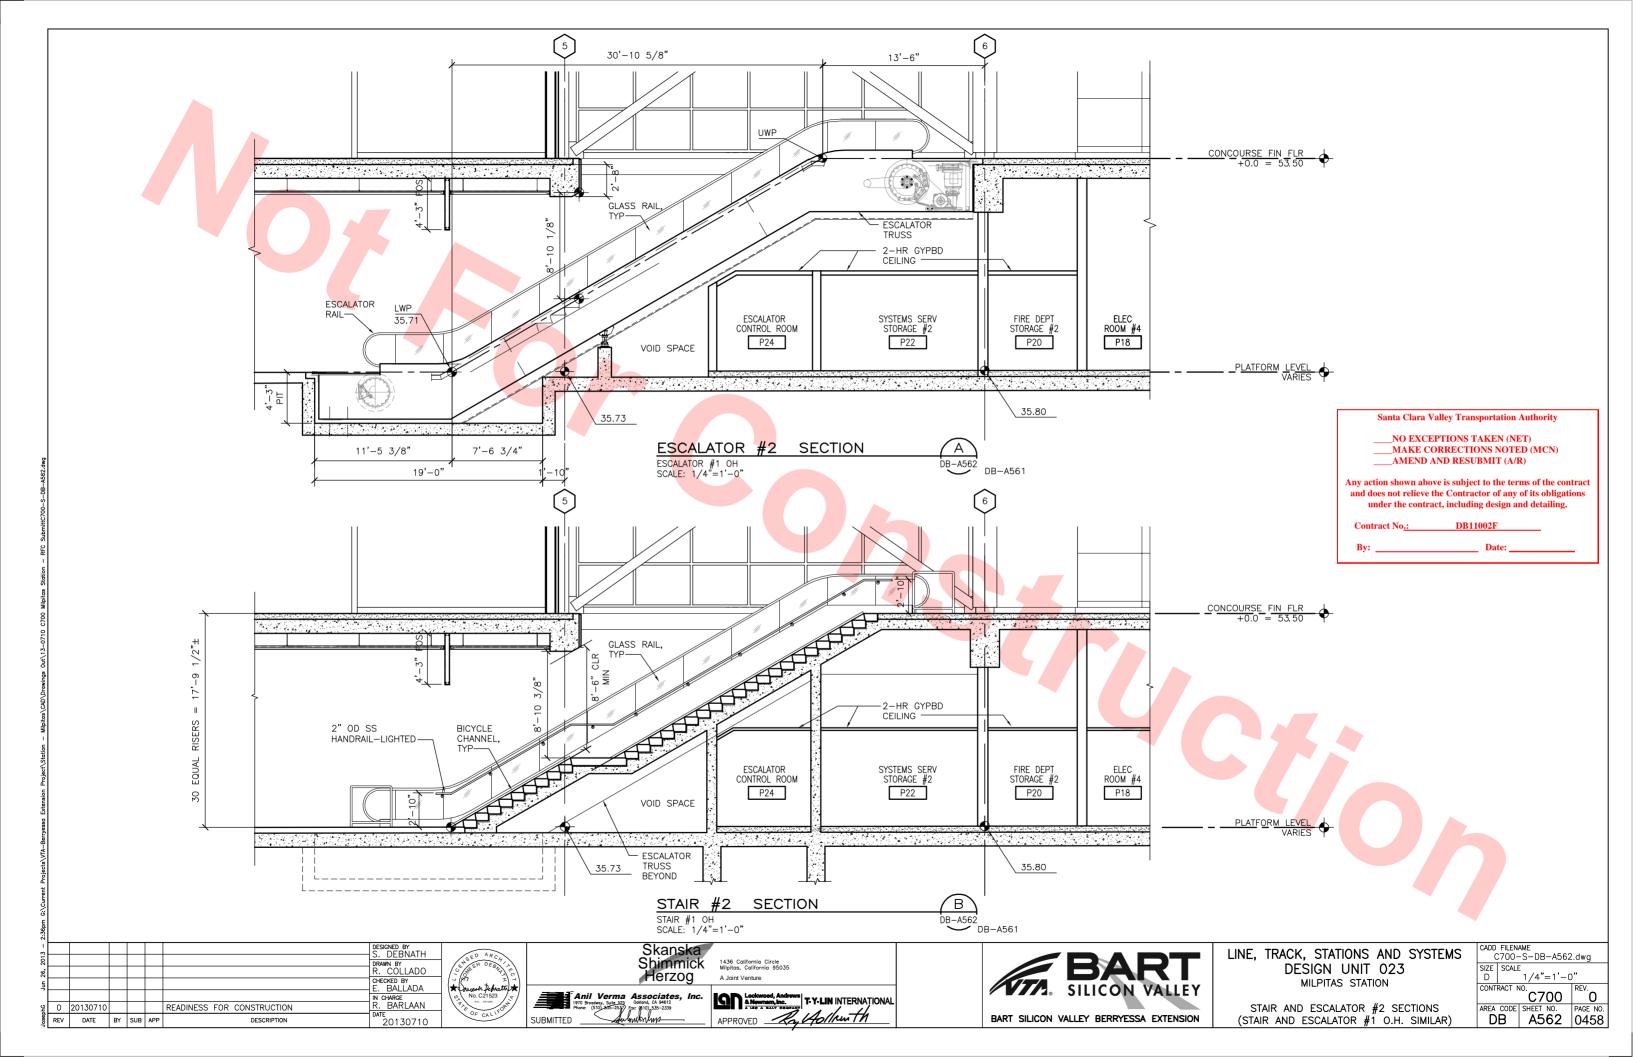


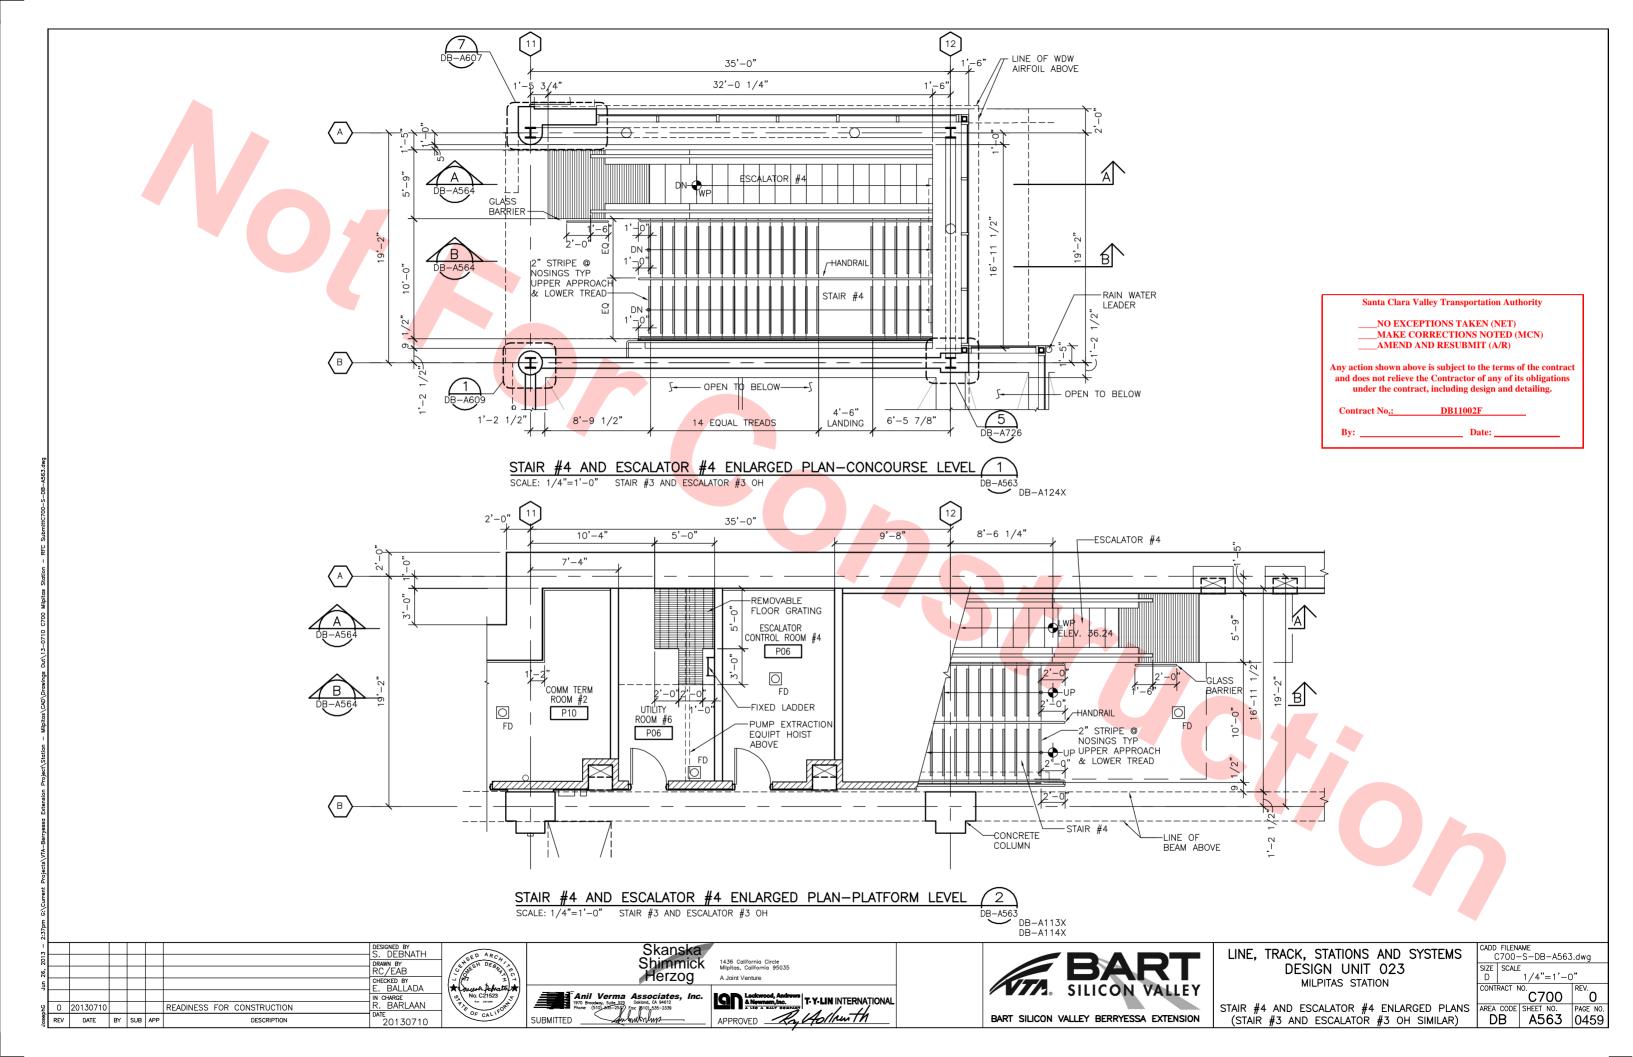


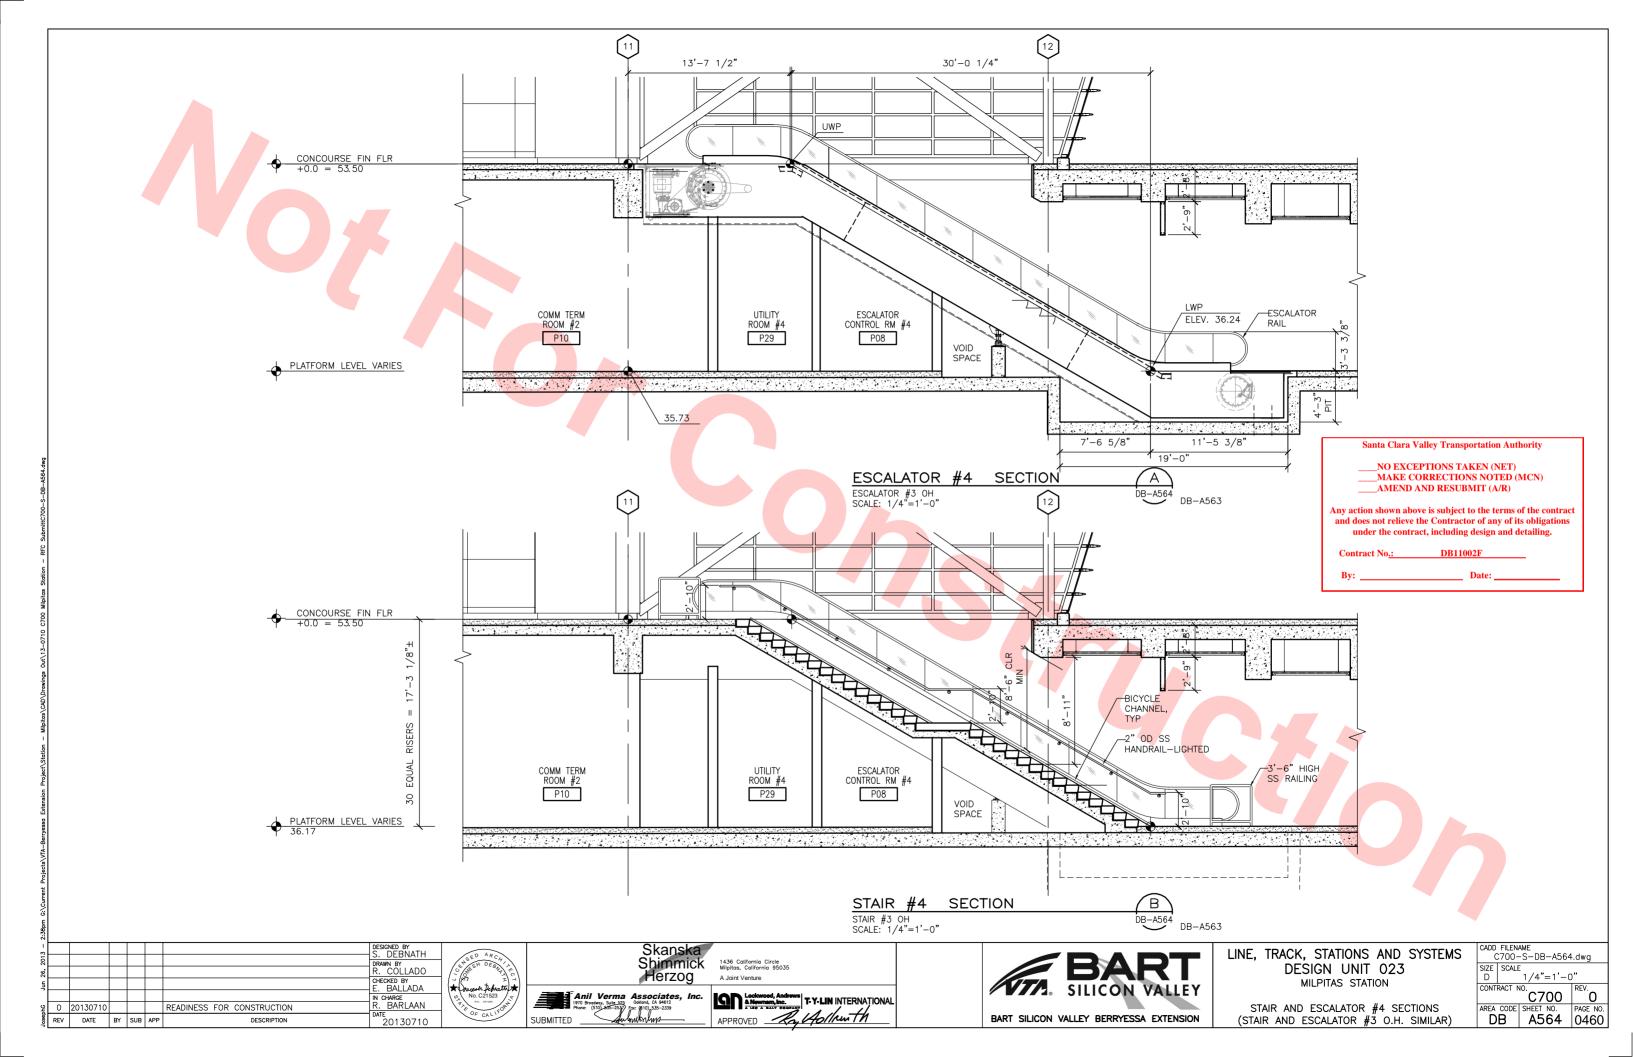

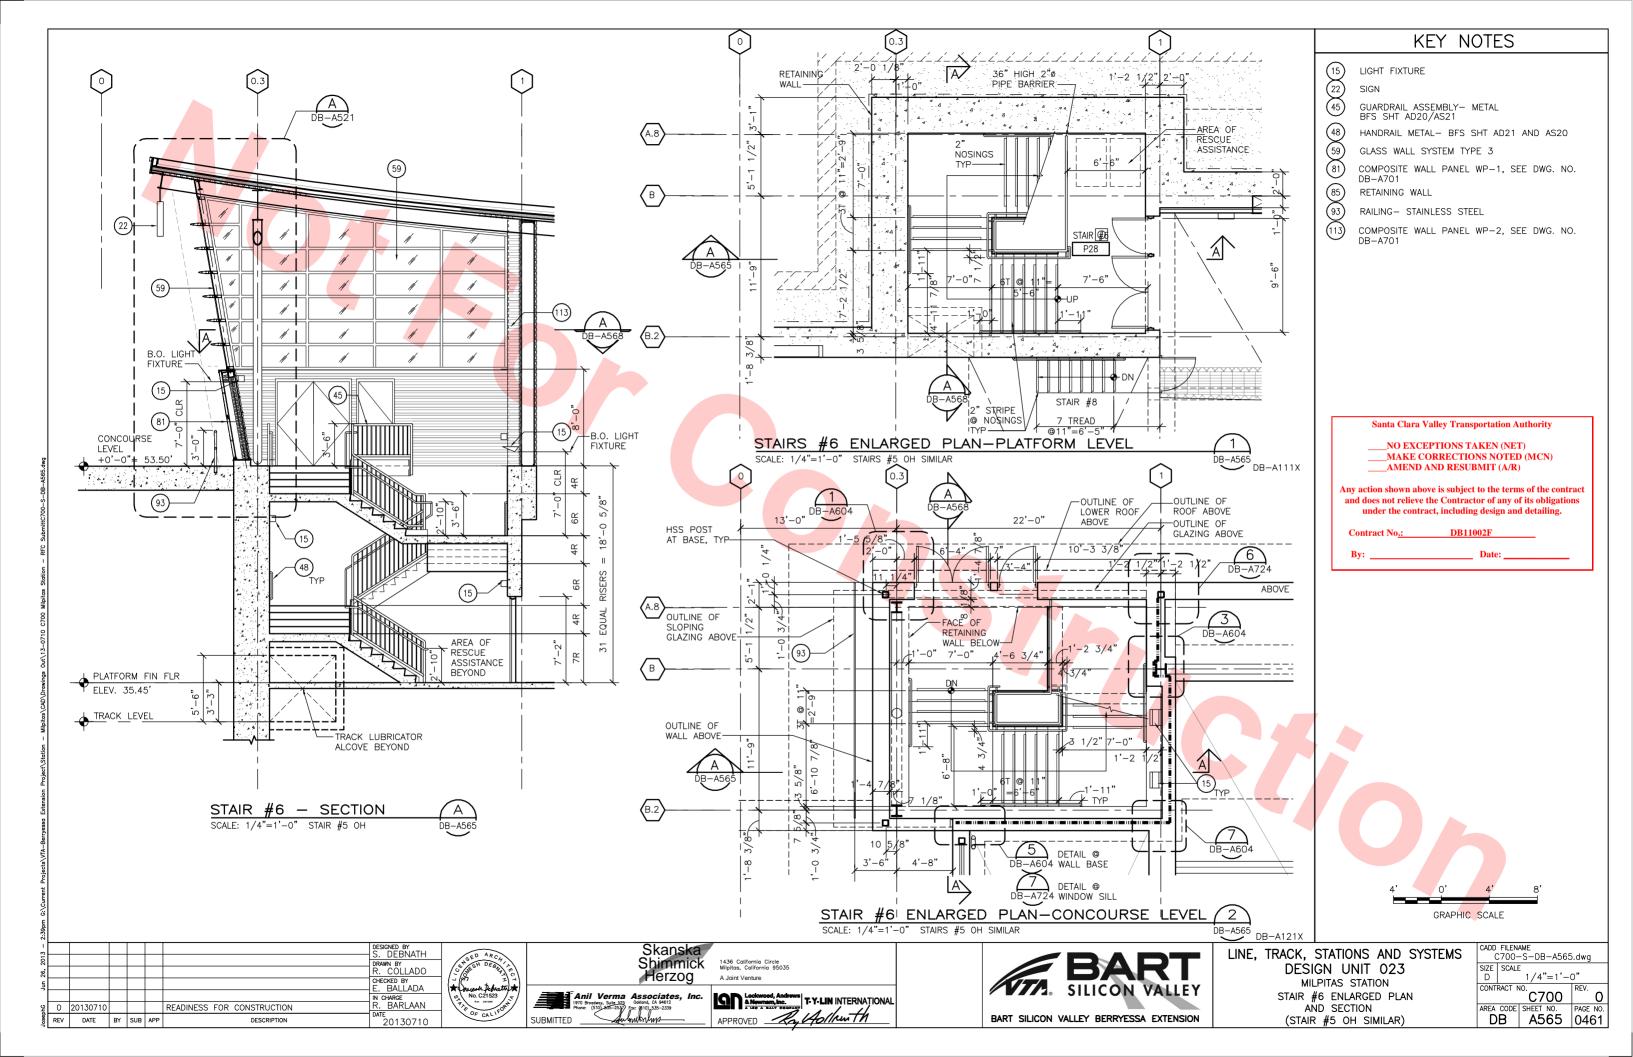

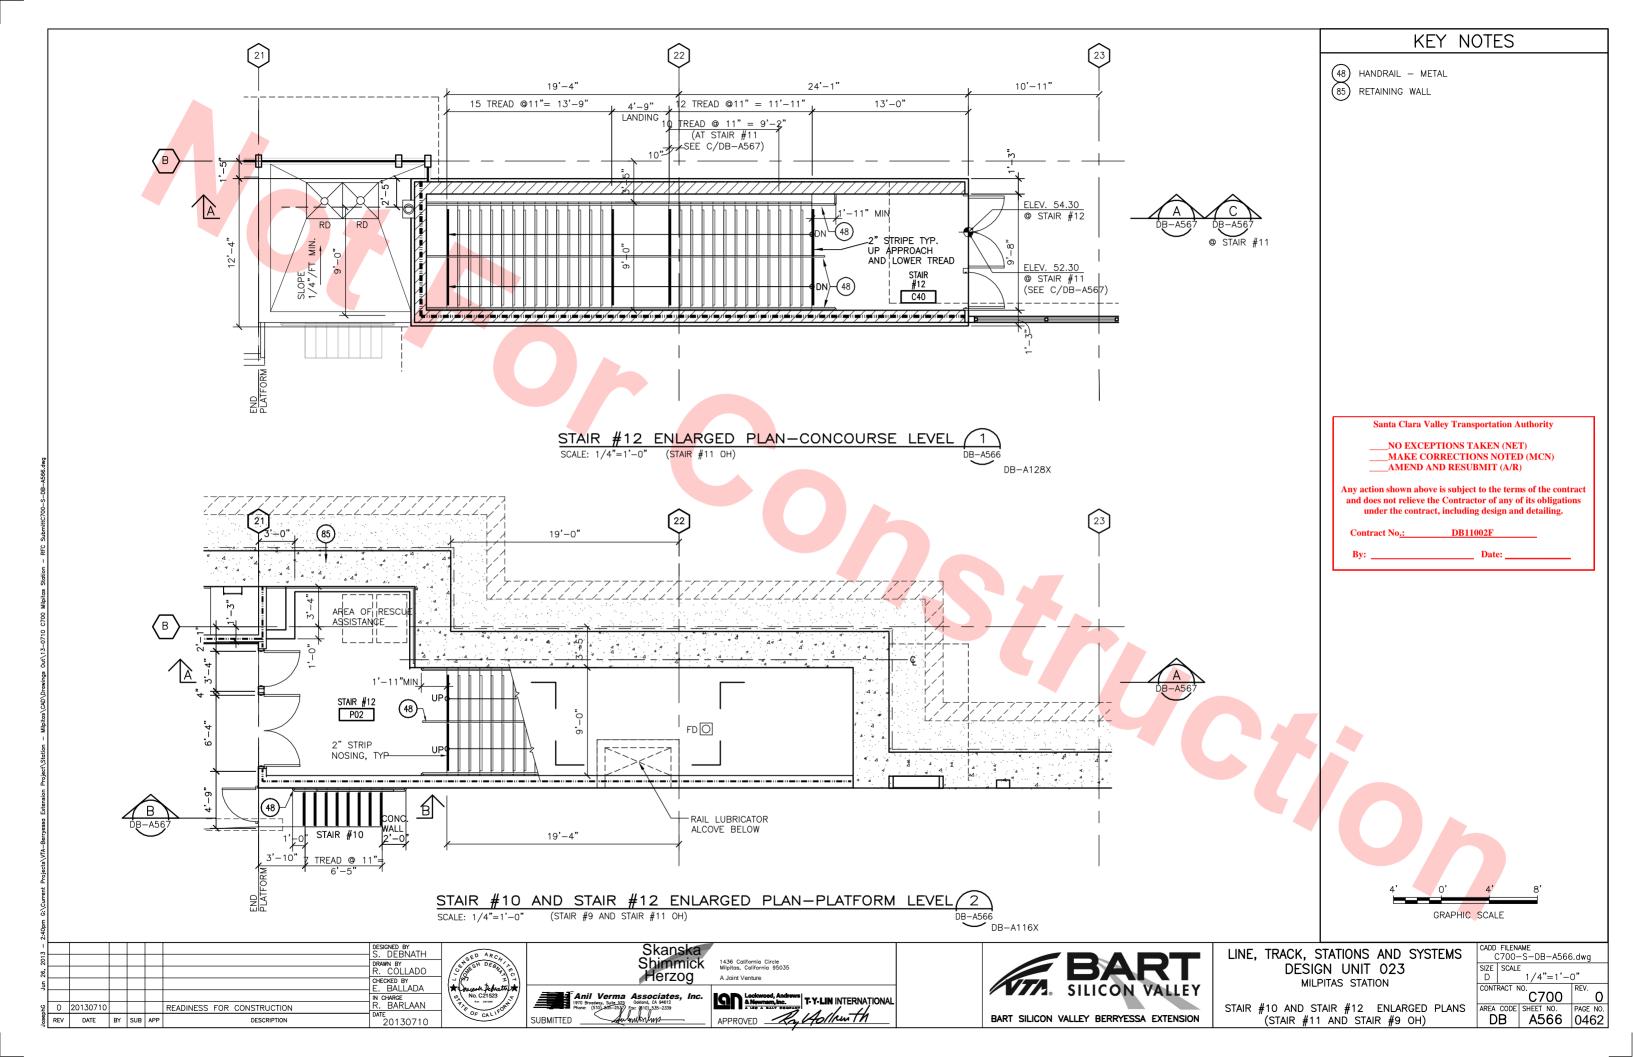

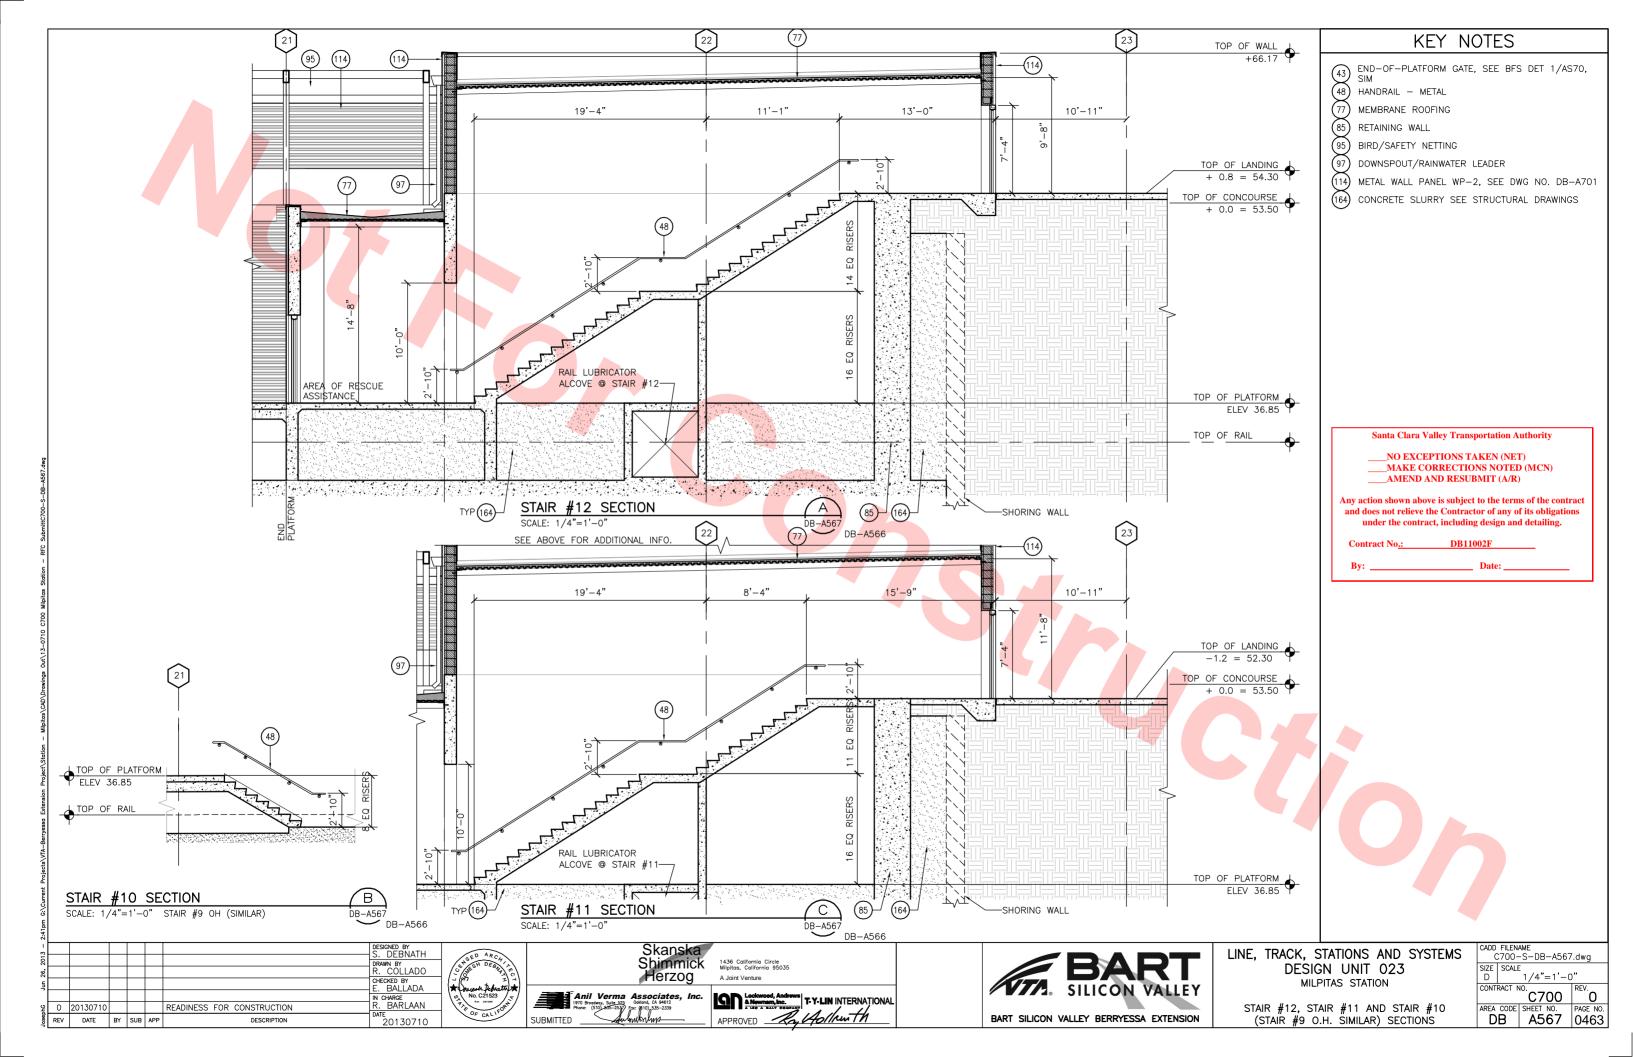

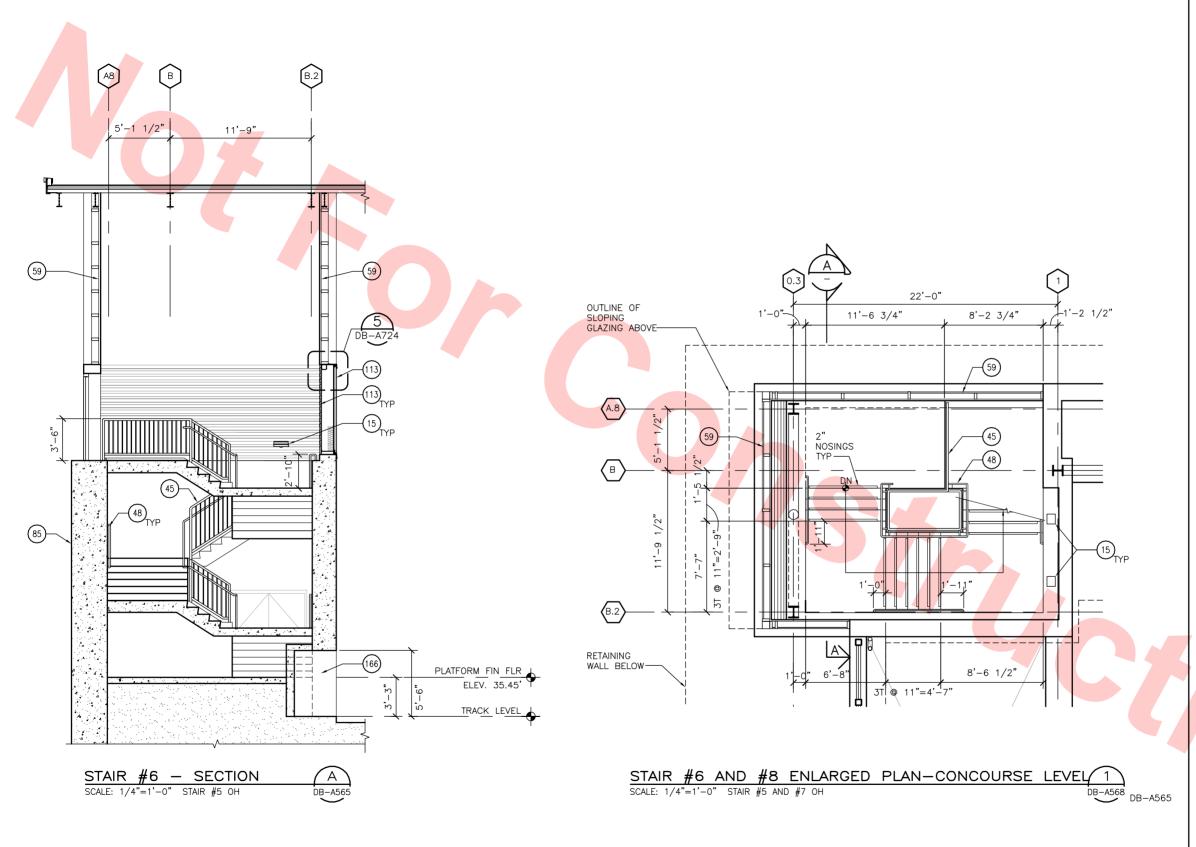

KEY NOTES

LIGHT FIXTURE

GUARDRAIL ASSEMBLY- METAL BFS SHT AD20/AS21

HANDRAIL METAL- BFS SHT AD21 AND AS20

59 81 GLASS WALL SYSTEM TYPE 3

COMPOSITE WALL PANEL WP-1, SEE DWG. NO. DB-A701

RETAINING WALL

113 COMPOSITE WALL PANEL WP-2, SEE DWG. NO. DB-A701

RAIL LUBRICATOR ALCOVE

Santa Clara Valley Transportation Authority

___NO EXCEPTIONS TAKEN (NET)
__MAKE CORRECTIONS NOTED (MCN) _AMEND AND RESUBMIT (A/R)

Any action shown above is subject to the terms of the contract and does not relieve the Contractor of any of its obligations under the contract, including design and detailing.


DB11002F

GRAPHIC SCALE

DESIGNED BY S. DEBNATH RAWN BY CHECKED BY E. BALLADA CHARGE . BARLAAN Q 0 20130710 READINESS FOR CONSTRUCTION
REVENUE BY SUB APP DESCRIPTION 20130430





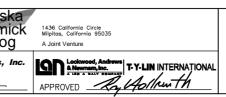






LINE, TRACK, STATIONS AND SYSTEMS DESIGN UNIT 023 MILPITAS STATION STAIR #6 ENLARGED PLANS AND SECTION


STAIR #5 OH SIMILAR

C700-S-DB-A568.dwg							
SIZE	SCALE	1/4"=1	,_(ດ"			
CONT	CONTRACT NO. C700				0		
AREA D	CODE	SHEET NO. A568	3	PAGE 04 6	NO. 64		

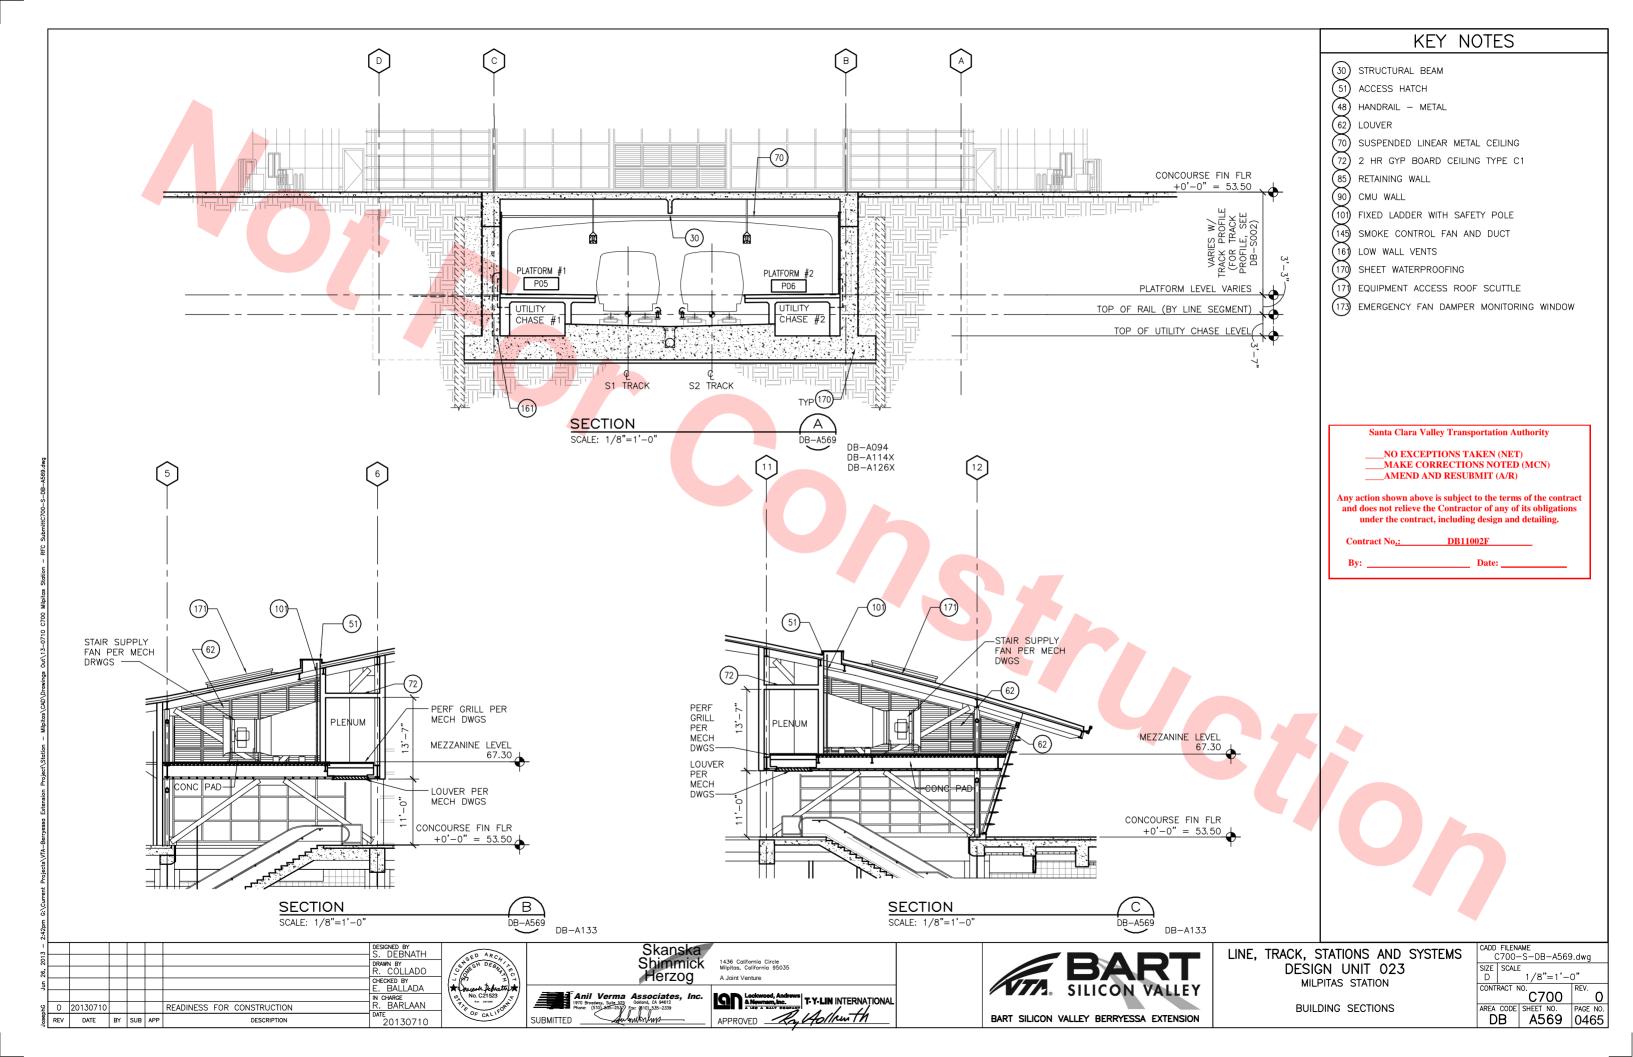

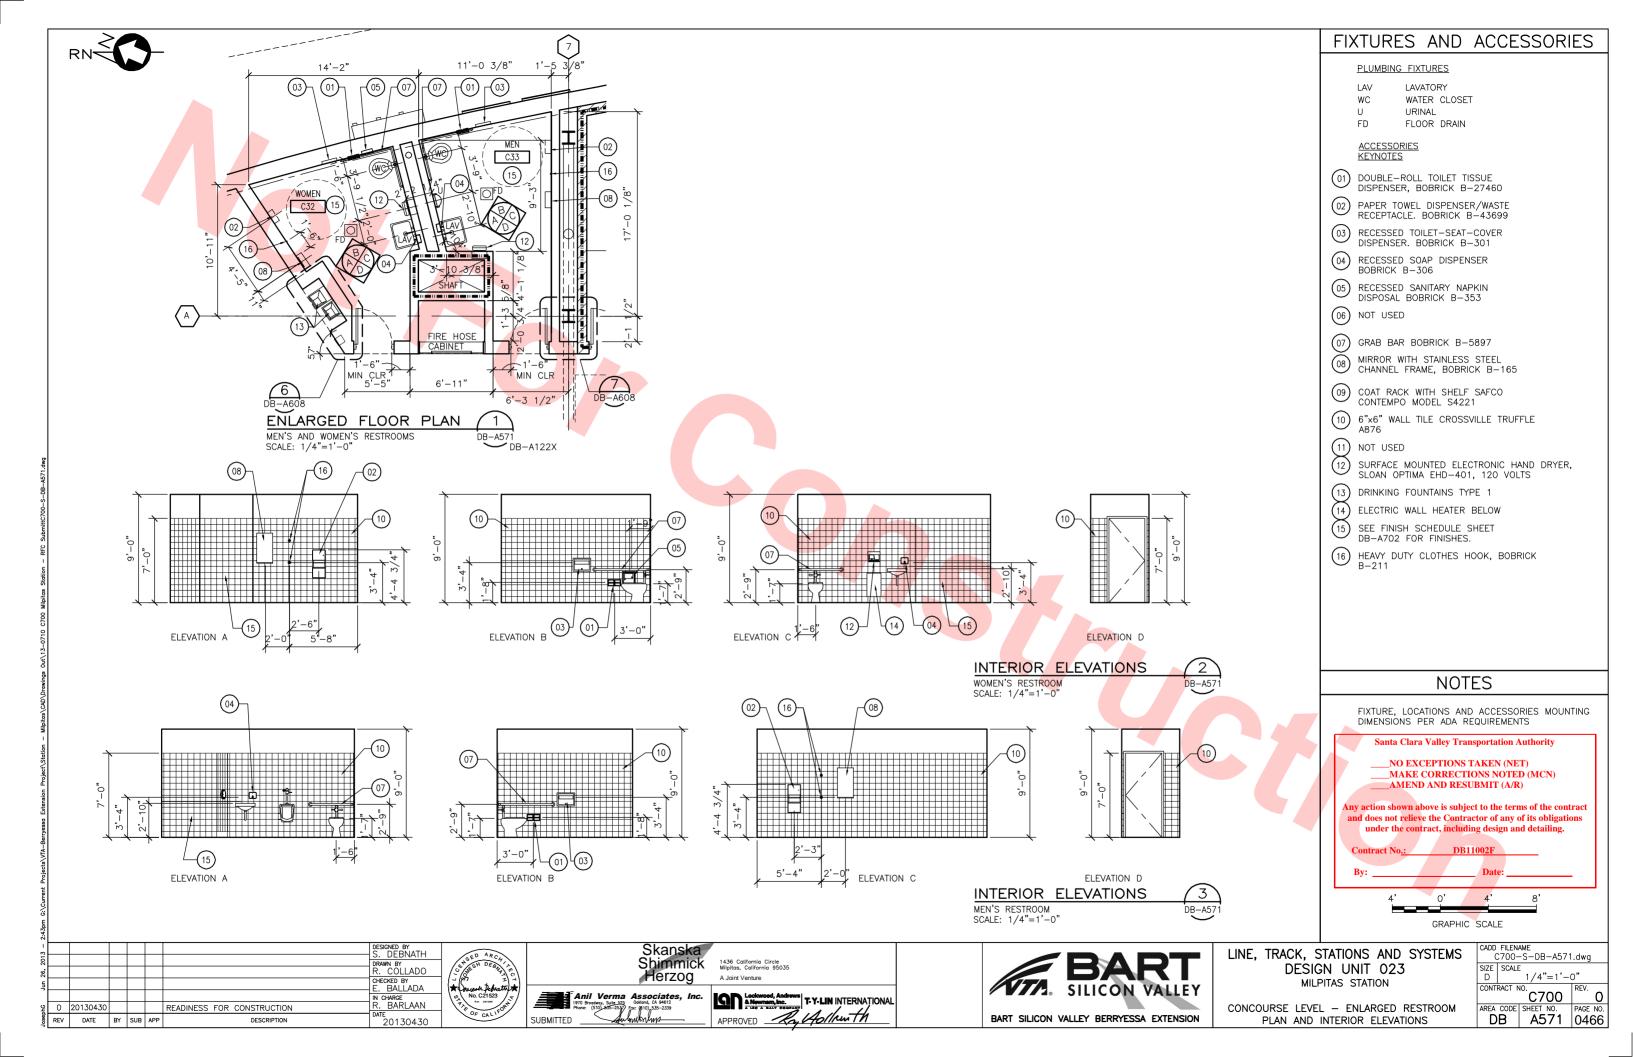


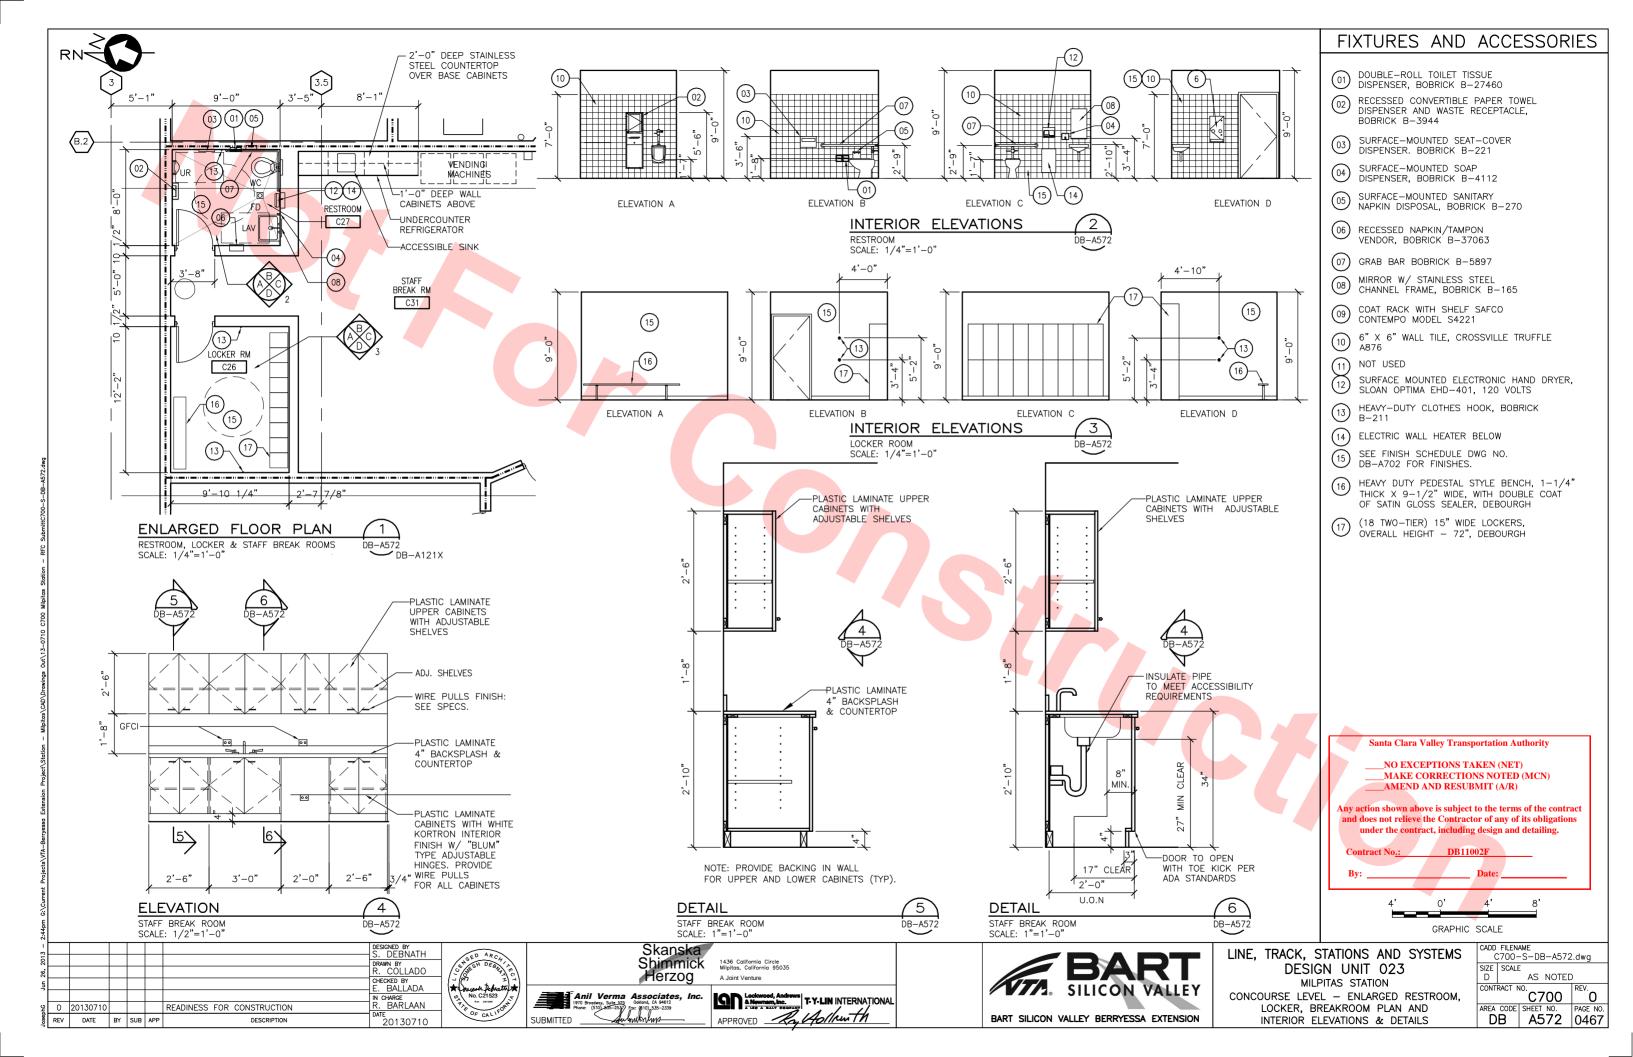


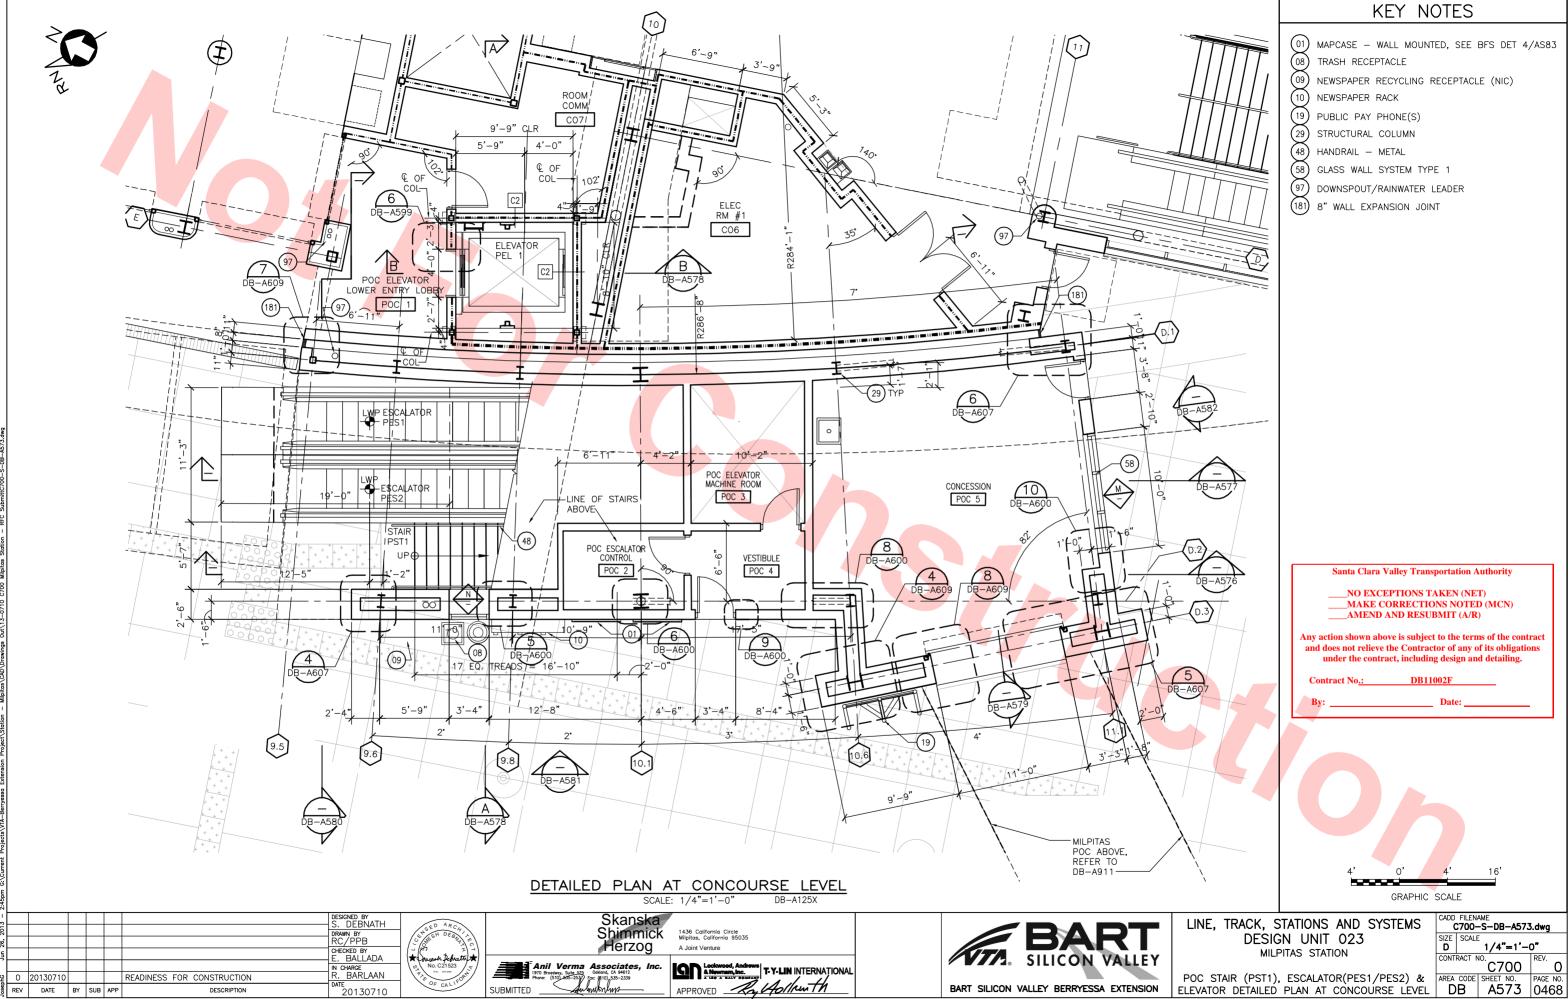



20130710


CADD FILENAME
C700—S—DB—A573.dwg

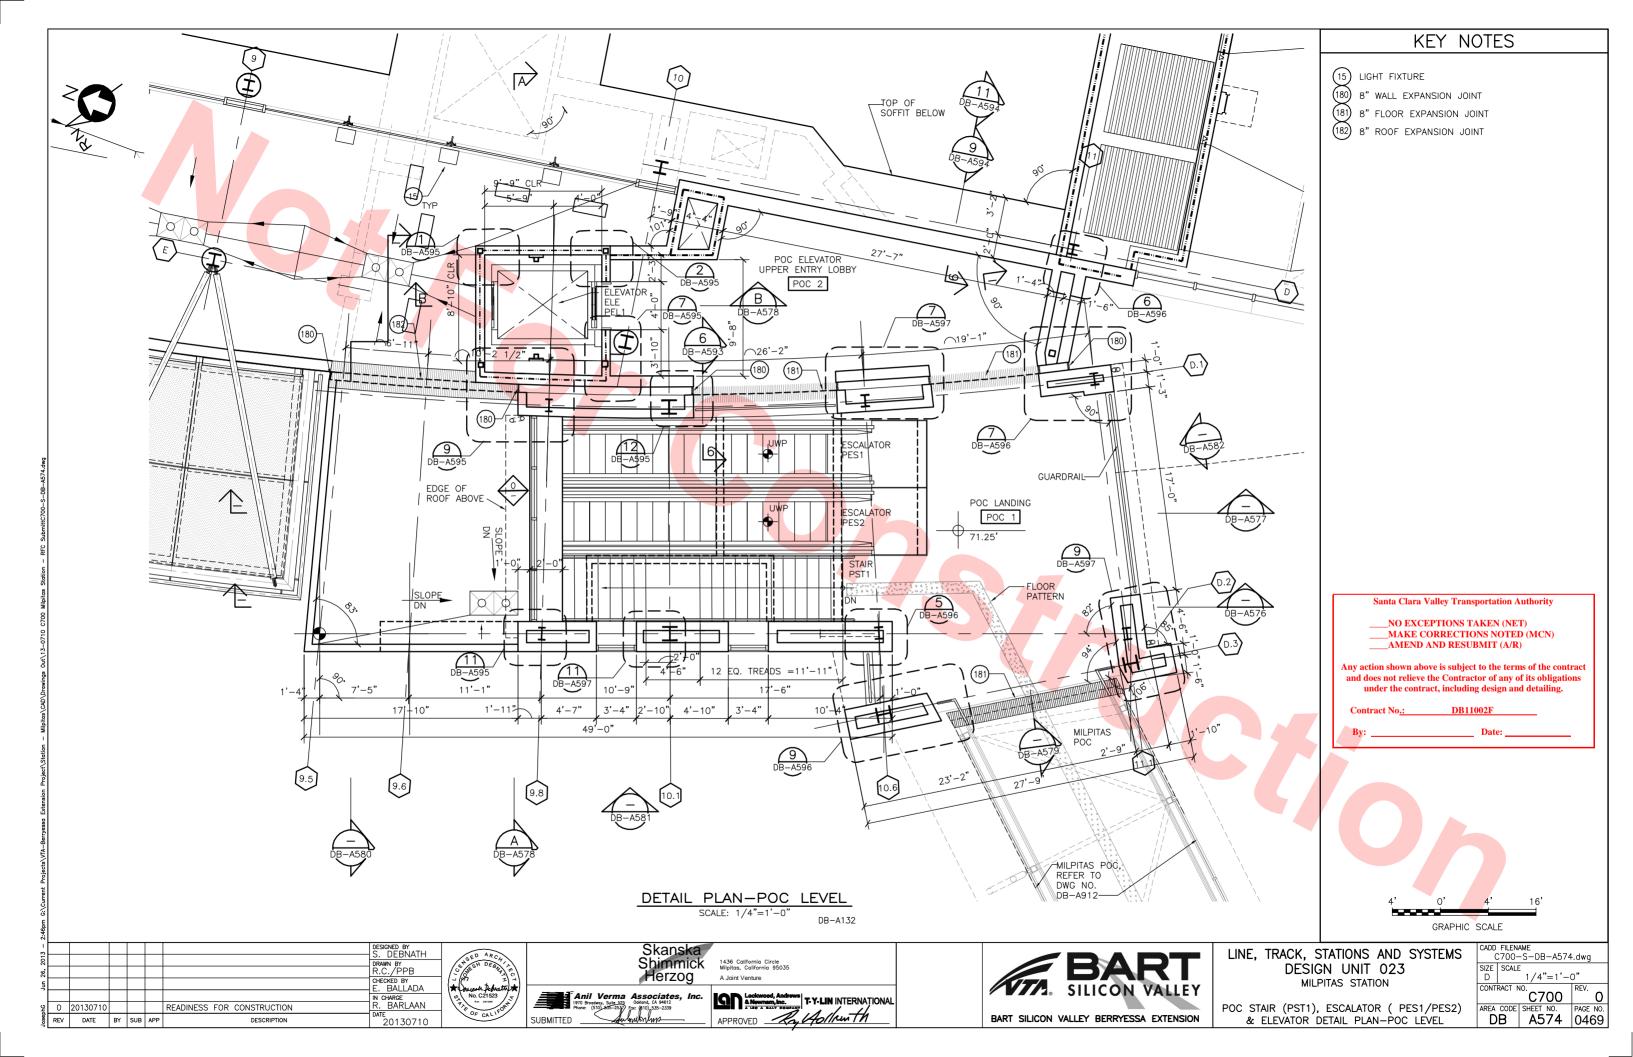


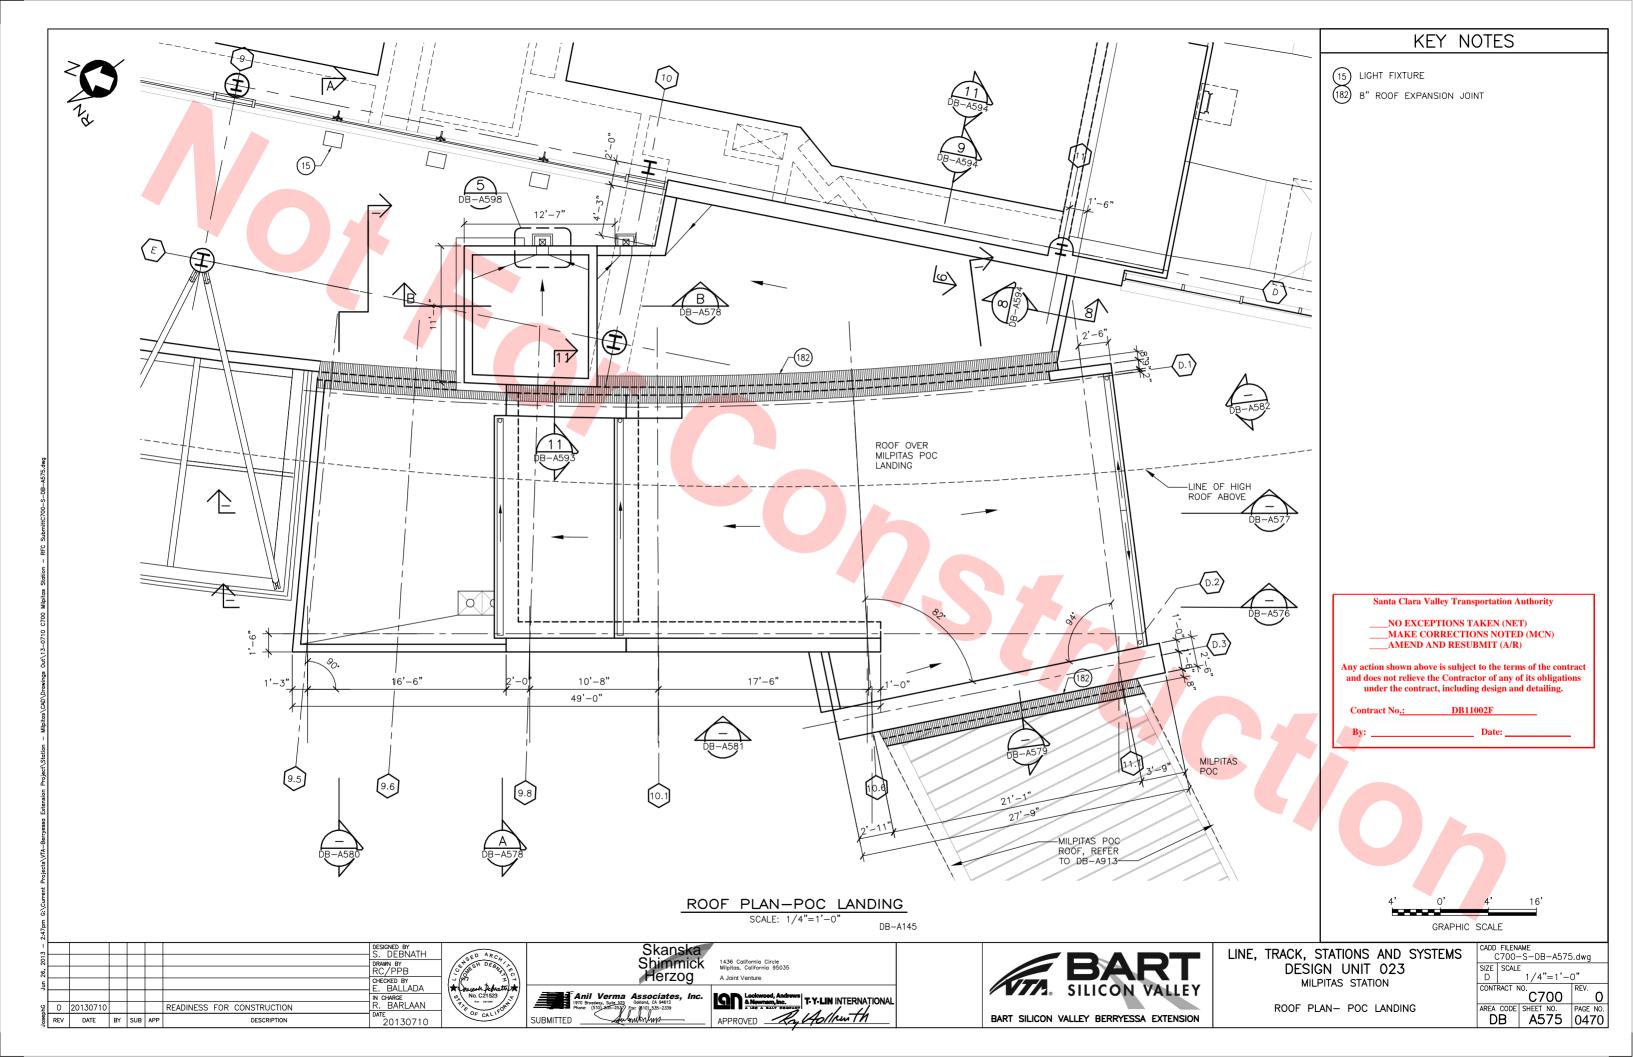

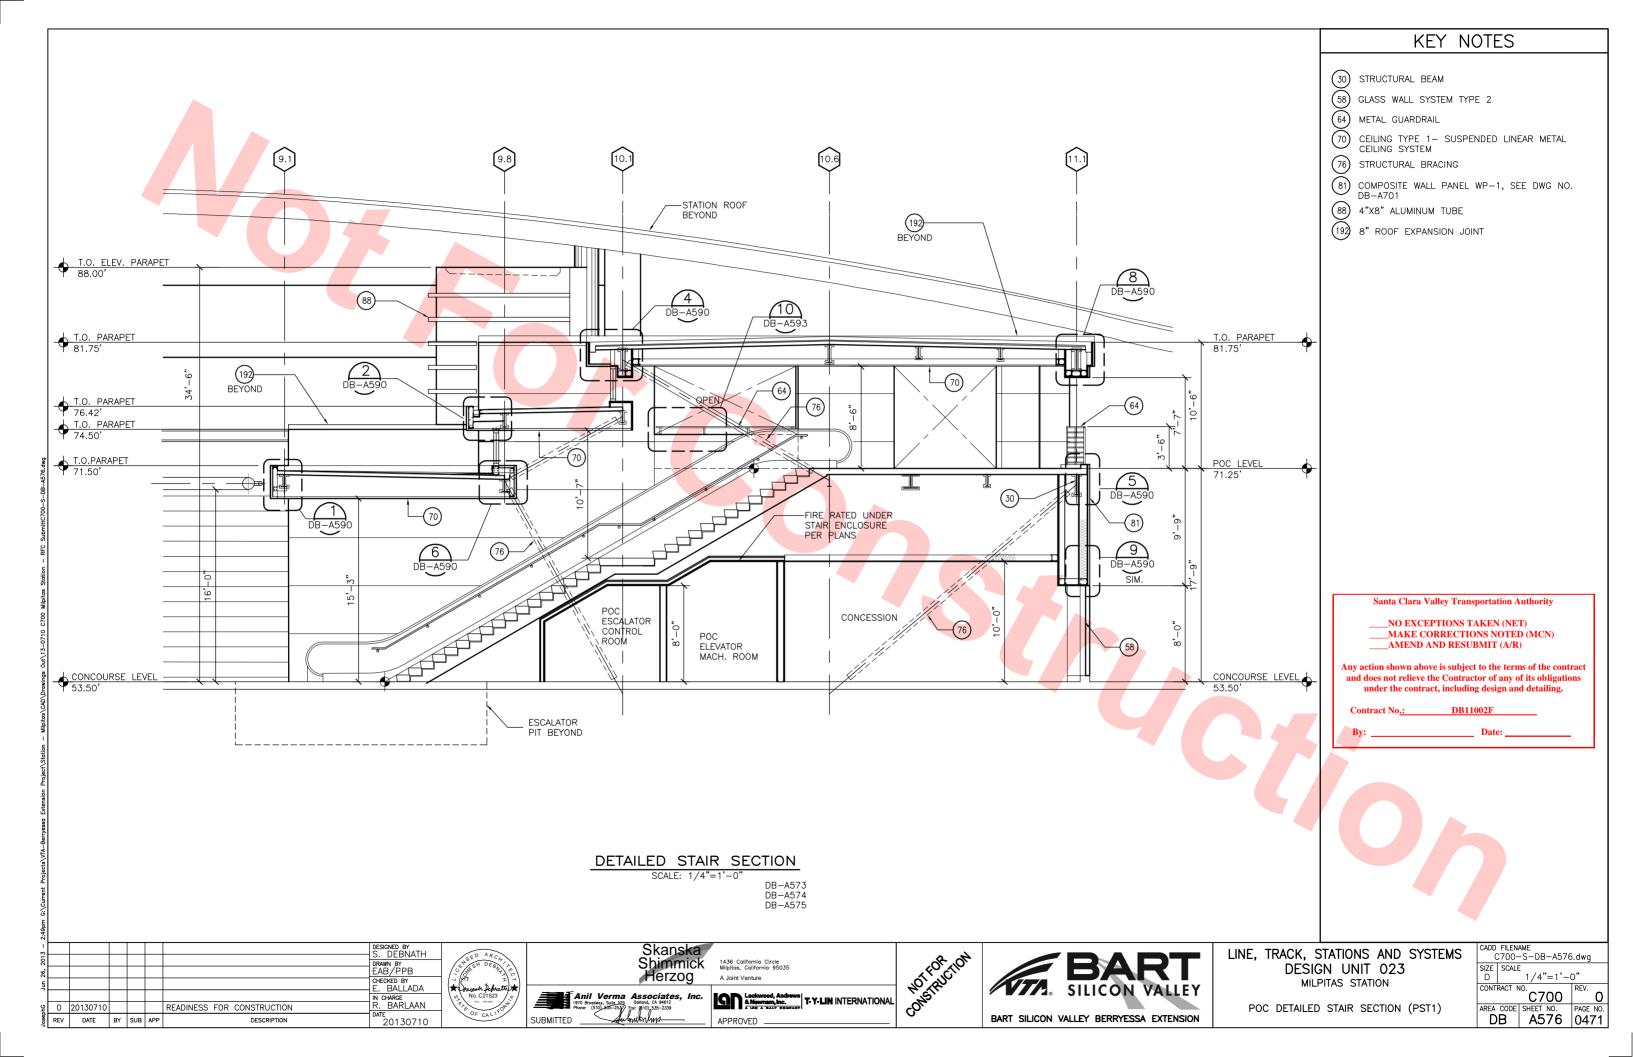

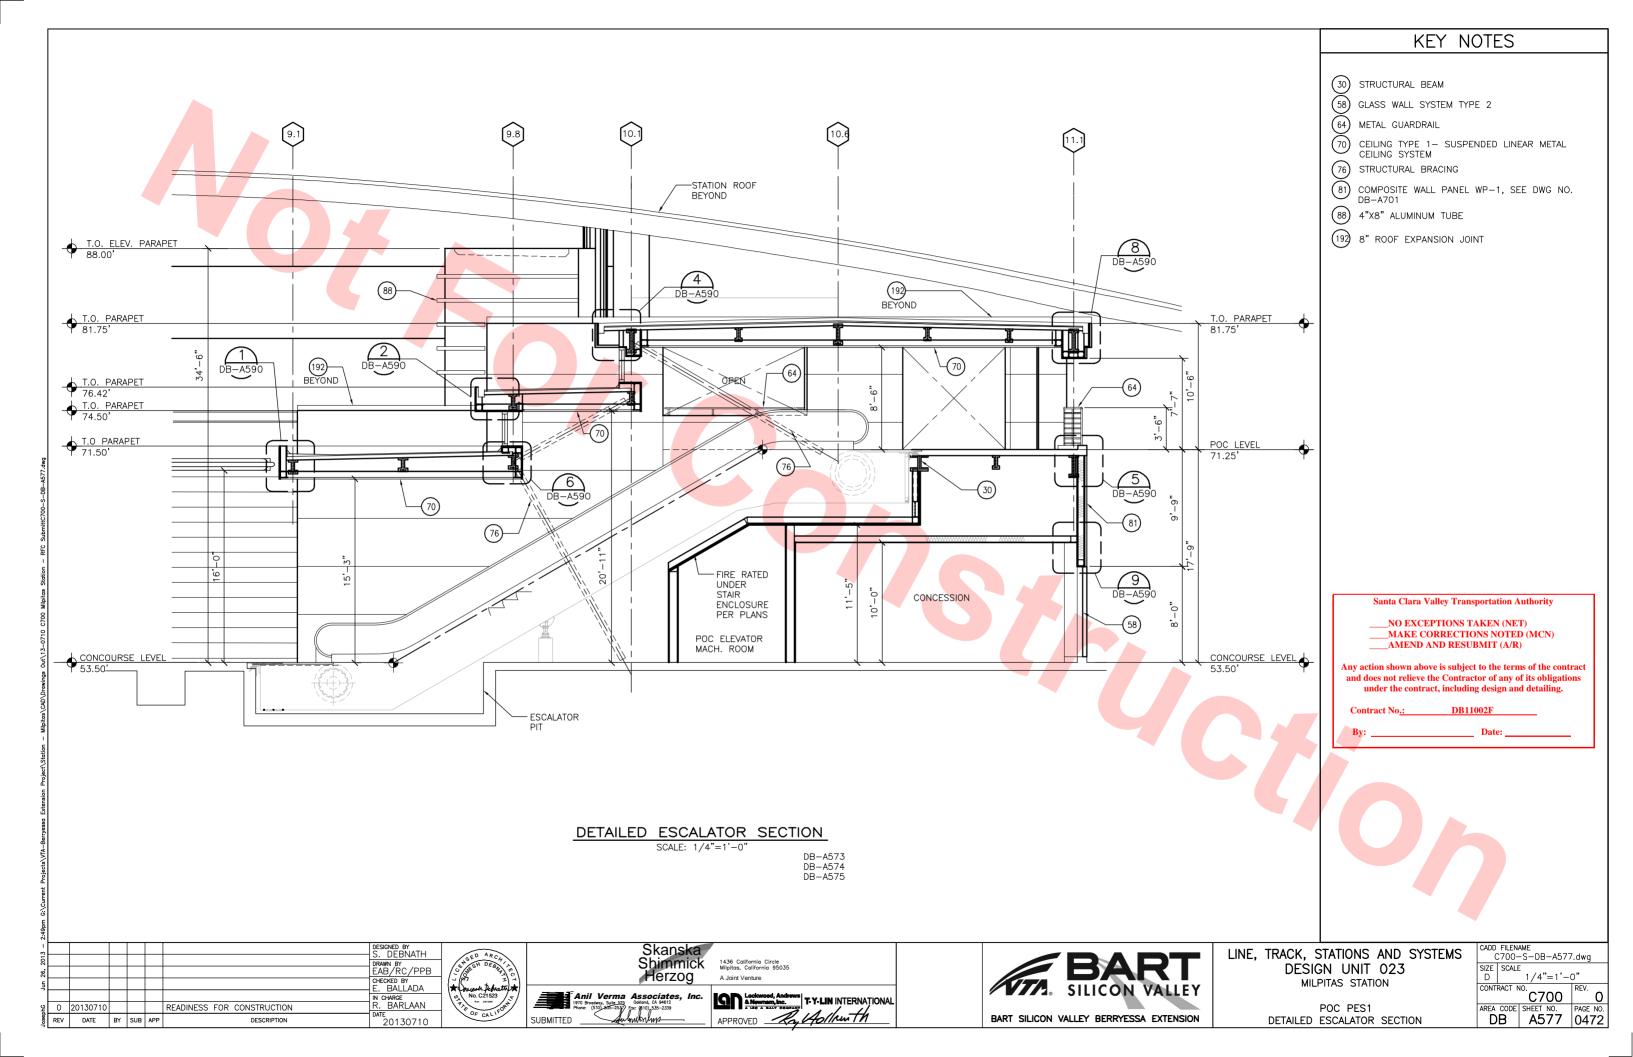

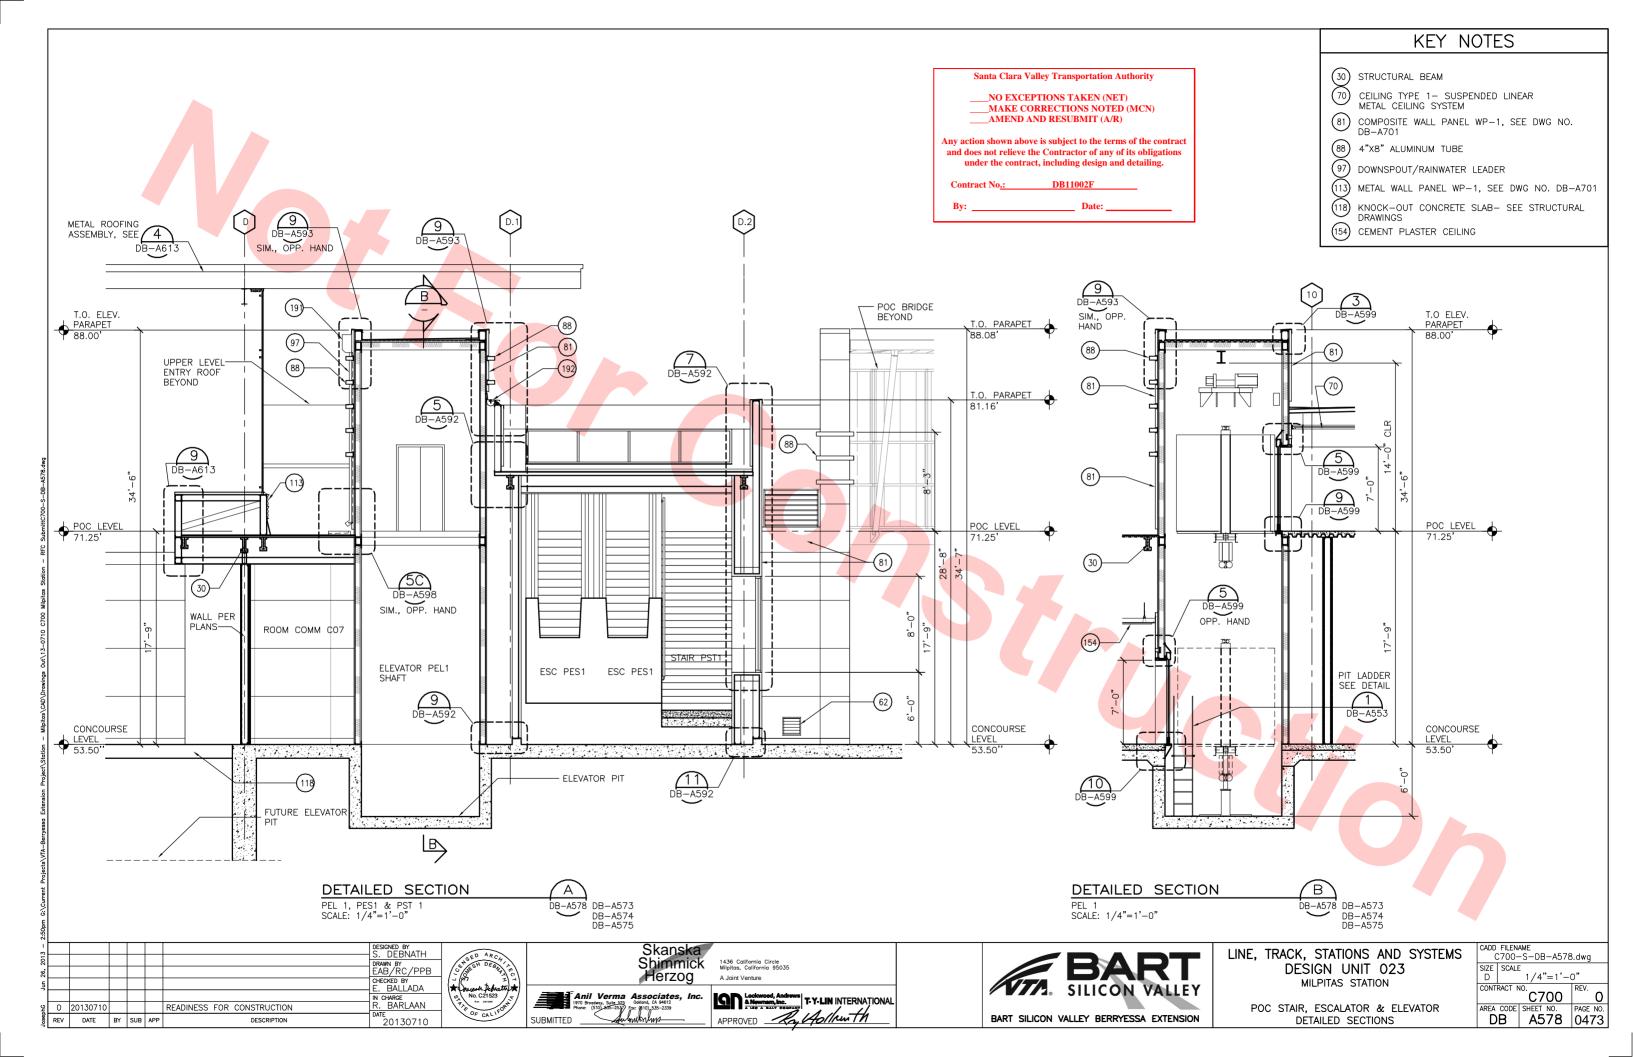

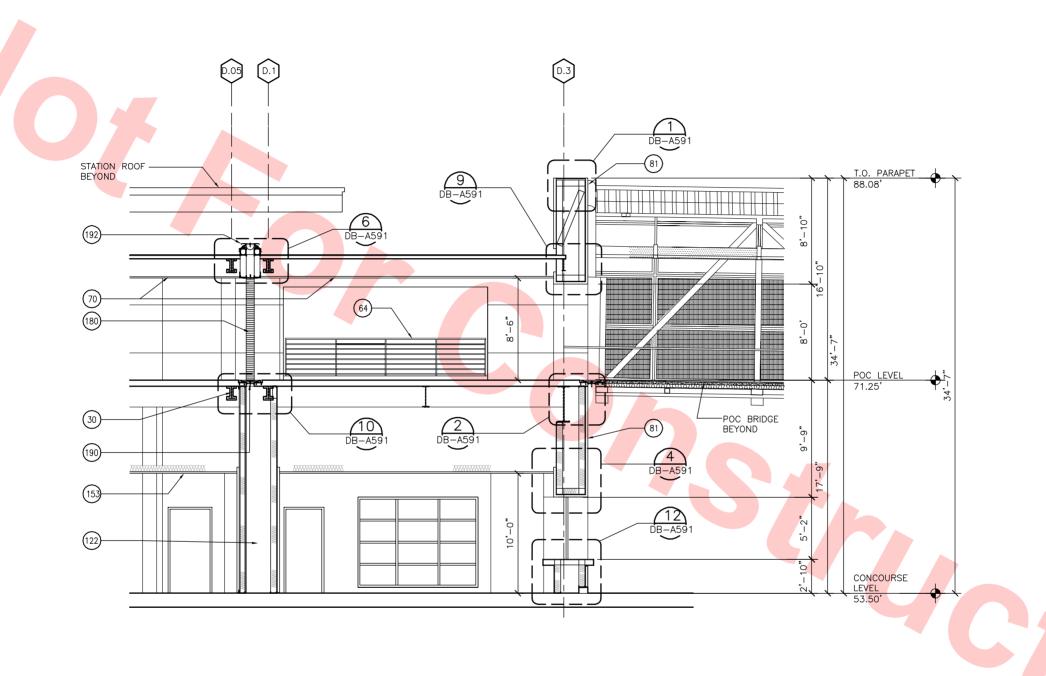

KEY NOTES

(30) STRUCTURAL BEAM

64) METAL GUARDRAIL

70 CEILING TYPE 1— SUSPENDED LINEAR METAL CEILING SYSTEM

(81) COMPOSITE WALL PANEL WP-1, SEE DWG DB A-701

(122) SHAFT

153) CEILING TYPE 2- SUSPENDED 24"x60" METAL PLANK CEILING SYSTEM

(180) 8" WALL EXPANSION JOINT COVER

(190) 8" FLOOR EXPANSION JOINT

(192) 8" ROOF EXPANSION JOINT

Santa Clara Valley Transportation Authority

___NO EXCEPTIONS TAKEN (NET) ___MAKE CORRECTIONS NOTED (MCN) AMEND AND RESUBMIT (A/R)

Any action shown above is subject to the terms of the contract and does not relieve the Contractor of any of its obligations under the contract, including design and detailing.

DETAILED SECTION SCALE: 1/4"=1'-0"

DB-A574 DB-A575

DESIGNED BY S. DEBNATH DRAWN BY EAB/RC/PPB CHECKED BY E. BALLADA CHARGE . BARLAAN 2 0 20130710 READINESS FOR CONSTRUCTION
8 REV DATE BY SUB APP DESCRIPTION 20130710








LINE, TRACK, STATIONS AND SYSTEM DESIGN UNIT 023 MILPITAS STATION

POC DETAILED SECTION

MS	CADD FILENAME C700-S-DB-A579.dwg					
	SIZE D	SCALE	1/4"=1'-	-0"		
	CONT	RACT N	^{10.} C700	REV. O		
			SHEET NO.	PAGE NO.		
	D	В	A579	0474		

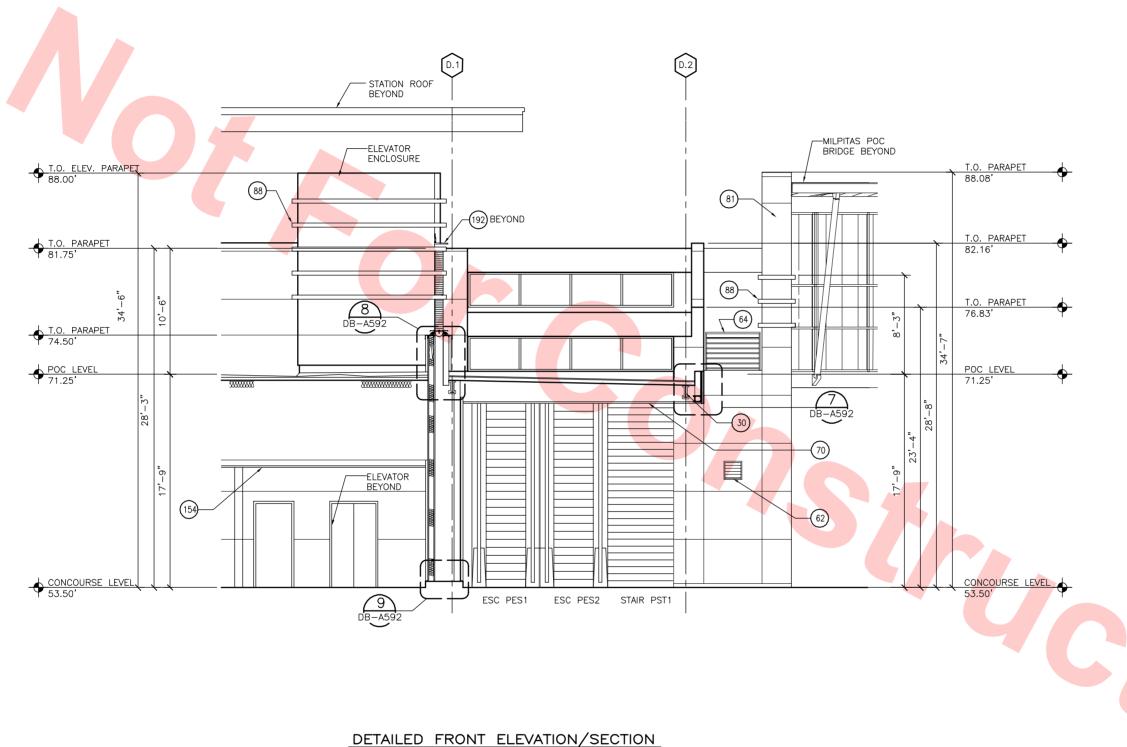

SCALE: 1/4"=1'-0"

DB-A573 DB-A574 DB-A574

LINE, TRACK, STATIONS AND SYSTEM DESIGN UNIT 023 MILPITAS STATION

POC DETAILED ELEVATION/SECTION DETAILED FRONT ELEVATION/SECTION

GRAPHIC SCALE							
STEMS	CADD FILENAME C700-S-DB-A580.dwg						
	SIZE D	SCALE	1/4"=	1'-0	o"		
N	C700 REV.						
ON		CODE B	SHEET NO		PAGE 04 7	ΝC 7 5	

KEY NOTES

CEILING TYPE 1- SUSPENDED LINEAR METAL CEILING SYSTEM

(81) COMPOSITE WALL PANEL WP-1, SEE DWG NO. DB-A701

Santa Clara Valley Transportation Authority ___NO EXCEPTIONS TAKEN (NET) ___MAKE CORRECTIONS NOTED (MCN) AMEND AND RESUBMIT (A/R)

Any action shown above is subject to the terms of the contract and does not relieve the Contractor of any of its obligations under the contract, including design and detailing.

30) STRUCTURAL BEAM
62) LOUVER

(64) METAL GUARDRAIL

(88) 4"X8" ALUMINUM TUBE (154) CEMENT PLASTER CEILING (192) 8" ROOF EXPANSION JOINT

DESIGNED BY S. DEBNATH CHECKED BY E. BALLADA CHARGE BARLAAN

RAWN BY

20130710

Q 0 20130710 READINESS FOR CONSTRUCTION
REV DATE BY SUB APP DESCRIPTION

Skanska Shimmick 1436 California Circle Milpitas, California 95035 Herzog A Joint Venture Anil Verma Associates, Inc.
1970 Brookey, Sule 525 Ookland, CA 94812
Phone: (\$10).635-2339 Fee: (\$10).535-2339 SUBMITTED


Lockwood, Andrews & Newman, Inc.


& Newman, Inc.


LIST & BALT COMPANY


T-Y-LIN INTERNATIONAL APPROVED By Hollanth


BART SILICON VALLEY BERRYESSA EXTENSION

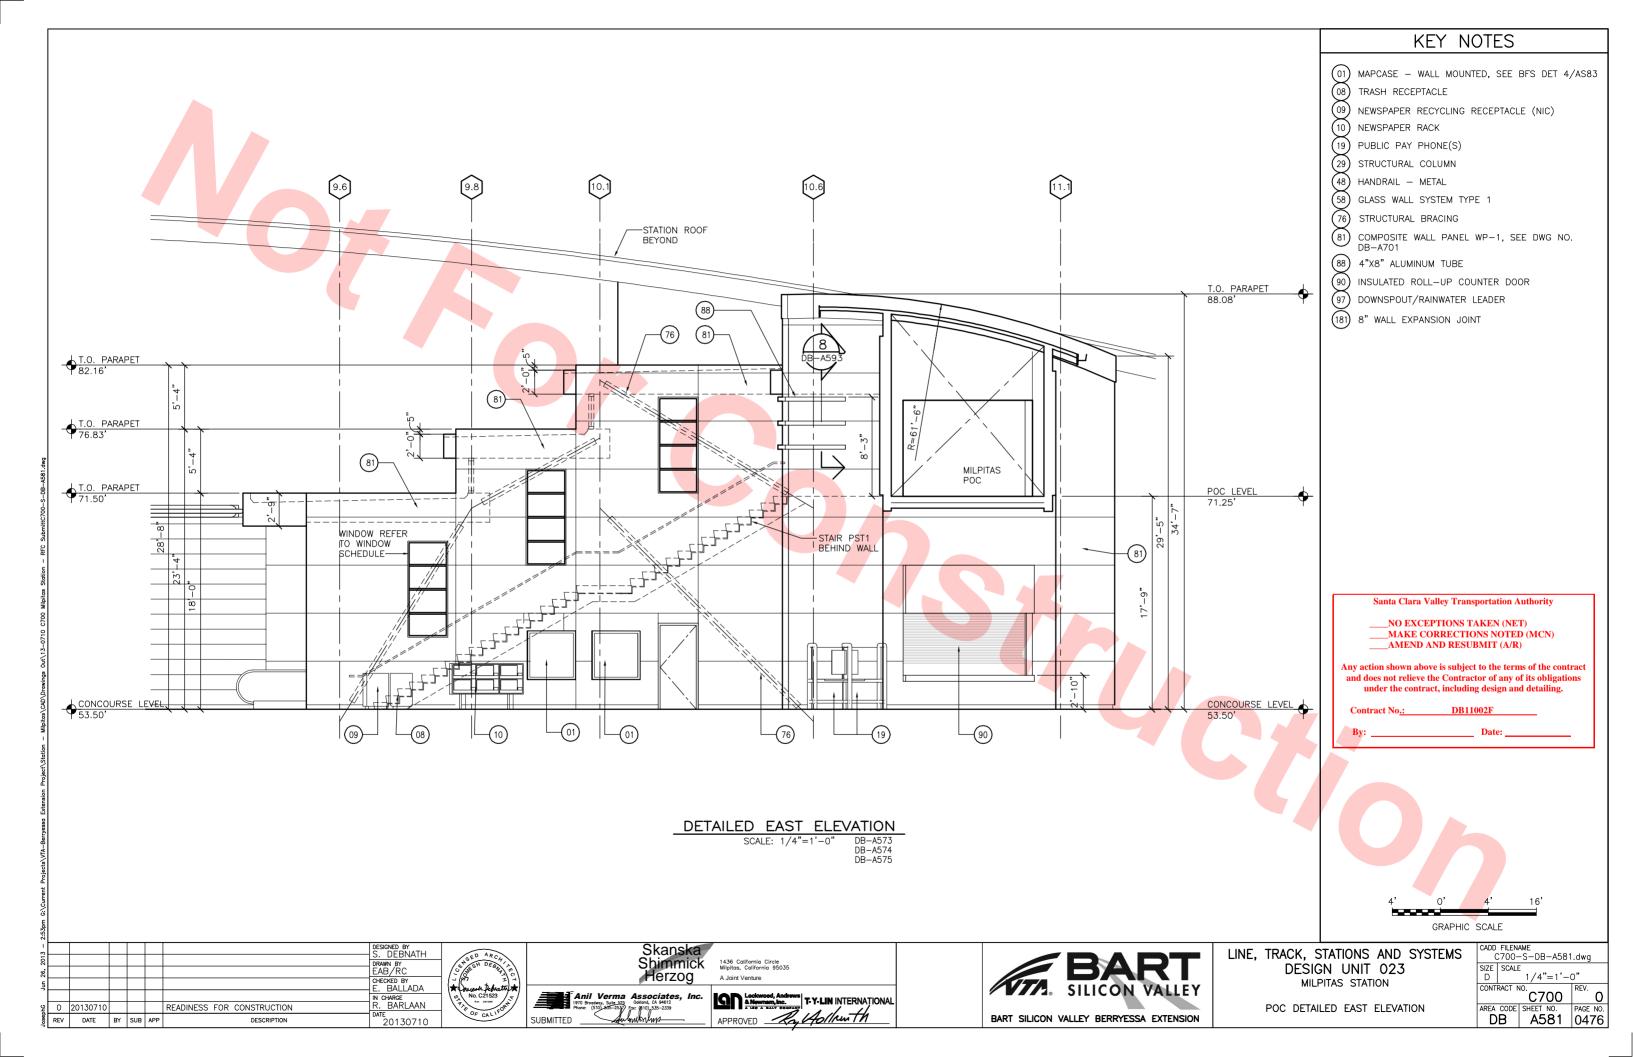


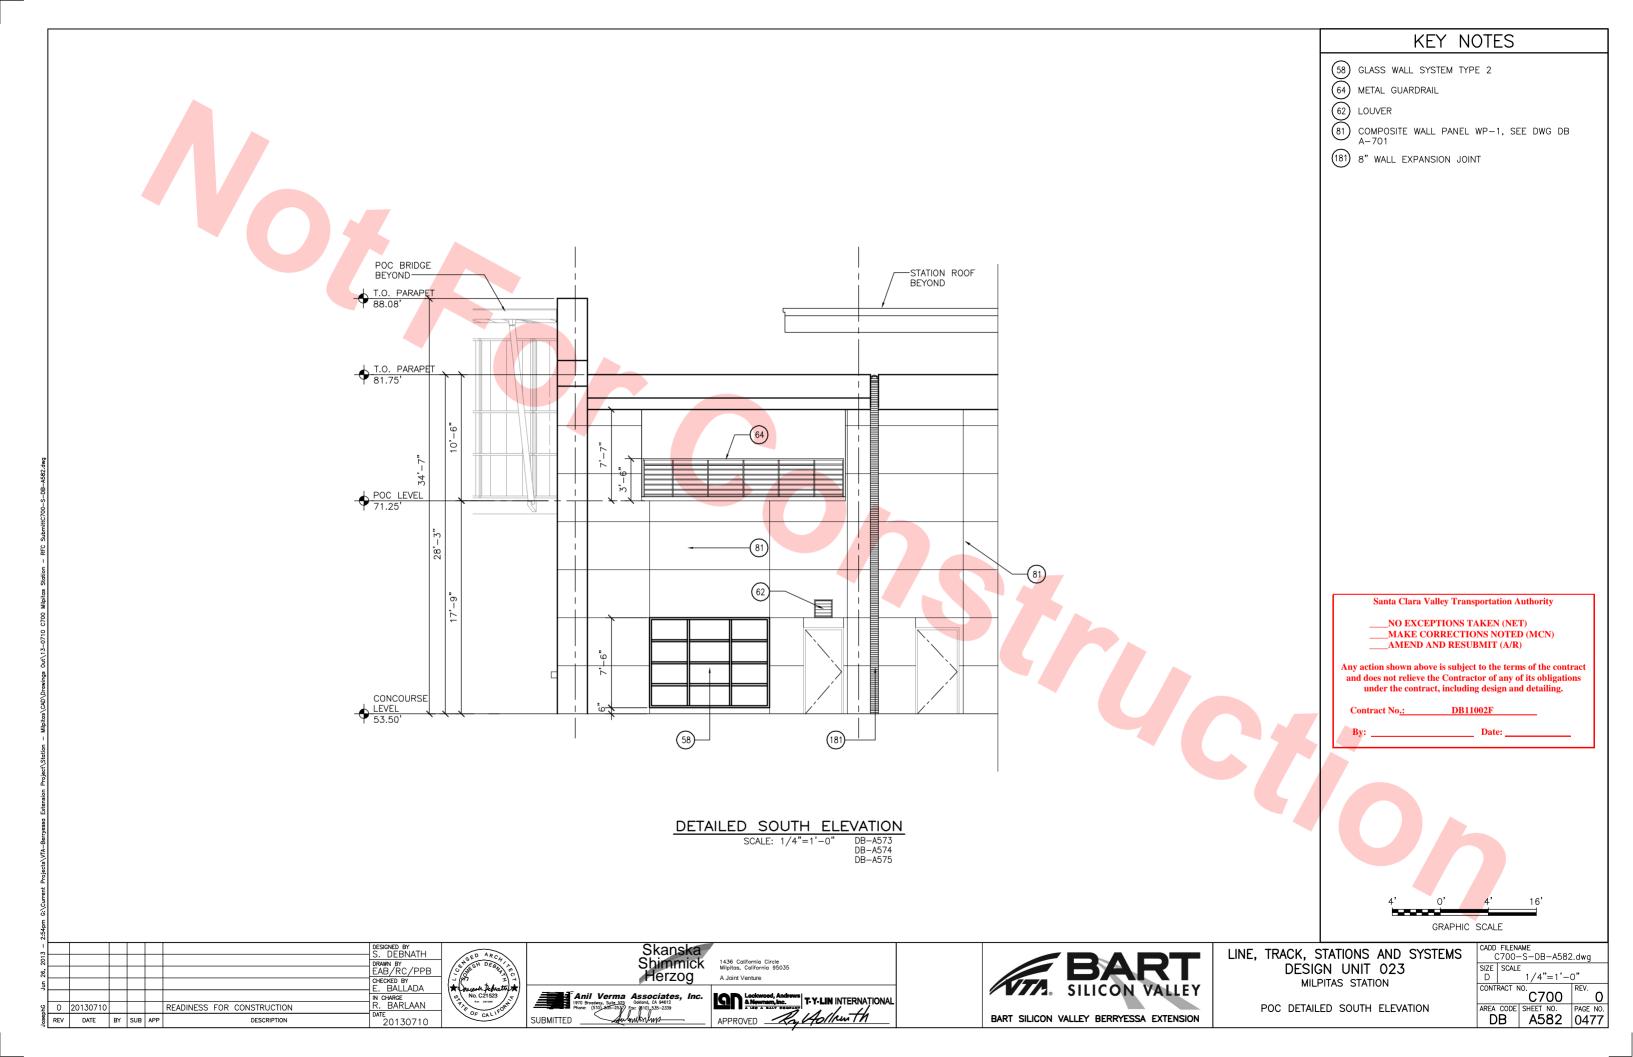


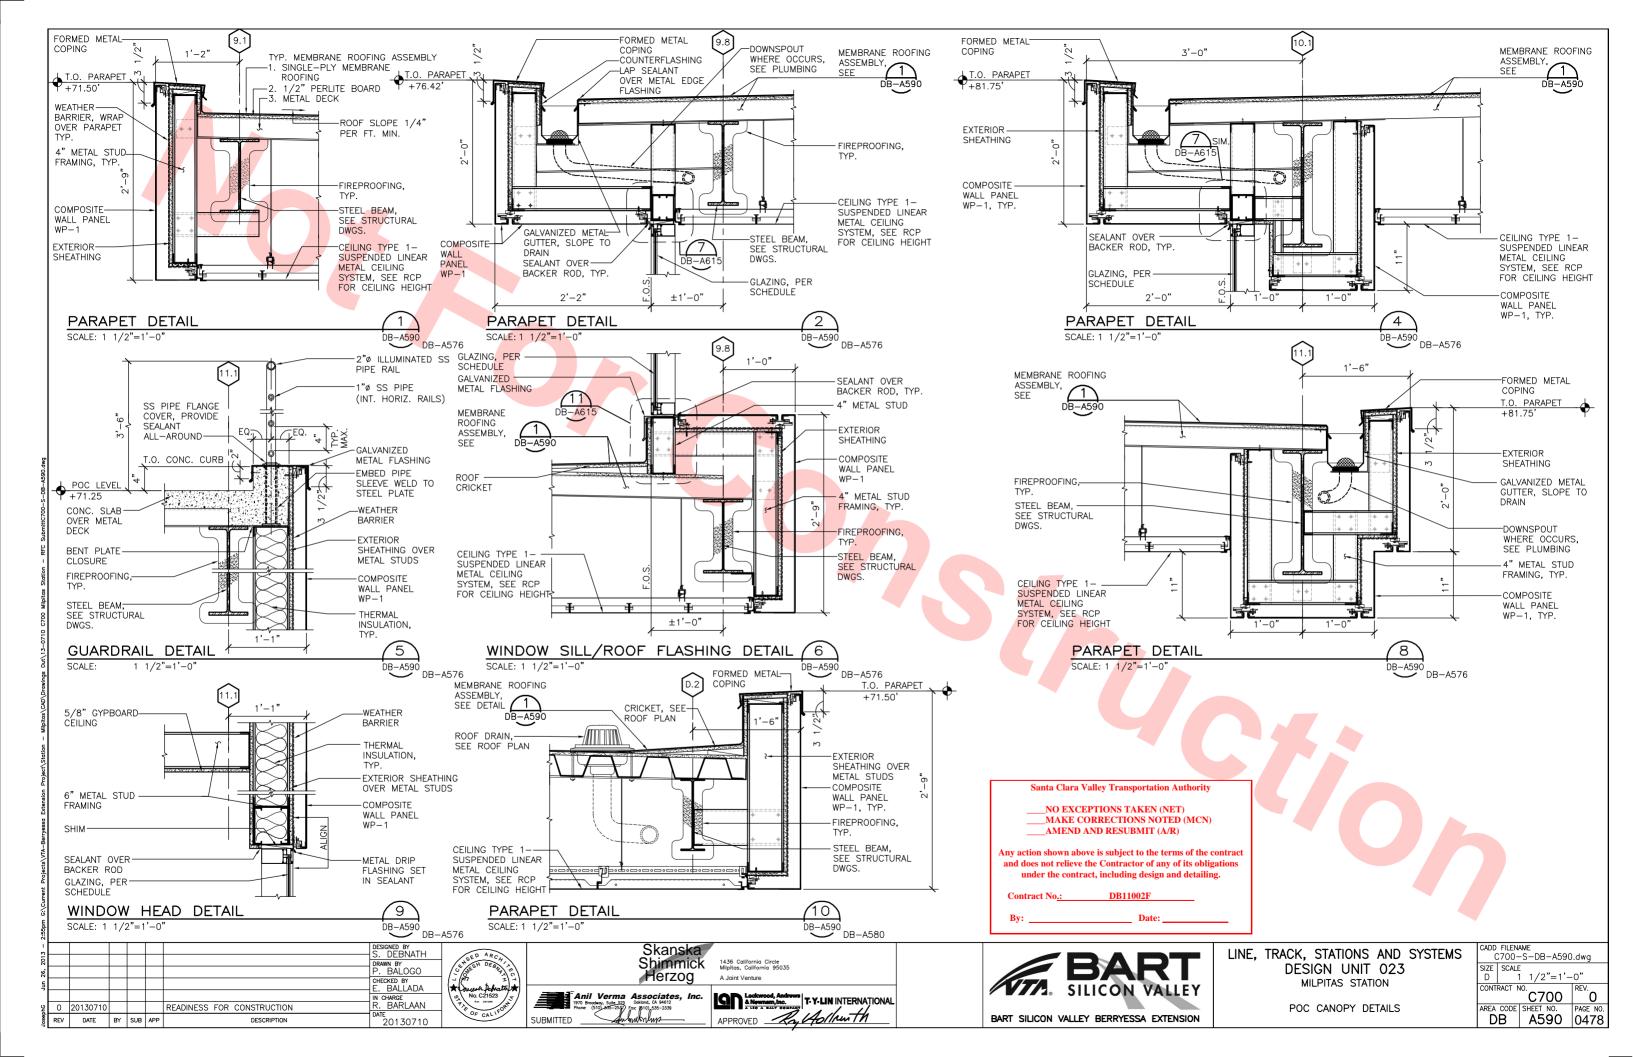


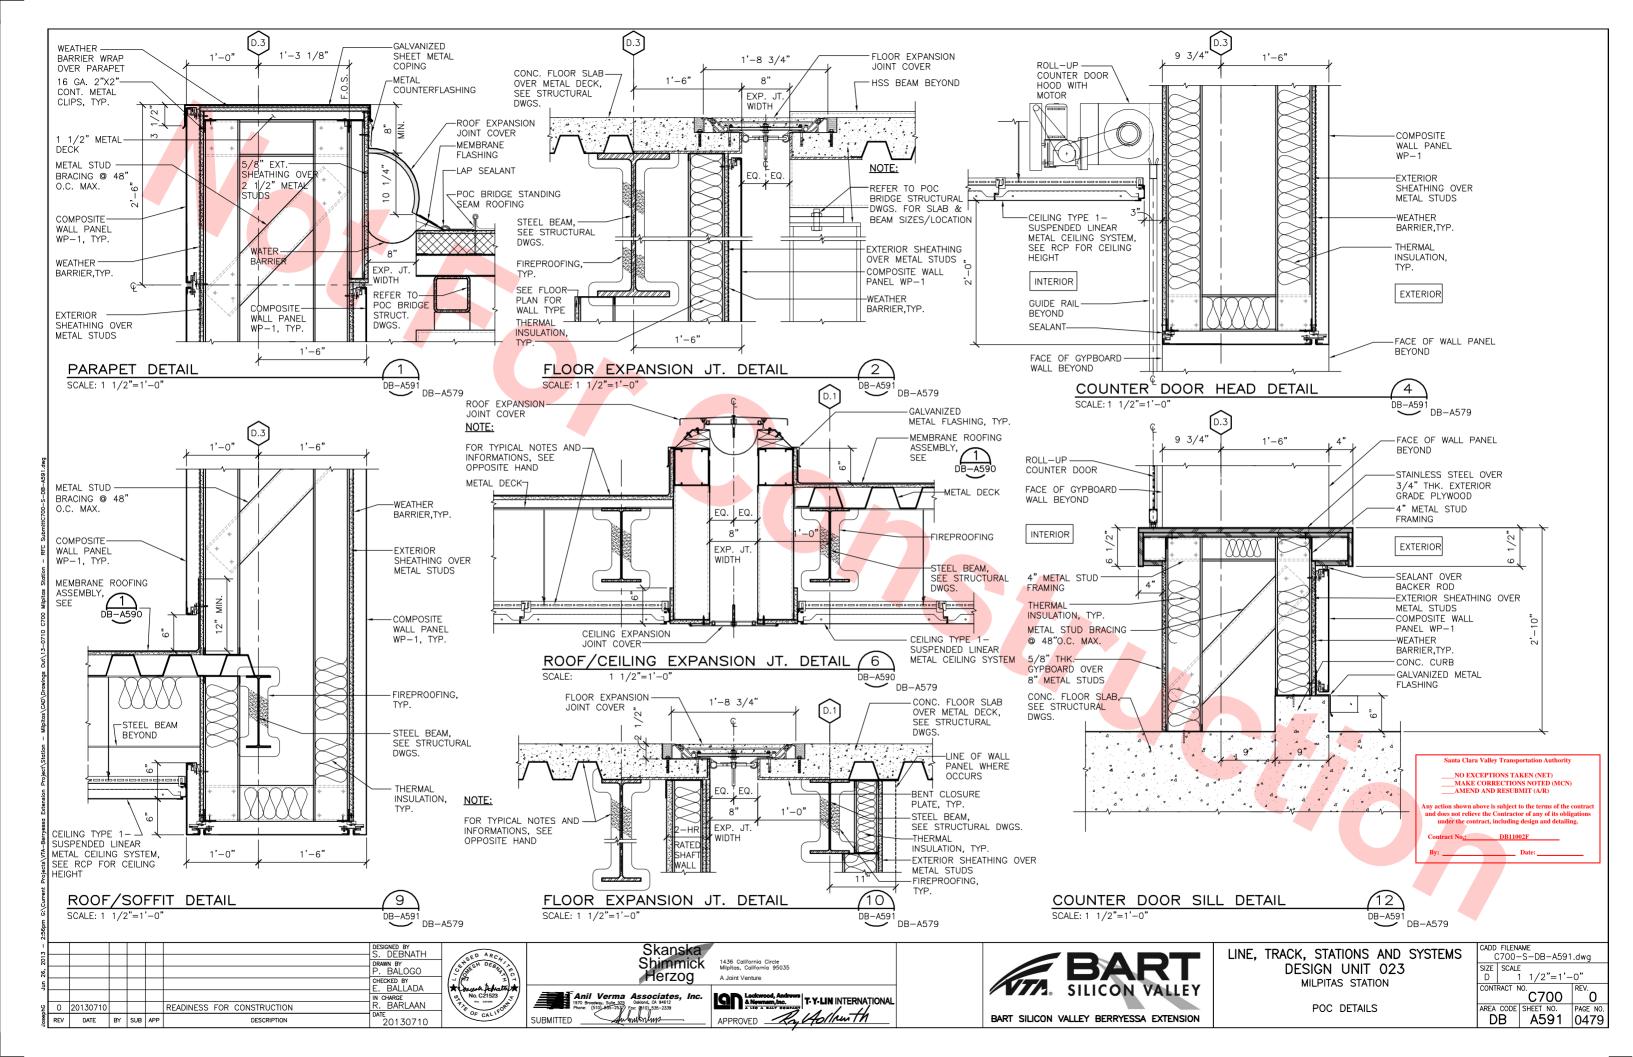


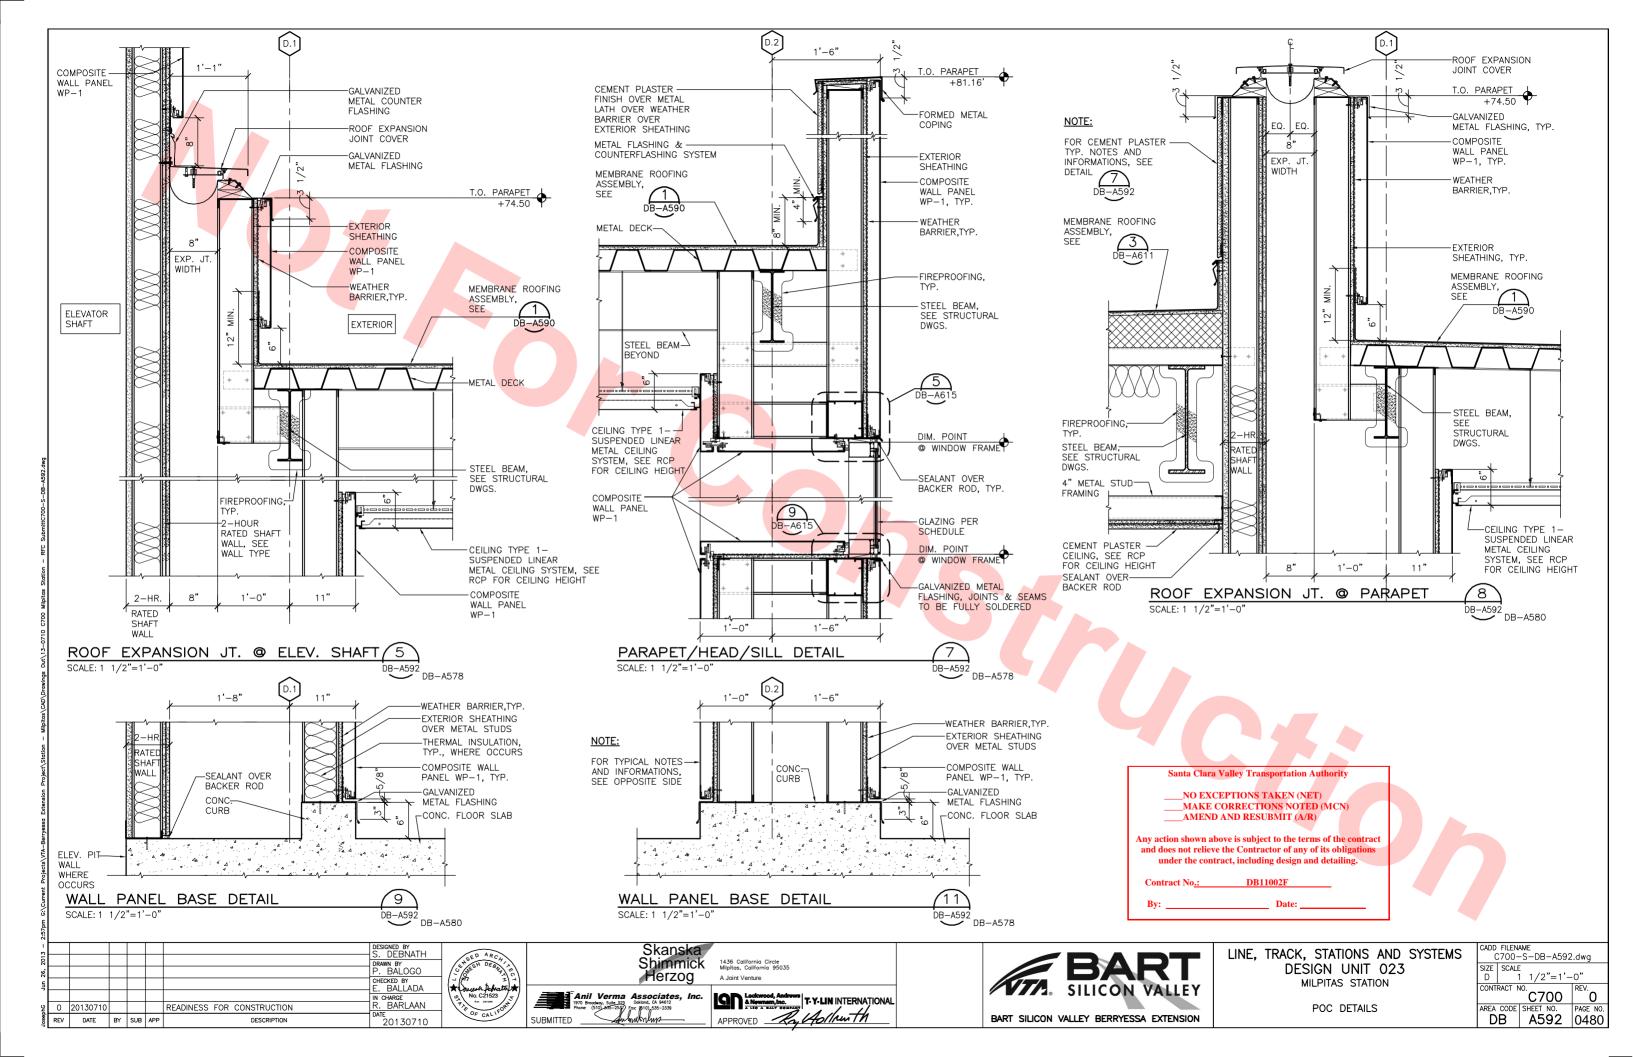


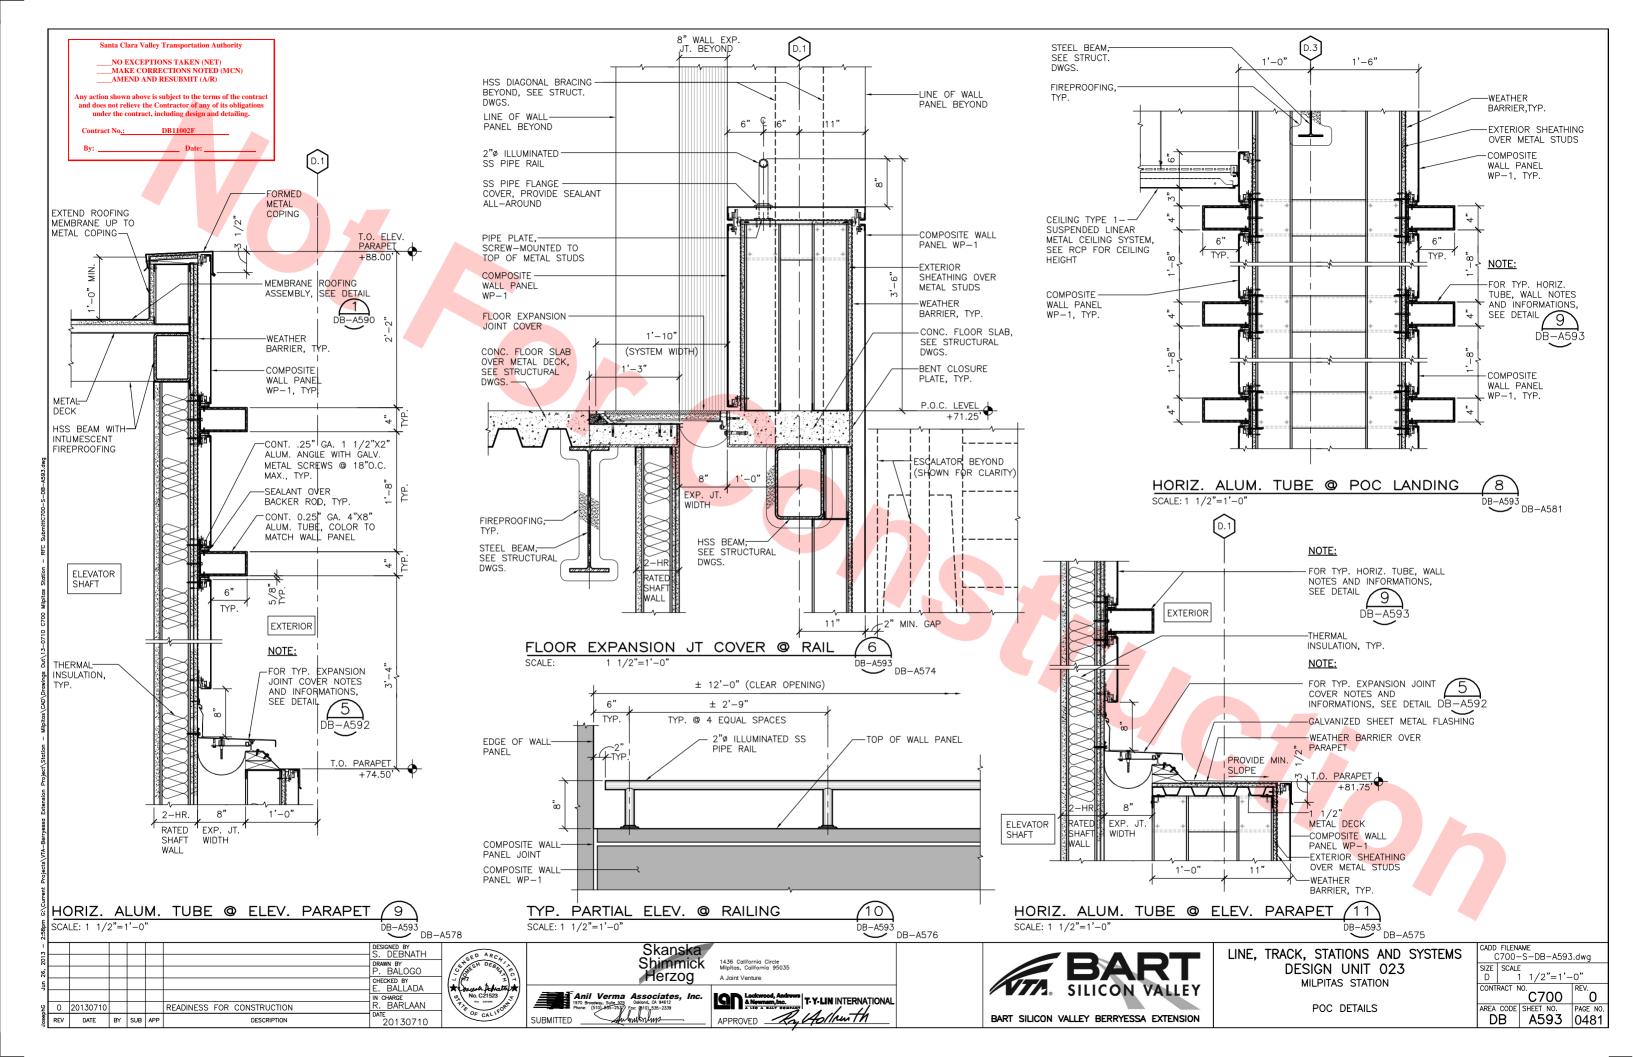


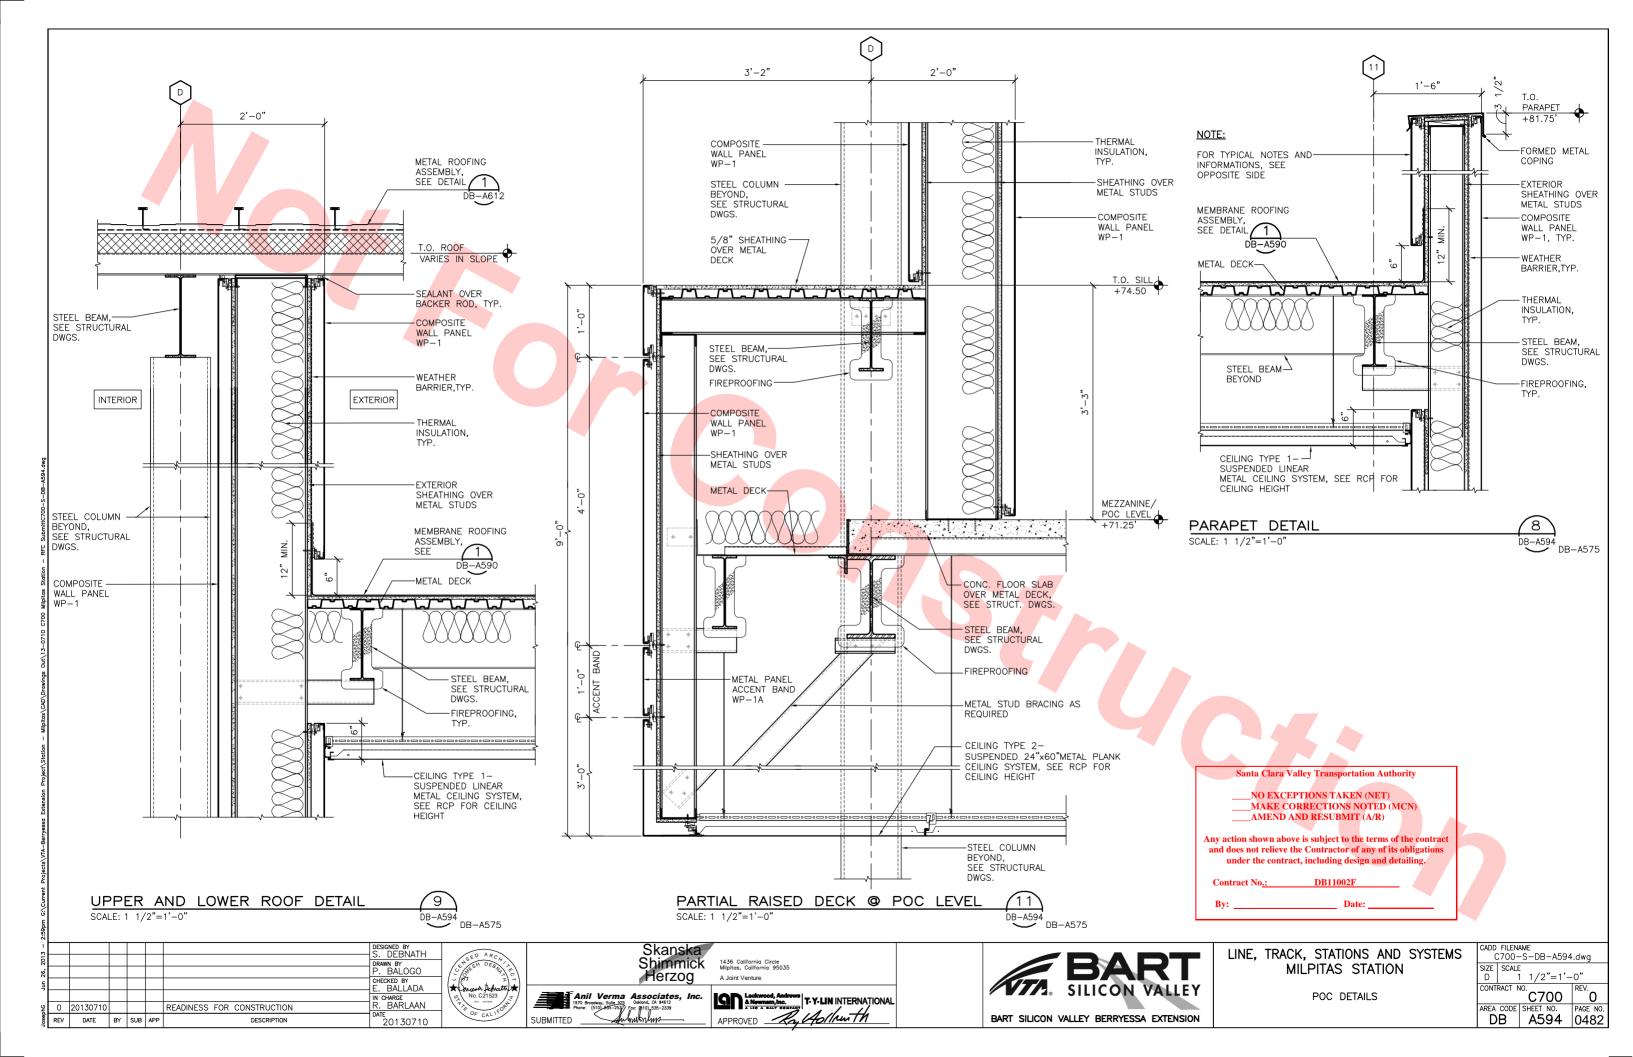


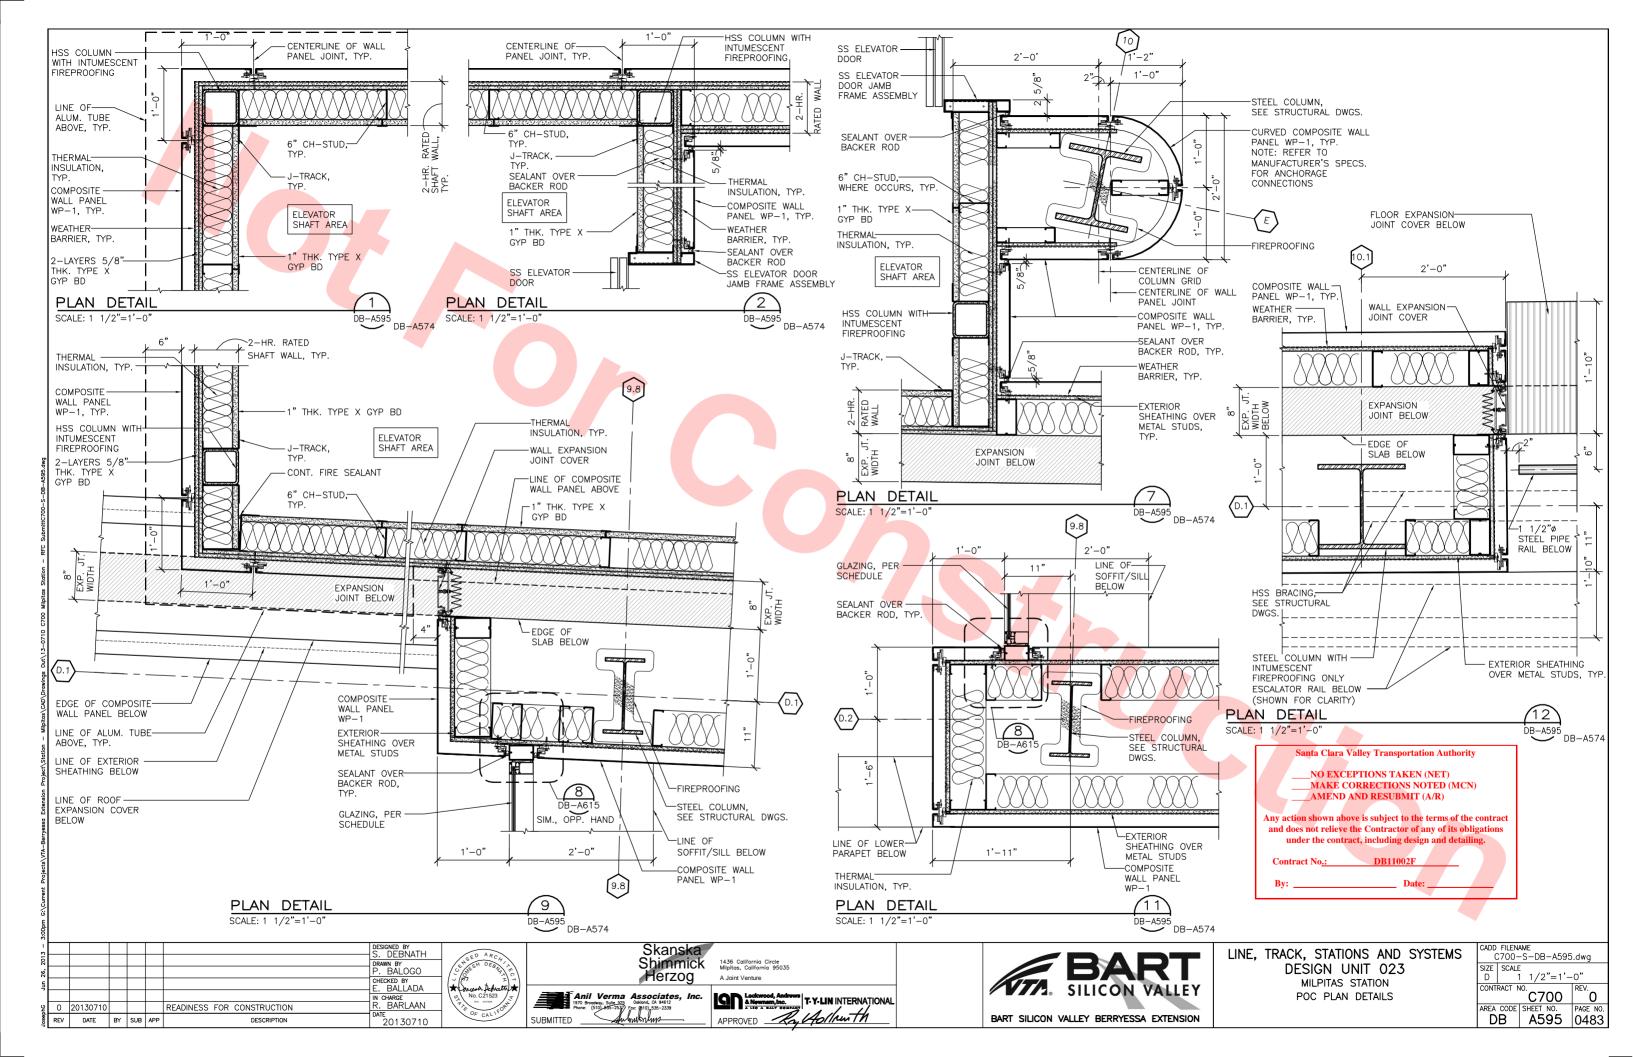


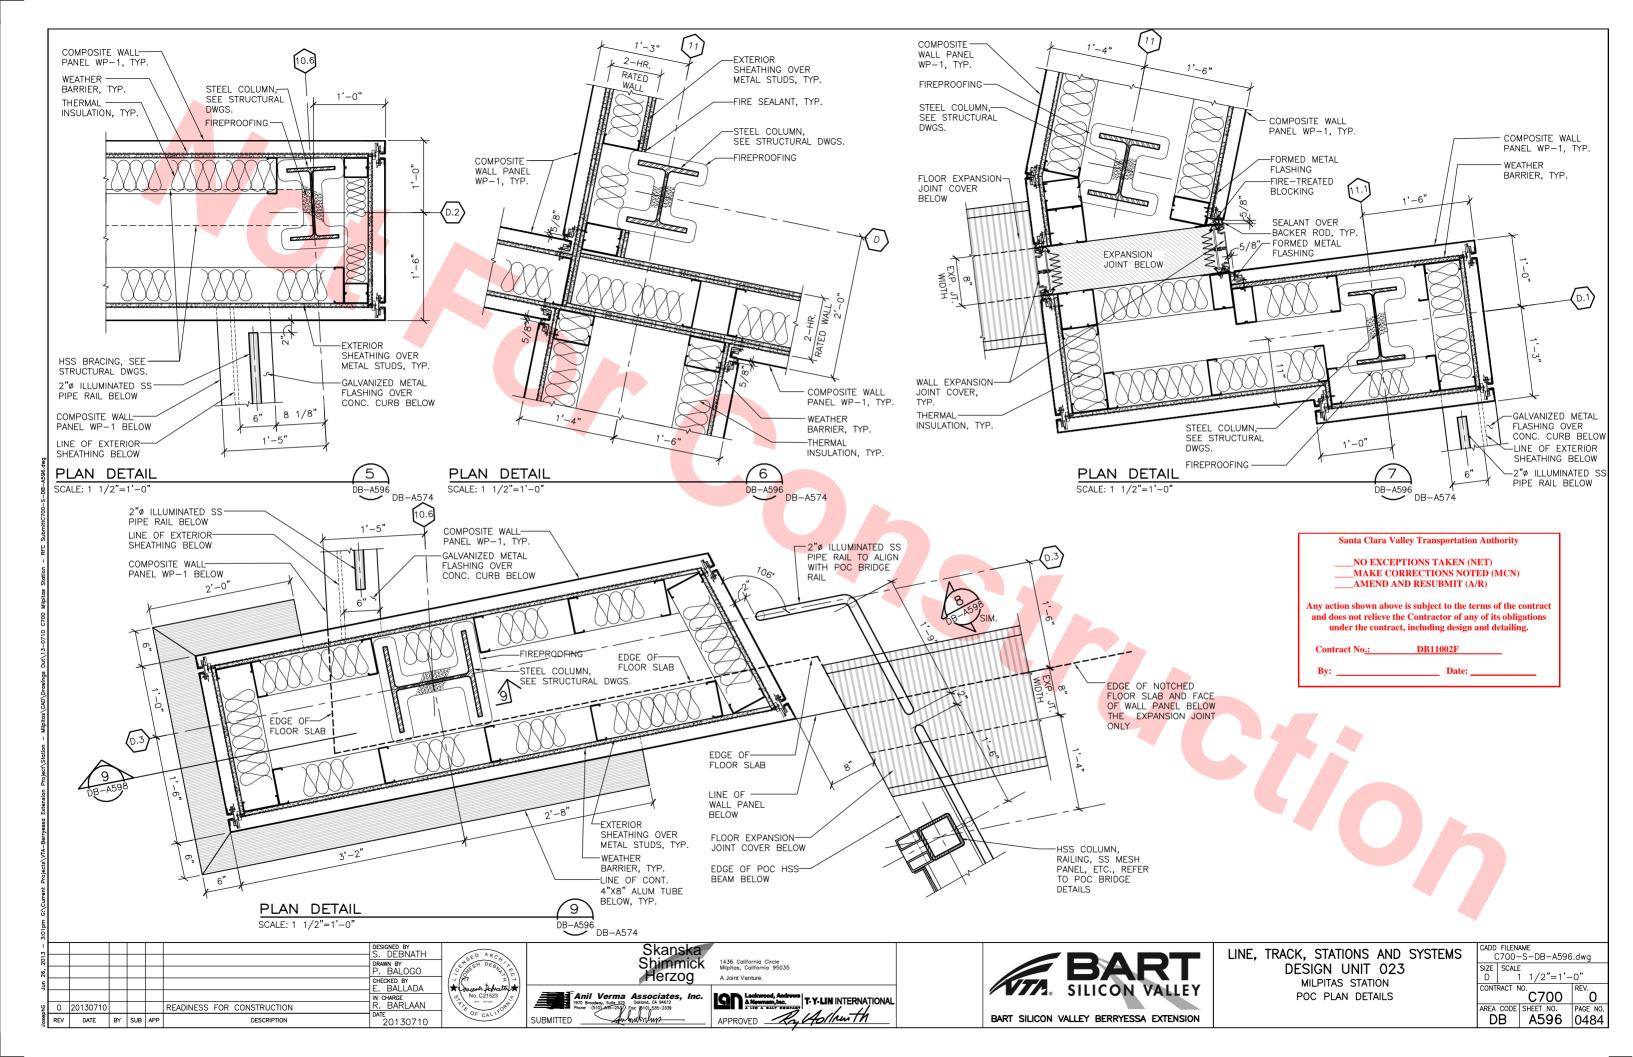


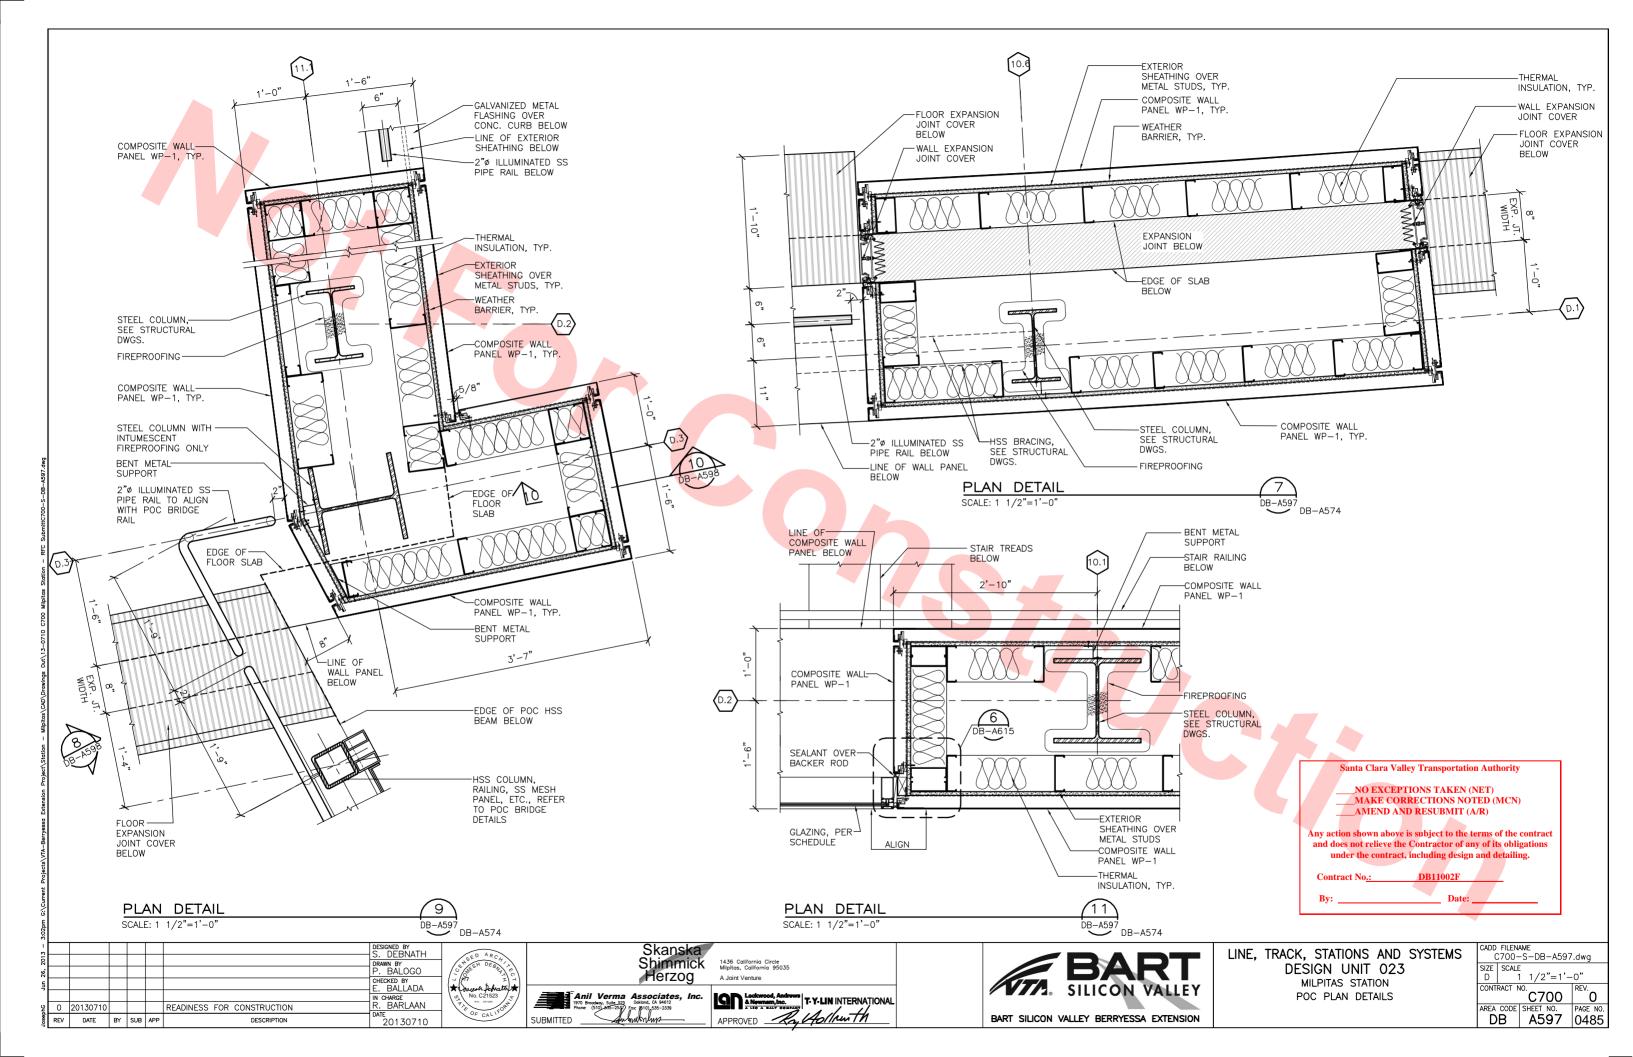


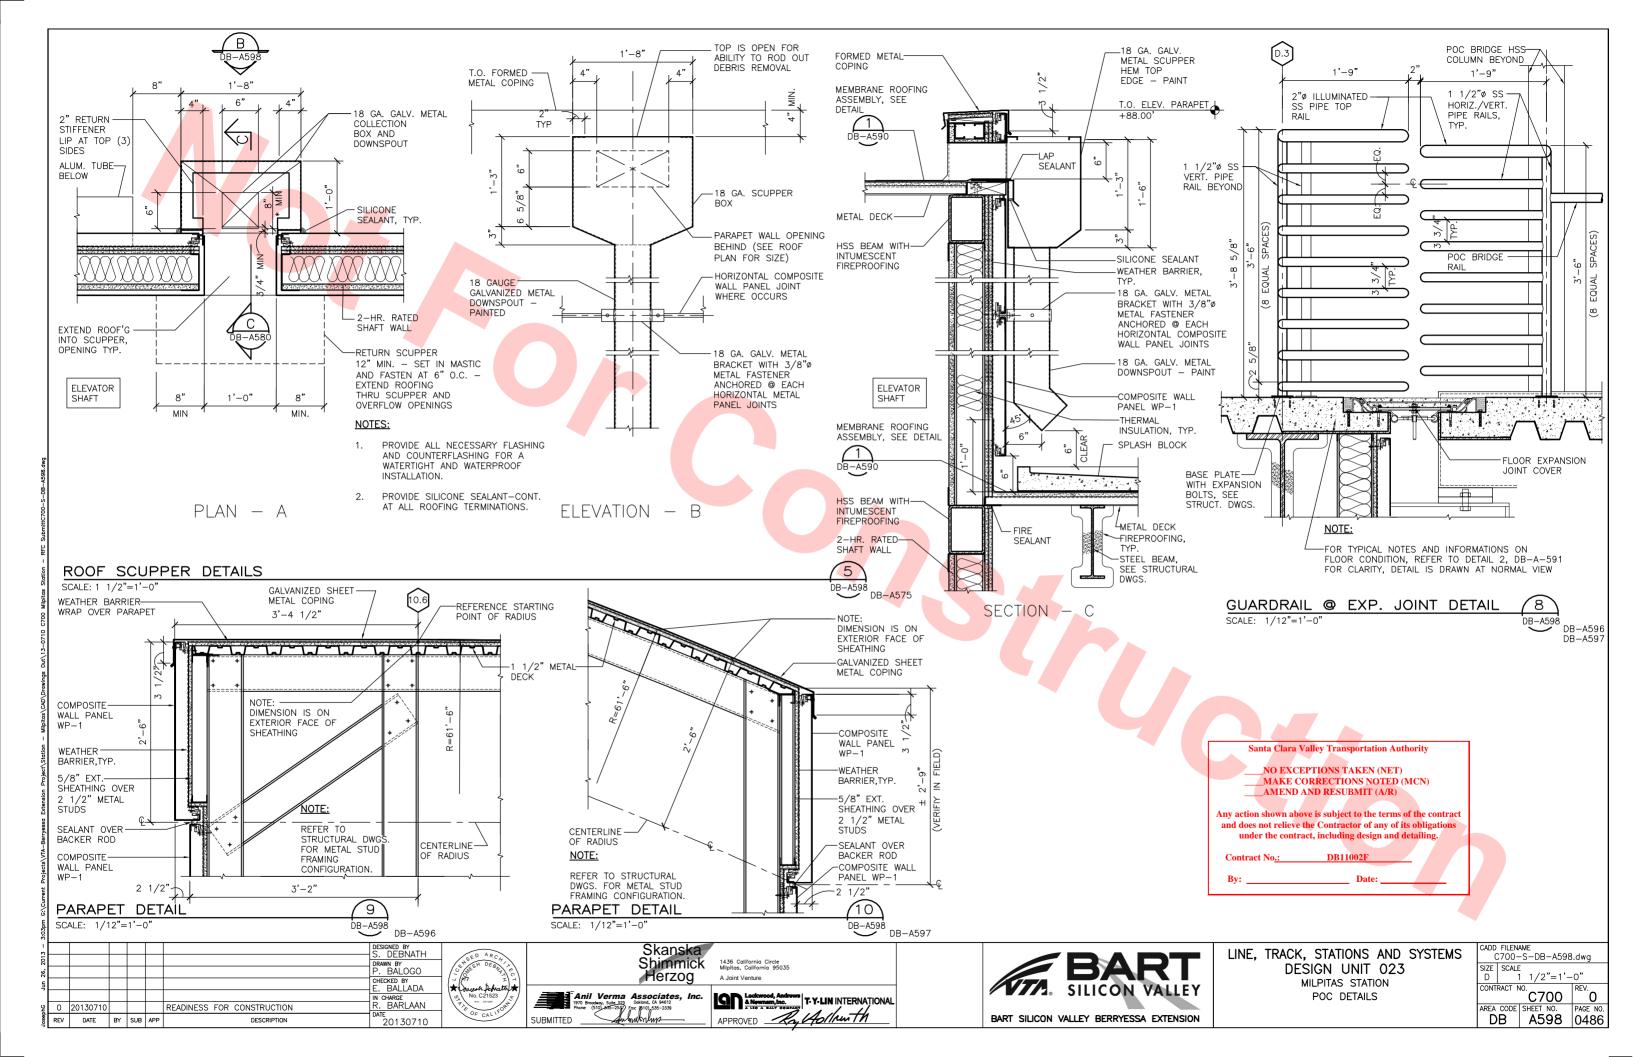


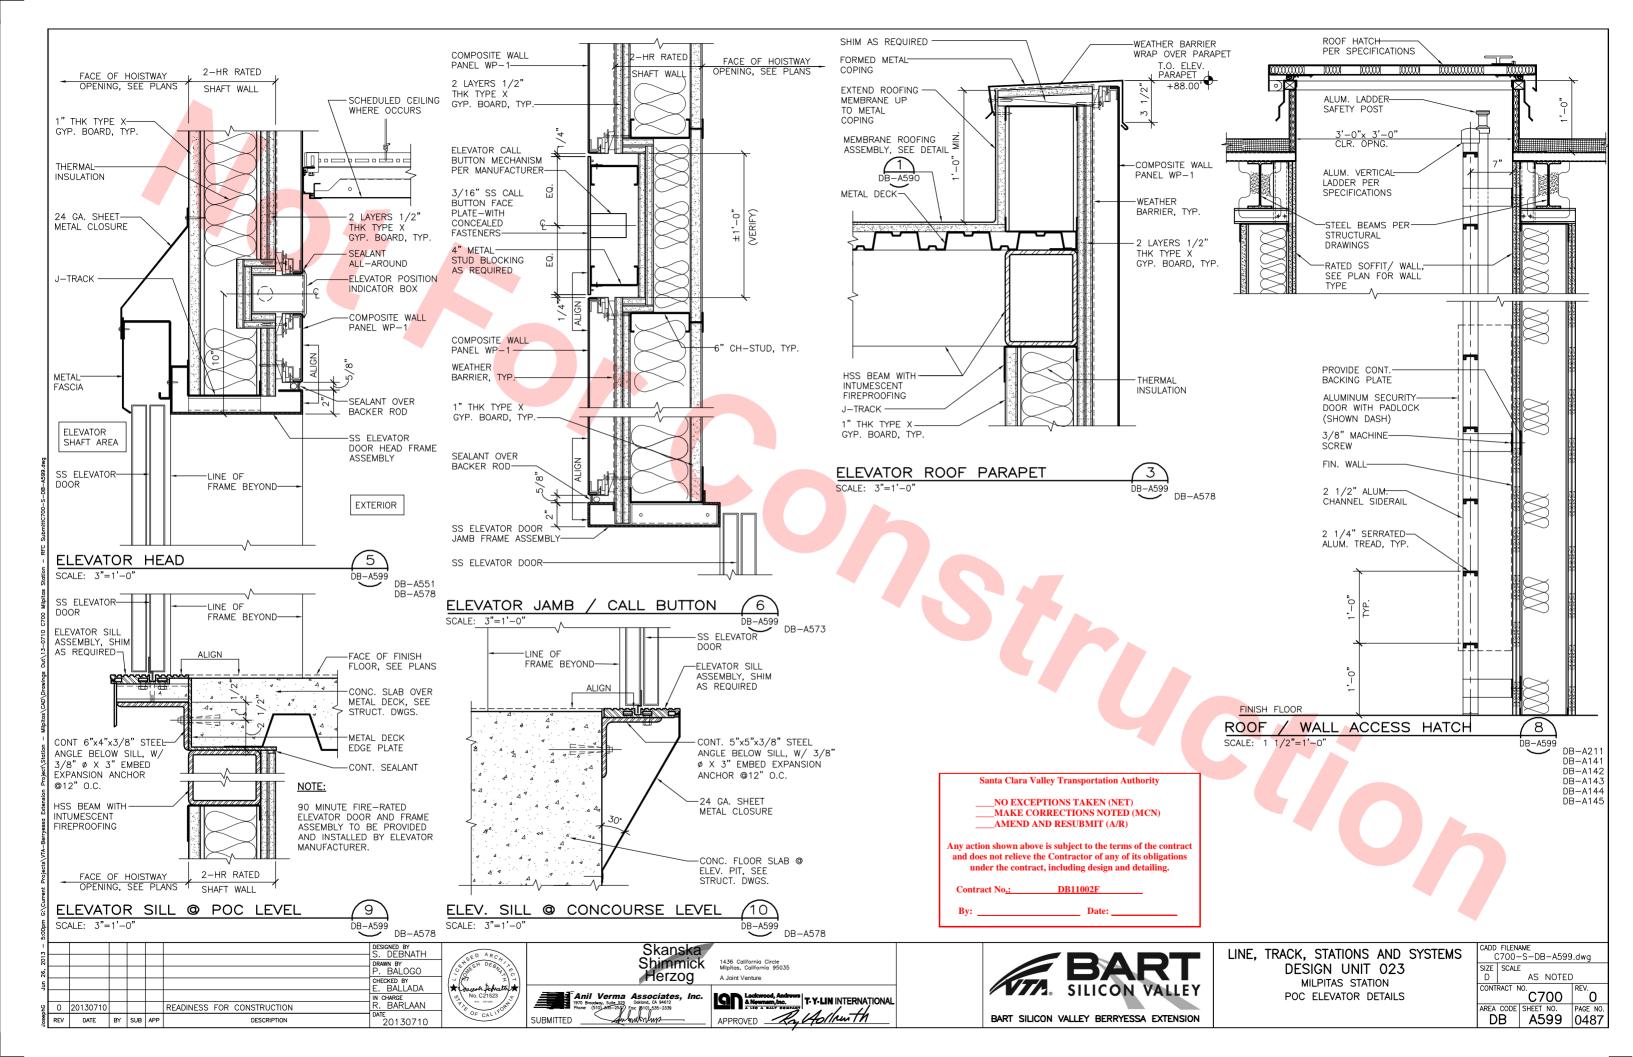


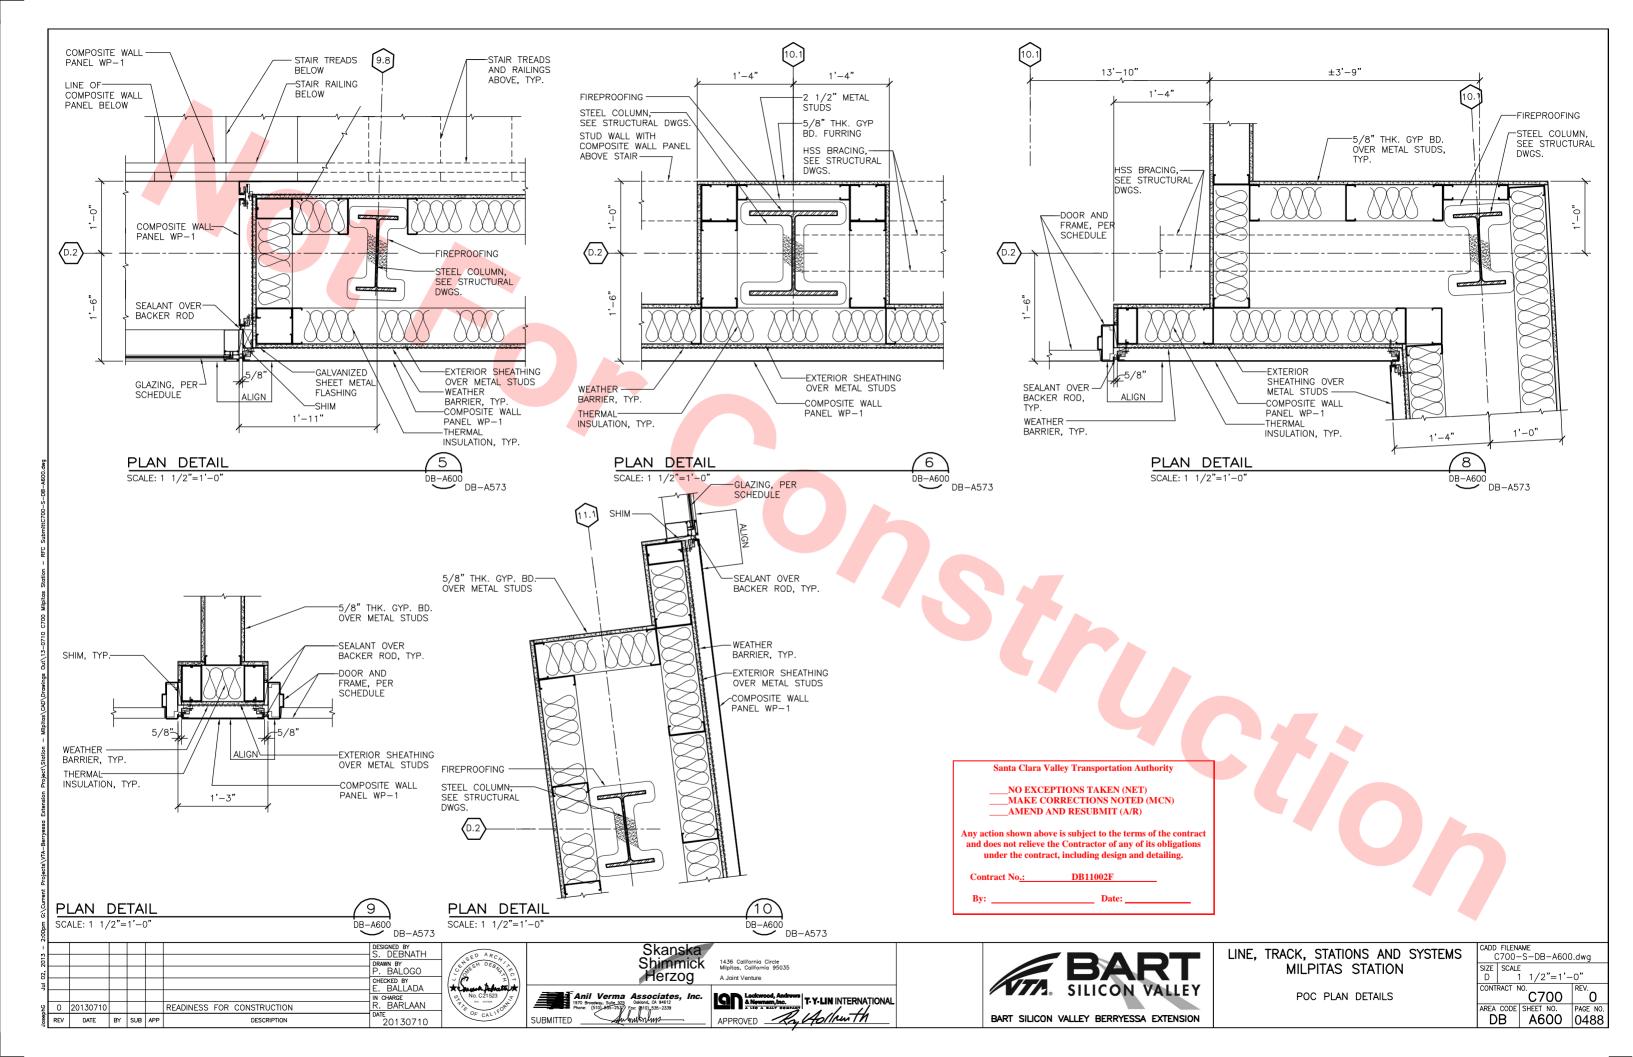


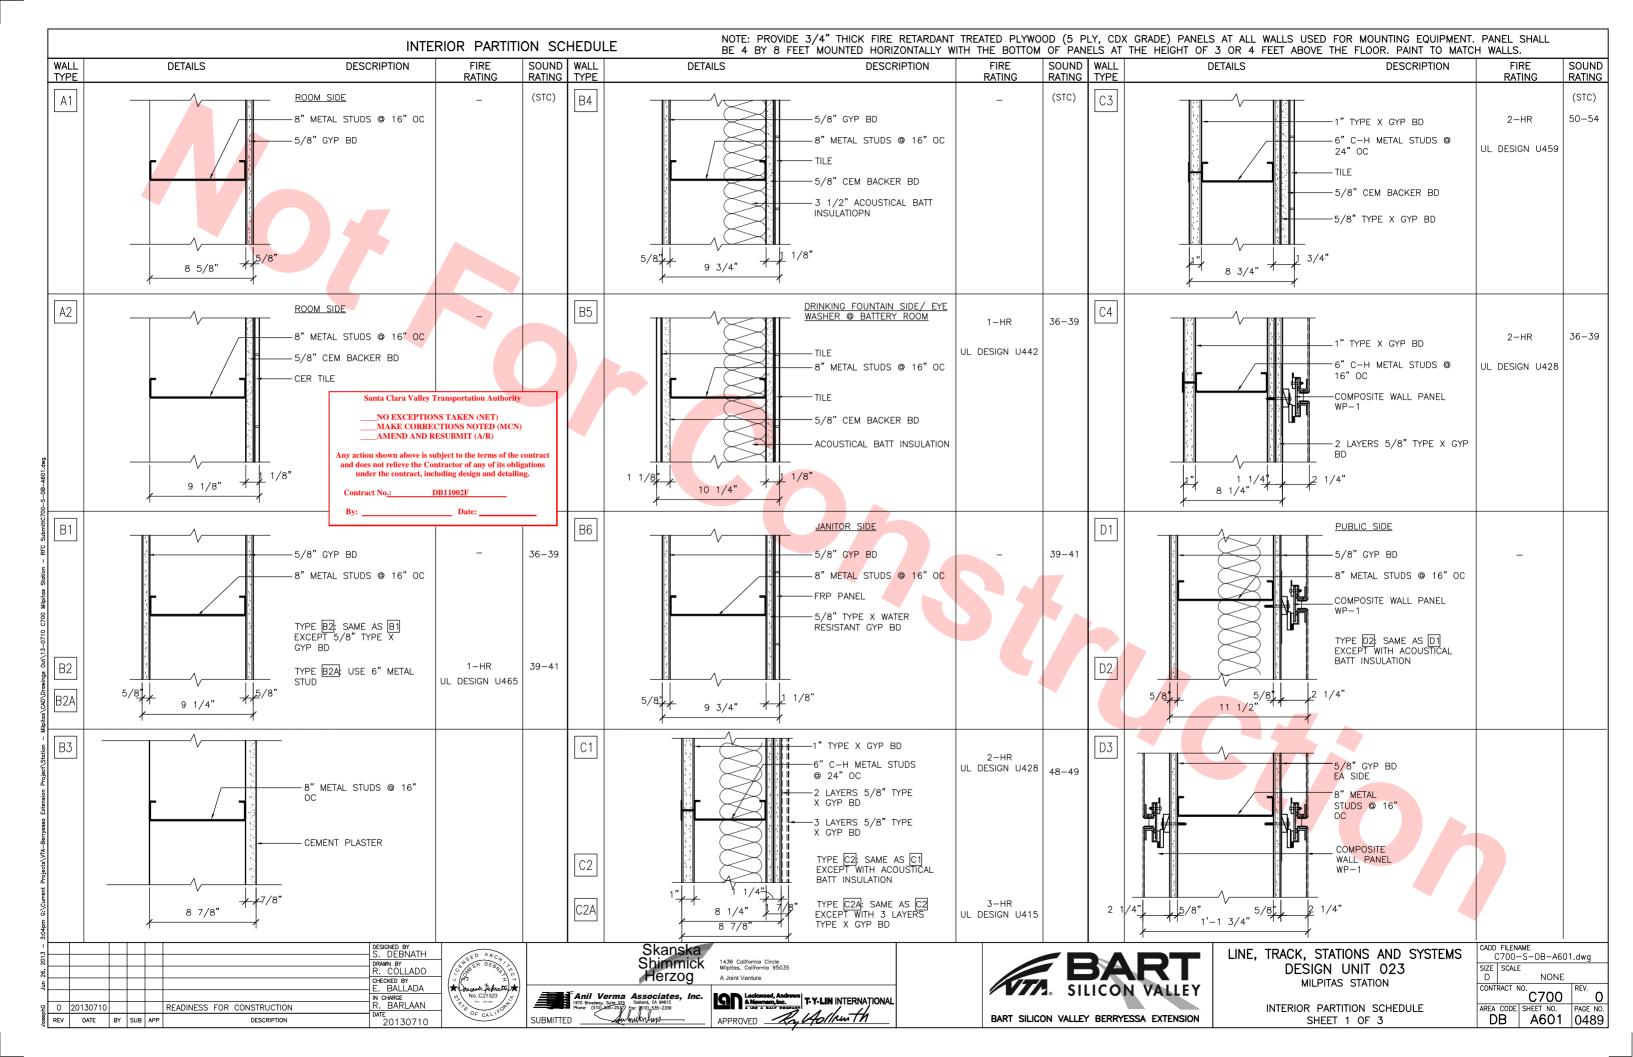


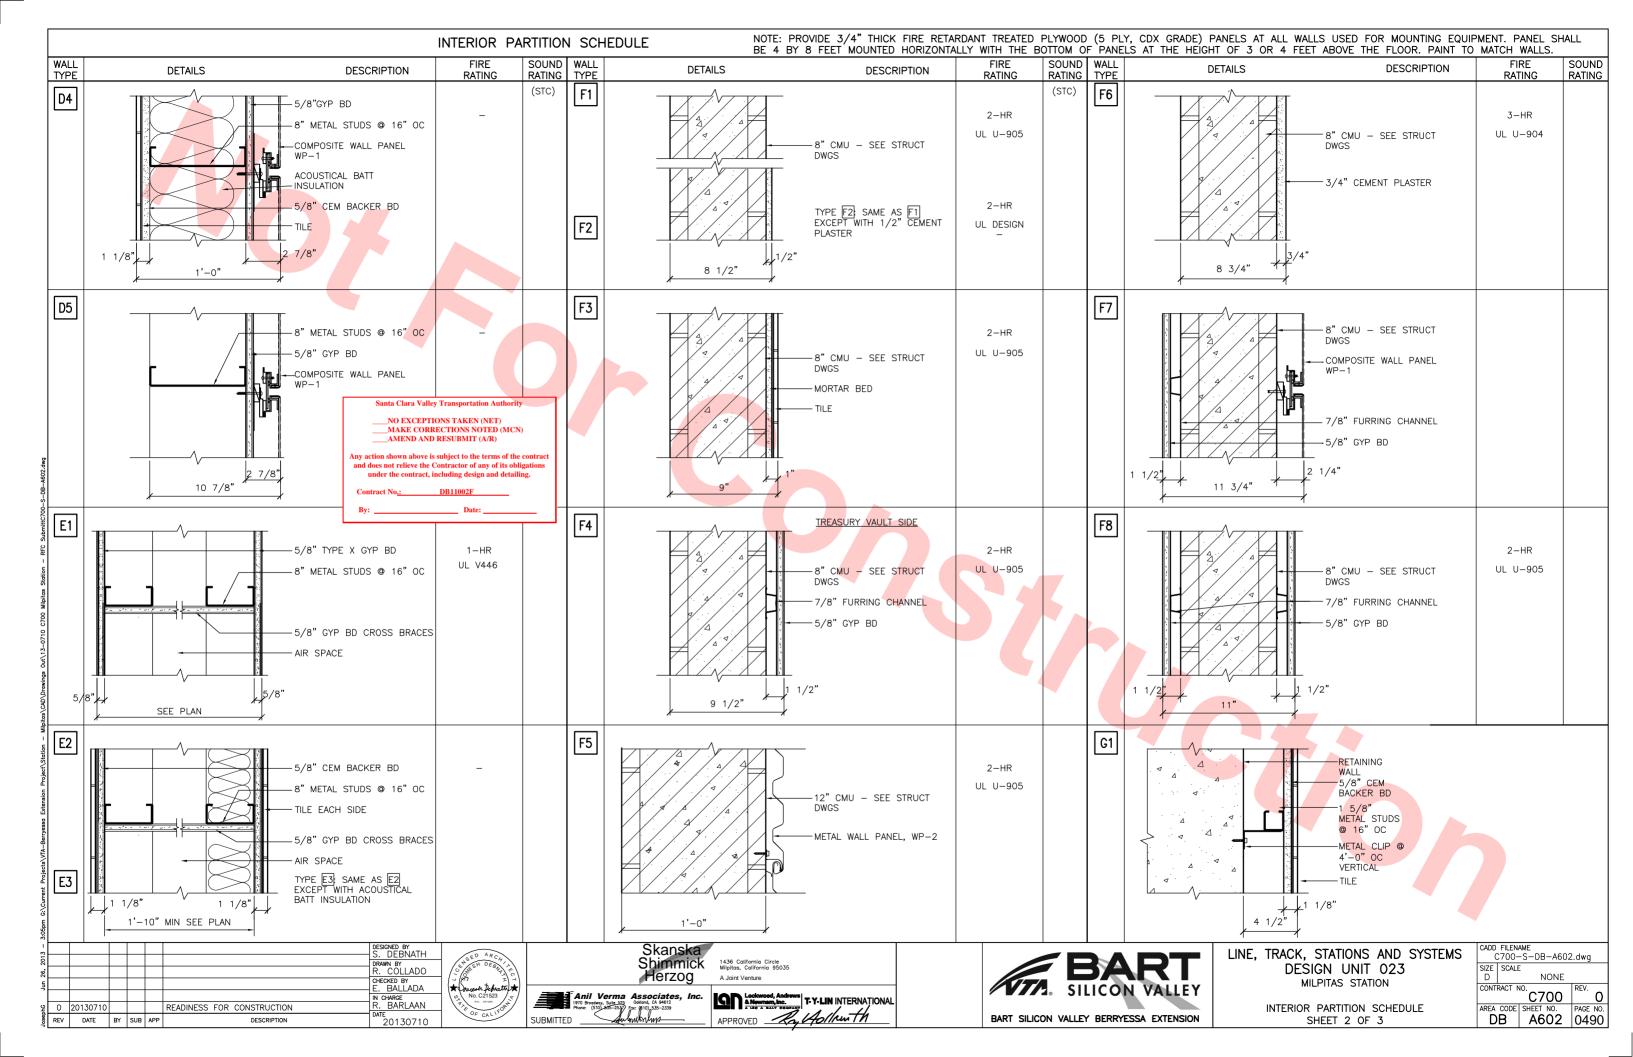


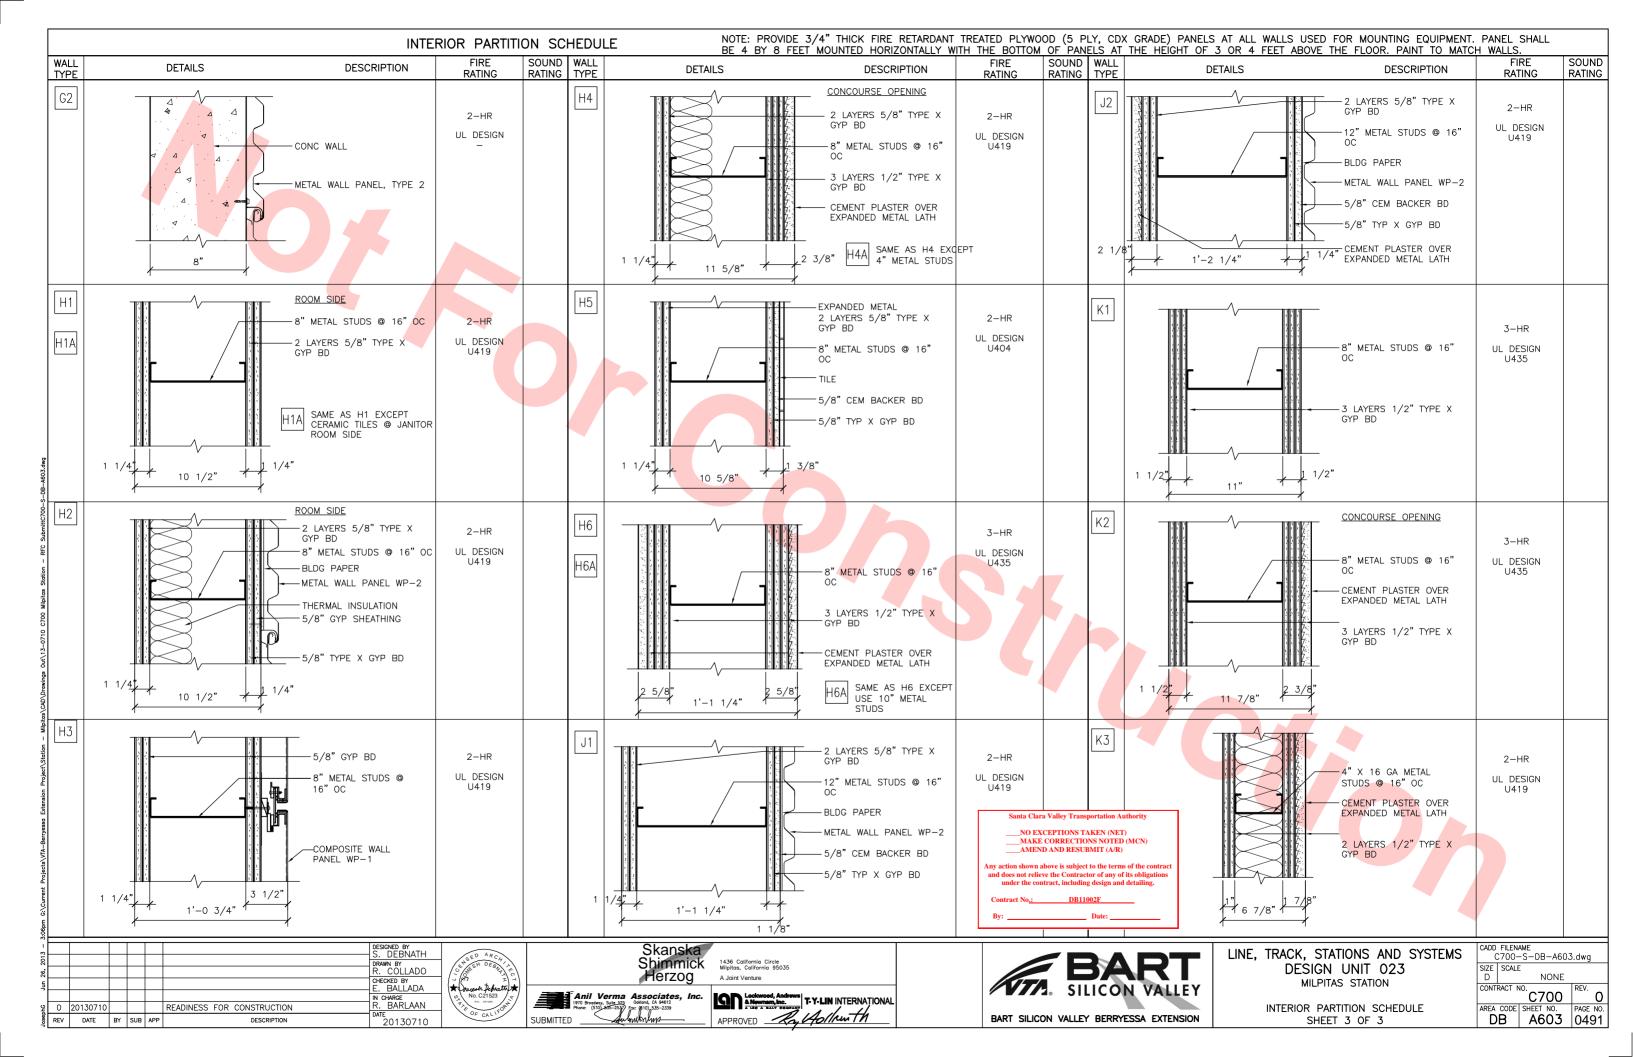


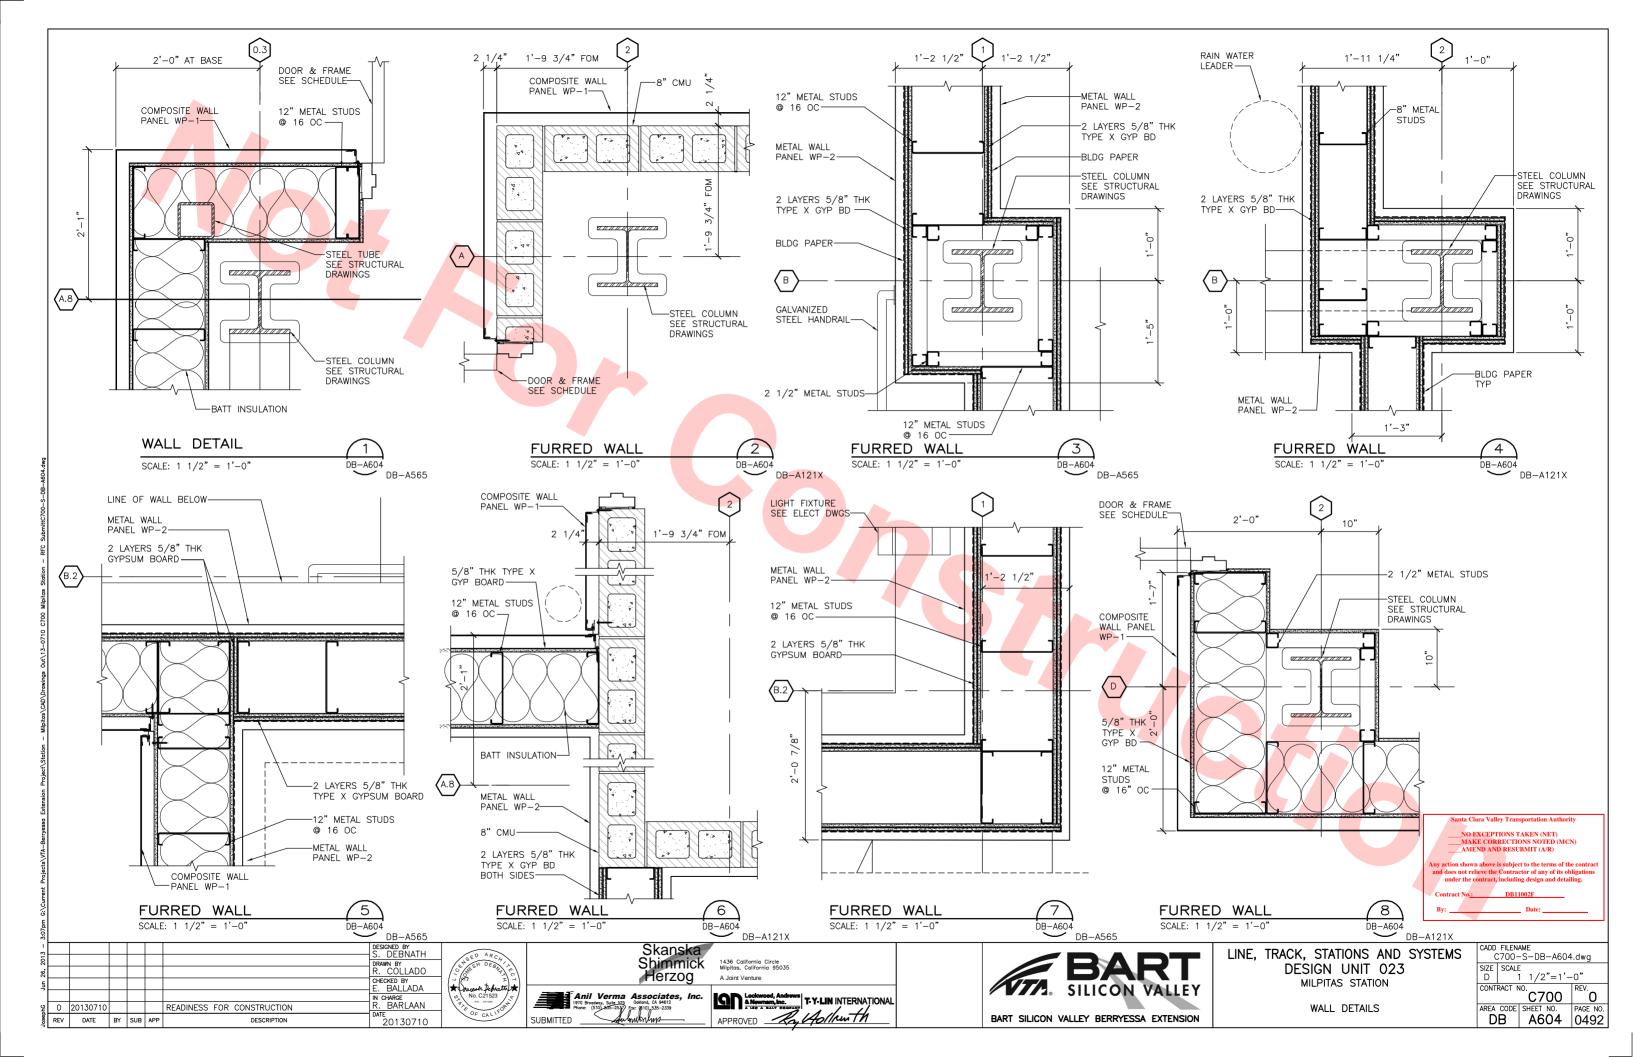


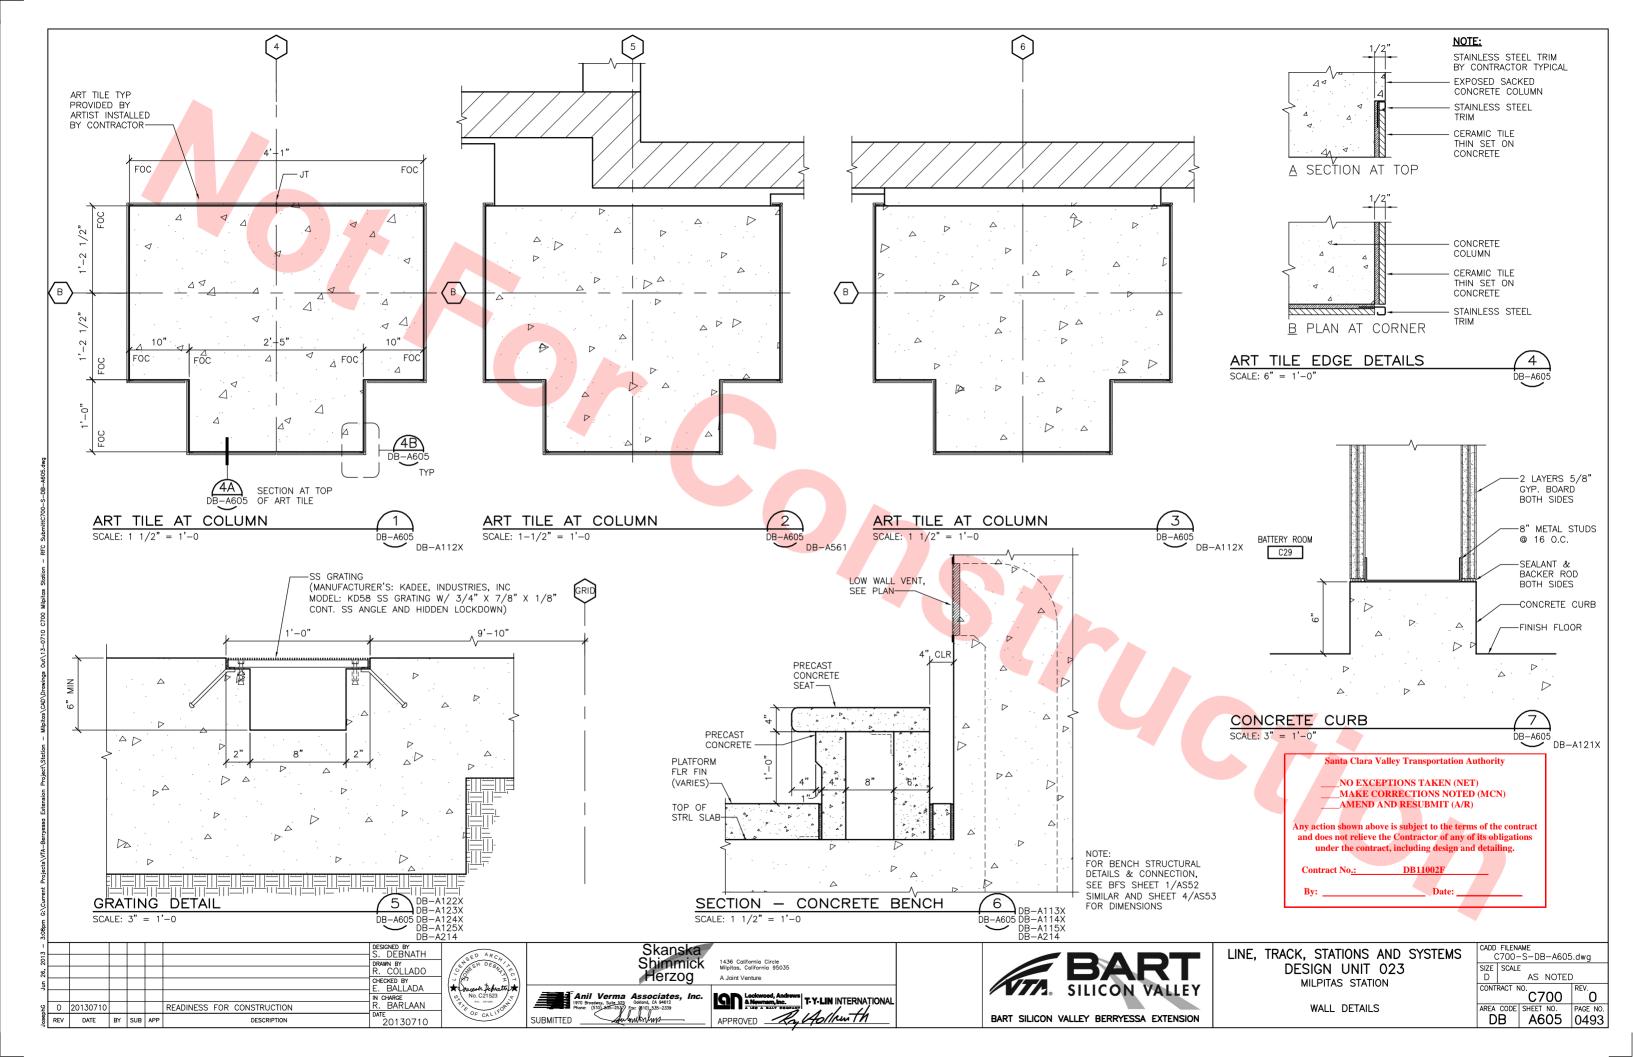


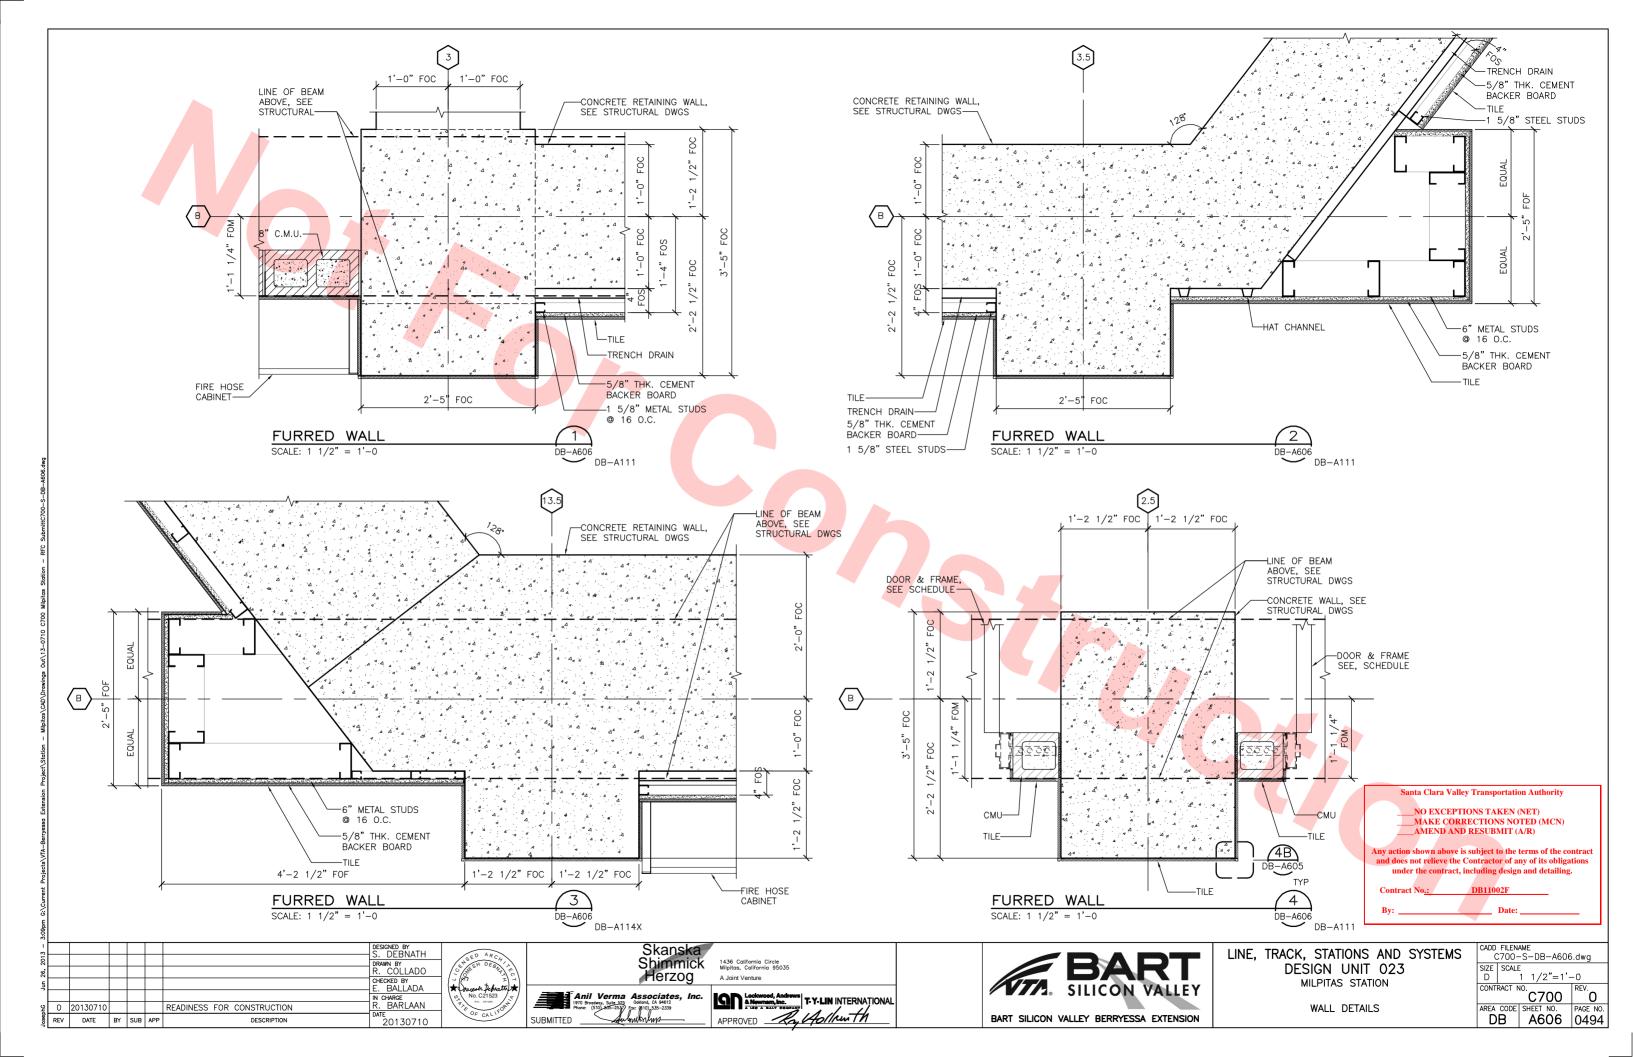


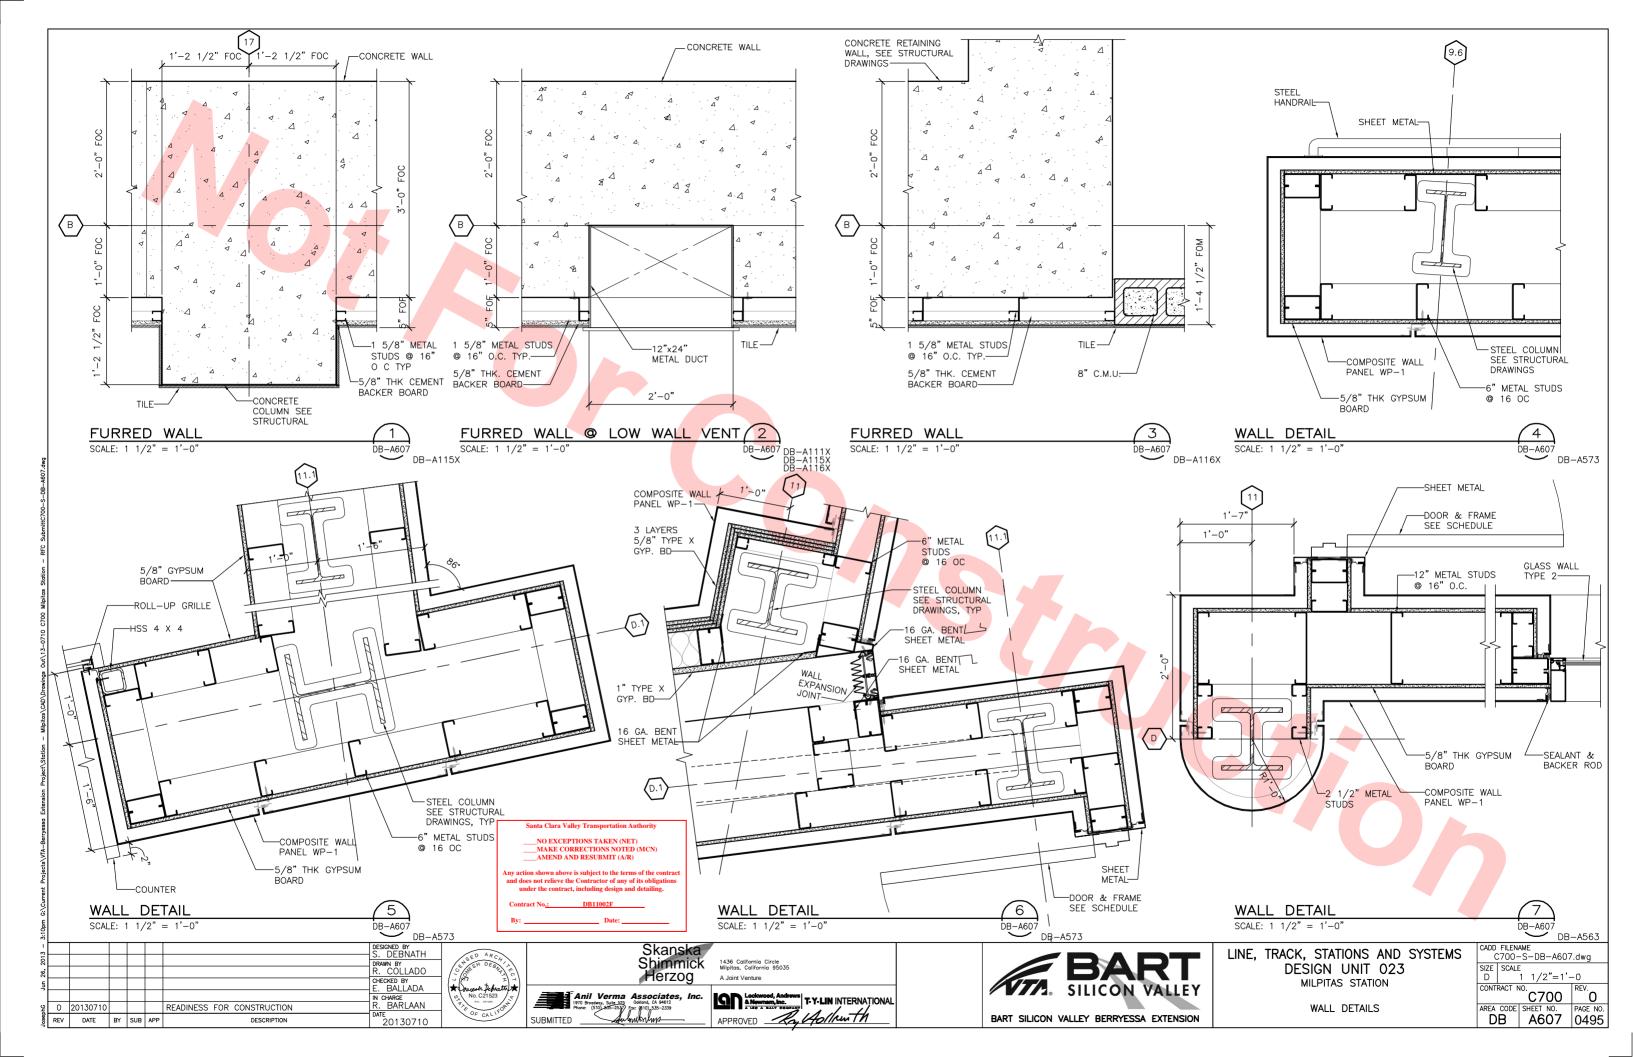


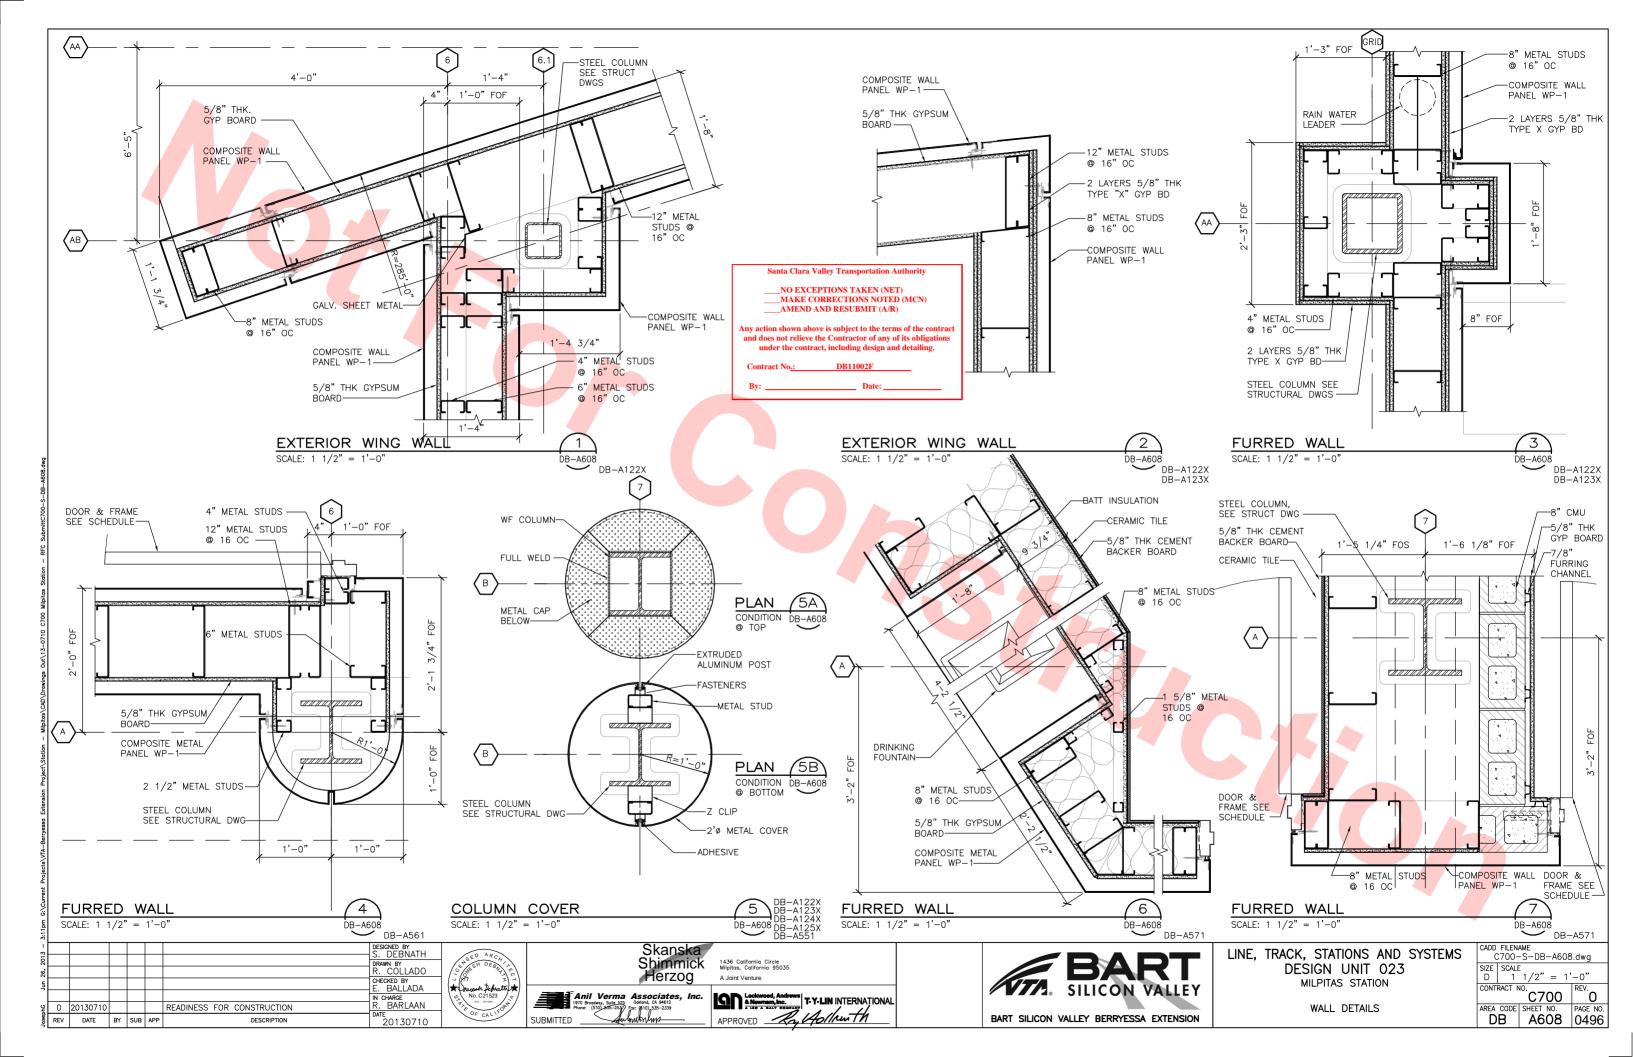


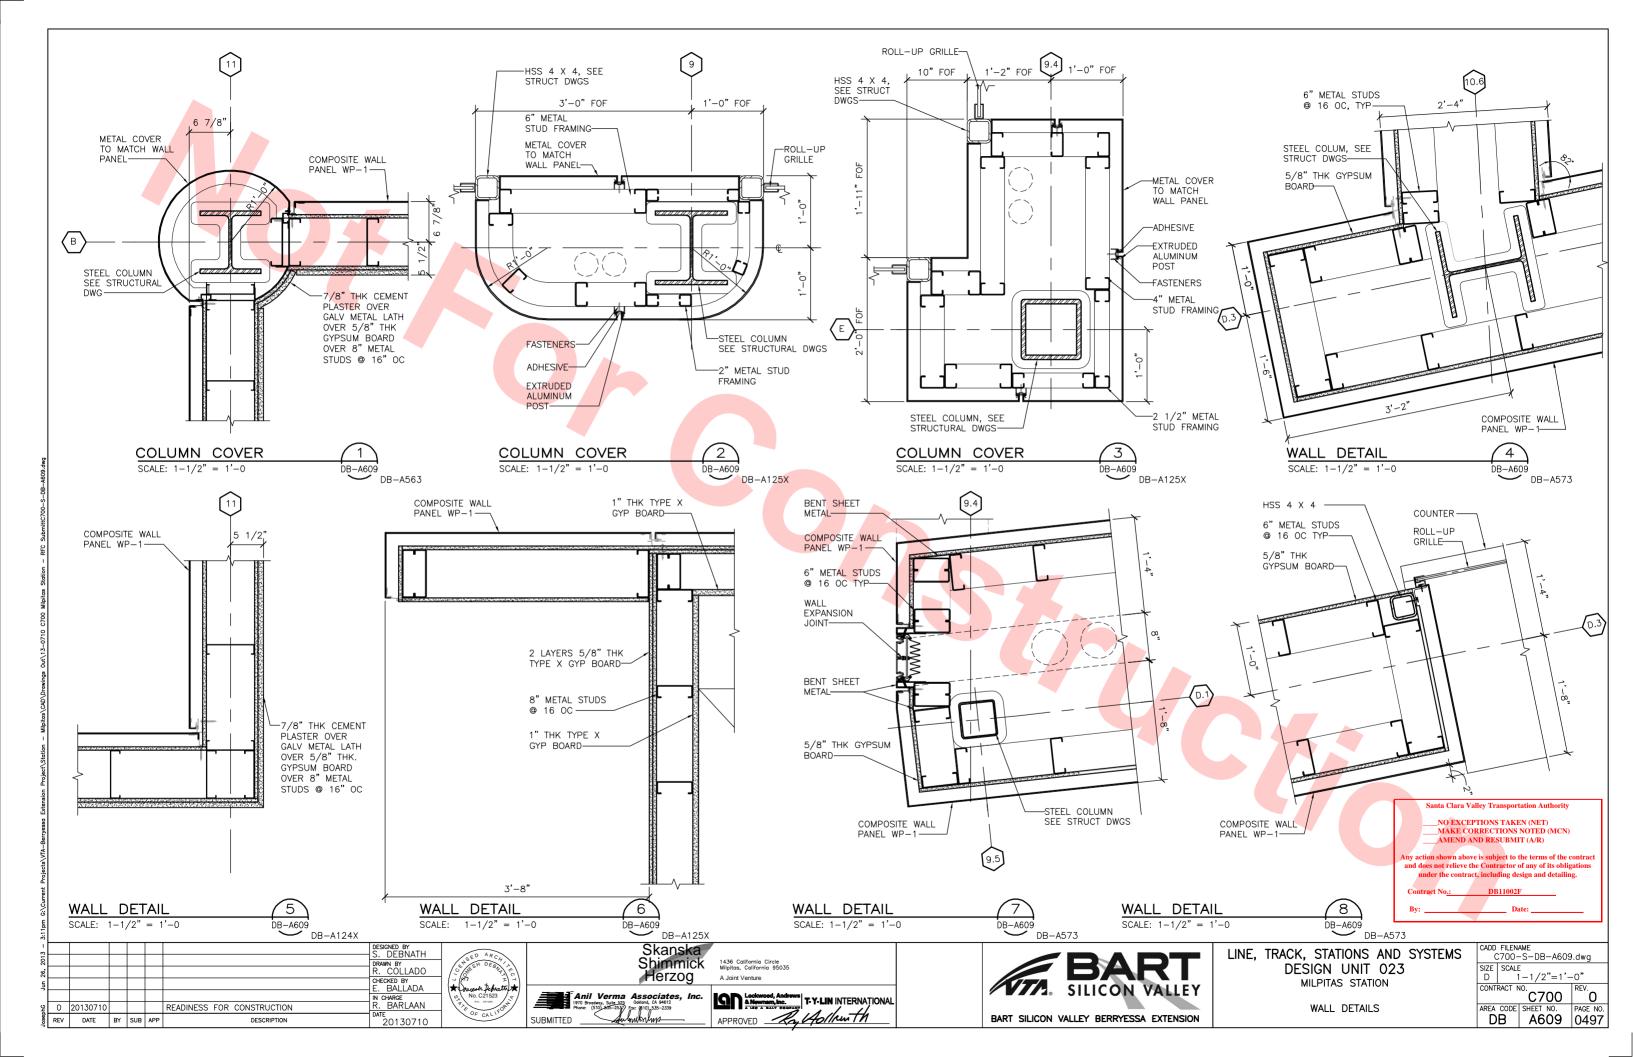


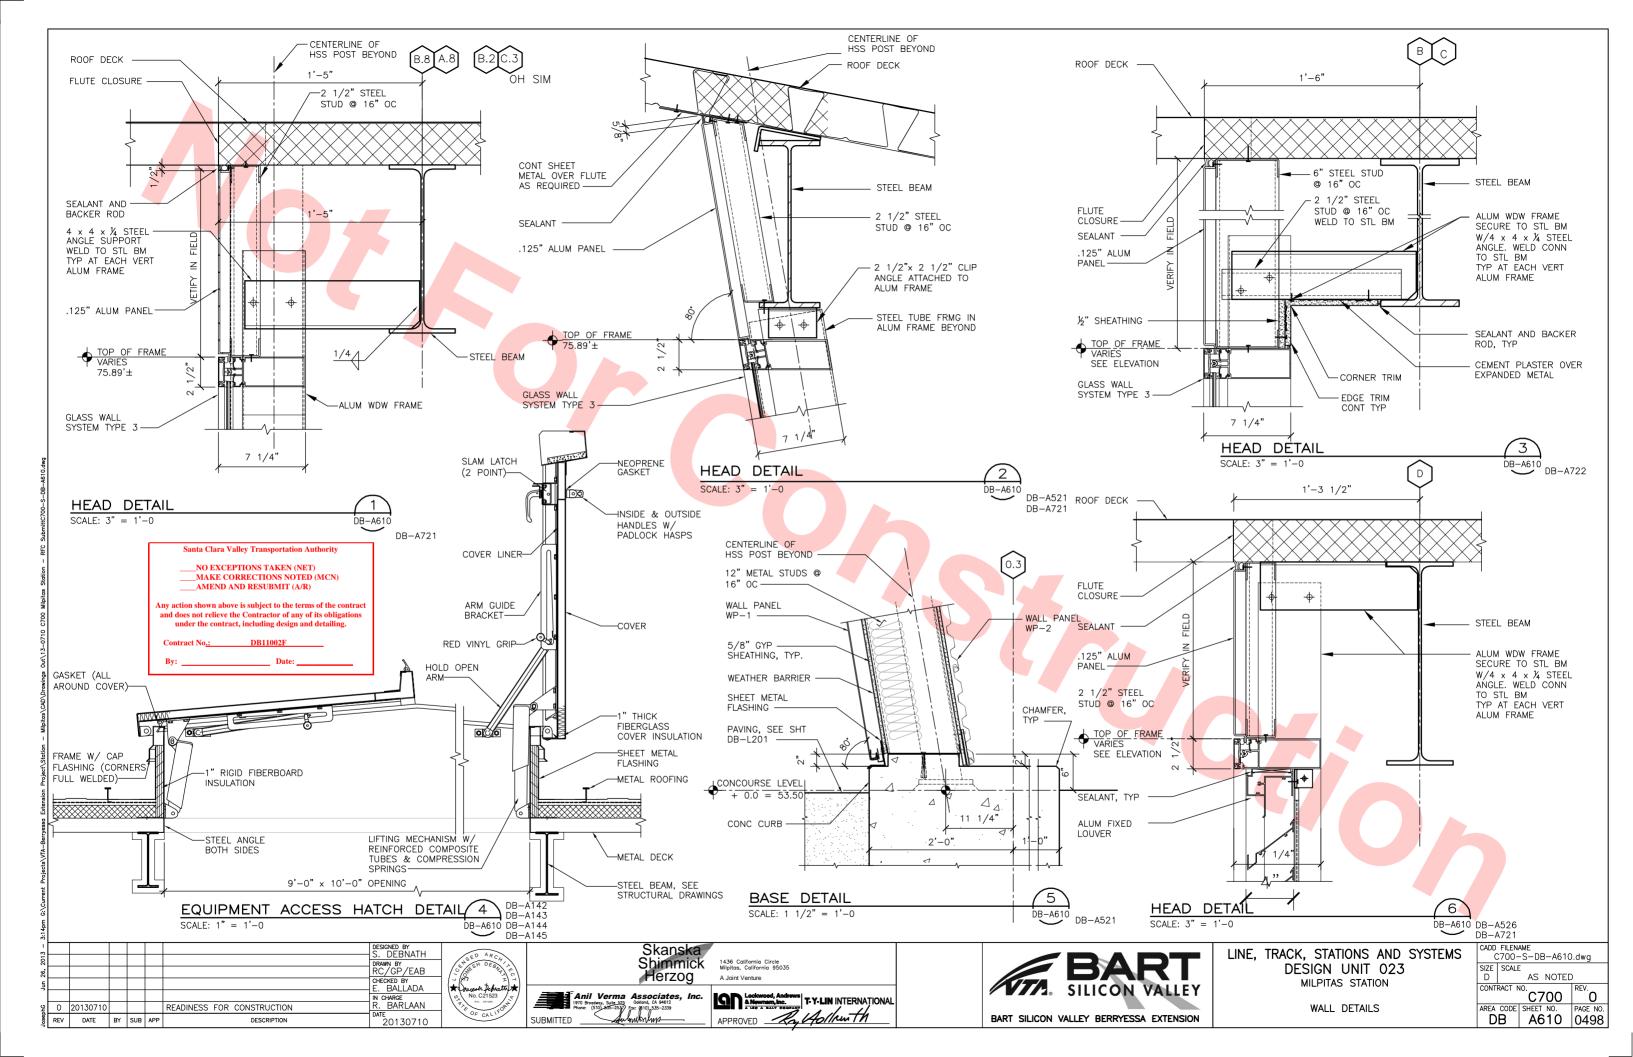


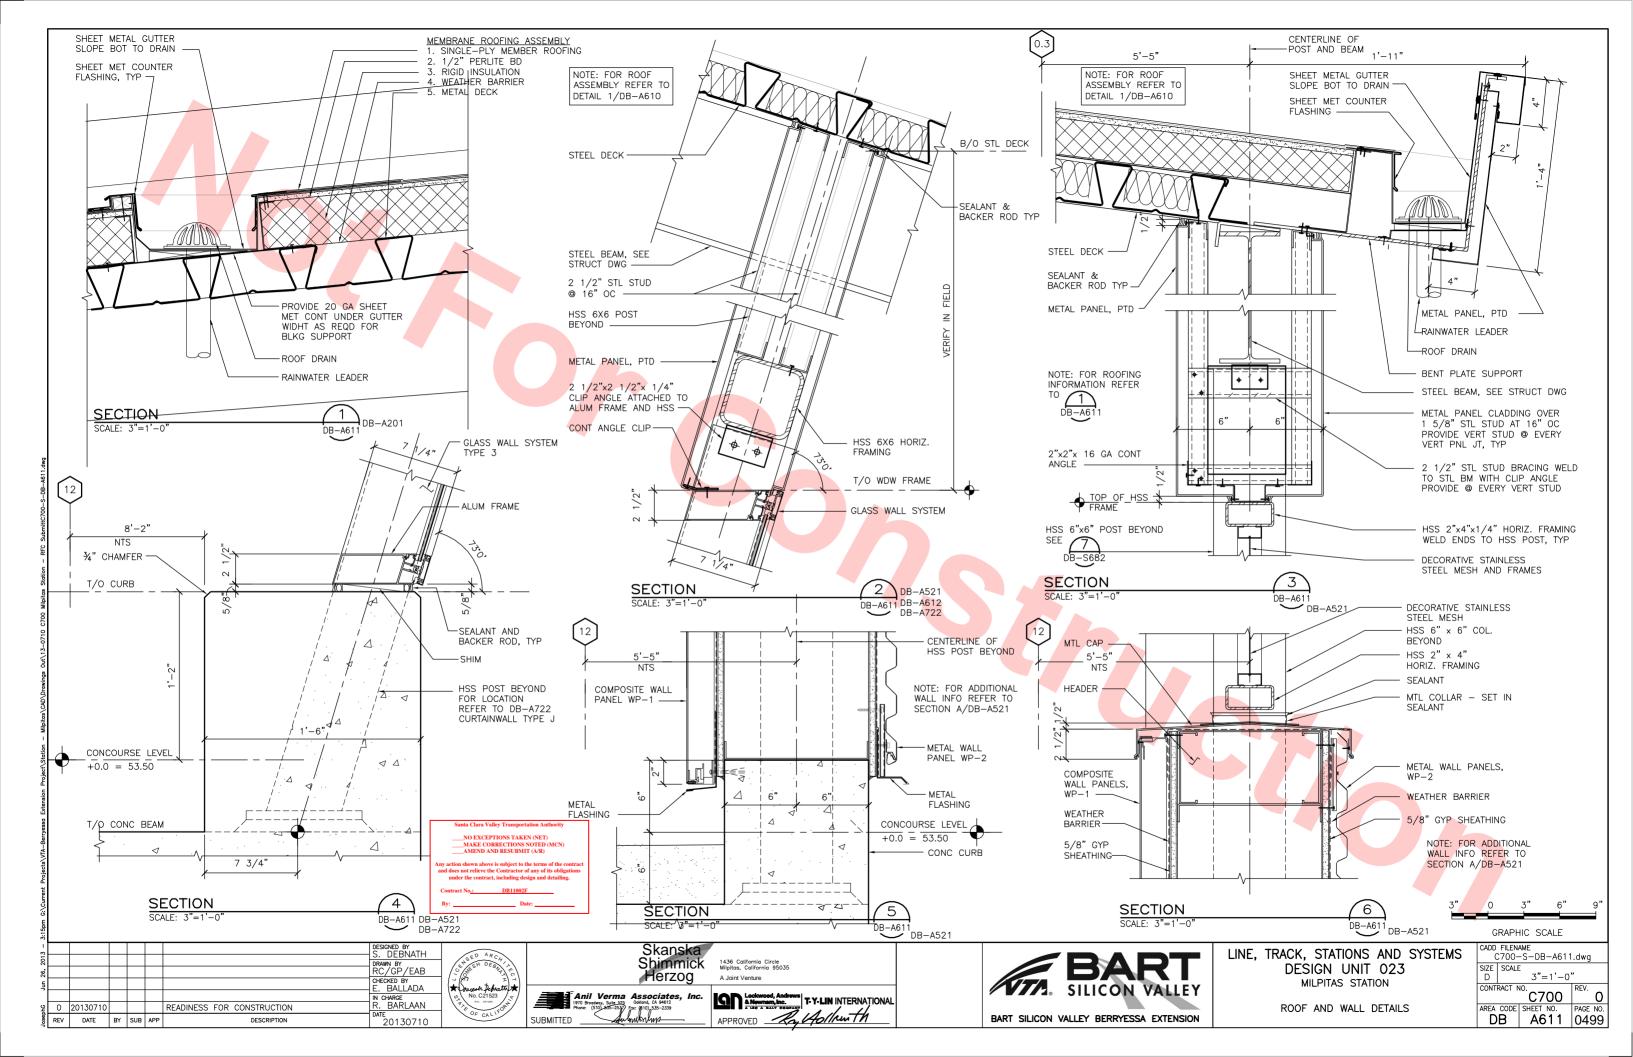

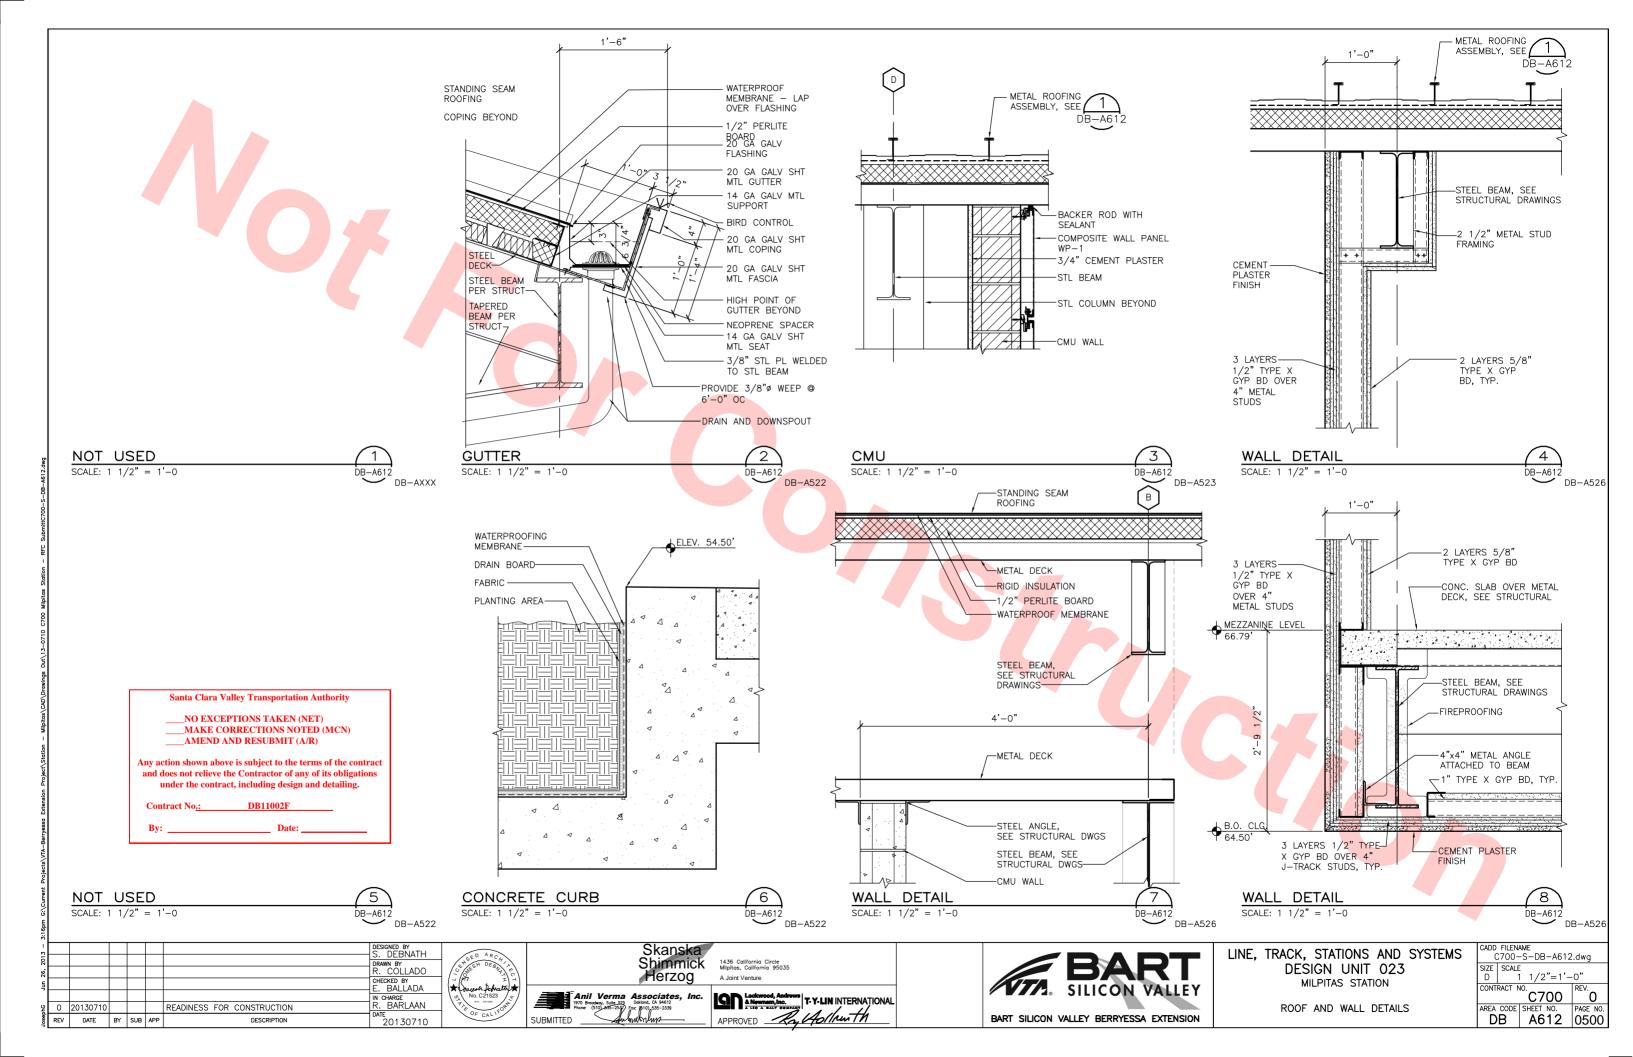

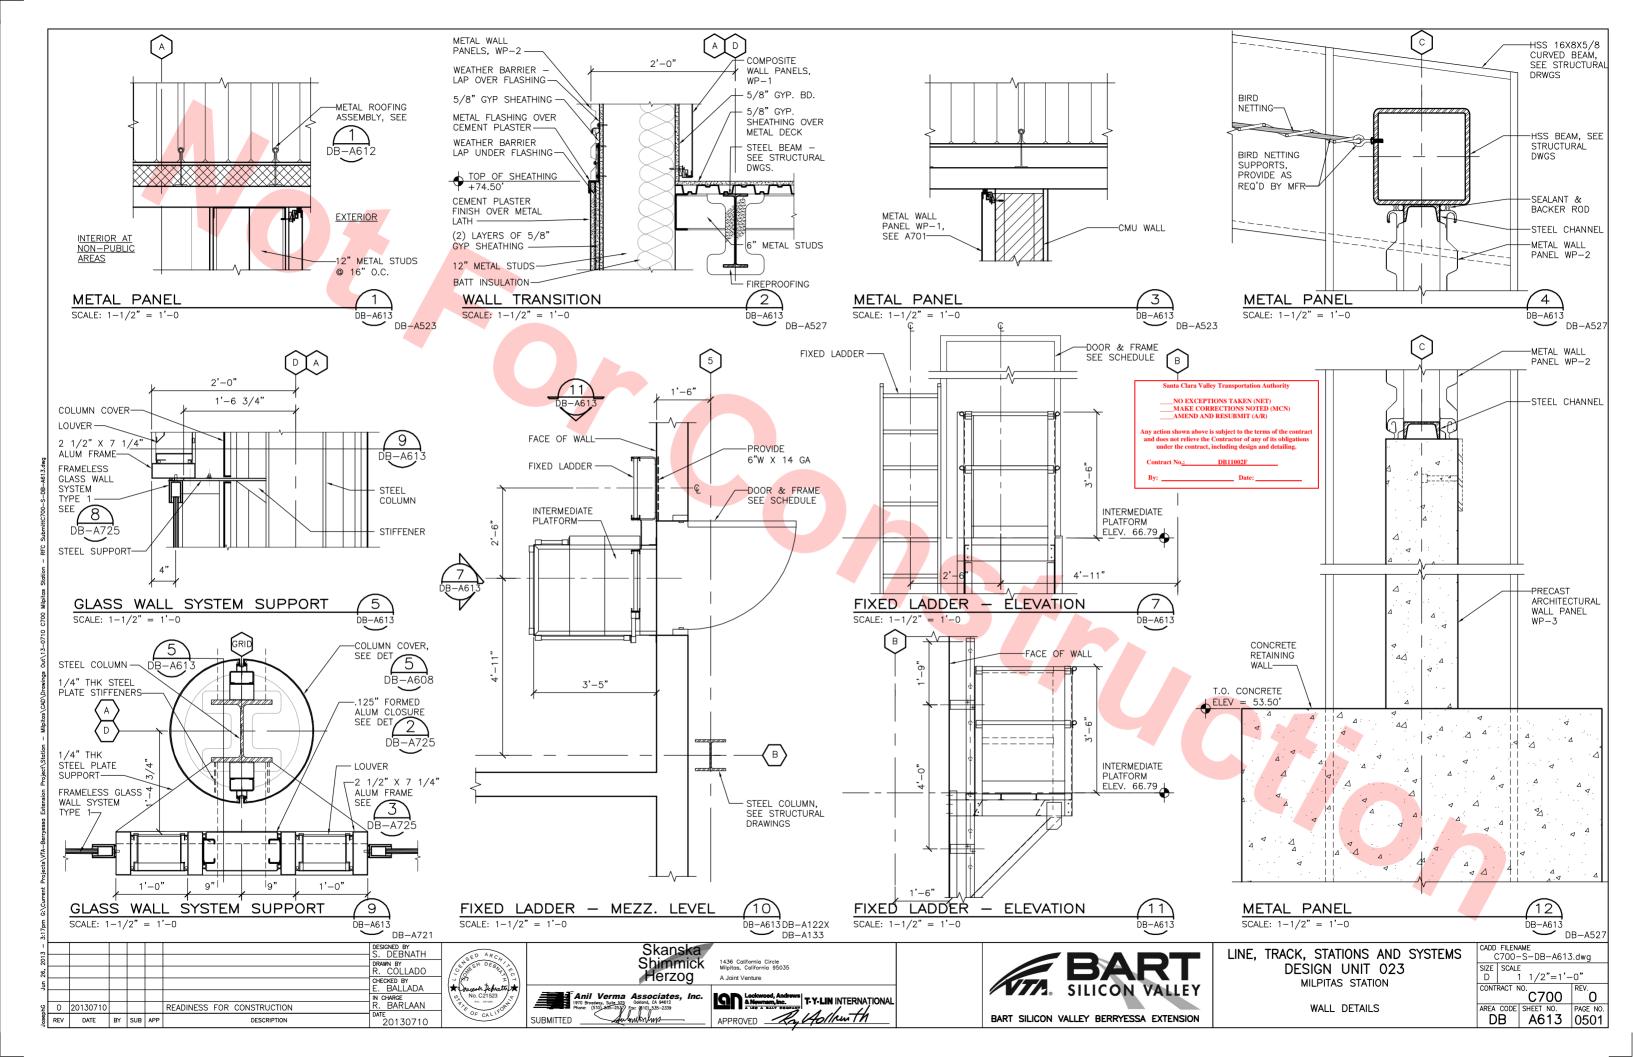

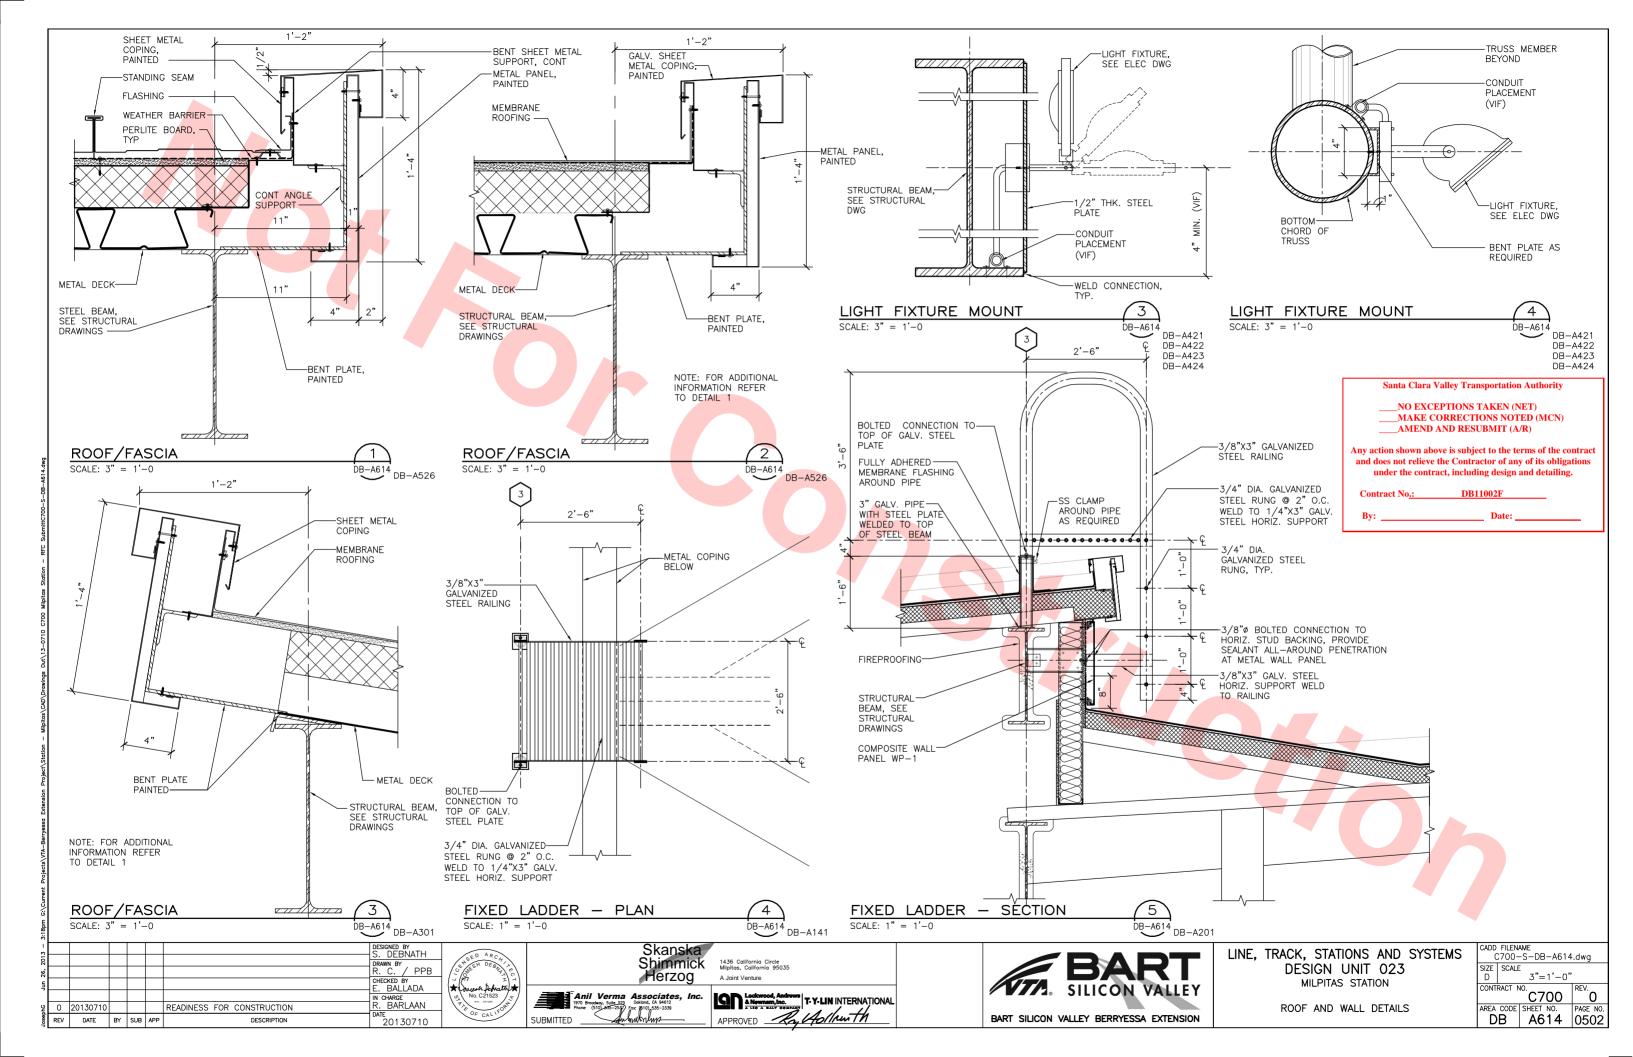

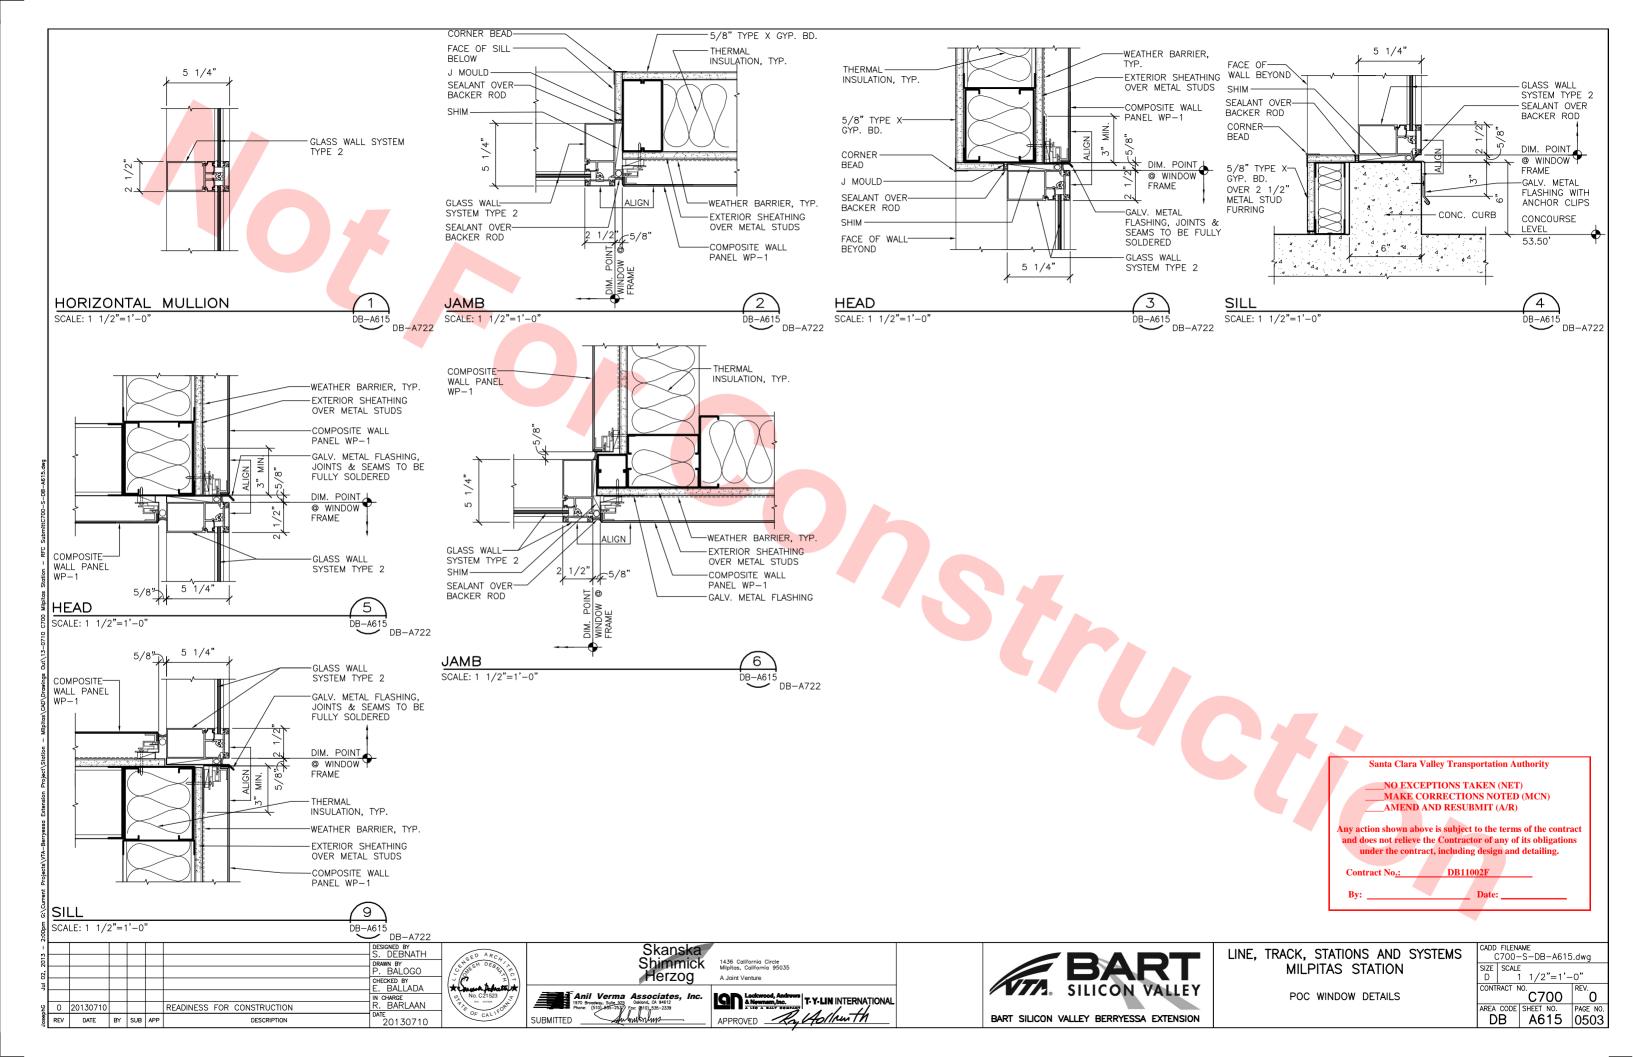

									INT	ΓERI	OR	FINISH	SCH	IEDU	LE											FINISH CODE
ADEA ROOM		REFERENCE	FLOOR	R (NOTE :	2,6,7,8)			W	ALL (NO	OTE 1,4,	,5)					IIAW	NSC0T				CEIL	ING	SOF	FFIT		CODE MANUFACTURER STYLE COLOR/SIZE NO.
AREA NO	ROOM NAME	SHEET NO.	SUB	FIN	BASE	NC MAT	ORTH FIN		ST	SO MAT	UTH FIN	WEST MAT F		NORTH FIN		AST FIN		JTH FIN	WE MAT		MAT	FIN	MAT	FIN	REMARK(S)	PAINT (INTERIOR & EXTERIOR) P-1 BENJAMIN MOORE - PLATINUM GRAY EXT. R
P01	STAIR #11	DB-A116X	CONC	CI-1	<u> </u>		P P-3	CMU	-	CONC	-	CONC		<u> </u>	-	-	-	-	-	-	EXP	P-3	_	_		P-2 BENJAMIN MOORE - HARBOR GRAY AC-25 P-3 BENJAMIN MOORE - WHITE INT-RM
P03	UTILITY ROOM #7	DB-A116X	CONC	EX-1	EX-1	CONC	-	СМИ	_	СМО	-	CONC	- -	T -	-	_	-	-	_	-	EXP	P-3	-	_		
P05	PLATFORM #1	DB-A116X	CONC	T-6/7/8	3 –		T-	-9/10/1	1/12/1	3, SEE	A501-A	505	_		_	_	-	-	-	-	CG-1	- 1	-	-	STAIR#1,#3: CI-1; NOTE A, F	WALL PANELS WP-1 REYNOBOND COLORWELD 500 BRIGHT SILVER METALL
P07	ESCALATOR CONTROL RM #3	DB-A113X	CONC	SLR	RB-1	GB	P-3	СМИ	_	GB	P-3	CONC	- -	-	-	_	_	-	-	-	EXP	P-3	-	_		WP-1A PEWTER PEWTER WP-2 CENTRIA CONCEPT CS-660 *
P09	COMM TERM #3	DB-A113X	CONC	SLR	RB-1	СМИ	_	СМИ	_	GB	P-3	CONC	- -	_	_	_	-	_	-	-	EXP	P-3	-	_		WP-3 PRE-CAST ARCHITECTURAL CONCRETE- PROVIDE GRAFFITI-RESISTANT COATINGS-
P11	UTILITY RM #1	DB-A111X	CONC	EX-1	EX-1	СМИ	_	СМИ	_	CMU	_	CONC	- -		-	_	-	_	_	_	EXP	P-3	-	_		PROVIDE GRAFFITI-RESISTANT COATINGS- SEE SPECIFICATION SECTION 09 96 33
P13	ELEV MACH #1	DB-A112X	CONC	SLR	RB-1	GB	P-3	СМИ	-	СМИ	-	CONC	- -	-	-	-	-	-	-	-	EXP	P-3	-	-		T-1 WAUSAU TERRAZZO TILES TZ 35 (24x24)
P15	MECHANICAL RM #1	DB-A112X	CONC	SLR	RB-1	GB	P-3	СМИ	_	GB	P-3	CONC	- -			_	_	_	_	-	EXP	P-3	_	_		T-2 WAUSAU TERRAZZO TILES WT2-774 (24x24) T-3 WAUSAU TERRAZZO TILES WT2-758 (24x24)
P17	ELEC RM #3	DB-A112X	CONC	SLR	RB-1	GB	P-3	СМИ	_	GB	P-3	CONC	- -			_	_	-	_	_	EXP	P-3	-	_		T-4 CROSSVILLE CROSS-COLORS ANTICO TAUPE B110
P19	FIRE DEPT STORAGE #1	DB-A112X	CONC	SLR	RB-1	GB	P-3	CMU	_	GB	P-3	CONC	- -		-	_	-	_	-	_	EXP	P-3	-	_		T-5 CROSSVILLE CROSS-COLORS TRUFFLE A876 T-6 CERIM AMBIENTE ROCK (12x24)
P21	SYSTEMS SERVICE STORAGE#1	DB-A112X	CONC	SLR	RB-1	GB	P-3	СМИ	_	GB	P-3	CONC	- -	_	-	-	-	_	-	_	EXP	P-3	-	-		T-7 PASTORELLI OPERA NATURAL BOHEME (12x24)
P23	ESCALATOR CONTROL RM #1	DB-A112X	CONC	SLR	RB-1	GB	P-3	СМИ	-	GB	P-3	CONC	- -		_	_	_	_	_	_	EXP	P-3	-	_		T-8 PASTORELLI OPERA NATURAL PARSIFAL (12x24) T-9 MIRAGE PLAIN NATURAL PURO 24"x24"(4.8mm)PA
P25	UTILITY CHASE ACCESS #1	DB-A111X	CONC	SLR	1	GB	P-3	СМП	-	GB	P-3	CONC	- -		_	_	_	_	_	-	EXP	P-3	_	_		T-10 MIRAGE PLAIN NATURAL PERLA 24"x24"(10mm)PA
P27	STAIR #5	DB-A111X	CONC	CI-1	RB-1	CONC	_	CONC	-	CONC, CMU/CP	_	CONC	- -	_	_	_	_	-	_	-	EXP	P-3	_	-		T-11 MIRAGE PLAIN NATURAL CENERE 6"x24"(10mm)PA T-12 MIRAGE PLAIN NATURAL NERO 24"x24"(10mm)PA
P29	STAIR #3	DB-A114X	CONC	CI-1	RB-1	GB	P-3	СМО	7	CONC/ MET	-	CONC/ MET	- -	_	_	_	_	-	_	-	EXP	P-3	-	-		T-13 CROWN METALIC GLAZES BRONZE BLEND STICK
P31 P33 P35	UTILITY RM #3	DB-A112X	CONC	EX-1	EX-1	СМИ	_	СМИ	-	СМИ	-	CONC		_	-	_	-	-	-	-	EXP	P-3	-	_		PLASTIC LAMINATE
P33	UTILITY RM #5	DB-A113X	CONC	EX-1	EX-1	СМИ	_	СМИ		СМИ	_	CONC		-	-	_	_	-	-	-	EXP	P-3	-	_		PL-1 FORMICA NATURELLE FINISH MILLENNIUM OAK
P35	STAIR #1	DB-A112X	CONC	CI-1	RB-1	CONC	-	CMU	-	GB	P-3	CONC		-	-	-	-	-	-	-	EXP	P-3	-	-		INTEGRAL COLORED CONCRETE WITH TRANSPARENT SEALE
1 1																										CI-1 SOLOMON INTEGRAL SLATE 920
N Z																										RUBBER BASE
P02	STAIR #12	DB-A116X	CONC	CI-1	RB-1	CMU/CF	P -	CONC	_	CONC	_	СМИ	<u> </u>	-	-	-	_	-	-	-	EXP	P-3	-	_		RB-1 ROPPE 114 LUNAR DUST P193
STATION P02 P04	UTILITY ROOM #8	DB-A116X	CONC	EX-1	EX-1	CONC	-	CONC	-	СМИ	-	СМИ		7	-	-	-	_	-	-	EXP	P-3	-	-		RESILIENT TILE FLOORING
P06	PLATFORM #2	DB-A116X	CONC	T-6/7/8	3 –		T-	-9/10/1	1/12/1	3, SEE	A501-A	505	_	-	-	_	A	_	-	-	CG-1	-	-	-	STAIR#2,#4: CI-1; NOTE A, F	RTF-1 ARMSTRONG EXCELON PEAT GRAY 52150
PO8	ESCALATOR CONTROL RM #4	DB-A113X	CONC	SLR	RB-1	GB	P-3	CONC	_	GB	P-3	CMU		-	-	7	-	-	-	-	EXP	P-3	-	-		SEAMLESS FLOORING
위 P10	COMM TERM RM #2	DB-A113X	CONC	SLR	RB-1	СМИ	_	CONC	_	GB	P-3	СМИ	_ _	_	_	- /	7-	_	-	-	EXP	P-3	-	_		EX-1 DEX-0-TEX EPOXY LIMESTONE 112
F12	UTILITY RM #2	DB-A111X	CONC	EX-1	EX-1	СМИ	_	CONC	_	СМИ	_	CMU		_	_	7	_	_	-	-	EXP	P-3	-	_		SUSPENDED CEILINGS
P14	ELEVATOR MACH #2	DB-A112X	CONC	SLR	RB-1	GB	P-3	CONC	_	СМО	_	СМИ	- -		_	_	-	-	-	1	EXP	P-3	-	_		CG-1 ARMSTRONG METALWORKS LINEAR UNPERFORATED *,**
P16	MECHANICAL RM #2	DB-A112X	CONC	SLR	RB-1	GB	P-3	CONC	_	GB	P-3	CMU	- -			_	-	-	-		EXP	P-3	-	_		CG-2 ARMSTRONG METALWORKS RH200 UNPERFORATED *,***
P18	ELEC RM #4	DB-A112X	CONC	SLR	RB-1	GB	P-3	CONC	_	GB	P-3	СМИ	- -			_	_	-	-	_	EXP	P-3	7_	_		METAL ROOF
P20	FIRE DEPT STORAGE #2	DB-A112X	CONC	SLR	RB-1	GB	P-3	CONC	_	GB	P-3	CMU	- -		_	_	_	-	-		EXP	P-3		-		RF-1 KALZIP CUSTOM COLOR TO MATCH 2034-5 BENJAMIN MOORE ACADIA GREEN
P22	SYSTEMS SERVICE STORAGE#2	DB-A112X	CONC	SLR	RB-1	GB	P-3	CONC	_	GB	P-3	CMU	_			_	_	-	-	_	EXP	P-3	_			FINISH CODE NOTES:
P24	ESCALATOR CONTROL RM #2	DB-A112X	CONC	SLR	RB-1	GB	P-3	CONC	_	GB	P-3	CMU	_		-	_	-	-	-	-	EXP	P-3		Santa (Clara Valley Transportation Authority	* COLOR TO MATCH WP-1.
P26	UTILITY CHASE ACCESS #2	DB-A111X	CONC	SLR	_	GB	P-3	CONC	_	GB	P-3	CMU	- -			_	_	-	-	-	EXP	-	/		EXCEPTIONS TAKEN (NET)	** NOMINAL 4' WIDE PANELS. *** NOMINAL 4'x10' PANEL SIZE.
P28	STAIR #6	DB-A111X	CONC	CI-1	RB-1	CONC	_	CONC	_	CONC, CMU/CP	_	CONC	- -			_	_	-	_	-	EXP	P-3	_	MA	KE CORRECTIONS NOTED (MCN) END AND RESUBMIT (A/R)	
P30	STAIR #4	DB-A114X	CONC	CI-1	RB-1	GB	P-3	CONC/ MET	-	CONC/ MET	_	CMU	- -				<u> </u>	_	_	_	EXP	P-3			wn above is subject to the terms of the contract elieve the Contractor of any of its obligations	FINISHES ABBREVIATIONS
P32	UTILITY RM #4	DB-A112X	CONC	EX-1	EX-1	CMU	_	CONC	-	CMU	-	CMU	- -				_	-	-	-	EXP	P-3			contract, including design and detailing.	ACT ACOUSTICAL CEILING TILE
P34	UTILITY RM #6	DB-A113X	CONC	EX-1	EX-1	GB	P-3	CONC	-	GB	P-3	CMU	- -				_	_	_	_	EXP	P-3	c	Contract No.	: DB11002F	CONC CONCRETE CG CEILING
F P36	STAIR #2	DB-A112X	CONC	CI-1	RB-1	CONC	_	CONC	-	GB	P-3	СМИ	- -			_	-	_	_	-	EXP	P-3	- I	Бу:	Date:	CI CONCRETE INTEGRAL COLORED CP CEMENT PLASTER
Extensi																										EXP EXPOSED
2. 3. 3. 3. 3. 3. 3. 3. 3. 3. 3. 3. 3. 3.	ALL CMU AND CONCRETE WALL TRANSPARENT SEALER PRIOR PROVIDE TACTILE TILES AND D PATTERN PLANS. RUBBER BASE SHALL BE INST. ON SCHEDULE. PLATFORM "WALLS" REFER TO WALLS SURROUNDING ROOMS ESCALATORS, AND AT FULL HE	TO PAINTING. IRECTIONAL ALLED ON G THE FINISHE LOCATED AT	TILES AS YPSUM E ES ON TI THE UN	S INDICATE BOARD WA THE EXTER IDERSIDE	ED ON F ALLS ONI RIOR FAC	LY, U.O E OF		0. SE 7. AL 8. TR. CE 9. SE SC	DERSIDE E FLOOF _ FLOOR ANSITION NTERLINI E "OTHE HEDULE.	OF MER PATTE SURFA	TAL DEC RN PLAI ICES SH IEEN DIS OOR. HES" FO	TO BE TO C CK WHEN ST NS A450 TO ALL BE NON SSIMILAR FLO DR FINISHES	RUCTURE A465 F(I—SLIP. OOR MATE	IS EXPO R LAYOU RIALS SI	OSED. UT OF FI	_OOR FIN	NISHES.	A. B. C. D. E. F. G. H.	GRILLES COLOR. CURTAIN EXPOSEI CEMENT CONCOU EXPOSEI ACOUSTI	DRAFT IN AND DI WALL SO METAL PLASTE RSE FLO CONC CAL CEIS AROUI	IFFUSERS SYSTEMS: COLUMI FR FINISH OOR OPE	E: PAINT FINISH S, BEAN JES ON E SININGS: F CHES AN ES: WHITI JEHTS: P	TO MA TO MA MS, TRU BOTH S PAINT F D COLI AINT P	TCH ADA TCH WP USSES, SIDES O P-2. UMNS: F	DRS: TILE T-9. JACENT WALL OR CEILING P-1. DIAGONAL BRACES: PAINT P-1. F WALLS SURROUNDING PAINT P-2.	FIN FINISH GB GYPSUM BOARD GWS GLASS WALL SYSTEM L LOUVERS RTF RESILIENT TILE FLOORING MET METAL P PAINT PLAM PLASTIC LAMINATE RB RUBBER BASE SLR SEALER, TRANSPARENT T TILE WP WALL PANEL
26, 2013 - 3:11				 S.	GNED BY DEBNATH WN BY COLLADO		SED AR	C4	2,70.			Skansk Shimmi	a Ck 1436 Milpite	California Circ is, California S	le 15035			1.	LOUVERS	ON E	A I E RIUK					CK, STATIONS AND SYSTEMS CADD FILENAME C700-S-DB-A701.dwg SIZE SCALE
5 0 2013071 8 REV DATE		NSTRUCTION DESCRIPTION		E. IN C R.	CKED BY BALLADA CHARGE BARLAAN	<u>\</u>	No. C215	23 T	SUBMITTE	1970 Broadway Phone: (510)	y, Suite 525 0 635-2537 Fax:	Herzog ssociates, II skind, CA 94612 (610) 535-2339	^{16.}	Lockwood & Newnam	Andrews T.	Y-LIN INTE	RNATIONA	<u> </u>		B	ART SILIC	1 . S	ILIC	ON	VALLEY	MILPITAS STATION

											INT	ERIO	R FIN	NISH	SCH	EDUL	E											
	ROOM		REFERENCE		FLOOR					W	ALL							WAIN	ISCOT				CEIL	_ING	SOF	FIT	25/42/(0)	1. S
AREA	NO	ROOM NAME	SHEET NO.	SUB	FIN	BASE	NOF MAT	RTH FIN	MAT EA	ST	SOL	JTH FIN	MAT WE	ST FIN	NO MAT	RTH FIN	EA MAT	ST FIN	SOI	UTH FIN	MAT	ST FIN	MAT	FIN	MAT	FIN	- REMARK(S)	1. S 2. S 3. S
	C01	PAID AREA	DB-A123X	CONC	T-1/2/	3 –	WP-1	-	WP-1	-	WP-1	-	WP-1	-	-	-	-	-	-	-	-	-	EXP	P-2	CG-2	-	STAIR #1, #2: CI-1; NOTE D, E	
	C02	FREE AREA	DB-A125X	CONC	T-1/2/3	3 –	WP-1	-	WP-1	_	WP-1	-	WP-1	-	-	_	-	_	-	-	_	-	EXP	P-2	CG-2	_	NOTE D	
	C03	PAID AREA	DB-A125X	CONC	T-1/2/3	3 –	WP-1	-	WP-1	-	WP-1	-	WP-1	-	_	_	_	-	_	_	_	_	EXP	P-2	CG-2	-	STAIR #3, #4: CI-1; NOTE D, E	
	C04	NOT USED	-	-	-	_	-	-	_	-	-	-	-	-	1	_	_	_	-	_	_	-	-	_	-	1		
	C05	CORRIDOR	DB-A121X	CONC	SLR	RB-1	GB	P-3	GB	P-3	GB	P-3	-	-	_	_	_	_	-	_	_	_	GB	P-3	-	-		
	C06	ELECTRICAL RM #1	DB-A125X	CONC	SLR	RB-1	GB	P-3		P-3	GB	P-3	GB	P-3	_	_	-	_	-	-	_	-	EXP	P-3	-	_		
	C07	VTA COMM ROOM	DB-A125X	CONC	SLR	RB-1	GB	P-3	GB	P-3	GB /WP-1	P-3	GB	P-3	-	_	-	-	_	-	_	_	GB	P-3	-	-		
	C08	POLICE ROOM	DB-A123X	CONC	RTF-1	RB-1	GB	P-3	GB	P-3	GB	P-3	CONC	P-3	-	-	-	-	-	-	-	-	CP	P-3	-	-		
	C09	SECURED INTERVIEW RM	DB-A123X	CONC	RTF-1	RB-1	WIRE		GB	P-3	GB	P-3	WIRE	-	-	_	_	_	_	_	_	_	CP	P-3	-	-		
	C10	MAINT ENGR OFFICE	DB-A123X	CONC	SLR	RB-1	GB /WP-1	P-3	GB	P-3	CP	P-3	CONC	P-3	-	-	-	_	-	-	_	_	GB	P-3	-	-		
	C11	VESTIBULE	DB-A123X	CONC	SLR	RB-1	GB	P-3	GB	P-3	GB	P-3	GB	P-3	-	_	-	-	_	-	_	_	GB	P-3	-	-		
	C12	VALVE ROOM	DB-A121X	CONC	SLR	RB-1	CMU/CP	-	CMU/CF	_	CMU/CP	-	СМU/СР	-	_	_	-	-	-	_	_	_	EXP	P-3	-	_		
	C13	STORAGE RM. #2	DB-A123X	CONC	SLR	RB-1	GB	P-3	GB	P-3	GB	P-3	СМИ	P-3	_	_	_	_	-	_	_	_	GB	P-3	-	_		
	C14	TELCO ROOM	DB-A123X	CONC	SLR	RB-1	GB	P-3	GB	P-3	GB	P-3	CONC	P-3	-	_	-	-	-	-	_	-	EXP	P-3	-	_		
	C15	ELEV/ESC STORAGE RM.	DB-A121X	CONC	SLR	RB-1	GB	P-3	GB	P-3	СР	P-3	CONC	P-3	-	_	-	-	-	-	_	-	EXP	P-3	-	-		
	C16	SMOKE VENT FAN RM. #1	DB-A121X	CONC	SLR	_	GB	P-3	L4	P-3	GB	P-3	GB	P-3	-	_	_	-	_	_	_	_	-	-	-	-	NO ROOF	
	C17	TC/C BATTERY	DB-A121X	CONC	EX-1	EX-1	GB	P-3	GB	P-3	CMU	/-	CONC	P-3	T-5	-	T-5	_	T-5	-	T-5	-	GB	P-3	-	_	8'-0" HIGH WAINSCOT	
ᆝ닗ᅵ	C18	TRAIN CONTROL/COMM RM	DB-A121X	CONC	SLR	RB-1	GB	P-3	CMU/GE	-	GB	P-3	GB	P-3	_	-	-	_	-	-	_	-	GB	P-3	-	_		
CONCOURSE	C19	GROUNDS MAINT OFFICE	DB-A121X	CONC	SLR	RB-1	CONC	-	GB	P-3	GB	P-3	CONC	-	_		-	-	-	-	-	-	GB	P-3	-	-		
[ਨ੍ਹ]	C20	STAIR #6	DB-A121X	CONC	CI-1	RB-1	WP-2	-	WP-2	-	CP	P-3	CP	P-3	-	-	-	_	-	-	-	-	EXP	P-3	-	-		
١×١	C21	STAIR #5	DB-A121X	CONC	CI-1	RB-1	WP-2	_	CP	P-3	CP	P-3	WP-2	-		_	-	-	-	-	-	-	EXP	P-3	-	-		
8	C22	TRASH	DB-A121X	CONC	SLR	_	СМИ	-	СМИ	-	CMU	_	СМИ	-	-	2	-	7	-	_	_	_	GB	P-3	-	_		
Z	C23	TC/C HVAC RM	DB-A121X	CONC	SLR	RB-1	GB	P-3	L4	-	GB	P-3	GB	P-3	-	-	-	-	-/	-	_	_	GB	P-3	-	_		
[일]	C24	ELECTRICAL RM #2	DB-A122X	CONC	SLR	RB-1	CP	P-3	L3	-	GB /WP-1	P-3	GB	P-3	_	-	-	/-	7	-	-	_	GB	P-3	-	_		
STATION	C25	JAN. ROOM	DB-A121X	CONC	RTF-1	RB-1	GB	P-3	GB	P-3	GB	P-3	GB	P-3	_	-	-	_	/- /	-)	7	_	GB	P-3	-	_		
"	C26	LOCKER ROOM	DB-A121X	CONC	RTF-1	RB-1	GB	P-3	GB	P-3	GB	P-3	GB	P-3	_	-	-	- 4	-	-/	7- /		GB	P-3	_	_		
	C27	RESTROOM	DB-A121X	CONC	T-4	T-5	GB/T-5	_	T-5	<u> </u>	T-5	_	GB/T-5	_	_	<u> </u>	-	_	-	/- 7	-	-	GB	P-3	_	_	COMPLETE COVE BASE WITH FACTORY CORNERS	
	C28	VESTIBULE	DB-A122X	CONC	RTF-1	RB-1	GB	P-3	GB	P-3	GB	P-3	GB	P-3	_	-	-	_	-	7	-	-	GB	P-3	-	_	OUNTERNO	
	C29	BATTERY RM.	DB-A121X	CONC	EX-1	EX-1	GB	P-3	GB	P-3	GB	P-3	GB	P-3	T-5	-	T-5	_	T-5	-	T-5		GB	P-3			8'-0" HIGH WAINSCOT	
	C30	MECHANICAL ROOM	DB-A121X	CONC	SLR	RB-1	GB	P-3	GB	P-3	GB	P-3	GB	P-3	_	-	-	_	-	-	-		-	7-	-			
	C31	STAFF BREAK ROOM	DB-A121X	CONC	RTF-1	RB-1	GB	P-3	GB	P-3	GB	P-3	GB	P-3	_	-	-	_	-	-	-	-	ACT	S- /	-	-/	CABINETS: PL-1; NOTE G	
	C32	WOMEN	DB-A122X	CONC	T-4	T-4	T-5	-	T-5	_	T-5	_	T-5	-	_	_	-	_	-	-	_	_	CP	P-3	7-	+	COMPLETE COVE BASE WITH FACTORY CORNERS	
	C33	MEN	DB-A122X	CONC	T-4	T-4	T-5	_	T-5	_	T-5	_	T-5	_	_	_	_	_	-	_	_	_	CP	P-3	_	- 7	COMPLETE COVE BASE WITH FACTORY CORNERS	
	C34	TREASURY VAULT	DB-A122X	CONC	SLR	RB-1	CMU/GB	P-3	CONC /GB	P-3	CMU/GB	_	CMU/GB	P-3	_	_	_	_	-	_	_	_	CP	P-3	_	_	CONVERS	
	C35	STORAGE #1	DB-A122X	CONC	SLR	RB-1	СМИ	P-3	CONC	P-3	GB /WP-1	P-3	GB	P-3	_	_	_	_	-	_	_	_	EXP	P-3	-	_		
	C36	EMP RM	DB-A124X	CONC	RTF-1	RB-1	GB	P-3	СМИ	P-3	GB	P-3	GB	P-3	_	-	-	_	-	-	_	-	GB	P-3	-	_		
	C37	COMM TERM #1	DB-A124X	CONC	SLR	RB-1	GB	P-3	CMU	P-3	GB	P-3	GB	P-3	_	_	_	_	-	_	_	_	EXP	P-3	_	_		
	C38	LOST & FOUND	DB-A124X		SLR	RB-1	GB	P-3	CMU	P-3	GB /WP-1	P-3	GB	P-3	_	_	-	_	-	_	_	_	GB	P-3	_	_		
	C39	STAIR #11	DB-A128X	CONC	CI-1	<u> </u>	СМИ	_	СМИ	_	CMU	_	CMU	_	_	_	-	_	-	-	_	-	EXP	P-2	_	_		
	C40	STAIR #12	DB-A128X	CONC	CI-1	<u> </u>	СМИ	_	CMU	_	CMU	_	CMU	_	_	_	_	_	_	_	_	_	EXP	P-3	_	_		
	C41	STRETCHER STORAGE	DB-A122X	CONC	RTF-1	RB-1	GB	P-3	GB	P-3	GB	P-3	GB	P-3	_	_	_	_	-	_	_	_	GB	P-3	_	_		
	C42	STAIR #1	DB-A123X		CI-1	_	CP	_	CP	_	_	_	GWS	_	_	_	_	_	-	_	_	_	EXP	P-2	_	_		
	C43	STAIR #2	DB-A122X		CI-1	<u> </u>	GB /WP-1	_	GWS	_	_	_	GB /WP-1	_	_	_	_	_	_	_	_	_	EXP	P-3	_	_		
	C44	STAIR #3	DB-A125X		CI-1	1 -	/WP=1	_	CP	-	GWS	_	GWS	_	_	-	-	_	-	-	_	-	EXP	P-2	_	_		
	C45	STAIR #4	DB-A124X	-	CI-1	<u> </u>	_	_	GWS	<u> </u>	GWS	_	CP	_	_	_	_	_	-	_	_	_	EXP	P-3	_	_		
	C46	SMOKE VENT FAN RM. #2	DB-A121X	_	SLR	<u> </u>	GB	P-3	L4	_	GB	P-3	GB	P-3	_	_	_	_	-	_	_	_		_	_	_		
		,	<u> </u>			DESIGNED E S. DEB				<u> </u>				anska	1								I				LINE TDAO	
						DRAWN BY R. COLL		& NED	ARCH DEBNA				Shi	mmic		6 California (itas, Californi	Circle a 95035									EΔ	RT LINE, TRACK	K, SI. ESIGN
						CHECKED B E. BALL	Y	12/8	£ (He	erzog		oint Venture									611		N WALLEY	MILPIT
	0170710	DEADINESS FOR S	ONICTOLICTICS	1		IN CHARGE R. BAR		O. No.	C21523) a	Ani 1970 Br	I Verm. oadway, Suite 53 (510) 835-253	ASSOCI 25 Ookland, CA (\$10),535	ates, In	c. <u> </u>	Lockwo & Newn	ed, Andrews am, inc.	T-Y-LIN II	ŅTERNAŢI	ONAL				# # 7 2 ₀	21L	ico		CIVILO:
REV 2	0130710 DATE	BY SUB APP	DESCRIPTION	ı		DATE 2013		(F OF	CALIFOR	SUB	AITTED	/	Fox: (610) 535		API	PROVED .	R.	1401k	NTERNATION OF THE PROPERTY OF				BART S	SILICON	VALLEY	BERRY	ESSA EXTENSION	FINISH
																		-									L	

NOTES

- SEE DWG. DB-A701 FOR FINISH CODES AND NOTES. SEE DWG. DB-A701 FOR FINISHES ABBREVIATIONS. SEE DWG. DB-A703 FOR GLAZING SCHEDULE.

Santa Clara Valley Transportation Authority

___NO EXCEPTIONS TAKEN (NET)

__MAKE CORRECTIONS NOTED (MCN)

__AMEND AND RESUBMIT (A/R)

Any action shown above is subject to the terms of the contract and does not relieve the Contractor of any of its obligations under the contract, including design and detailing.

DB11002F Contract No.:

Date:

STATIONS AND SYSTEMS GN UNIT 023 PITAS STATION

> FINISH SCHEDULE SHEET 2 OF 3

CADD FILENAME C700-S-DB-A702.dwg SIZE SCALE D NONE CONTRACT NO. C700 0

AREA CODE SHEET NO. PAGE NO. DB A702 0505

											INT	ERIO	R FII	NISH	SCH	EDUL	E											
	ROOM		REFERENCE	-	FLOOR					W	ALL							WAIN	SCOT				CEI	LING	SOI	FFIT	25,412,4(0)	
AREA	NO	ROOM NAME	SHEET NO.	SUB	FIN	BASE	NOF MAT	RTH FIN	EA MAT	ST FIN	SO MAT	UTH FIN	MAT	ST	NO MAT	RTH FIN	EA MAT	ST FIN	SO! MAT	JTH FIN	MAT WE	ST FIN	МАТ	FIN	МАТ	FIN	- REMARK(S)	1. 2.
	P0C1	POC ELEV LOWER LOBBY	DB-A125X	CONC	SLR	-	-	-	GB/WP	-	GB/WP		GP/CP	_	-	-	-	-	-	-	-	-	-	-	-	-	_	
	POC2	POC ESC CONTROL RM	DB-A125X	CONC	SLR	-	GB/CP	P-3	GB/CP	P-3	GB	P-3	GB/WP	-	_	-	_	-	_	_	_	_	-	-	-	-	_	
	POC3	POC ELEV MACHINE RM	DB-A125X	CONC	SLR	_	GB/CP	P-3	GB/CP	P-3	GB	P-3	GB/WP	_	-	_	-	_	-	-	-	-	_	_	-	-	-	
빌	POC4	VESTIBULE	DB-A125X	CONC	SLR	_	GB/CP	P-3	GB/CP	P-3	GWS	_	GB/WP	_	_	_	_	_	_	_	_	_	_	-	-	_	_	
MEZZANINE	POC5	CONCESSION	DB-A125X	CONC	SLR	_	GB/CP	P-3	GB/CP	P-3	GWS	_	GB/WP	_	_	_	_	_	_	_	_	_	-	-	-	-	_	
727																												
୴	MO1	STAIR VENT FAN ROOM #1	DB-A133	CONC	SLR	-	GB/CP	P-3	GB/CP	P-3	GB/CP	P-3	GWS	-	_	_	_	_	_	_	_	_	-	_	_	-	-	
	M02	STAIR VENT FAN ROOM #2	DB-A133	CONC	SLR	!	GB/CP	P-3	GWS	-	GB/CP	P-3	GB/CP	P-3	_	_	_	_	_	_	_	_	-	-	-	-	-	
은	м03	STAIR VENT FAN ROOM #3	DB-A133	CONC	SLR	-	GB/CP		GB/CP	P-3	GB/CP			-	_	_	_	_	_	_	-	_	-	-	-	-	-	
STATION	M04	STAIR VENT FAN ROOM #4	DB-A133	CONC	SLR	-	GB/CP	P-3	GWS	_	GB/CP	P-3	GB/CP	P-3	-	-	-	-	-	-	-	-	-	-	-	-	-	
ا _د				\ \ \ \ \ \ \ \ \ \ \ \ \ \ \ \ \ \ \																								
						4																						

GLAZING SCHEDULE

											_
1 CLEAR TEMPERED 1/4" NONE INCLUDING BART STANDARD KIOSK 5 LAMINATED CLEAR 1/2" NONE FRAMELESS GLASS WALL SYSTEM TYPE 2 2 LAMINATED TINTED 3/8" GRAY UON GLASS WALL SYSTEM TYPES 1, 2, 3 6 LAMINATED TINTED TEMPERED 3/4"* GRAY SKYLIGHT *½" / ¼" LAMINATIONS 3 LAMINATED CLEAR 1/2" x 3/4" LAMINATIONS * 1/2" x 3/4" LAMINATIONS	TYPE	DESCRIPTION	THICKNESS	COLOR	USE	TYPE	DESCRIPTION	THICKNESS	COLOR	USE	
2 LAMINATED TINTED 3/8" GRAY UON GLASS WALL SYSTEM TYPES 1, 2, 3 6 LAMINATED TINTED TEMPERED 3/4"* GRAY SKYLIGHT *½" / ¼" LAMINATIONS 3 LAMINATED CLEAR 1/2" NONE GUARDRAILS, * 1/2" x 3/4" LAMINATIONS		OLEAD TEMPEDED	1 /4"	NONE	ALL MAP, SCHEDULE & ADVERTISING DISPLAY CASES	4	LAMINATED TINTED	1/2"	GRAY UON	FRAMELESS GLASS WALL SYSTEM TYPE 1,	
3 LAMINATED CLEAR 1/2" NONE GUARDRAILS, * 1/2" x 3/4" LAMINATIONS	1	CLEAR TEMPERED	1/4	NONE	INCLUDING BART STANDARD KIOSK	5	LAMINATED CLEAR	1/2"	NONE	FRAMELESS GLASS WALL SYSTEM TYPE 2	
3 LAMINATED CLEAR 1/2" NONE GUARDRAILS, * 1/2" x 3/4" LAMINATIONS	2	LAMINATED TINTED	3/8"	GRAY UON	GLASS WALL SYSTEM TYPES 1, 2, 3	6	LAMINATED TINTED TEMPERED	3/4"*	GRAY	SKYLIGHT *½" / ¼" LAMINATIONS	Any
	3	LAMINATED CLEAR	1/2"	NONE	GUARDRAILS,						and
									5		


NO	TES	

- . SEE DWG. DB-A701 FOR FINISH CODES AND NOTES. SEE DWG. DB-A701 FOR FINISHES ABBREVIATIONS.

Sar	ıta Clara Valle	ey Transpo	rtation A	uthority	
	NO EXCEPT	IONS TAE	KEN (NE'	Γ)	
	MAKE CORI	RECTION	S NOTE	O (MCN)	
	AMEND ANI	D RESUBN	IIT (A/R)	
nd does r	shown above i not relieve the the contract,	Contracto	r of any o	f its oblig	ations
a	**	DD1100	ar.		

3:2								
13 -							DESIGNED BY S. DEBNATH	
201							DRAWN BY	
26,							B. ITURALDE	
٩							CHECKED BY E. BALLADA	
							IN CHARGE	
ઠ્ઠ	0	20130710				READINESS FOR CONSTRUCTION	R. BARLAAN	
JosephG	REV	DATE	BY	SUB	APP	DESCRIPTION	DATE 20130710	
7				_	_			



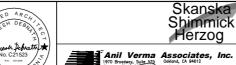







LINE, TRACK, STATIONS AND SYSTEMS DESIGN UNIT 023 MILPITAS STATION


> FINISH SCHEDULE SHEET 3 OF 3

S	(FILEN. C700-	AME -S-DB-A703	5.dwg
	SIZE D	SCALE	NONE	
	CONT	RACT N	°. C700	REV. O
	AREA	CODE	SHEET NO.	PAGE NO.
	D	В	A703	0506

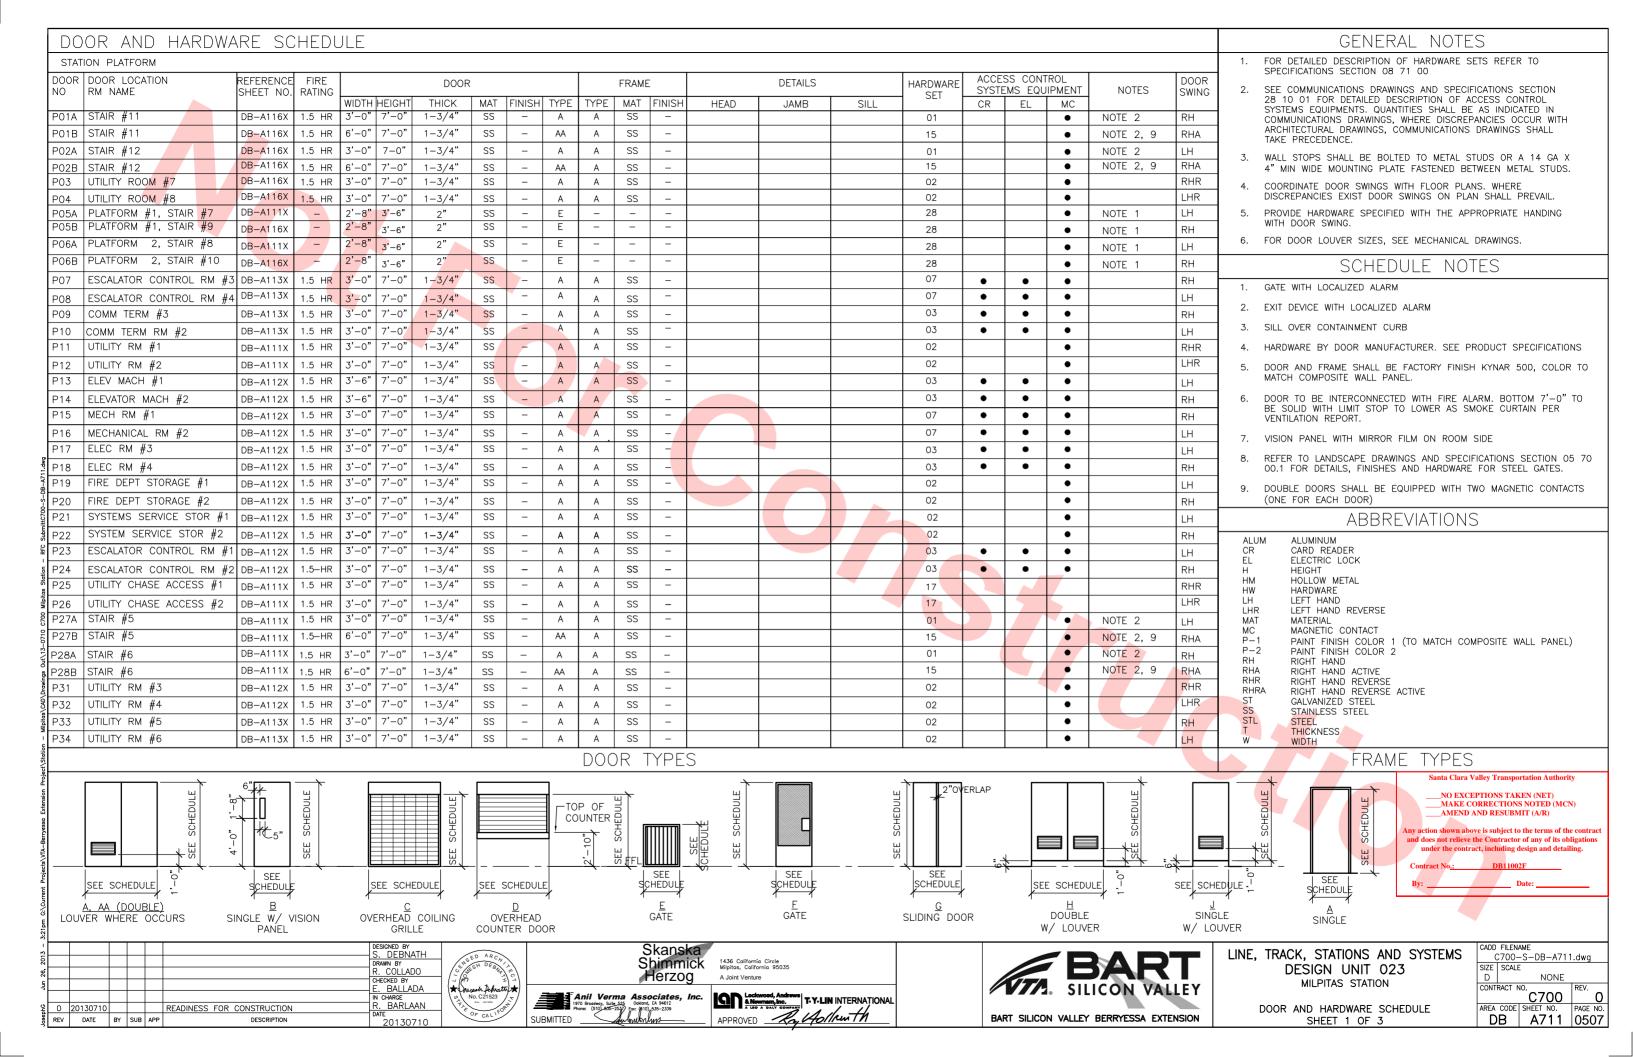


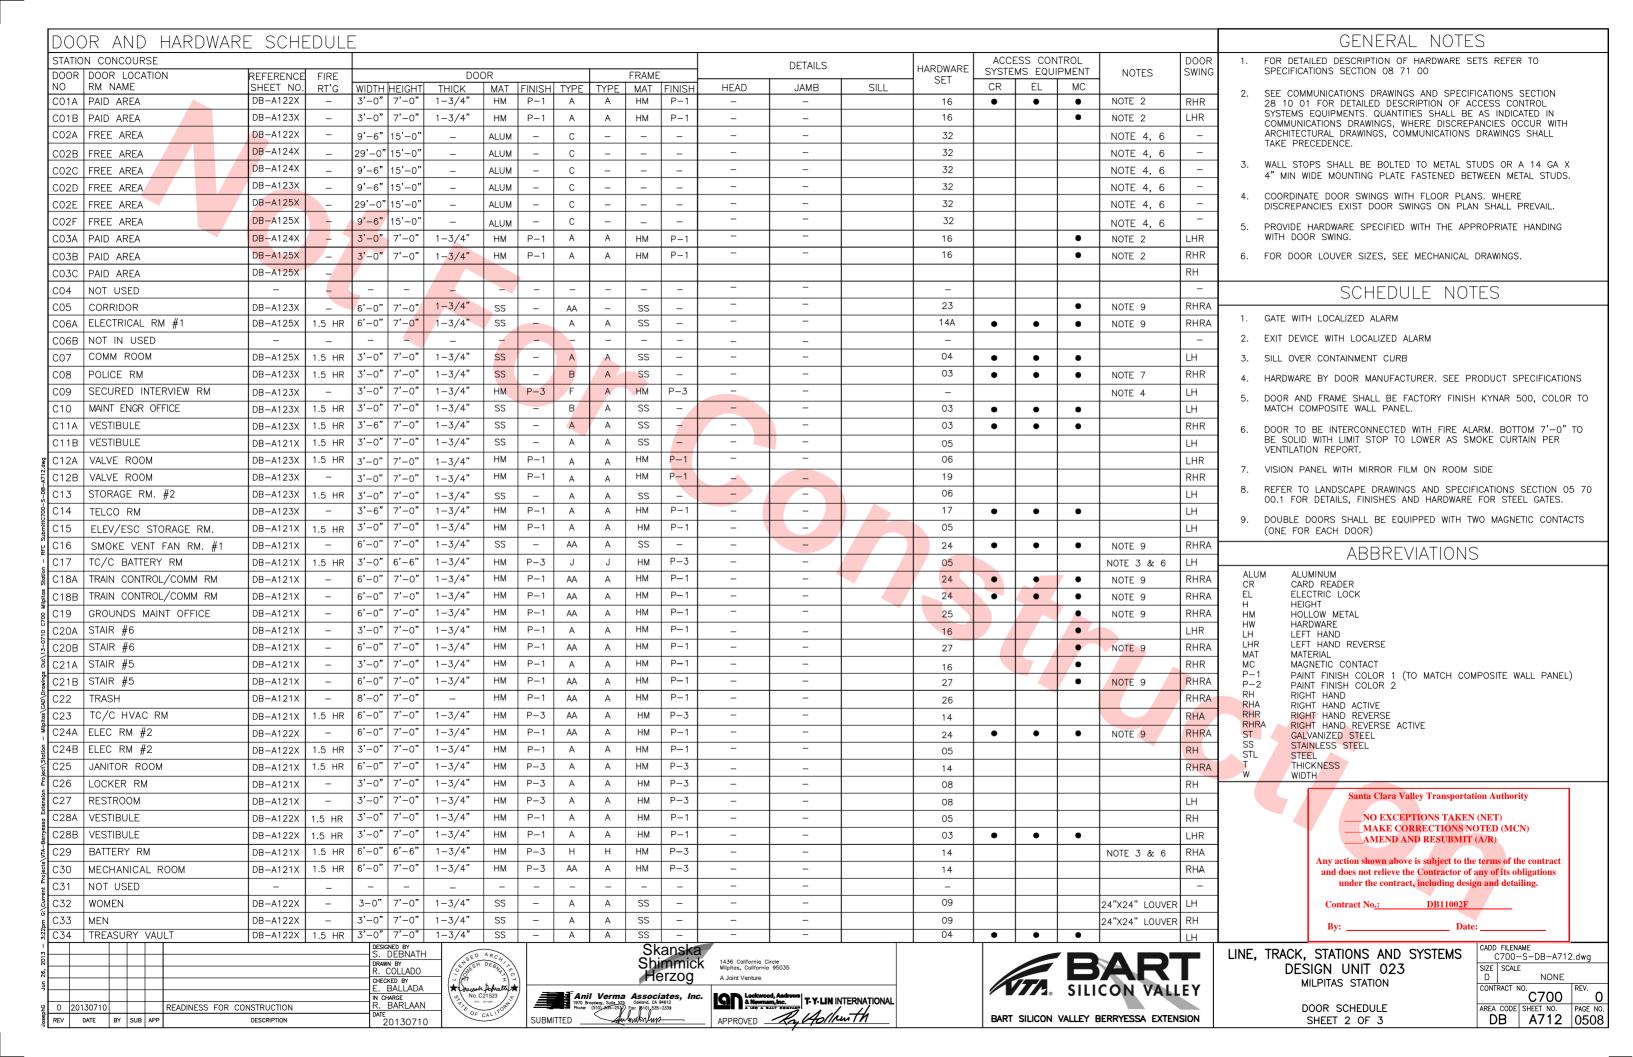

	OR AND HARDWAF	RE SCI	HEDU	LE ((CON	T'D)																
DOOR		REFERENCE	FIRE			DOC)R				FRAME			DETAILS		HARDWARE	ACCE SYSTI	SS CON	TROL JIPMENT	NOTES	DOOR SWING	-
NO	RM NAME	SHEET NO.	RATING		HEIGHT	THICK	MAT	FINISH	TYPE	TYPE	MAT	FINISH	HEAD	JAMB	SILL	SET	CR	EL	MC		311110	
C35	STORAGE #1	DB-A122X	1.5 HR	3'-0"	7'-0"	1-3/4"	SS	_	Α	A	SS	_				06					LH	
C36	EMP ROOM	DB-A124X	1.5 HR	3'-0"	7'-0"	1-3/4"	SS	-	A	A	SS	_				04	•	•	•		RH	
C37	COMM TERM #1	DB-A124X	1.5 HR	3'-0"	7'-0"	1-3/4"	SS	_	A	A	SS	-				04	•	•	•		LH] ;
C38A	LOST & FOUND	DB-A124X	1.5 HR	3'-0"		1-3/4"	SS	_	Α	A	SS	_				06			•		LH	
C38B	LOST & FOUND	DB-A124X	1.5 HR	7'-0"	5'-2"	-	SS	_	D	_	SS	_								NOTE 10	_	╛.
C39A	STAIR #11	DB-A128X		6'-0"		1-3/4"	НМ	P-1	AA	A	НМ	P-1				27			•			
C39B	STAIR #11	DB-A128X	-	3'-0"	7'-0"	1-3/4"	НМ	P-1	Α	A	НМ	P-1				16			•		RHR	
C40A	STAIR #12	DB-A128X	_	6'-0"	7'-0"	1-3/4"	НМ	P-1	AA	A	НМ	P-1				27			•	NOTE 9	RHRA	
C40B	STAIR #12	DB-A128X	-	3'-0"	7'-0"	1-3/4"	НМ	P-1	Α	A	НМ	P-1				16			•		LHR	
C41	STRETCHER STORAGE	DB-A122X	1.5 HR	3'-0"	7'-0"	1-3/4"	НМ	P-3	G	А	НМ	P-3				05					LHR	
C46	SMOKE VENT FAN ROOM #2	DB-A121X	- (6'-0"	7'-0"	1-3/4"	SS	-	AA	A	SS	_				24	•	•	•	NOTE 9	RHRA	
] `
MO1	STAIR VENT FAN ROOM #1	DB-A133	1.5 HR	3'-0"	7'-0"	1-3/4"	НМ		Α	Α	НМ					06					RH] '
M02	STAIR VENT FAN ROOM #1	DB-A133	1.5 HR	3'-0"	7'-0"	1-3/4"	НМ		Α	Α	НМ					06					LH] :
																						1.
																						7 '
																						1
																						7 :
																						7 8
POC1	POC ELEV LOWER LOBBY	DB-A125X	-	7'-0"	10'-0""	_	SS	_	С	_	SS	-/									_	1
POC2	POC ESC CONTROL RM	DB-A125X	_	3'-0"	7'-0"	1-3/4"	SS	_	Α	А	SS	-				20					LH	7 9
POC3	POC ELEV MACHINE RM	DB-A125X	_	3'-0"	7'-0"	1-3/4"	SS	-	Α	Α	SS	-				20					LH	1
POC4	VESTIBULE	DB-A125X	-	3'-0"	7'-0"	1-3/4"	SS	-	Α	Α	SS	-				20					LH	1 1
POC5A	CONCESSION	DB-A125X	_	3'-0"	7'-0"	1-3/4"	SS	-	Α	А	SS	_				20					RH	1_
POC5B	CONCESSION	DB-A125X	_	11'-0"	5'-2"	_	SS	-	D	-	SS	-								INSULATED	-	1
<u>a</u>																						
Mileitas (GAD) Drawings Out (13-0710 C700 Mileitas Station - Rif	LHR	ROOM			PH −					ROOM		R	HA - - HRA					7	5			

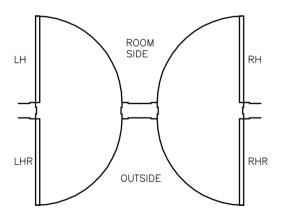



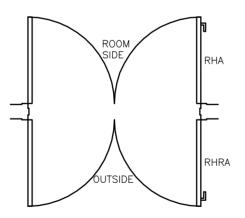

DOOR SWING DOUBLE

GENERAL NOTES

- FOR DETAILED DESCRIPTION OF HARDWARE SETS REFER TO SPECIFICATIONS SECTION 08 71 00
- SEE COMMUNICATIONS DRAWINGS AND SPECIFICATIONS SECTION 28 10 01 FOR DETAILED DESCRIPTION OF ACCESS CONTROL SYSTEMS EQUIPMENTS. QUANTITIES SHALL BE AS INDICATED IN COMMUNICATIONS DRAWINGS, WHERE DISCREPANCIES OCCUR WITH ARCHITECTURAL DRAWINGS, COMMUNICATIONS DRAWINGS SHALL TAKE PRECEDENCE.
- 3. WALL STOPS SHALL BE BOLTED TO METAL STUDS OR A 14 GA X 4" MIN WIDE MOUNTING PLATE FASTENED BETWEEN METAL STUDS.
- COORDINATE DOOR SWINGS WITH FLOOR PLANS, WHERE DISCREPANCIES EXIST DOOR SWINGS ON PLAN SHALL PREVAIL.
- PROVIDE HARDWARE SPECIFIED WITH THE APPROPRIATE HANDING WITH DOOR SWING.

SCHEDULE NOTES

- 1. GATE WITH LOCALIZED ALARM
- 2. EXIT DEVICE WITH LOCALIZED ALARM
- 3. SILL OVER CONTAINMENT CURB

ALUMINUM

ALUM

- 4. HARDWARE BY DOOR MANUFACTURER. SEE PRODUCT SPECIFICATIONS
- DOOR AND FRAME SHALL BE FACTORY FINISH KYNAR 500, COLOR TO MATCH COMPOSITE WALL PANEL.
- DOOR TO BE INTERCONNECTED WITH FIRE ALARM. BOTTOM 7'-0" TO BE SOLID WITH LIMIT STOP TO LOWER AS SMOKE CURTAIN PER VENTILATION REPORT.
- 7. VISION PANEL WITH MIRROR FILM ON ROOM SIDE
- REFER TO LANDSCAPE DRAWINGS AND SPECIFICATIONS SECTION 05 70 00.1 FOR DETAILS, FINISHES AND HARDWARE FOR STEEL GATES.
- DOUBLE DOORS SHALL BE EQUIPPED WITH TWO MAGNETIC CONTACTS (ONE FOR EACH DOOR)
- 10. PROVIDE FUSIBLE LINK OR ELECTRIC HEAT DETECTOR.

ABBREVIATIONS

CR	CARD READER
EL	ELECTRIC LOCK
Н	HEIGHT
HM	HOLLOW METAL
HW	HARDWARE
LH	LEFT HAND
LHR	LEFT HAND REVERSE
MAT	MATERIAL
MC	MAGNETIC CONTACT
P-1	PAINT FINISH COLOR 1 (TO MATCH COMPOSITE WALL PANEL)
P-2	PAINT FINISH COLOR 2
RH	RIGHT HAND
RHA	RIGHT HAND ACTIVE
RHR	RIGHT HAND REVERSE
RHRA	RIGHT HAND REVERSE ACTIVE
ST	GALVANIZED STEEL
SS	STAINLESS STEEL
STL	STEEL
T	THICKNESS
W	WIDTH

Santa Clara Valley Transportation Authority

NO EXCEPTIONS TAKEN (NET) _MAKE CORRECTIONS NOTED (MCN) AMEND AND RESUBMIT (A/R)

Any action shown above is subject to the terms of the contract and does not relieve the Contractor of any of its obligations under the contract, including design and detaili

3:2							
3							DESIGNED BY S. DEBNATH
201							DRAWN BY
56,							R. COLLADO
Jun							CHECKED BY E. BALLADA
							IN CHARGE
٤	0	20130710				READINESS FOR CONSTRUCTION	R. BARLAAN
Josep	REV	DATE	BY	SUB	APP	DESCRIPTION	DATE 20130710







1436 California Circle Milpitas, California 95035 A Joint Venture








LINE, TRACK, STATIONS AND SYSTEM DESIGN UNIT 023 MILPITAS STATION


> DOOR SCHEDULE SHEET 3 OF 3


10		FILEN		
/IS	(2700-	-S-DB-A713	3.dwg
	SIZE	SCALE	<u> </u>	
	D		NONE	
	CONT	RACT N		REV.
			C700	0
			SHEET NO.	PAGE NO.
	l D	В	A713	0509

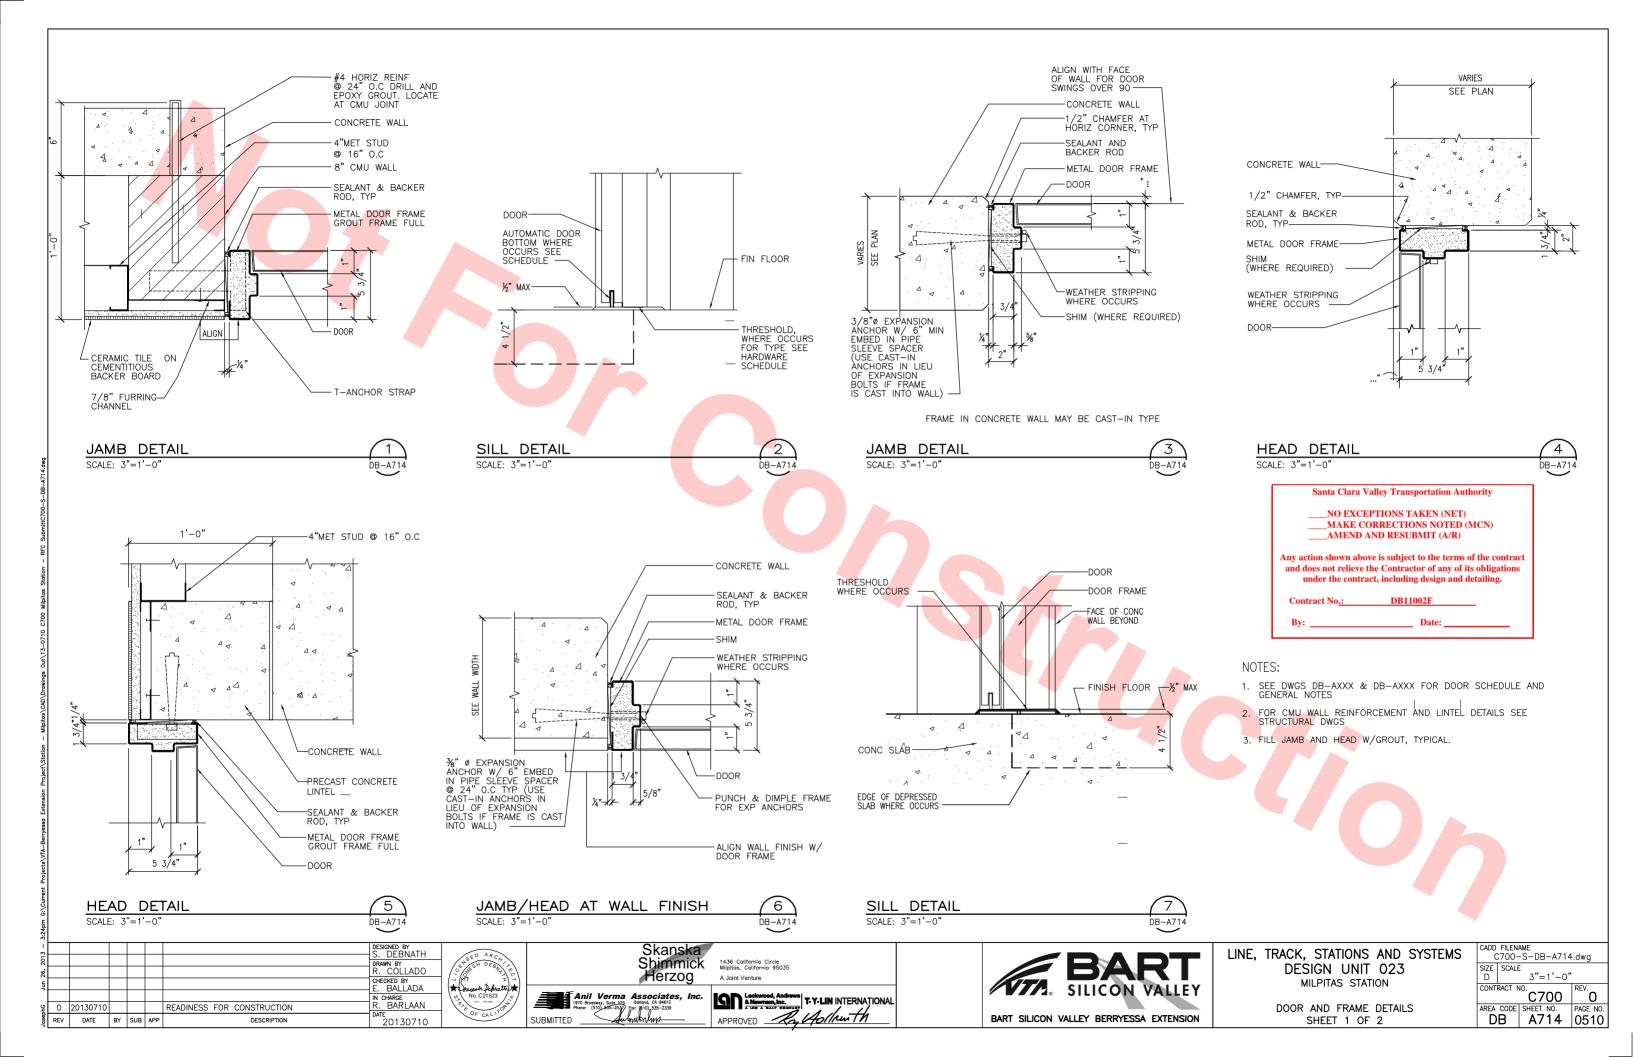


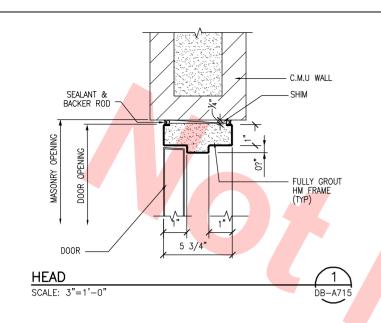


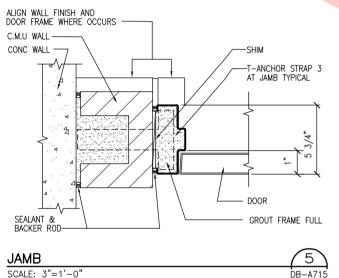


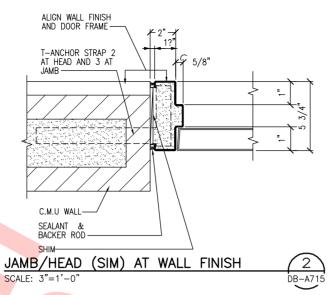


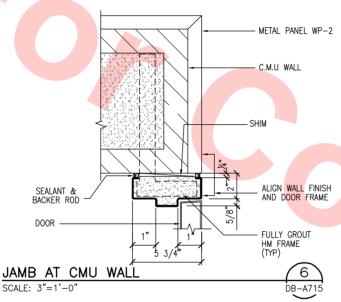

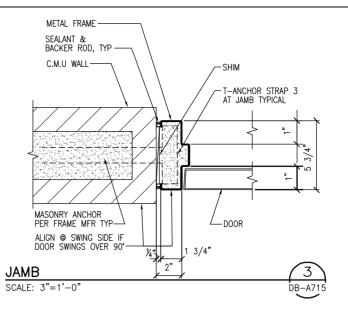

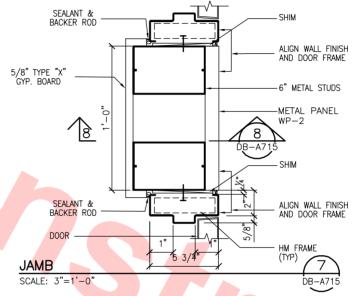


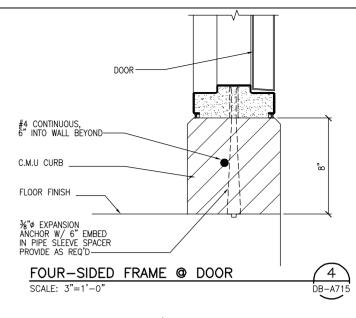

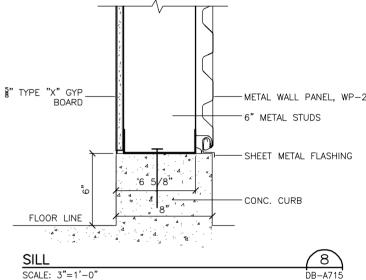

NOTES:


- 1. SEE DWG'S DB-A711, DB-A712 AND DB-A713 FOR DOOR SCHEDULE AND GENERAL NOTES
- 2. FOR CMU WALL REINFORCEMENT AND LINTEL DETAILS SEE STRUCTURAL DRAWINGS FILL JAMB AND HEAD W/ GROUT, TYP.
- 3. FOR DOOR SWING SEE ARCH DWGS DB-AXXX THRU DB-AXXX

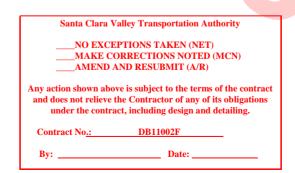

3:25								
3-							DESIGNED BY S. DEBNATH	
201							DRAWN BY R. COLLADO	
un 26,							CHECKED BY E. BALLADA	1 (
٦							IN CHARGE	۱
욅	0	20130710				READINESS FOR CONSTRUCTION	R. BARLAAN	
lose	REV	DATE	BY	SUB	APP	DESCRIPTION	20130710	





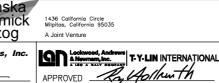




LINE, TRACK, STATIONS AND SYSTEMS

DESIGN UNIT 023

MILPITAS STATION

DOOR AND FRAME DETAILS SHEET 2 OF 2

1S	CADD FILENAME C700-S-DB-A715.dwg				
	SIZE D	,			
	CONT	RACT N	REV.		
	AREA	CODE	SHEET NO.	PAGE NO.	
	D	В	A715	0511	

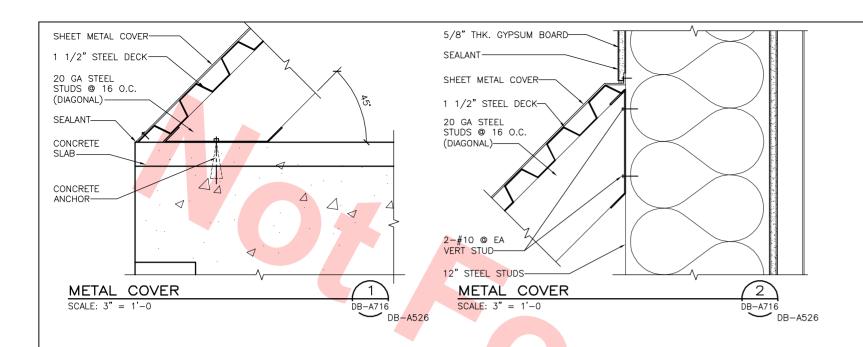

Santa Clara Valley Transportation Authority

___NO EXCEPTIONS TAKEN (NET)
__MAKE CORRECTIONS NOTED (MCN)
AMEND AND RESUBMIT (A/R)

Any action shown above is subject to the terms of the contract and does not relieve the Contractor of any of its obligations under the contract, including design and detailing.

DB11002F

Contract No .:

By: _____ Date: _____


| DESIGNED BY | S. DEBNATH | DRAWN BY | R. COLLADO | CHECKED BY | E. BALLADA | IN CHARGE | CHARGE | REV DATE | BY SUB APP | DESCRIPTION | DATE | BY SUB APP | DESCRIPTION | DATE | DATE | BY SUB APP | DESCRIPTION | DATE |



SUBMITTED





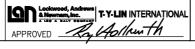






LINE, TRACK, STATIONS AND SYSTEMS
DESIGN UNIT 023
MILPITAS STATION


MISCELLANEOUS DETAILS


S	CADD FILENAME C700-S-DB-A716.dwg						
	SIZE D	SCALE	3"=1'-0"				
	CONT	RACT N	°.C700	REV.			
	AREA	CODE	SHEET NO.	PAGE NO.			
	D	В	A716	0512			

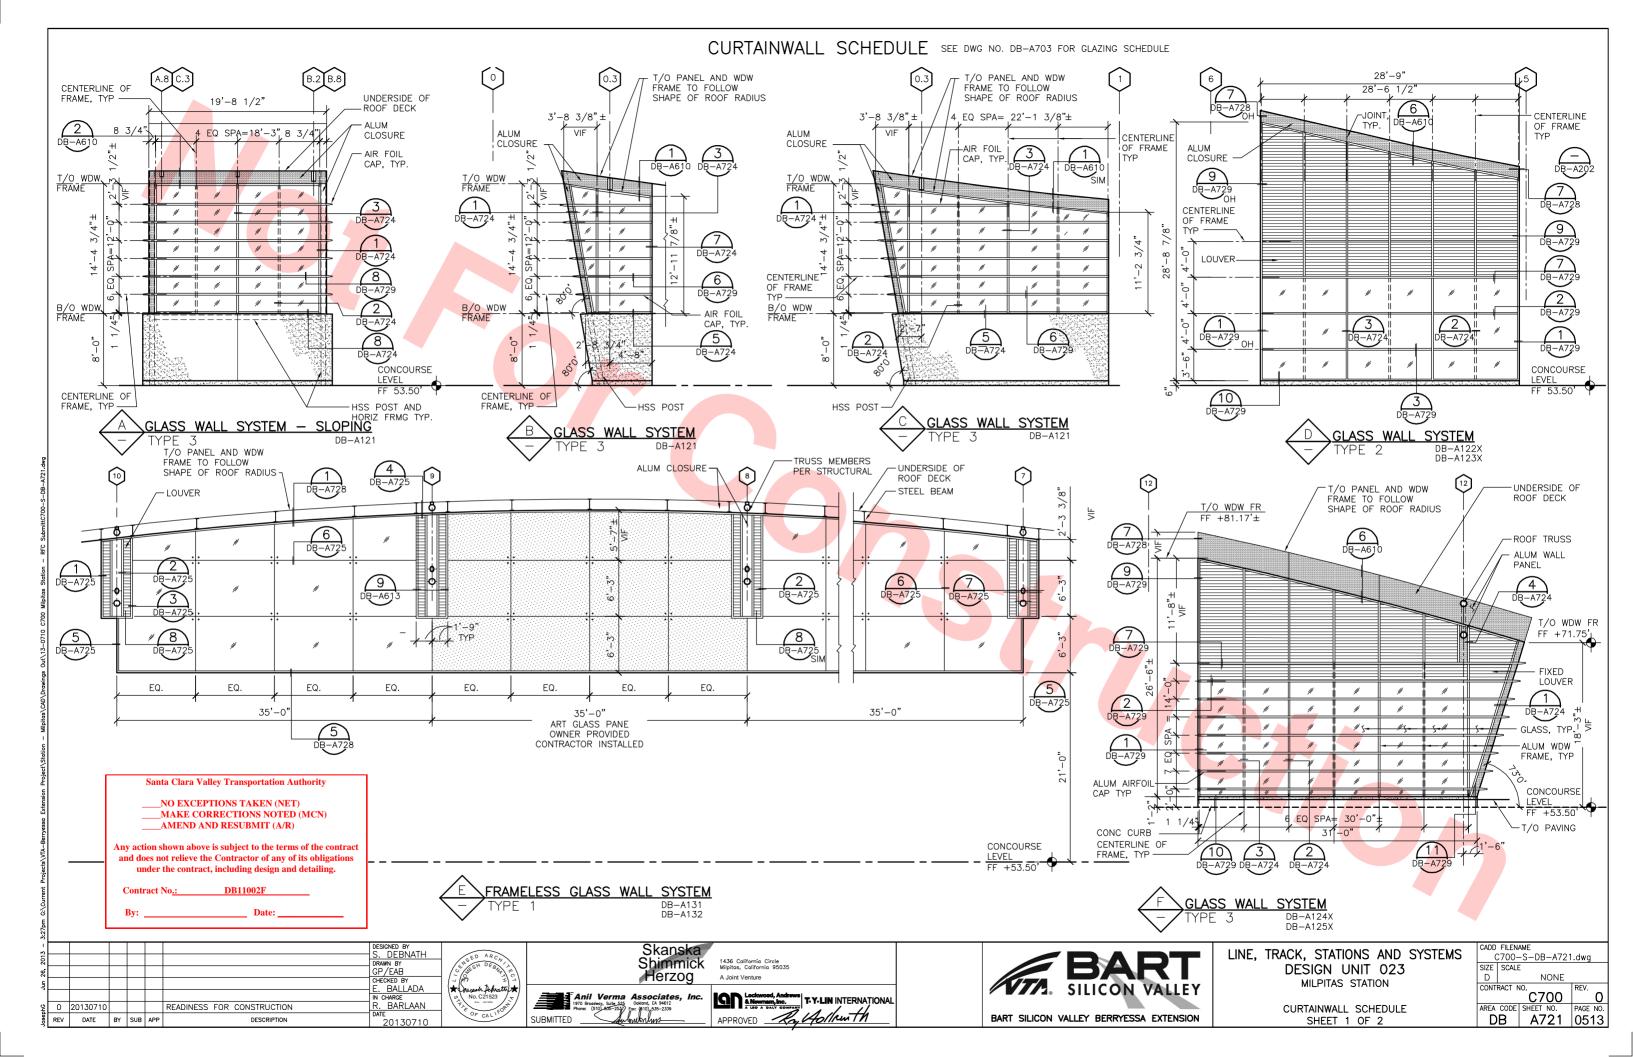


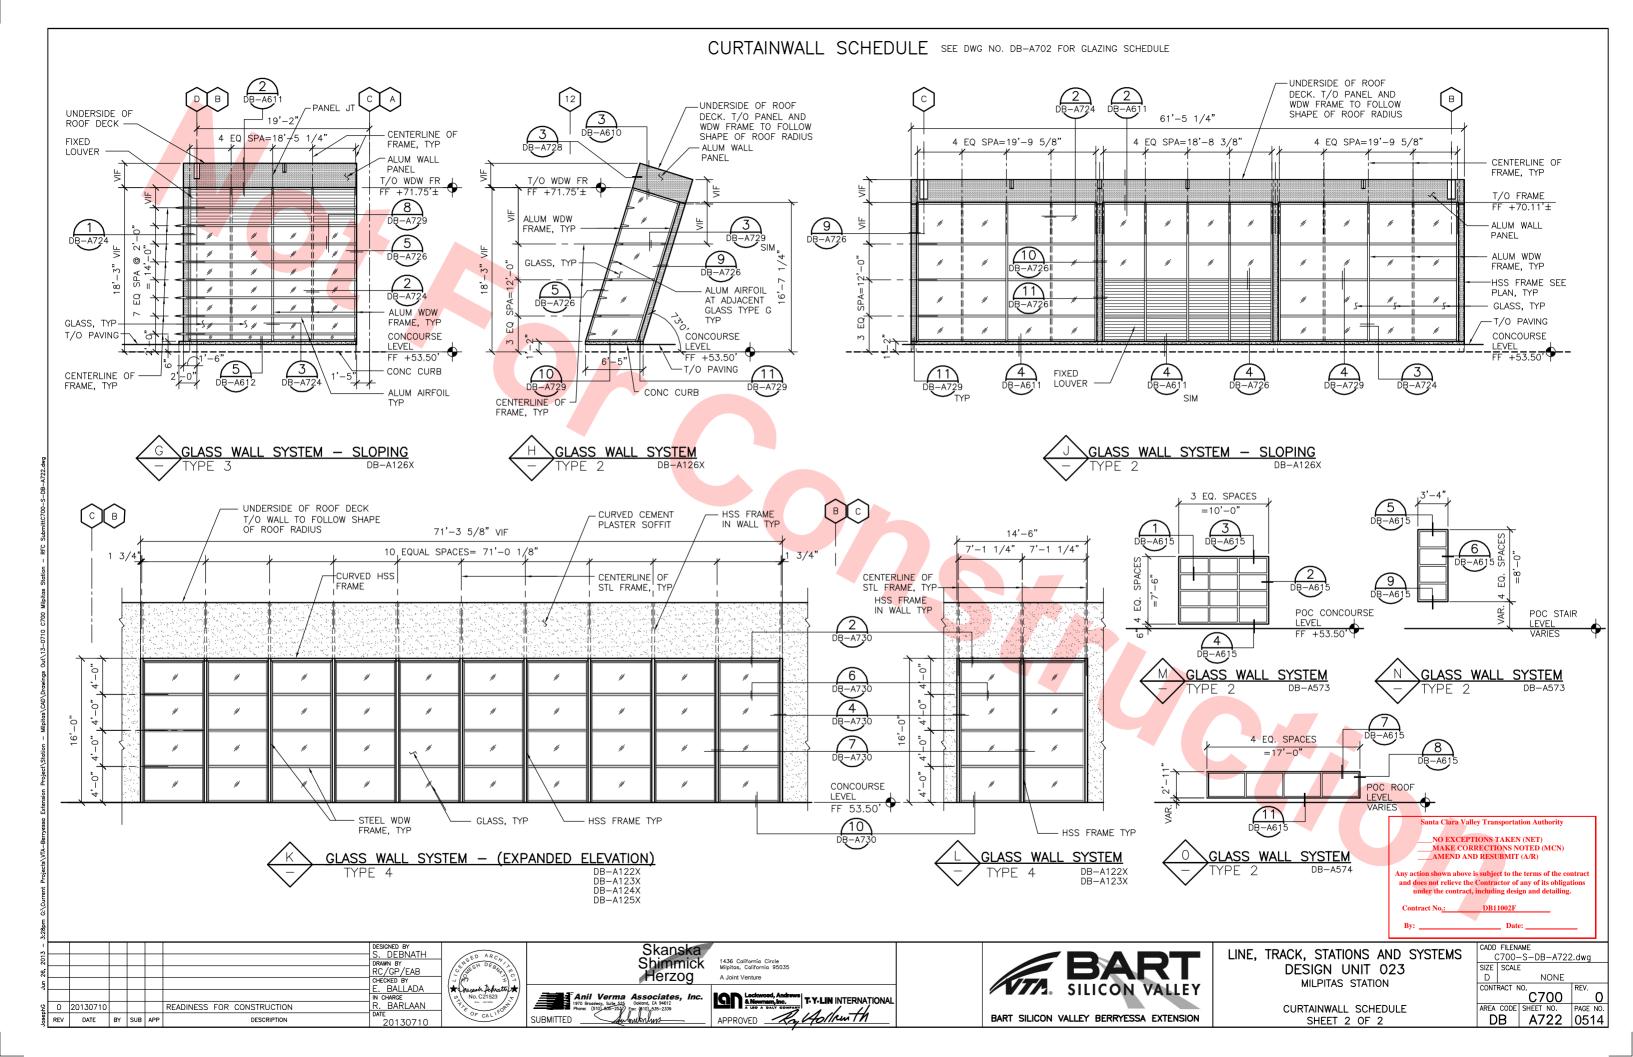


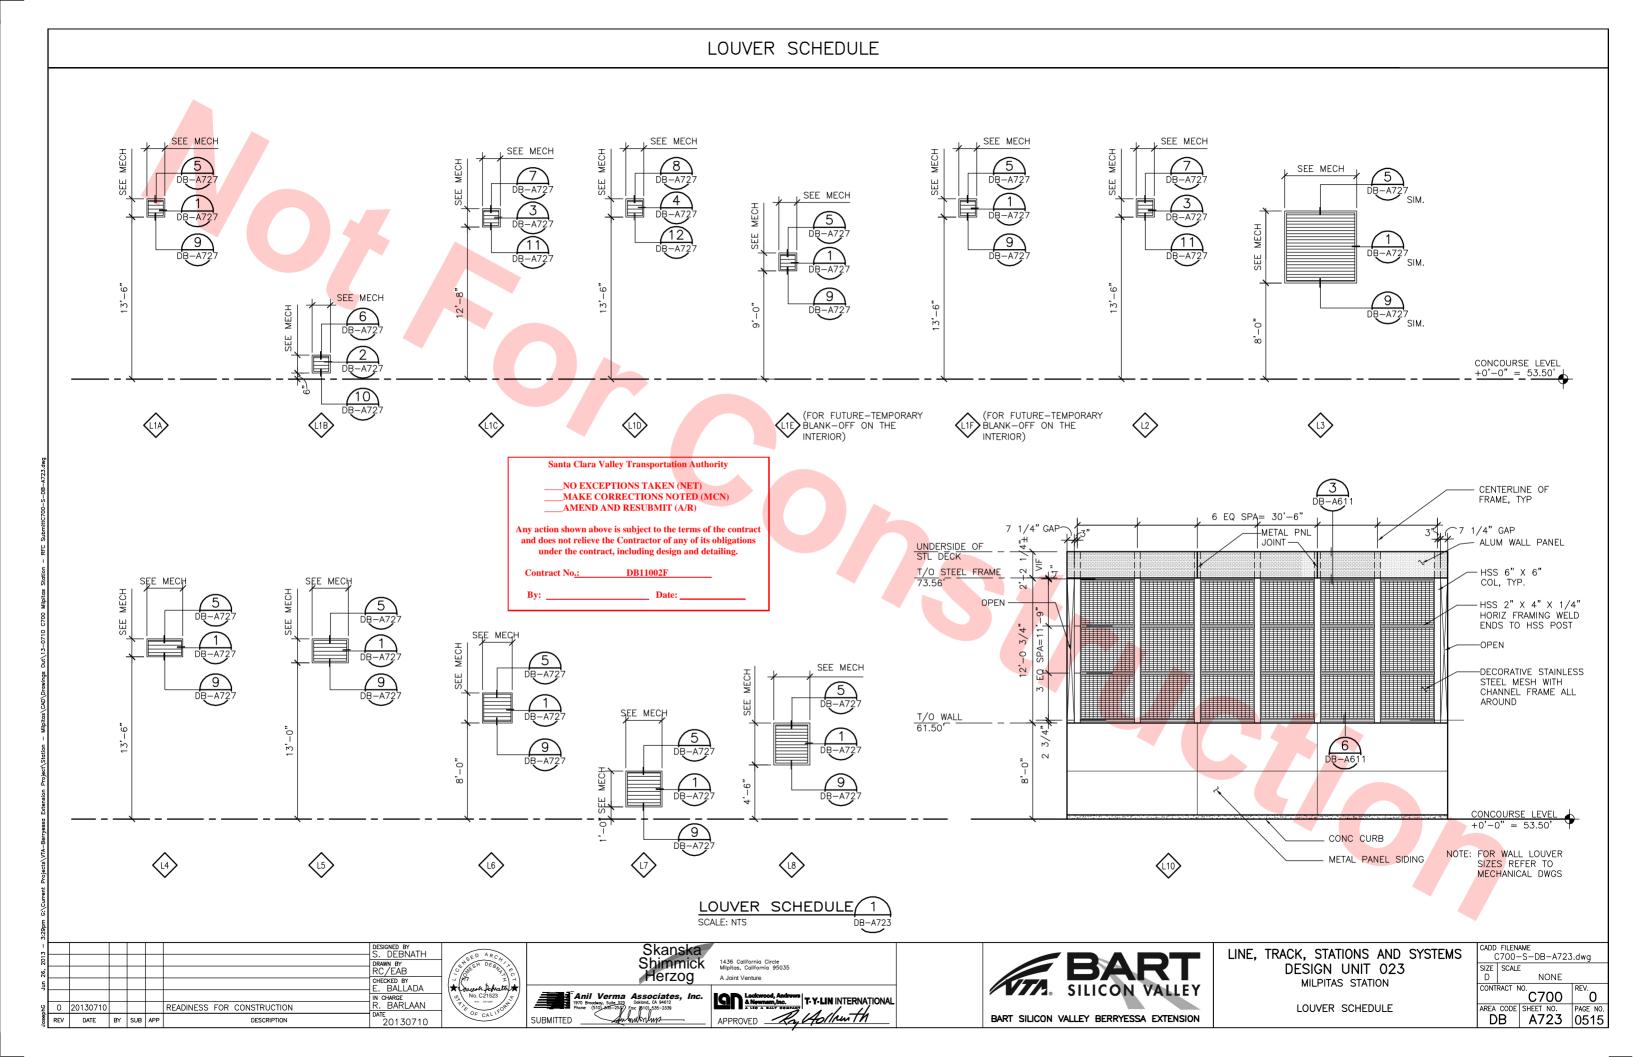


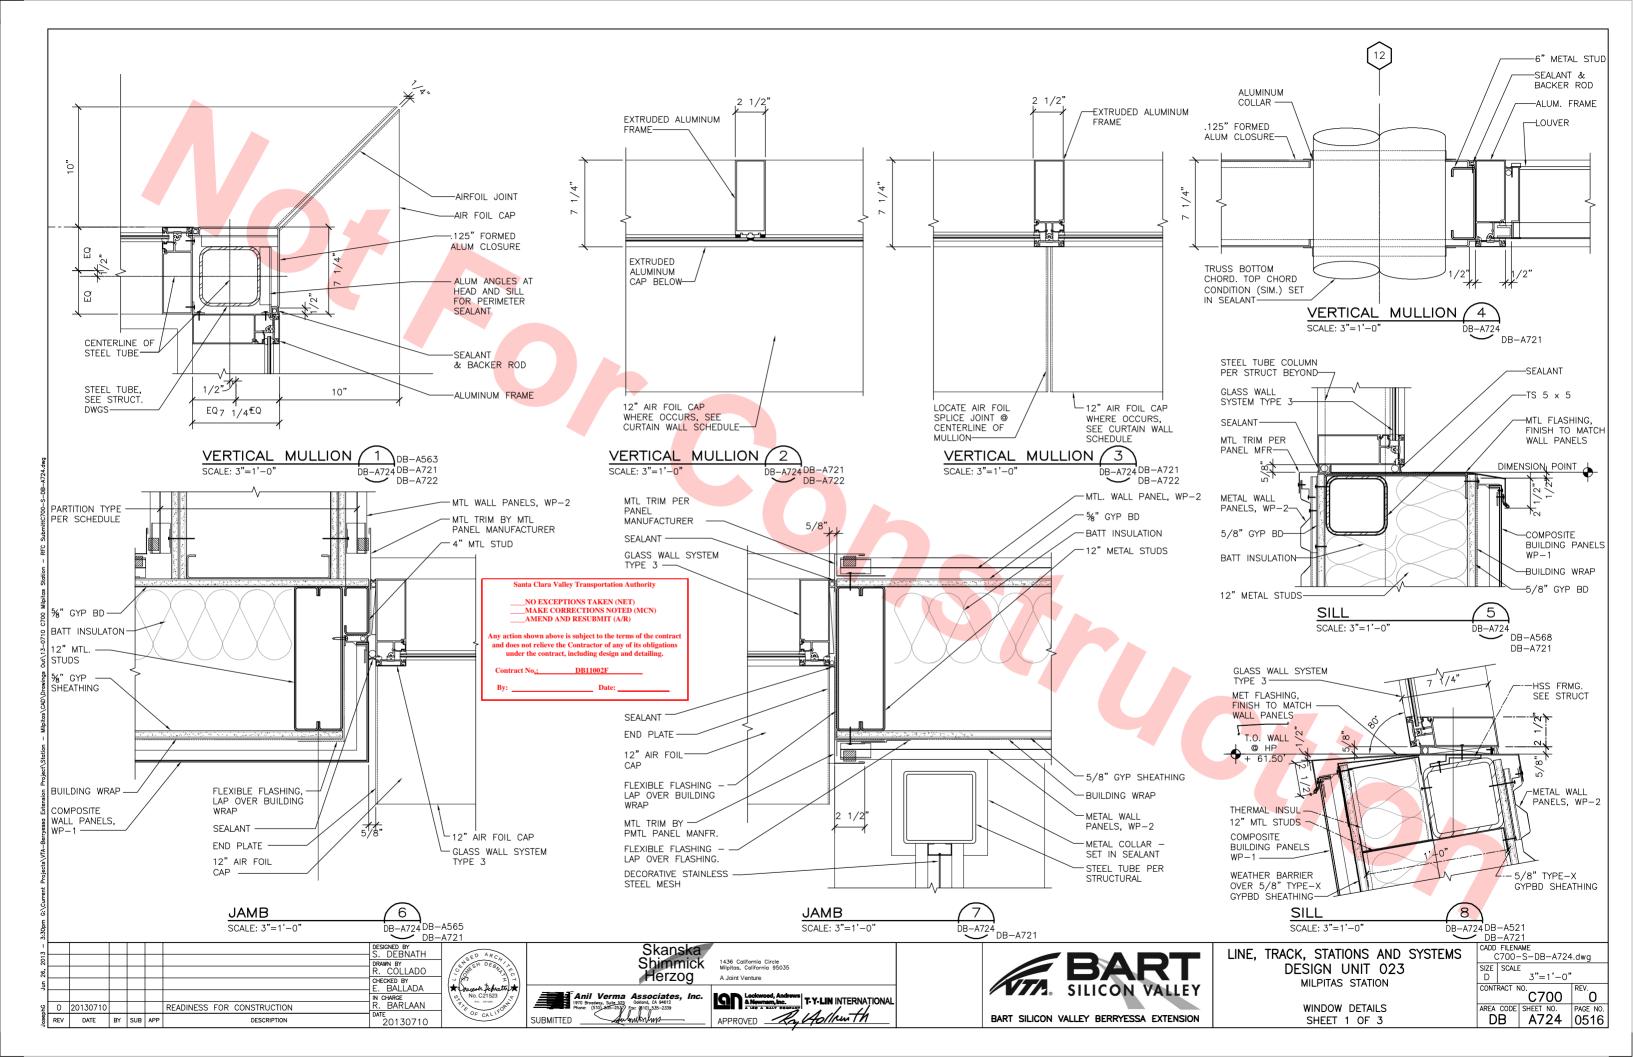


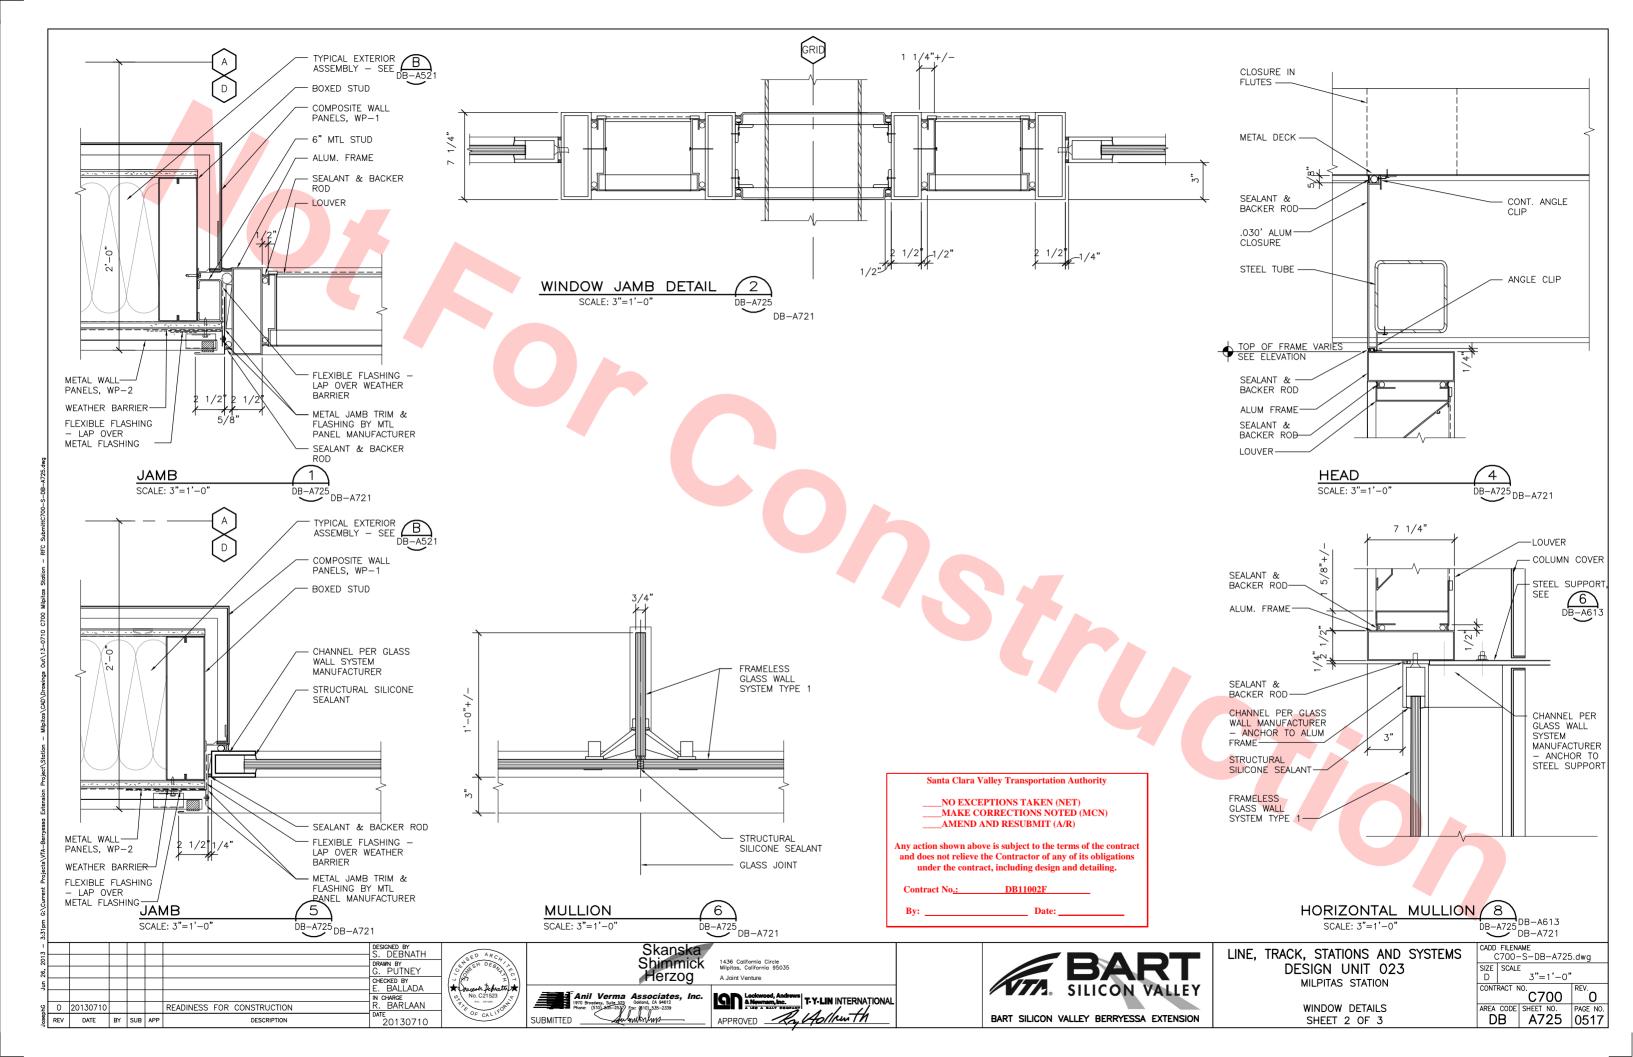


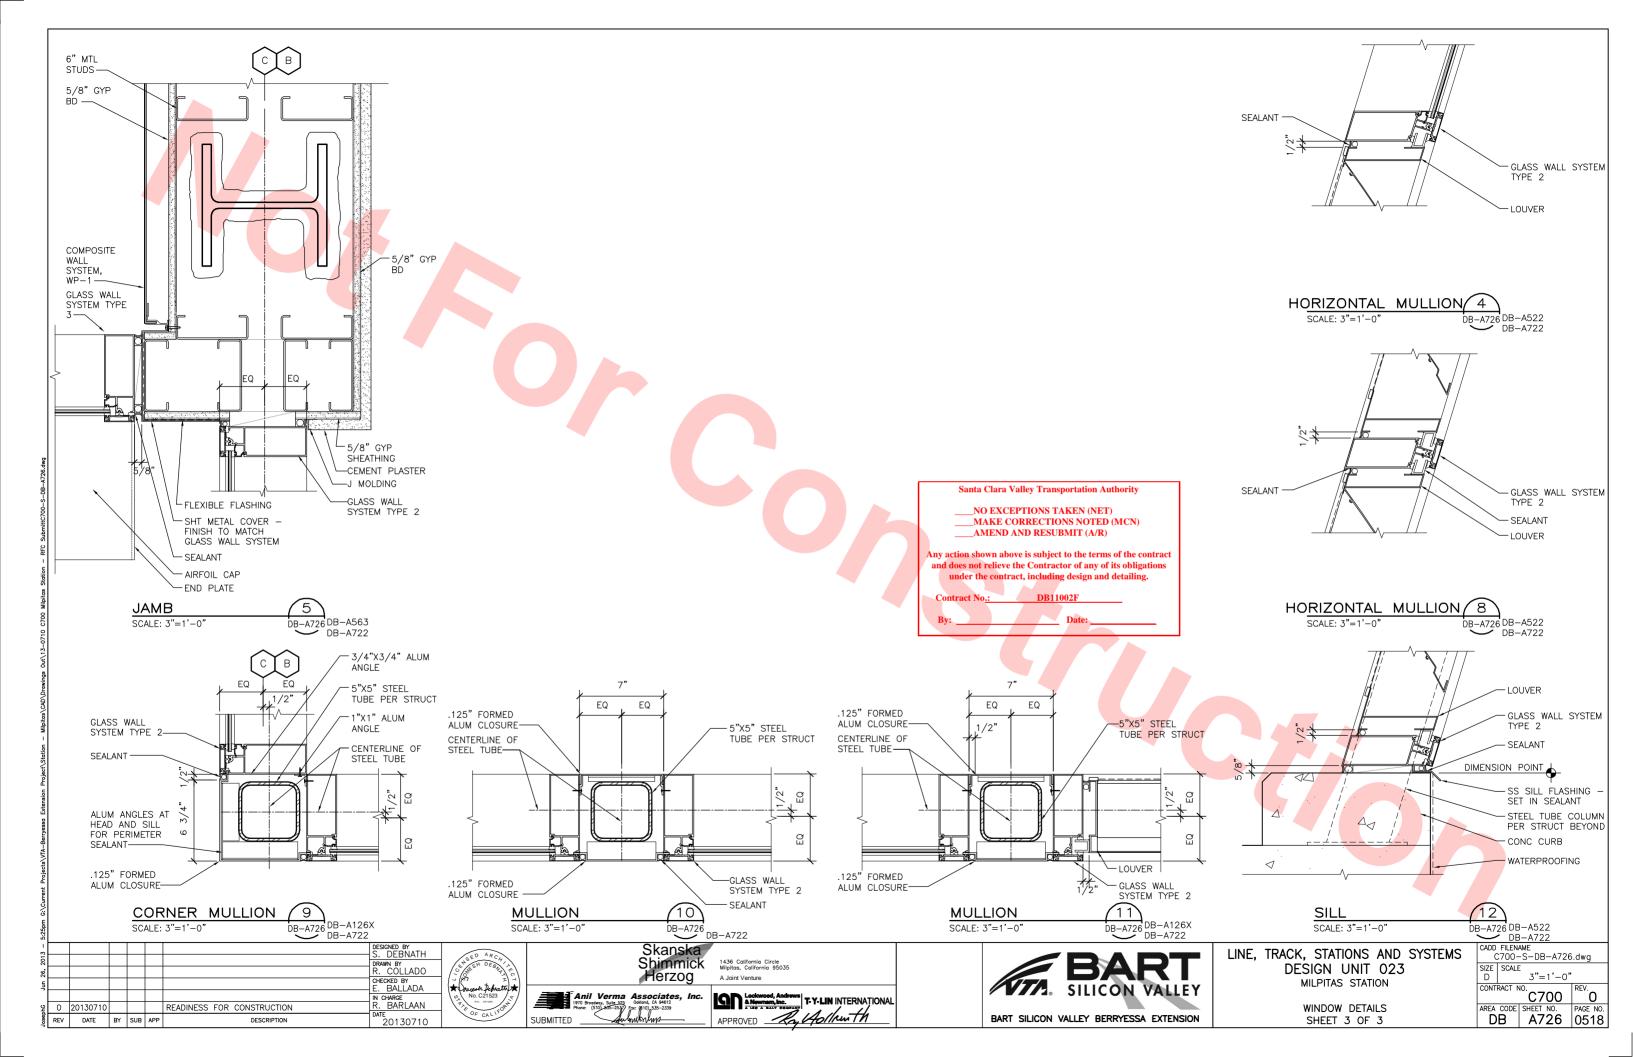


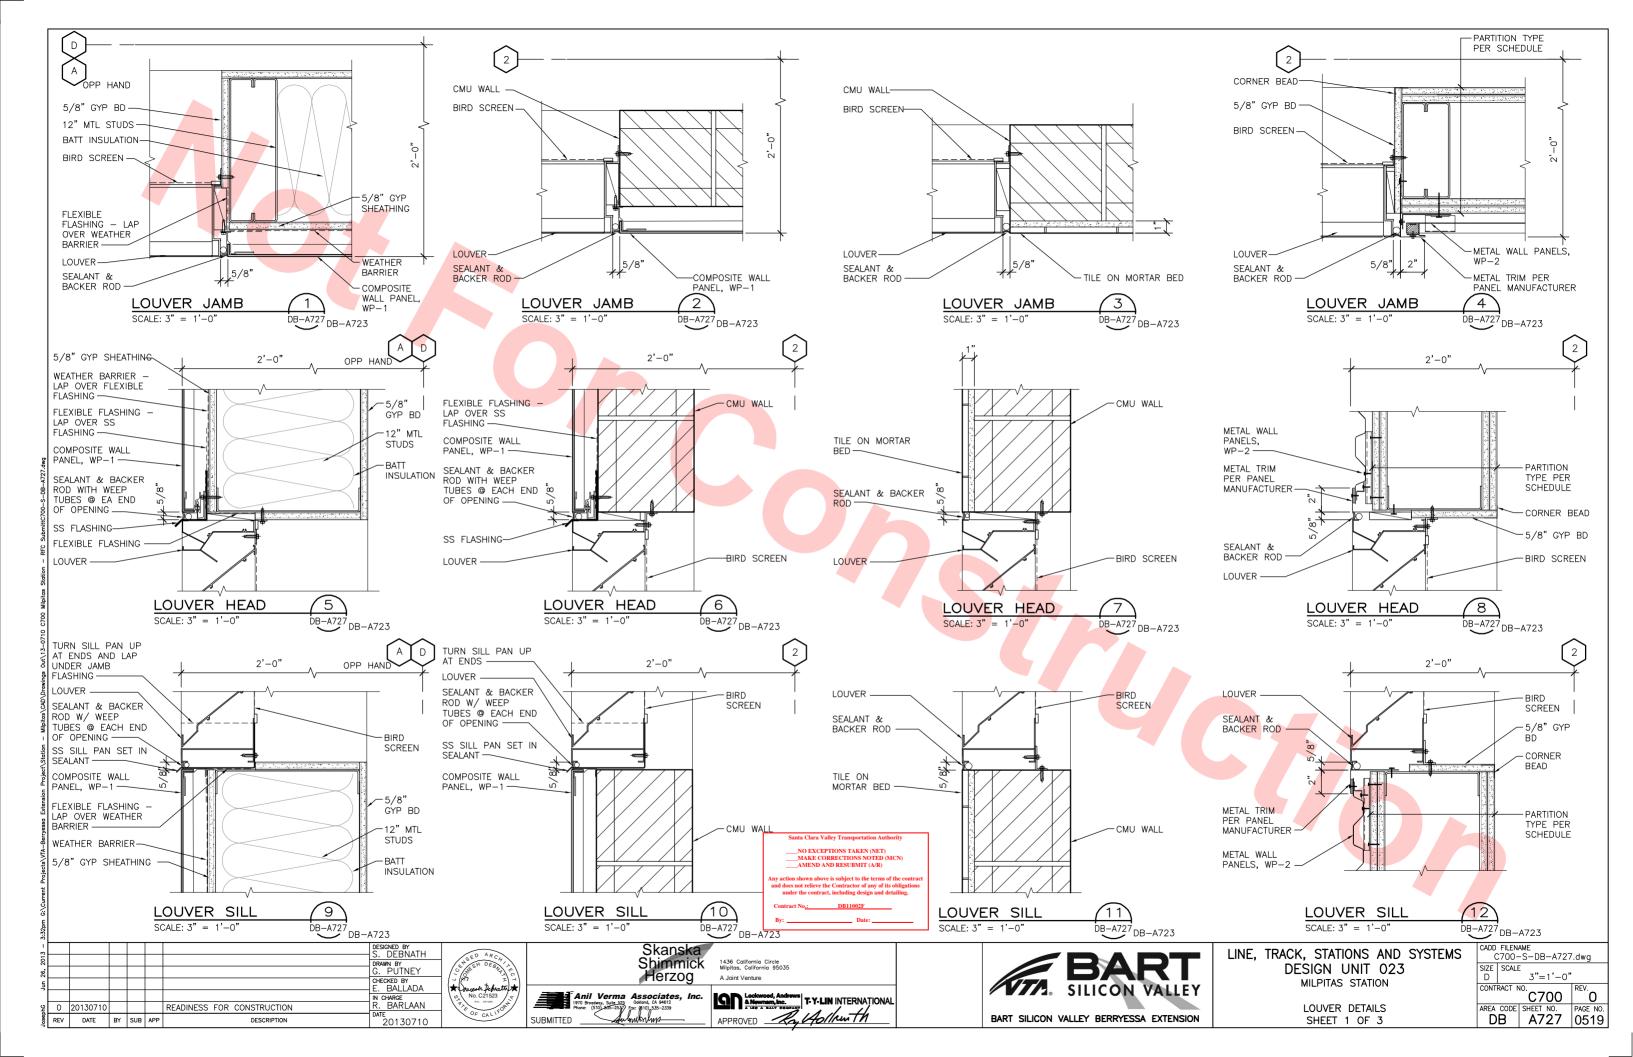


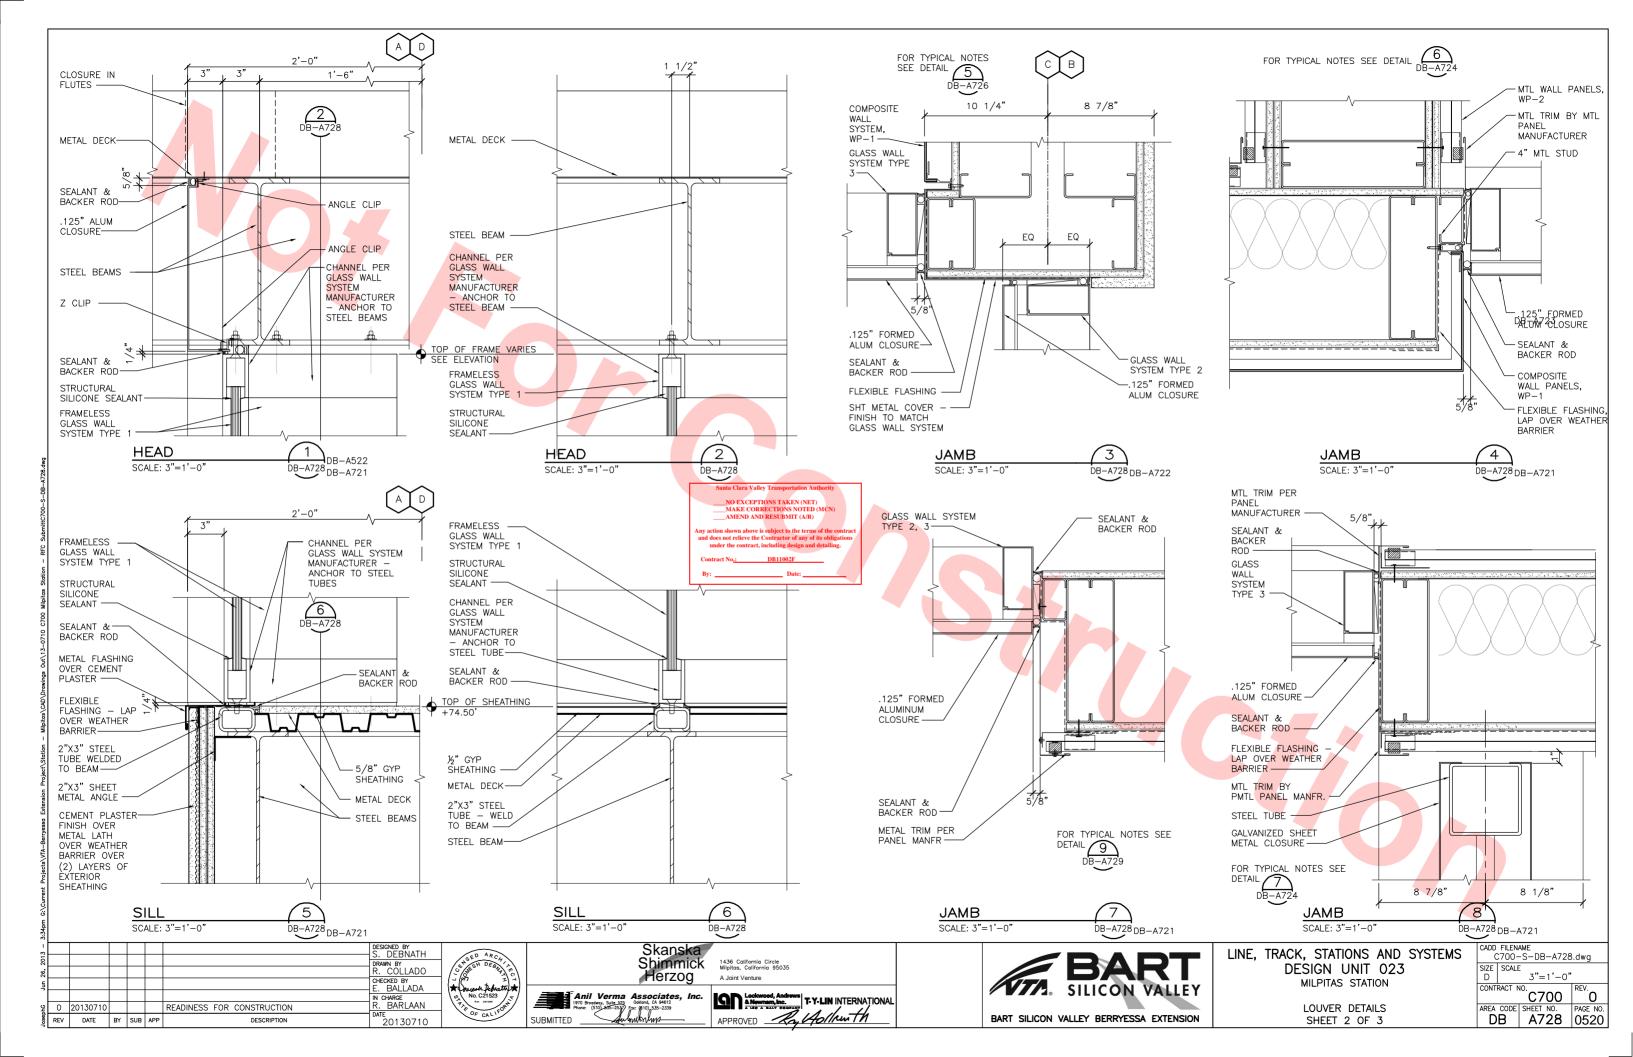


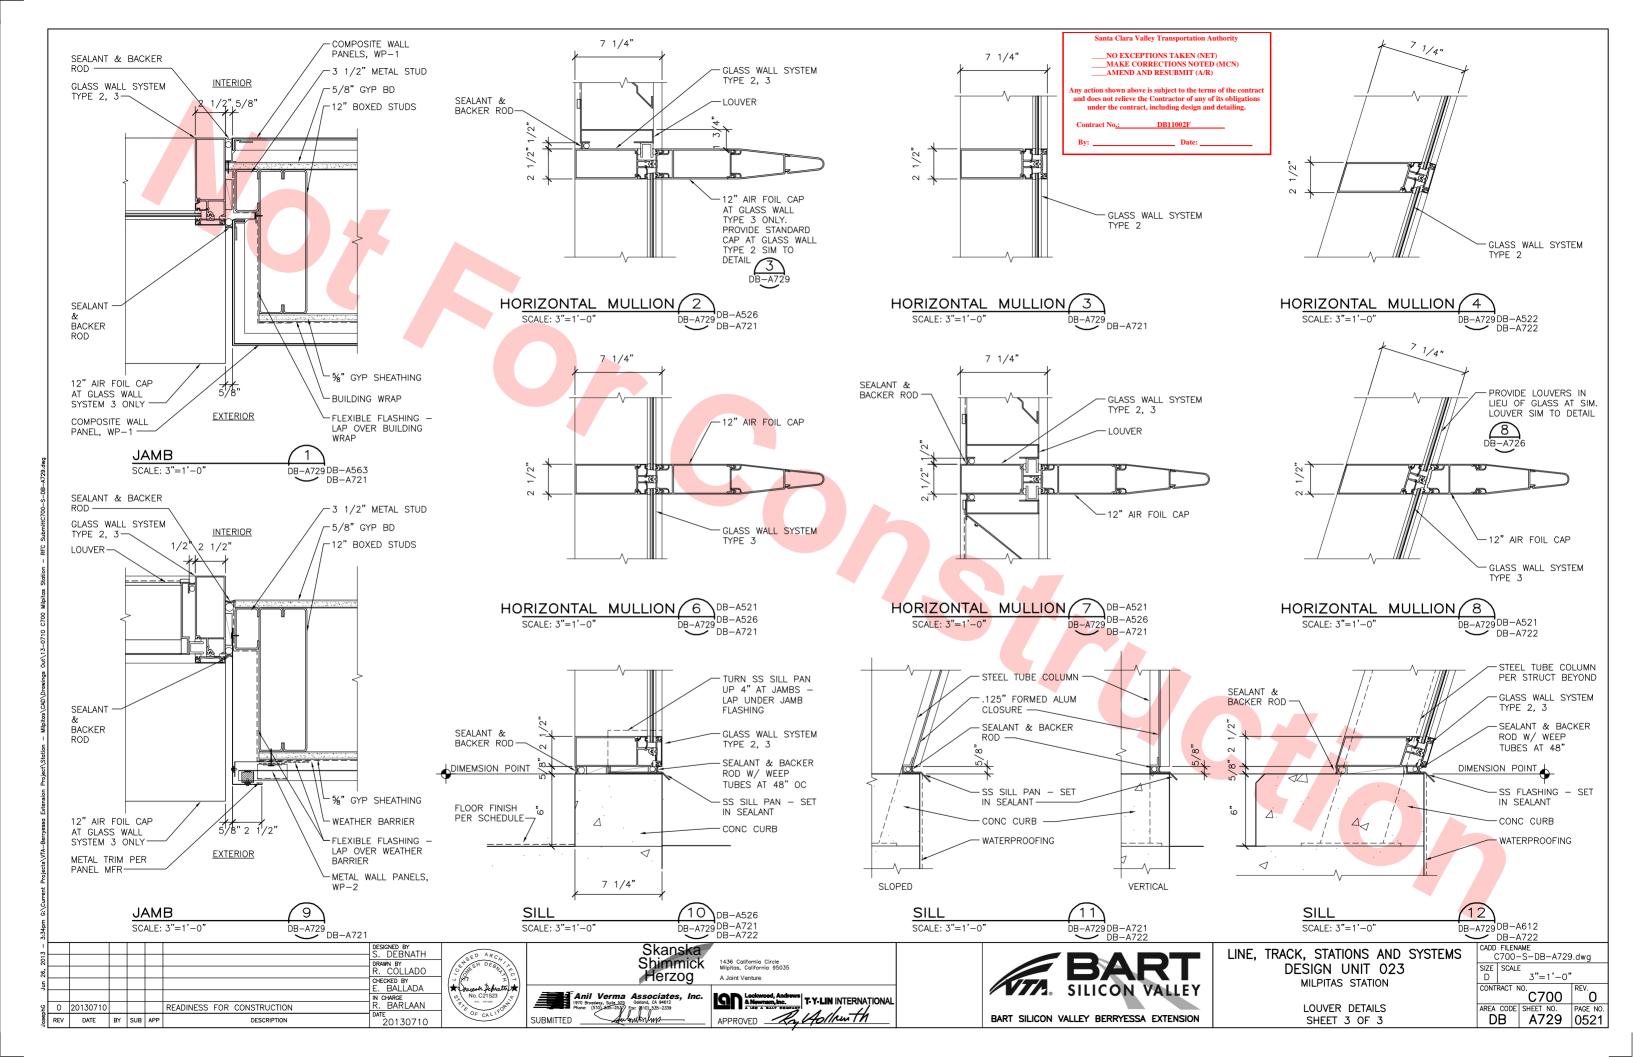


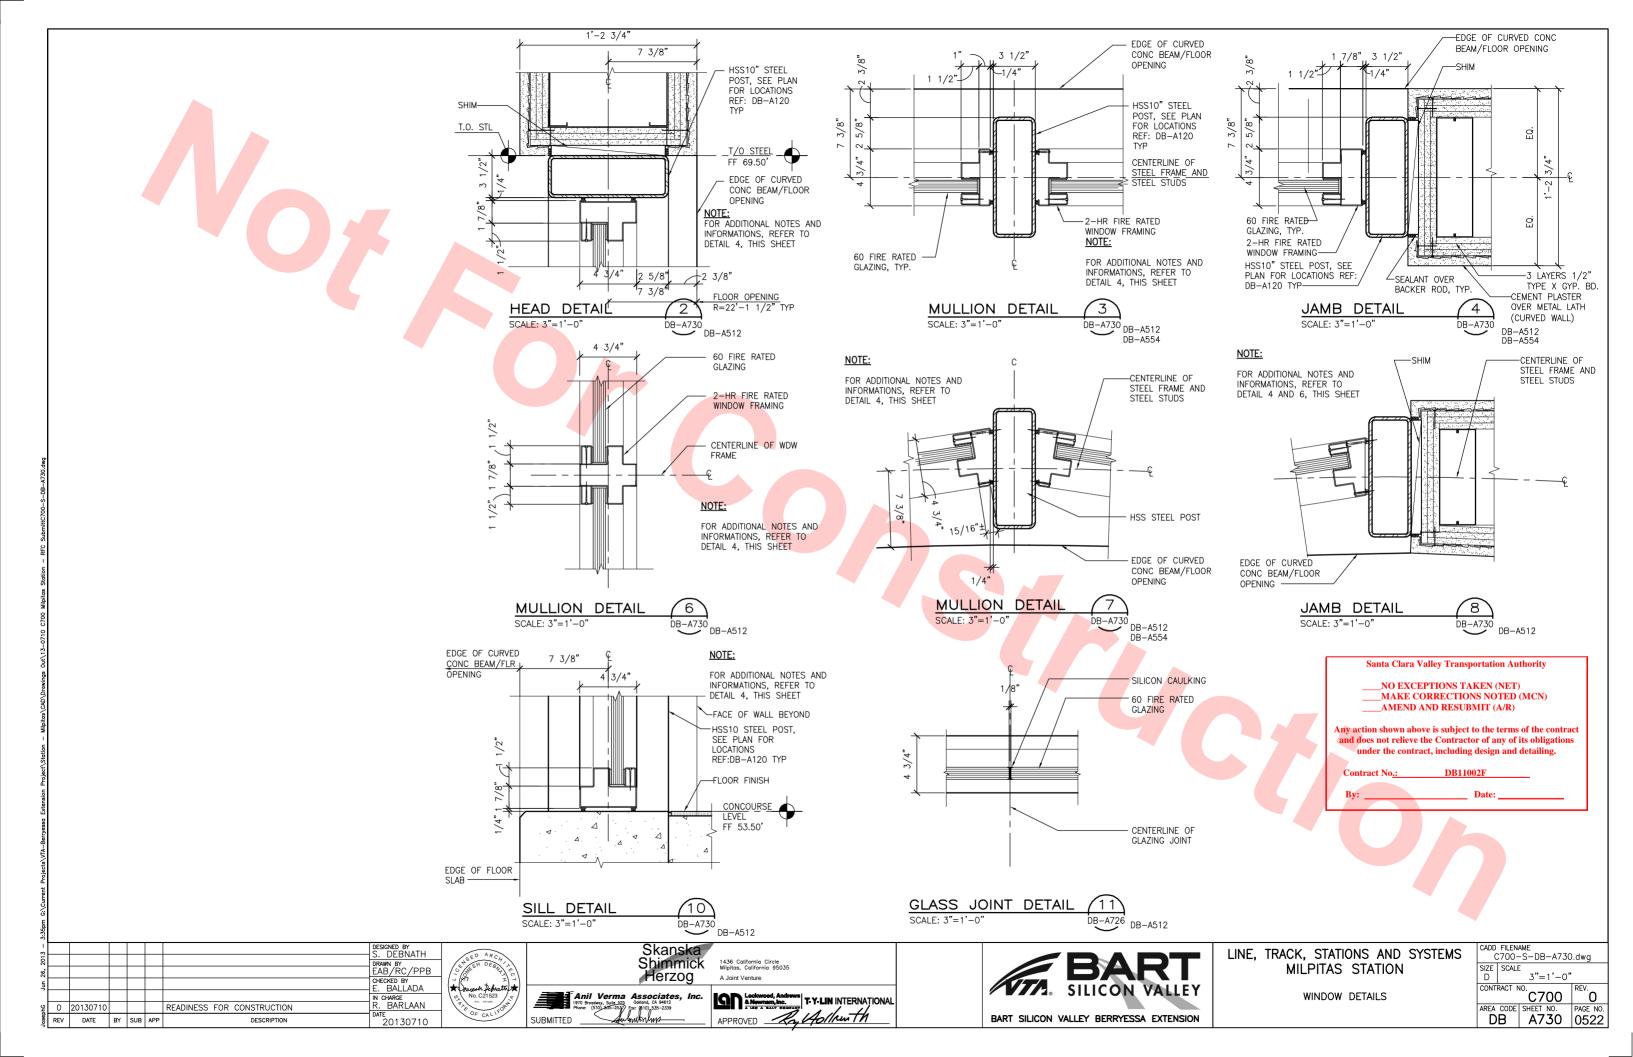


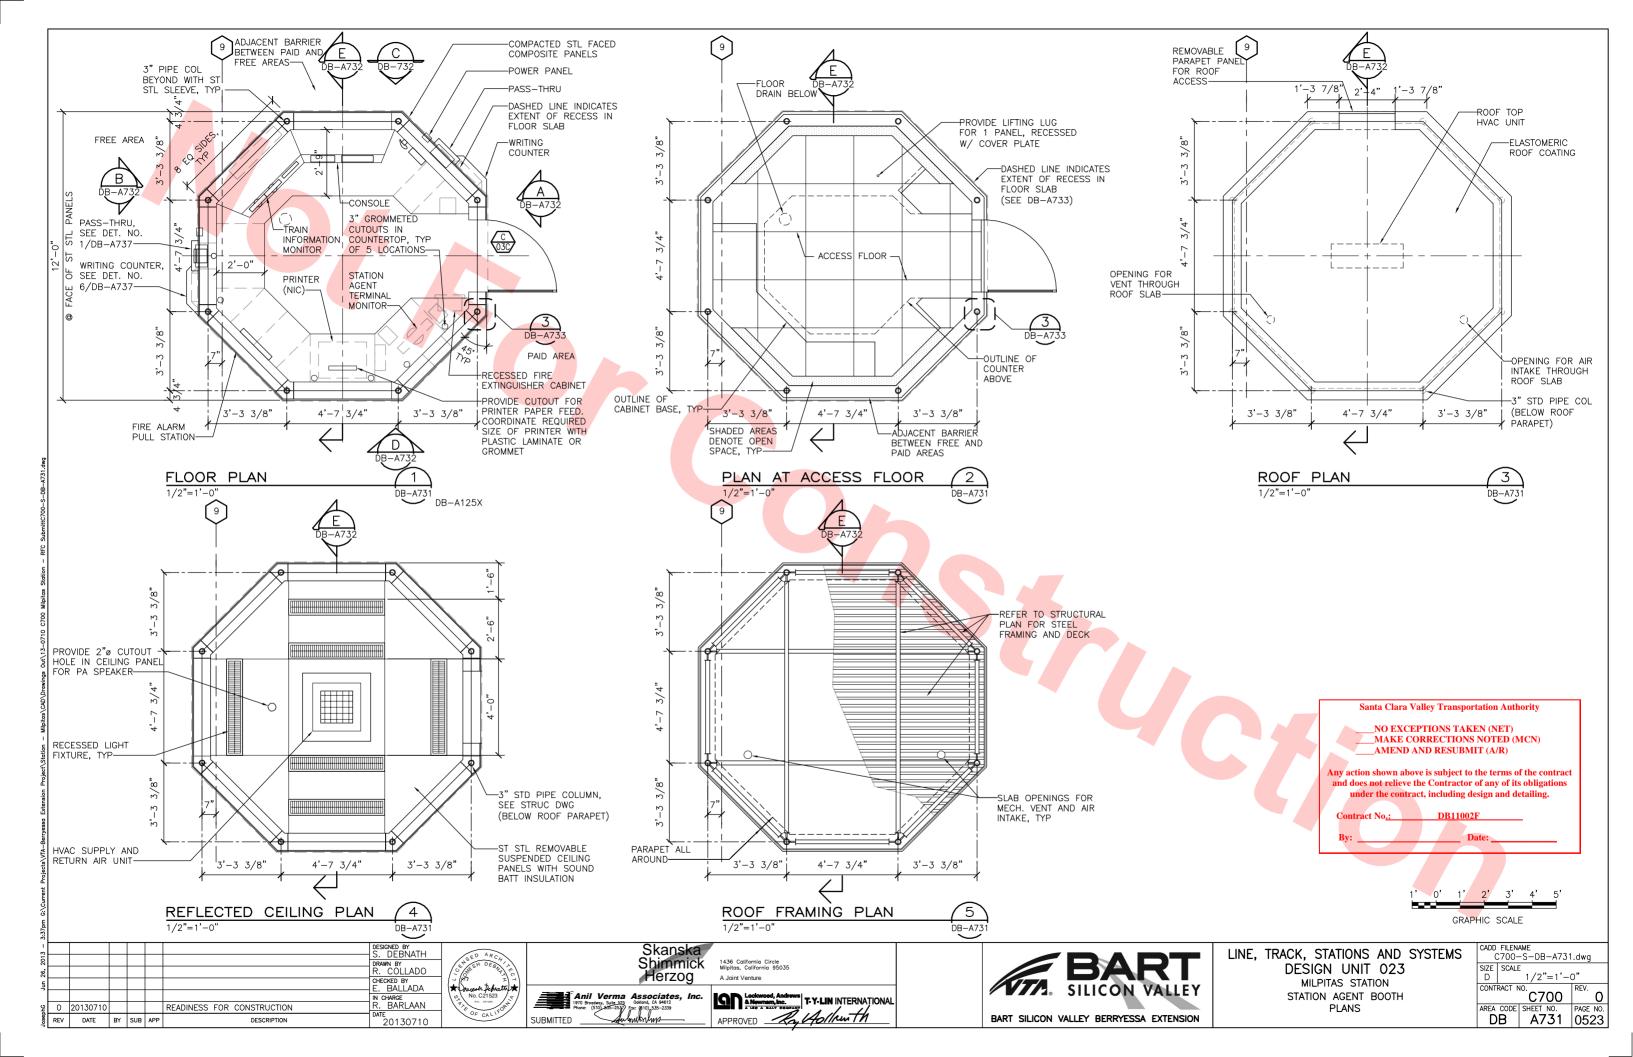


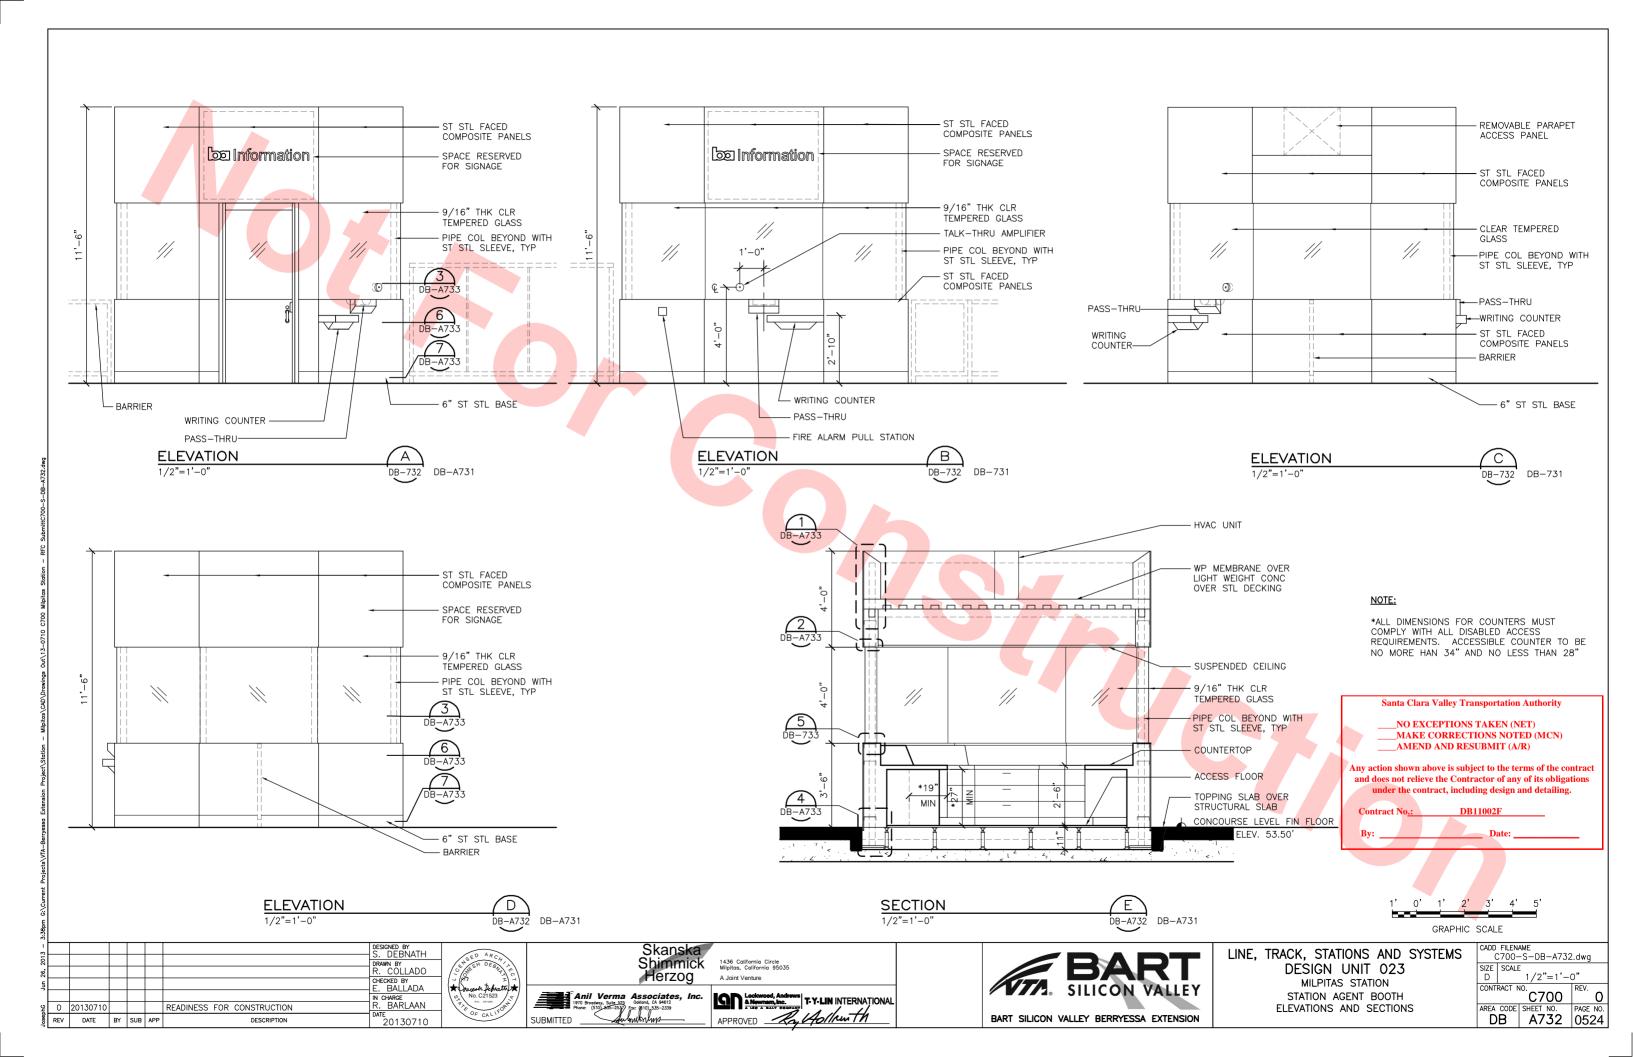


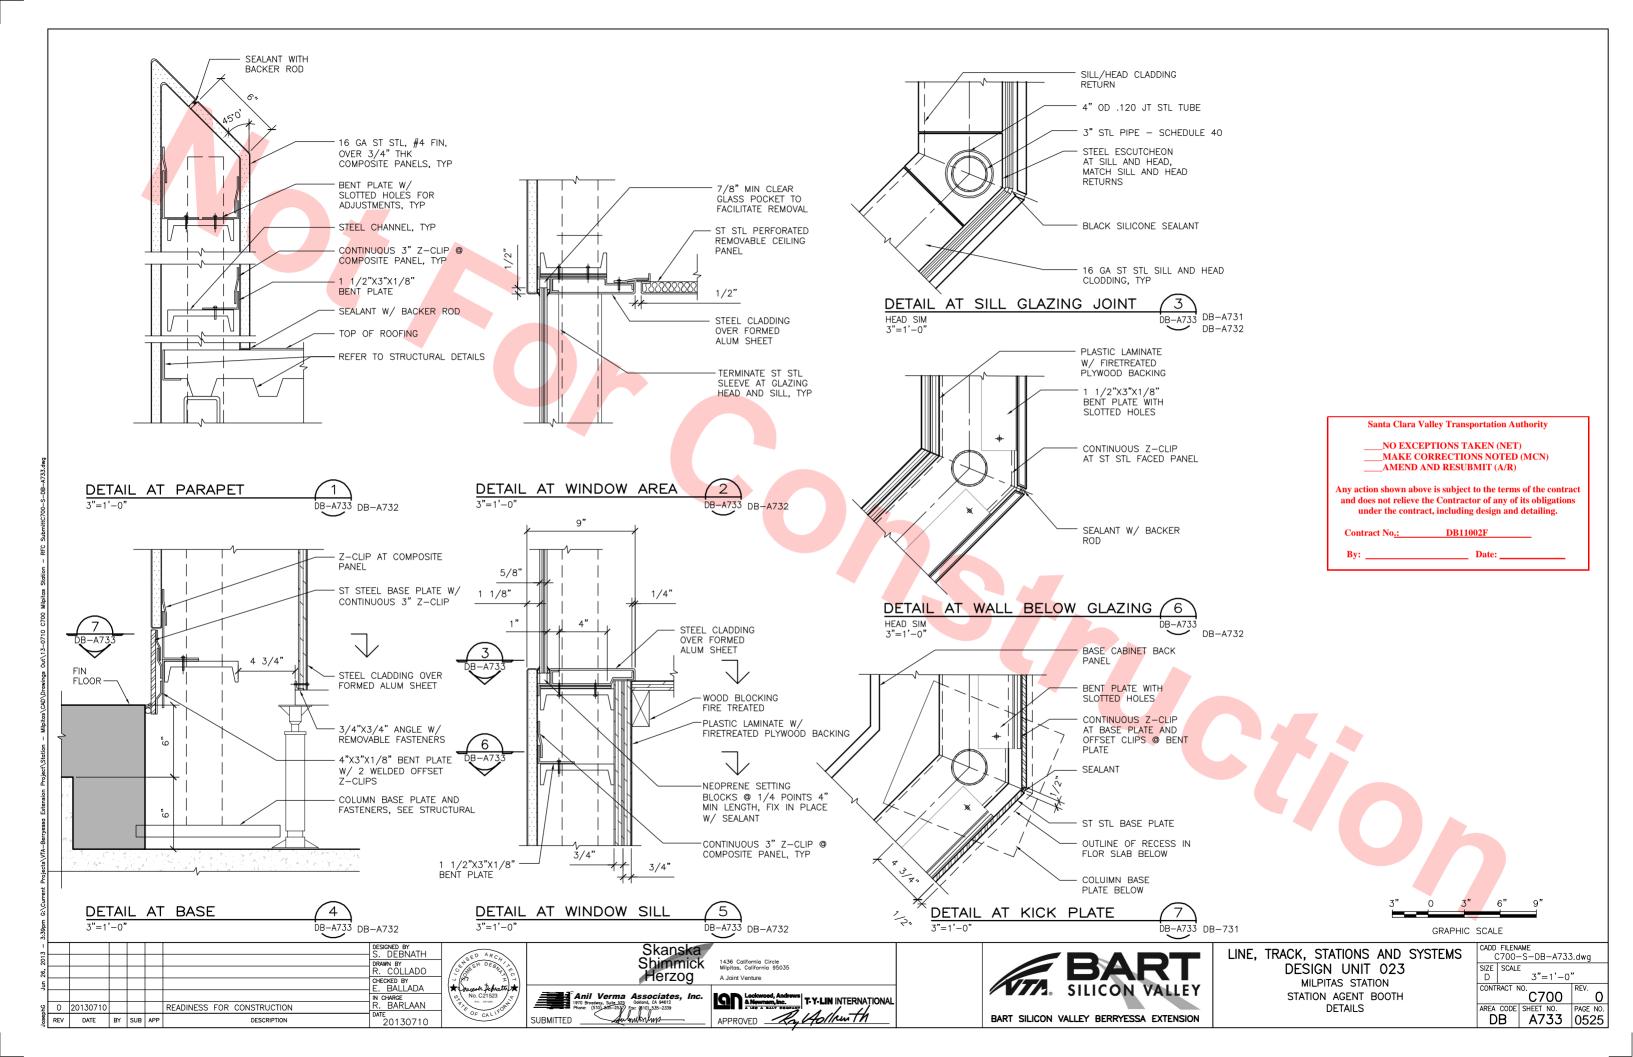


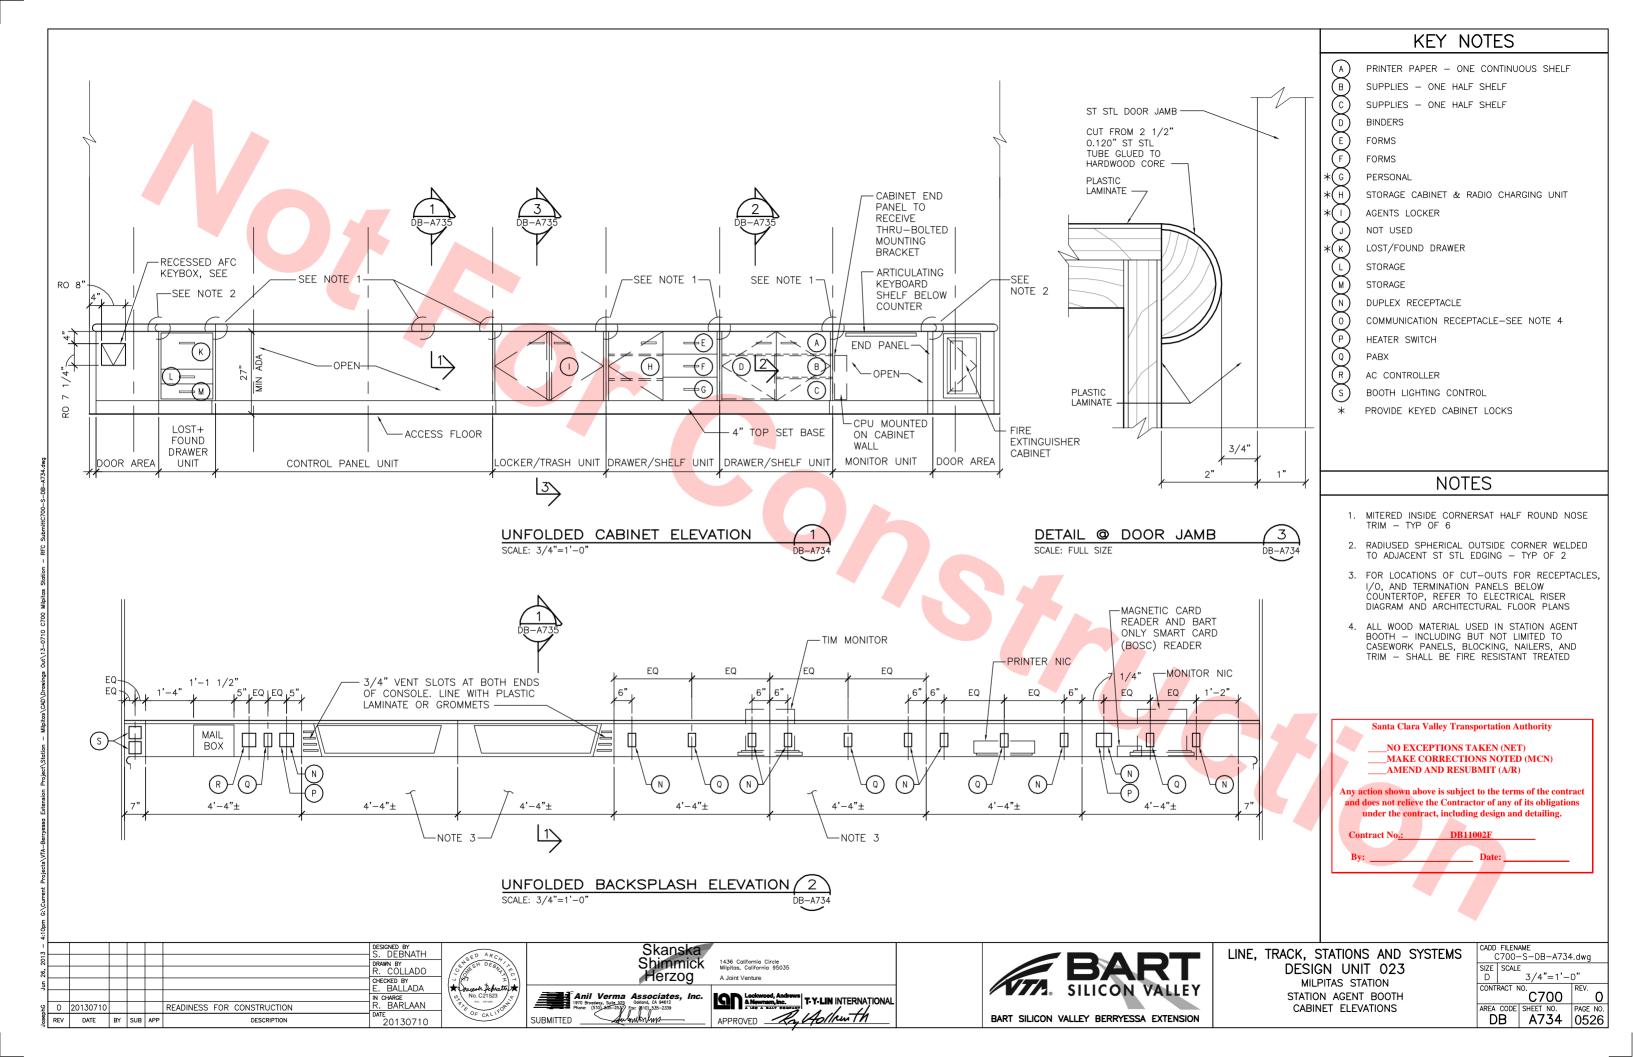


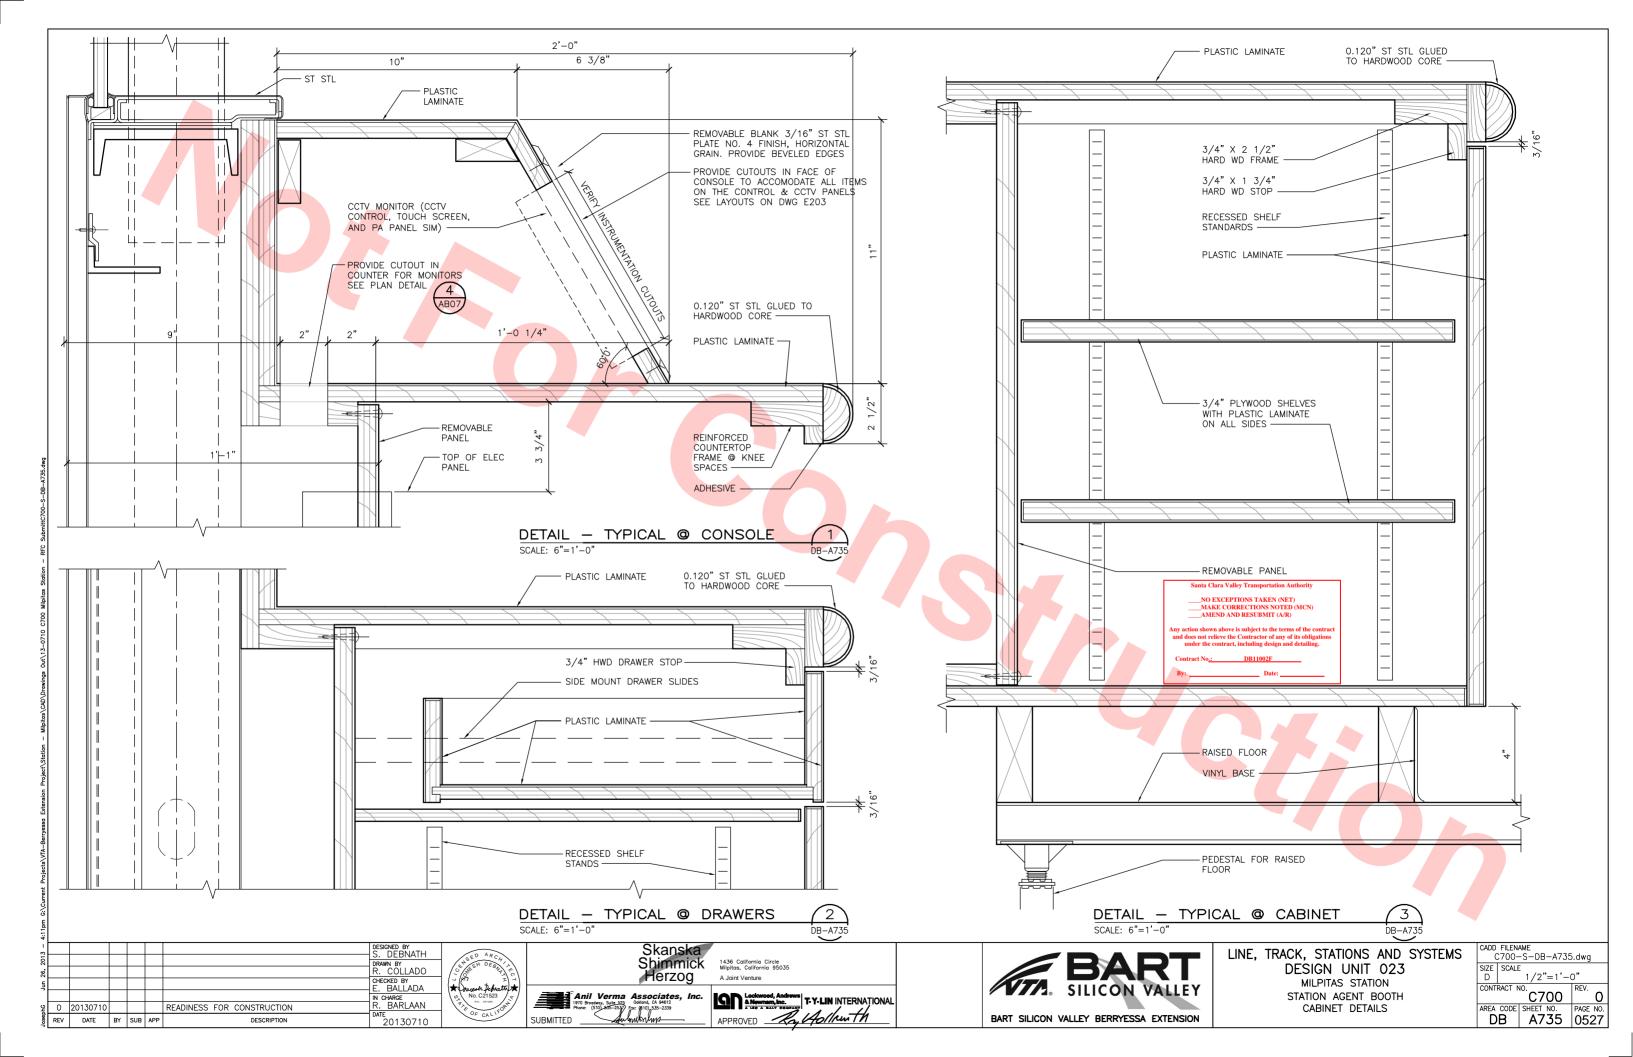


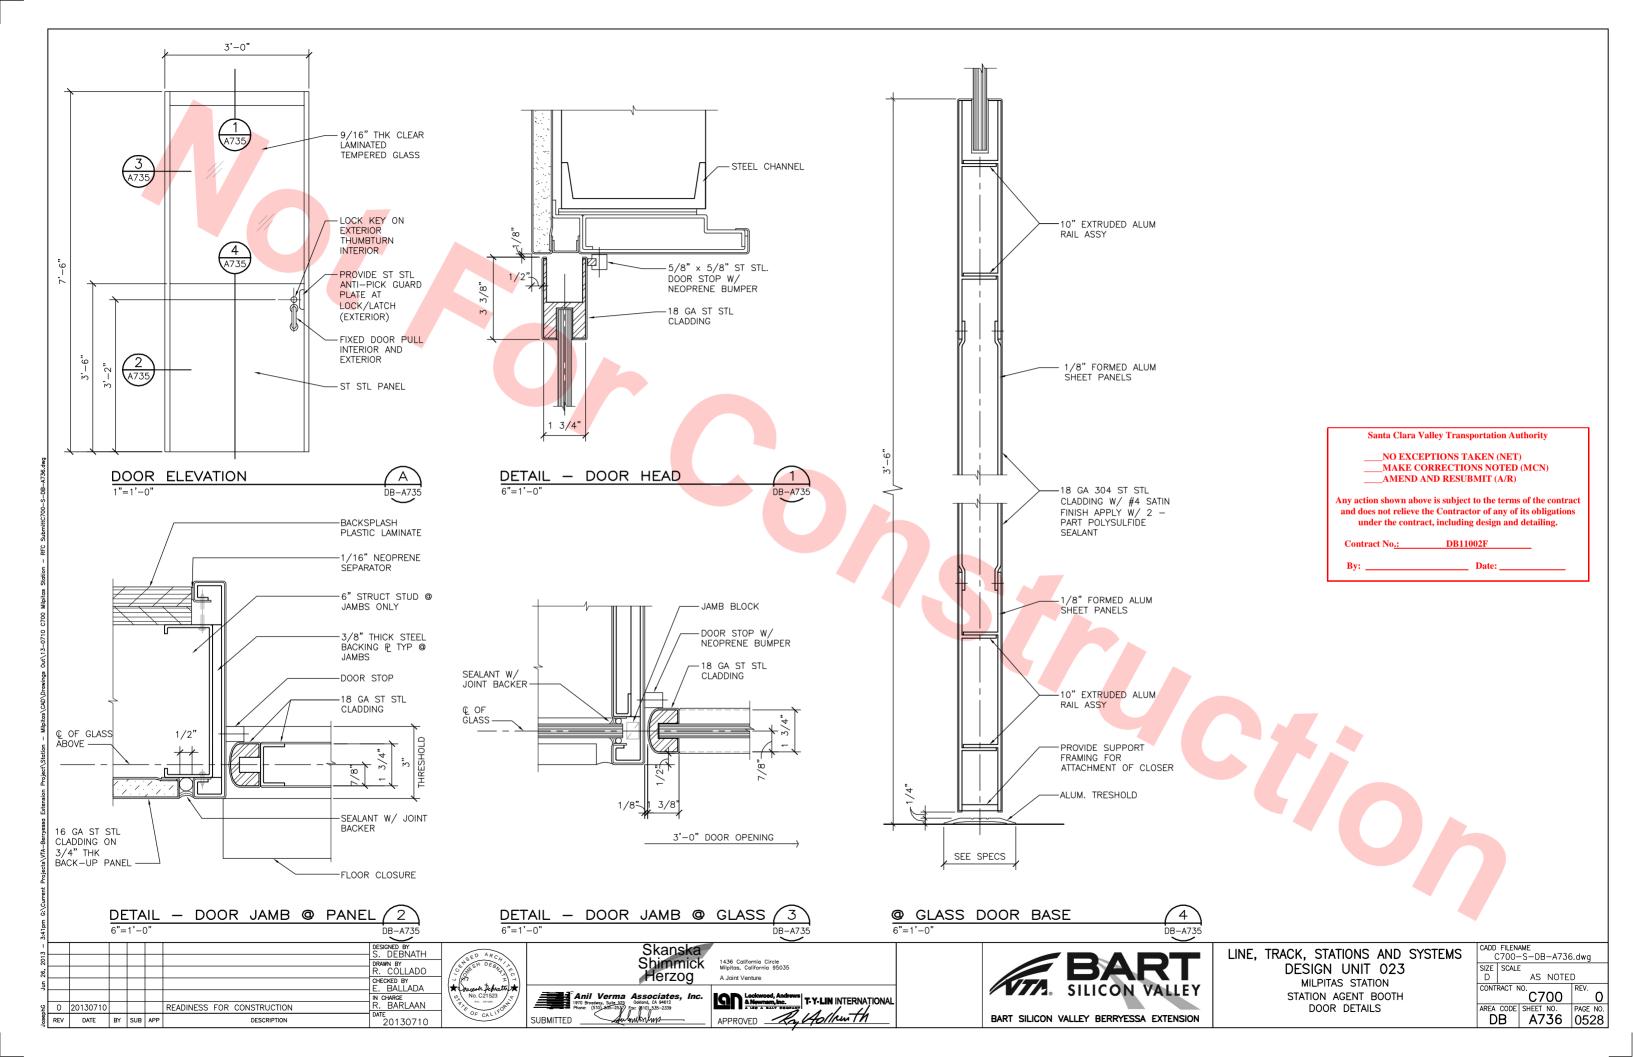


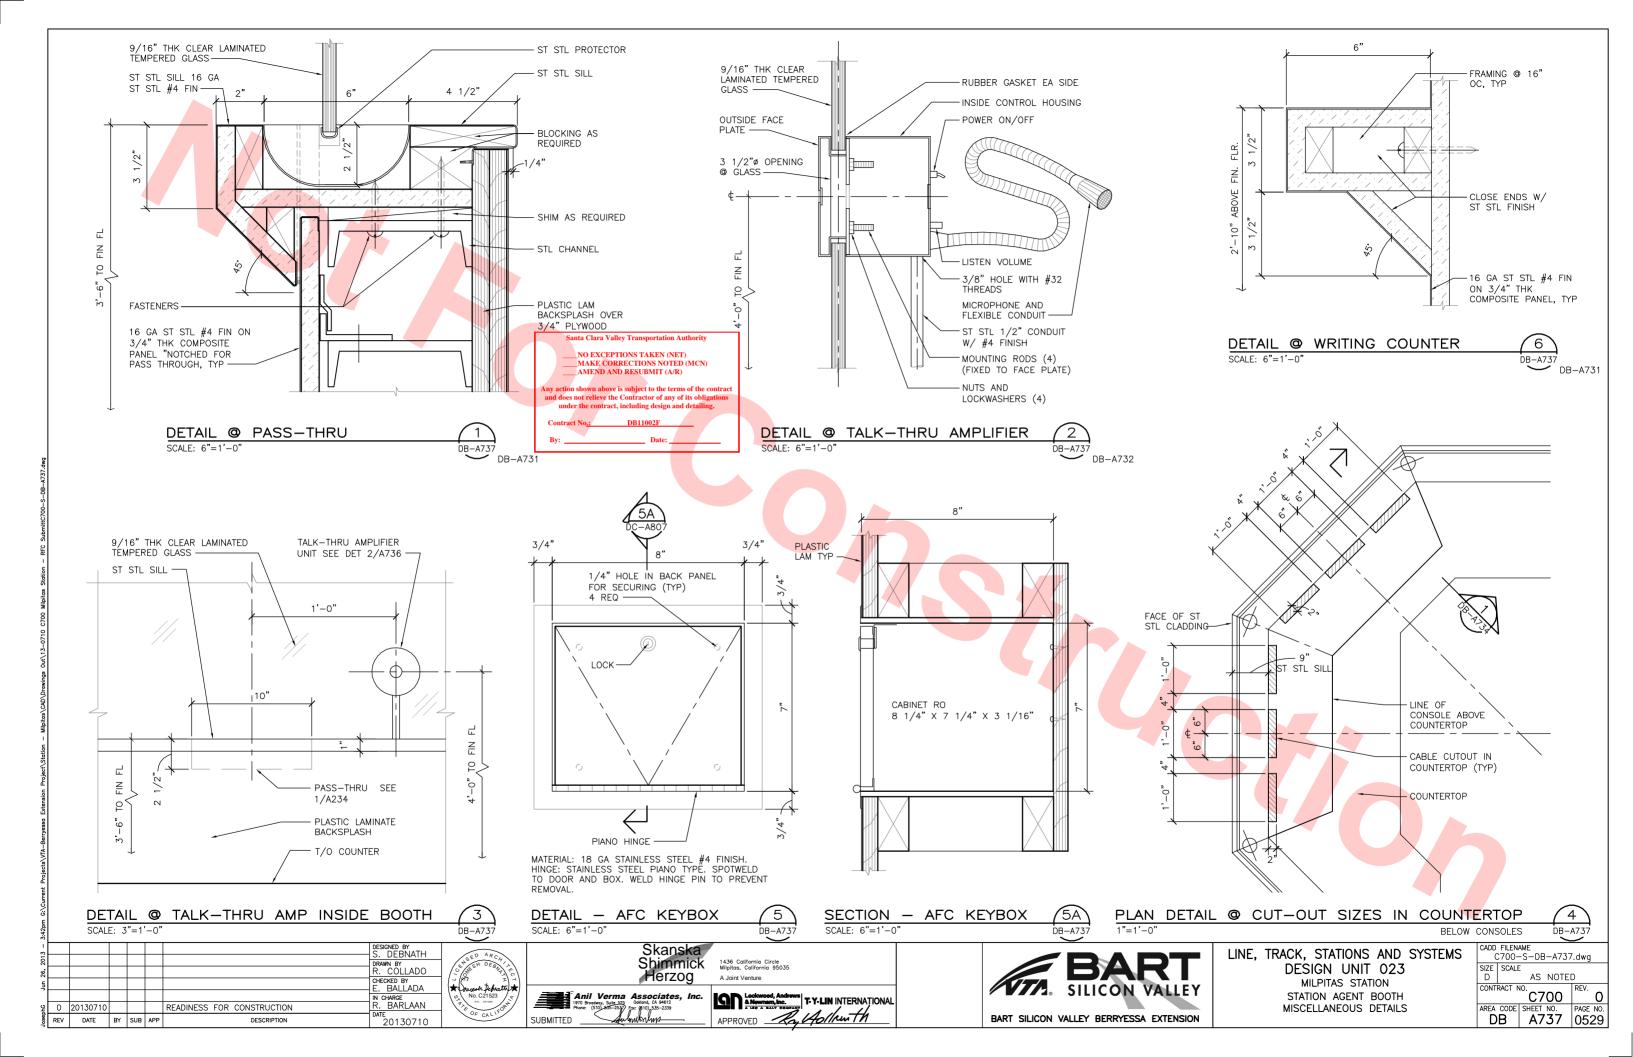


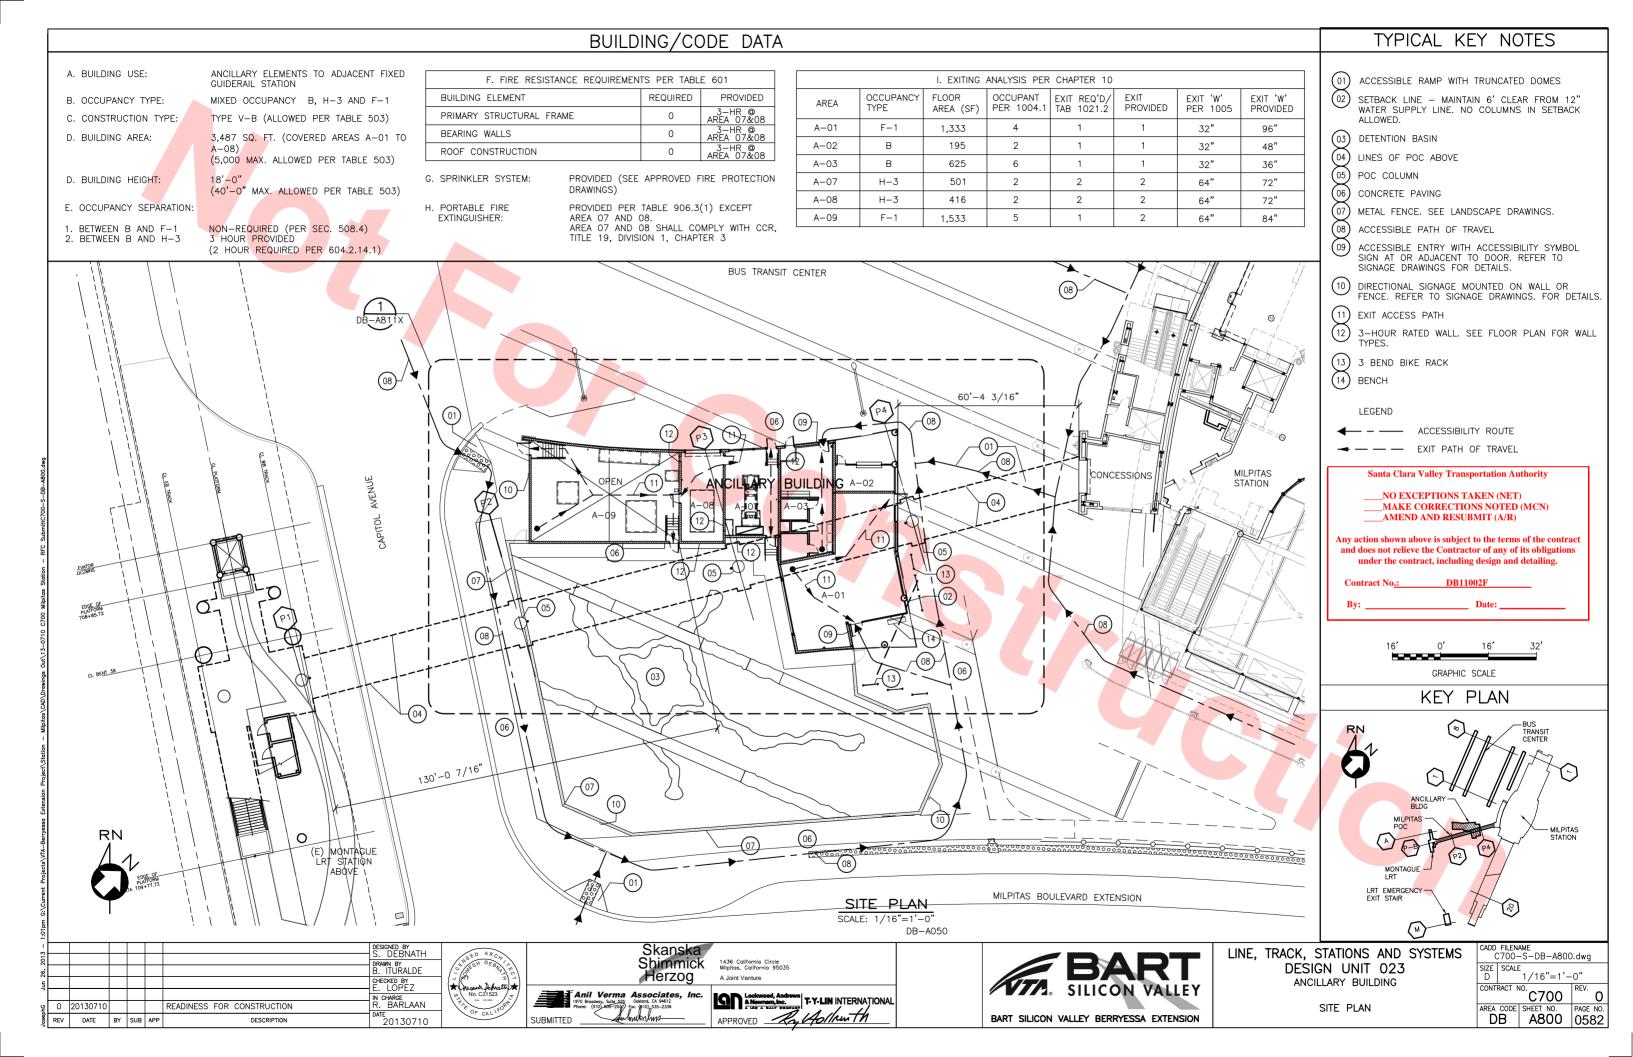


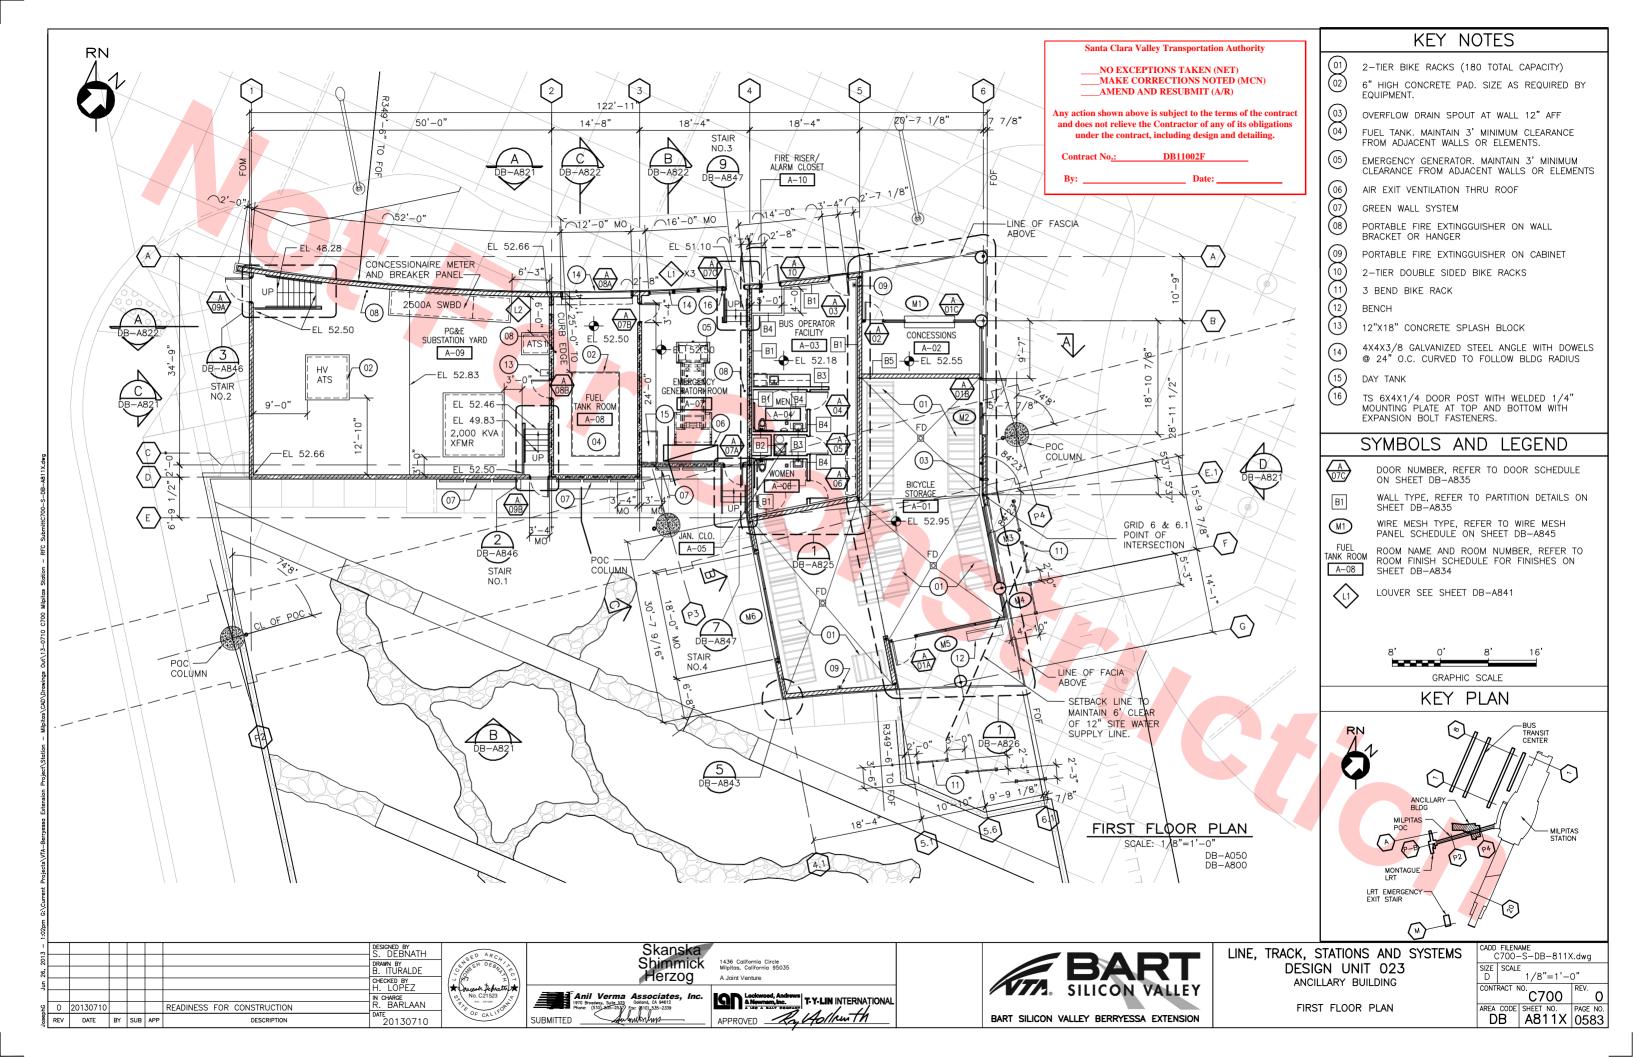

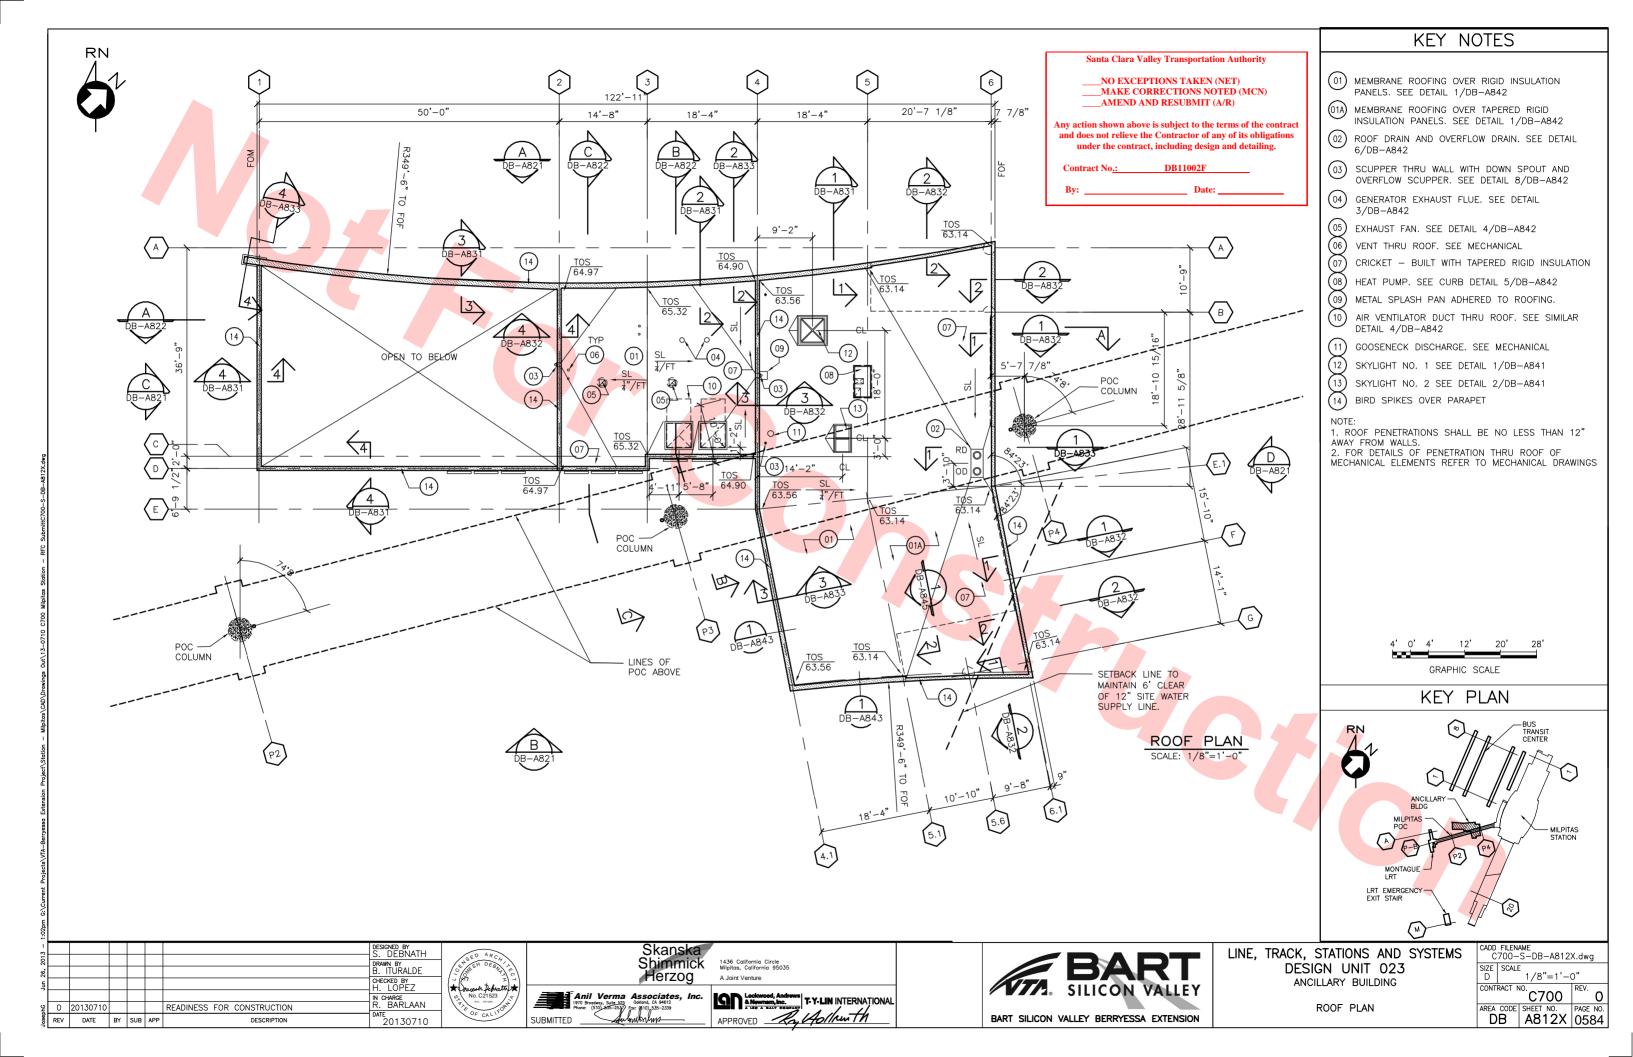

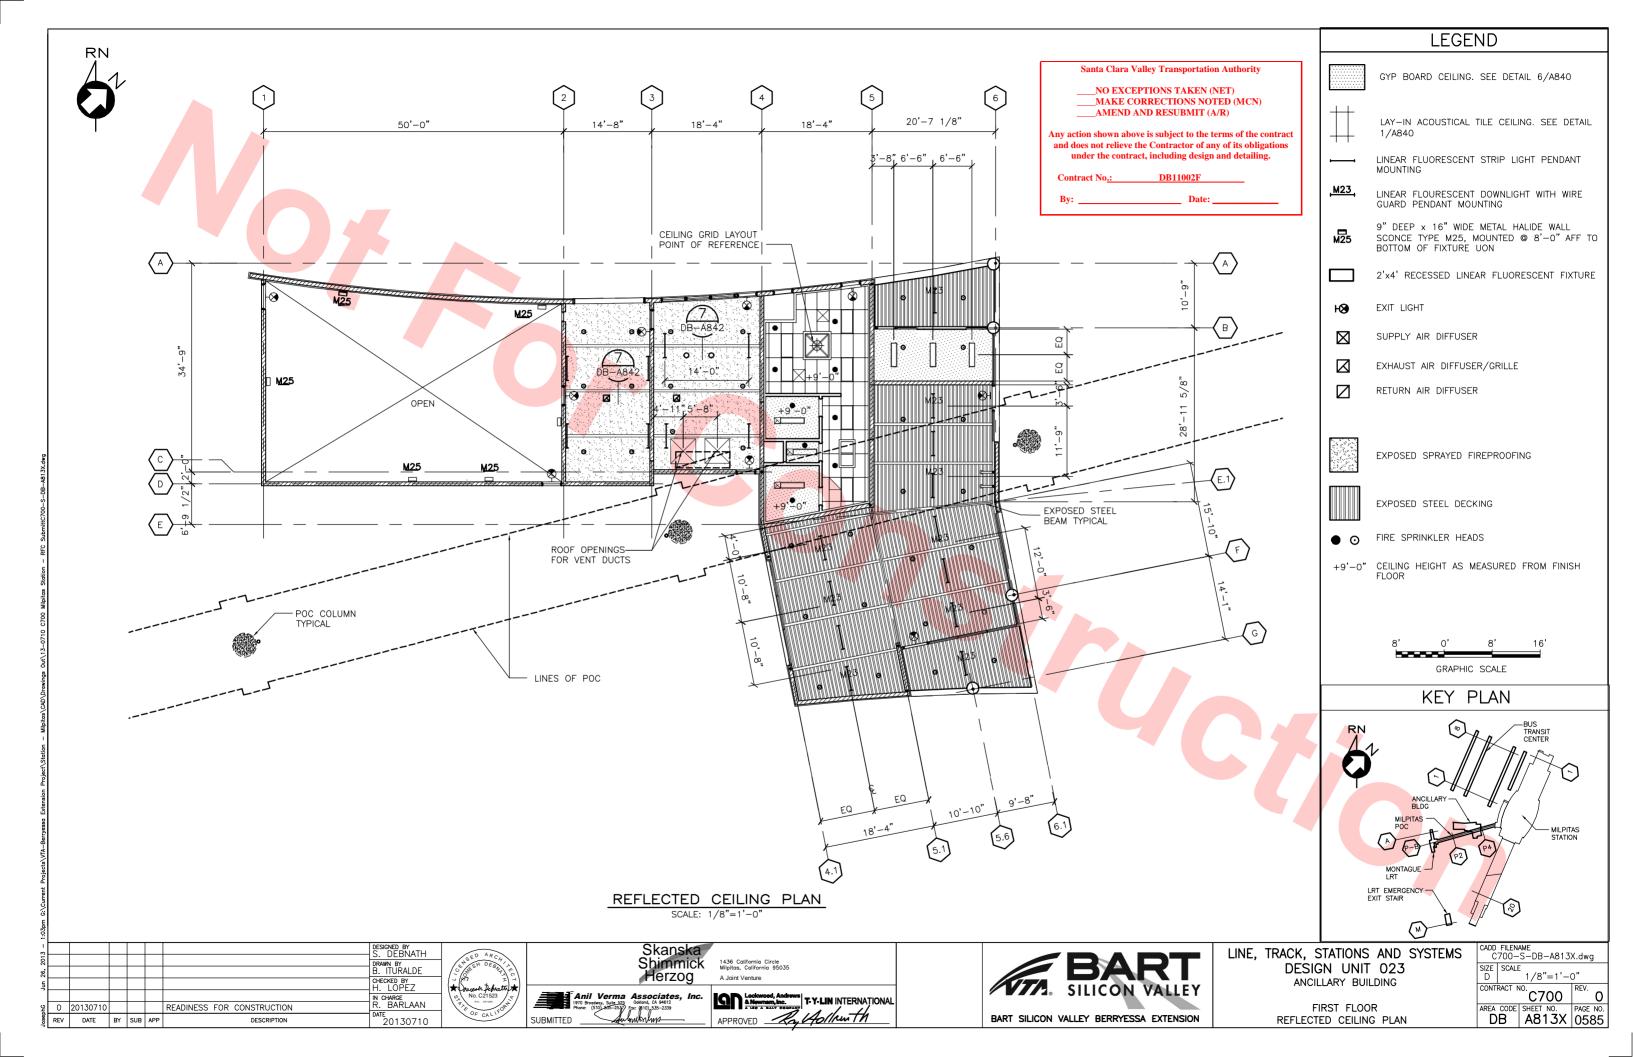

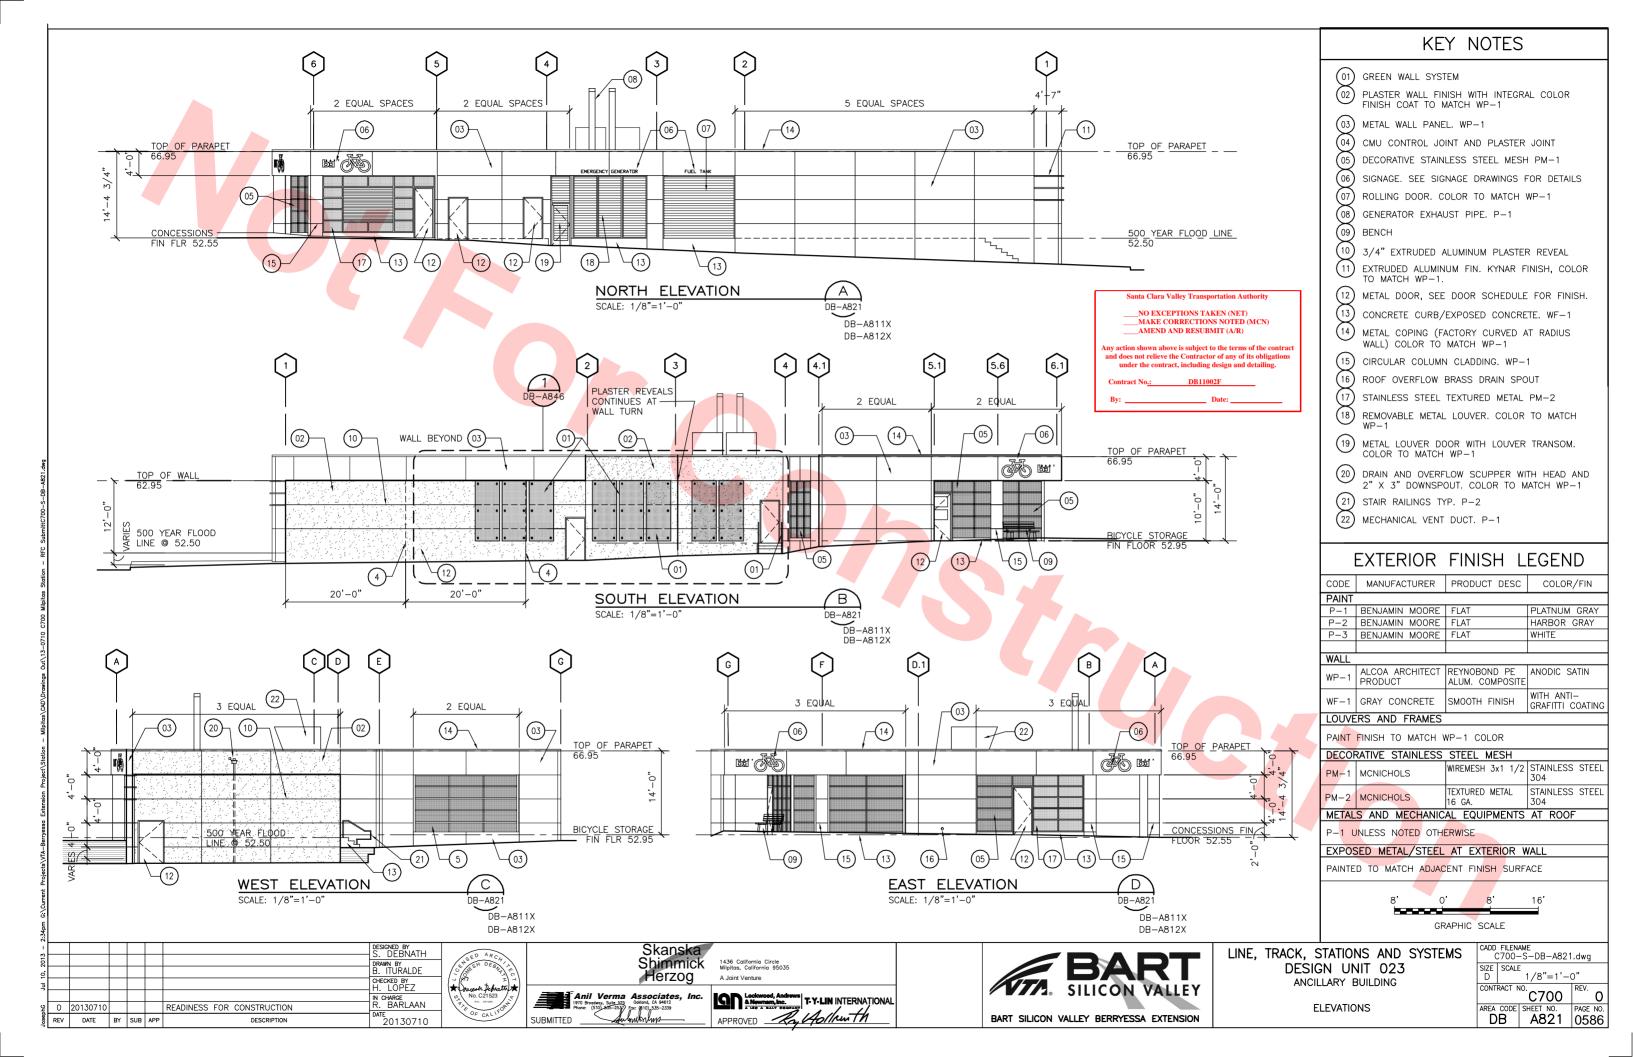

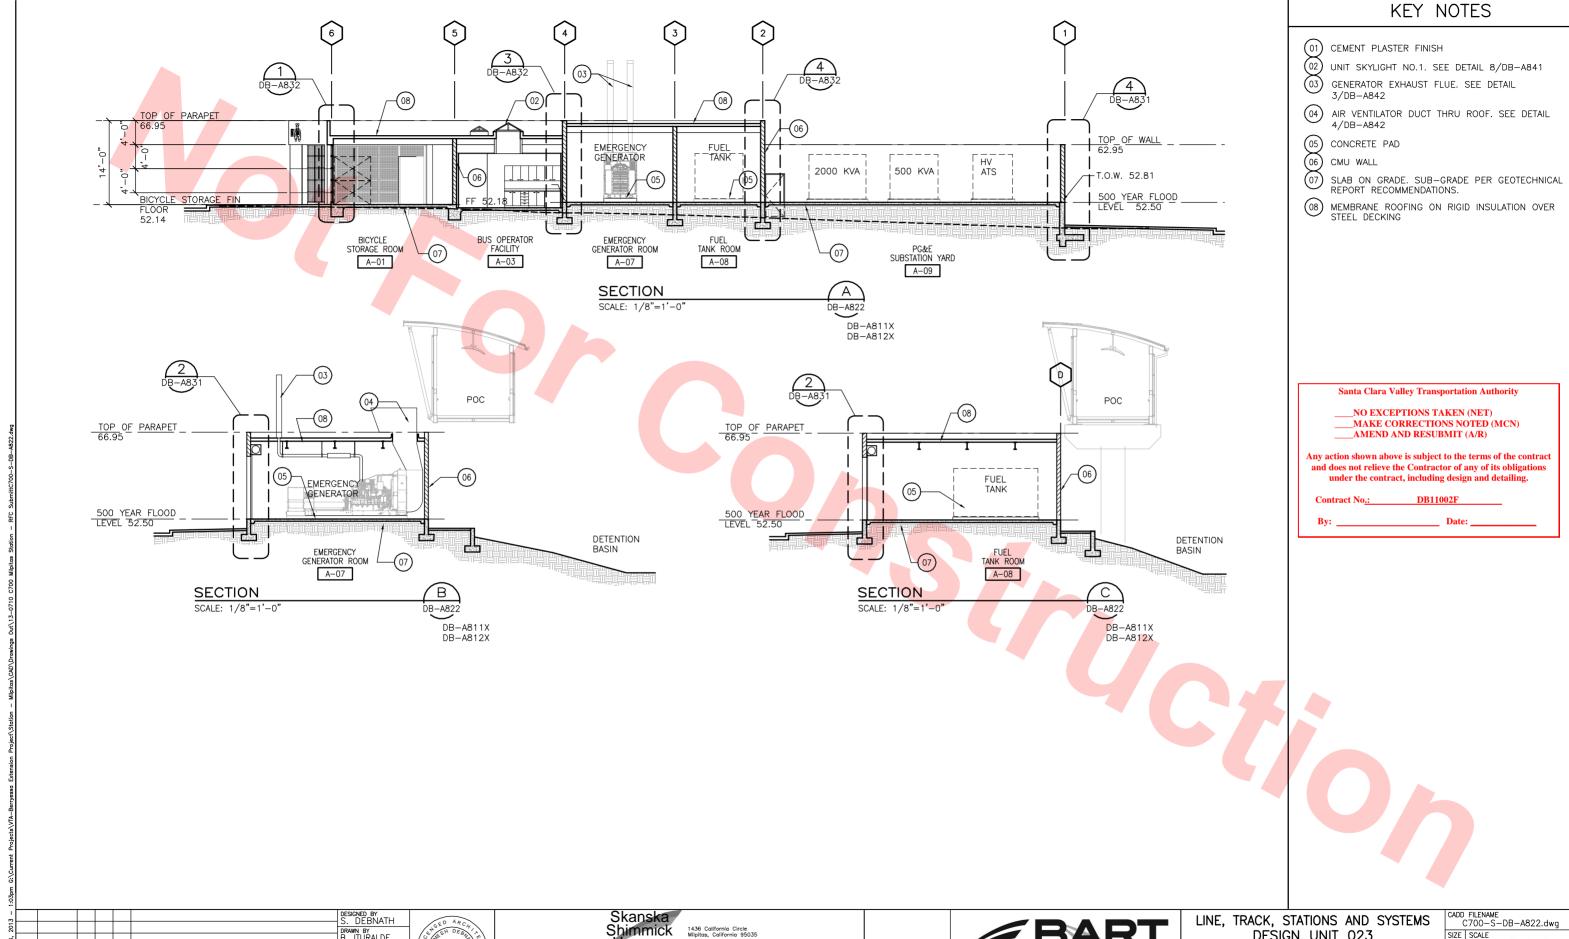

Lockwood, Andrews & Newman, Inc.

A Newman, Inc.

LUG - BAY COMPANY

T-Y-LIN INTERNATIONAL APPROVED Ry Hollren th

1436 California Circle Milpitas, California 95035

A Joint Venture

Herzog

Anil Verma Associates, Inc.
1970 Brookey, Suite, 525 Cooland, CA 94612
Phone: (\$10).635-2339 Fax: (\$10).535-2339

SUBMITTED

DRAWN BY B. ITURALDE

CHARGE . BARLAAN

20130710

CHECKED BY E. LOPEZ


Q 0 20130710 READINESS FOR CONSTRUCTION
REV DATE BY SUB APP DESCRIPTION


BART SILICON VALLEY BERRYESSA EXTENSION


LINE, TRACK, STATIONS AND SYSTEMS DESIGN UNIT 023 ANCILLARY BUILDING


SECTIONS


S	CADD FILENAME C700-S-DB-A822.dwg						
	SIZE D	SCALE	1/8"=1'-	0"			
	CONT	RACT N	^{10.} C700	REV. O			
		CODE	SHEET NO. A822	PAGE NO. 0587			

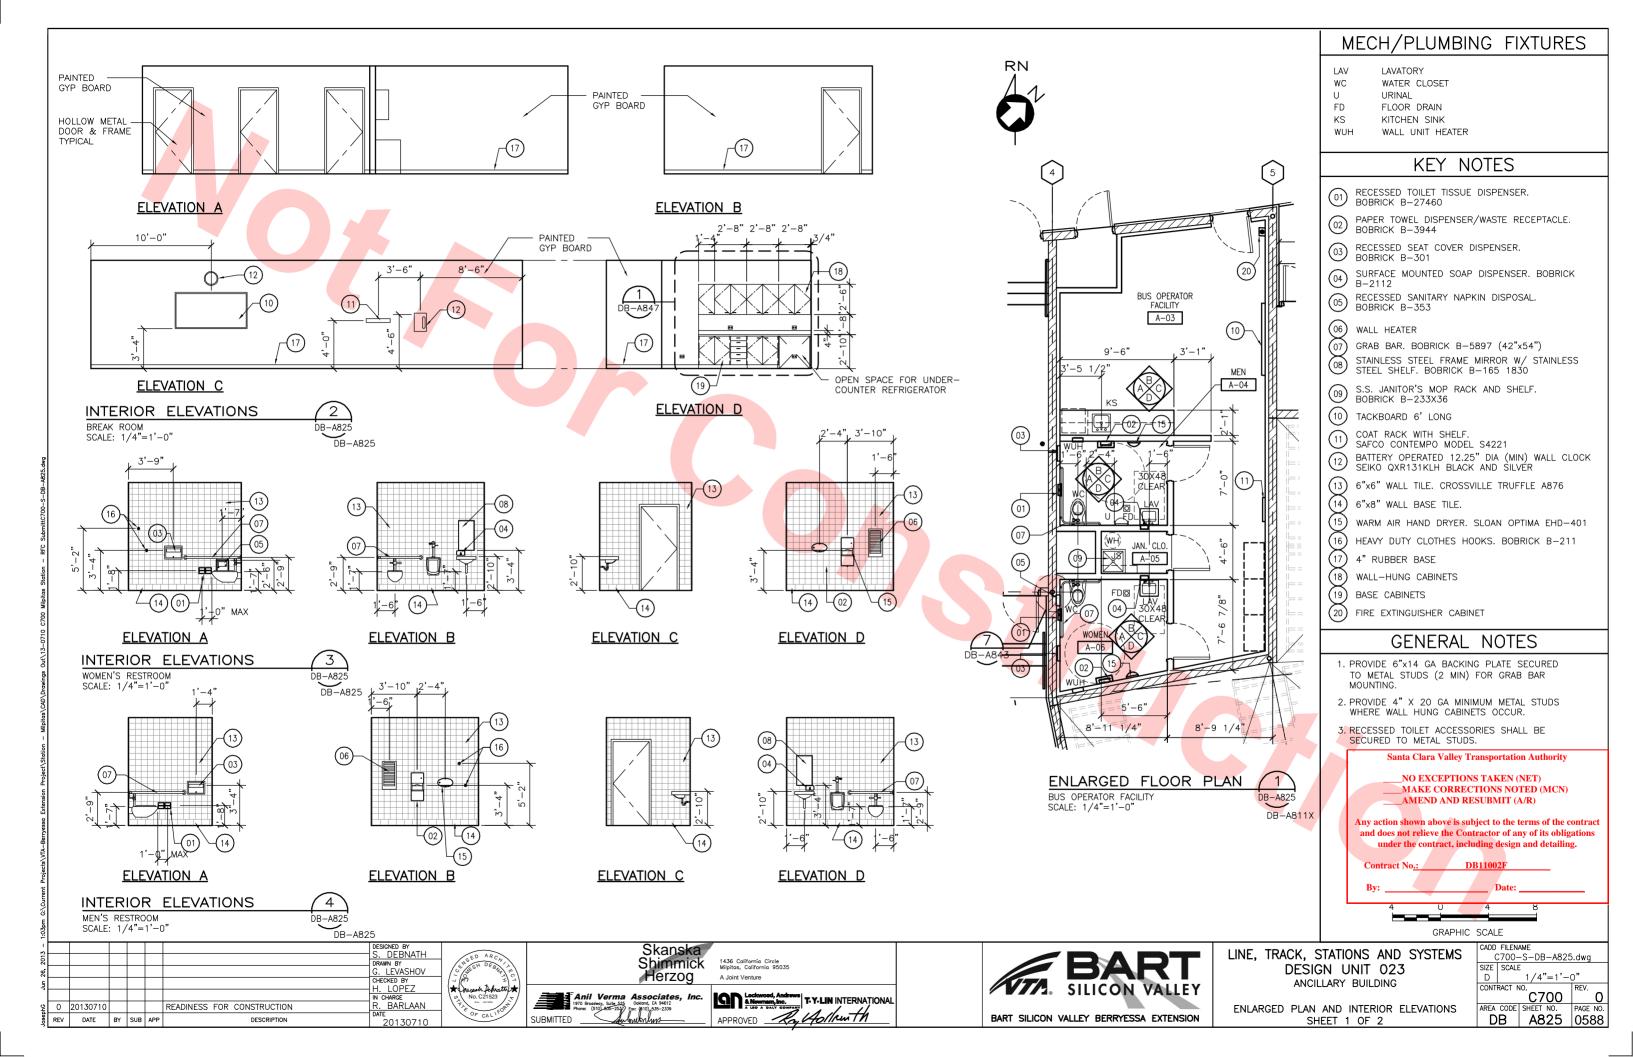


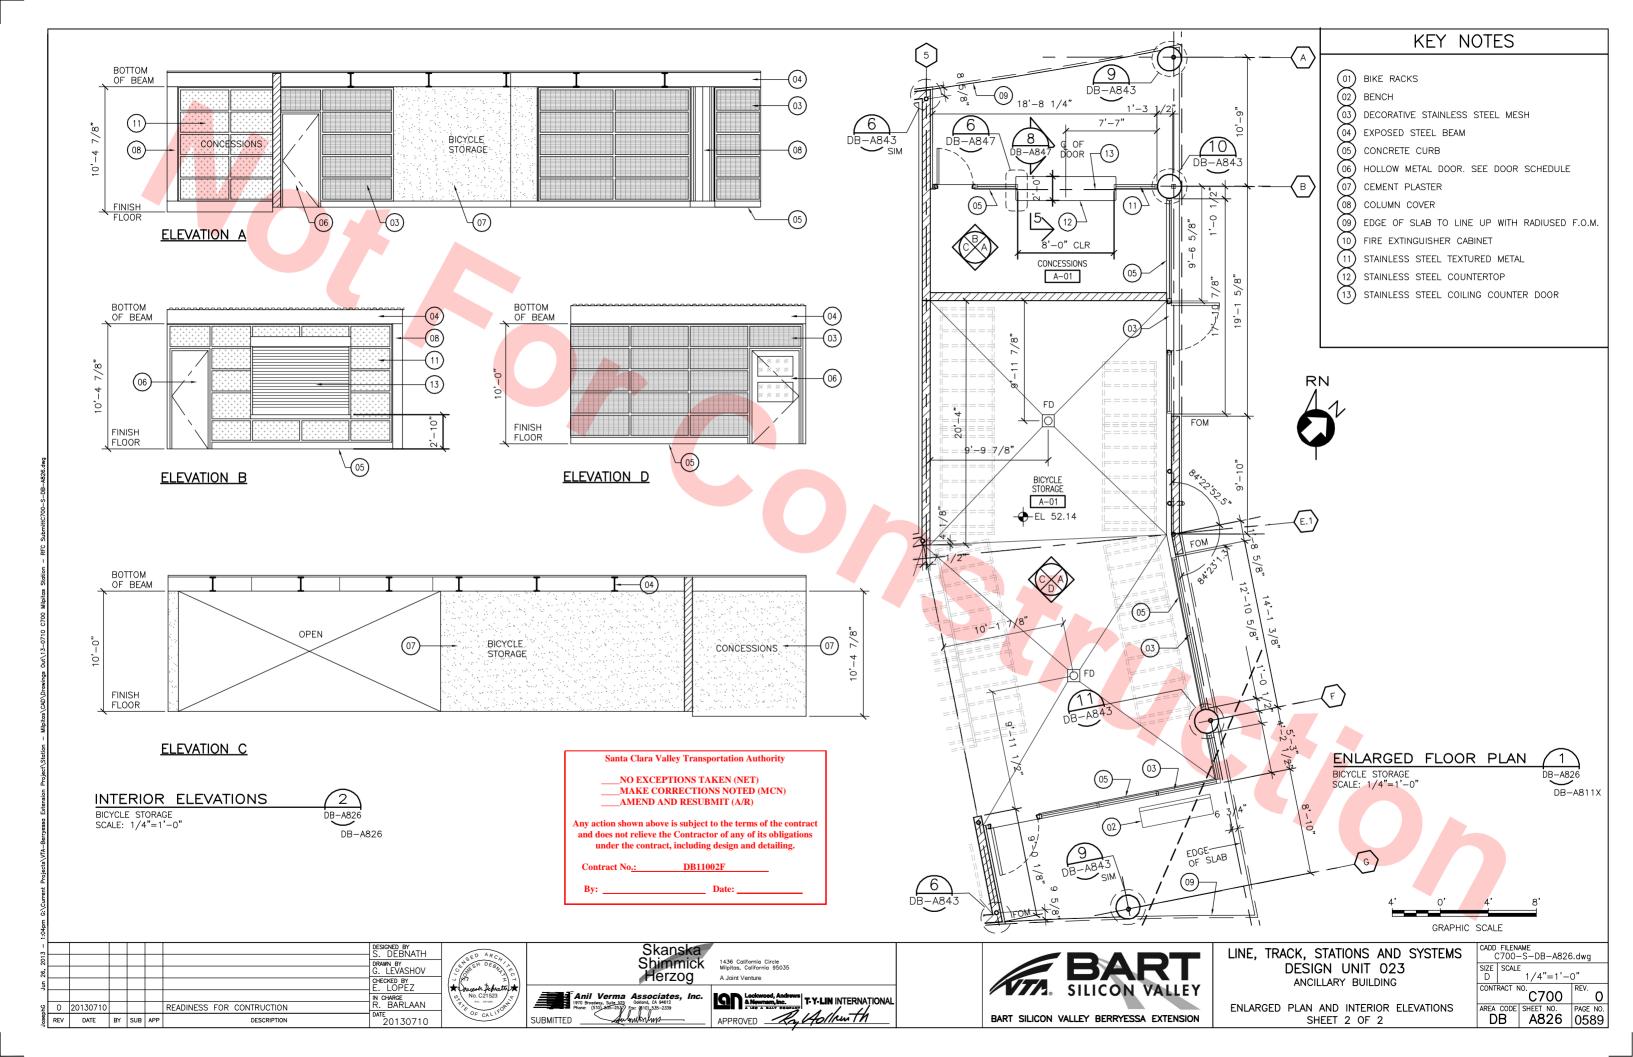


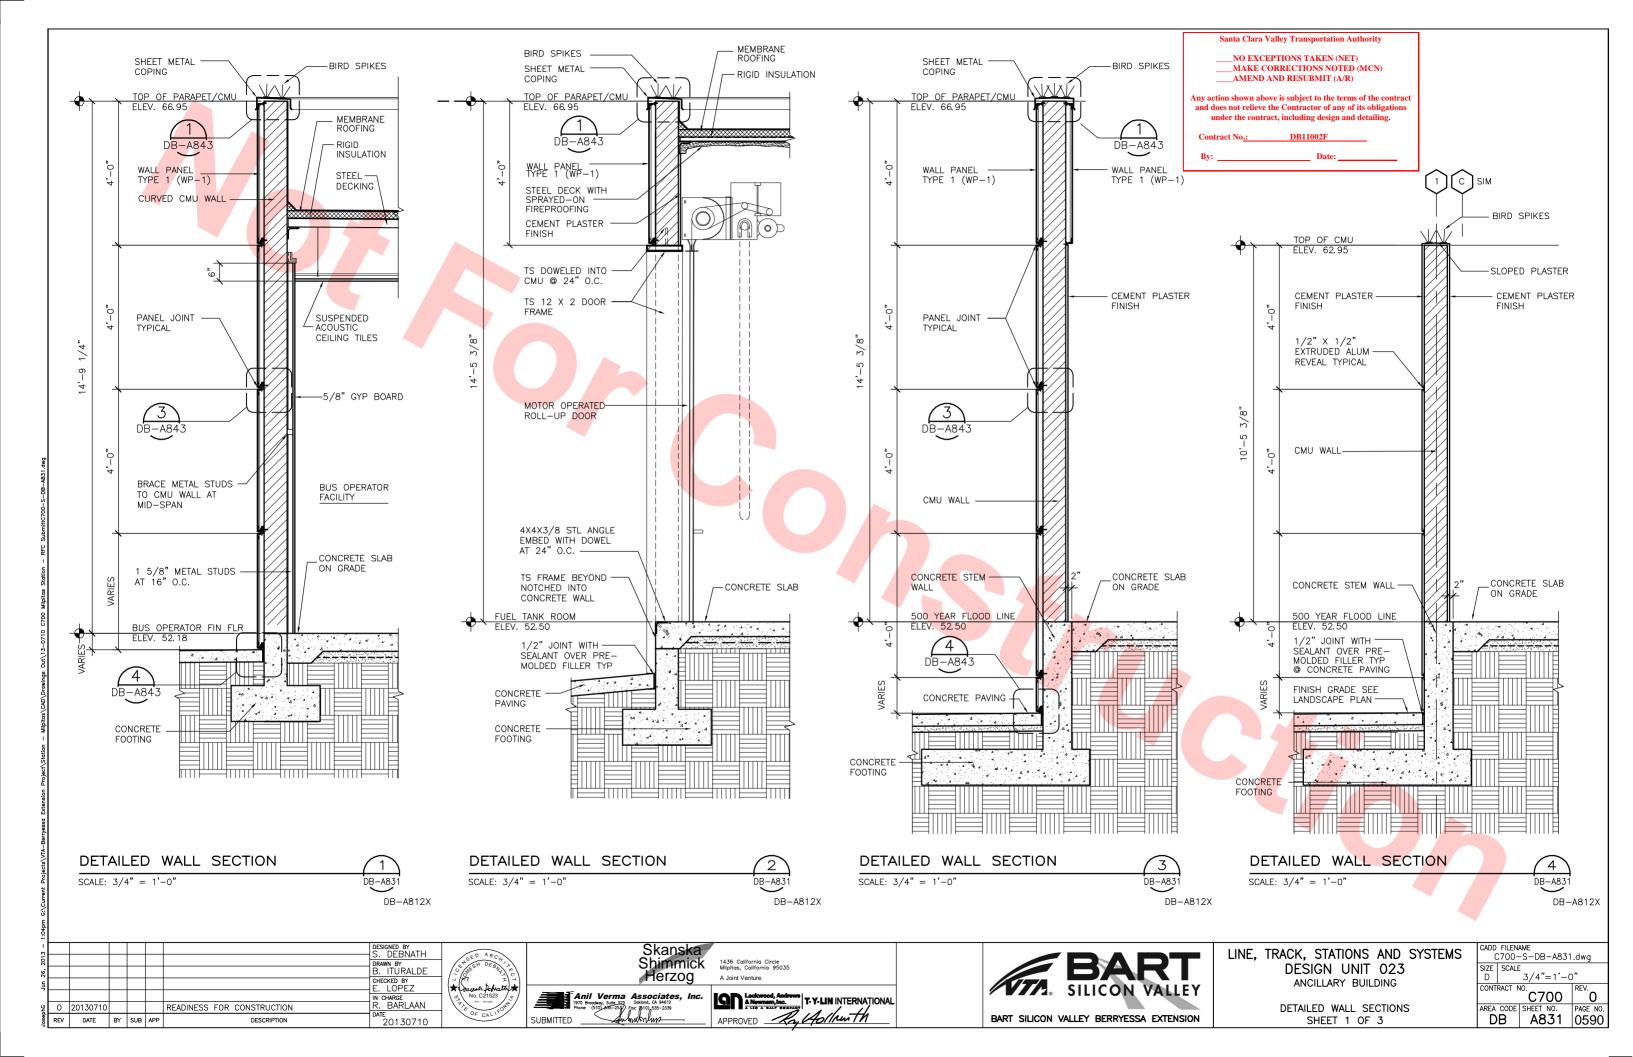


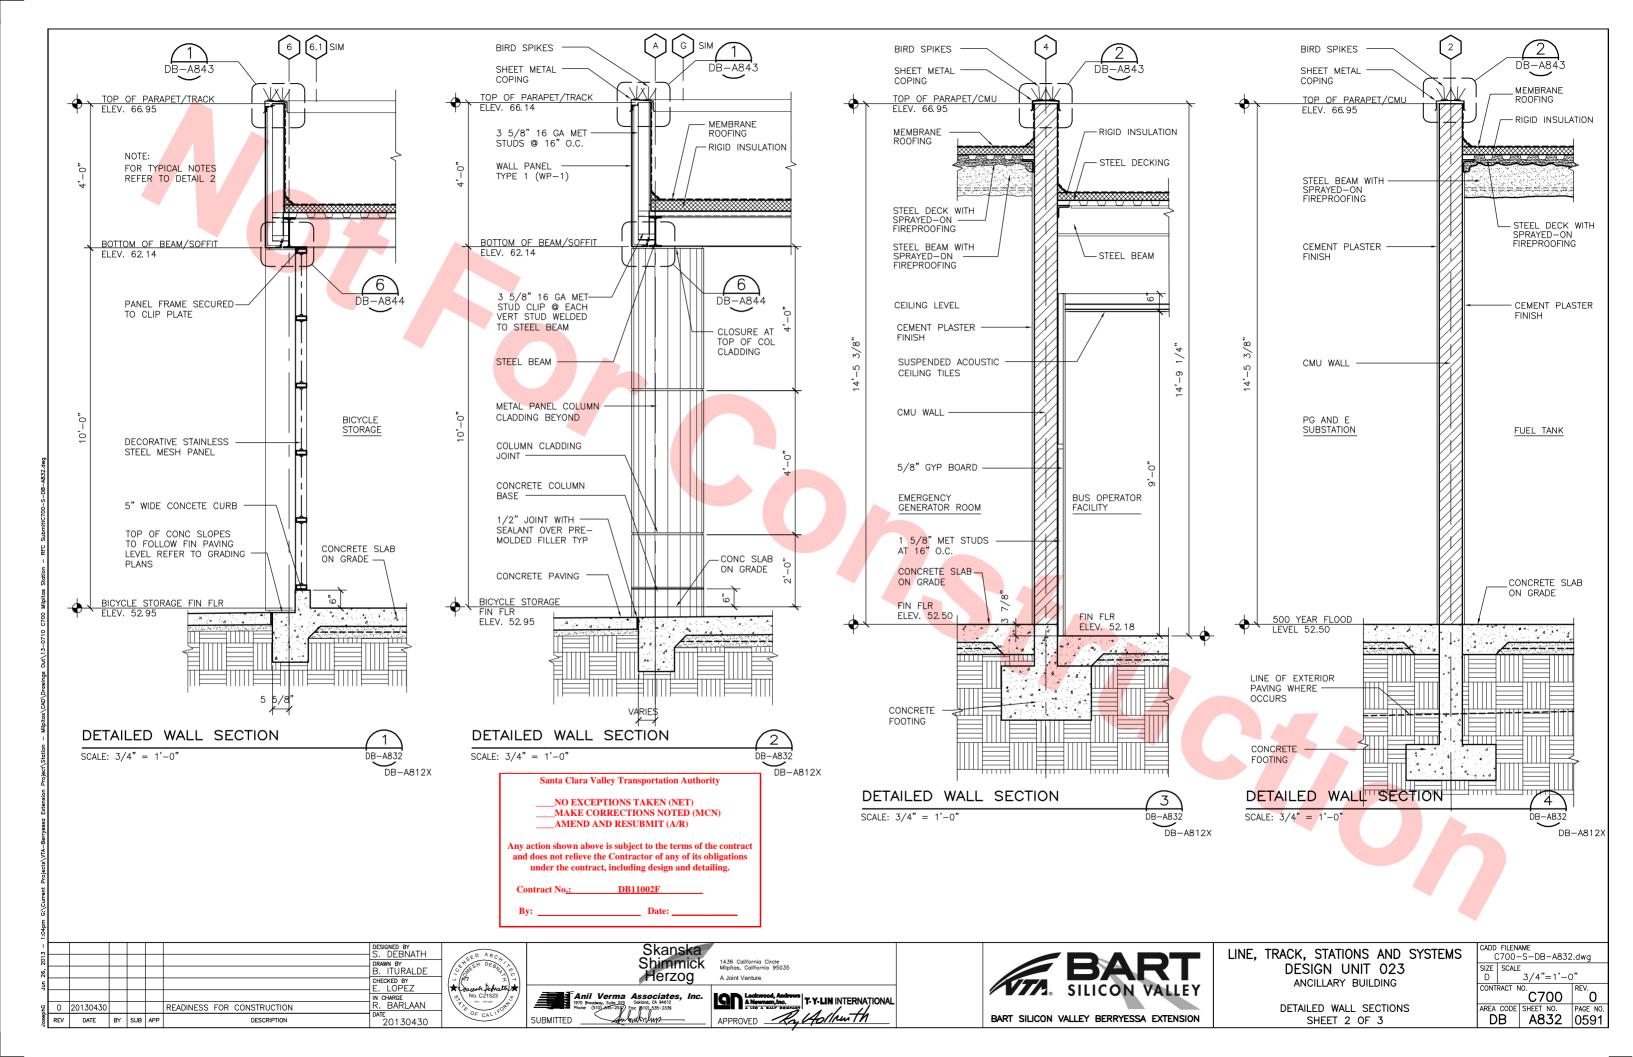


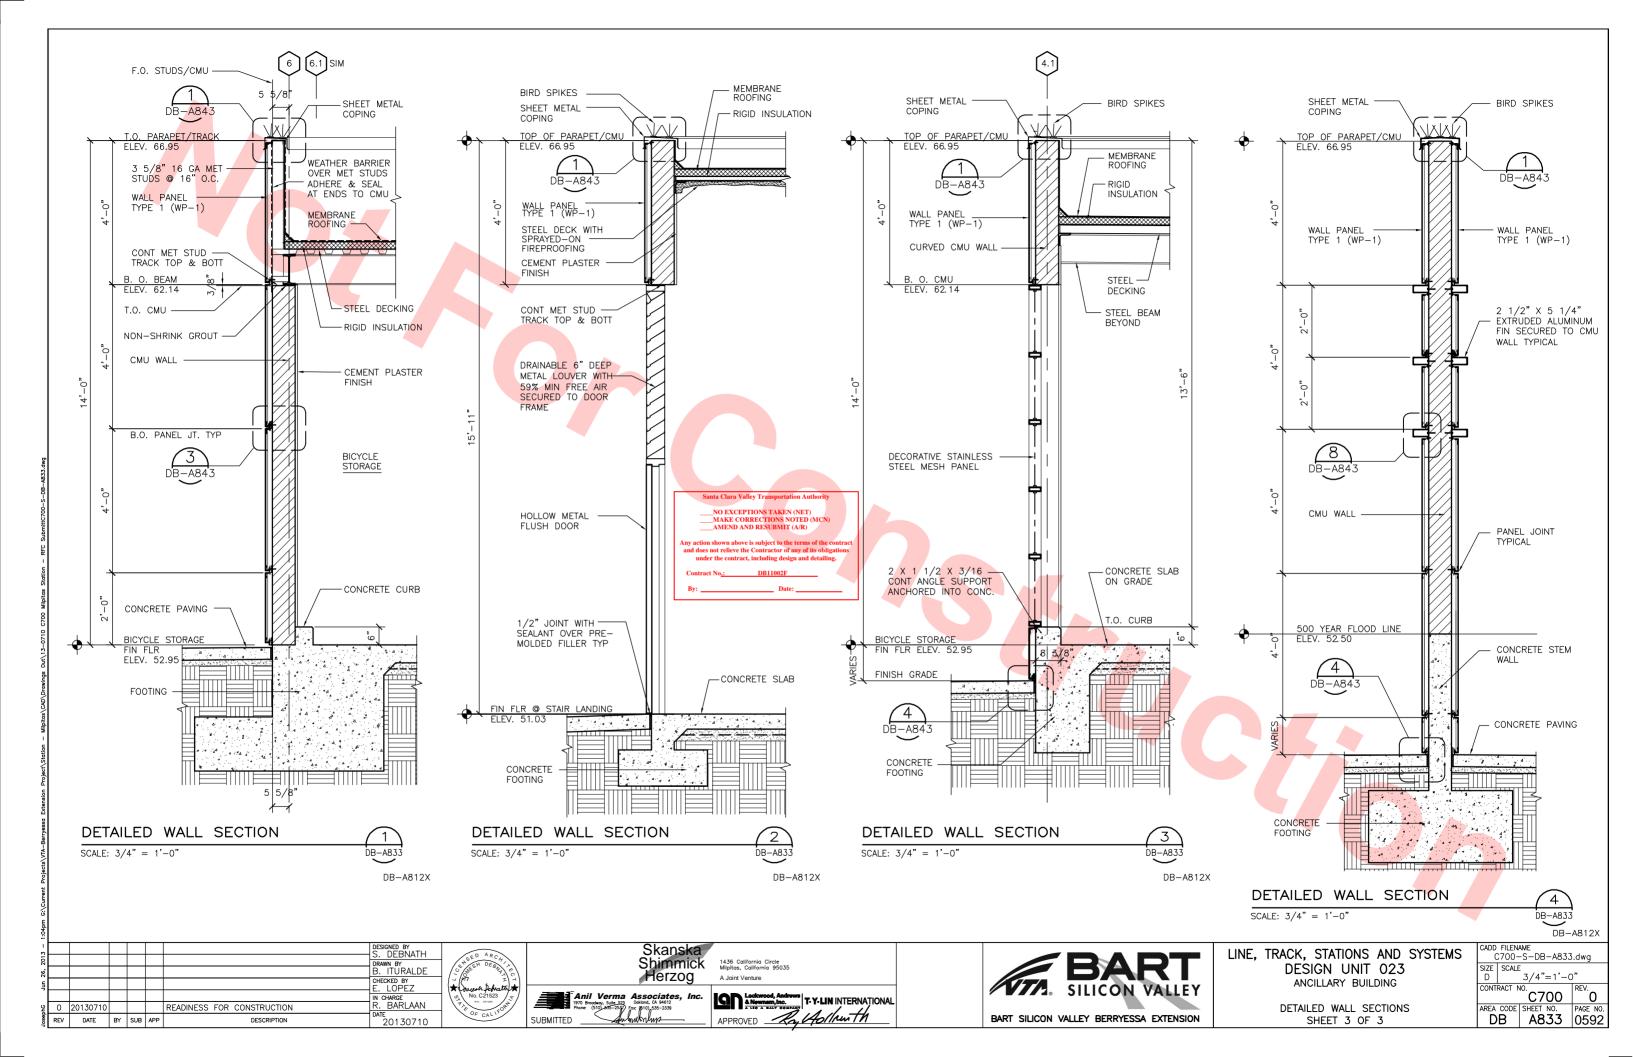

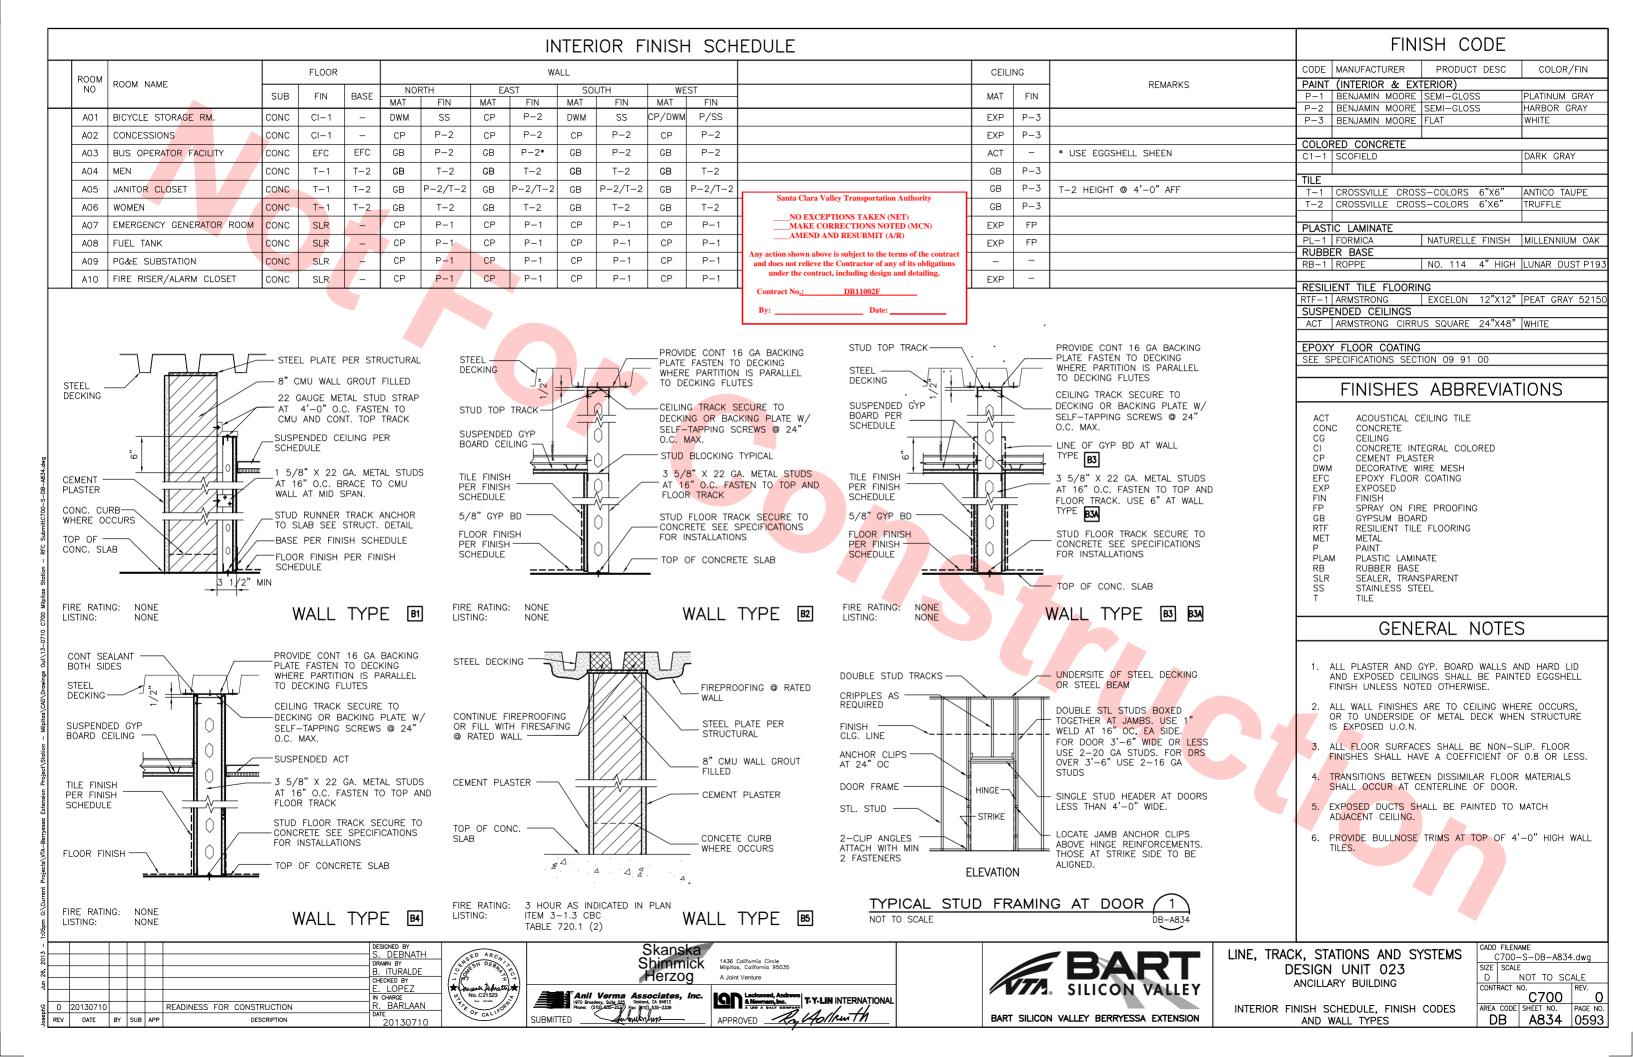

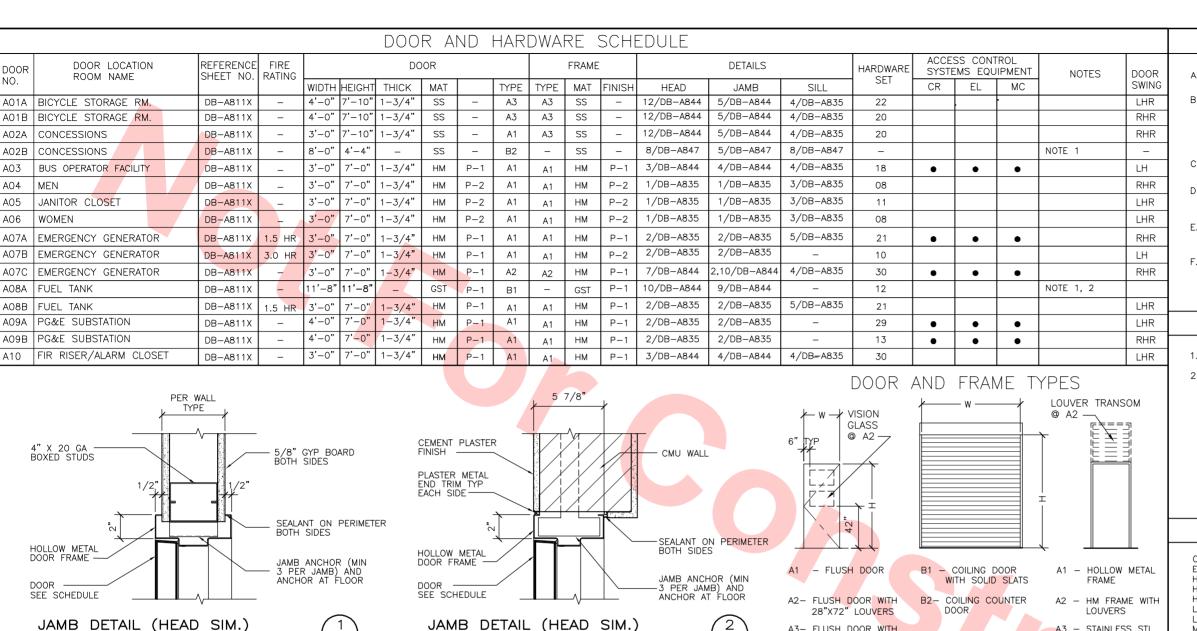

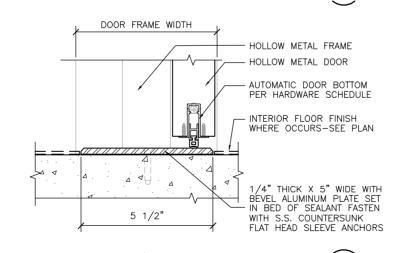

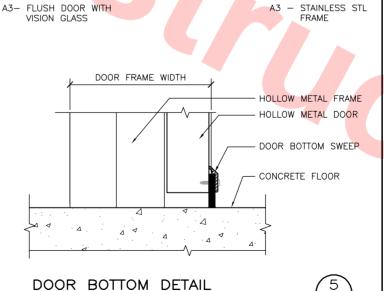

GENERAL NOTES

- A. FOR DETAILED DESCRIPTION OF HARDWARE SETS REFER TO SPECIFICATIONS SECTION 08 71 00
- B. SEE COMMUNICATIONS DRAWINGS AND SPECIFICATIONS SECTION 28 10 01 FOR DETAILED DESCRIPTION OF ACCESS CONTROL SYSTEMS EQUIPMENTS. QUANTITIES SHALL BE AS INDICATED IN COMMUNICATIONS DRAWINGS, WHERE DISCREPANCIES OCCUR WITH ARCHITECTURAL DRAWINGS, COMMUNICATIONS DRAWINGS SHALL PREVAIL
- C. WALL STOPS SHALL BE BOLTED TO METAL STUDS OR A 14 GA X 4" MIN WIDE MOUNTING PLATE FASTENED BETWEEN METAL STUDS.
- D. METAL DOORS WITH VISION GLASS SHALL BE 1/4" THICK CLEAR TEMPERED GLASS SECURED WITH METAL GLAZING MOLDING WITH SECURITY FASTENERS.
- E. COORDINATE DOOR SWINGS WITH FLOOR PLANS. WHERE DISCREPANCIES EXIST, DOOR SWINGS SHOWN ON PLANS SHALL PREVAIL
- F. PROVIDE DOOR HARDWARE SPECIFIED WITH THE APPROPRIATE HANDING OF DOOR SWING.

SCHEDULE NOTES

- HARDWARE BY DOOR MANUFACTURER. SEE PRODUCT SPECIFICATIONS
- DOOR AND FRAME SHALL BE FACTORY FINISH KYNAR 500, COLOR TO MATCH COMPOSITE WALL PANEL.

ABBREVIATIONS

CARD READER ELECTRIC LOCK EL HFIGHT HOLLOW METAL HARDWARE LEFT HAND IHR LEFT HAND REVERSE MAT MATERIAL MC MAGNETIC CONTACT PAINT FINISH COLOR 1 (TO MATCH COMPOSITE WALL PANEL) PAINT FINISH COLOR 2 GST GALVANIZED STEEL RH RIGHT HAND RHA RIGHT HAND ACTIVE RHR RIGHT HAND REVERSE RHRA RIGHT HAND REVERSE ACTIVE STAINLESS STEEL STFFI THICKNESS

Santa Clara Valley Transportation Authority

__NO EXCEPTIONS TAKEN (NET)
__MAKE CORRECTIONS NOTED (MCN)
AMEND AND RESUBMIT (A/R)

Any action shown above is subject to the terms of the contract and does not relieve the Contractor of any of its obligations under the contract, including design and detailing.

Contract No.: DB11002F

By: Date:

1:05p							
2013 -							DESIGNED BY S. DEBNATH DRAWN BY
8,							B. ITURALDE
틧							CHECKED BY E. LOPEZ
							IN CHARGE
일	0	20130710				READINESS FOR CONSTRUCTION	R. BARLAAN
JosephG	REV	DATE	BY	SUB	APP	DESCRIPTION	DATE 20130710

2 1/2"

FLOOR FINISH TRANSITION DETAIL

SCALE: 3'' = 1'-0''

CERAMIC TILE

SCALE: 6'' = 1'-0''

ON THINSET

DOOR FRAME WIDTH



SCALE: 3'' = 1'-0'

SCALF: 6" = 1'-0"

SUBMITTED

DB-A835

HOLLOW METAL FRAME

HOLLOW METAL DOOR

TRANSITION THRESHOLD PER JOHNSONITE "CTA-XX-K" ADHERED TO CONCRETE

RESILIENT TILE

CONCRETE SLAB

FLOORING



THRESHOLD/DOOR BOTTOM DETAIL

1436 California Circle Milpitas, California 95035 A Joint Venture



SCALF: 6" = 1'-0'

DB-A835

DB-A835




DB-A835

LINE, TRACK, STATIONS AND SYSTEMS
DESIGN UNIT 023
ANCILLARY BUILDING

DOORS AND HARDWARE SCHEDULE AND DETAILS

ONTRACT NO. C700 C700 PAGE NO. DB A835 0594

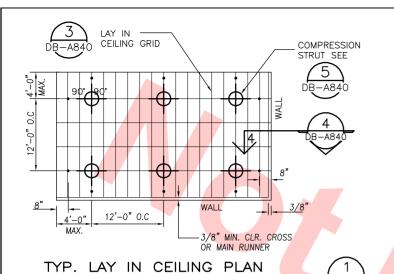

WIRE TO DECK ATTACHMENTS

ATTACH TO METAL DECK-

DB-A840

5/8" MAX.

CEILING CLIP "HILTI"

OR EQUAL 13 GA. X

3/4" WIDE

WIRE

3 TIGHT TURNS

VERTICAL HANGER

12 GA VERTICAL HANGER WIRE

AT 4'-0" FA WAY WITH MINI 3

TIGHT TURNS IN 1 1/2" BOTH

12 GA. BRACING WIRE WITH

MIN. 4 TIGHT TURNS IN 1

1/2" BOTH ENDS OF WIRE

TYPICAL

NOT TO SCALE

8" MAX.


ENDS OF WIRE (TYP)


DB-A840

CROSS RUNNERS


MAIN RUNNERS

(TYP)

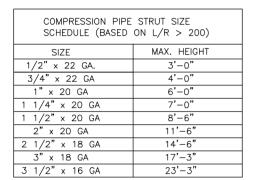

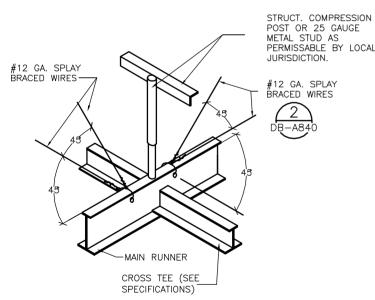



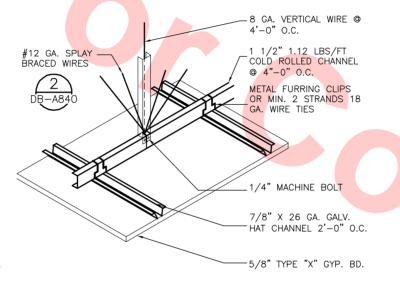

NOTES:

UNDERSIDE -

4 TIGHT TURNS

SPLAYED SEISMIC

STEEL STRAP 1" WIDE

X 2" LONG 12 GA.

BRACING WIRE

MINIMUM

DB-A840

DB-A813X

OF DECK

- 1. LATERAL SUPPORT SHALL BE PROVIDED BY (4) WIRES (12 GA. MIN.) SPLAYED IN FOUR DIRECTIONS 90° APART. CONNECT TO MAIN RUNNER @ 2" MAX. FROM CROSS-RUNNER AND TO STRUCTURE ABOVE AT AN ANGLE NOT EXCEEDING 45' FROM PLANE OF CEILING. INSTALL LATERAL SUPPORTS @ 12'-0" INTERVALS EA. DIRECTION W/FIRST POINT @ 6'-0" MAX. FROM EA. WALL
- 2. VERTICAL SUPPORT SHALL BE PROVIDED AS REQUIRED IN CHAPTER 47 UNIFORM BUILDING CODE, WITH THE ADDED REQUIREMENT THAT DISCONTINUOUS ENDS OF CROSS-RUNNERS AND MAIN RUNNERS SHALL BE VERTICALLY SUPPORTED @ 8" MAX. FROM SUCH DISCONTINUITIES WHICH OCCUR WHERE CEILING IS DISRUPTED BY A WALL
- 3. PROVIDE 1 1/8" X 1 1/2" X 20 GA. ANGLE AT END OF EACH CHANNEL TO VERTICAL WALL STUDS.

TYPICAL GYP. BD CEILING

SURMITTED



DB-A813X

NOT TO SCALE

1436 California Circle Milpitas, California 95035 A Joint Venture

BART SILICON VALLEY BERRYESSA EXTENSION

GENERAL NOTES

VERTICAL COMPRESSION STRUT

AT 12'-0" O.C. EA. WAY WITH FIRST POINT TO BE WITHIN

FASTENED TO MAIN RUNNER &

STRUCTURE ABOVE PER U.B.C.

COMPRESSION STRUTS MAY BE

METAL STUDS, AS PERMISSIBLE

DB-A840

SUBSTITUTED WITH 25 GAUGE

BY LOCAL JURISDICTION) SEE

6'-0" FROM FACH WALL

25.212.3 (VERTICAL

8" MAX

- 1. 12 GA. (MIN) HANGER WIRES MAY BE USED FOR UP TO AND INCLUDING 4'-0' x 4'-0" GRID SPACING ALONG MAIN RUNNERS. SPLICES WILL NOT BE PERMITTED IN HANGER WIRES.
- 2. PROVIDE 12 GA. HANGER WIRES AT THE ENDS OF ALL MAIN & CROSS RUNNERS WITHIN 8" OF THE SUPPORT OR WITHIN 1/4" OF THE LENGTH OF THE END TEE, WHICHEVER IS LEAST, FOR THE PERIMETER OF THE CEILING
- 3. PROVIDE TRAPEZE OR OTHER SUPPLEMENTARY SUPPORT MEMBERS AT OBSTRUCTIONS TO MAIN HANGER SPACING. PROVIDE ADDITIONAL HANGERS. STRUTS OR BRACES AS REQUIRED AT ALL CEILING BREAKS, SOFFITS, OR DISCONTINUOUS AREAS. HANGER WIRES THAT ARE MORE THAN 1 IN 6 OUT OF PLUMB ARE TO HAVE COUNTER SLOPING WIRES.
- 4. AT THE PERIMETER OF THE CEILING AREA WHERE MAIN OR CROSS RUNNERS ARE NOT TO THE ADJACENT WALL. PROVIDE INTERCONNECTION BETWEEN THE RUNNERS AT THE FREE END TO PREVENT LATERAL SPREADING. A METAL STRUT OR 16 GA. WIRE WITH A POSITIVE MECHANICAL CONNECTOR TO THE RUNNER MAY BE USED. WHERE THE PERPENDICULAR DISTANCE FROM THE WALL TO THE FIRST PARALLEL RUNNER IS 12" OR LESS, THIS INTERLOCK IS NOT REQUIRED
- 5. CEILING GRID MEMBERS MAY BE ATTACHED TO NOT MORE THAN 2 ADJACENT WALLS CEILING GRID MEMBERS SHOULD BE AT LEAST 1/2" FREE OF OTHER
- 6. PROVIDE SETS OF 4-12 GA. SPLAYED BRACING WIRES ORIENTED 90 DEGREES FROM EACH OTHER AT NOT MORE THAN 8' x 12' O.C. PROVIDE BRACING WIRES AT LOCATIONS NOT MORE THAN 1/2 THE SPACING GIVEN ABOVE (4' & 6') FROM EACH PERIMETER WALL AND AT THE EDGE OF VERTICAL CEILING SOFFITS. THE SLOPE OF THESE WIRES SHOULD NOT EXCEED 45 DEGREES FROM THE SLOPE OF THE CELLING AND SHOULD BE TAUT WITHOUT CAUSING THE CEILING TO UPLIFT. A STRUT FASTENED TO THE MAIN RUNNER AT EACH OF THE SPLAYED BRACING WIRE CONVERGENCE POINTS SHALL BE EXTENDED TO AND FASTENED TO THE FLOOR OR ROOF STRUCTURE ABOVE.
- 7. FASTEN HANGER WIRES WITH NOT LESS THAN 3 TIGHT TURNS. FASTEN BRACING WIRES WITH 4 TIGHT TURNS. MAKE ALL TIGHT TURNS WITHIN A DISTANCE OF 1-1/2 INCHES.
- 8. SEPARATE ALL CEILING HANGING AND BRACING WIRES AT LEAST 6 INCHES FROM ALL UNBRACED PIPES, DUCTS, PIPES, CONDUITS, ETC. IT IS ACCEPTABLE TO ATTACH LIGHTWEIGHT ITEMS, SUCH AS SINGLE ELECTRICAL CONDUIT NOT EXCEEDING 3/4" NOMINAL TO HANGER WIRES USING CONNECTORS ACCEPTABLE TO OSHPD.
- ATTACH ALL LIGHT FIXTURES TO THE CEILING GRID RUNNERS TO RESIST A HORIZONTAL FORCE EQUAL TO THE WEIGHT OF THE FIXTURES.
- 10.FLUSH OR RECESSED LIGHT FIXTURES AND AIR TERMINALS OR SERVICES WEIGHING LESS THAN 56 LBS. MAY BE SUPPORTED DIRECTLY ON THE RUNNER OF A HEAVY DUTY GRID SYSTEM BUT, IN ADDITION, THEY MUST HAVE A MIN. OF 2-12 GA. SLACK SAFETY WIRES ATTACHED TO THE FIXTURE AT DIAGONAL CORNERS AND ANCHORED TO THE STRUCTURE ABOVE. ALL 4' x 4' LIGHT FIXTURES MUST HAVE SLACK SAFETY WIRES AT EACH CORNER. ALL FLUSH OR RECESSED LIGHT FIXTURES AND AIR TERMINALS OR SERVICES WEIGHING 56 LBS. OR MORE MUST BE INDEPENDANTLY SUPPORTED BY NOT LESS THAN 4 TAUT 12 GA. WIRES EACH ATTACHED TO THE FIXTURE AND TO THE STRUCTURE ABOVE REGARDLESS OF THE TYPE OF CEILING GRID SYSTEM USED THE 4 TAUT 12 GA. WIRES INCLUDING THEIR ATTACHMENT TO THE STRUCTURE ABOVE MUST BE CAPABLE OF SUPPORTING 4 TIMES THE THE WEIGHT OF THE
- 11.ALL FIXTURES AND AIR TERMINALS OR SERVICES SUPPORTED ON INTERMEDIATE DUTY GRID SYSTEMS MUST BE INDEPENDENTLY SUPPORTED BY NOT LESS THAN 4 TAUT 12 GA. WIRES EACH ATTACHED TO THE FIXTURE OR TERMINAL AND TO THE STRUCTURE ABOVE.
- 12.SUPPORT SURFACE MOUNTED LIGHT FIXTURES BY AT LEAST TWO POSITIVE DEVICES WHICH SURROUND THE CEILING RUNNER AND WHICH ARE EACH SUPPORTED FROM THE STRUCTURE ABOVE BY 12 GA. WIRE. SPRING CLIPS OR CLAMPS THAT CONNECT ONLY TO THE RUNNER ARE NOT ACCEPTABLE. PROVIDE ADDITIONAL SUPPORT WHEN LIGHT FIXTURES ARE 8 FEET OR LONGER.

Santa Clara Valley Transportation Authority NO EXCEPTIONS TAKEN (NET) MAKE CORRECTIONS NOTED (MCN) AMEND AND RESUBMIT (A/R) Any action shown above is subject to the terms of the contract and does not relieve the Contractor of any of its obligations under the contract, including design and detailing. DB11002F

LAY IN CEILING GRID

WALL LINE -

#12 GA. HANGER

PERIMETER WALLS

MAIN RUNNER OR

WIRE TYP. AT

ACOUSTIC TILE -

WALL ANGLE -

ACOUSTIC TILE DETAIL

CROSS TEE

LINE, TRACK, STATIONS AND SYSTEMS **DESIGN UNIT 023** ANCILLARY BUILDING

CEILING DETAILS

CADD FILENAME C700-S-DB-A840.dwg SIZE SCALE AS NOTED CONTRACT NO C700 A840 0595 DB


DESIGNED BY S. DEBNATH I FVASHOV LOPEZ . BARLAAN READINESS FOR CONSTRUCTION DATE BY SUB APP 20130710


* Course Schatty *

Skanska Shimmick Herzoa Anil Verma Associates, In

Lockwood, Andrews & Newmann, Inc.

T. Y. LIN INTERNATIONAL Mollren th APPROVED

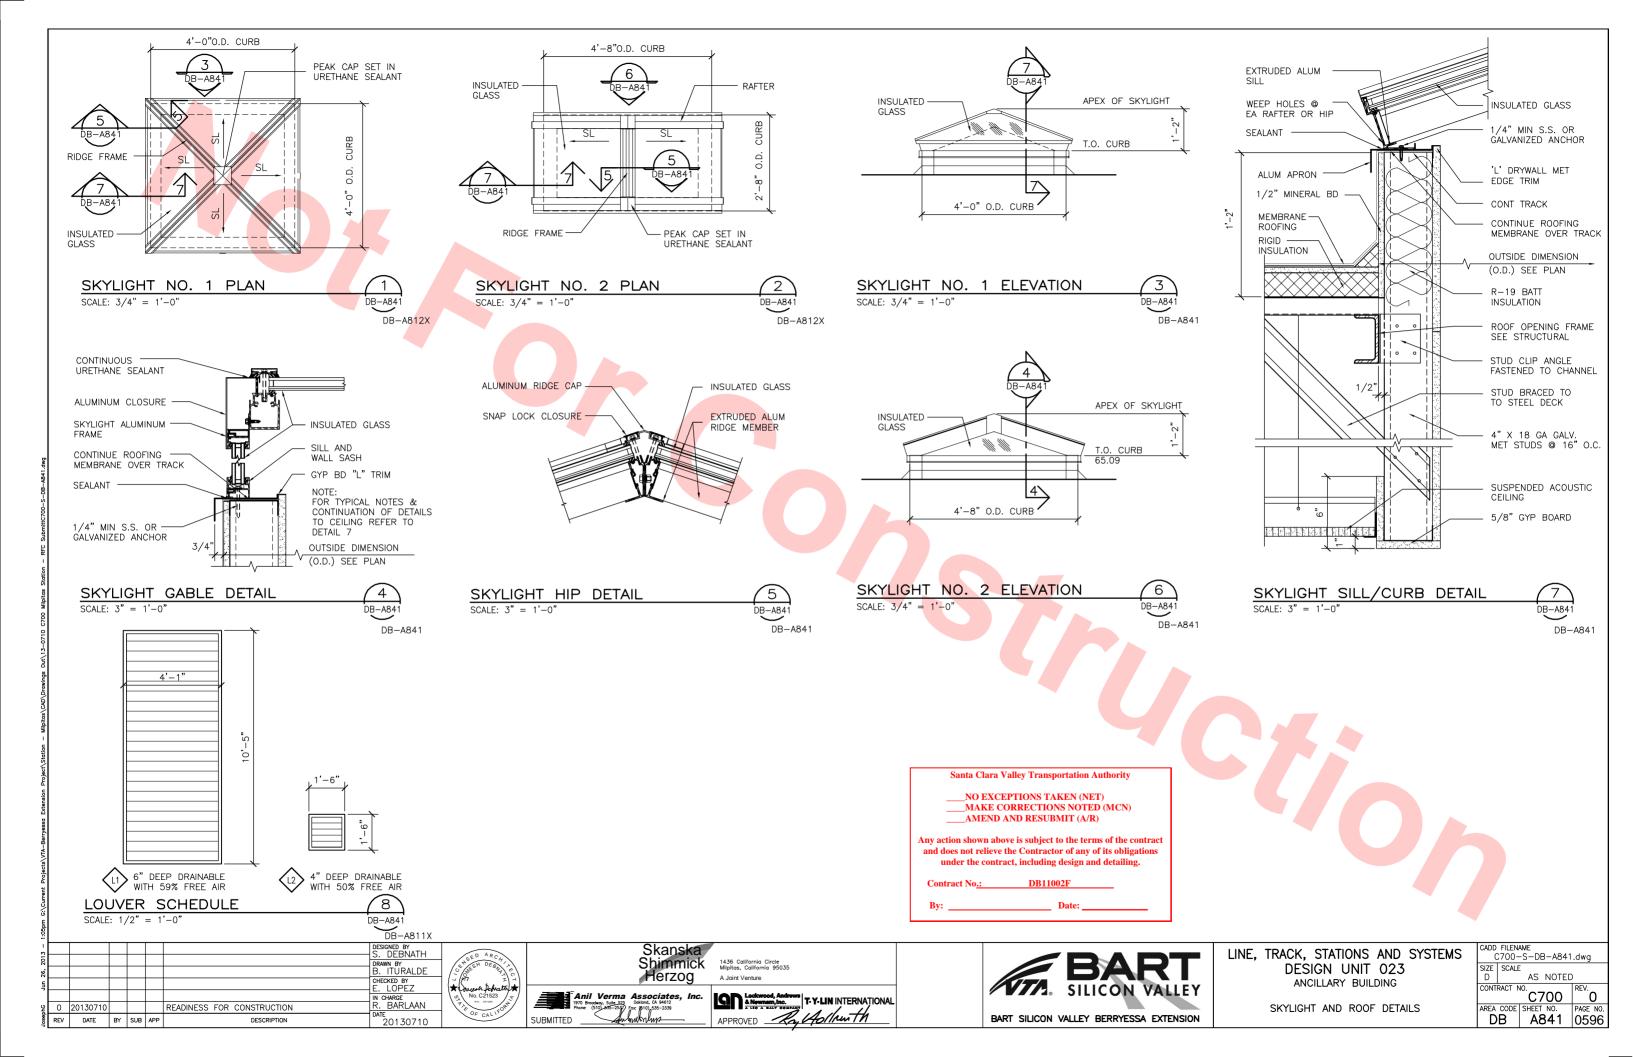

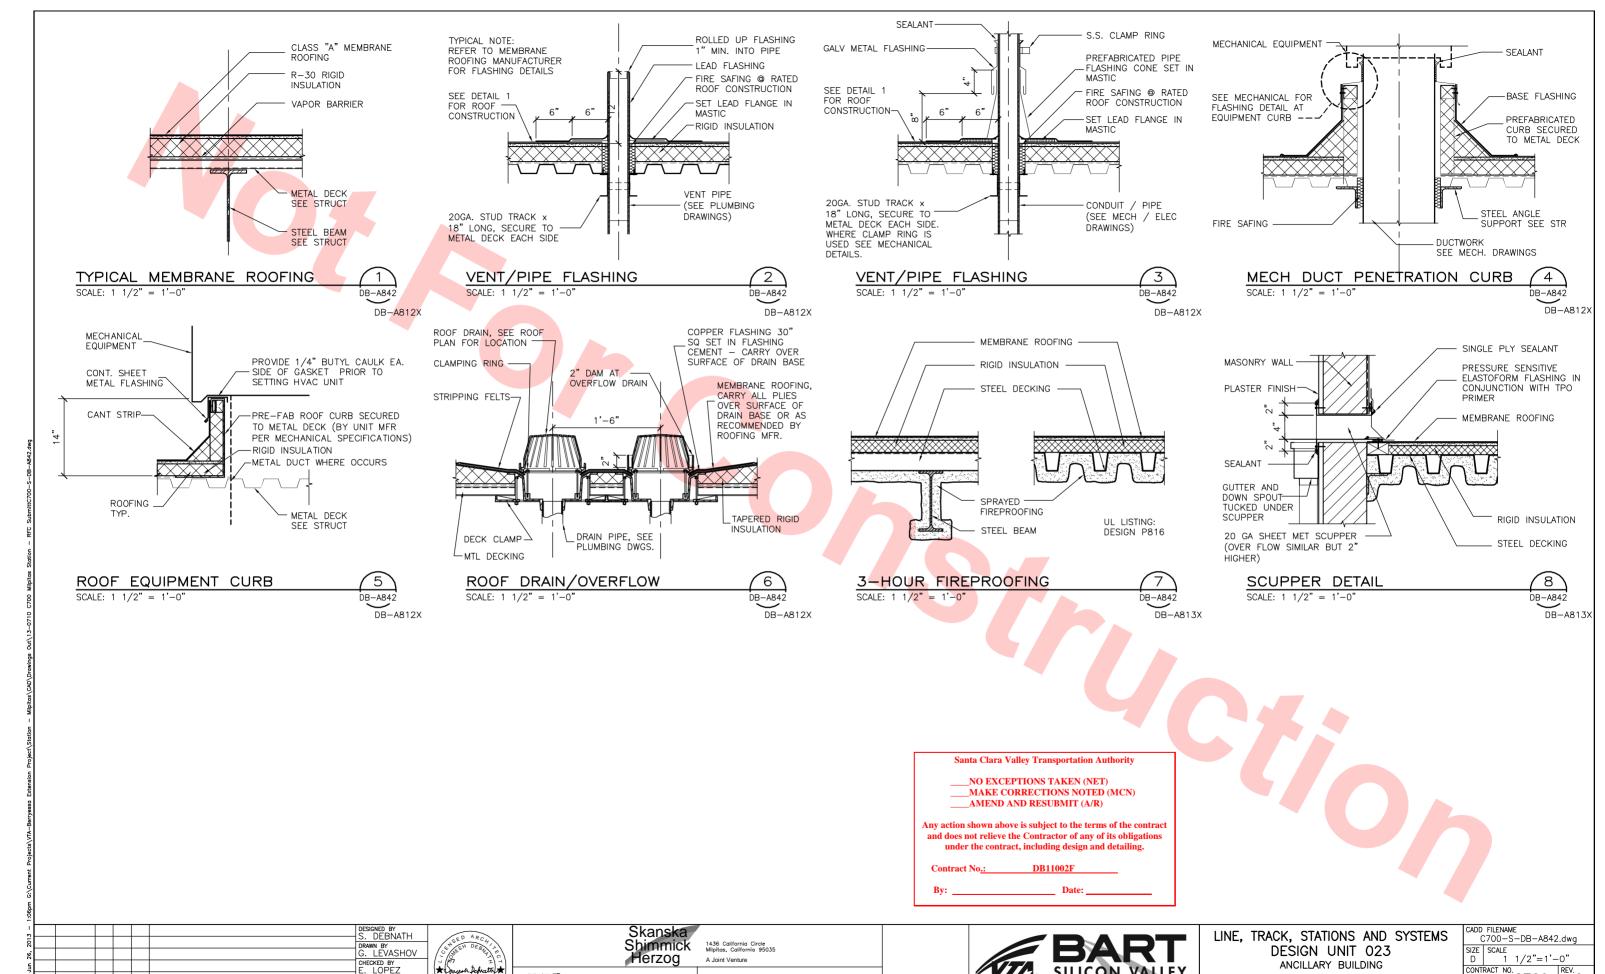

Lockwood, Andrews & Newmam, Inc. 2010 A. 100 A. ALLY COMPANY T. Y. LIN INTERNATIONAL

APPROVED

Mollren th

Anil Verma Associates, Inc

SUBMITTED

CHARGE BARLAAN

20130710

READINESS FOR CONSTRUCTION

REV DATE BY SUB APP


C700 0


REA CODE SHEET NO. PAGE NO.


DB A842 0597


ROOF DETAILS


BART SILICON VALLEY BERRYESSA EXTENSION

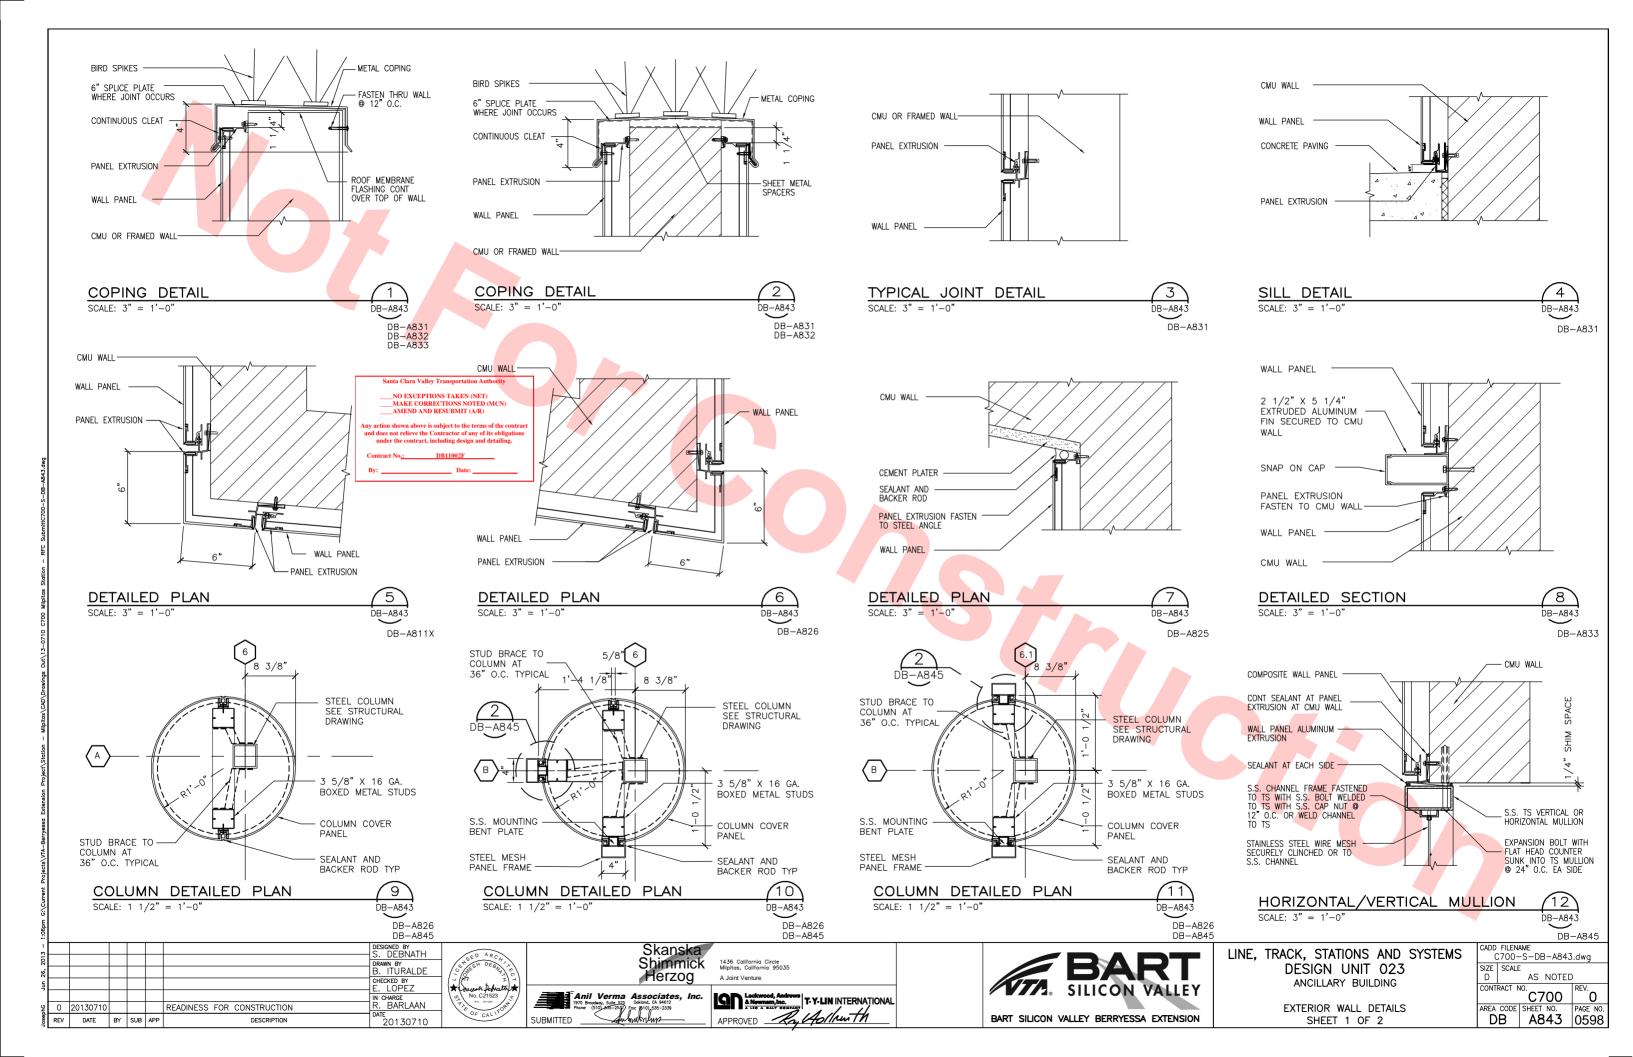


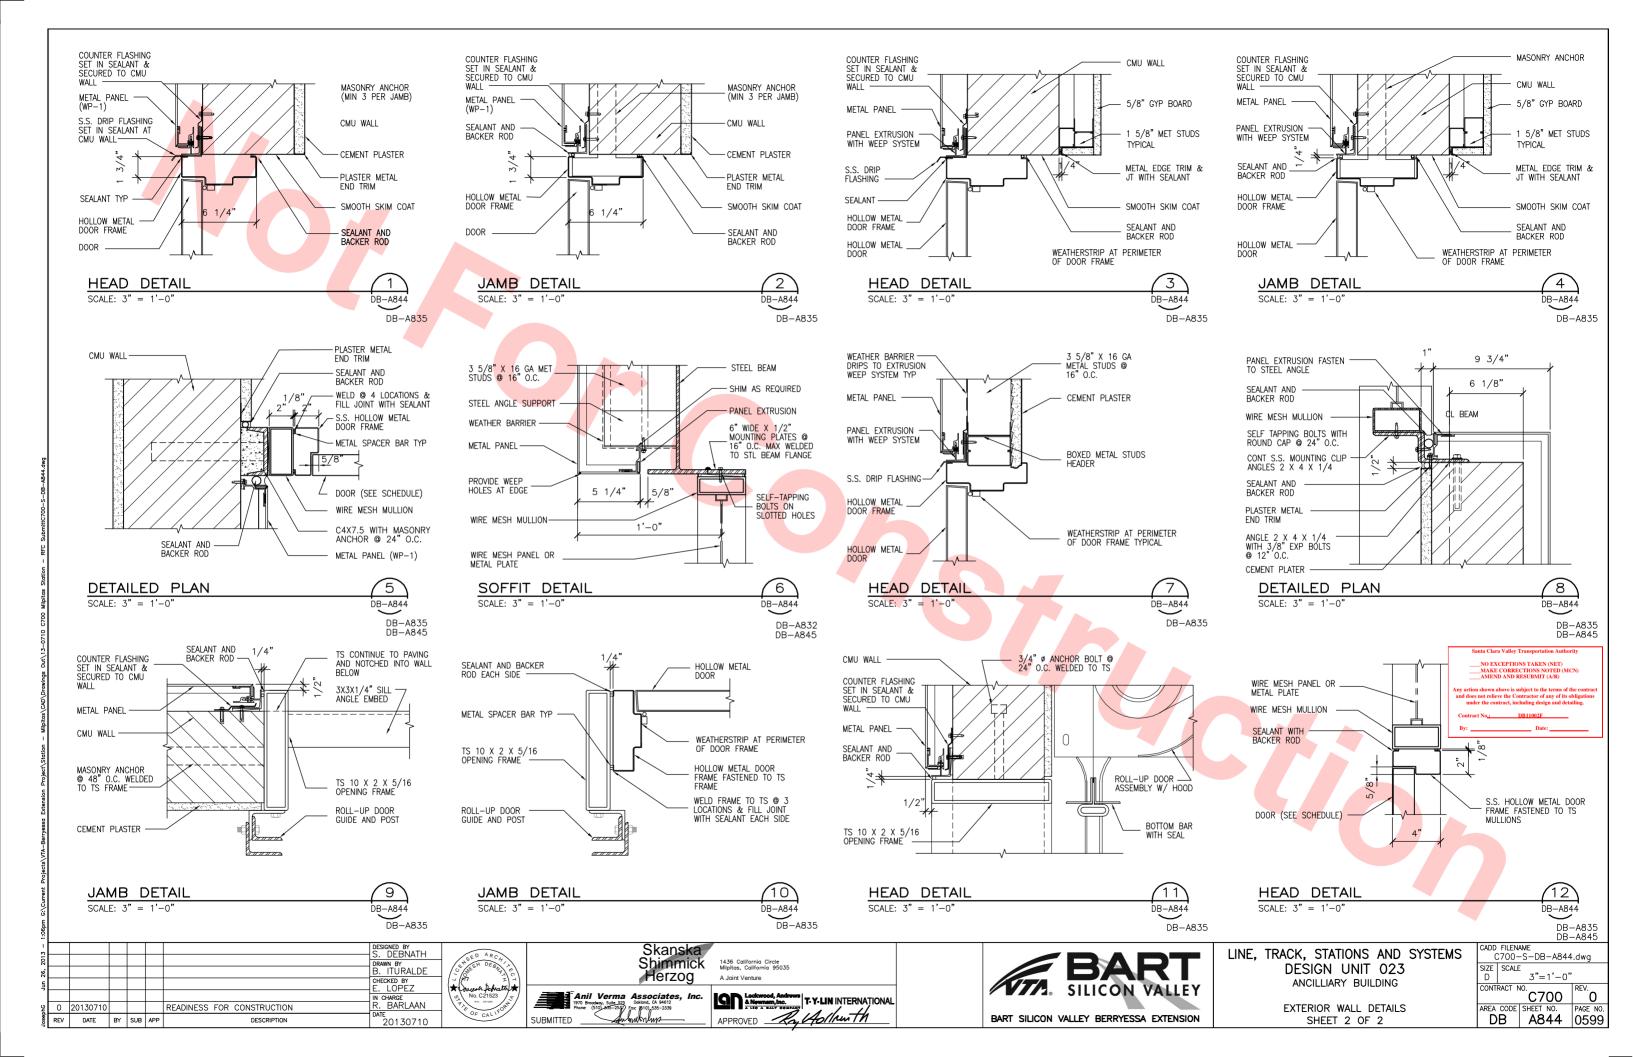


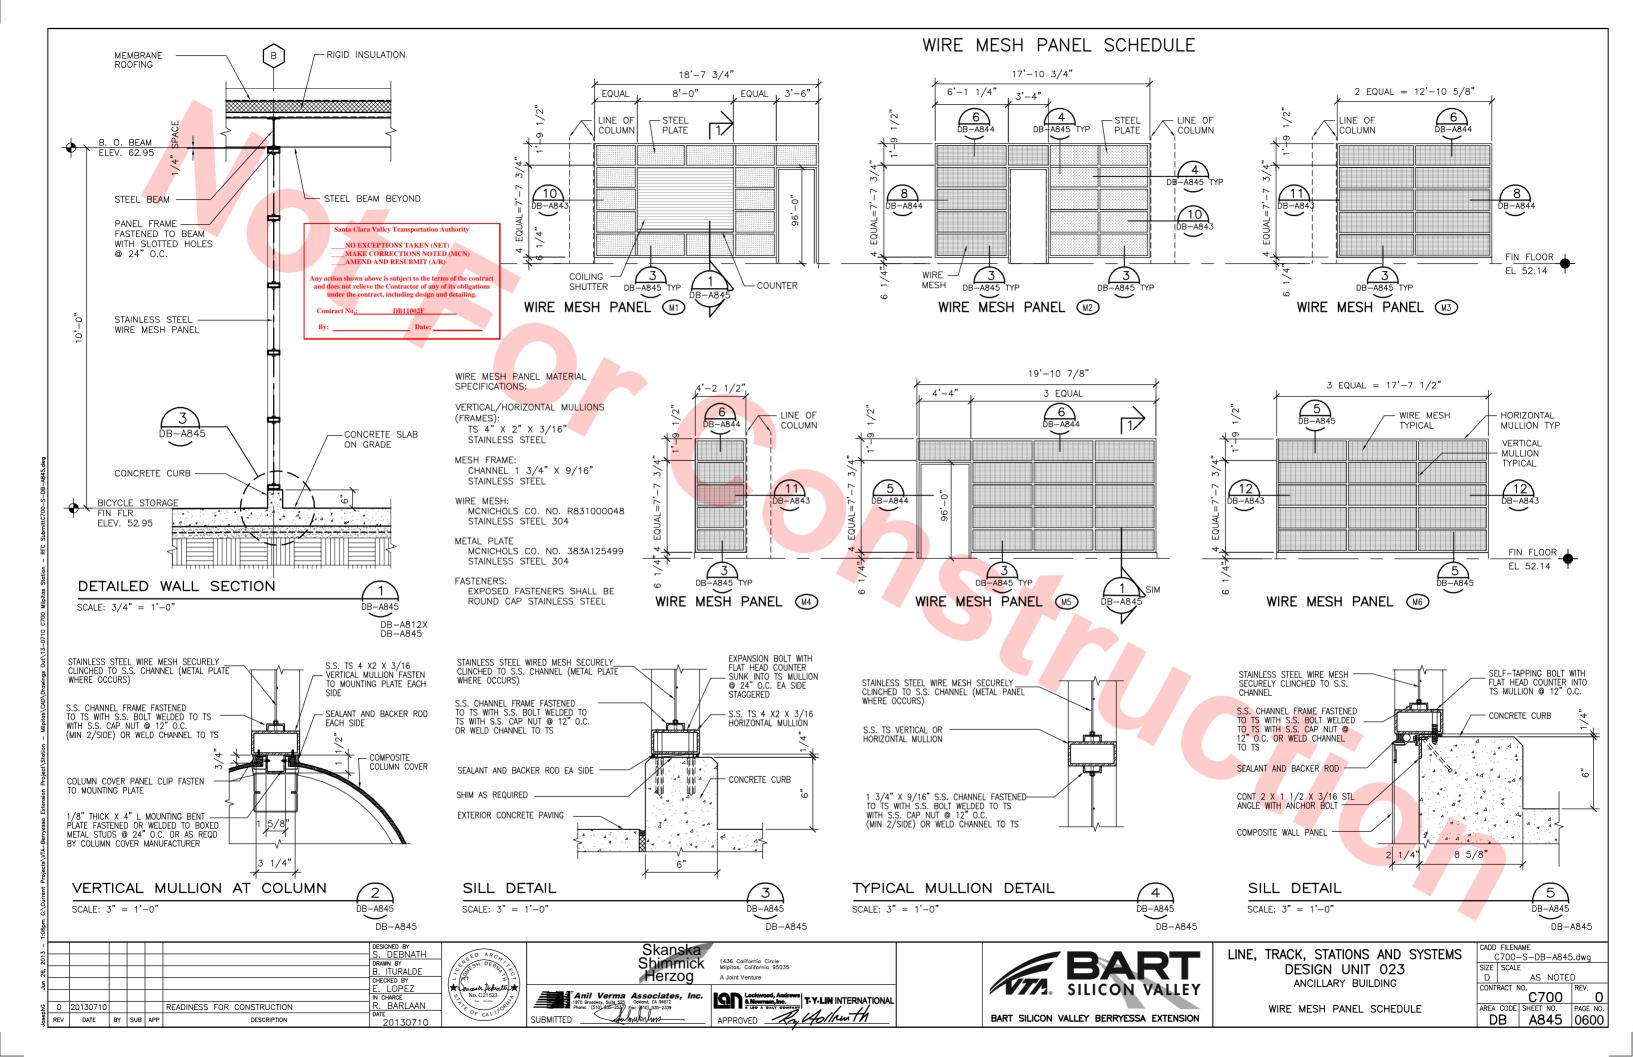


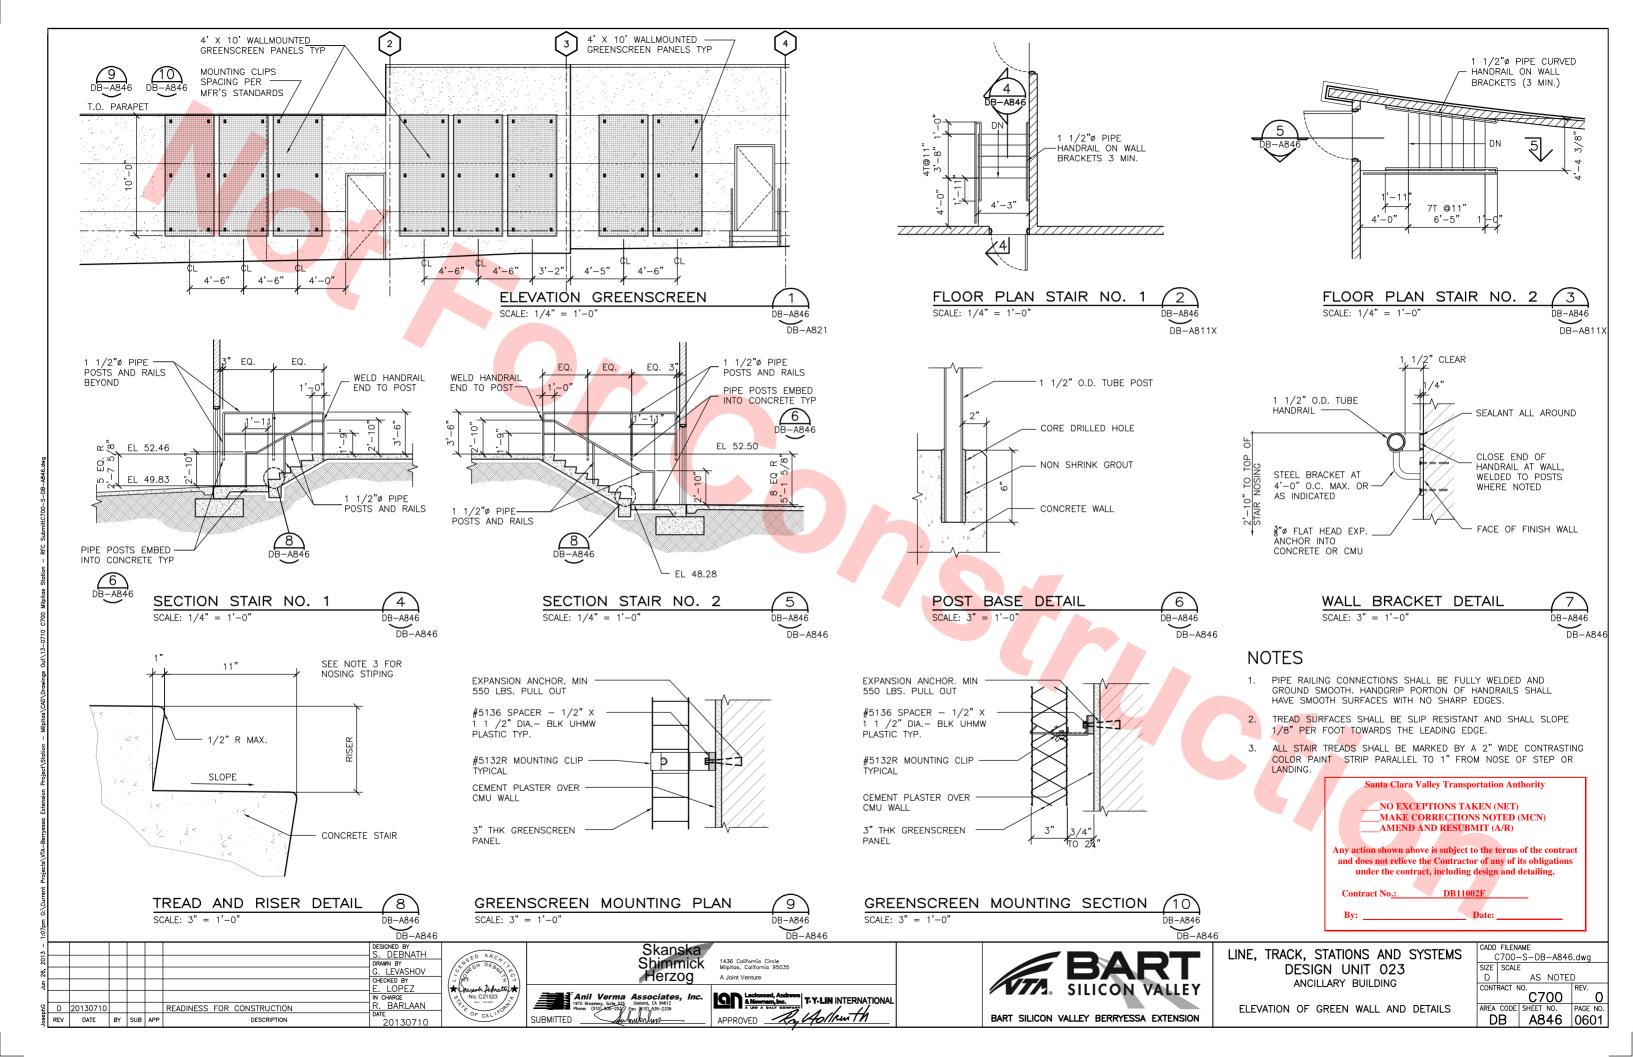


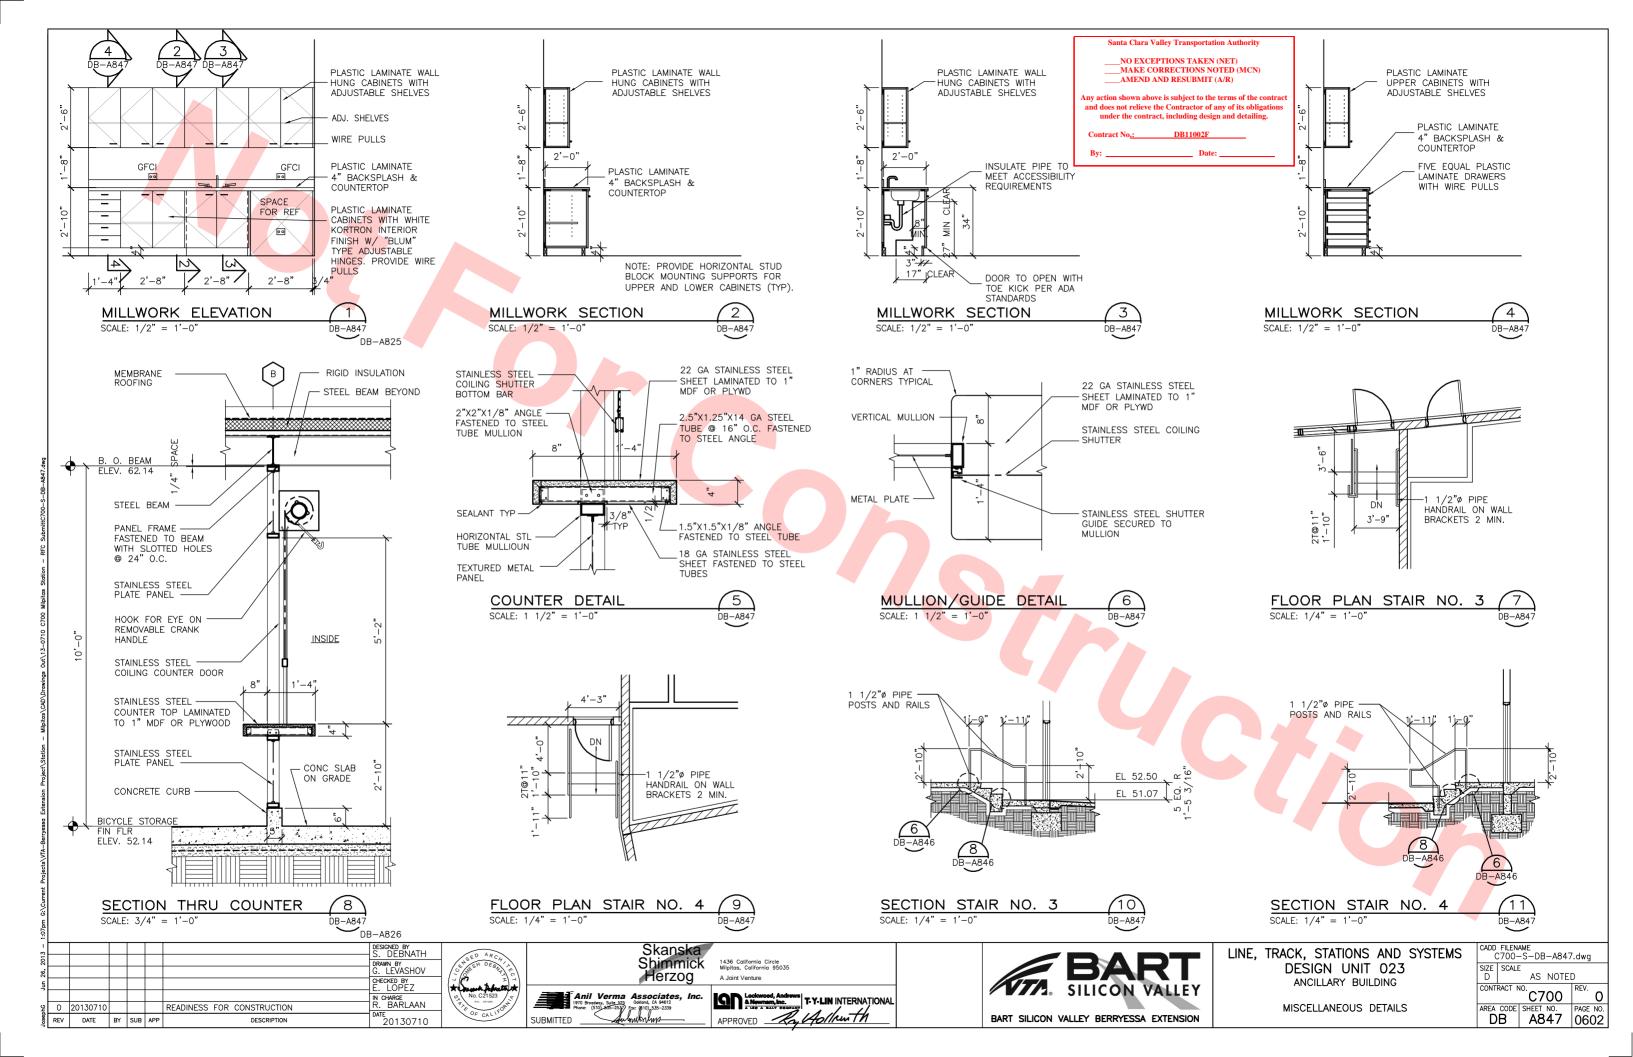

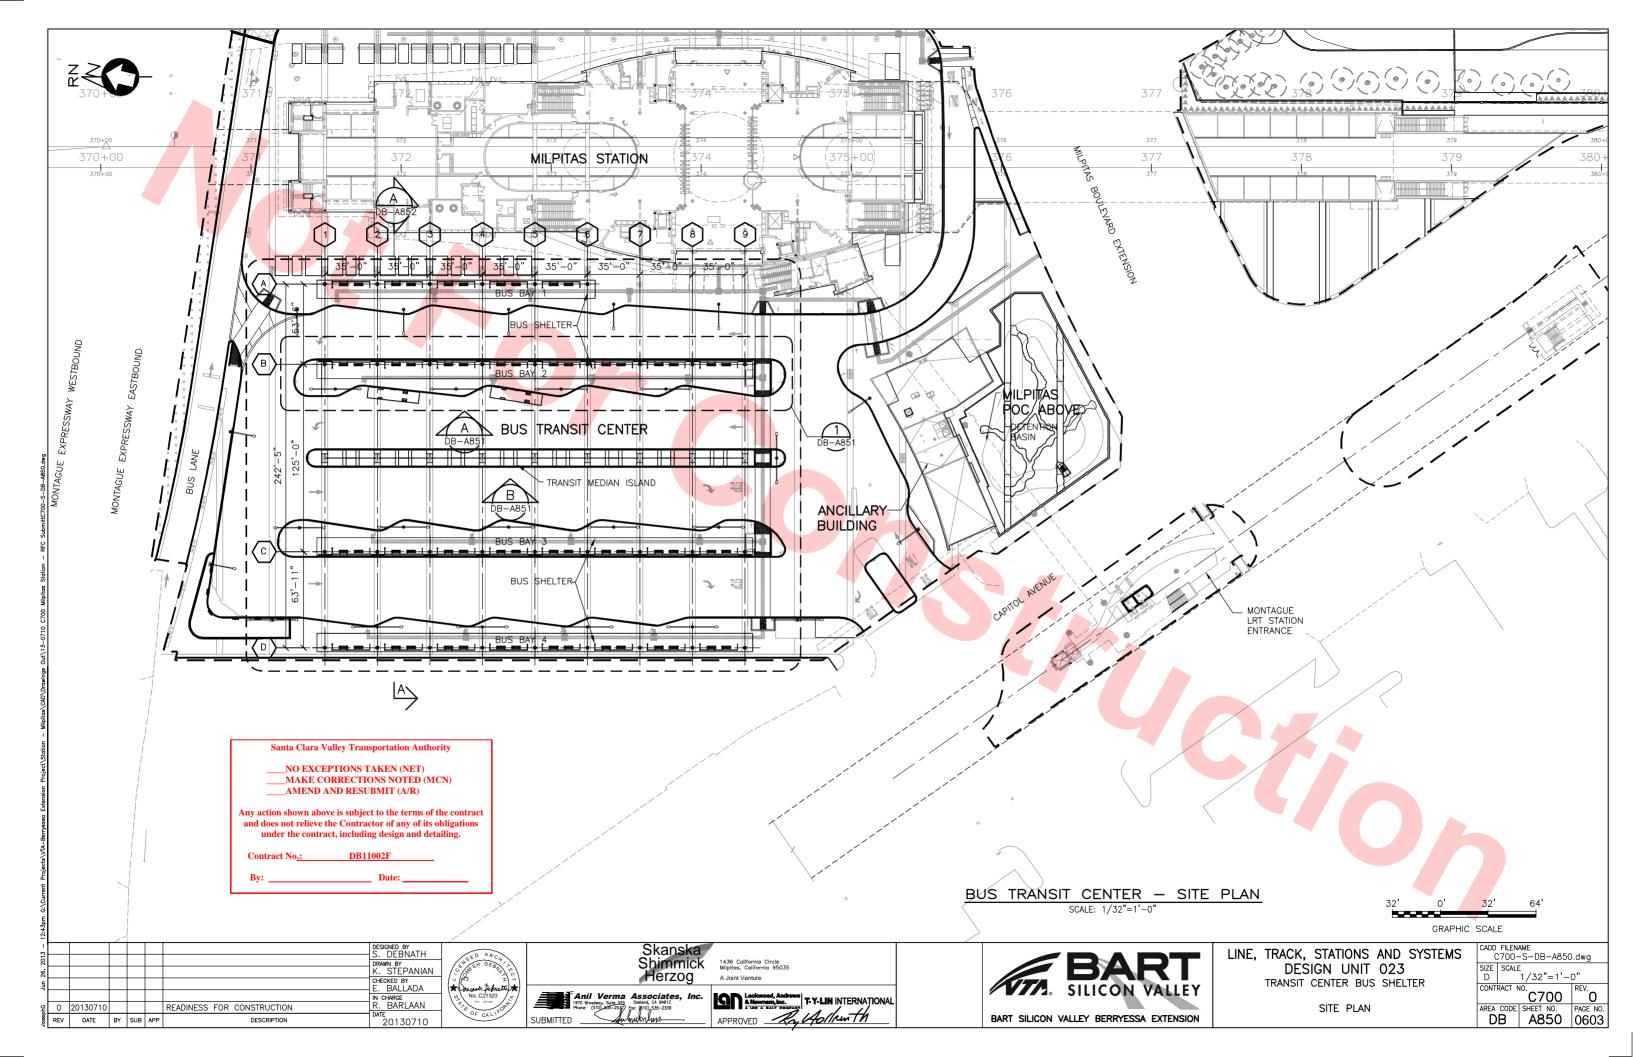

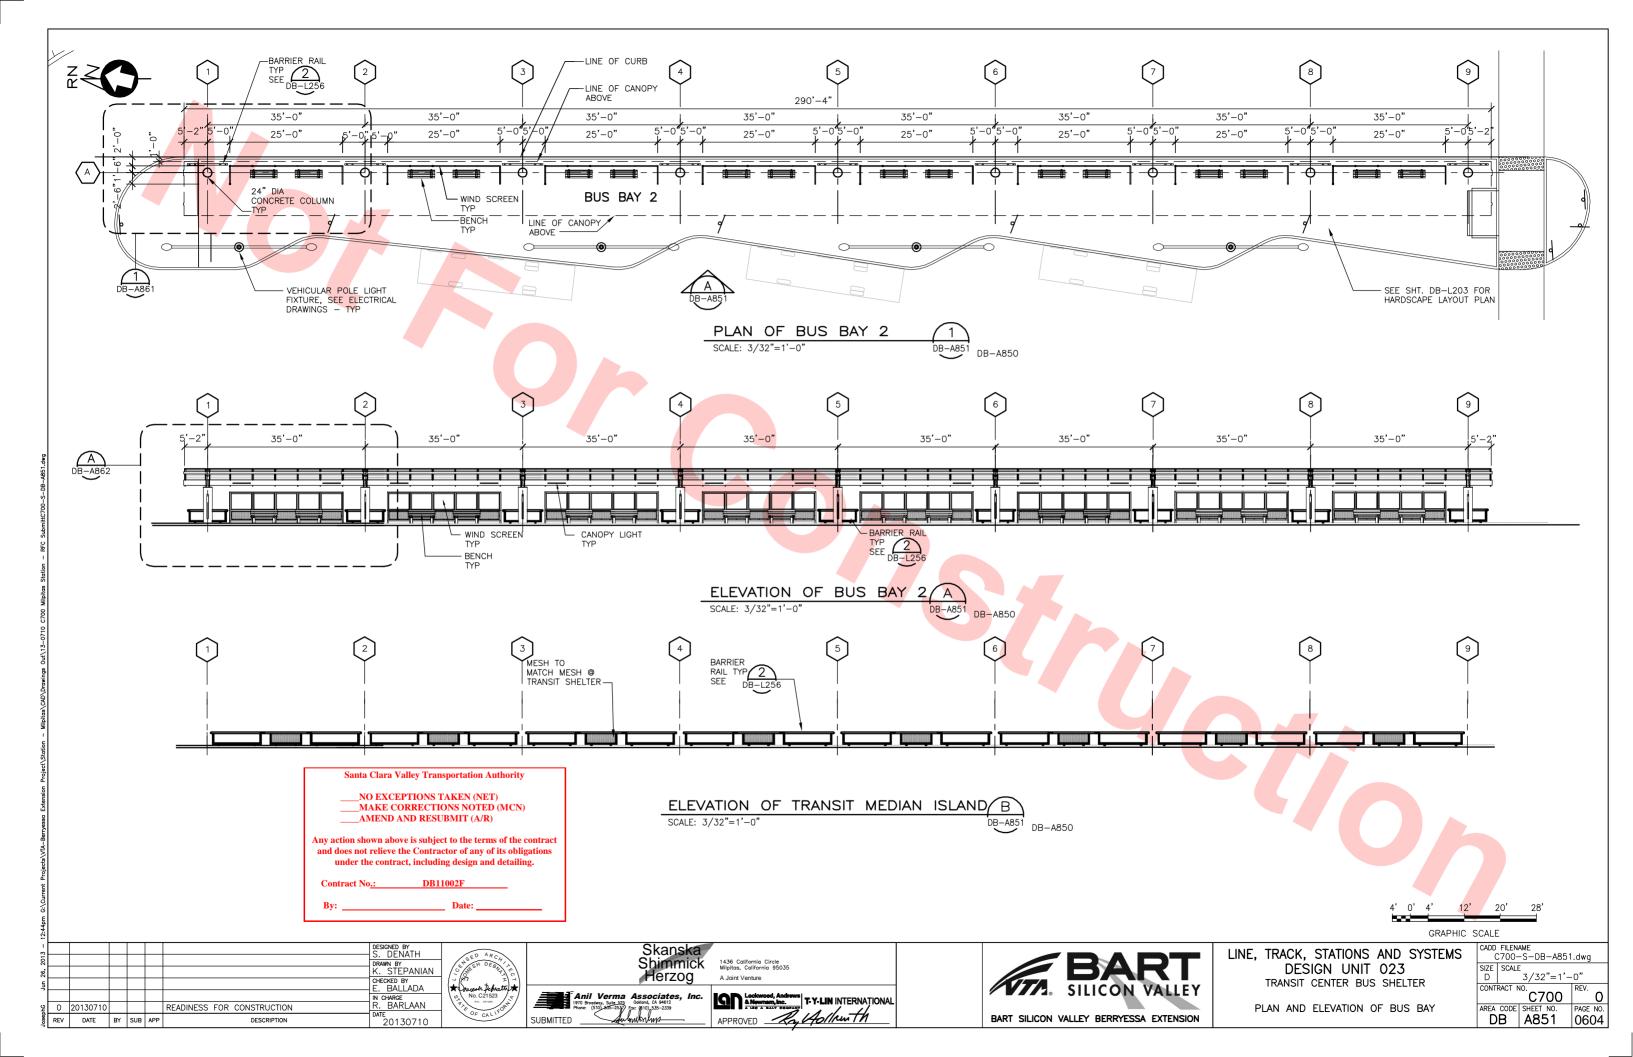


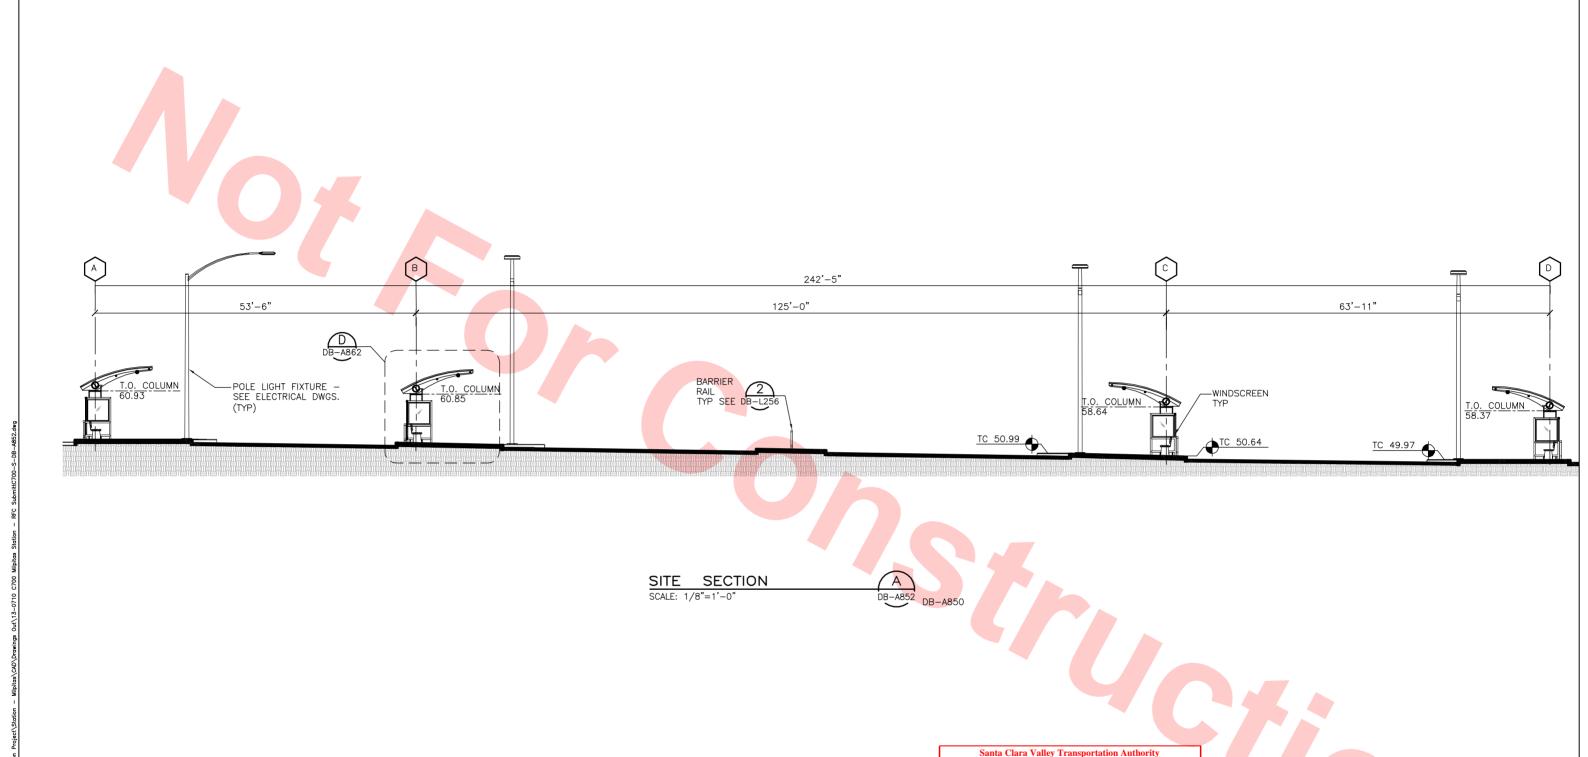

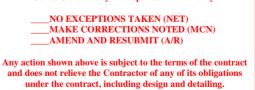

Contract No.: DB11002F

By: _____ Date: ____

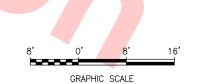

2							
<u>.</u>							DESIGNED BY S. DEBNATH
2							DRAWN BY
8,							K. STEPANIAN
Jun							CHECKED BY E. BALLADA
							IN CHARGE
일	0	20130710				READINESS FOR CONSTRUCTION	R. BARLAAN
osephG	REV	DATE	BY	SUB	APP	DESCRIPTION	20130710












LINE, TRACK, STATIONS AND SYSTEMS
DESIGN UNIT 023
TRANSIT CENTER BUS SHELTER

ANSIT	CENTER	BUS	SHELTER	
	SITE SE	CTION		

S	CADD FILENAME C700-S-DB-A852.dwg							
	SIZE D	SCALE	1/8"=1'-	o"				
	CONT	RACT N	°. C700	REV. O				
		CODE	SHEET NO. A852	PAGE NO. 0605				

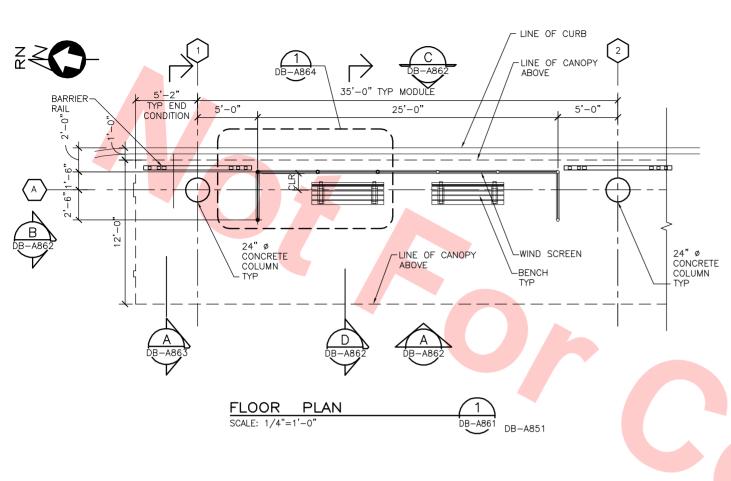

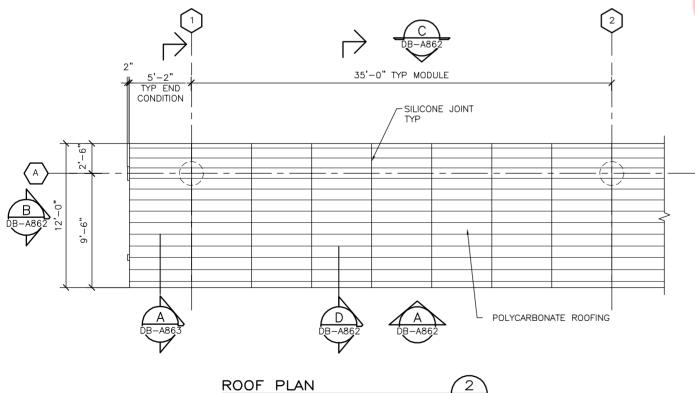

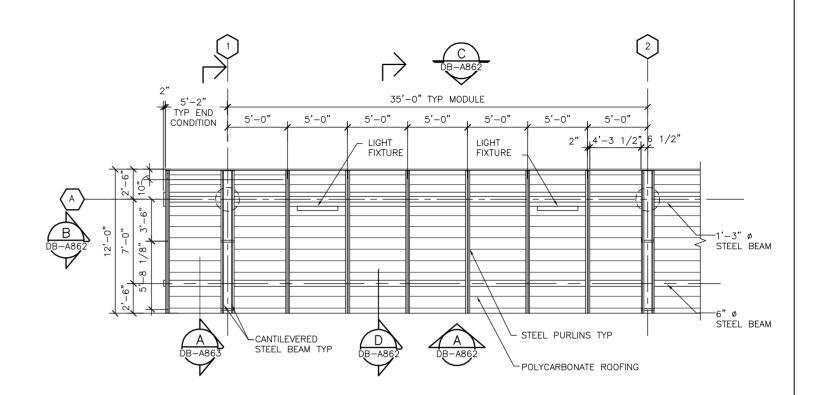






___NO EXCEPTIONS TAKEN (NET)
__MAKE CORRECTIONS NOTED (MCN)
__AMEND AND RESUBMIT (A/R)

Any action shown above is subject to the terms of the contract and does not relieve the Contractor of any of its obligations under the contract, including design and detailing.

Contract No.: DB11002F

By: _____ Date: ____

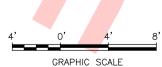

ائ ا							DESIGNED BY S. DEBNATH
2							DRAWN BY
97							K. STEPANIAN
un l							CHECKED BY E. BALLADA
	0	20130710				READINESS FOR CONSTRUCTION	IN CHARGE
2						REPLACES C700-S-DB-A811, REV. P	R. BARLAAN
losephG	REV	DATE	BY	SUB	APP	DESCRIPTION	DATE 20130710





SUBMITTED

1436 California Circle Milpitas, California 95035 A Joint Venture






LINE, TRACK, STATIONS AND SYSTEMS

DESIGN UNIT 023

TRANSIT CENTER BUS SHELTER

DETAIL	PLANS

CADD FILENAME C700-S-DB-A861.dwg						
		:				
CONT	RACT N	0.C700	REV. O			
		SHEET NO. A861	PAGE NO. 0606			
	SIZE D CONT	C700- SIZE SCALE D CONTRACT N	C700-S-DB-A86' SIZE SCALE D 1/4"=1'- CONTRACT NO. C700 AREA CODE SHEET NO.			

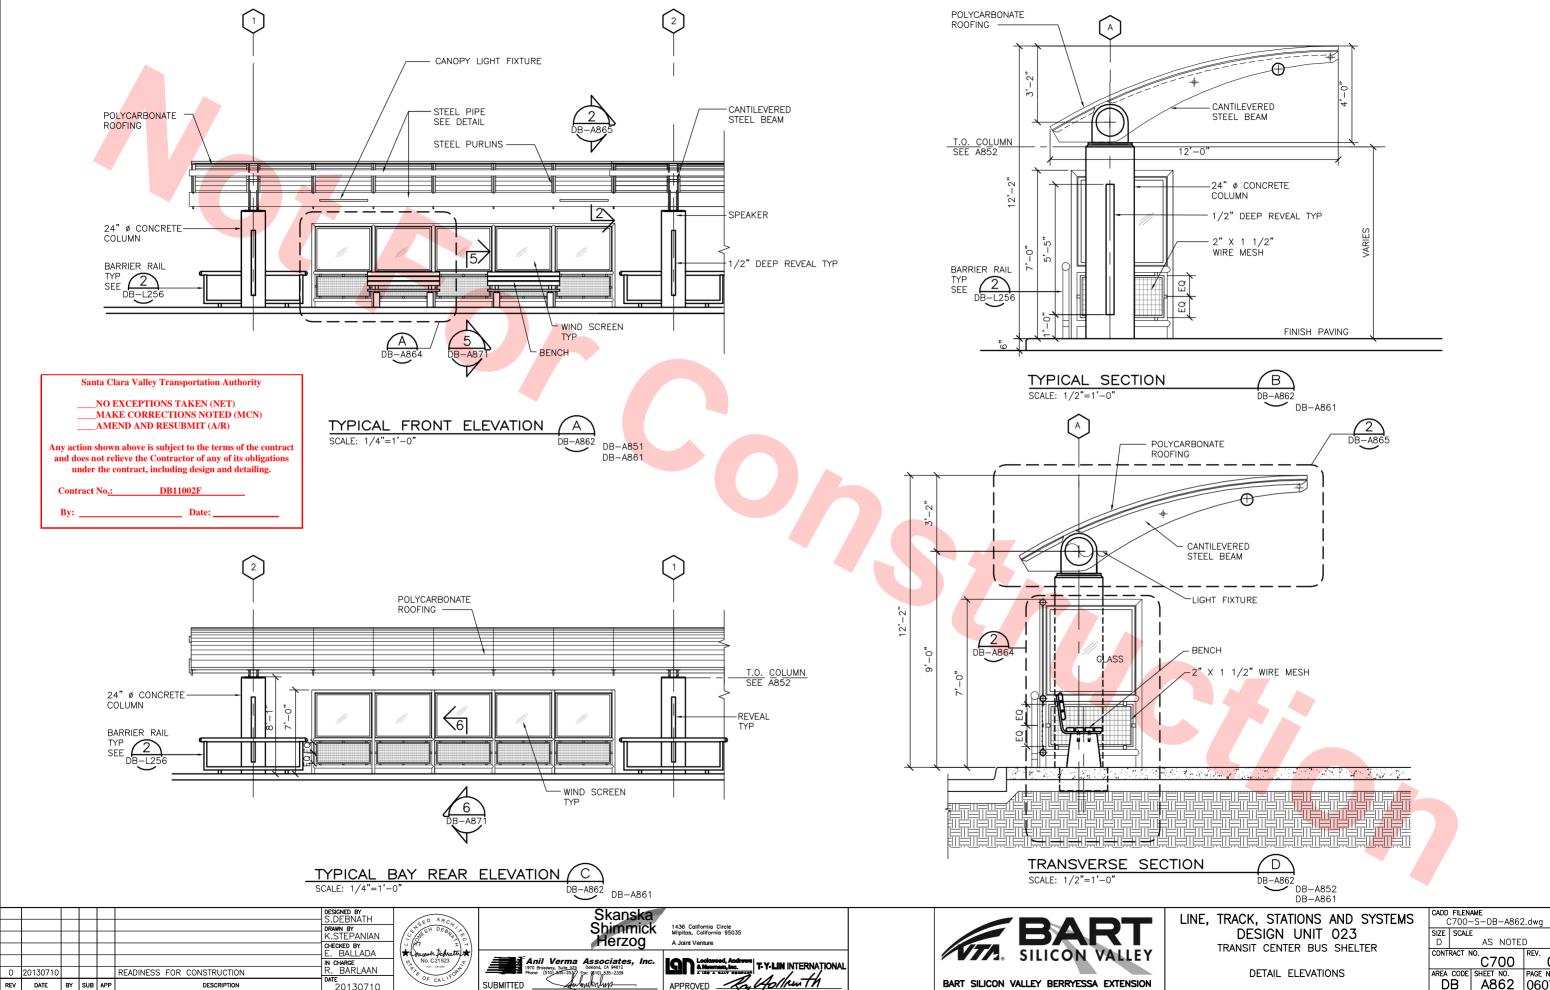

-				_	_		DESIGNED BY	_
<u>.</u>							S.DEBNATH	
20							DRAWN BY	/
92							K.STEPANIAN	/s
S							CHECKED BY E. BALLADA	ند) ا
7							IN CHARGE	\
								\ \ "
오	0	20130710				READINESS FOR CONSTRUCTION	R. BARLAAN	\
Josep	REV	DATE	BY	SUB	APP	DESCRIPTION	20130710	










1S	CADD FILENAME C700-S-DB-A862.dwg						
	SIZE SCALE D AS NOTED						
		RACT N)	REV.			
			SHEET NO.		PAGE NO.		
	D	В	A862	2	0607		

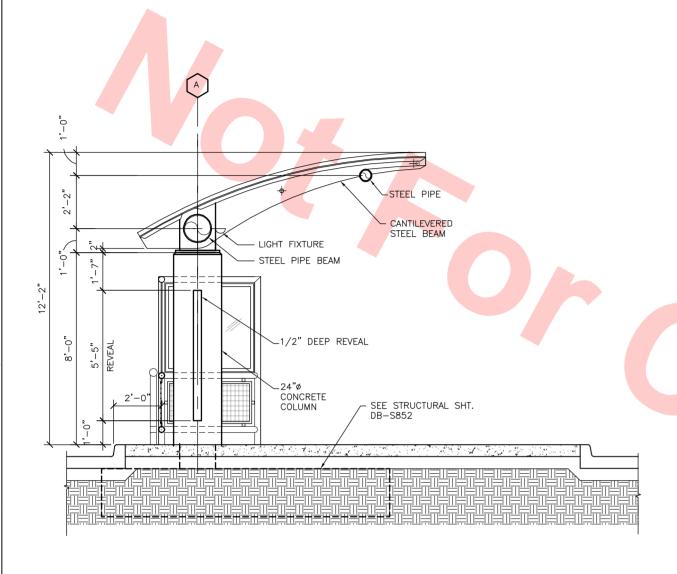

TRANSVERSE SECTION SCALE: 1/2"=1'-0" DB-A863

Santa Clara Valley Transportation Authority

_NO EXCEPTIONS TAKEN (NET) MAKE CORRECTIONS NOTED (MCN) AMEND AND RESUBMIT (A/R)

Any action shown above is subject to the terms of the contract and does not relieve the Contractor of any of its obligations

under the contract, including design and detailing.

DESIGNED BY S. DEBNATH RAWN BY K. STEPANIAN CHECKED BY E. BALLADA I CHARGE R. BARLAAN PE 0 20130710 READINESS FOR CONSTRUCTION
REVENUE DATE BY SUB APP DESCRIPTION 20130710



SUBMITTED



1436 California Circle Milpitas, California 95035








LINE, TRACK, STATIONS AND SYSTEMS DESIGN UNIT 023 TRANSIT CENTER BUS SHELTER

DETAIL SECTIONS


S		FILEN.		-A863	s.dwg
	SIZE D	SCALE	1/2	"=1"-	ס"
	CONT	RACT N	^{10.} C7	00	REV. O
	AREA	CODE	SHEET A8	NO. 663	PAGE NO. 0608

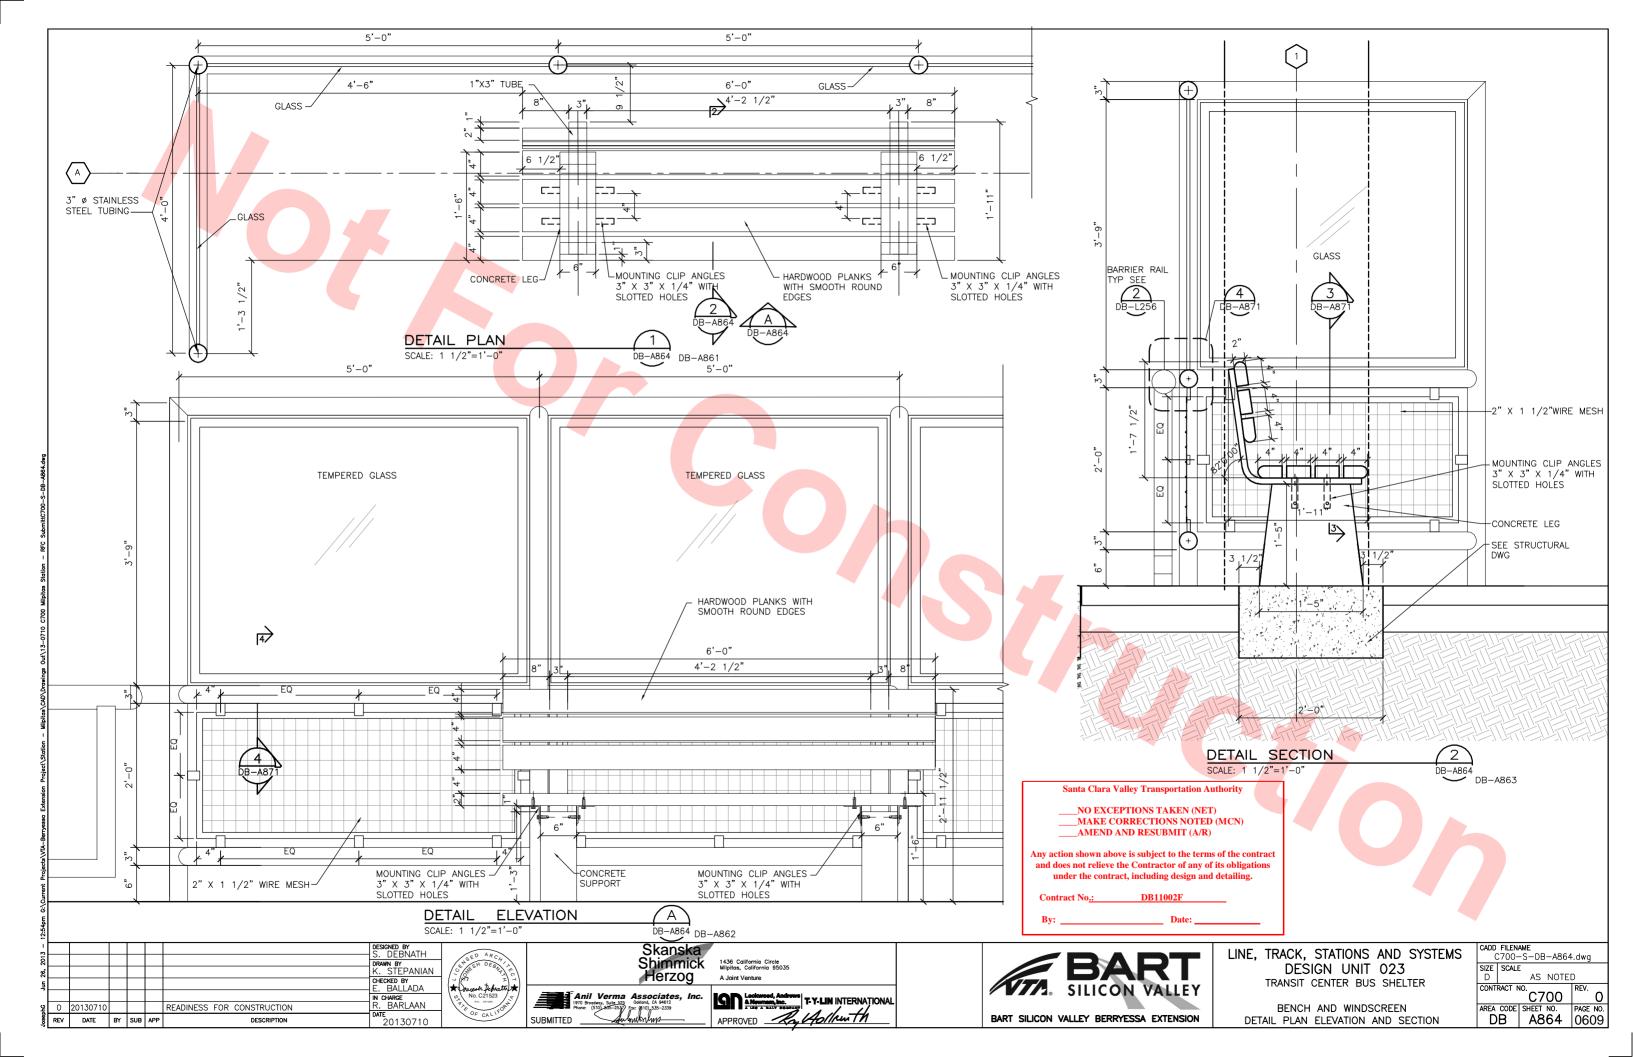


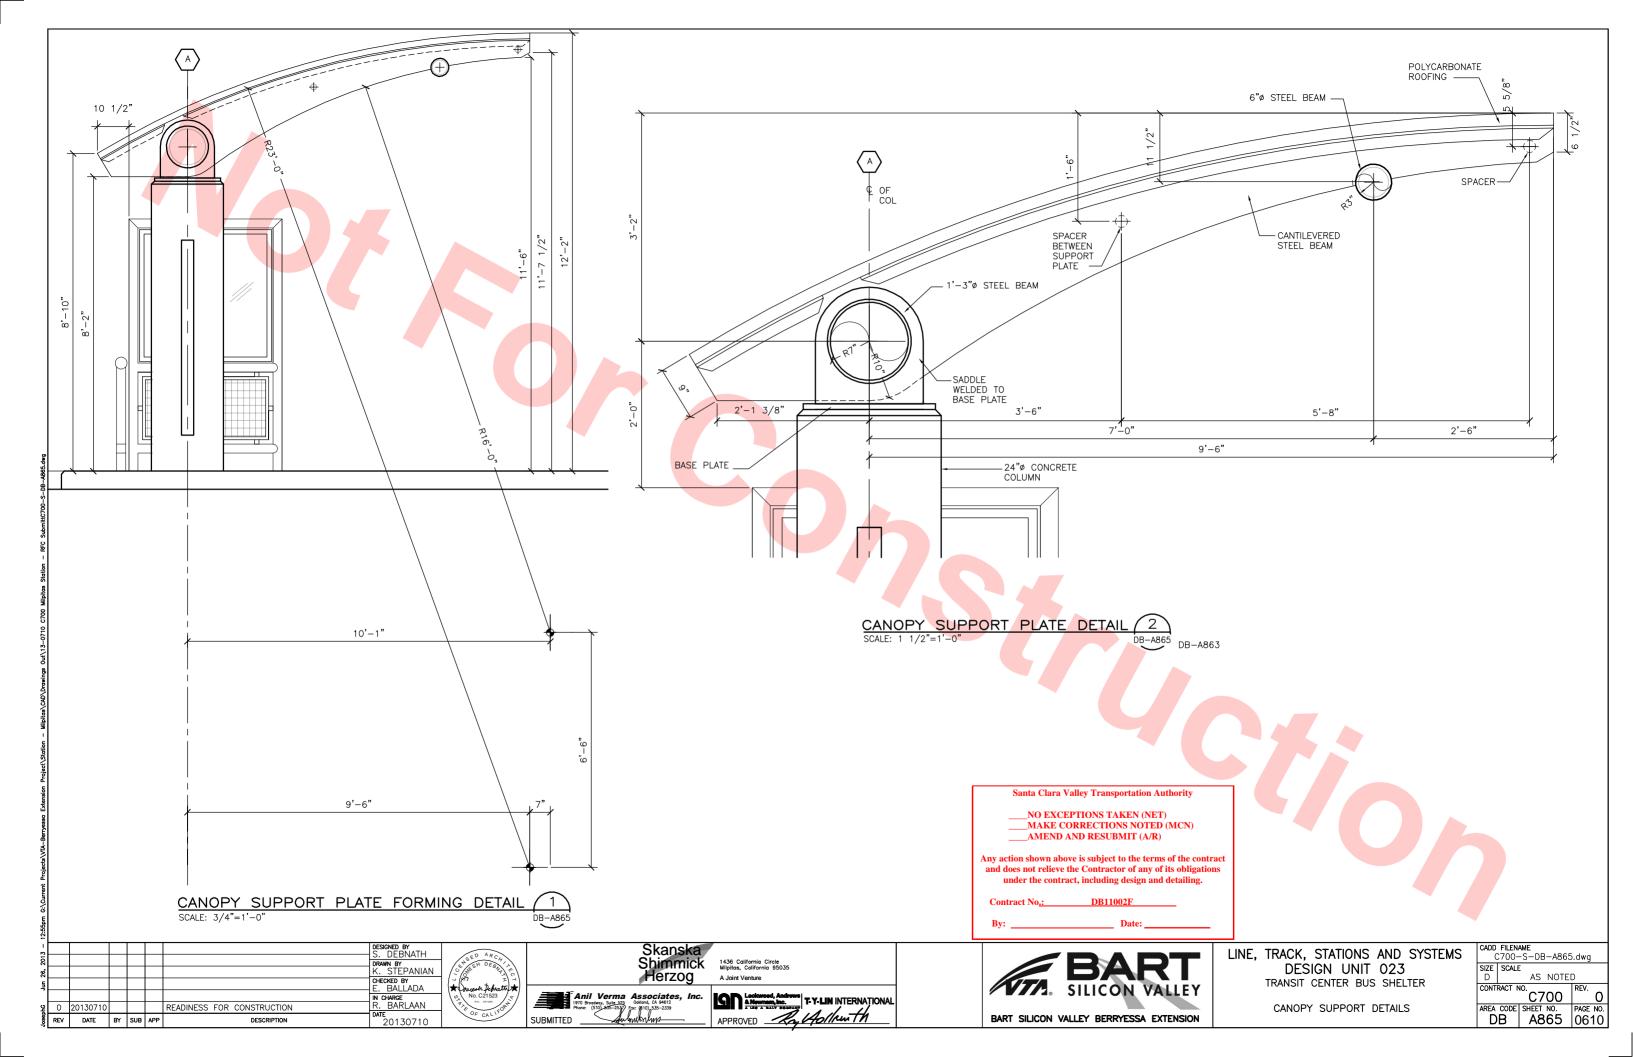

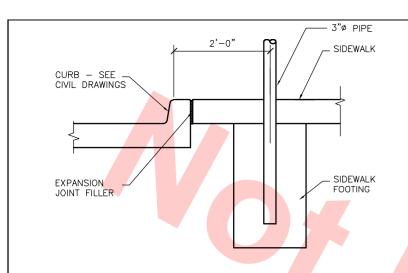

WINDSCREEN PIPE FOUNDATION & CURB DETAIL 1 SCALE: 1" = 1'-0"DB-A871 DB-A863

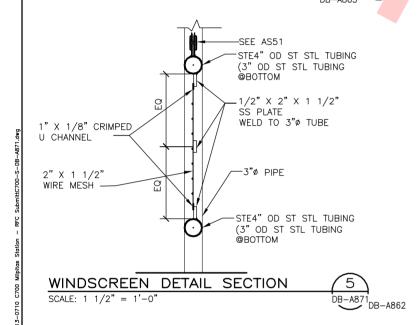


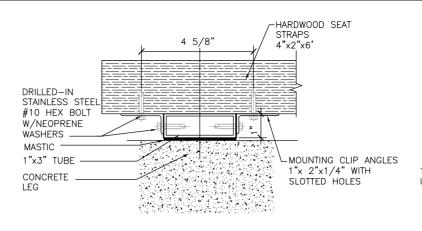

BENCH SECTION DETAIL SCALF: 6" = 1'-0"

DB-A871 DB-A862

DB-A871 DB-A864

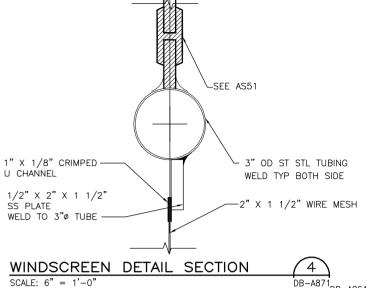

1/2" X 2" 1 1/2" — SS PLATE WELD TO 3"Ø TUBE _1/2" X 2" X 1 1/2' SS PLATE WELD TO 3"Ø TUBE 1/2" X 2" SS PLATE WELD TO 1" X 1/8" 1/2"X2" SS PLATE WELD TO 1" X 1/8" CRIMPED U CHANNEL CRIMPED U CHANNEL 1 1/2" GAP 1 1/2" GAP 2" X 1 1/2" WIRE MESH___ 2" X 1 1/2" WIRE MESH _3" OD ST STL TUBING WINDSCREEN DETAIL SECTION

Santa Clara Valley Transportation Authority

_NO EXCEPTIONS TAKEN (NET) _MAKE CORRECTIONS NOTED (MCN) AMEND AND RESUBMIT (A/R)

Any action shown above is subject to the terms of the contract and does not relieve the Contractor of any of its obligations under the contract, including design and detailing.

DB11002F

DESIGNED BY S. DEBNATH ORAWN BY K. STEPANIAN CHECKED BY E. BALLADA N CHARGE R. BARLAAN READINESS FOR CONSTRUCTION REV DATE BY SUB APP 20130710







SCALE: 1' = 1'-0"





LINE, TRACK, STATIONS AND SYSTEM DESIGN UNIT 023 TRANSIT CENTER BUS SHELTER


MISCELLANEOUS DETAILS


MS	CADD FILENAME C700-S-DB-A871.dwg					
	SIZE D	SCALE	AS NOTED)		
		RACT N	C700	REV.		
			SHEET NO.	PAGE NO.		
	ט ן	В	A871	0611		


DB-A864

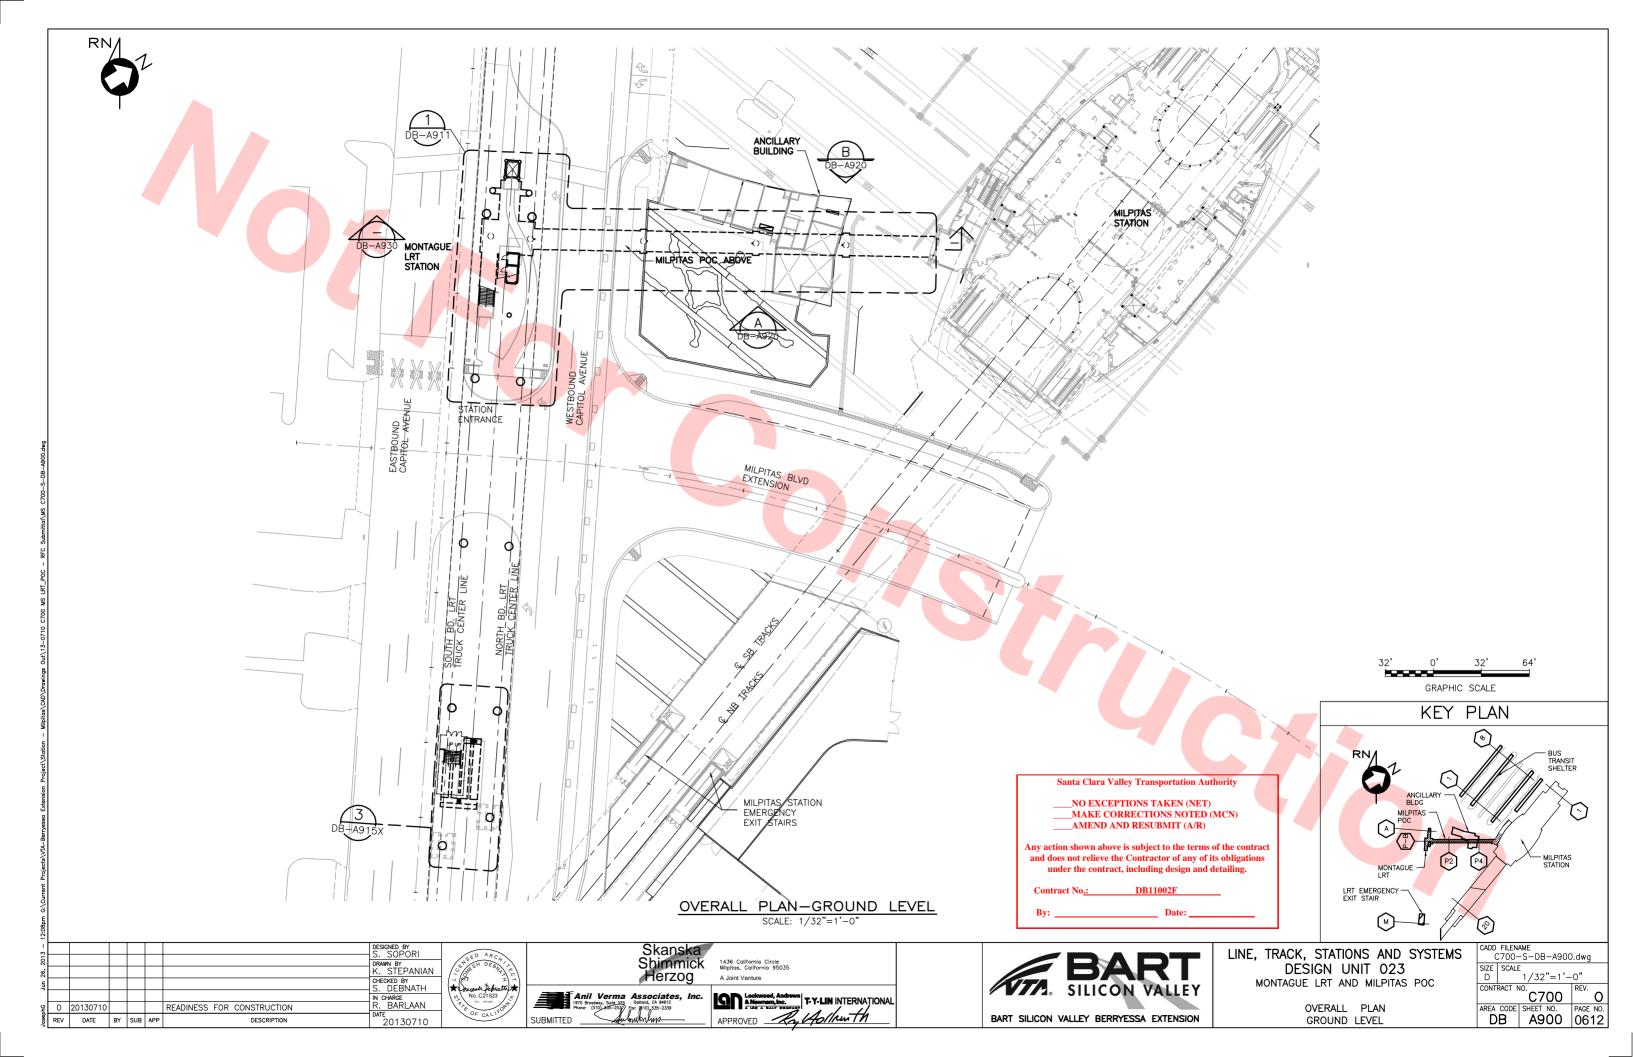


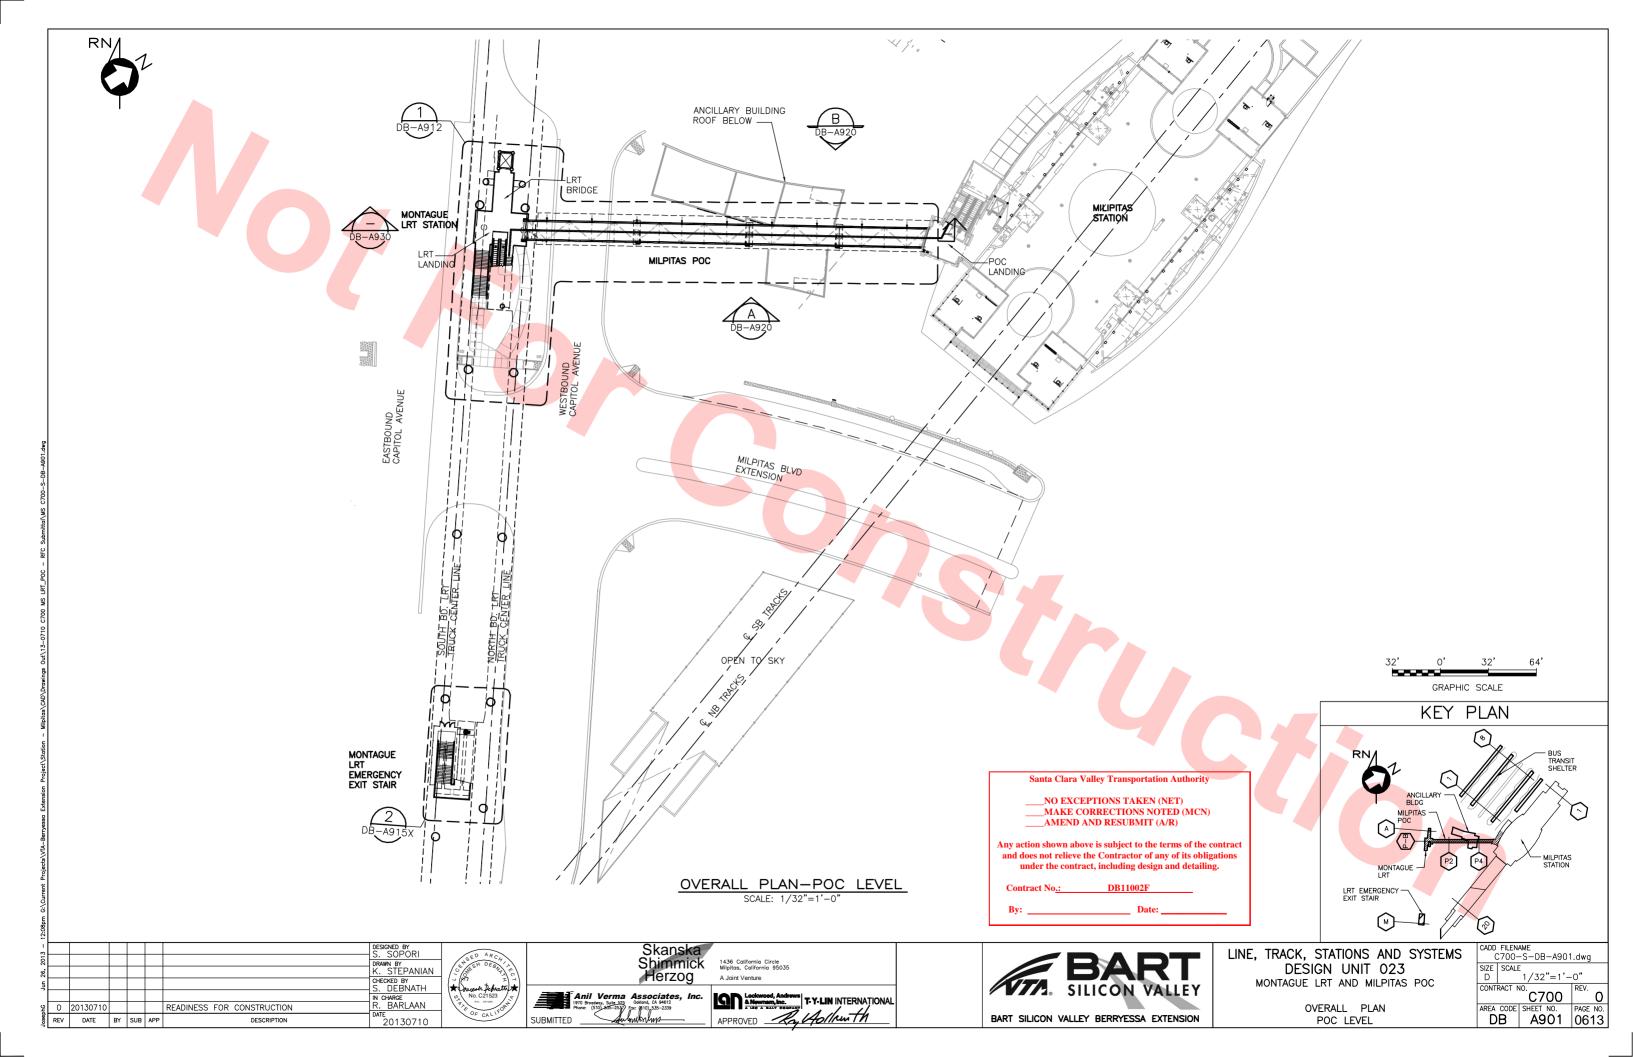


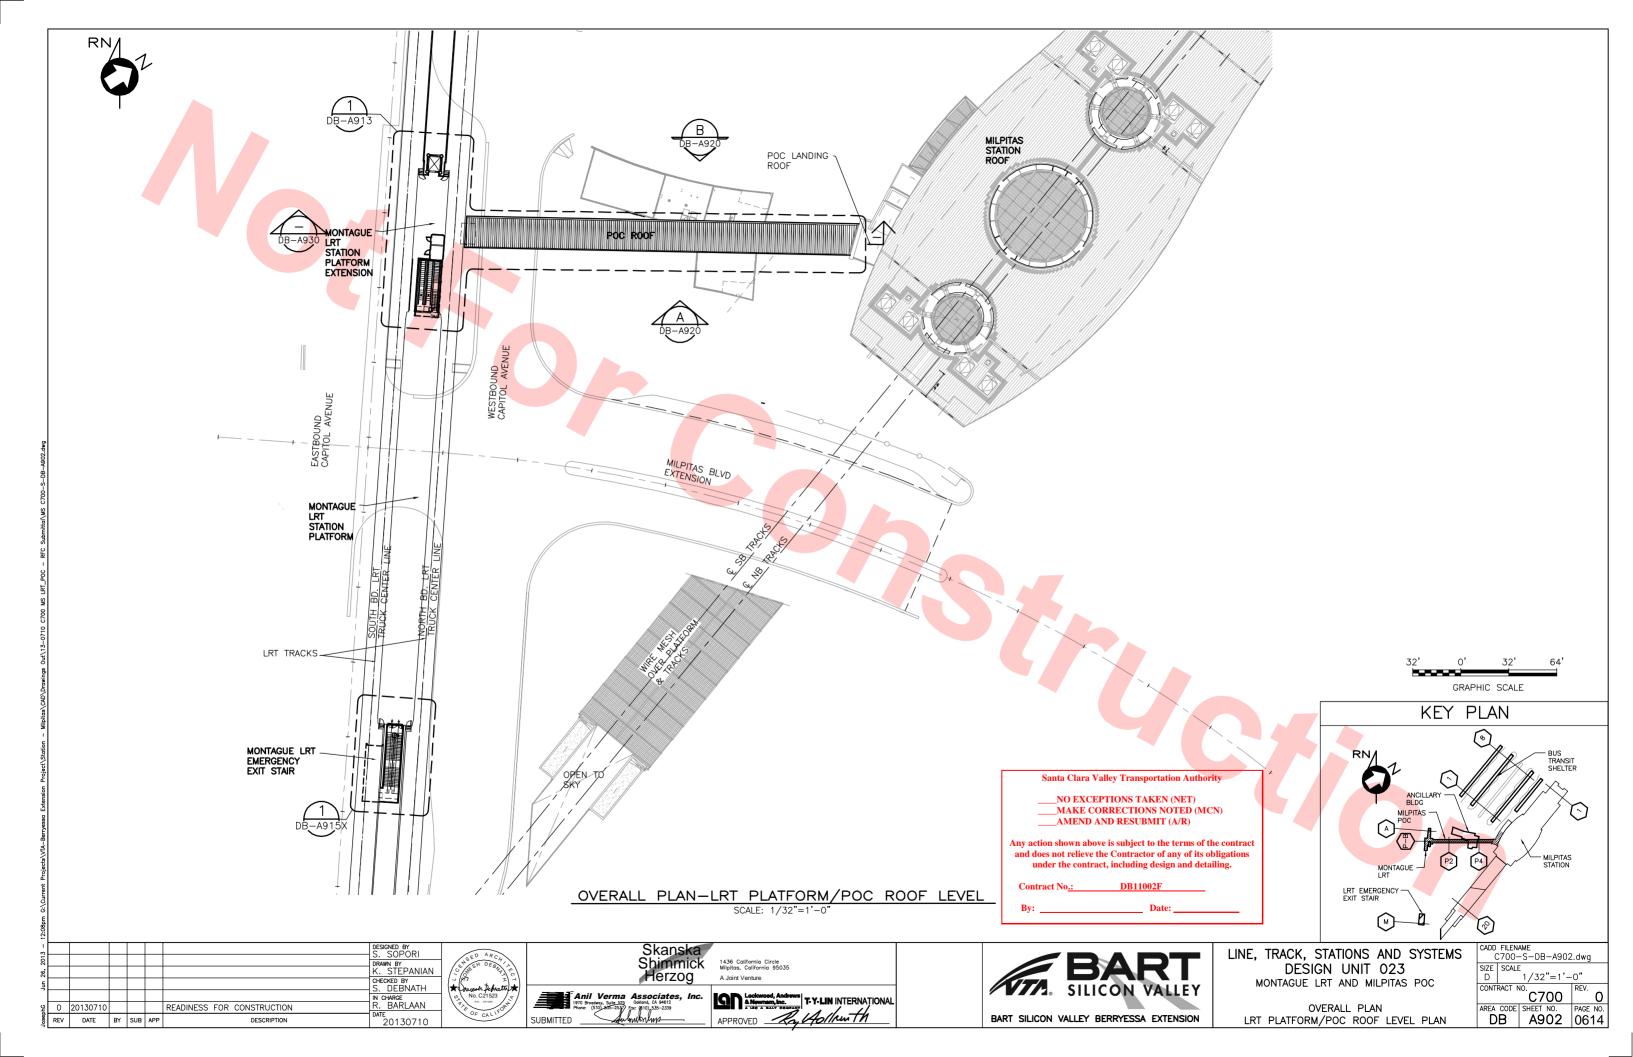


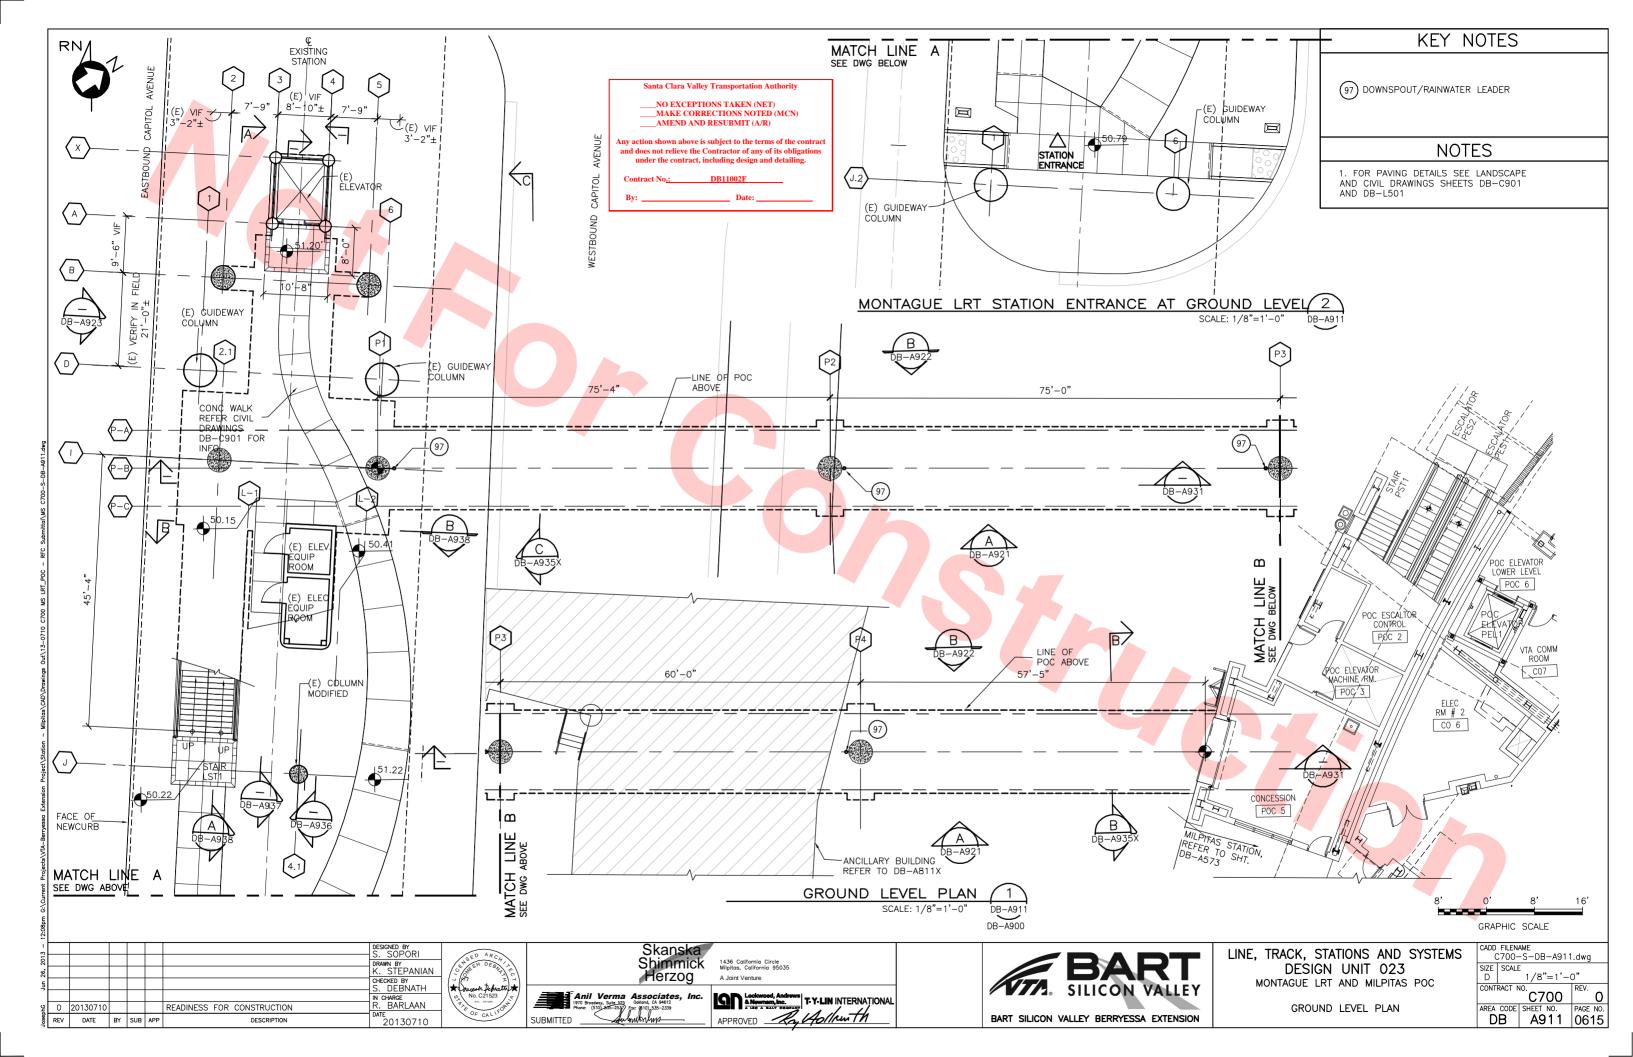


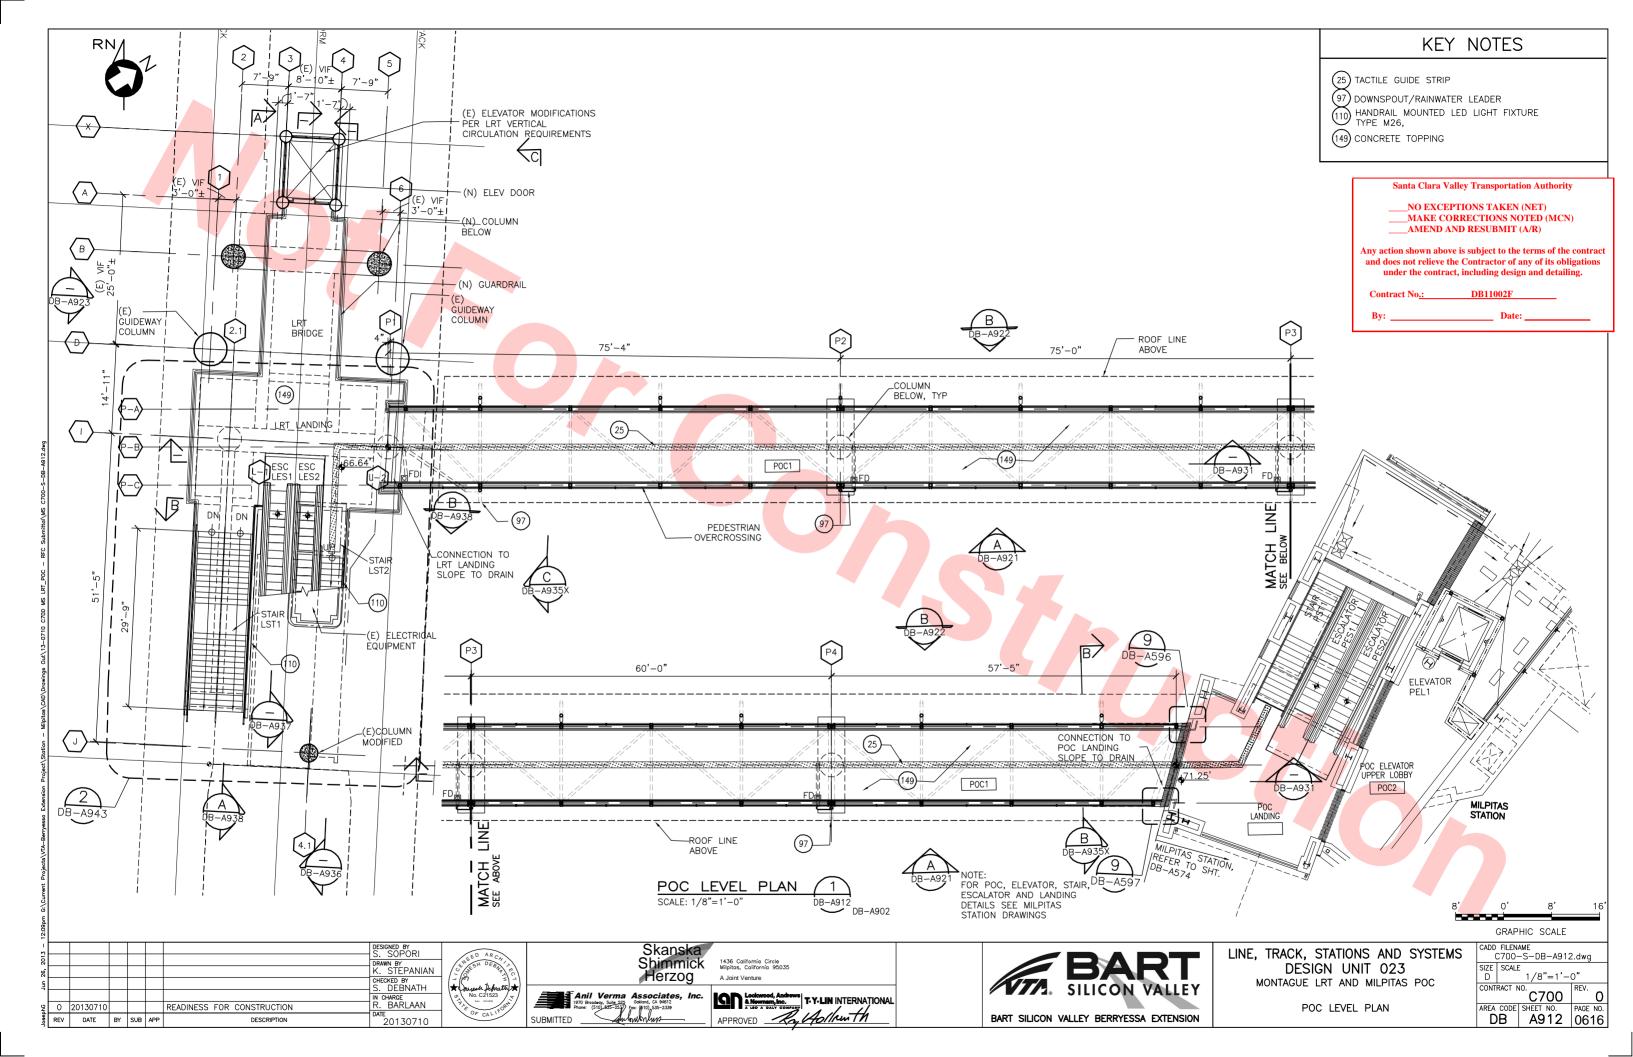


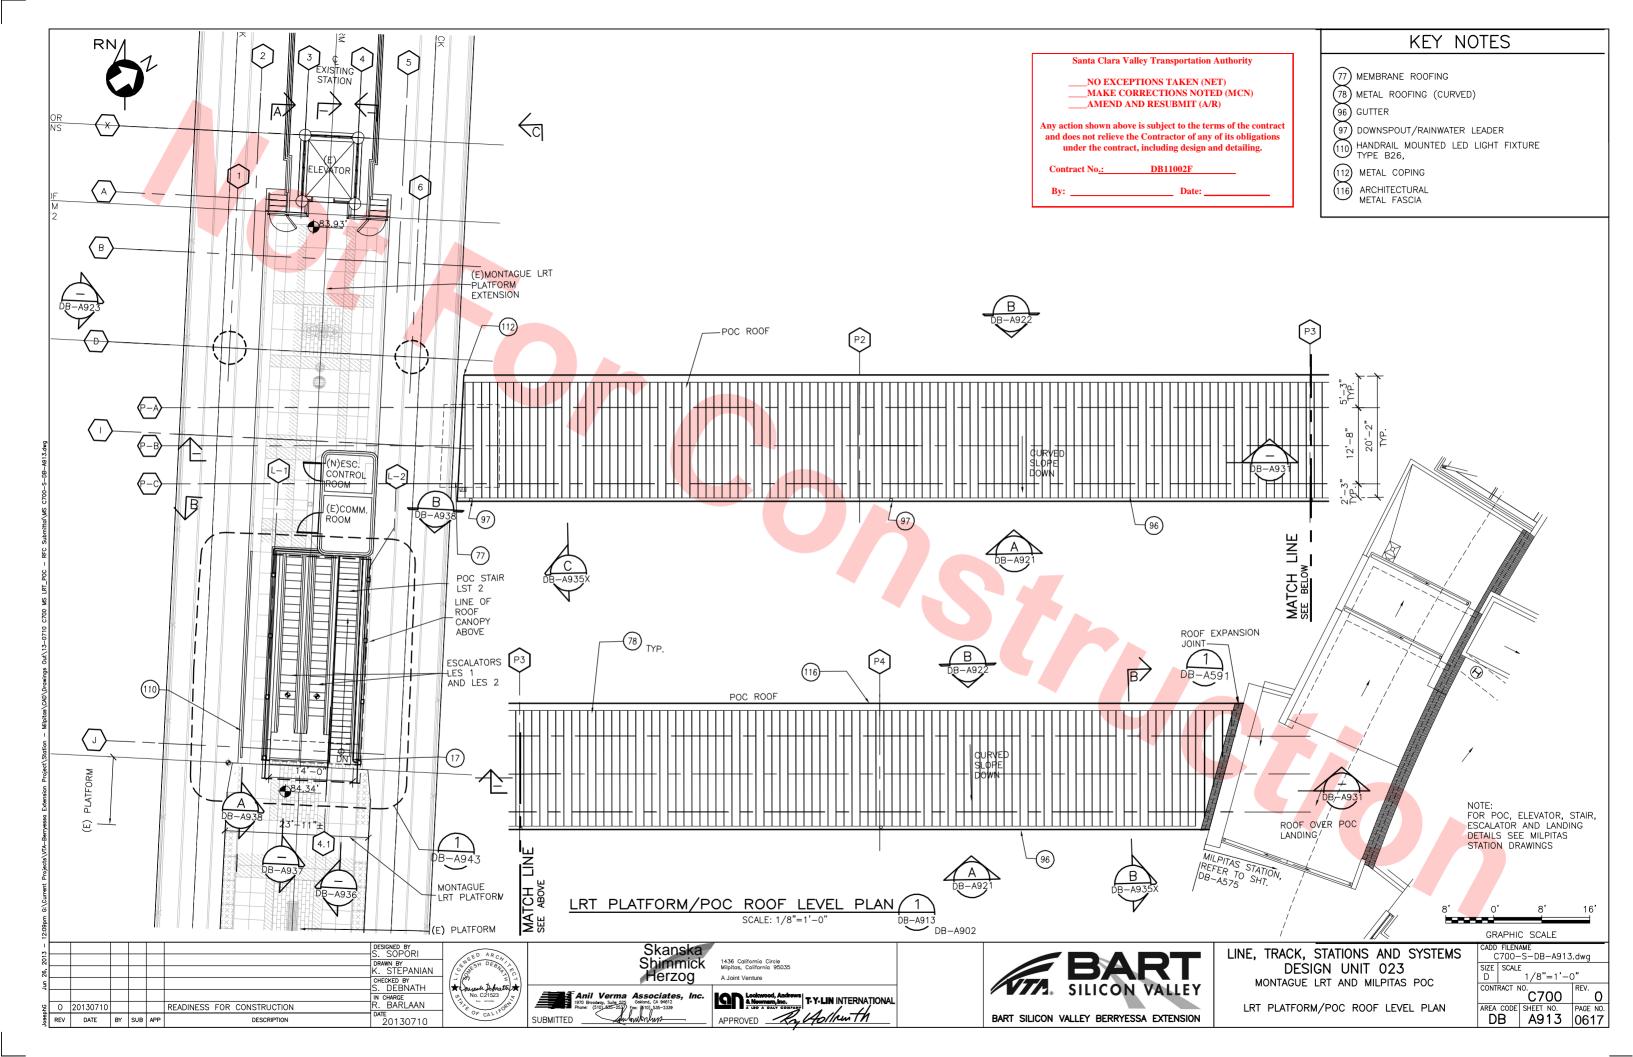


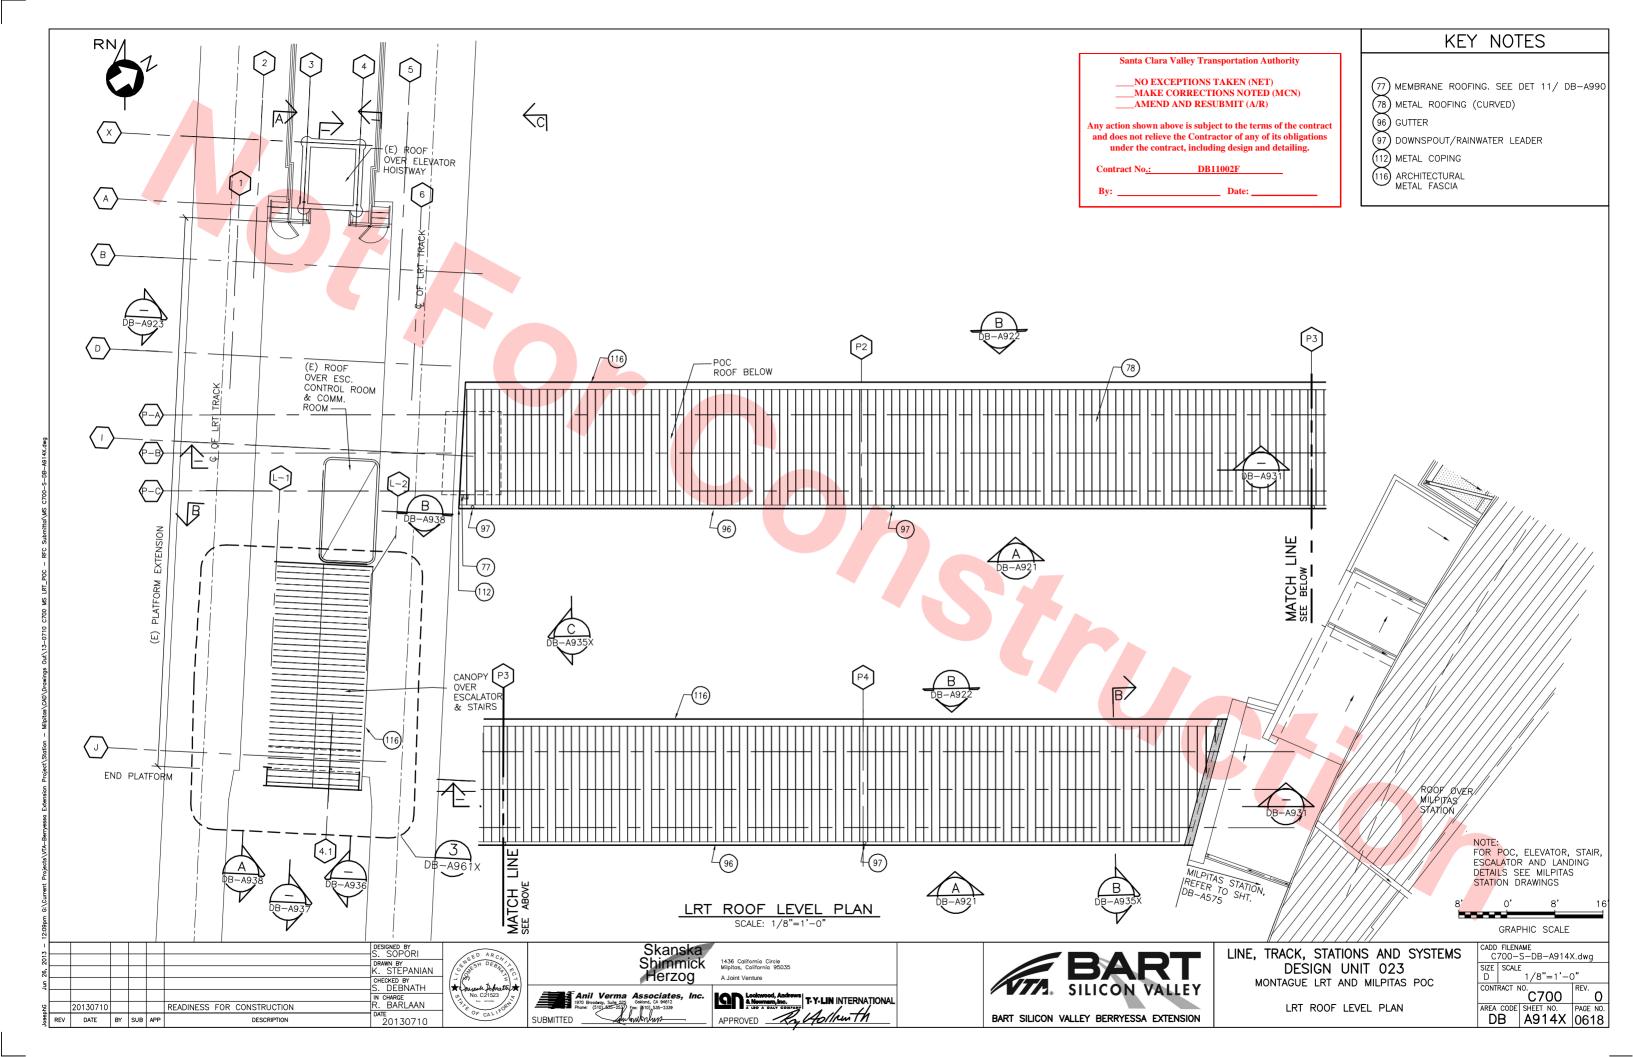


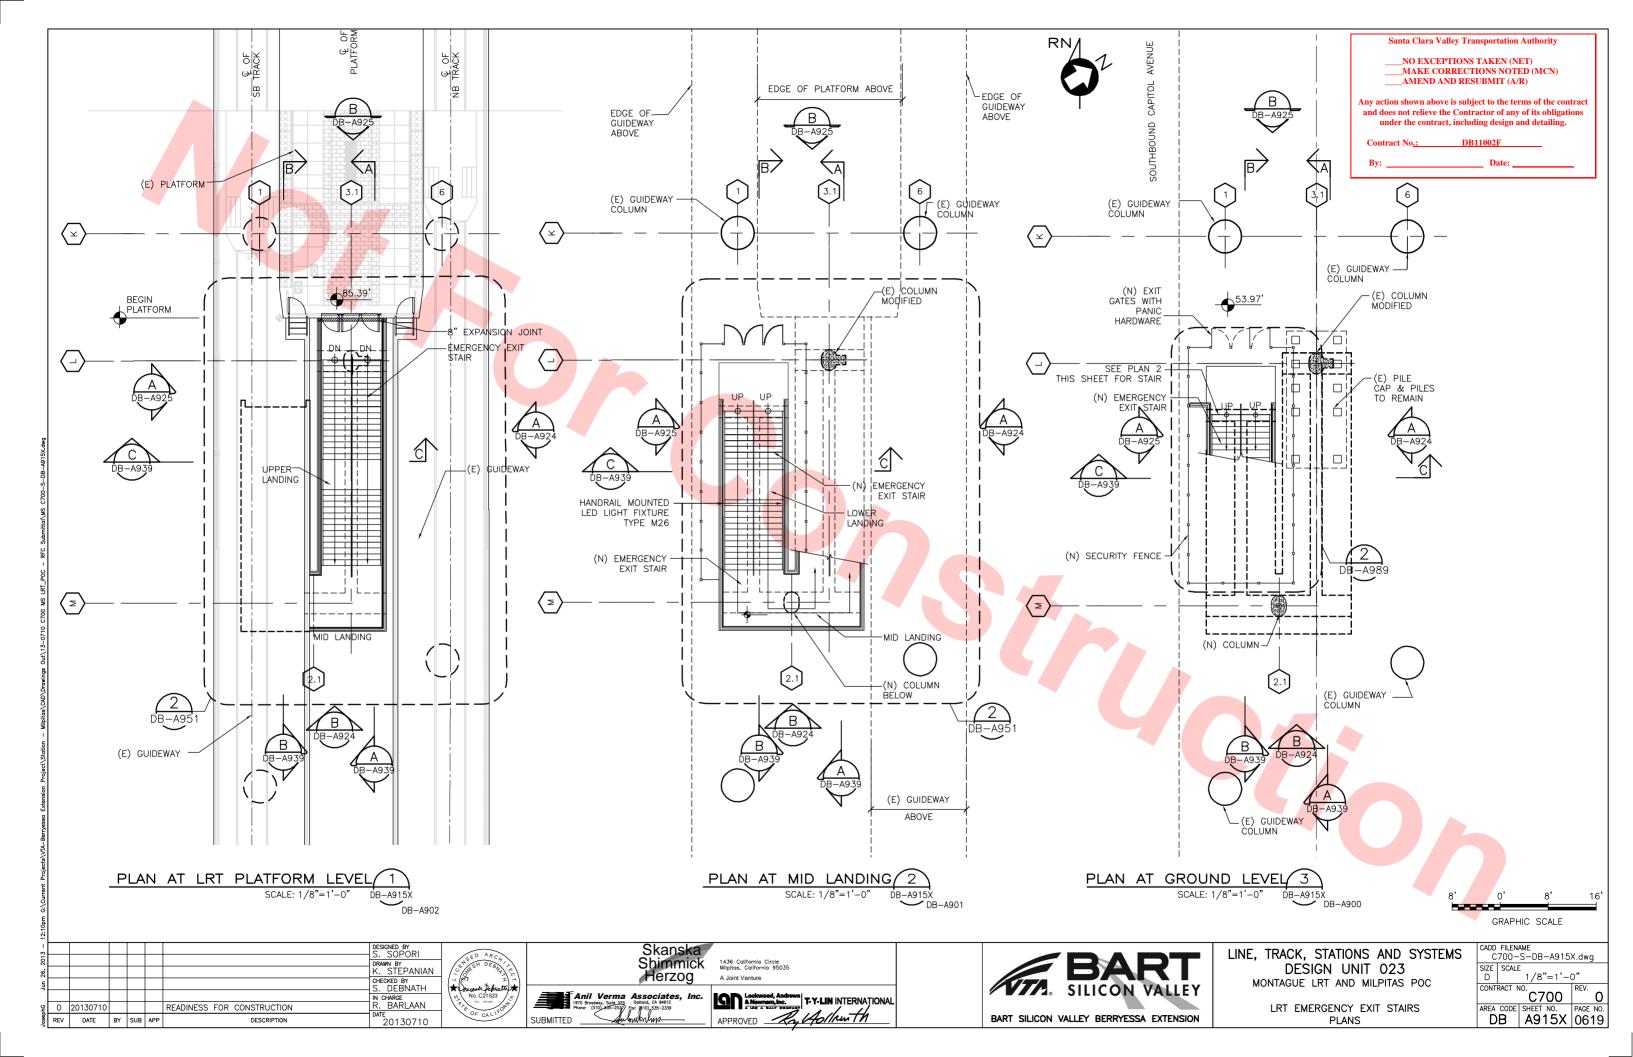


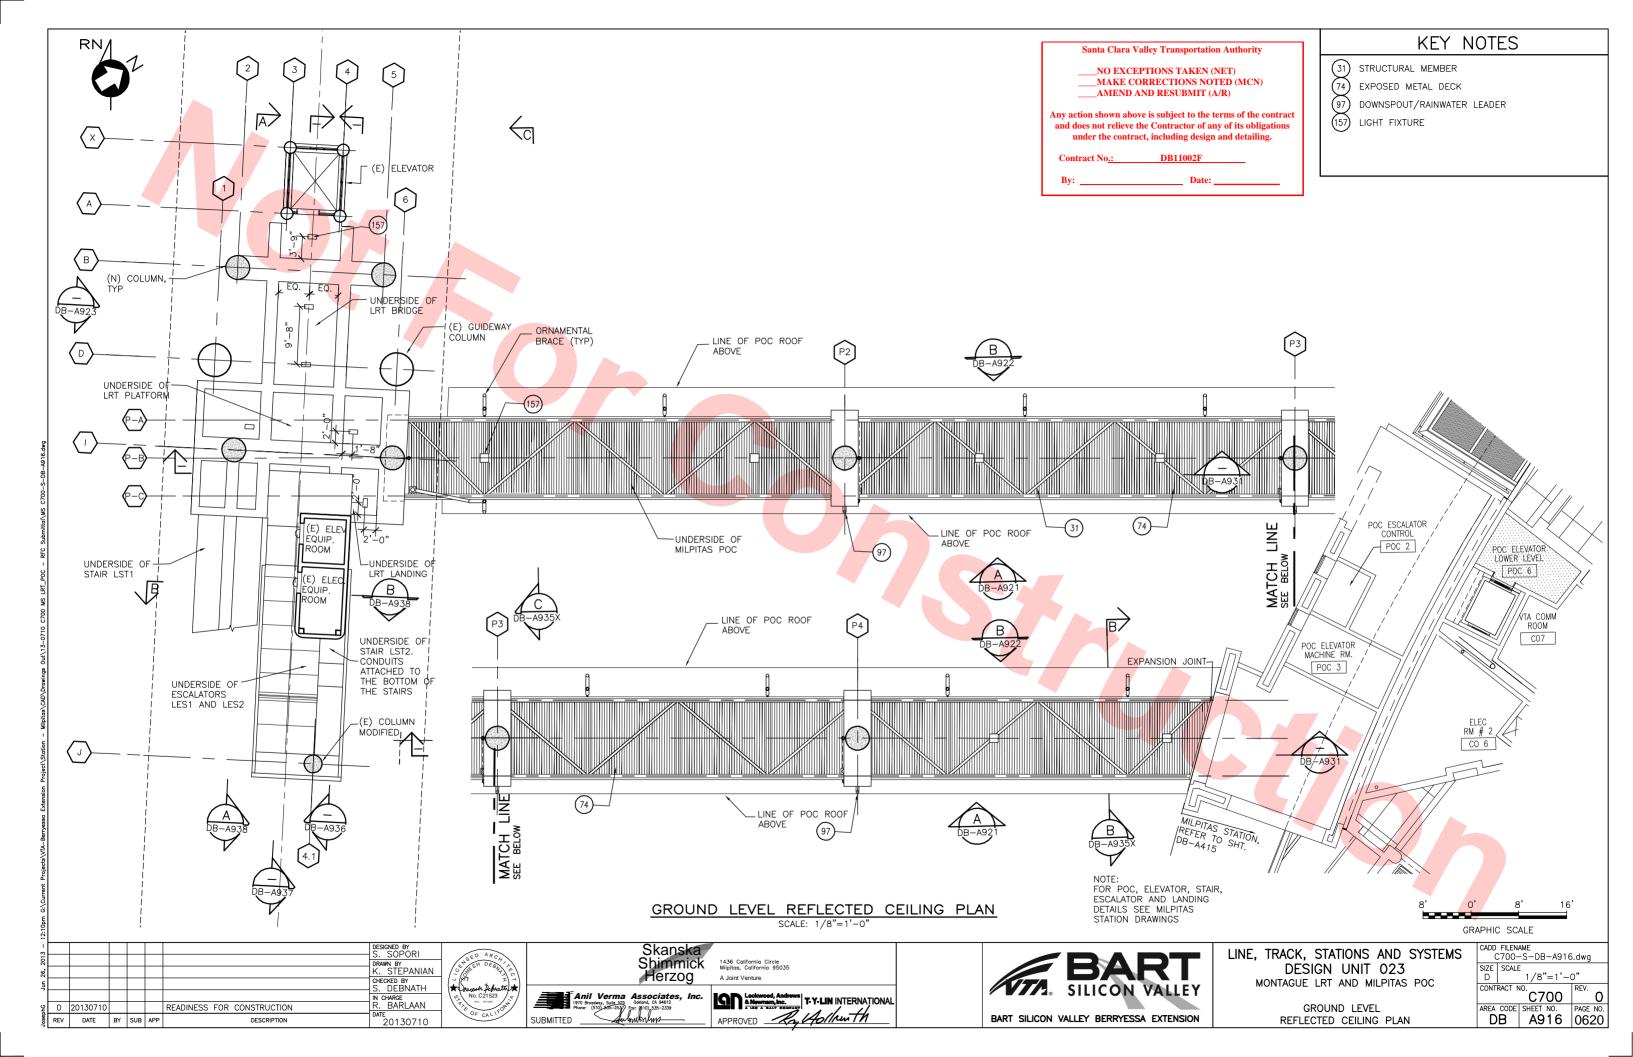


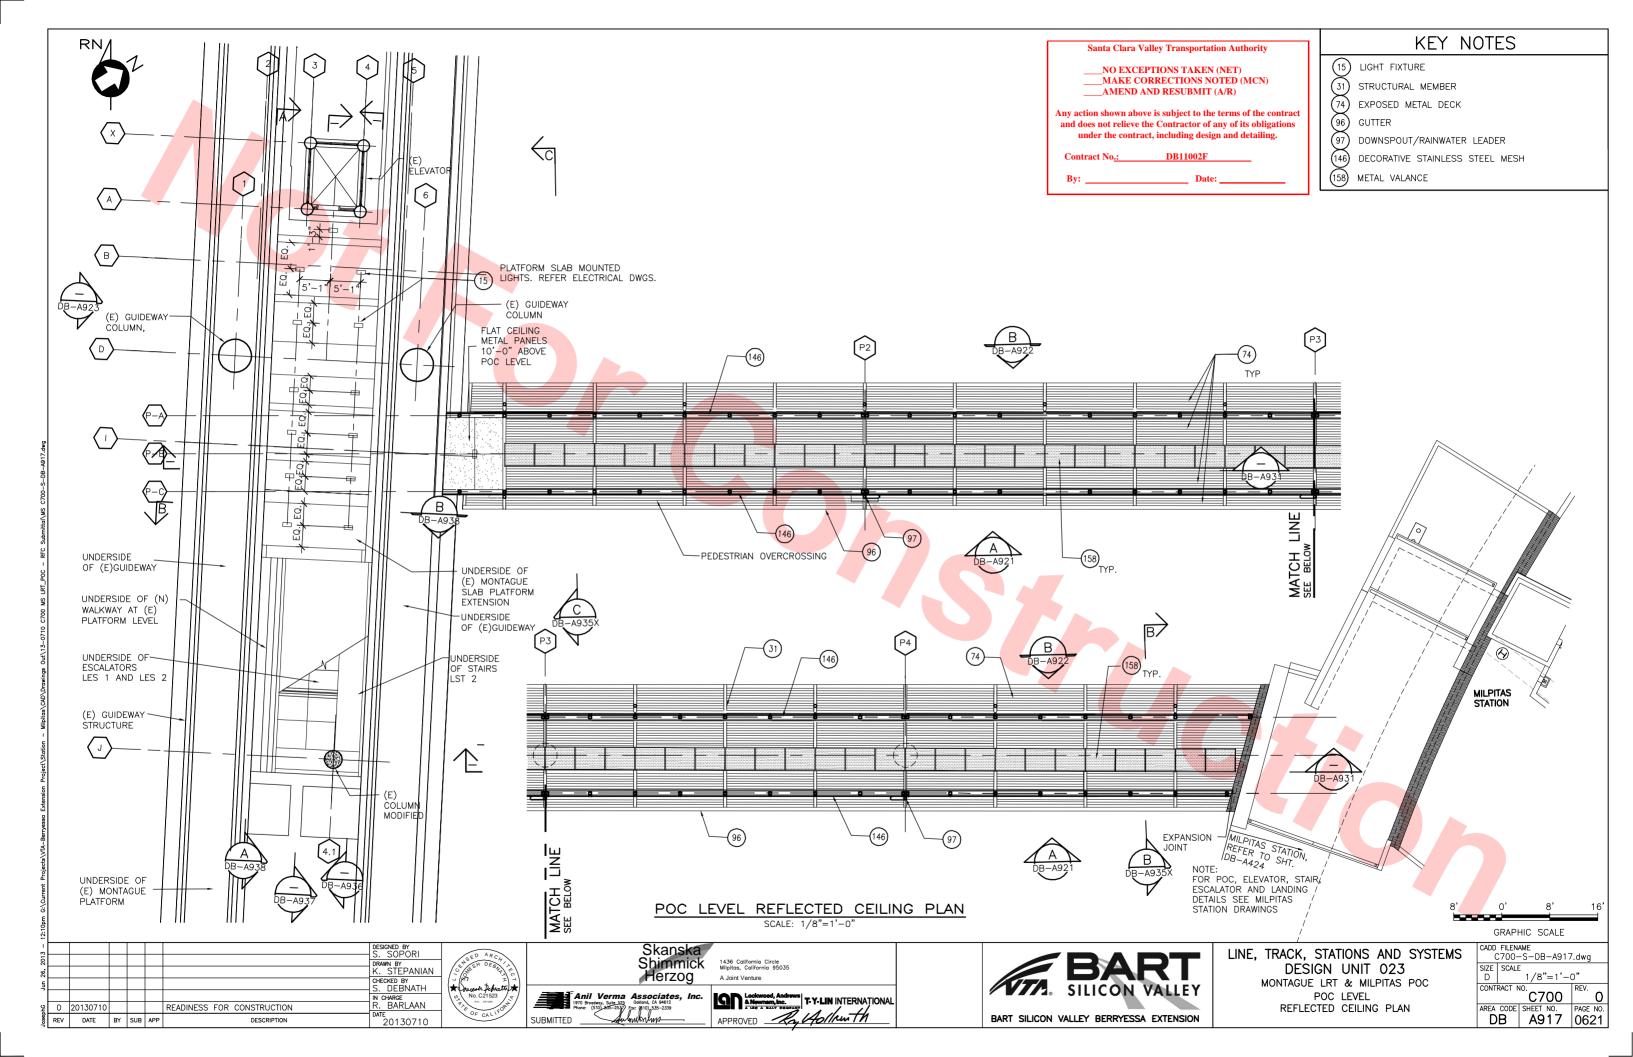

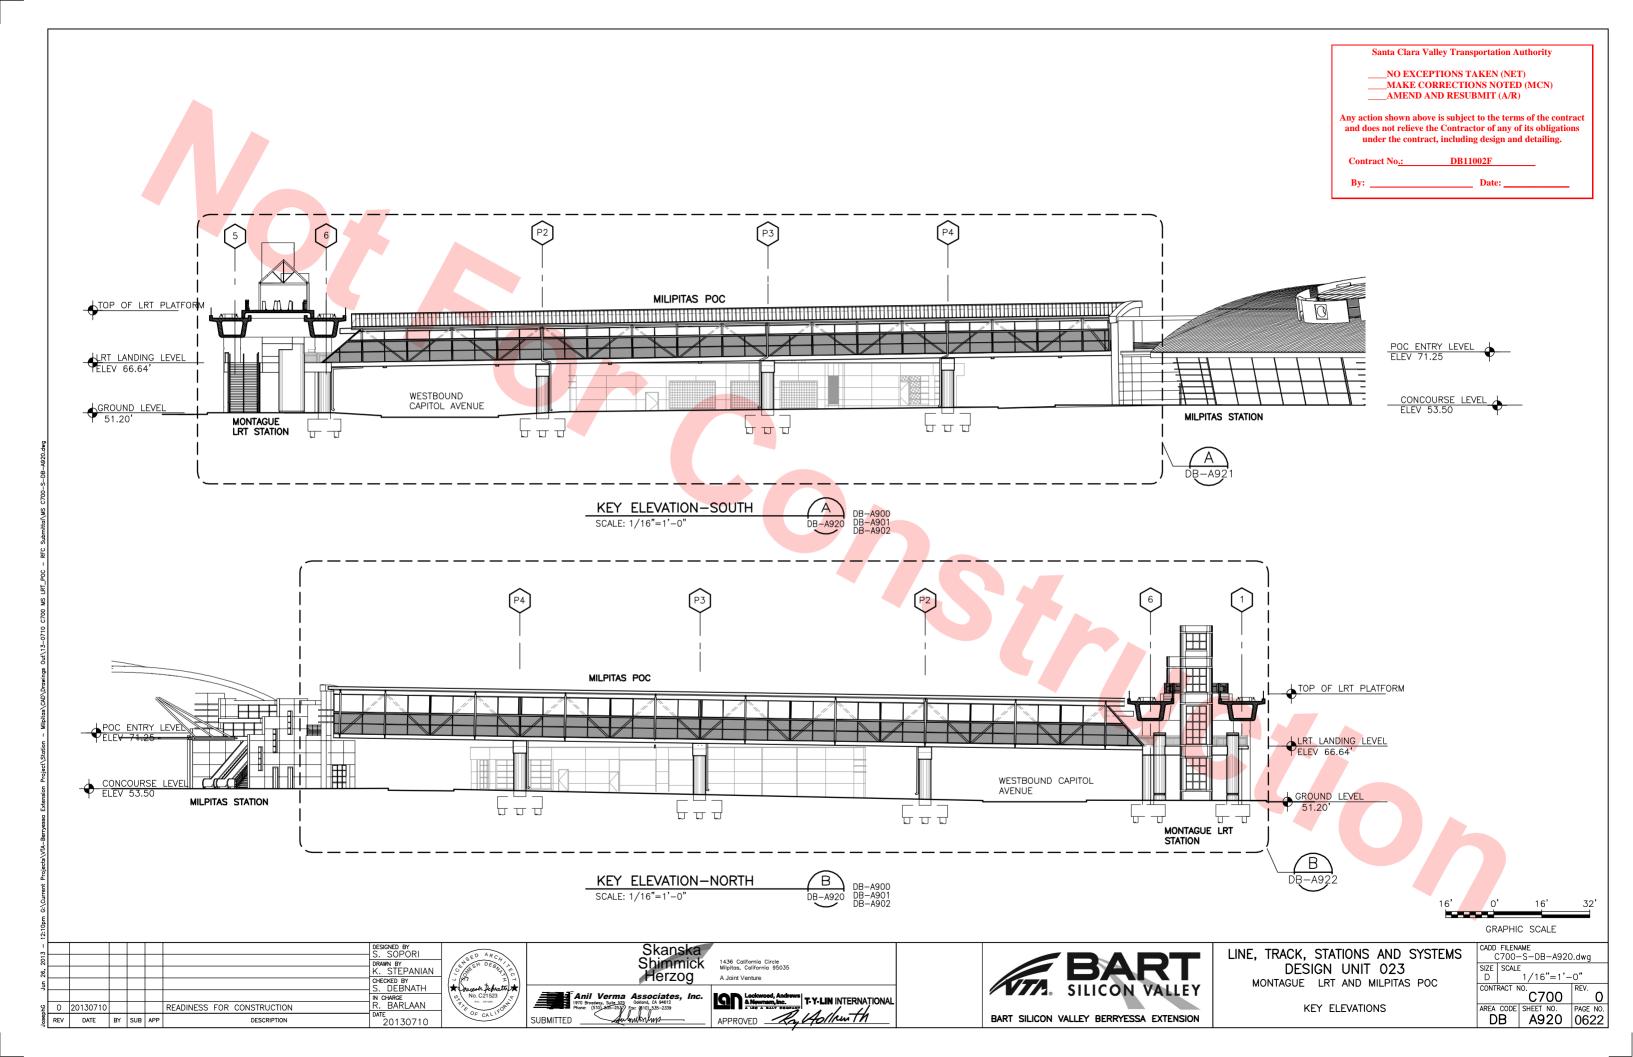

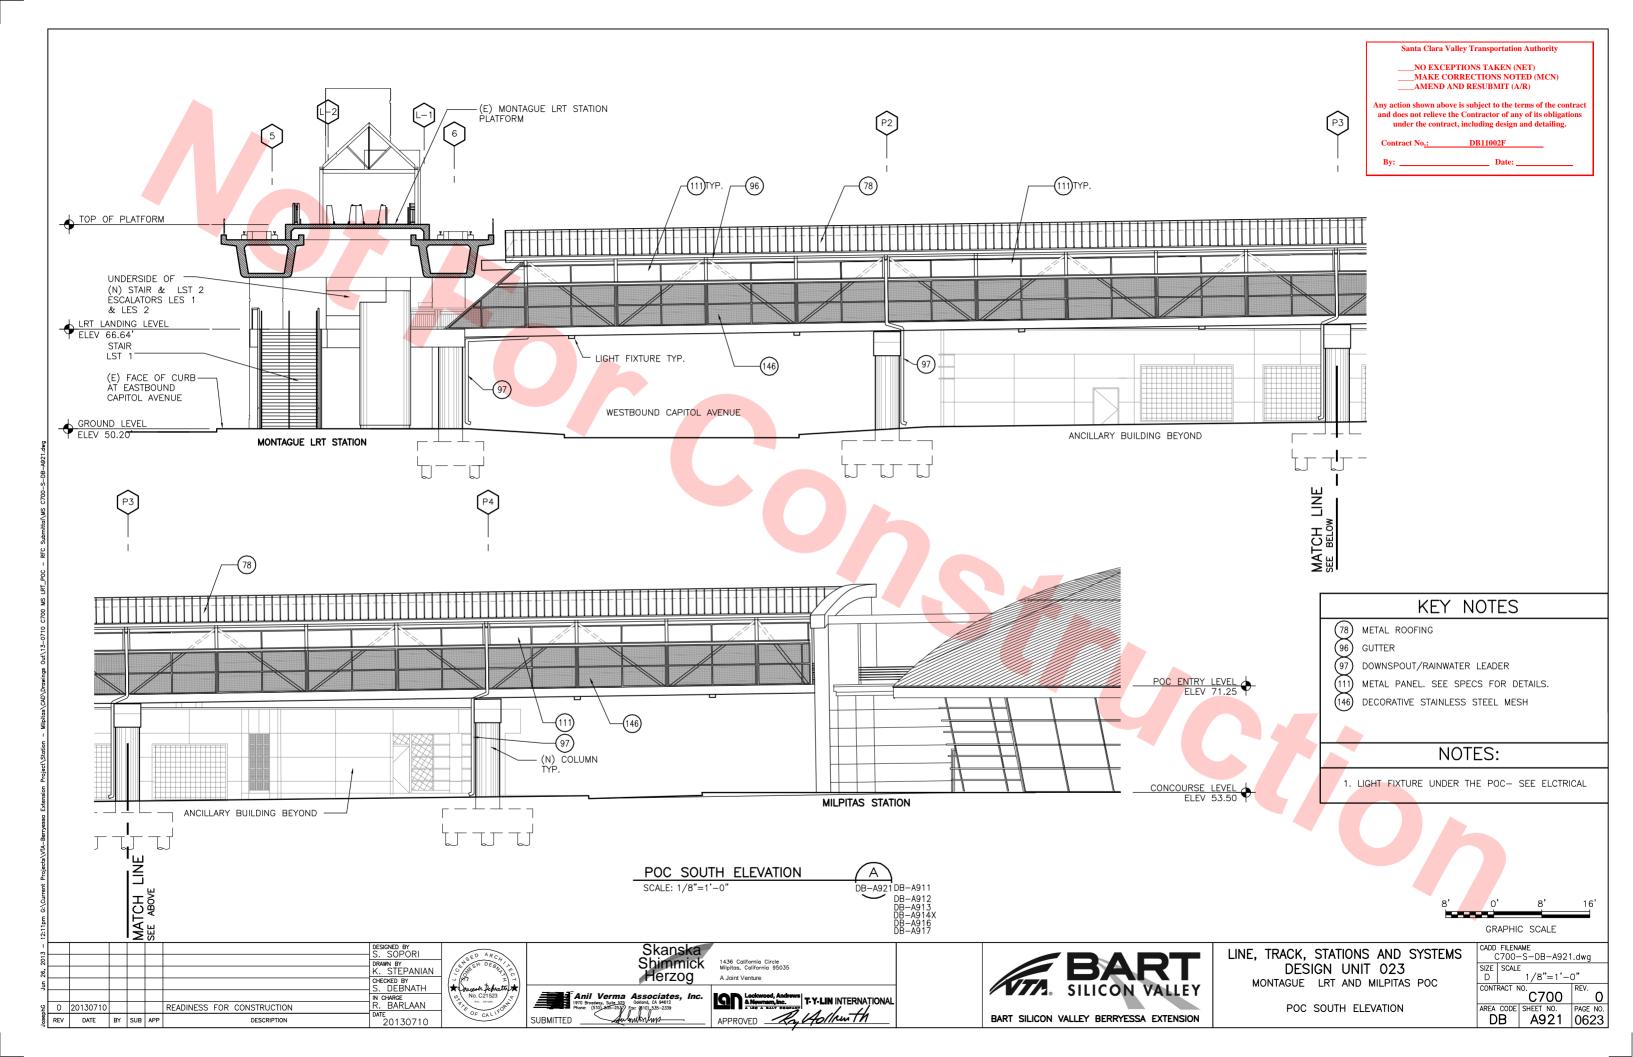

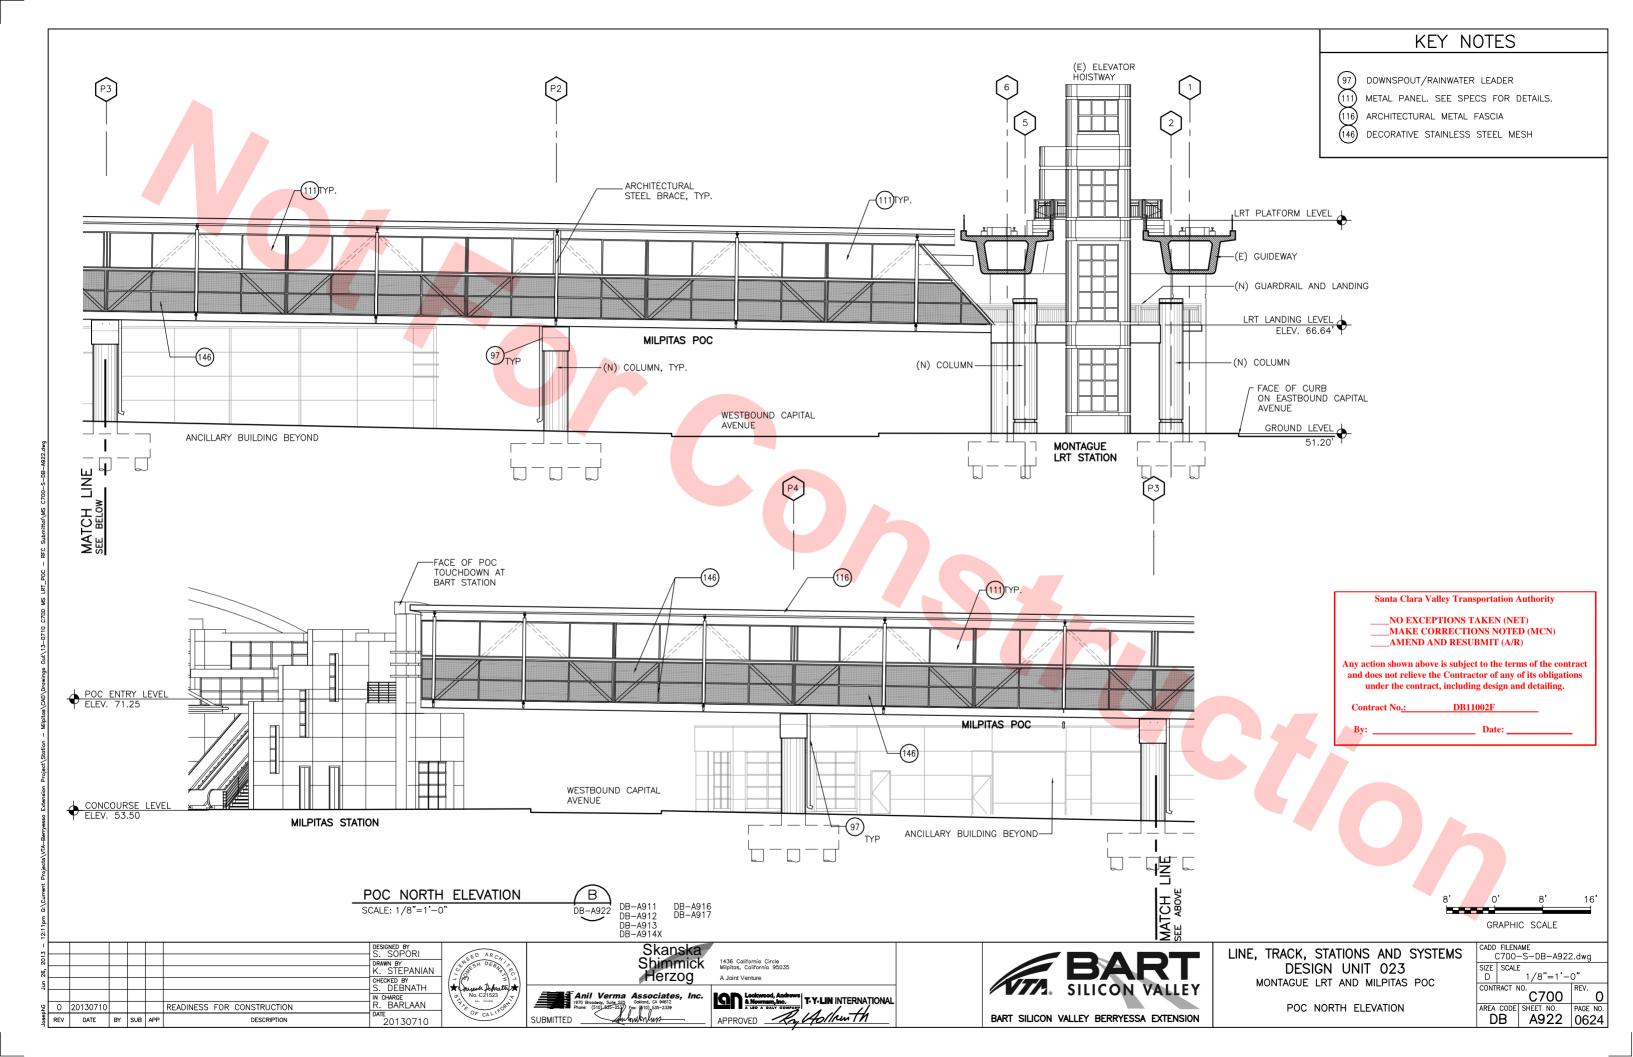

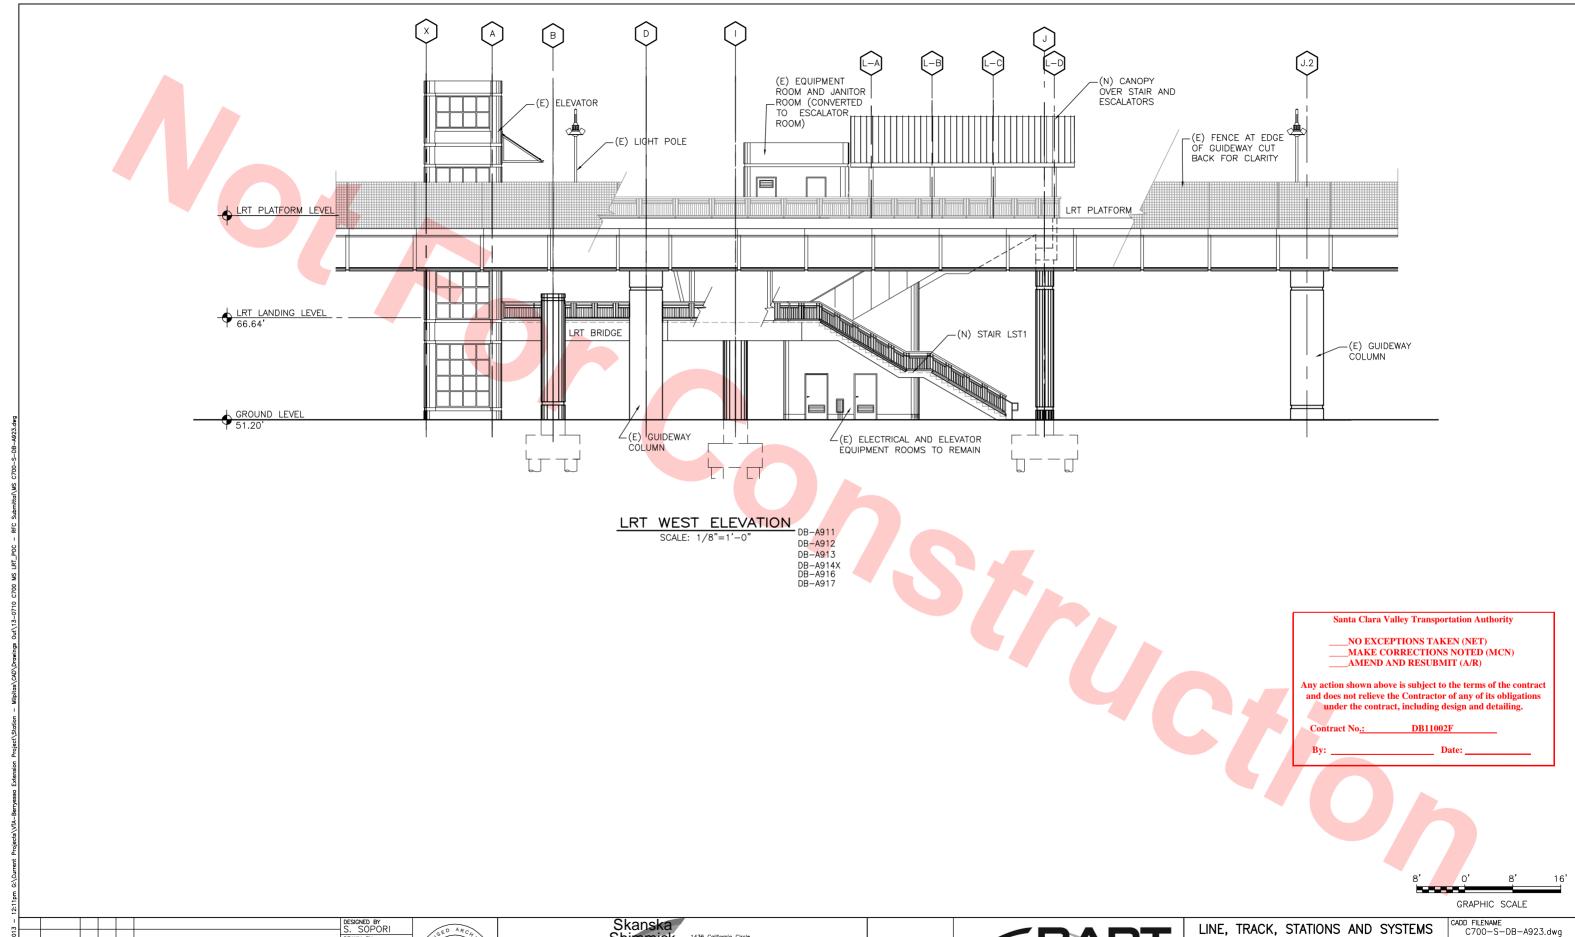

PE 0 20130710 READINESS FOR CONSTRUCTION
REV DATE BY SUB APP DESCRIPTION








LINE, TRACK, STATIONS AND SYSTEMS
DESIGN UNIT 023
MONTAGUE LRT AND MILPITAS POC

LRT	WEST	ELEVATION	

CADD FILENAME										
C700-S-DB-A923.dwg										
SIZE	SCALE			_						
D		AS	NOTE	D						
CONT	RACT N	10.		REV.						
			'00		~ 1					
					$\overline{}$					
AREA	CODE	SHEET	NO.	PAGE						
ח	R	۸۵	23	062	ったし					
ט	ן ט		23	100	20					

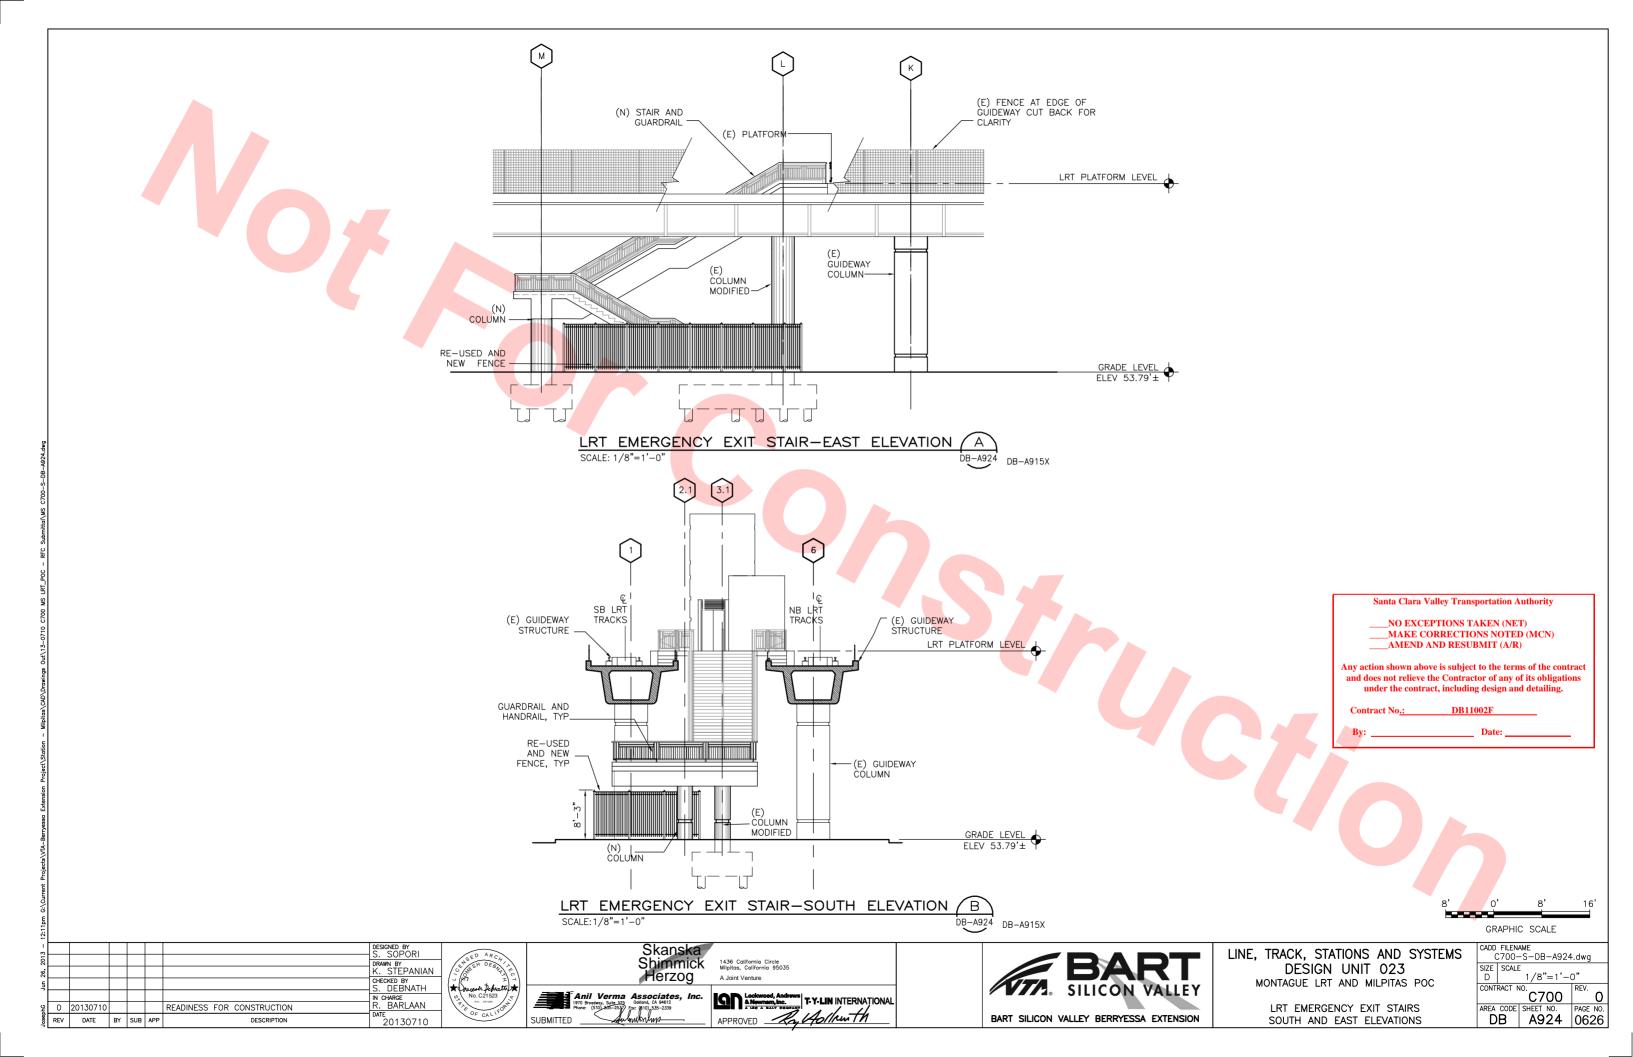

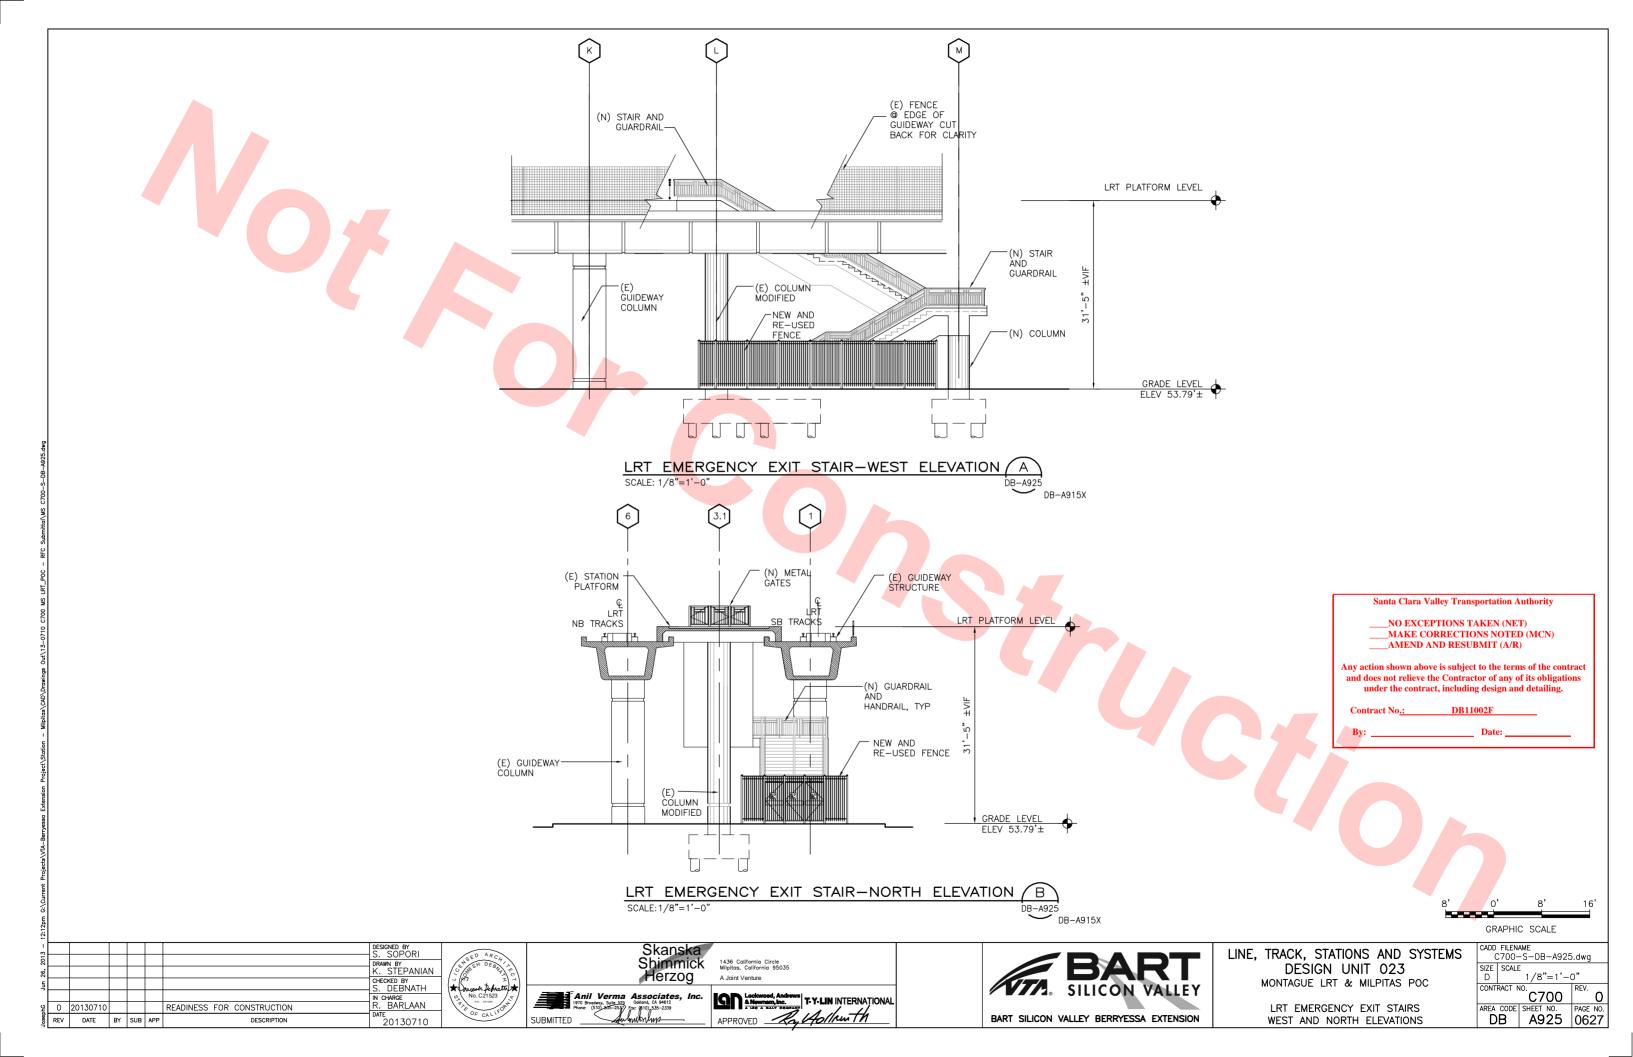

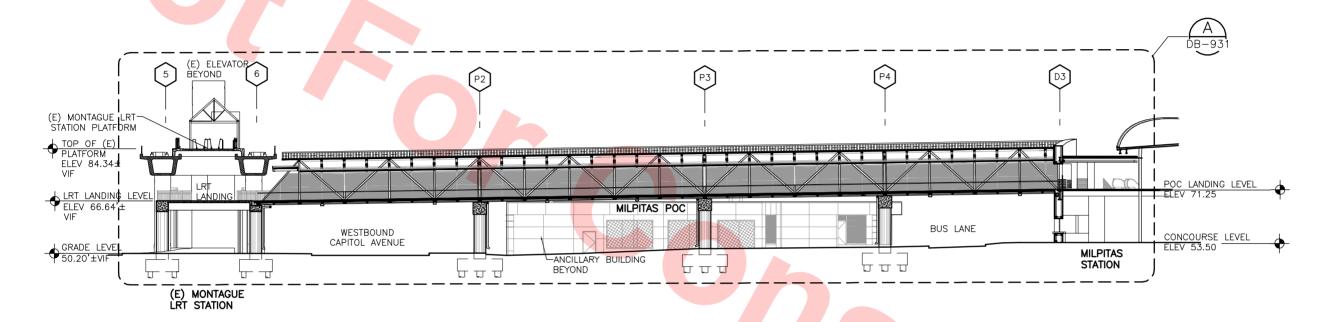

POC KEY LONGITUDINAL SECTION

SCALE: 1/16"=1'-0"

DB

DB-A900 DB-A901 DB-A902 Santa Clara Valley Transportation Authority

____NO EXCEPTIONS TAKEN (NET)
____MAKE CORRECTIONS NOTED (MCN)
___AMEND AND RESUBMIT (A/R)

Any action shown above is subject to the terms of the contract and does not relieve the Contractor of any of its obligations under the contract, including design and detailing.


Contract No : DR11002F

Ву: ____

Date

| DESIGNED BY | S. SOPORI | DRAWN BY | S. SOPORI | DRAWN BY | K. STEPANIAN | K. STEPANIAN | S. DEBNATH | S. D



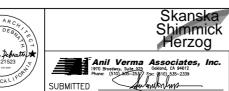








LINE, TRACK, STATIONS AND SYSTEMS DESIGN UNIT 023 MONTAGUE LRT AND MILPITAS POC

POC KEY LONGITUDINAL SECTION

			-A930	dwg.
SIZE D	SCALE		"=1'-	0"
		C7		REV. O
				PAGE NO. 0628
	SIZE D CONT	C700- SIZE SCALE D CONTRACT N	SIZE SCALE D 1/16 CONTRACT NO. C7 AREA CODE SHEET	C700-S-DB-A930 SIZE SCALE D 1/16"=1'- CONTRACT NO. C700 AREA CODE SHEET NO.

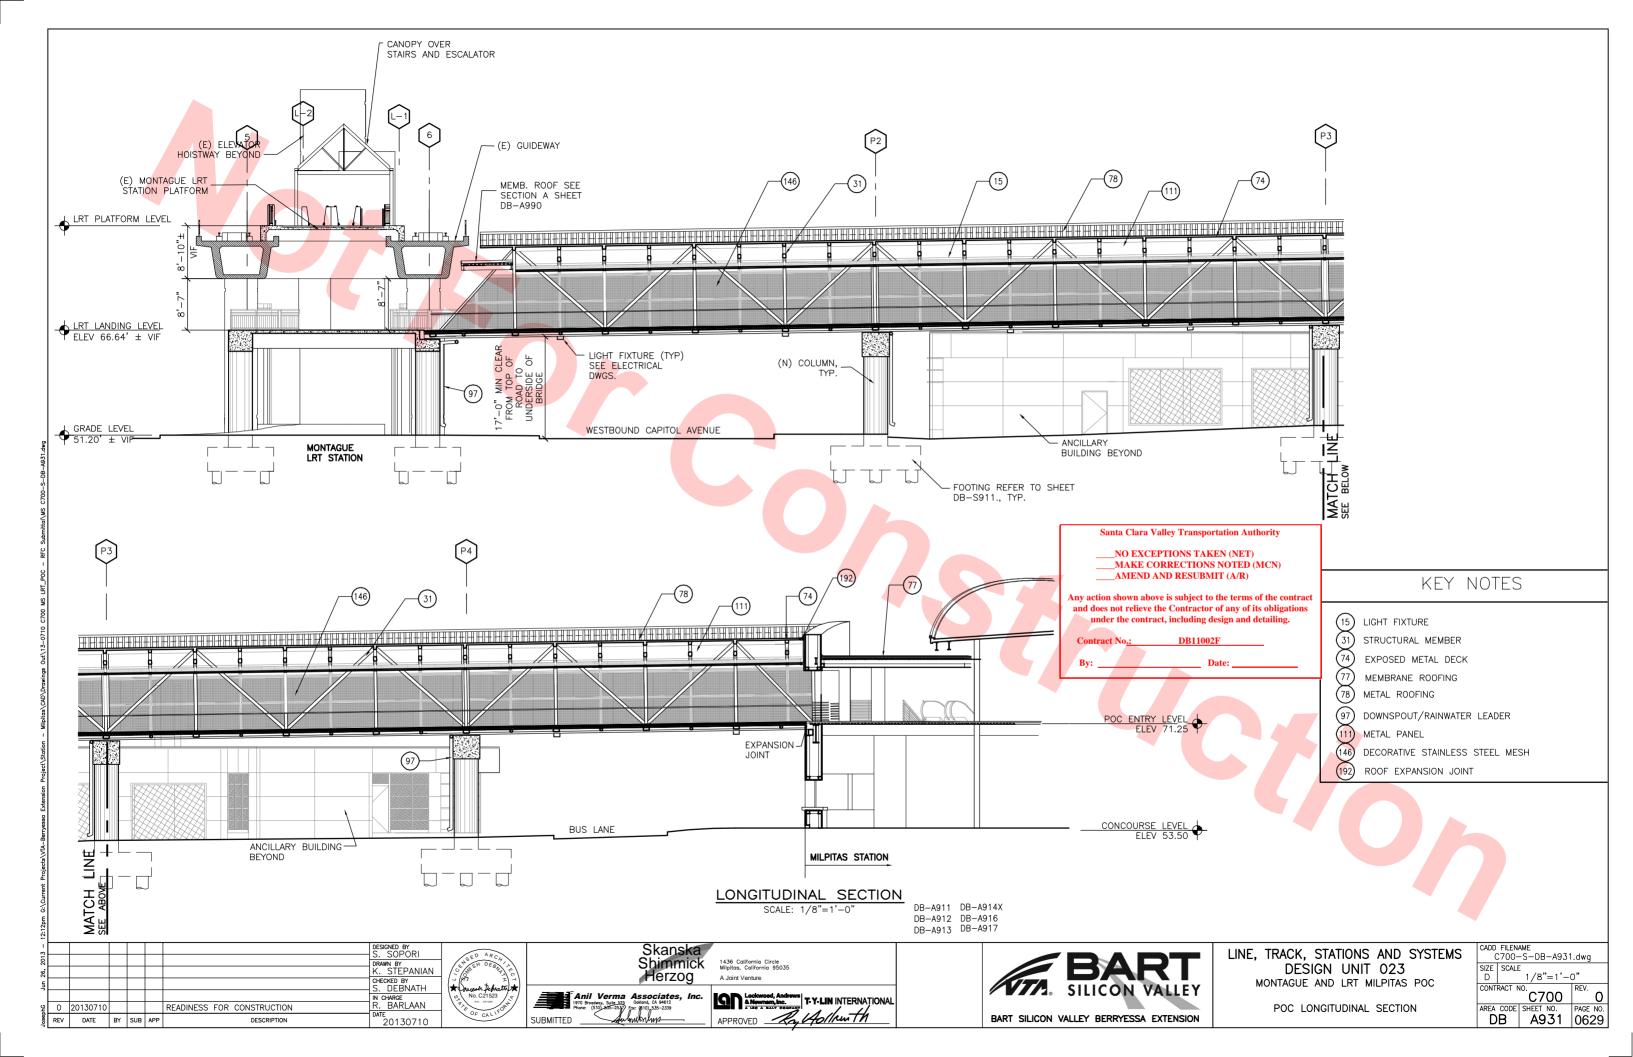

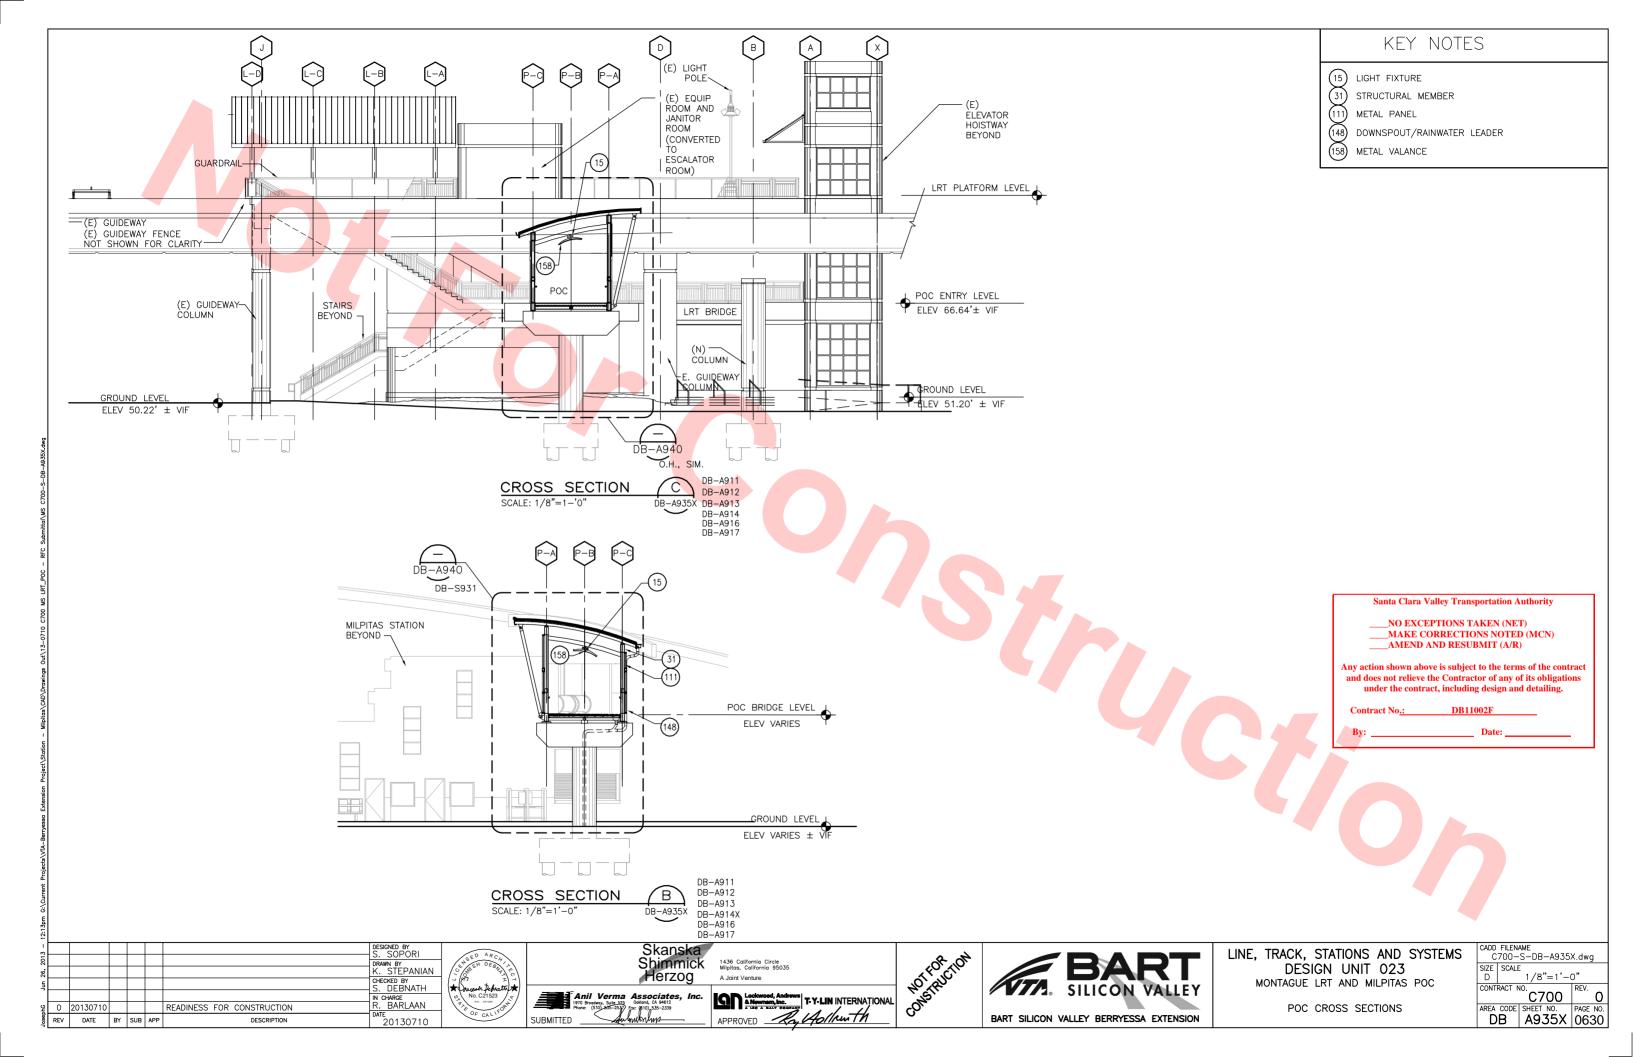

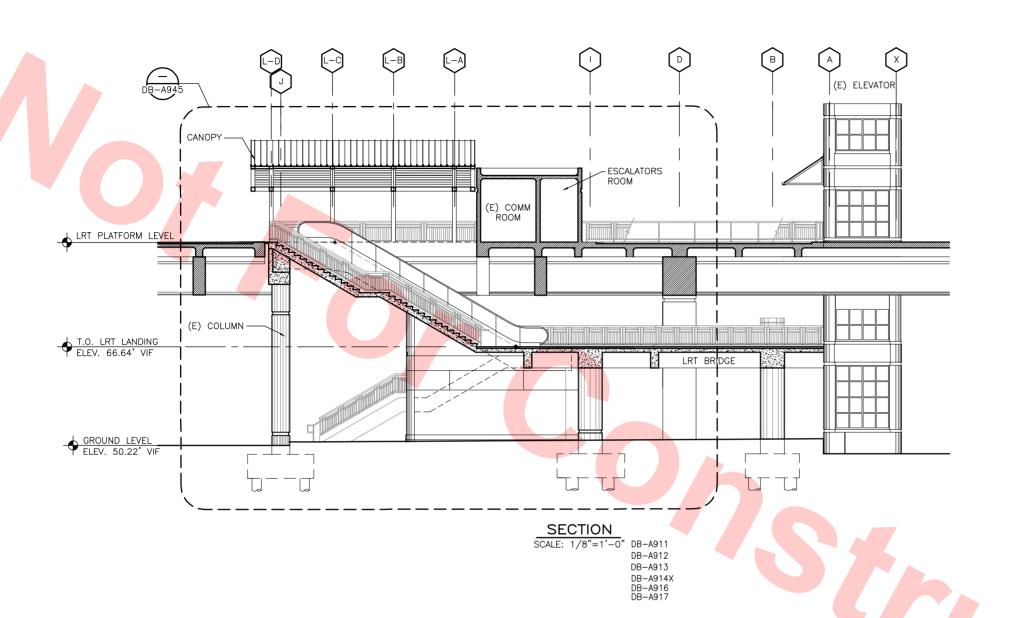

Santa Clara Valley Transportation Authority

____NO EXCEPTIONS TAKEN (NET)
___MAKE CORRECTIONS NOTED (MCN)
__AMEND AND RESUBMIT (A/R)

Any action shown above is subject to the terms of the contract and does not relieve the Contractor of any of its obligations under the contract, including design and detailing.

Contract No.: DB11002F

By: ____

___ Date: ____

						DESIGNED BY S. SOPORI
						DRAWN BY K. STEPANIAN
						CHECKED BY S. DEBNATH
						IN CHARGE
0	20130710				READINESS FOR CONSTRUCTION	R. BARLAAN
REV	DATE	BY	SUB	APP	DESCRIPTION	DATE 20130710










LINE, TRACK, STATIONS AND SYSTEMS

DESIGN UNIT 023

MONTAGUE LRT AND MILPITAS POC

LRT SECTIONS SHEET 1 OF 3

CADD	FILEN	AME							
C700-S-DB-A936.dwg									
SIZE	SCALE								
D		1/8"=1'-	0"						
CONT	RACT N	10	REV.						
		C700	0						
AREA	CODE	SHEET NO.	PAGE NO.						
	В	A936	0631						

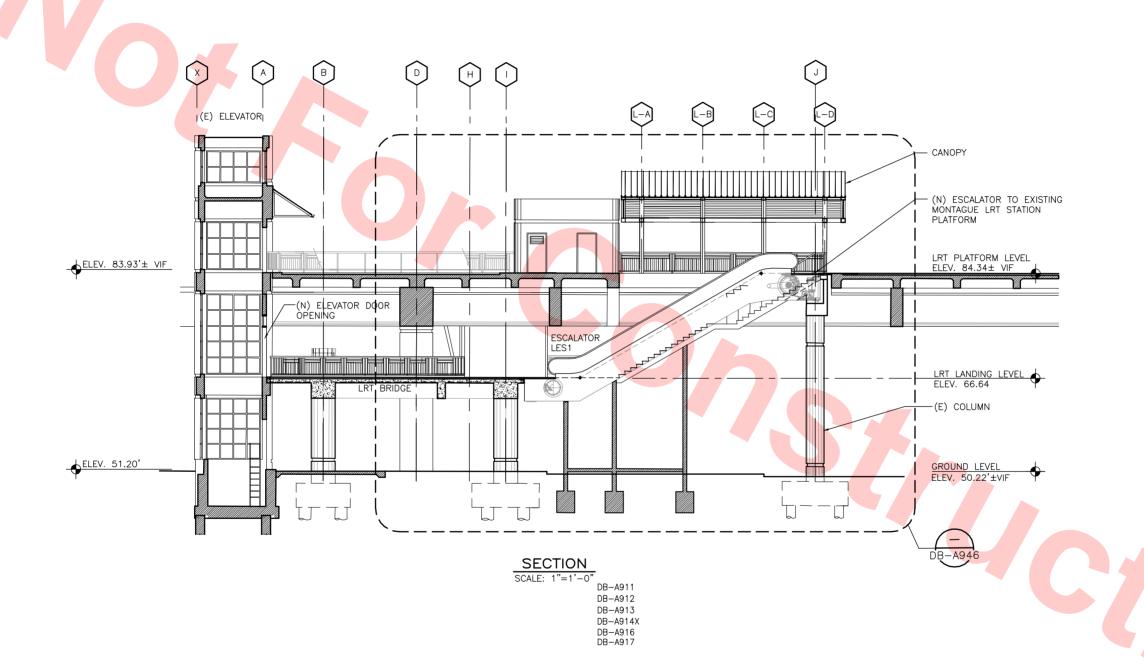

Santa Clara Valley Transportation Authority


___NO EXCEPTIONS TAKEN (NET) ___MAKE CORRECTIONS NOTED (MCN) AMEND AND RESUBMIT (A/R)

Any action shown above is subject to the terms of the contract and does not relieve the Contractor of any of its obligations under the contract, including design and detailing.

GRAPHIC SCALE

13 -							DESIGNED BY S. SOPORI
8							DRAWN BY
26,							K. STEPANIAN
S							CHECKED BY S. DEBNATH
7							
							IN CHARGE
Ę.	0	20130710				READINESS FOR CONSTRUCTION	R. BARLAAN
Josep	REV	DATE	BY	SUB	APP	DESCRIPTION	20130710



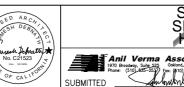








LINE, TRACK, STATIONS AND SYSTEMS DESIGN UNIT 023 MONTAGUE LRT AND MILPITAS POC


LRT S	EC	TION	S
SHEET	2	OF	3


;		FILEN. C700-		I-A937	7.dwg
	SIZE D	SCALE	1/8'	'=1'-	0"
		RACT N	C7	00	REV.
			SHEET		PAGE NO
	ט ן	В	A9	37	0632

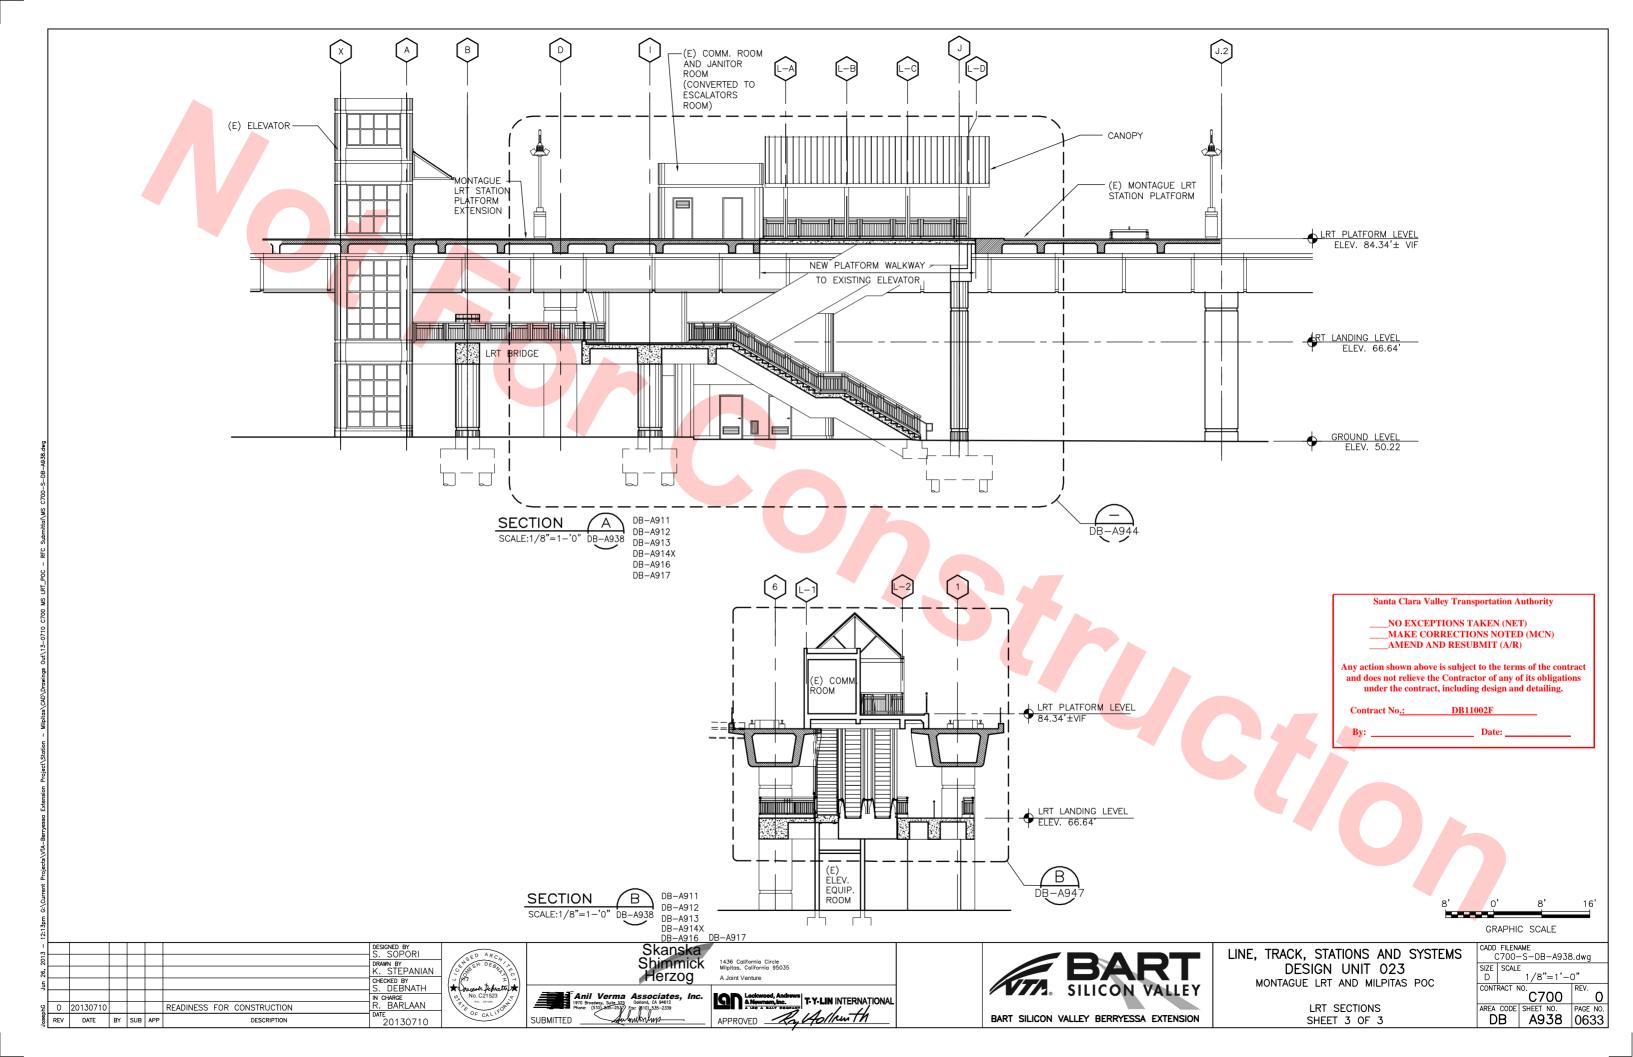


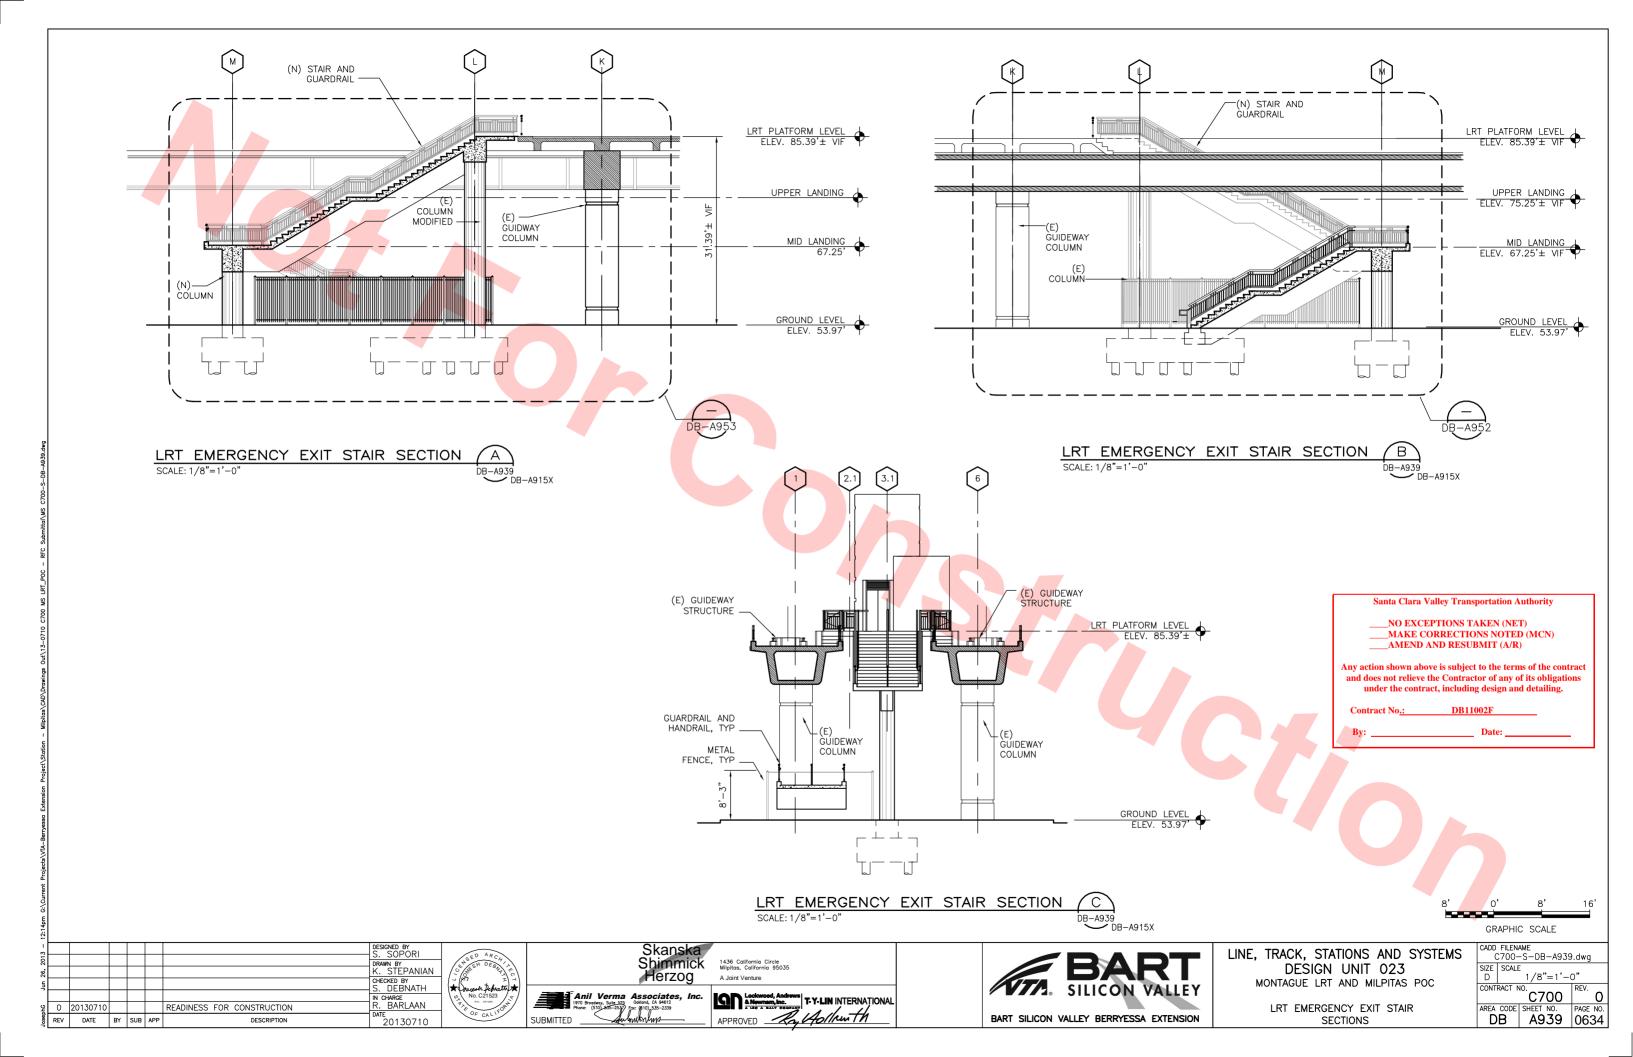


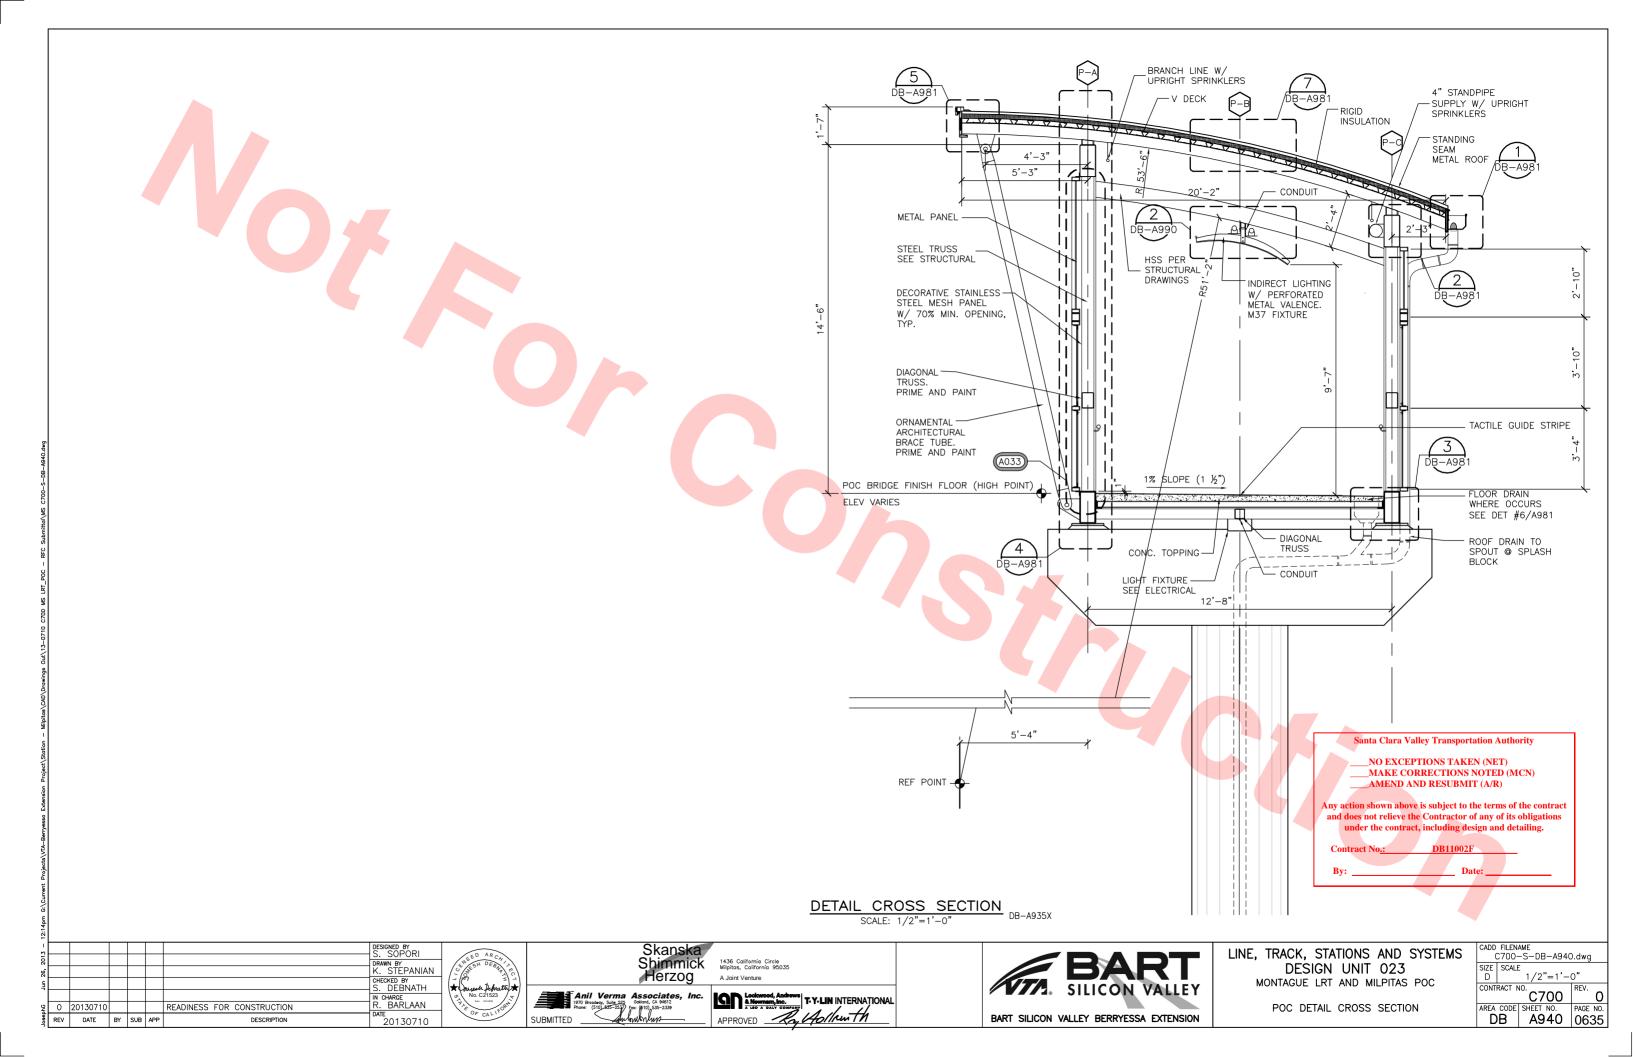


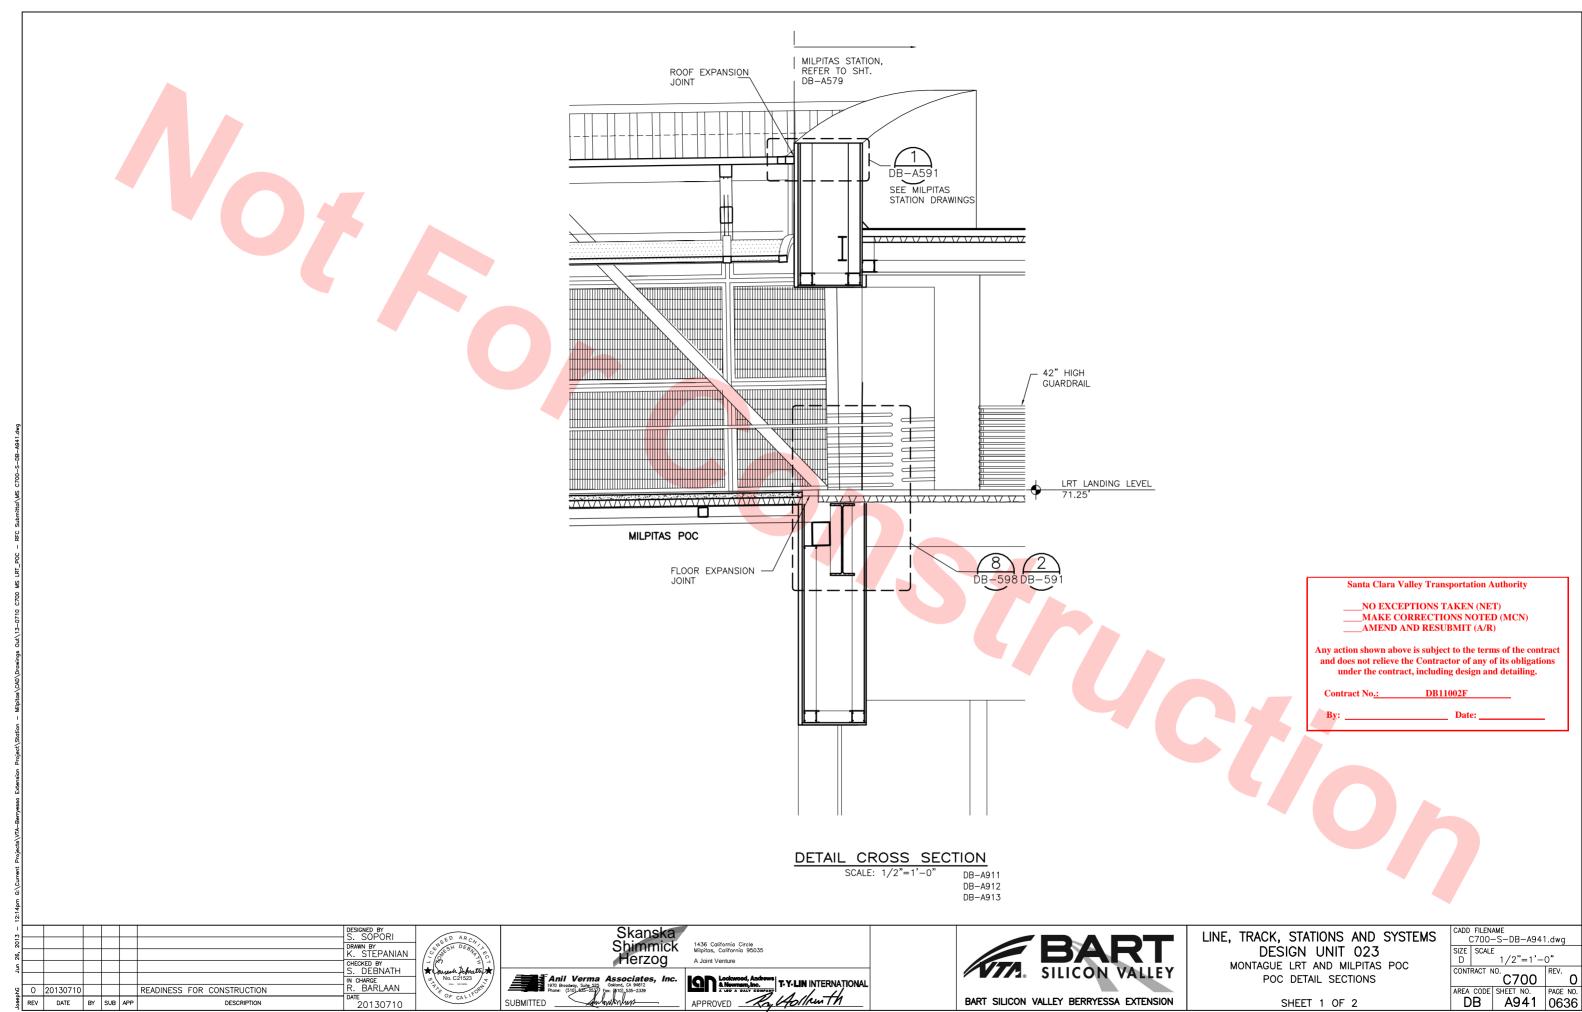


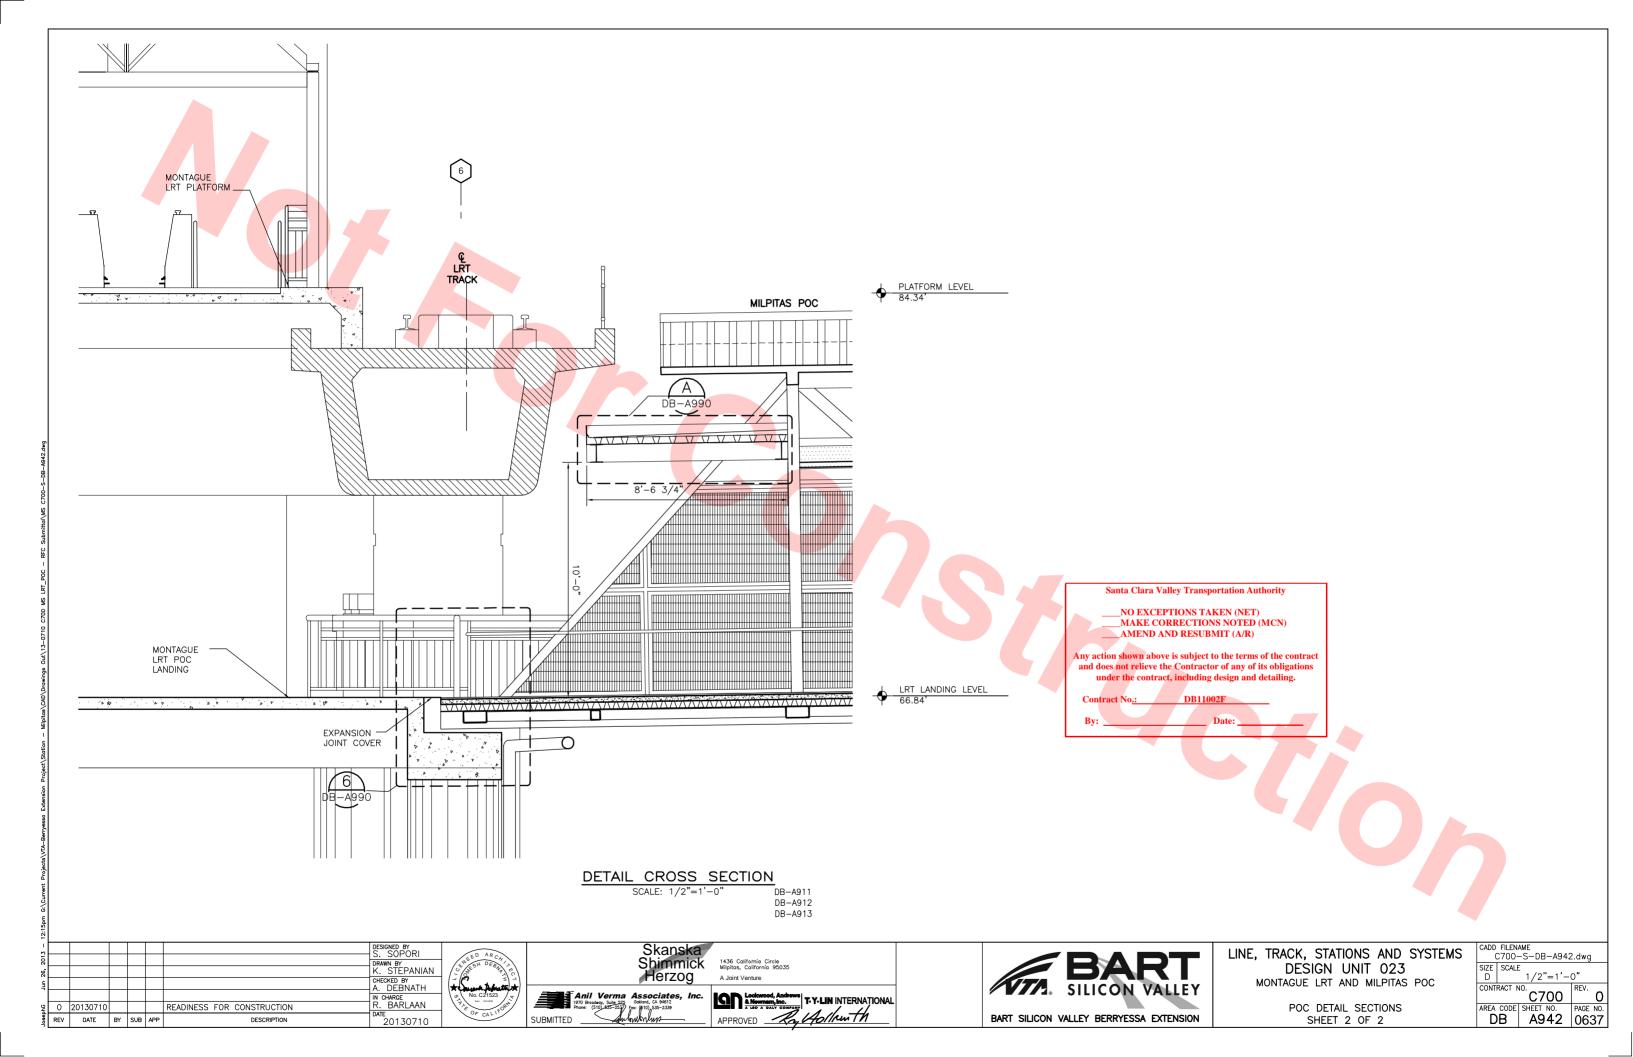


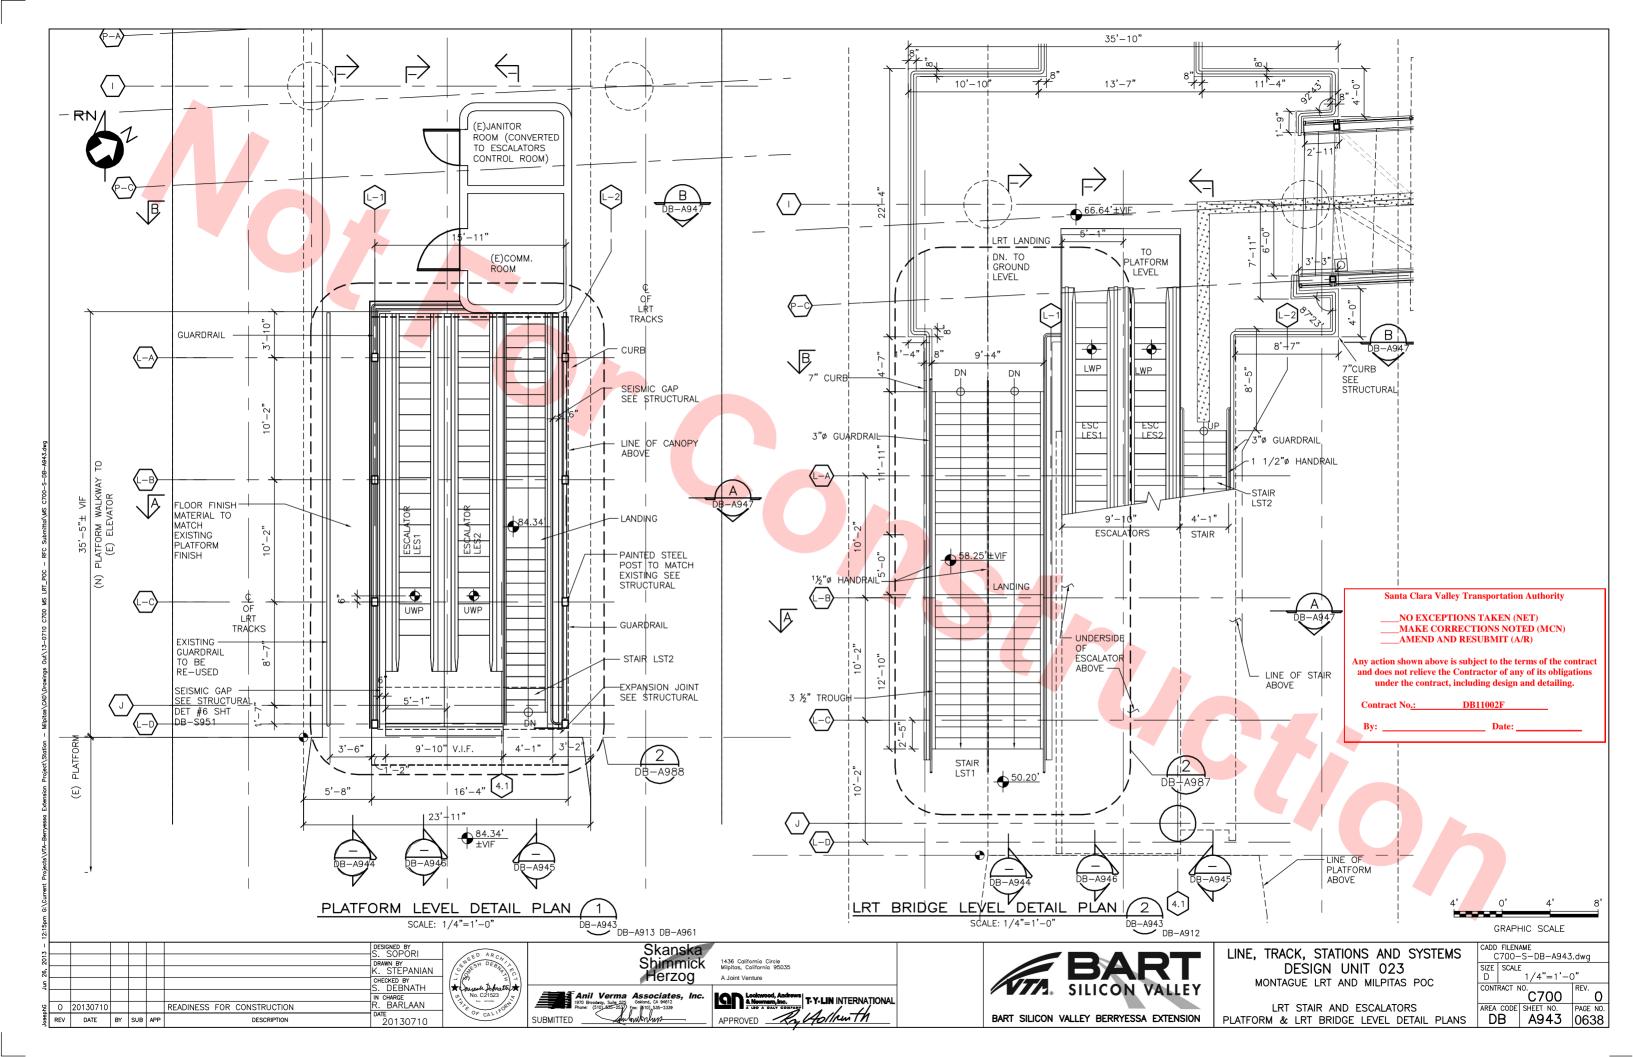


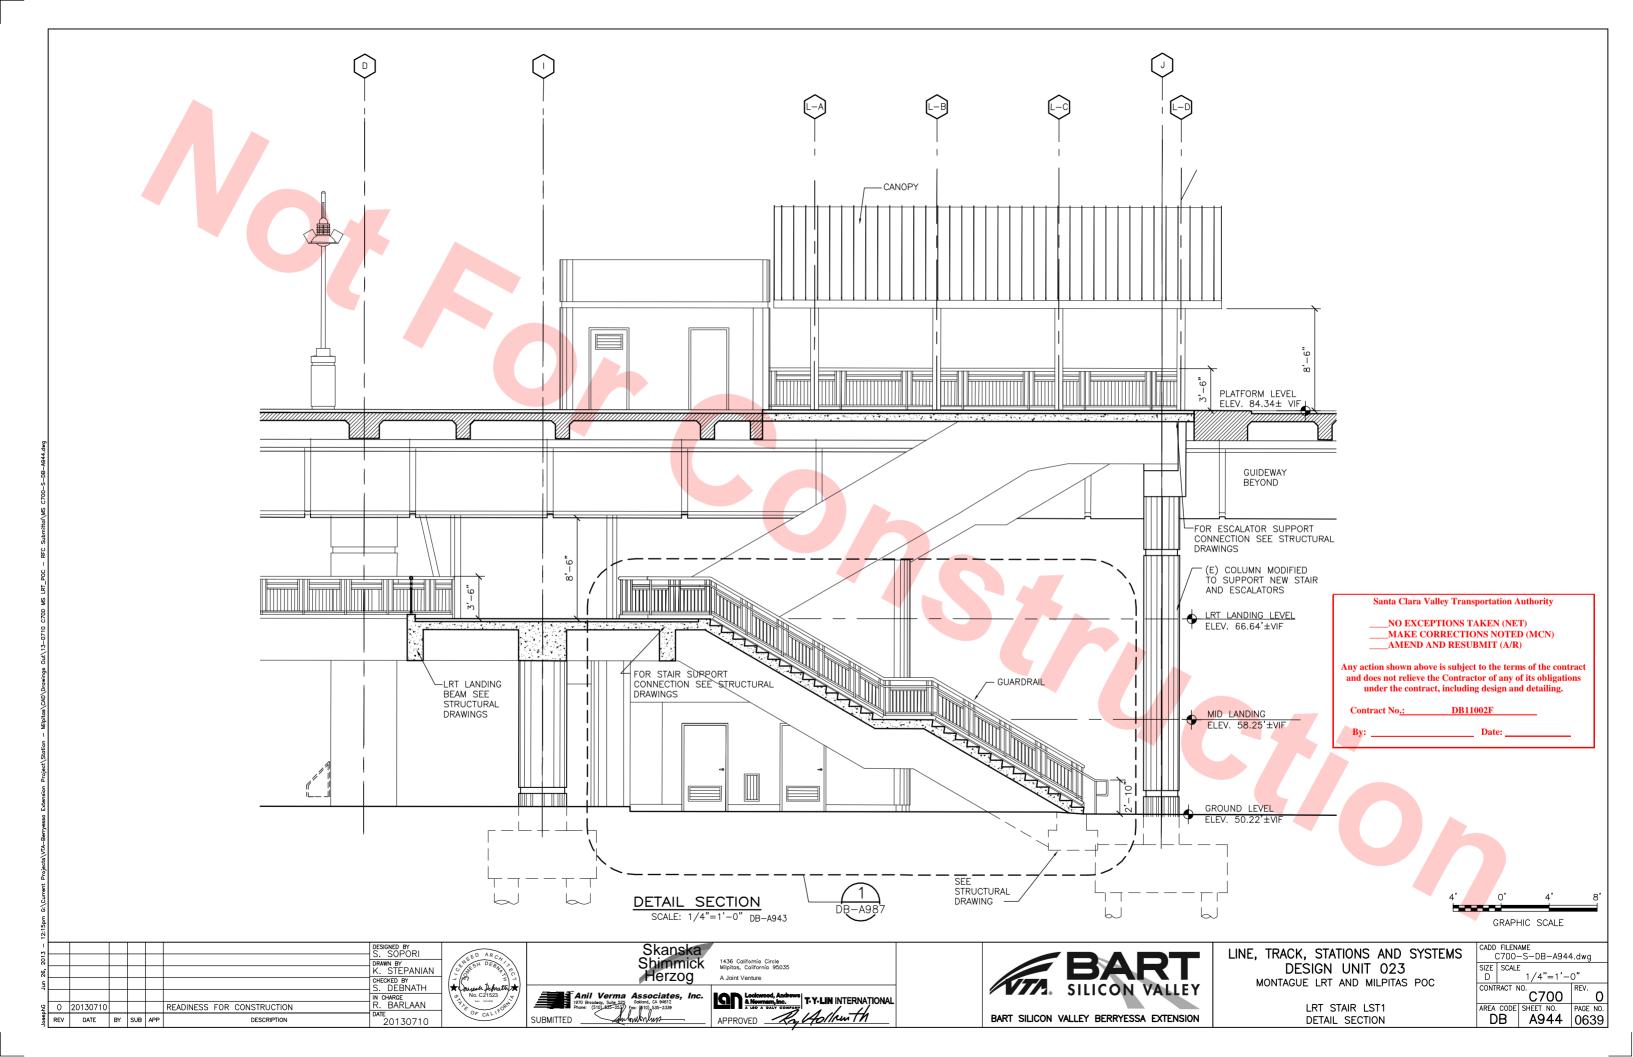


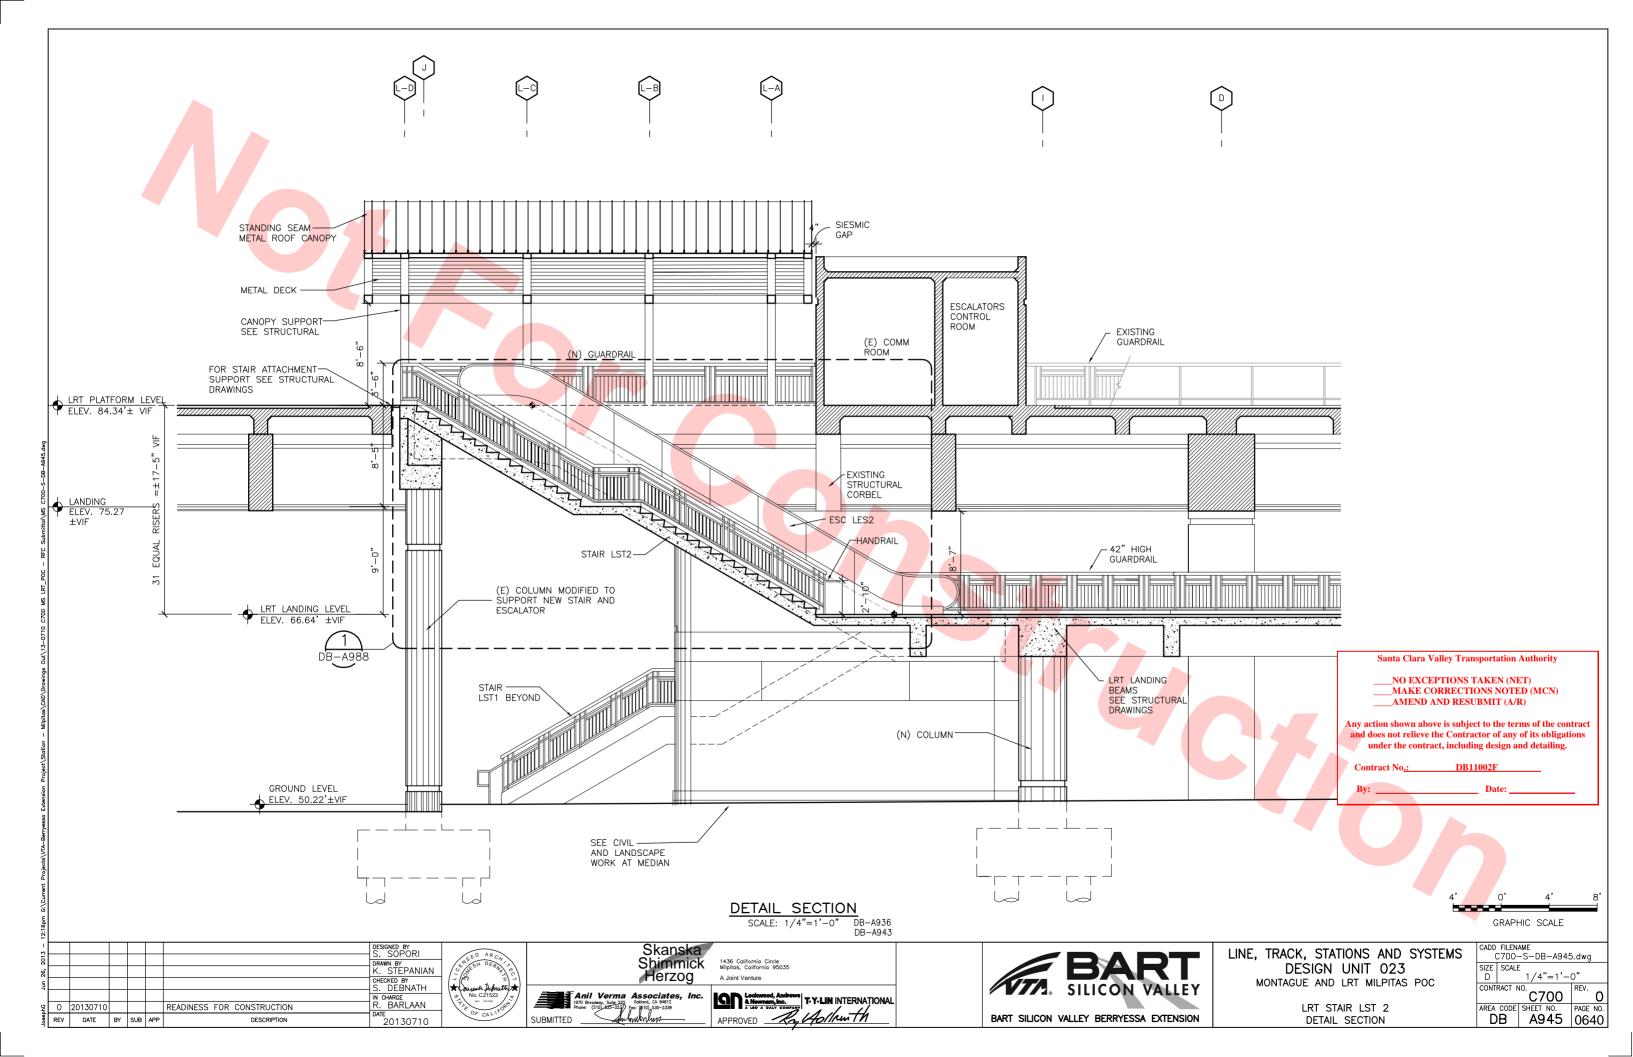


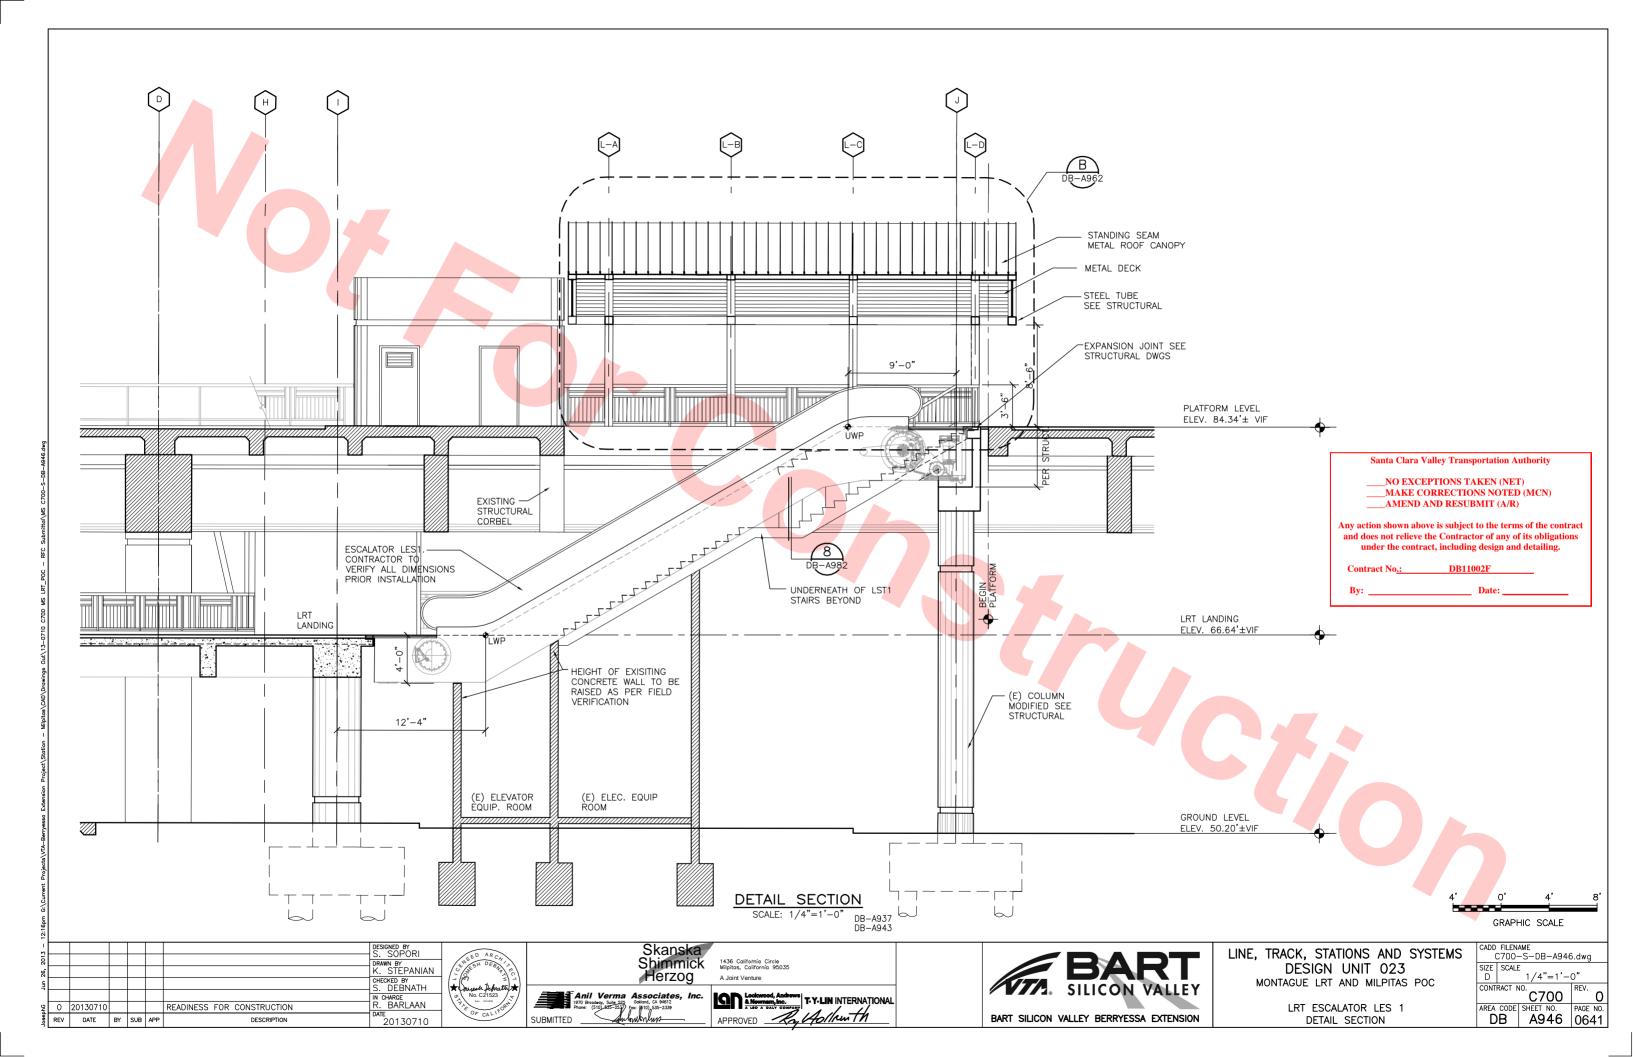


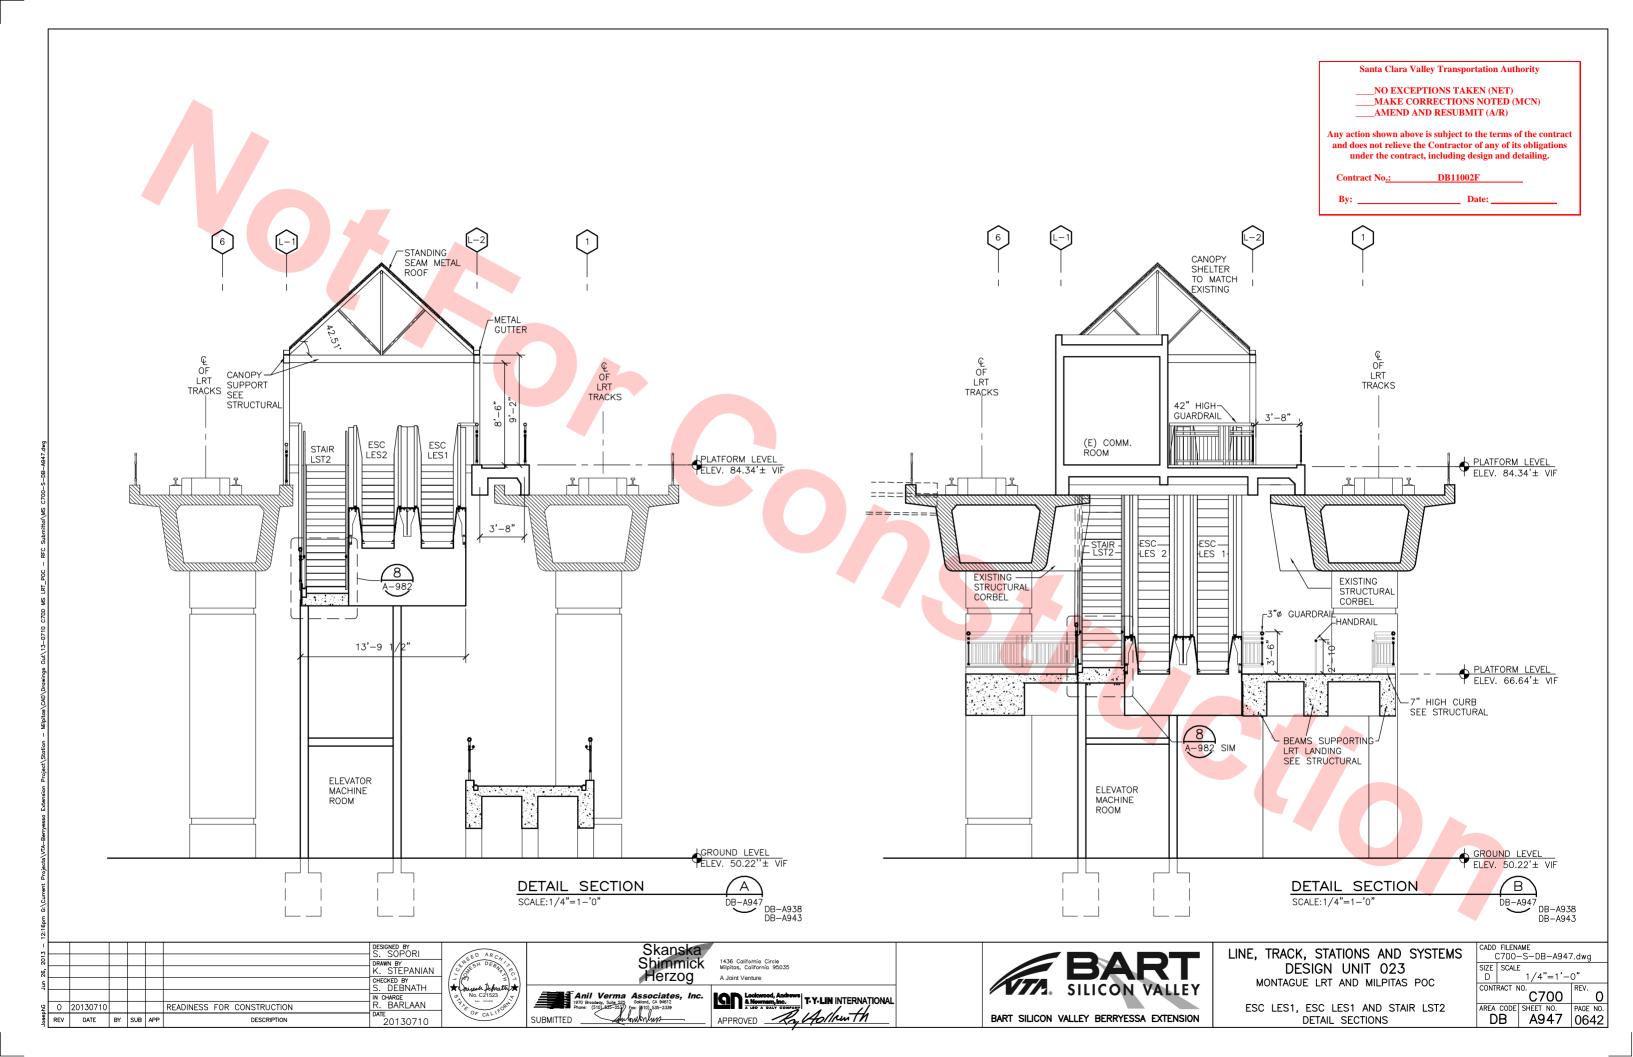


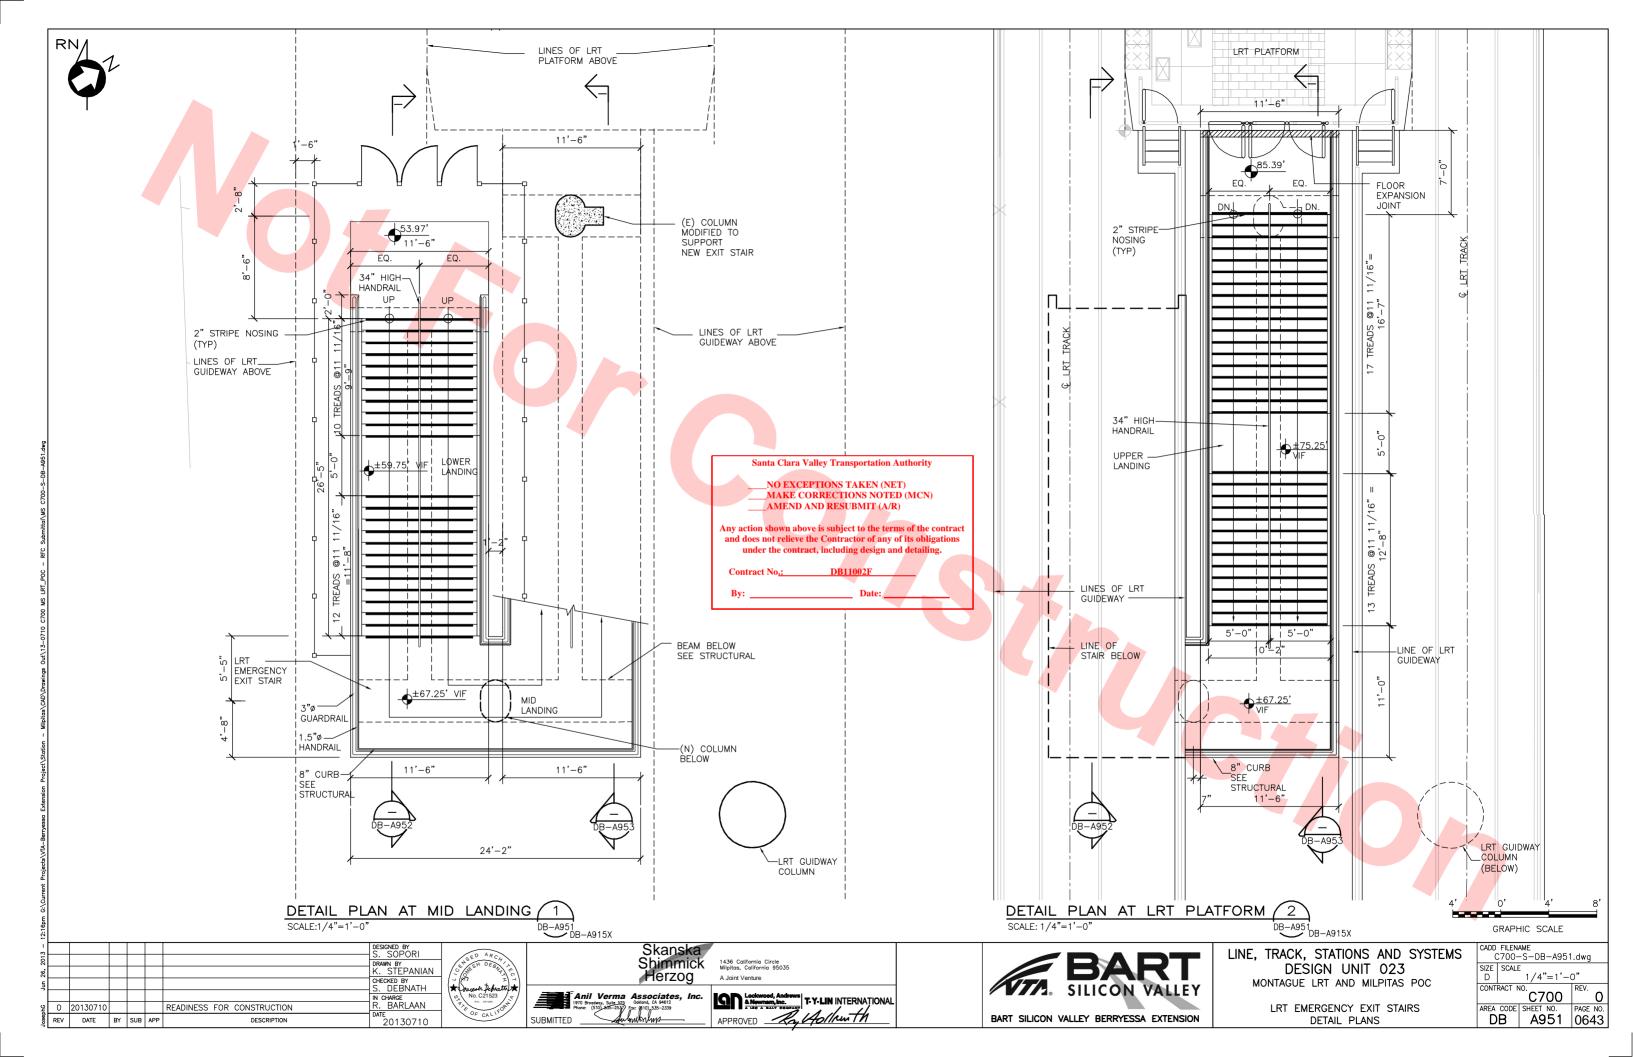

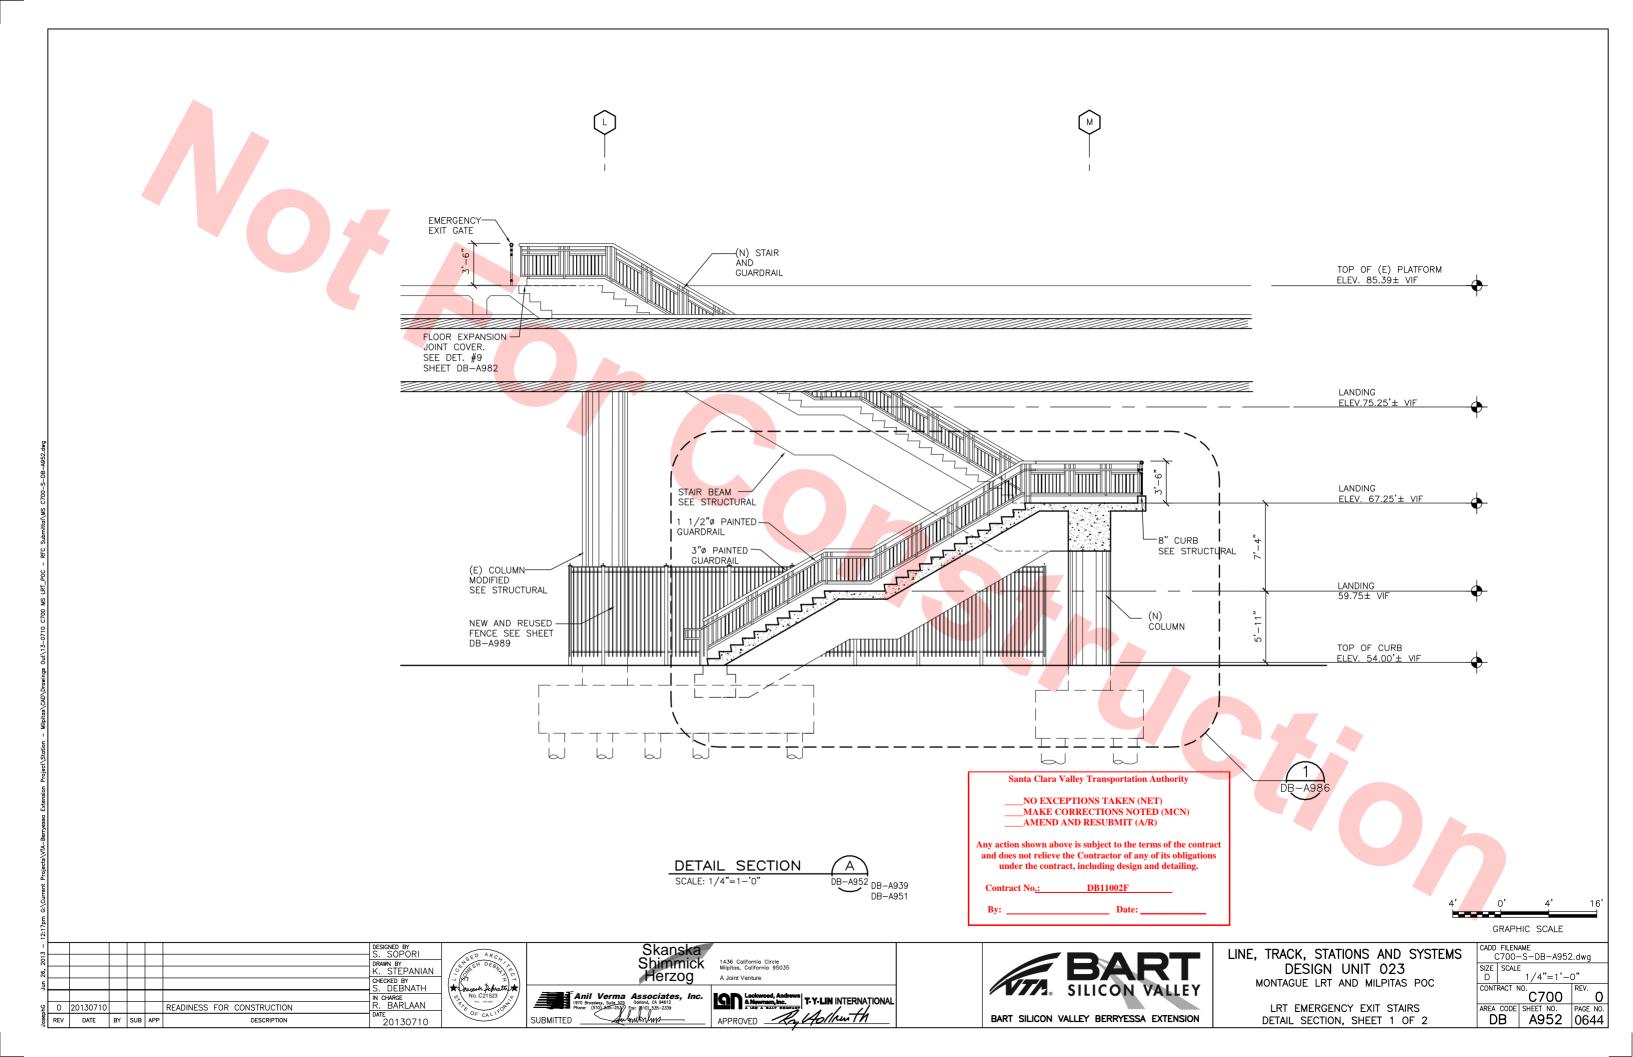

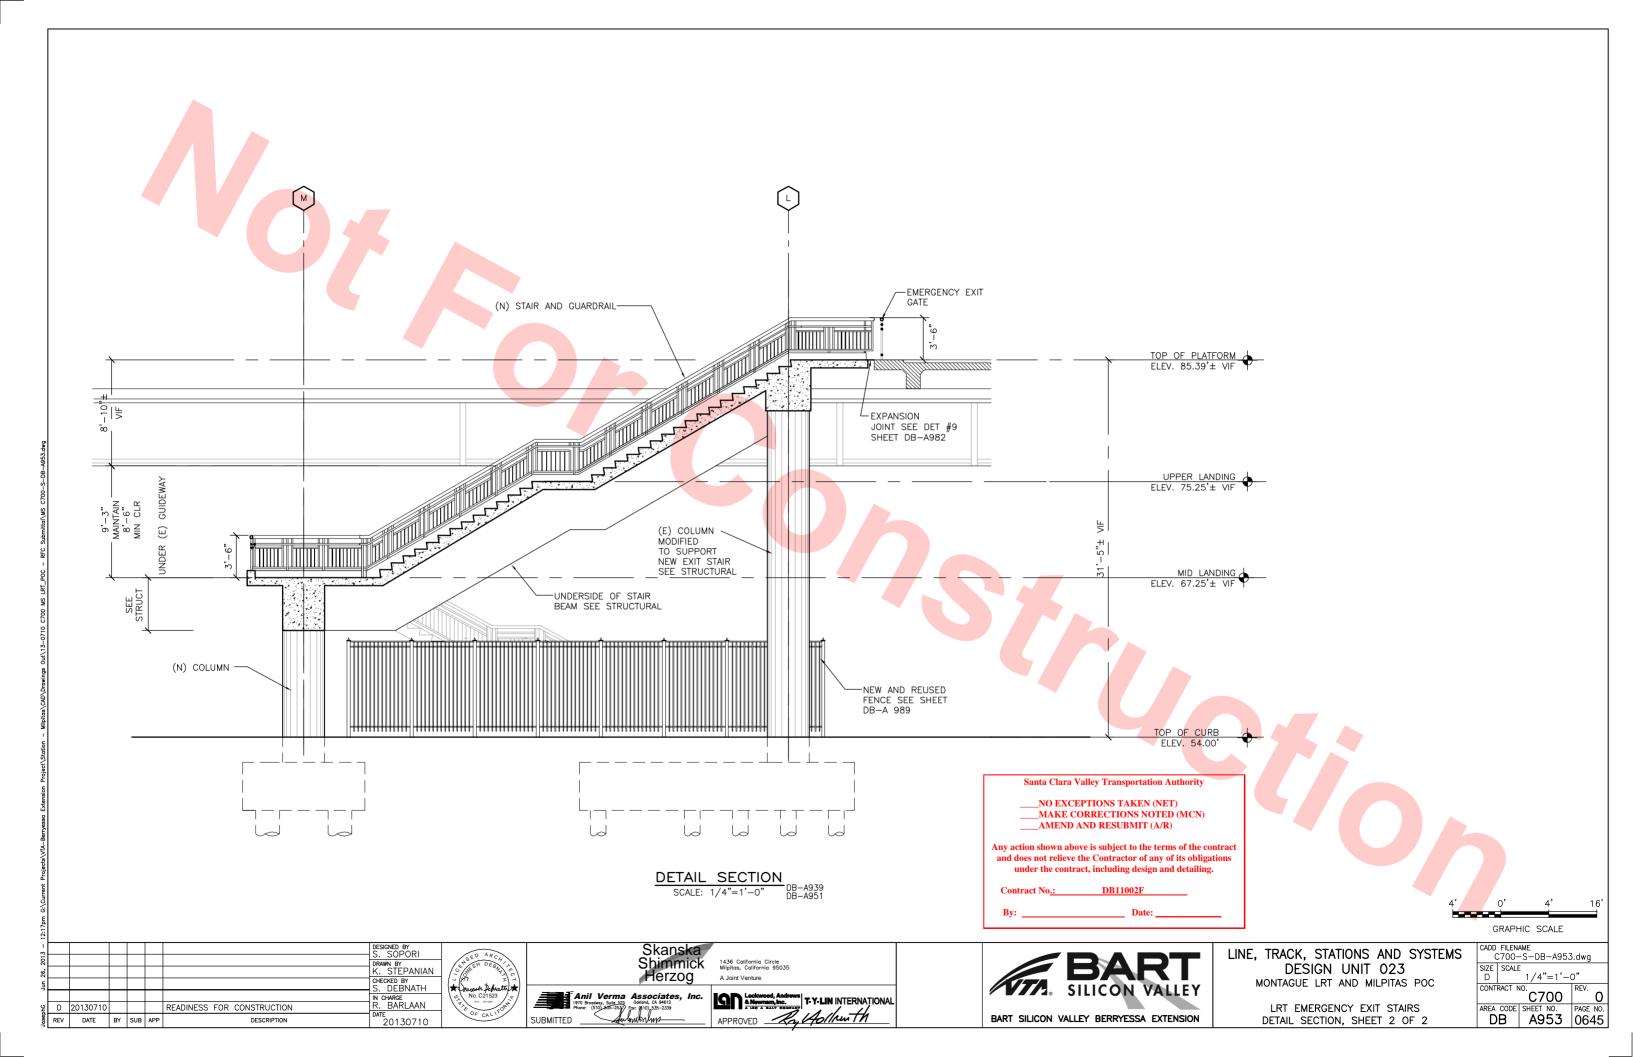

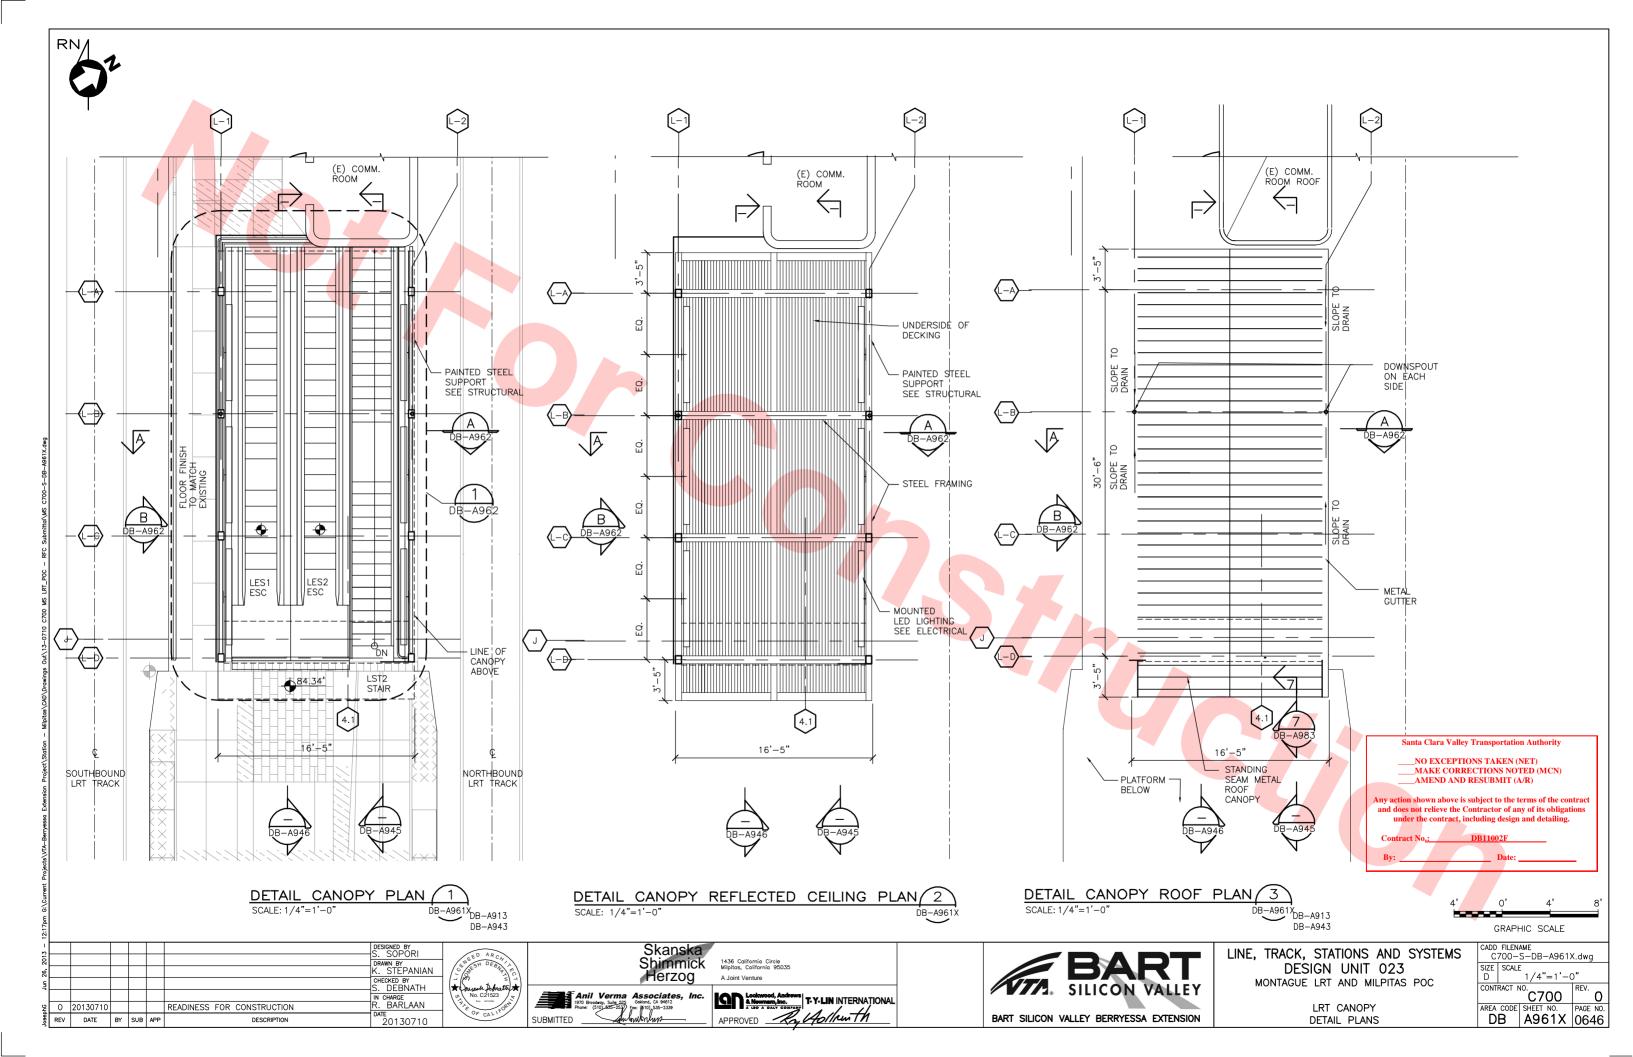

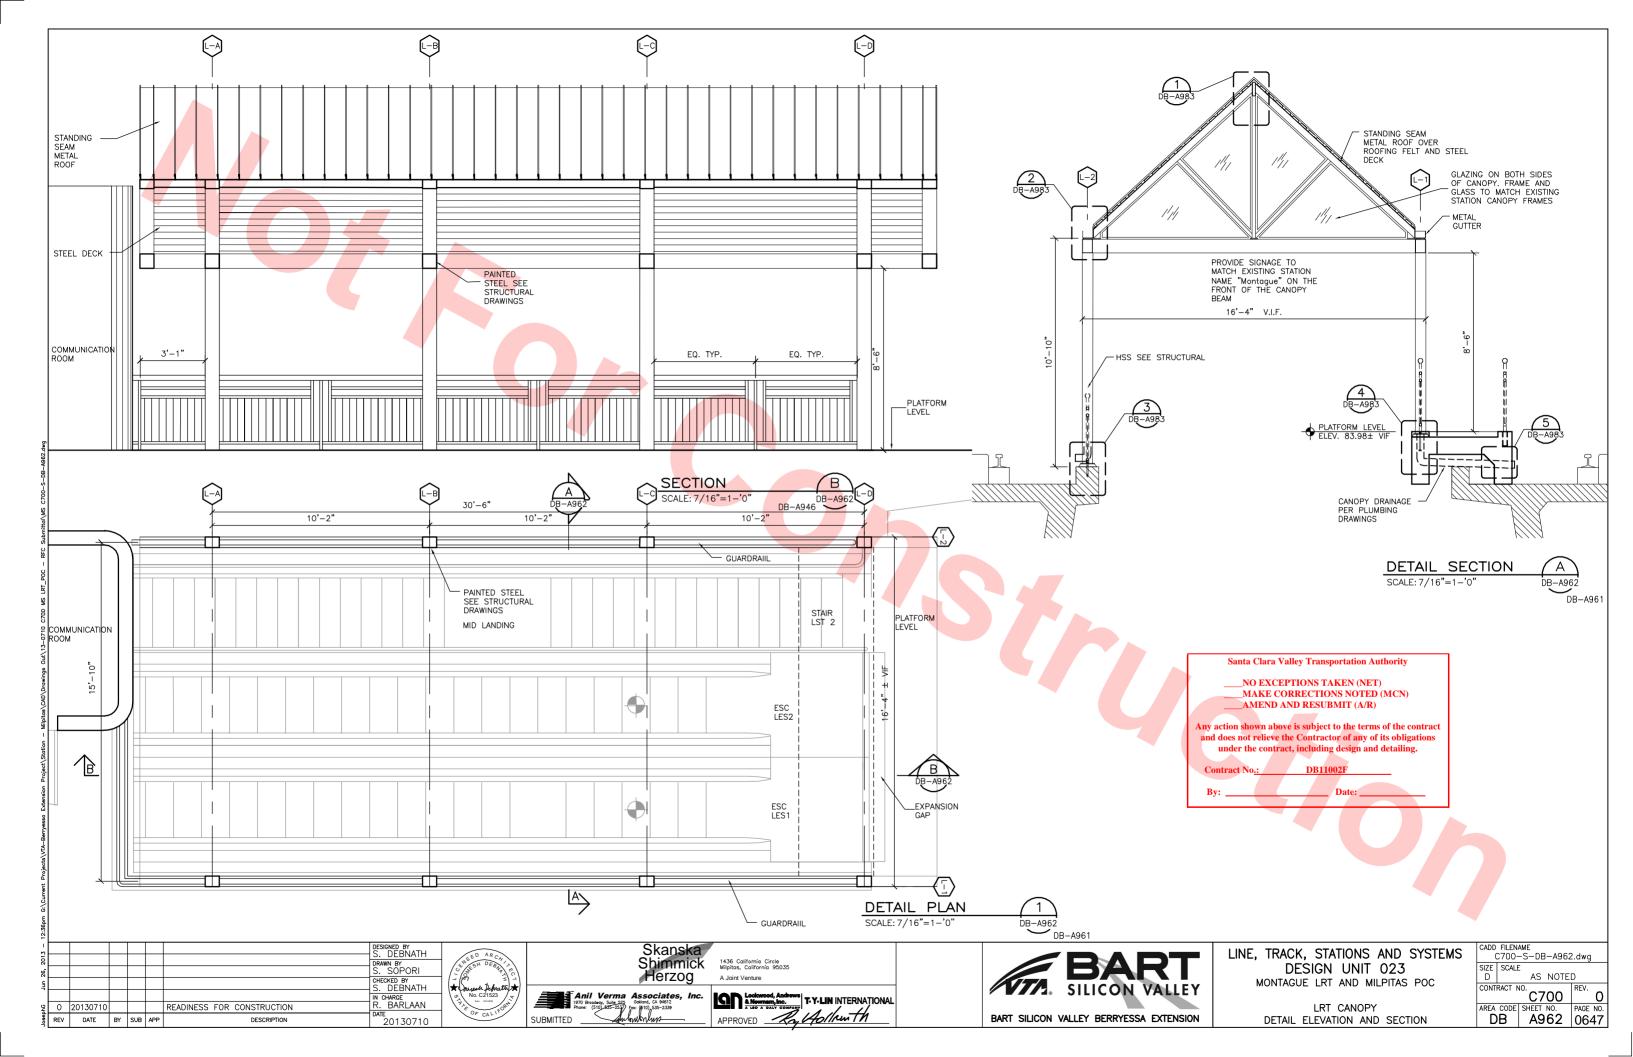

	INTERIOR FINISH SCHEDULE																									
	ROOM	M		FLOOR		WALL							WAINSCOT							CEII	LING	SO	FFIT	25,42,40)		
AREA	NO		SUB	FIN	BASE	NO! MAT	RTH FIN	EA MAT		SO MAT	UTH FIN	MAT		NO MAT		EA MAT		SOU	UTH FIN	MAT	FIN	MAT	FIN	МАТ	FIN	- REMARK(S)
	1	(E) ELEV EQUIPMENT ROOM	_	CONC	-	CONC	_	CONC	_	CONC	_	CONC	_	_	-	-	-	-	_	_	_	-	_	-	_	SHOWN ON DWG DB-A911
	2	(E) ELEC EQUIPMENT ROOM	_	CONC	_	CONC	_	CONC	_	CONC	_	CONC	_	_	_	-	_	_	_	_	_	_	_	_	_	SHOWN ON DWG DB-A911
POC	POC1	PEDESTRIAN OVERCROSSING	CONC	CI-1	-	_	_			_	_	_	-	_	_	_	_	_	_	_	_	EXP	_	EXP	_	4'-0" WIDE METAL VALENCE AT CENTER PAINTED WHITE. PRIME AND PAINT ALL STRUCTURAL ELEMENTS. NO PAINT ON STAINLESS STEEL AND ALUMINUM ELEMENTS. PRIME AND PAINT STANDING SEAM ROOF — COLOR TO MATCH STATION ROOF. VERIFY FINISHES WITH OWNER OR REPRESENTATIVE. HANDRAILS AND GUARDRAILS — PAINT TO MATCH STATION COLORS.
MONTAGUE LRT	3	MONTAGUE LRT	CONC	-	_	-	-	-		-	-	-	-	-	-	-	-	-	-	-	-	-	-	-	-	ALL FINISHES TO MATCH EXISTING FINISHES IN COLOR, TEXTURE, AND QUALITY U.N.O.
≥																										
											-															
												_														

NOTES:

- 1. SEE DWG DB-A701 FOR FINISH CODES AND NOTES.
- 2. SEE DWG DB-A701 FOR FINISHES ABBREVIATIONS.

Santa Clara Valley Transportation Authority

___NO EXCEPTIONS TAKEN (NET)
___MAKE CORRECTIONS NOTED (MCN)
__AMEND AND RESUBMIT (A/R)


Any action shown above is subject to the terms of the contract and does not relieve the Contractor of any of its obligations under the contract, including design and detailing.


Contract No.: DB11002F

· Date

12:18p							
- 51							DESIGNED BY S. SOPORI
26, 201							DRAWN BY K. STEPANIAN
Jun							CHECKED BY S. DEBDATH
							IN CHARGE
ρķ	0	20130710				READINESS FOR CONSTRUCTION	R. BARLAAN
Josep	REV	DATE	BY	SUB	APP	DESCRIPTION	20130710



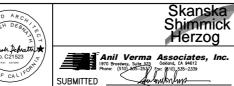

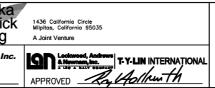






LINE, TRACK, STATIONS AND SYSTEMS
DESIGN UNIT 023
MONTAGUE LRT AND MILPITAS POC


FINISH SCHEDULE


٠		FILEN									
S	C700-S-DB-A971.dwg										
	SIZE	SCALE		,							
	D NONE										
	CONT	10.	REV.								
		C700	0								
	AREA	CODE	SHEET NO.	PAGE NO.							
	D	В	A971	0648							

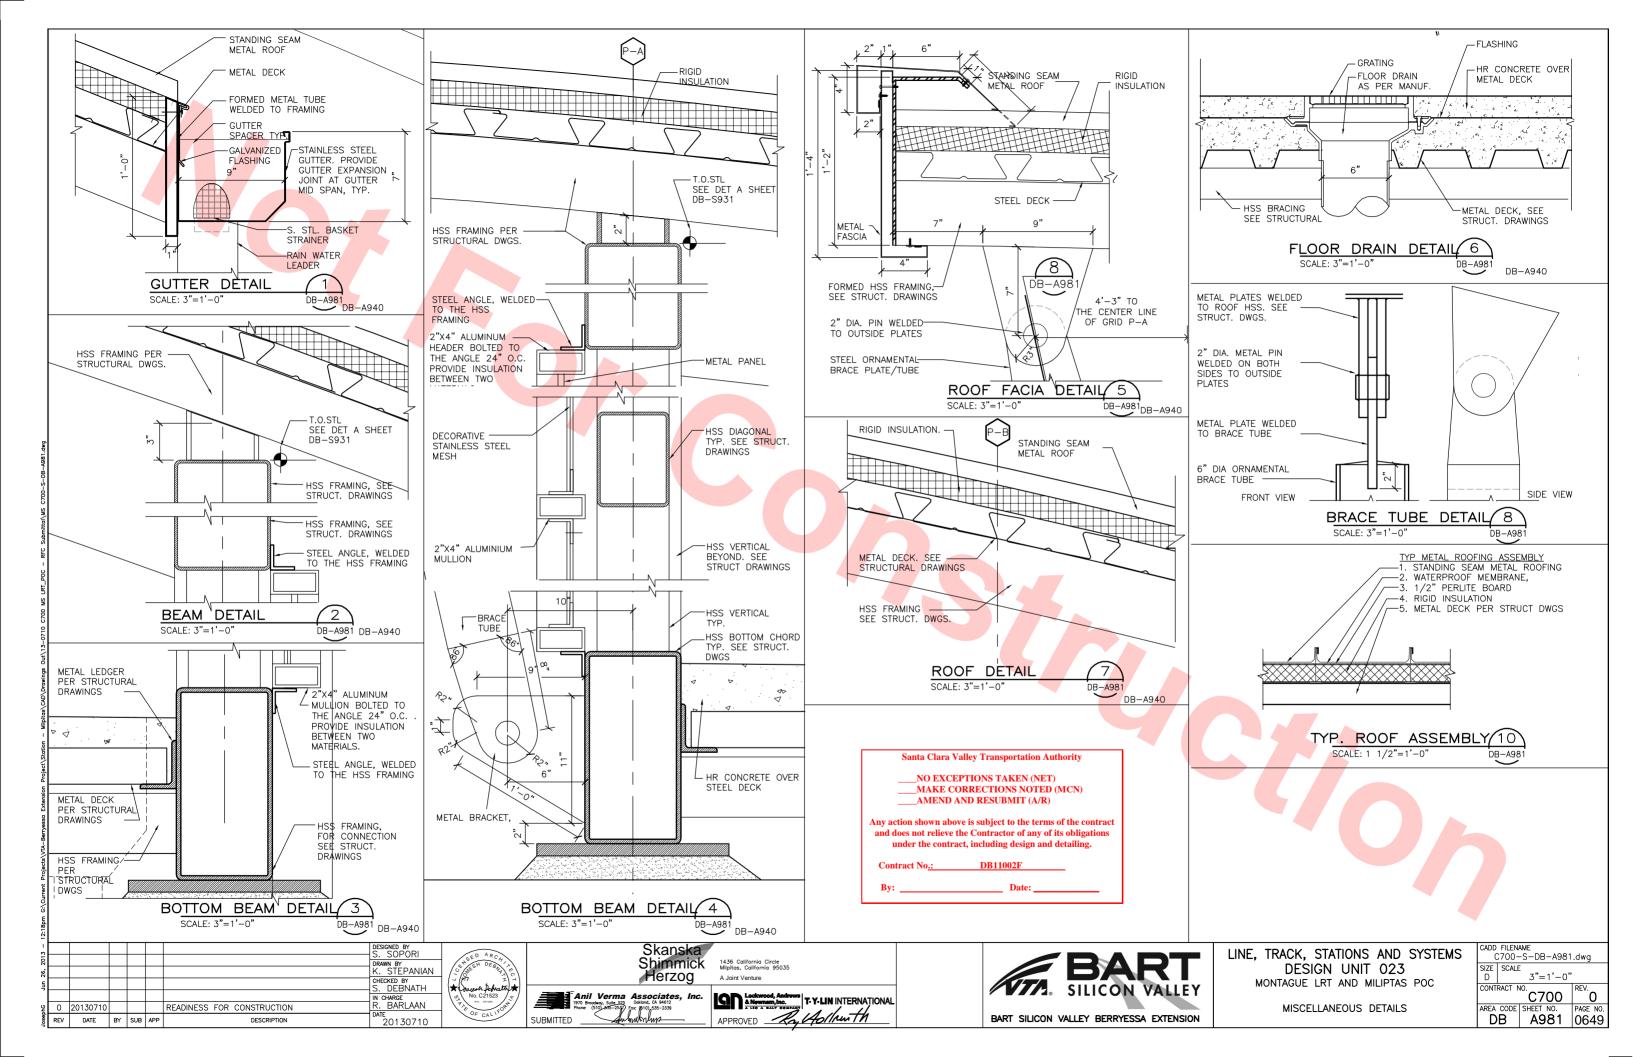


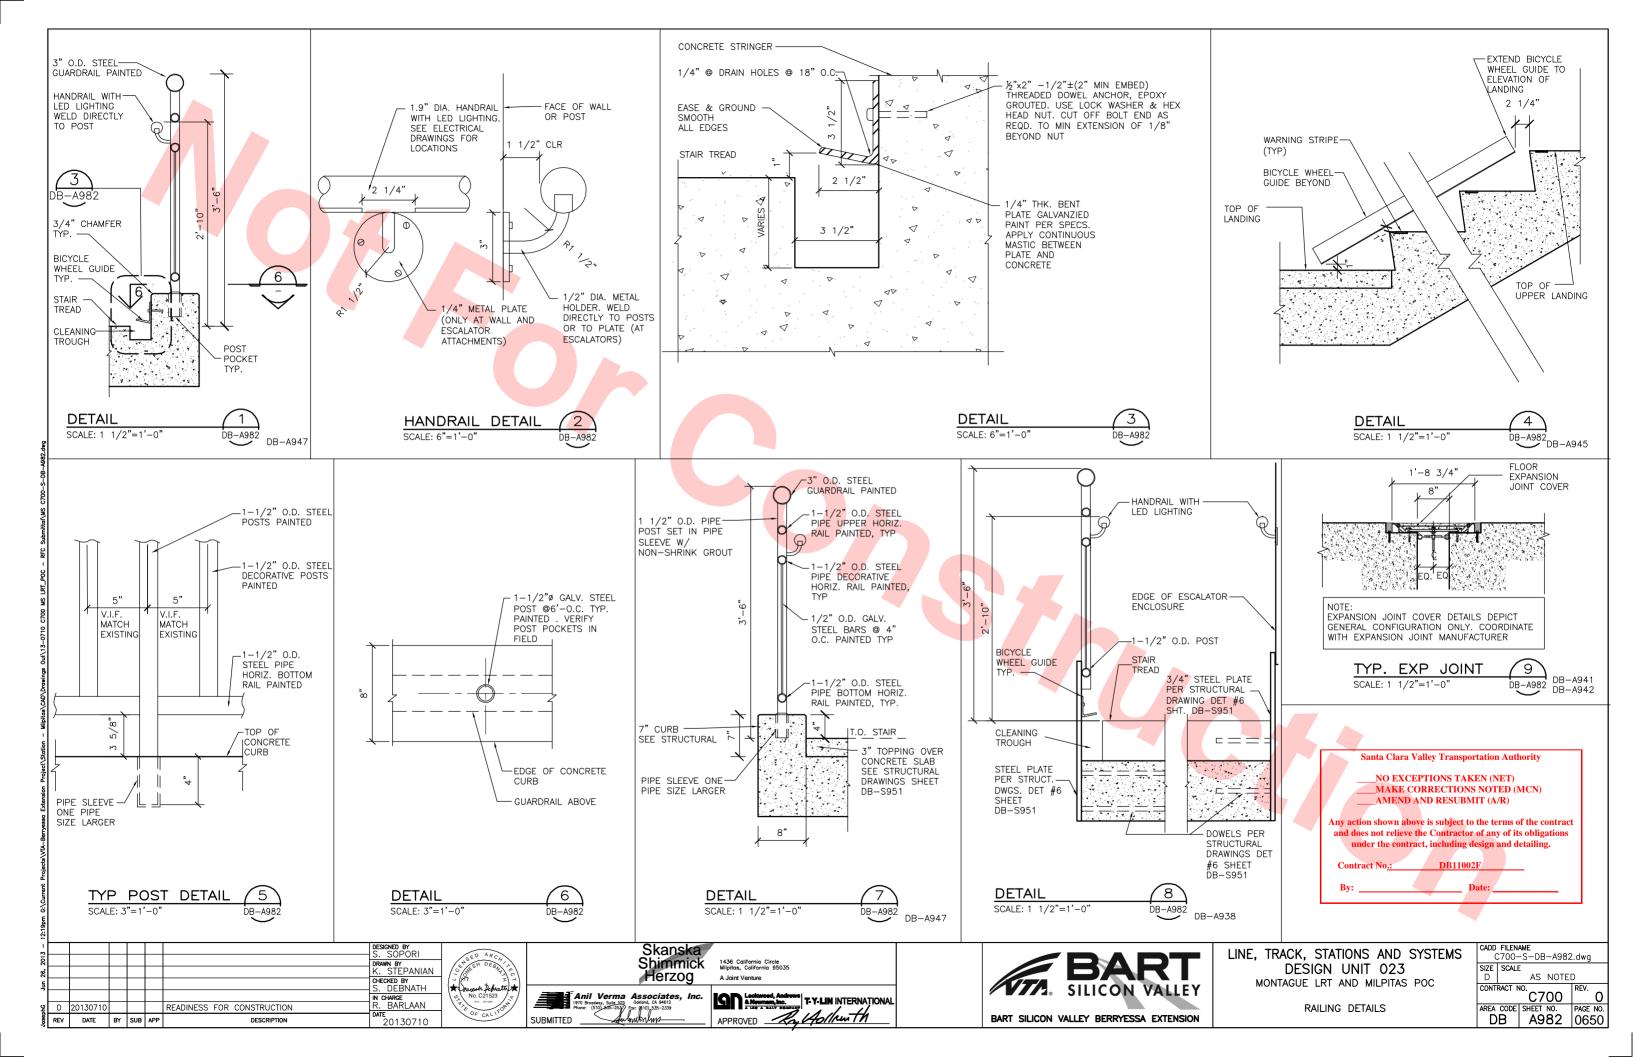

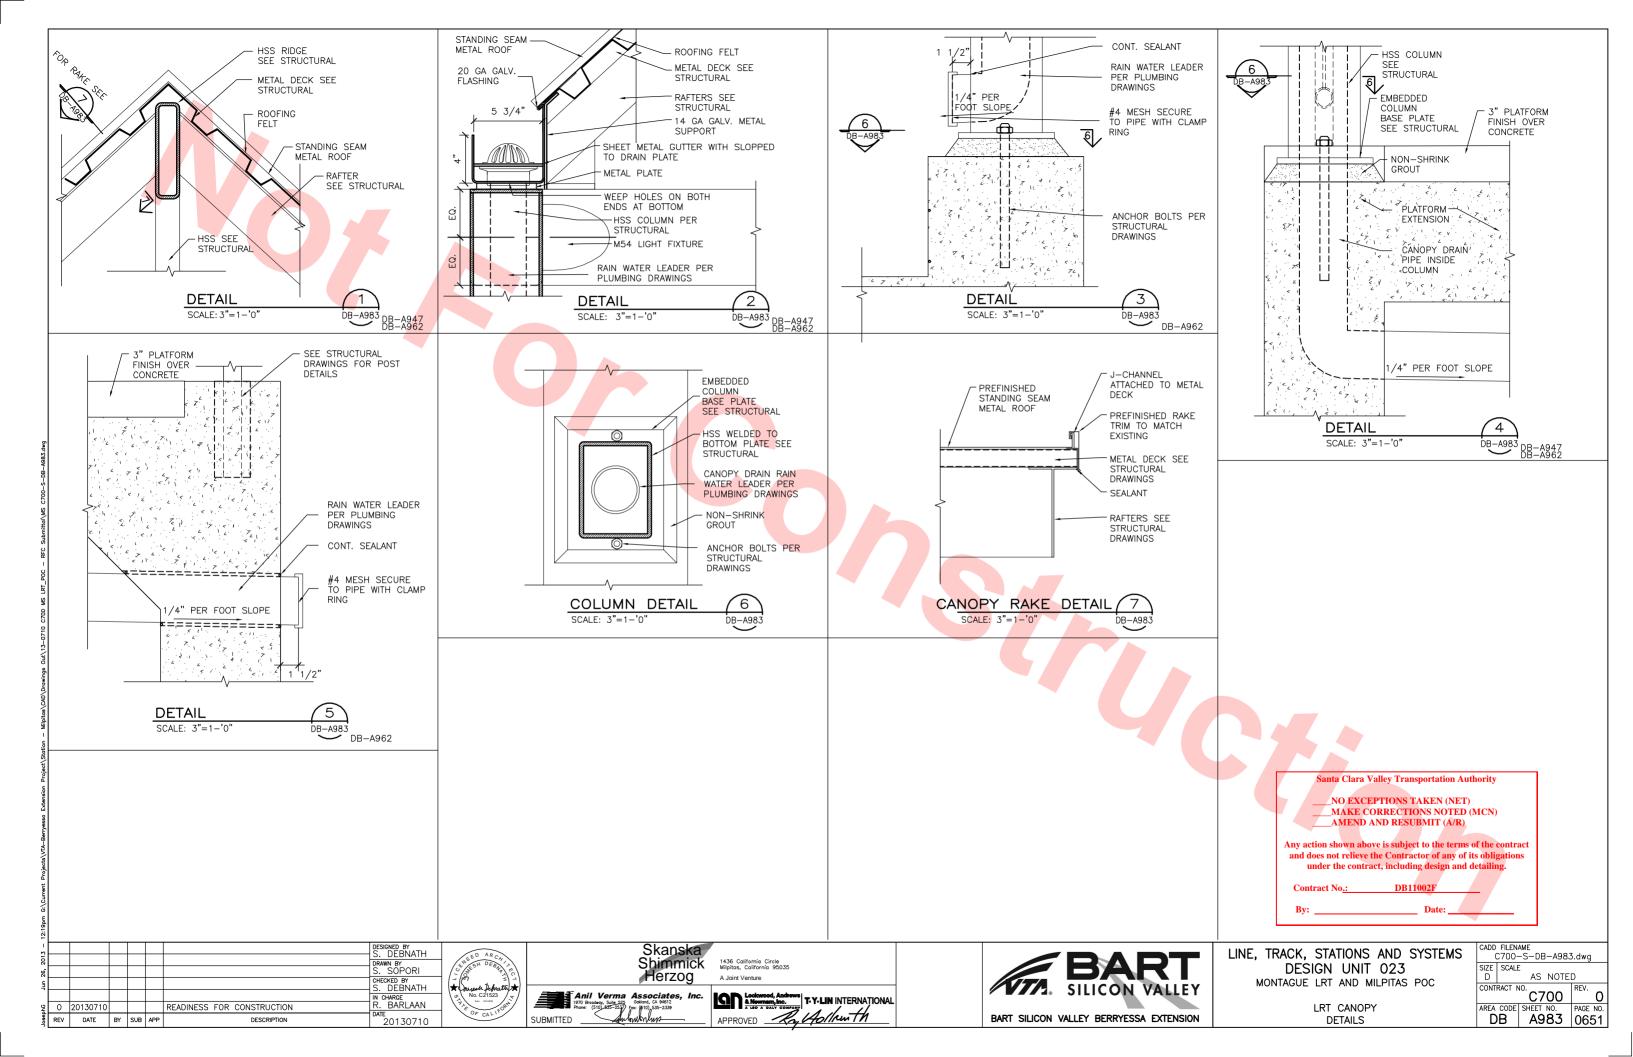

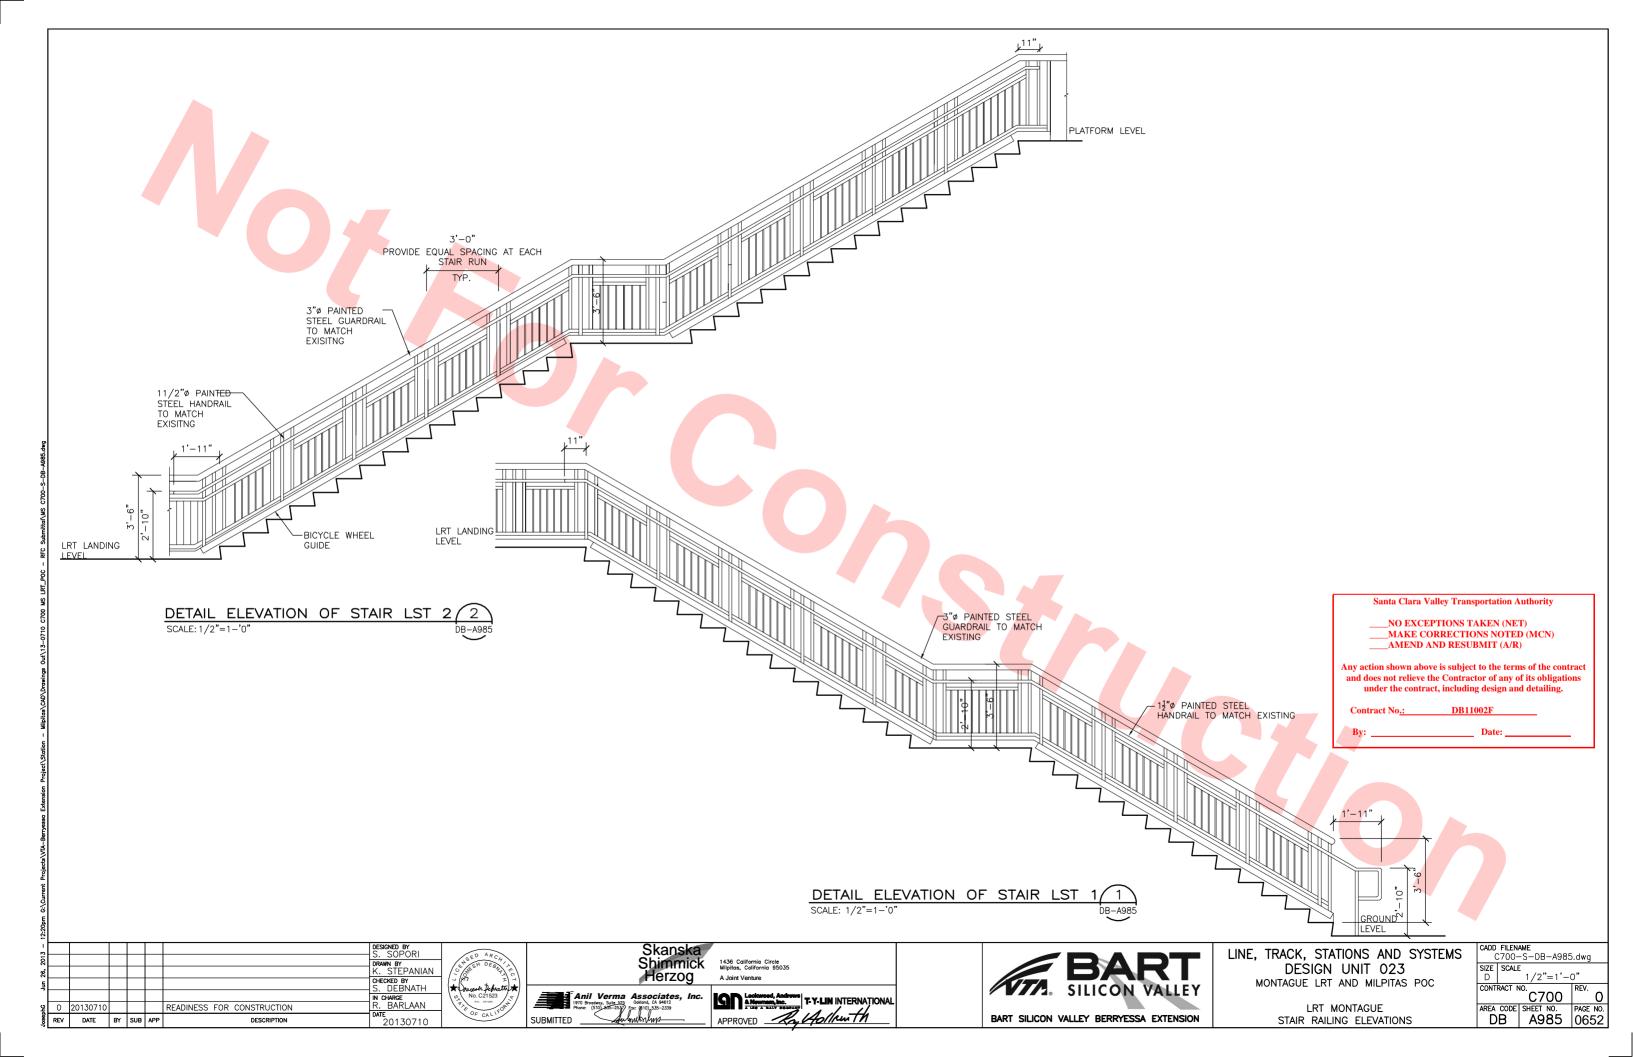

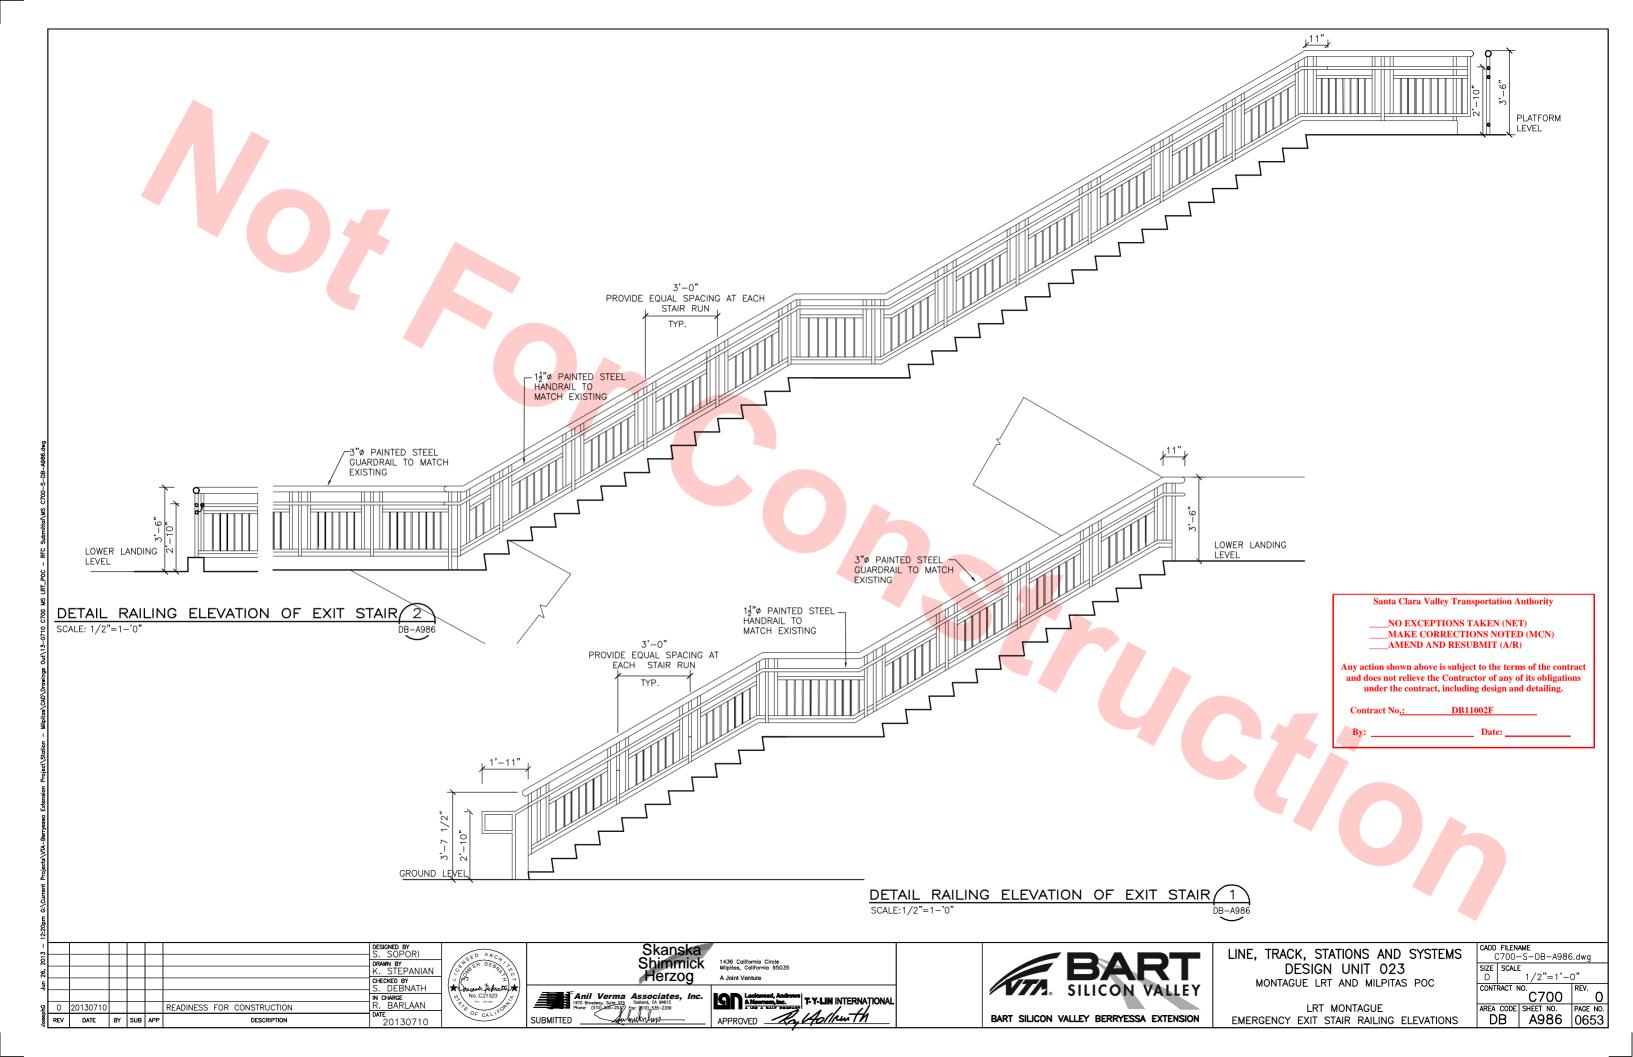

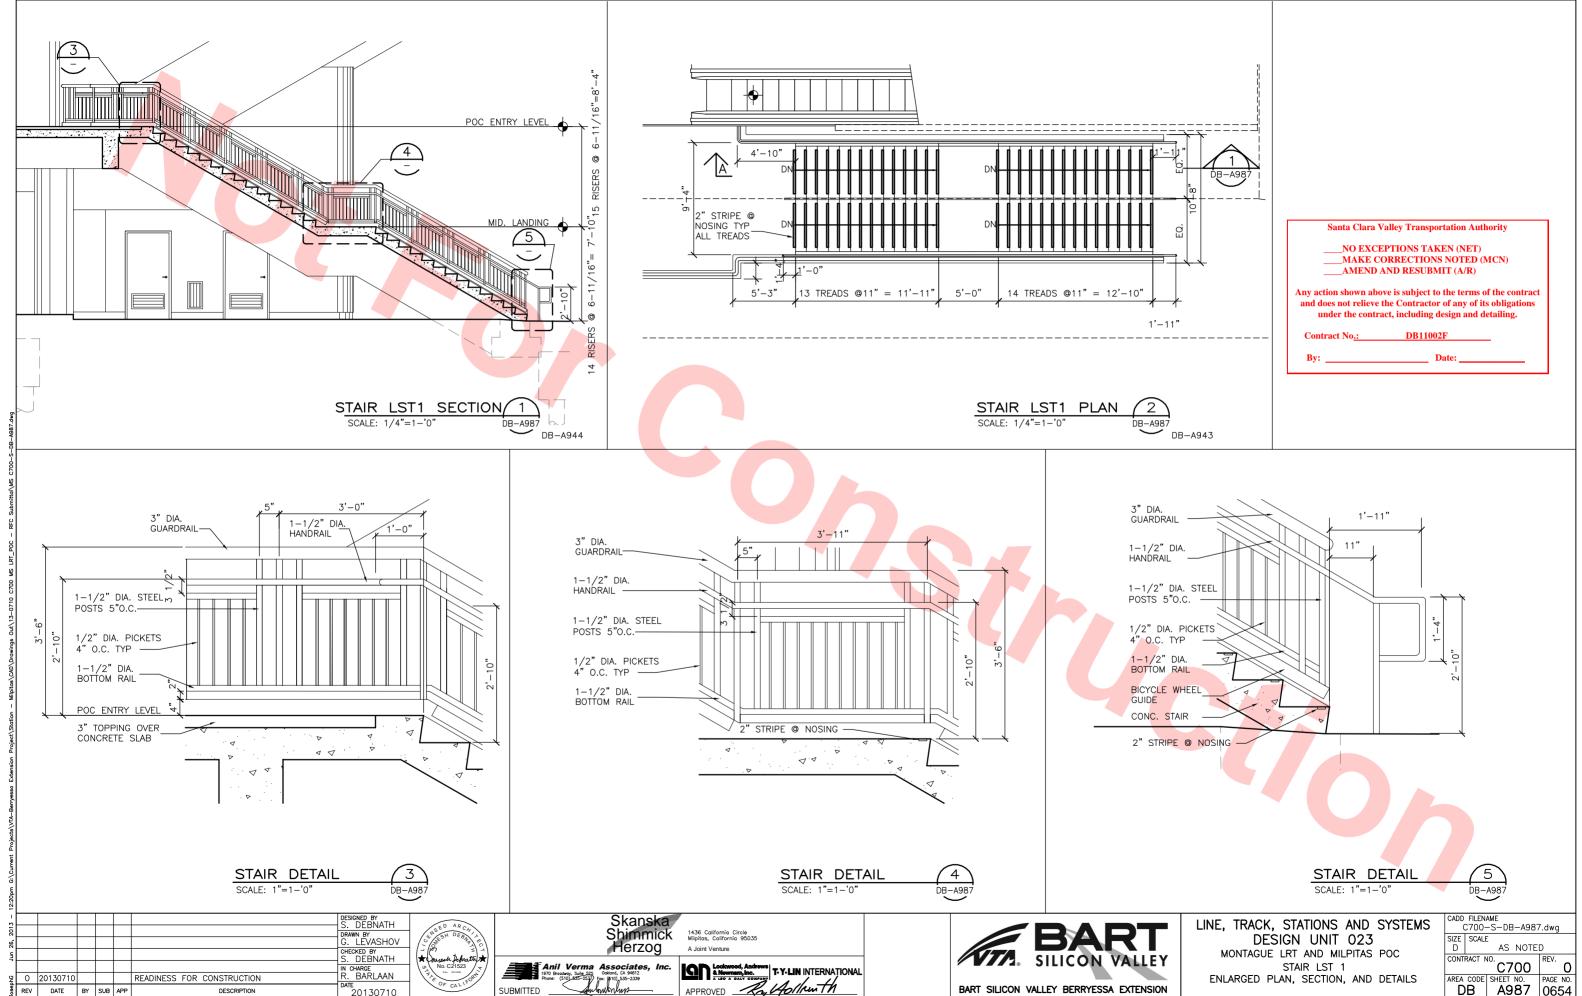

APPROVED

SUBMITTED

20130710

REV DATE BY SUB APP

AREA CODE SHEET NO. PAGE NO. DB A987 0654

ENLARGED PLAN, SECTION, AND DETAILS

BART SILICON VALLEY BERRYESSA EXTENSION

