



SSH JV

Milpitas Station Design Unit 023 Readiness for Construction Mechanical

SVBX C700

Wednesday, July 10, 2013

HALF SIZE
COPY



TYLIN INTERNATIONAL
engineers | planners | scientists

ABBREVIATIONS										GENERAL NOTES																			
<div>A AA AC ACD ACU AD AF AFF AHU AI AL AMB ANSI AO AP APD APPROX ARCH ASTM AVG</div>					<div>F FAR FCO FD FDP FLA FLEX FLR FPM FPS FS FSC FSD FT FV GA GAL GALV GND GPM GV HB HC HD HDN HI HORIZ HP HR HT HTG HSPF HVAC HWR HWS HZ ID IE IN INSUL INWC IPS IW KW L LAV LBS LCP LR LRA MAX MCA MCC MCP MFR MIN MISC MS MT (N) N/A NC NIC NK NO NOM NTS OA OD OFD</div>					<div>OPER OV PC PD PH PLBG POC PRESS PS PSI PSIG PVC QTY QUANTITY R RA RD RECT REF REQ'D REV RL RLA RM RPM RS RWL S SA SAR SCH SD SF SHC SHR SIM SMS SOL SP SPDT SPWG SQ SQ FT SS SSK STD T T&P TD TEMP TG THK THRU TP TSP TSTAT TV TYP UB UC UG UH UL UR V VB VD VEL VERT VFD VOL VT</div>					<div>VTR W W/ W/O WC W.C. WCO WEG WG WH WHA WMS WRG WSR WT WTG WASTE, OVERALL WIDTH WITH WITHOUT WATER CLOSET WATER COLUMN WALL CLEAN OUT WALL EXHAUST GRILLE WATER GAUGE WATER HEATER WATER HAMMER ARRESTOR WIRE MESH SCREEN WALL RETURN GRILLE WALL SUPPLY REGISTER WEIGHT WALL TRANSFER GRILLE</div>					<div>1. ENTIRE INSTALLATION SHALL CONFORM TO THE REQUIREMENTS OF THE 2010 CALIFORNIA BUILDING, PLUMBING, MECHANICAL AND CALGREEN (TIER 1) CODES AND ALL OTHER APPLICABLE CODES AND REGULATIONS, INCLUDING 2008 CALIFORNIA ENERGY CONSERVATION STANDARDS DIVISION T-20, 2. PRIOR TO OCCUPANCY THE ENTIRE HVAC SYSTEMS SHALL BE BALANCED IN ACCORDANCE WITH ASSOCIATED AIR BALANCE COUNCIL (AABC) OR NATIONAL ENVIRONMENTAL BALANCING COUNCIL (NEBB) STANDARDS. 3. PLATFORMS, CURBS AND FLASHING FOR MECHANICAL EQUIPMENT SHALL BE AS INDICATED ON THE STRUCTURAL AND ARCHITECTURAL PLANS, UNLESS NOTED OTHERWISE. 4. EQUIPMENT, ACCESSORIES AND RELATED PIPING SHALL BE INSTALLED IN STRICT ACCORDANCE WITH THE EQUIPMENT MANUFACTURER'S RECOMMENDATIONS. PROVIDE ALL FITTINGS, TRANSITIONS, DAMPERS, VALVES, AND OTHER DEVICES REQUIRED FOR A COMPLETE WORKABLE INSTALLATION. 5. MAINTENANCE LABEL SHALL BE AFFIXED TO ALL MECHANICAL EQUIPMENT AND A MAINTENANCE MANUAL SHALL BE PROVIDED FOR THE OWNER'S USE. LABEL SHALL IDENTIFY THE UNIT DESIGNATION PER PLANS AND THE SPACE IT SERVES. SEE PLANS AND SPECIFICATIONS FOR IDENTIFICATION STANDARDS. 6. OUTSIDE AIR INTAKES SHALL MEET, AS A MINIMUM, 10' OR CODE REQUIRED CLEARANCES FROM EXHAUST AND PLUMBING VENT OUTLETS. 7. PROVIDE MERV 11 MIN EFFICIENCY THROWAWAY FILTERS FOR AIR CONDITIONING EQUIPMENT SERVING NORMALLY OCCUPIED AREAS. IN ADDITION PROVIDE MERV 14 FILTERS FOR THE TRAIN CONTROL CENTER. SIZES SHALL BE AS RECOMMENDED BY THE MANUFACTURER, UNLESS OTHERWISE SPECIFIED. 8. HVAC EQUIPMENT SHALL HAVE TEMPORARY FILTERS IN PLACE DURING CONSTRUCTION AND SHALL BE REPLACED WITH NEW FOR FINAL AIR BALANCING. SYSTEMS SHALL BE AIR BALANCED WITH FILTERS IN PLACE AND AN ARTIFICIAL LOAD FOR DIRTY FILTERS: 8.1. 0.5 INWC FOR SYSTEMS WITH MERV 11 FILTERS 8.2. 1.5 INWC FOR SYSTEMS WITH BOTH MERV 11 AND MERV 14 FILTERS 8.3. EXCEPTIONS – 0.25 INWC AT SYSTEMS EF-1, EF-2, EF-9, EF-10. 9. AIR FILTERS SHALL BE STATE FIRE MARSHALL APPROVED AND LISTED, PREFORMED FILTERS HAVING COMBUSTIBLE FRAMING SHALL BE TESTED AS A COMPLETE ASSEMBLY. AIR FILTERS SHALL BE ACCESSIBLE FOR CLEANING OR REPLACEMENT. 10. EQUIPMENT WITH MOVING PARTS SHALL BE PROVIDED WITH FLEXIBLE DUCT AND PIPE CONNECTIONS. 11. HVAC EQUIPMENT SHALL BE CERTIFIED BY THE CALIFORNIA ENERGY COMMISSION TO COMPLY WITH THE LATEST EFFICIENCY STANDARDS. 12. AIR HANDLING EQUIPMENT SERVING CONDITIONED SPACES SHALL PROVIDE CONTINUOUS OUTSIDE AIR TO SPACES IN OCCUPIED MODE. 13. DUCTWORK, PIPING, CONDUIT, ETC. PENETRATING FIRE RATED CONSTRUCTION SHALL HAVE APPROVED FIRE STOPPING. 14. AIR CONDITIONING UNIT THERMOSTATS SHALL BE OF THE ELECTRONIC, PROGRAMMABLE, AUTOMATIC CHANGEOVER TYPE TO SEQUENCE HEATING OR COOLING. SET POINT RANGE SHALL BE 10F BETWEEN FULL HEATING AND COOLING. THEY SHALL HAVE CAPABILITY OF TERMINATING ALL HEATING AT A TEMPERATURE NO MORE THAN 70°F, AND COOLING AT A TEMPERATURE NOT LESS 78°F. ADJUSTABLE TEMPERATURE DIFFERENTIAL SHALL BE 1½°F. CONTROL LIMITS SHALL BE FROM 55°F TO 85°F. MOUNT TOP OF BOX AT NO MORE THAN 48 INCHES ABOVE FLOOR OR AS REQUIRED BY LOCAL AUTHORITIES FOR HANDICAP CODES. 15. CONTROLS SHALL BE PROVIDED TO PROVIDE THE MINIMUM RATE OF OUTDOOR AIR REQUIRED BY THE STATE ENERGY REGULATIONS. 16. DUCTWORK SHALL BE SHEET METAL CONSTRUCTED OR SPIRAL, ERECTED, AND TESTED IN ACCORDANCE WITH THE MOST RESTRICTIVE OF LOCAL REGULATIONS, PROCEDURES DETAILED IN THE ASHRAE HANDBOOK OF FUNDAMENTALS, CHAPTER 6 OF THE CALIFORNIA MECHANICAL CODES, OR THE APPLICABLE STANDARDS ADOPTED BY (SMACNA) SHEET METAL AND AIR CONDITIONING CONTRACTORS NATIONAL ASSOCIATION. 17. AT THE TIME OF ROUGH INSTALLATION OR DURING STORAGE ON THE CONSTRUCTION SITE AND UNTIL FINAL STARTUP OF THE HEATING AND COOLING EQUIPMENT, ALL DUCT AND OTHER RELATED AIR DISTRIBUTION COMPONENT OPENINGS SHALL BE COVERED WITH TAPE, PLASTIC, SHEET METAL OR OTHER METHODS ACCEPTABLE TO THE ENFORCING AGENCY TO REDUCE THE AMOUNT OF DUST OR DEBRIS WHICH MAY COLLECT IN THE SYSTEM. 18. PROVIDE SEISMIC RESTRAINTS TO ALL DUCTWORK, PIPE, AND EQUIPMENT SUPPORTS IN ACCORDANCE WITH THE LATEST SMACNA GUIDELINES FOR SEISMIC RESTRAINT OF MECHANICAL SYSTEMS. SUSPENDED EQUIPMENT SHALL BE PROVIDED WITH SEISMIC ANCHORAGE AND ISOLATION SUPPORTS. 19. RECTANGULAR DUCT TURNS IN SUPPLY, RETURN, AND EXHAUST DUCTS SHALL HAVE TURNING VANES UNLESS OTHERWISE NOTED. 20. DUCTWORK HANDLING CONDITIONED AIR SHALL BE INSULATED. INTERIOR DUCTWORK SHALL BE INSULATED WITH A THICKNESS OF 2" AND R=4.2. ALL INSULATION SHALL HAVE A FLAME SPREAD OF NOT MORE THAN 25 AND A SMOKE DENSITY NOT EXCEEDING 50. 21. DUCT JOINTS SHALL BE SEALED PER CALIFORNIA MECHANICAL CODE CHAPTER 6 REQUIREMENTS. SEAL CLASS B. 22. MANUAL VOLUME DAMPERS SHALL BE PROVIDED IN ALL DUCT BRANCHES TO INDIVIDUAL DIFFUSERS, GRILLES, AND REGISTERS, AS WELL AS OUTSIDE AIR INTAKE DUCTS. DAMPERS SHALL BE LOCATED AT THE BRANCH DUCT LOCATIONS. THE MECHANICAL CONTRACTOR SHALL COORDINATE LOCATIONS OF DAMPERS WITH THE AIR BALANCING CONTRACTOR. IN LOCATIONS WHERE THESE DAMPERS ARE INACCESSIBLE, CABLE OPERATED ADJUSTMENT CONTROLS SHALL BE PROVIDED. 23. SMOKE DAMPERS SHALL BE CONTROLLED BY SMOKE DETECTORS FURNISHED AND INSTALLED BY FIRE ALARM CONTRACTOR. DUCT MOUNTED SMOKE DETECTORS SHALL BE FURNISHED BY FIRE ALARM CONTRACTOR AND INSTALLED BY MECHANICAL CONTRACTOR. ALL POWER AND SIGNAL WIRING FOR ALARM SYSTEM SHALL BE FURNISHED AND INSTALLED BY FIRE ALARM CONTRACTOR. INTERLOCK FOR SHUT DOWN CONTROLS SHALL BE BY CONTROLS CONTRACTOR.</div>									
<div><div><div>DESIGNED BY J. CHOU</div><div>DRAWN BY J. CHOU</div><div>CHECKED BY G. HENNINGS</div><div>IN CHARGE G. HENNINGS</div><div>DATE 20130710</div></div><div><div><div>Skanska Shimmick Herzog</div><div>1436 California Circle Milpitas, California 95035 A Joint Venture</div></div><div><div>Block Construction Inc. 4405 Enterprise St., Fremont, CA 94538 (910) 607-3686 Fax: (910) 607-3686 CA Lic. #679326 email: info@blockinc.com</div><div><div>HM Mechanical Group 8517 Earhart Rd, #230 Oakland, CA 94621 510-569-2000</div><div><div>Lookwood, Andrews & Newnam, Inc. A LEED A BUILT GREENING</div><div>T-Y-LIN INTERNATIONAL</div></div></div></div></div><div><div><div>BART SILICON VALLEY</div><div>BART SILICON VALLEY BERRYESSA EXTENSION</div></div></div><div><div>LINE, TRACK, STATIONS AND SYSTEMS DESIGN UNIT 023 MILPITAS STATION HVAC AND PLUMBING ABBREVIATIONS & GENERAL NOTES</div></div><div><div>CADD FILENAME C700-S-DB-M001.dwg</div><div><div>SIZE D NONE</div><div>CONTRACT NO. C700</div><div>REV. 0</div></div><div><div>AREA CODE DB</div><div>SHEET NO. M001</div><div>PAGE NO. 0658</div></div></div></div>																													

HVAC					HVAC					PLUMBING					CONTROLS				
SYMBOL		DESCRIPTION			SYMBOL		DESCRIPTION			SYMBOL		DESCRIPTION			SYMBOL AND DESCRIPTION				
		DUCT SIZE – FIRST FIGURE IS SIDE SHOWN					SOUND ATTENUATOR					TRAP PRIMER			<div><div>MECHANICAL AND HVAC DEVICES</div><div> BALANCING DAMPER</div><div> N.C. OPPOSED BLADE DAMPER W/ACTUATOR</div><div> DUCT INSERT TEMPERATURE SENSOR</div><div> MISCELLANEOUS DEVICE</div><div> DIFFERENTIAL PRESSURE SWITCH</div><div><div>FIRE ALARM DEVICES (SUPPLIED AND INSTALLED BY MECHANICAL, WIRED BY OTHERS)</div><div> FIRE/SMOKE DAMPER</div><div><div>FIRE ALARM DEVICES (SUPPLIED, INSTALLED AND WIRED BY OTHERS)</div><div> FIRE ALARM RELAY</div></div></div></div>				
		SUPPLY AIR DUCT SECTION					FLEXIBLE DUCT, 5' MAX					BALL VALVE							
		RETURN AIR DUCT SECTION					FAN, CENTRIFUGAL					ELBOW UP			<div><div>ELECTRICAL DEVICES</div><div> MOTOR</div><div> RELAY/HOLDING COIL</div><div> RELAY NORMALLY OPEN CONTACT</div><div> RELAY NORMALLY CLOSE CONTACT</div><div> THERMOSTAT</div><div> DISCONNECT</div><div> XX</div></div>				
		EXHAUST AIR DUCT SECTION					VANE-AXIAL FAN					ELBOW DOWN							
		OUTSIDE AIR DUCT SECTION					EQUIPMENT IDENTIFICATION TAG					AREA DRAIN (AD)							
		ROUND DUCT SECTION					COOLING COIL, DIRECT EXPANSION					CATCH BASIN (CB)							
		MANUAL VOLUME DAMPER					HEATING COIL, ELECTRIC					FLOOR DRAIN (FD)							
		FIRE DAMPER WITH ACCESS PANEL (2 HOUR RATING)					FILTER, DISPOSABLE					HOPPER DRAIN (HDN)							
		DUCT THRU PENETRATION (2 HOUR RATING)					REFRIGERANT DISCHARGE					PLANTER DRAIN (PDN)							
		SPLITTER DAMPER					REFRIGERANT LIQUID					(TYPE AS NOTED) GRATE FREE AREA x OUTLET (EXAMPLE 12x4 = 12 SQ IN x 4 IN GRATE SIZE)							
		ADJUSTABLE EXTRACTOR					REFRIGERANT SUCTION					ROOF DRAIN (TYPE AS NOTED)							
		FLEXIBLE DUCT AND EQUIPMENT CONNECTION					THERMOSTAT					OVERFLOW ROOF DRAIN (TYPE AS NOTED)							
		ELBOW WITH TURNING VANES										WATER HAMMER ARRESTOR							
		TEE WITH TURNING VANES										FLOOR CLEAN OUT							
		CSD = CEILING SUPPLY DIFFUSER SIZE = NECK SIZE CFM = FLOW IN CFM → = DIRECTION OF AIR FLOW, AS SHOWN ON PLAN DRAWINGS										WALL CLEAN OUT							
		CEILING RETURN DIFFUSER-TYPE										EXPANSION JOINT							
		WALL EXHAUST GRILLE										FLEXIBLE PIPE CONNECTOR							
		WALL RETURN GRILLE										GROOVED COUPLING							
		WALL SUPPLY REGISTER										POINT OF CONNECTION							
		WALL TRANSFER GRILLE (TWO-GRILLES)										SEWAGE EJECTOR							
		LOUVER										URINAL							
		DOOR LOUVER										WATER CLOSET (TYPE AS NOTED)							
		ACOUSTICAL LINED DUCT, 2 INCHES UNLESS OTHERWISE NOTED										LAVATORY, WALL HUNG (TYPE AS NOTED)							
		BACK DRAFT DAMPER										DRINKING FOUNTAIN							
		DUCT RISE IN DIRECTION OF AIR FLOW										KITCHEN SINK							
		DUCT DROP IN DIRECTION OF AIR FLOW										MOP SINK, SERVICE SINK							
		RECTANGULAR TO ROUND TRANSITION										SHOWER							
		MOTORIZED DAMPER										WATER HEATER							
		MOTOR										EMERGENCY SHOWER/EYE WASH							
		SMOKE/FIRE DAMPER WITH ACCESS DOOR, 2 HOUR RATING																	
					PLUMBING														
SYMBOL		DESCRIPTION			SYMBOL		DESCRIPTION			SYMBOL		DESCRIPTION							
		COLD WATER (DOMESTIC)					SEWAGE EJECTOR					LAVATORY, WALL HUNG (TYPE AS NOTED)							
		HOT WATER SUPPLY (DOMESTIC)					WATER CLOSET (TYPE AS NOTED)					DRINKING FOUNTAIN							
		HOT WATER RETURN (DOMESTIC)					KITCHEN SINK					MOP SINK, SERVICE SINK							
		COMPRESSED AIR LINE					WATER HEATER					EMERGENCY SHOWER/EYE WASH							
		FUEL OIL DISCHARGE																	
		FUEL OIL RETURN																	
		FUEL OIL SUCTION																	
		INDUSTRIAL WASTE LINE																	
		SANITARY SEWER ABOVE GRADE																	
		SANITARY SEWER BLOW GRADE																	
		WASTE DRAIN ABOVE GRADE																	
		WASTE DRAIN BLOW GRADE																	
		STORM DRAIN ABOVE GRADE																	
		STORM DRAIN BLOW GRADE																	
		VENT																	
		CONDENSATE DRAIN																	
		DIRECTION OF SLOPE, RISE (R), DROP (D)																	
		UNION																	
		BLIND FLANGE																	
		CLEAN OUT																	
		CAP ON END OF PIPE																	
		CHECK VALVE (FLOW ARROW SHOWN)																	
		PRESSURE REGULATOR VALVE																	
		PRESSURE RELIEF VALVE																	
		PRESSURE GAUGE W/GAUGE CLOCK																	
		HOSE BIBB																	
					CONTROLS														
					SYMBOL AND DESCRIPTION														
					SIGNAL/CONTROLS CARRIERS														
					— LINE VOLTAGE WIRING (#14 AWG OR #12 AWG)														
					— LOW VOLTAGE WIRING OR CABLING (#18 AWG)														
					REFERENCES AND TERMINATIONS														

Santa Clara Valley Transportation Authority

NO EXCEPTIONS TAKEN (NET)
MAKE CORRECTIONS NOTED (MCN)
AMEND AND RESUBMIT (A/R)

Any action shown above is subject to the terms of the contract and does not relieve the Contractor of any of its obligations under the contract, including design and detailing.

Contract No.: DB11002F

By: _____ Date: _____

					DESIGNED BY J. CHOU DRAWN BY J. CHOU CHECKED BY G. HENNINGS IN CHARGE G. HENNINGS DATE 20130710				
					READINESS FOR CONSTRUCTION				
					DESCRIPTION				
					20130710				

Skanska Shimmick Herzog

1436 California Circle
Milpitas, California 95035
A Joint Venture

Blocka Construction Inc.
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info@blocka.com


H&M Mechanical Group
8517 Earhart Rd, #230
Oakland, CA 94621
(510) 510-569-2000

Lookwood, Andrews & Nowmann, Inc.
A LEQ A DALY COMPANY

T-Y-LIN INTERNATIONAL

BART SILICON VALLEY BERRYESSA EXTENSION

LINE, TRACK, STATIONS AND SYSTEMS DESIGN UNIT 023 MILPITAS STATION HVAC, PLUMBING AND CONTROLS SYMBOLS					CADD FILENAME C700-S-DB-M002.dwg SIZE D SCALE NONE CONTRACT NO. C700 SHEET NO. DB PAGE NO. 00659				
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KEY NOTES

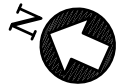- 26 3" CW
- 42 3" SD TO CIVIL
- 43 3" SS TO CIVIL
- 51 4" IW TO CIVIL
- 60 4" SS TO CIVIL
- 64 4" TO GREASE/OIL SEPERATOR


Santa Clara Valley Transportation Authority

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Contract No.: DB11002F

By: Date:



MECHANICAL SITE PLAN
SCALE: 1"=30'-0"

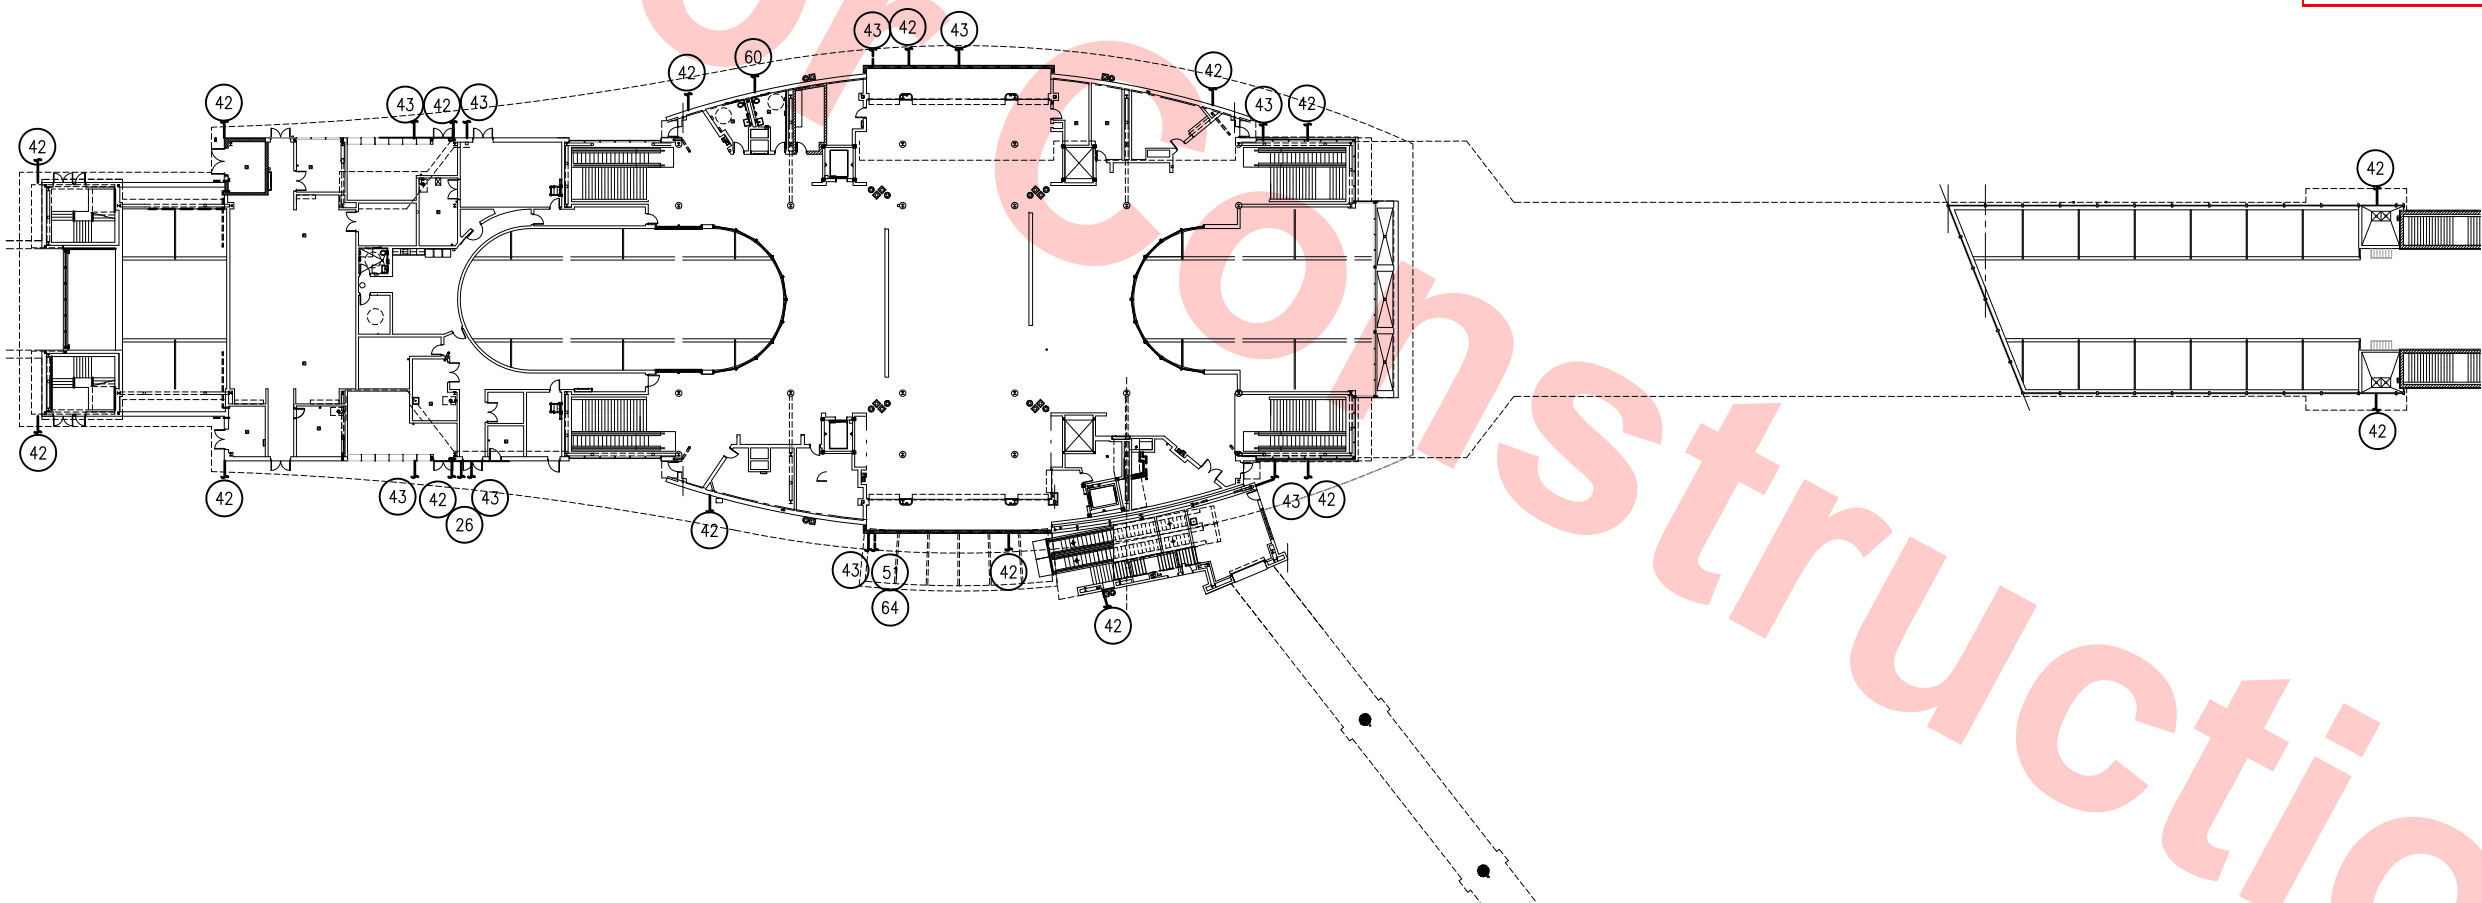

						DESIGNED BY P. BLAUVELT
						DRAWN BY P. BLAUVELT
						CHECKED BY G. HENNINGS
						IN CHARGE G. HENNINGS
0	20130710					DATE 20130710
REV	DATE	BY	SUB	APP	DESCRIPTION	



**Skanska
Shimmick
Herzog**

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510-569-2000

LEN Lookwood, Andrews
& Newnam, Inc.
A LEQ A BALLY COMPANY

T-Y-LIN INTERNATIONAL



SUBMITTED *[Signature]* APPROVED *[Signature]*

BART
SILICON VALLEY

BART SILICON VALLEY BERRYESSA EXTENSION

LINE, TRACK, STATIONS AND SYSTEMS
DESIGN UNIT 023
MILPITAS STATION
MECHANICAL SITE PLAN

CADD FILENAME C700-S-DB-M005.dwg		
SIZE D	SCALE 1"=30'-0"	
CONTRACT NO. C700		REV. 0
AREA CODE DB	SHEET NO. M005	PAGE NO. 0660

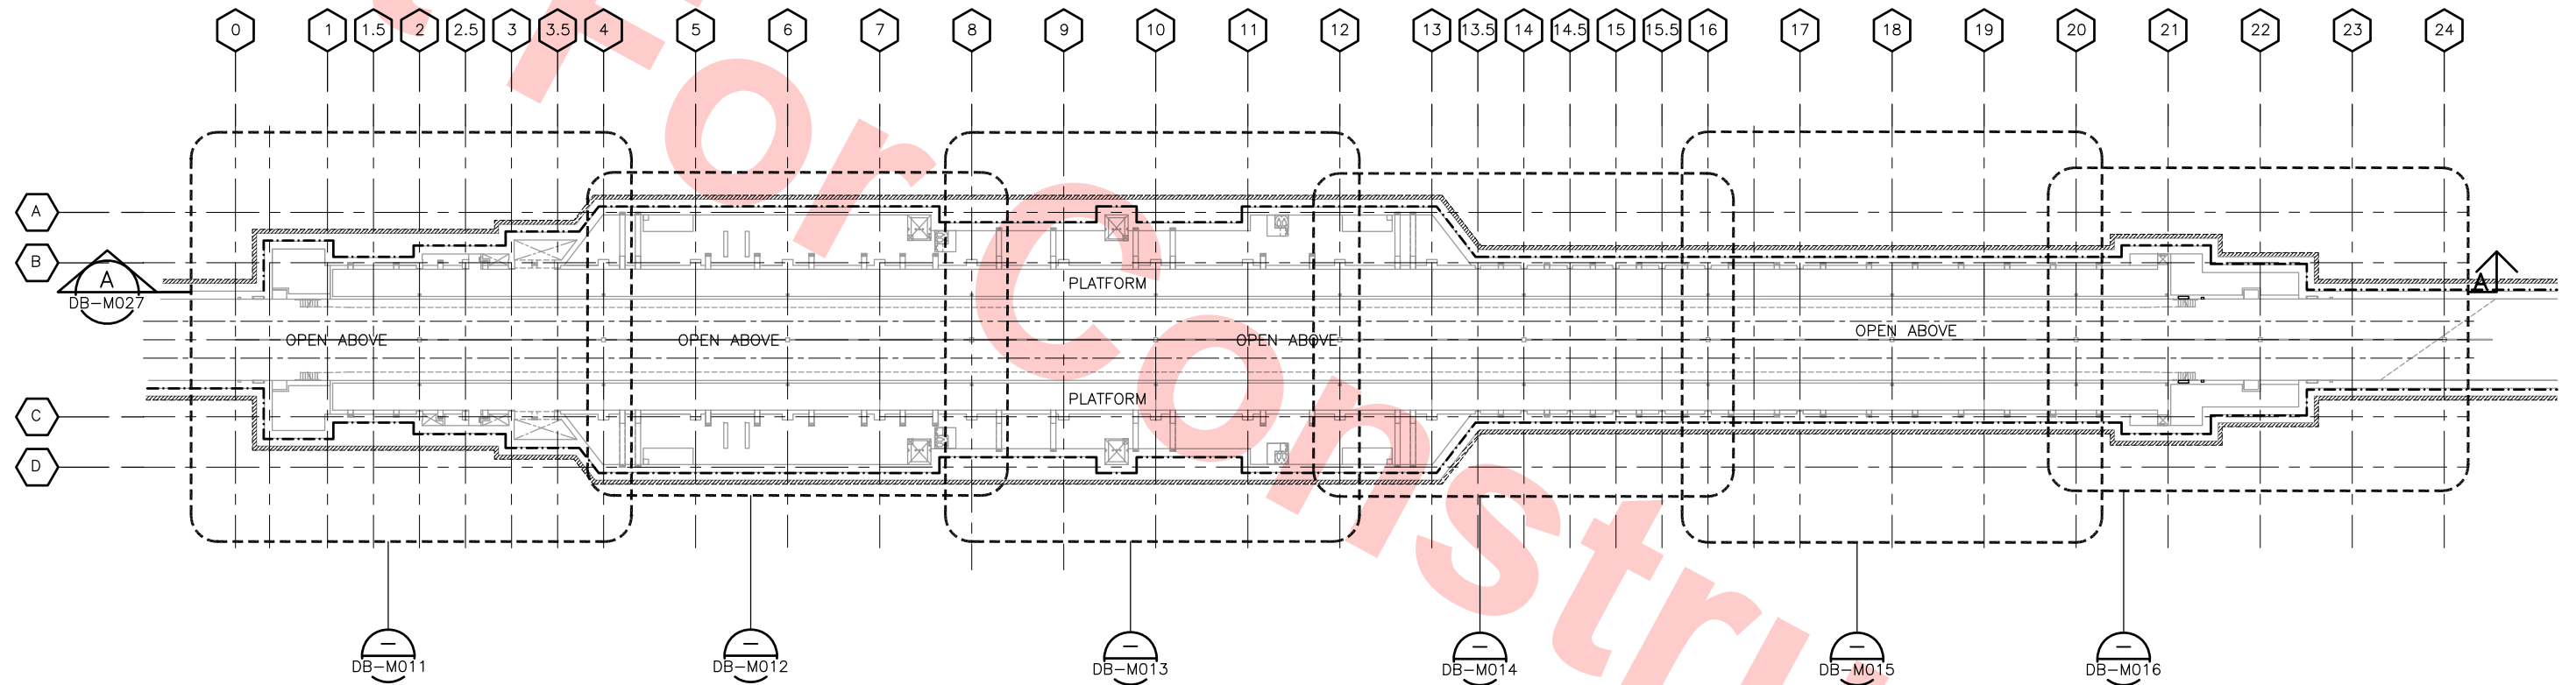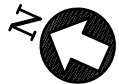

KEY PLAN TRACK LEVEL – HVAC
SCALE: 1/32"=1'-0"


Santa Clara Valley Transportation Authority

— NO EXCEPTIONS TAKEN (NET)
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— AMEND AND RESUBMIT (A/R)

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Contract No.: DB11002F

By: _____ Date: _____

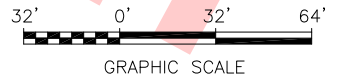

REV	DATE	BY	SUB	APP	DESCRIPTION
0	20130710				READINESS FOR CONSTRUCTION

DESIGNED BY
J. CHOU
DRAWN BY
J. CHOU
CHECKED BY
G. HENNINGS
IN CHARGE
G. HENNINGS
DATE
20130710

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& Newnam, Inc.
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APPROVED _____



LINE, TRACK, STATIONS AND SYSTEMS
DESIGN UNIT 023
MILPITAS STATION
KEY PLAN TRACK LEVEL
HVAC

CADD FILENAME C700-S-DB-M010.dwg	REV.	0
SIZE D	SCALE 1/32"=1'-0"	
CONTRACT NO. C700	SHEET NO. M010	PAGE NO. 0661

KEY NOTES

- 1 24x12 SA DUCT RISER FROM UTILITY CHASE UP TO PLATFORM. INSTALL BALANCING VOLUME DAMPER AT FACE OF INLET. TYPICAL

Santa Clara Valley Transportation Authority

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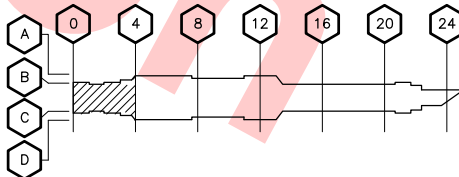
Contract No.: DB11002F

By: Date:



GRAPHIC SCALE

KEY PLAN



TRACK LEVEL PLAN – HVAC

SCALE: 1/8"=1'-0" DB-M010

MATCH LINE
SEE DWG NO. DB-M012

REV	DATE	BY	SUB	APP	DESCRIPTION
0	20130710				READINESS FOR CONSTRUCTION



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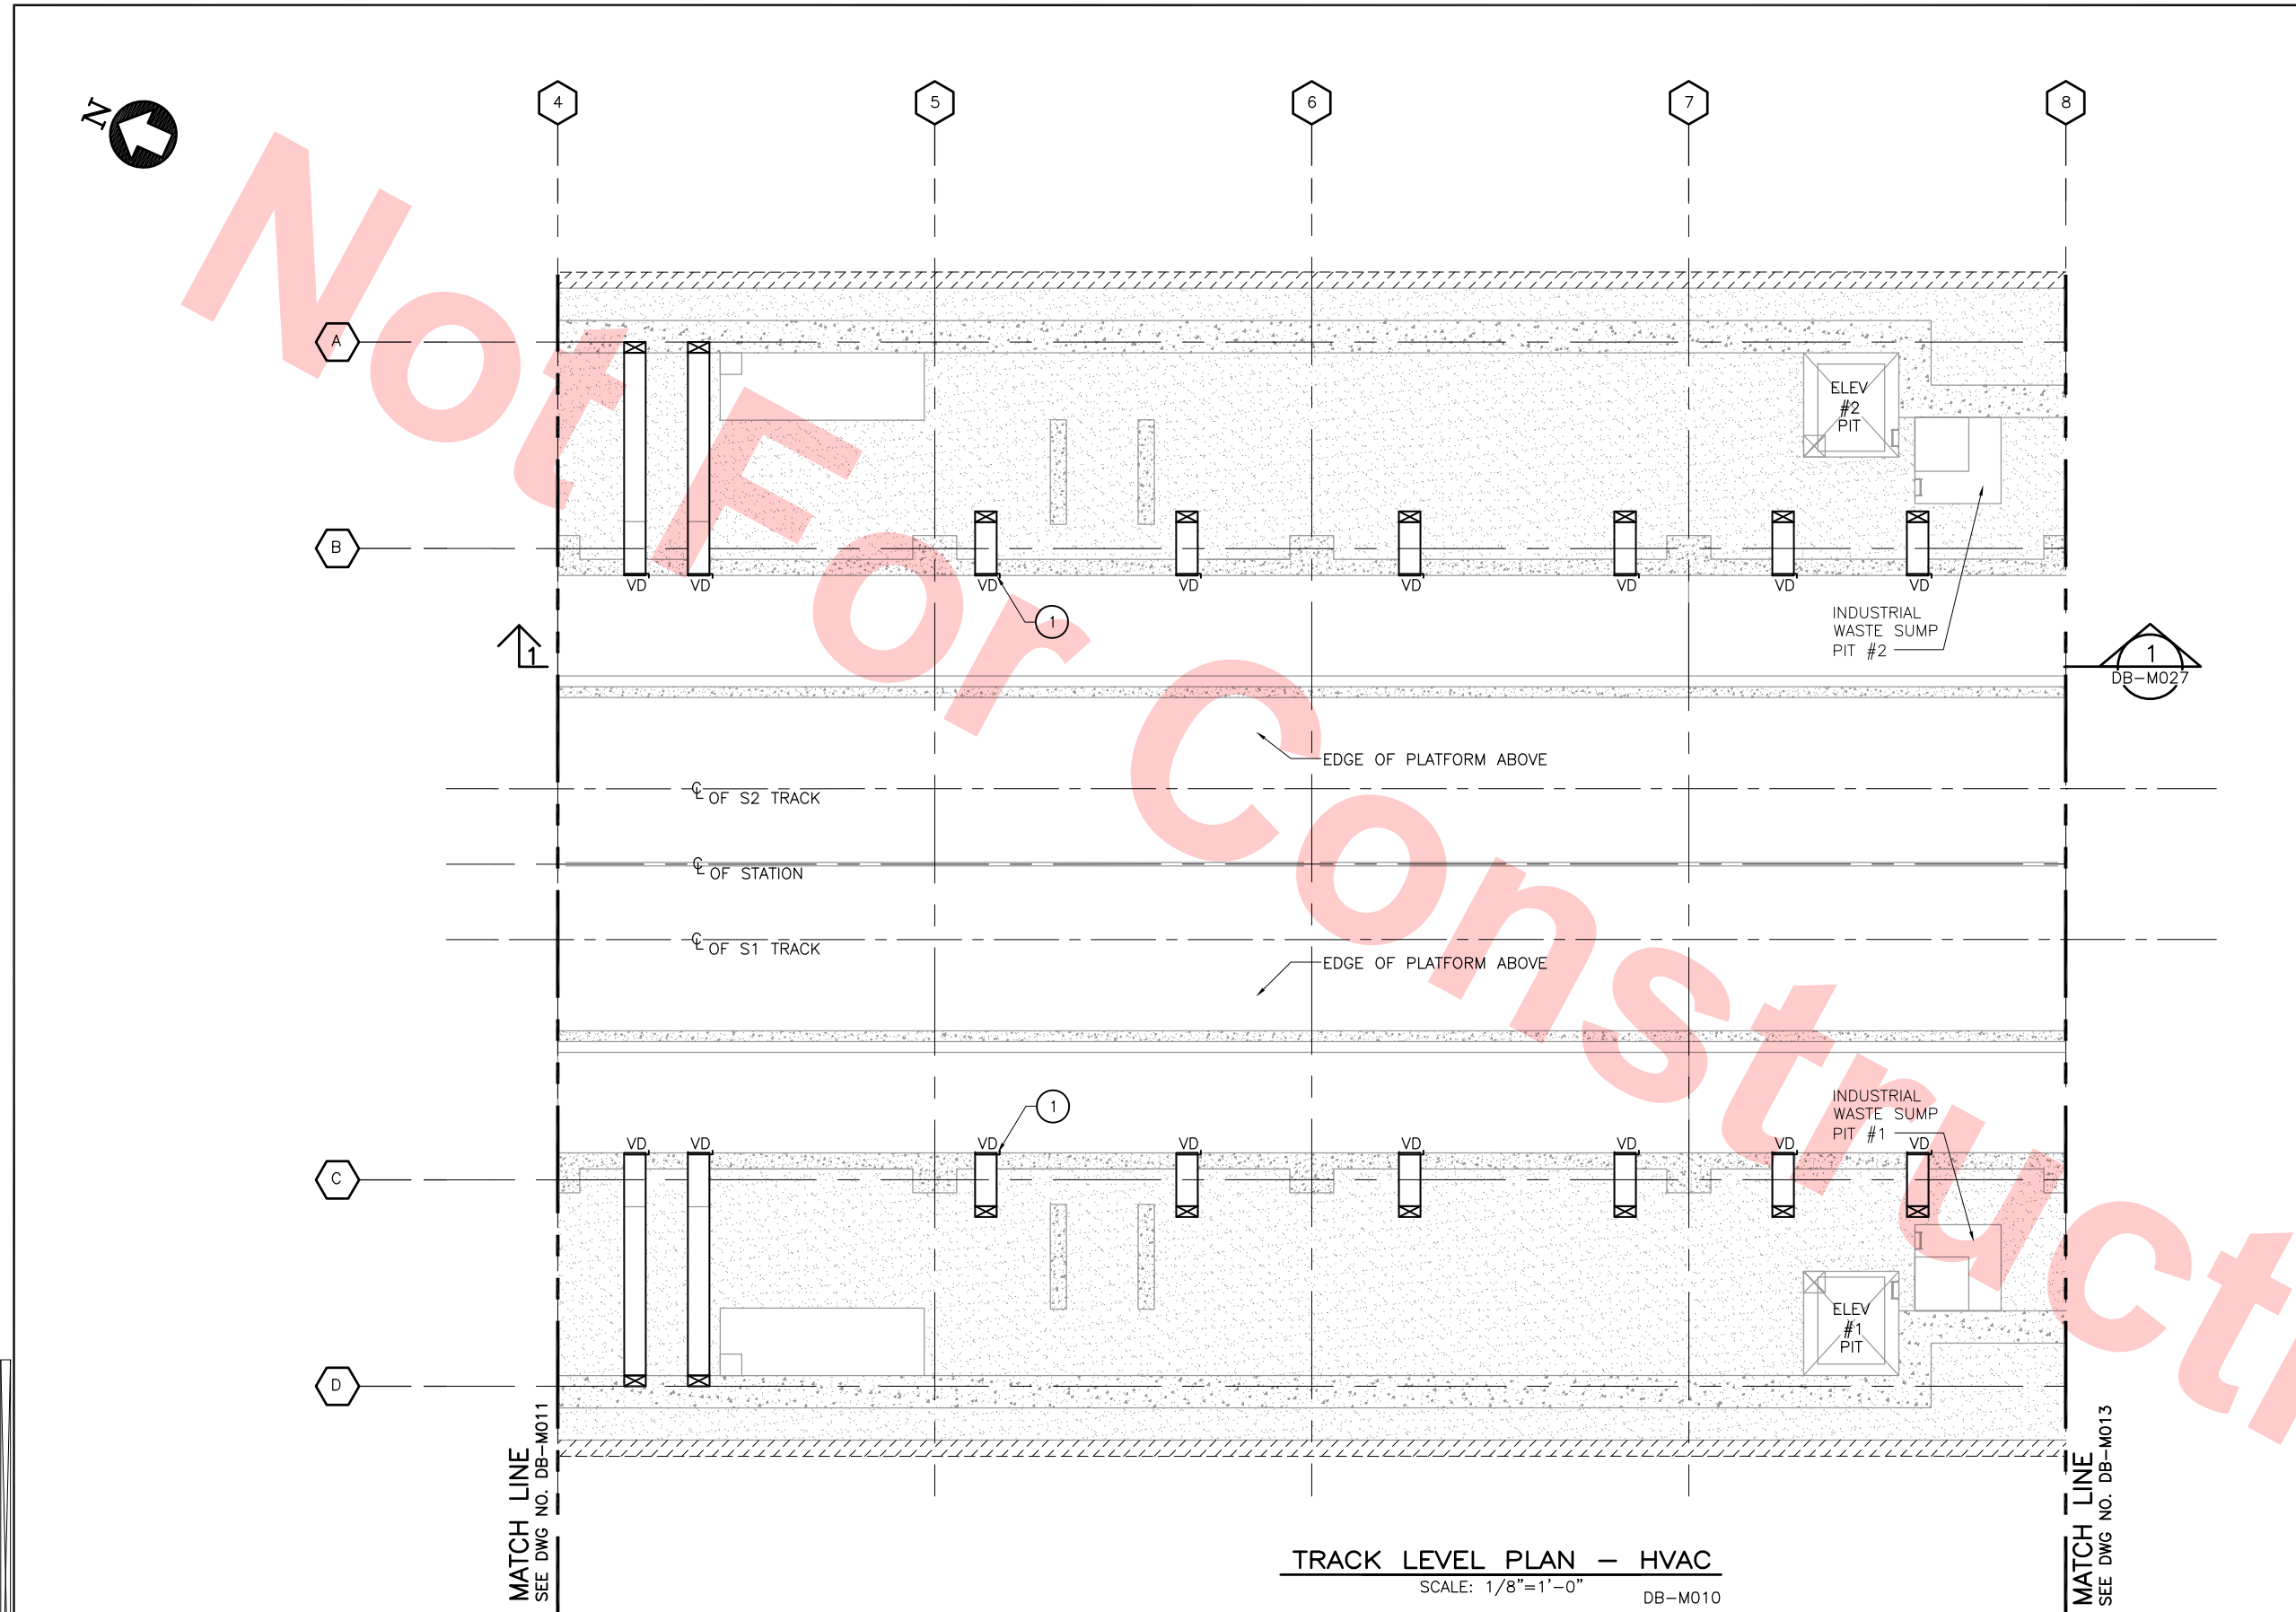
T-Y-LIN INTERNATIONAL



BART SILICON VALLEY BERRYESSA EXTENSION

LINE, TRACK, STATIONS AND SYSTEMS
DESIGN UNIT 023
MILPITAS STATION
TRACK LEVEL PLAN
HVAC
SHEET 1 OF 6

CADD FILENAME	C700-S-DB-M011.dwg
SIZE	D
SCALE	1/8"=1'-0"
CONTRACT NO.	C700
AREA CODE	DB
SHEET NO.	M011
PAGE NO.	0662



TRACK LEVEL PLAN — HVAC
SCALE: 1/8"=1'-0" DB-M010

KEY NOTES

- 1 24x12 SA DUCT RISER FROM UTILITY CHASE UP TO PLATFORM. INSTALL BALANCING VOLUME DAMPER AT FACE OF INLET. TYPICAL

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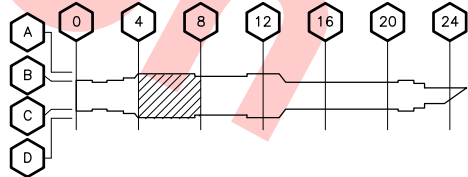
Contract No.: DB11002F

By: _____ Date: _____

8' 0' 8' 16'

GRAPHIC SCALE

KEY PLAN



REV	DATE	BY	SUB	APP	DESCRIPTION
0	20130710				READINESS FOR CONSTRUCTION

DESIGNED BY
J. CHOU

DRAWN BY
J. CHOU

CHECKED BY
C. HENNINGS

IN CHARGE
C. HENNINGS

DATE
20130710

Skanska
Shimmick
Herzog

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Lookwood, Andrews
& Newnam, Inc.
A LEOP A BALLY COMPANY

T-Y LIN INTERNATIONAL

APPROVED
R. Apolunth

BART
VTA SILICON VALLEY

BART SILICON VALLEY BERRYESSA EXTENSION



LINE, TRACK, STATIONS AND SYSTEMS
DESIGN UNIT 023
MILPITAS STATION
TRACK LEVEL PLAN
HVAC
SHEET 2 OF 6

CADD FILENAME
C700-S-DB-M012.dwg

SIZE SCALE
D 1/8"=1'-0"

CONTRACT NO. C700 REV. 0

AREA CODE SHEET NO. PAGE NO.
DB M012 0663

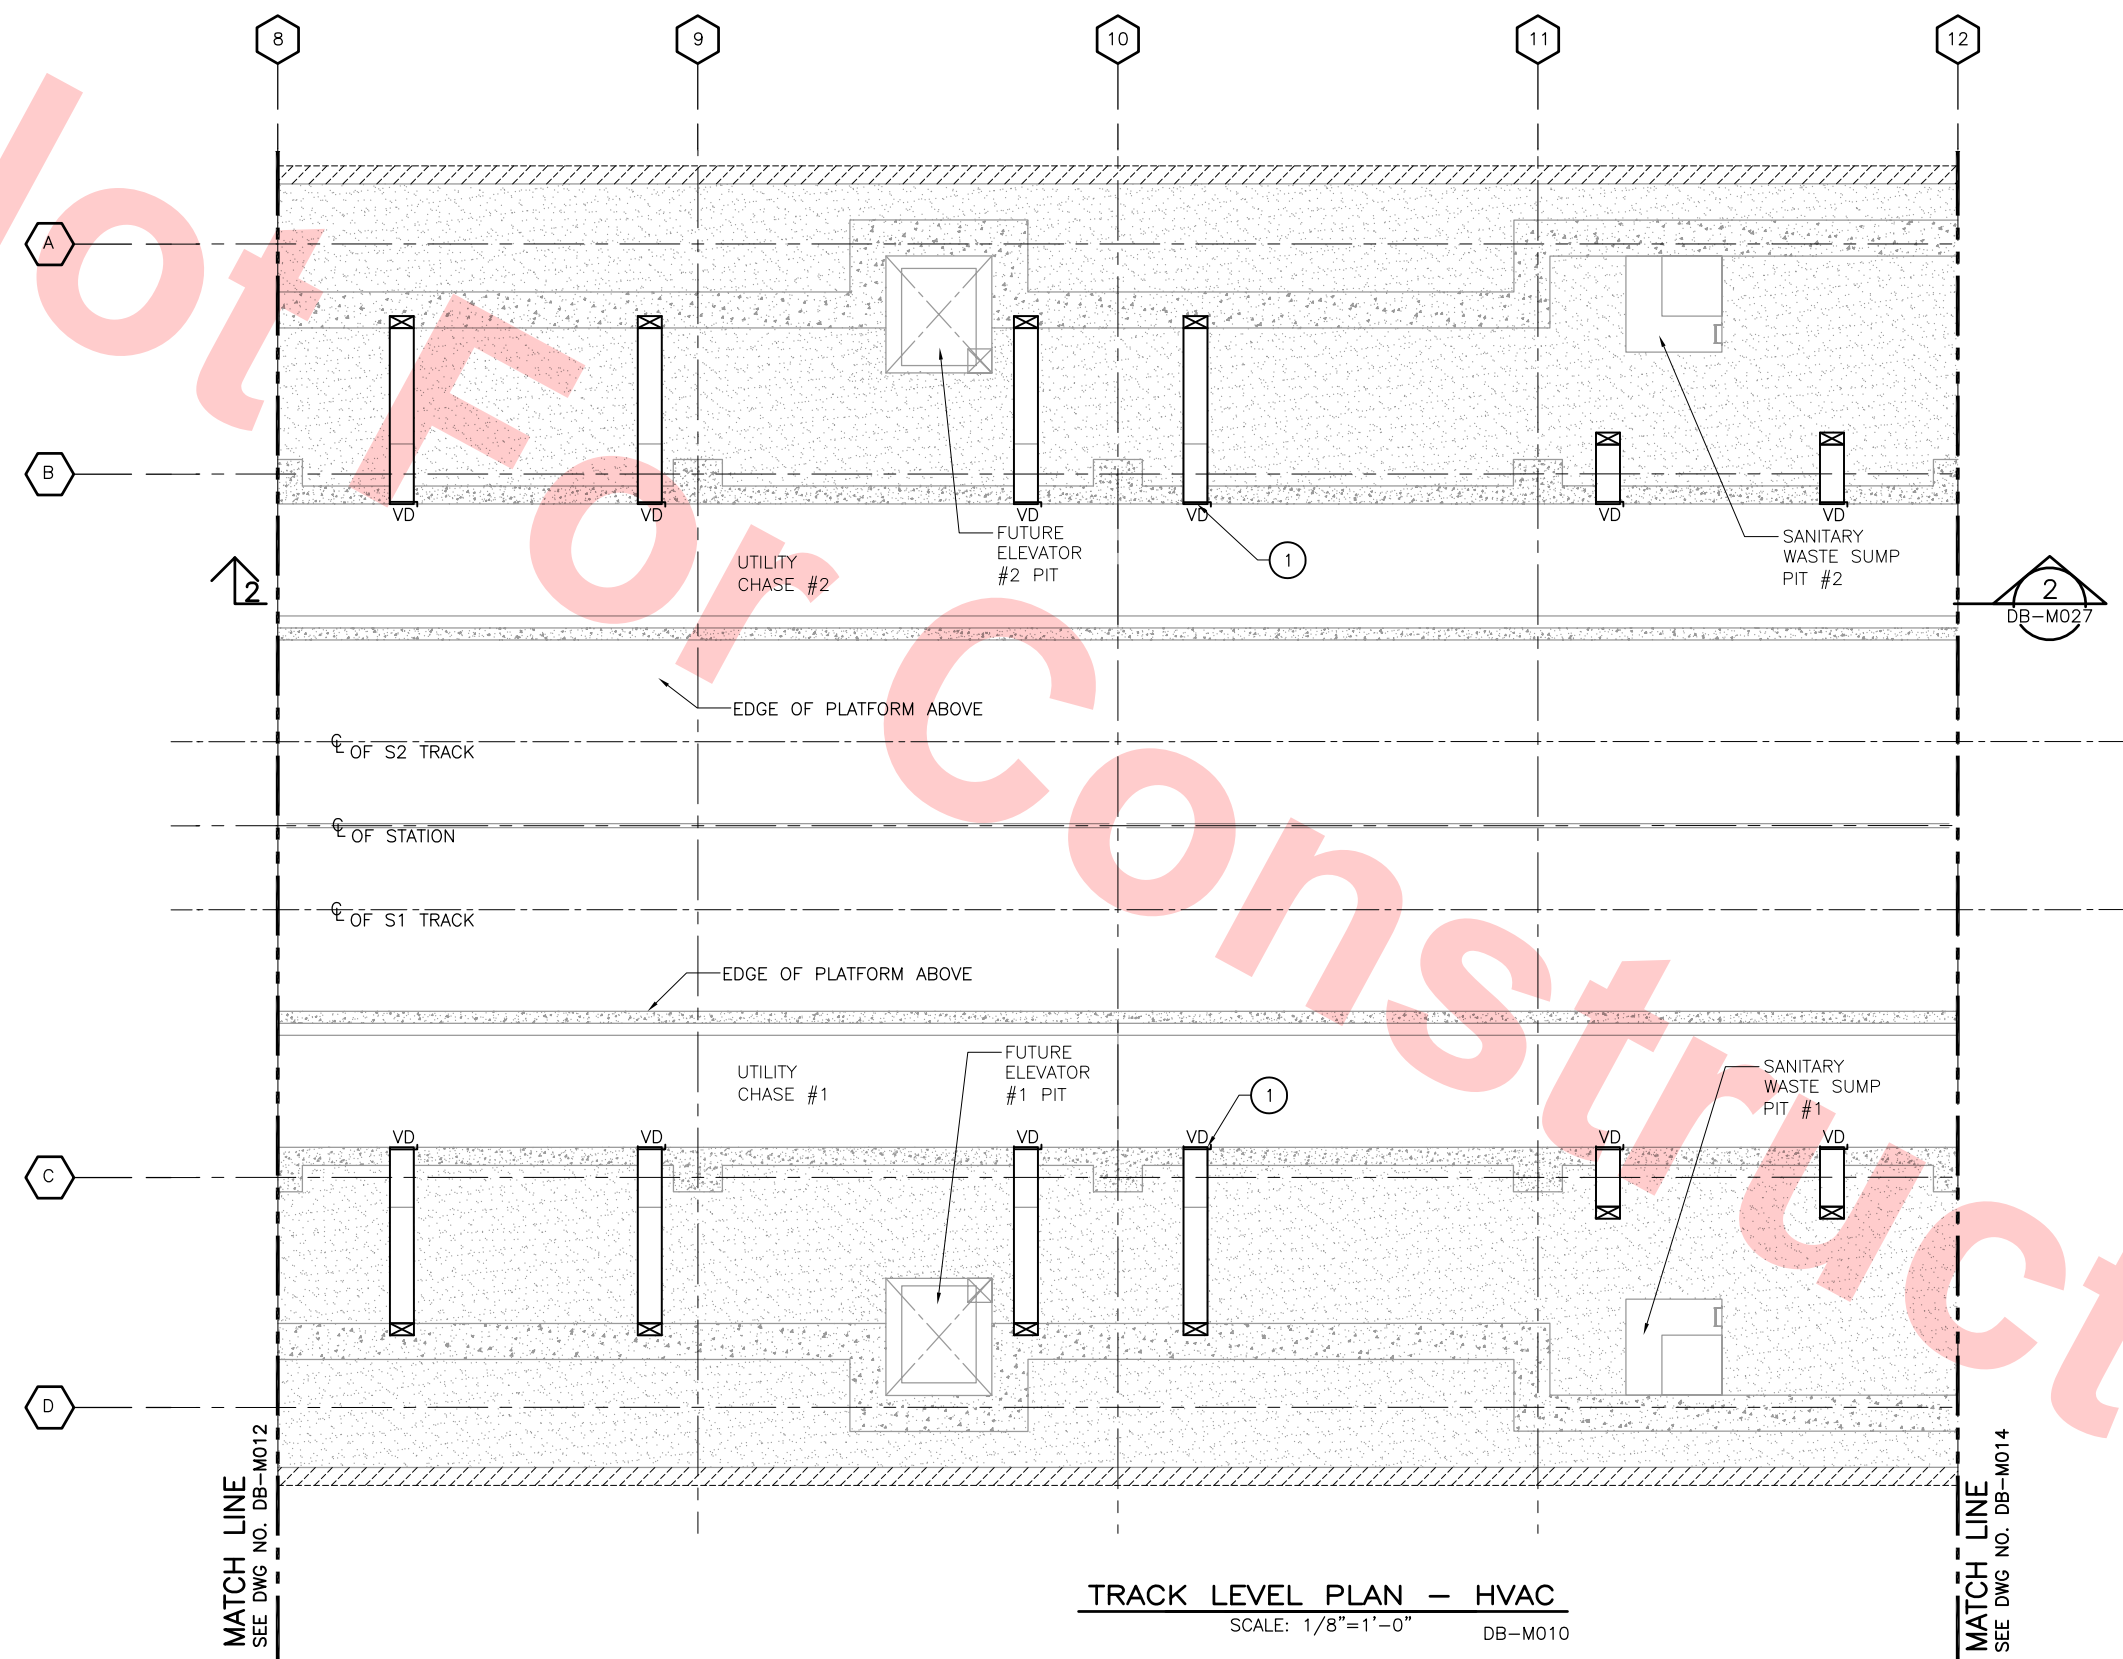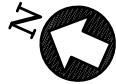

TRACK LEVEL PLAN — HVAC
SCALE: 1/8"=1'-0" DB-M010

KEY NOTES

- 1 24x12 SA DUCT RISER FROM UTILITY CHASE UP TO PLATFORM. INSTALL BALANCING VOLUME DAMPER AT FACE OF INLET. TYPICAL


Santa Clara Valley Transportation Authority

NO EXCEPTIONS TAKEN (NET)
MAKE CORRECTIONS NOTED (MCN)
AMEND AND RESUBMIT (A/R)


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Contract No.: DB11002F


By: _____ Date: _____

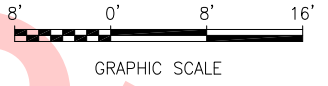

KEY PLAN

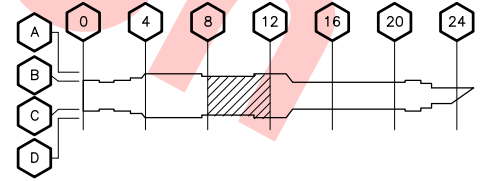

REV	DATE	BY	SUB	APP	DESCRIPTION
0	20130710				READINESS FOR CONSTRUCTION

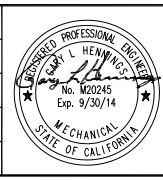

DESIGNED BY J. CHOU
DRAWN BY J. CHOU
CHECKED BY G. HENNINGS
IN CHARGE G. HENNINGS
DATE 20130710

Skanska Shimmick Herzog
1436 California Circle
Milpitas, California 95035
A Joint Venture

BCT Block Construction Inc.
4455 Enterprise St., Fremont, CA 94538
(510) 857-5666 Fax: (510) 857-5668
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H&M Mechanical Group
8517 Eastman Rd. #230
Oakland, CA 94621
510-569-2000


Lookwood, Andrews & Newnam, Inc.
A LEOP A BALLY COMPANY

T-Y LIN INTERNATIONAL



LINE, TRACK, STATIONS AND SYSTEMS
DESIGN UNIT 023
MILPITAS STATION
TRACK LEVEL PLAN
HVAC
SHEET 3 OF 6

CADD FILENAME	C700-S-DB-M013.dwg
SIZE	D
SCALE	1/8"=1'-0"
CONTRACT NO.	C700
AREA CODE	DB
SHEET NO.	M013
PAGE NO.	0664
REV.	0

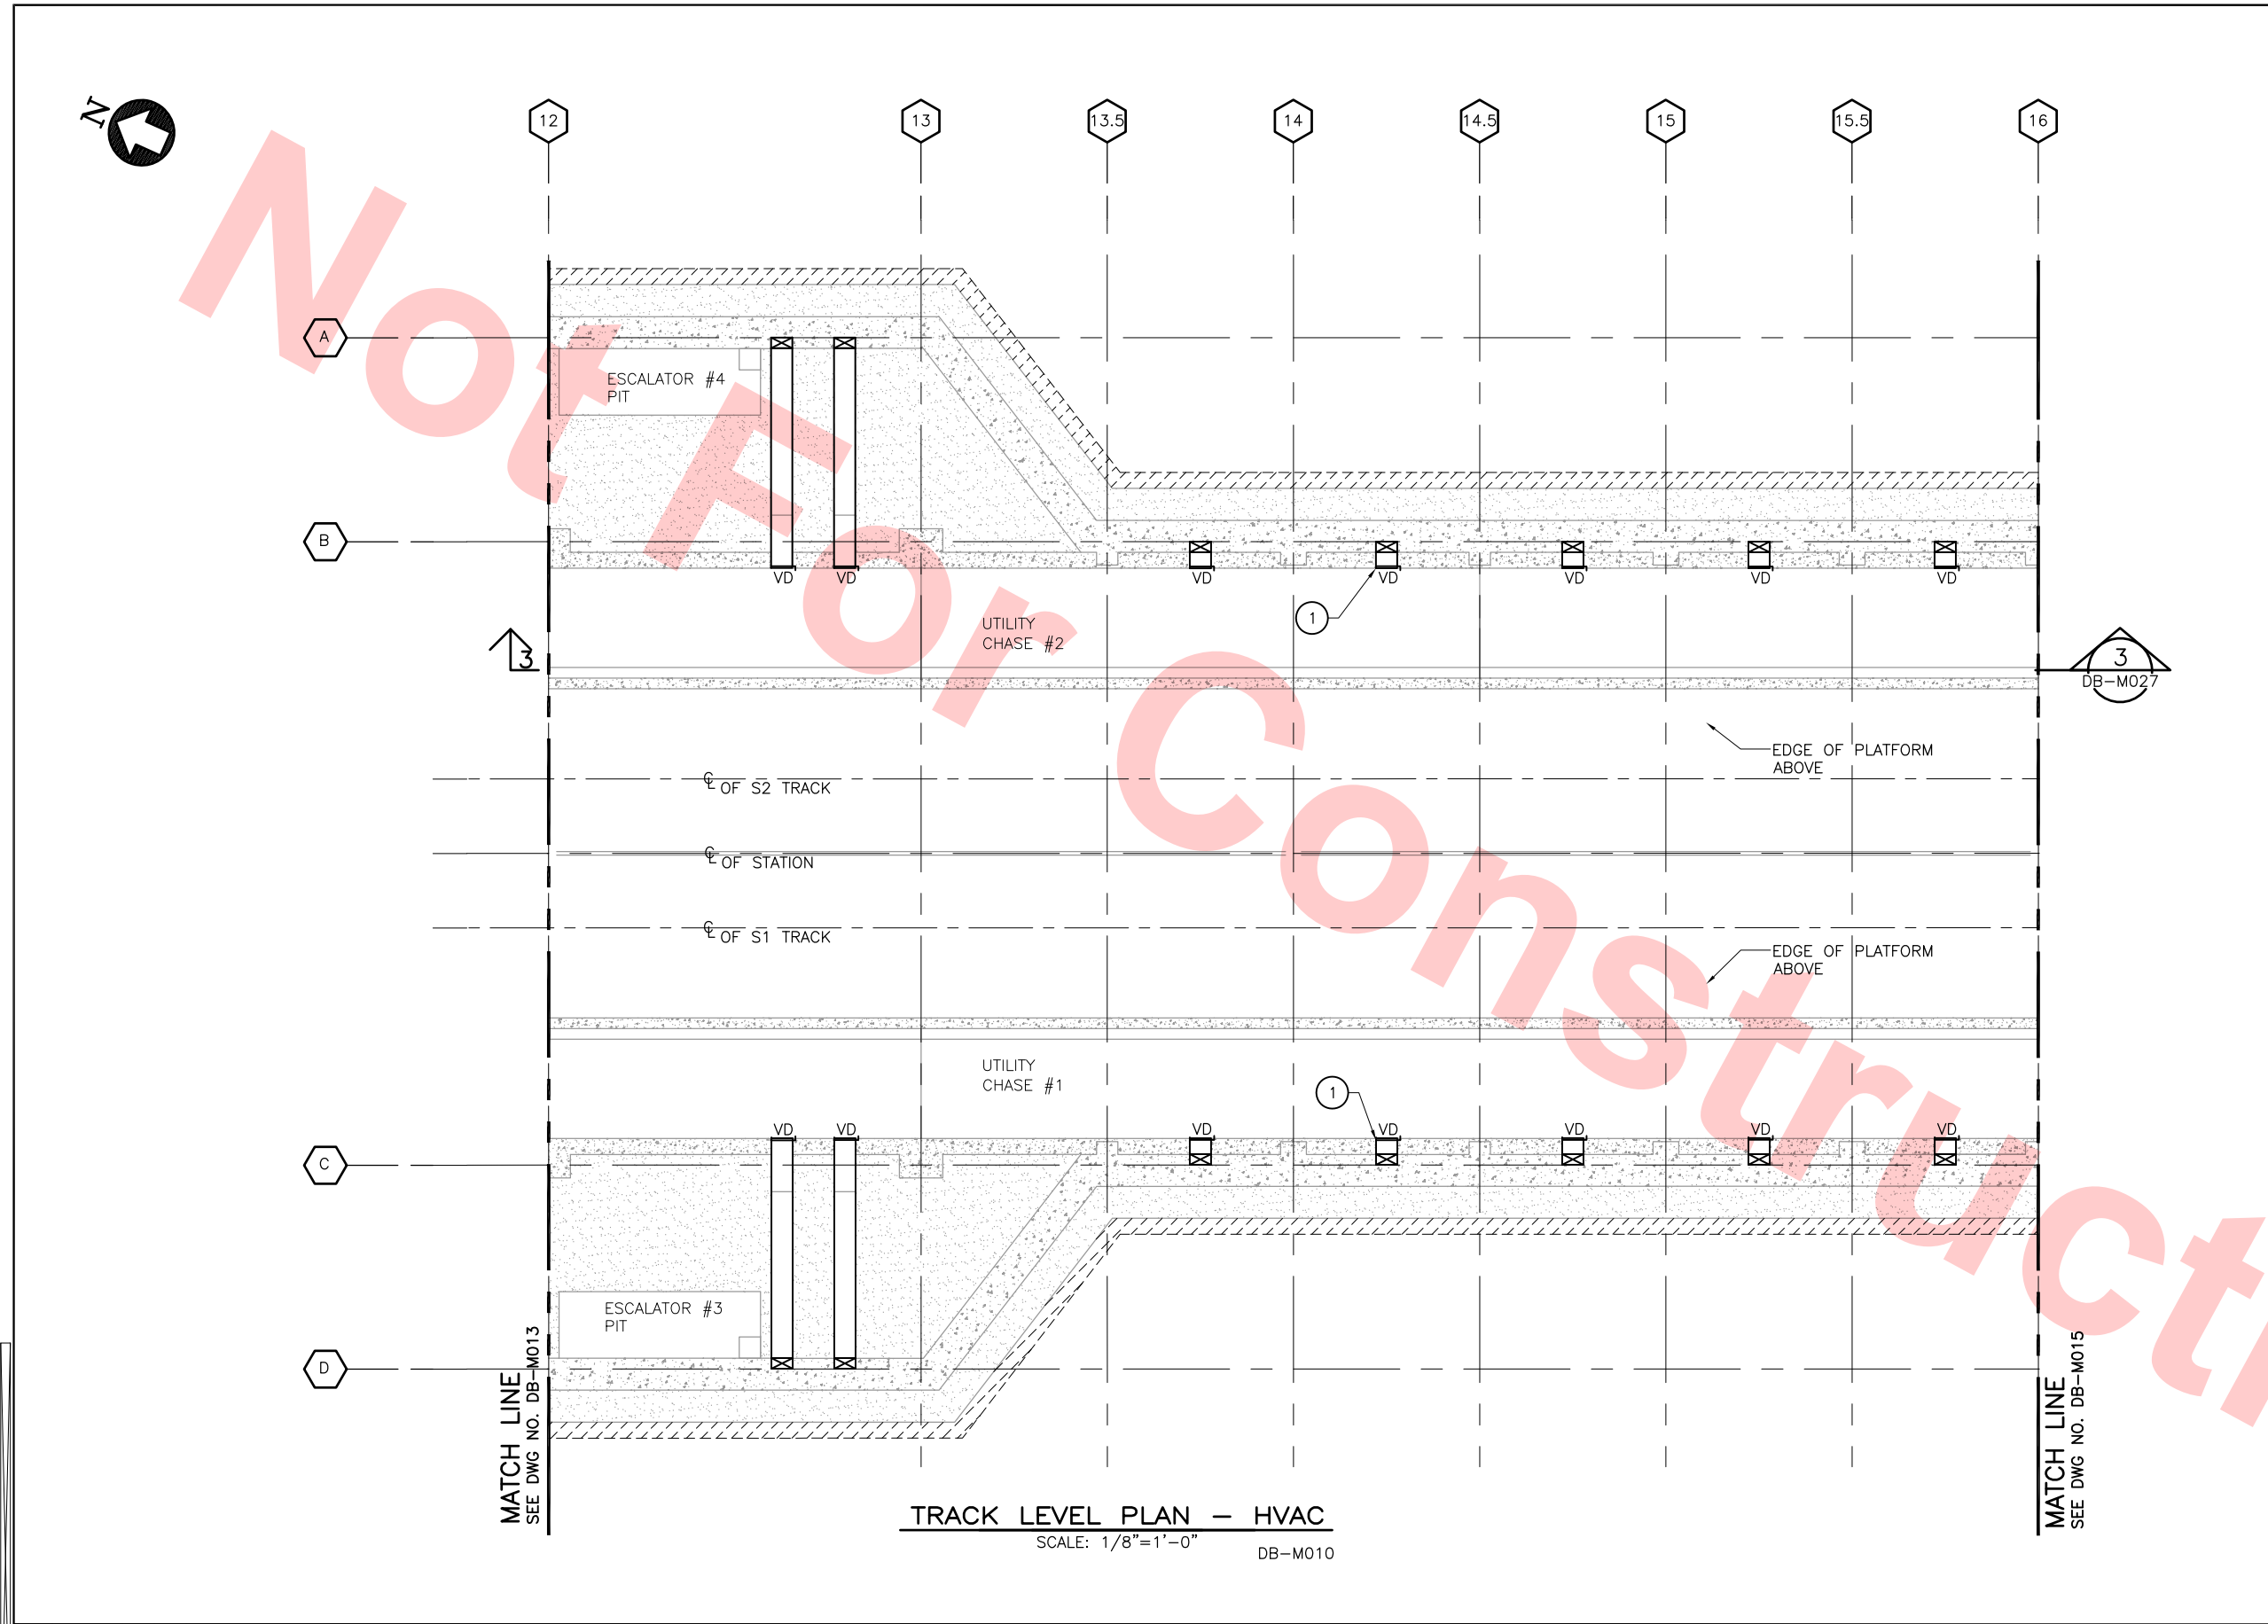

KEY NOTES

1 24x12 SA DUCT RISER FROM UTILITY CHASE UP TO PLATFORM. INSTALL BALANCING VOLUME DAMPER AT FACE OF INLET. TYPICAL

Santa Clara Valley Transportation Authority

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Contract No.: DB11002F

By: _____ Date: _____


8' 0' 8' 16'

GRAPHIC SCALE

KEY PLAN

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1 24x12 SA DUCT RISER FROM UTILITY CHASE UP TO PLATFORM. INSTALL BALANCING VOLUME DAMPER AT FACE OF INLET. TYPICAL

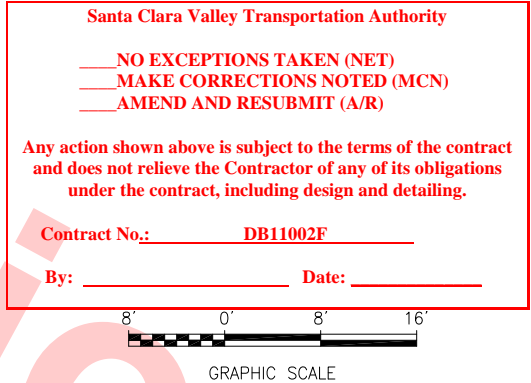

						DESIGNED BY J. CHOU
						DRAWN BY J. CHOU
						CHECKED BY G. HENNINGS
						IN CHARGE G. HENNINGS
0	20130710				READINESS FOR CONSTRUCTION	DATE 20130710
REV	DATE	BY	SUB	APP	DESCRIPTION	

BCI Block Construction Inc.
4455 Enterprise St., Fremont, CA 94538
(510) 657-3686 Fax: (510) 657-3688
CA Lic. #679326 email: info@blockcainc.com


SUBMITTED

LAN Lockwood, Andrew & Newnam, Inc.
A LEO A DALY COMPANY

APPROVED Ry Hollenuth



CADD FILENAME C700-S-DB-M015.dwg		
SIZE D	SCALE 1/8"=1'-0"	
CONTRACT NO. C700		REV. 0
AREA CODE DB	SHEET NO. M015	PAGE NO. 0666

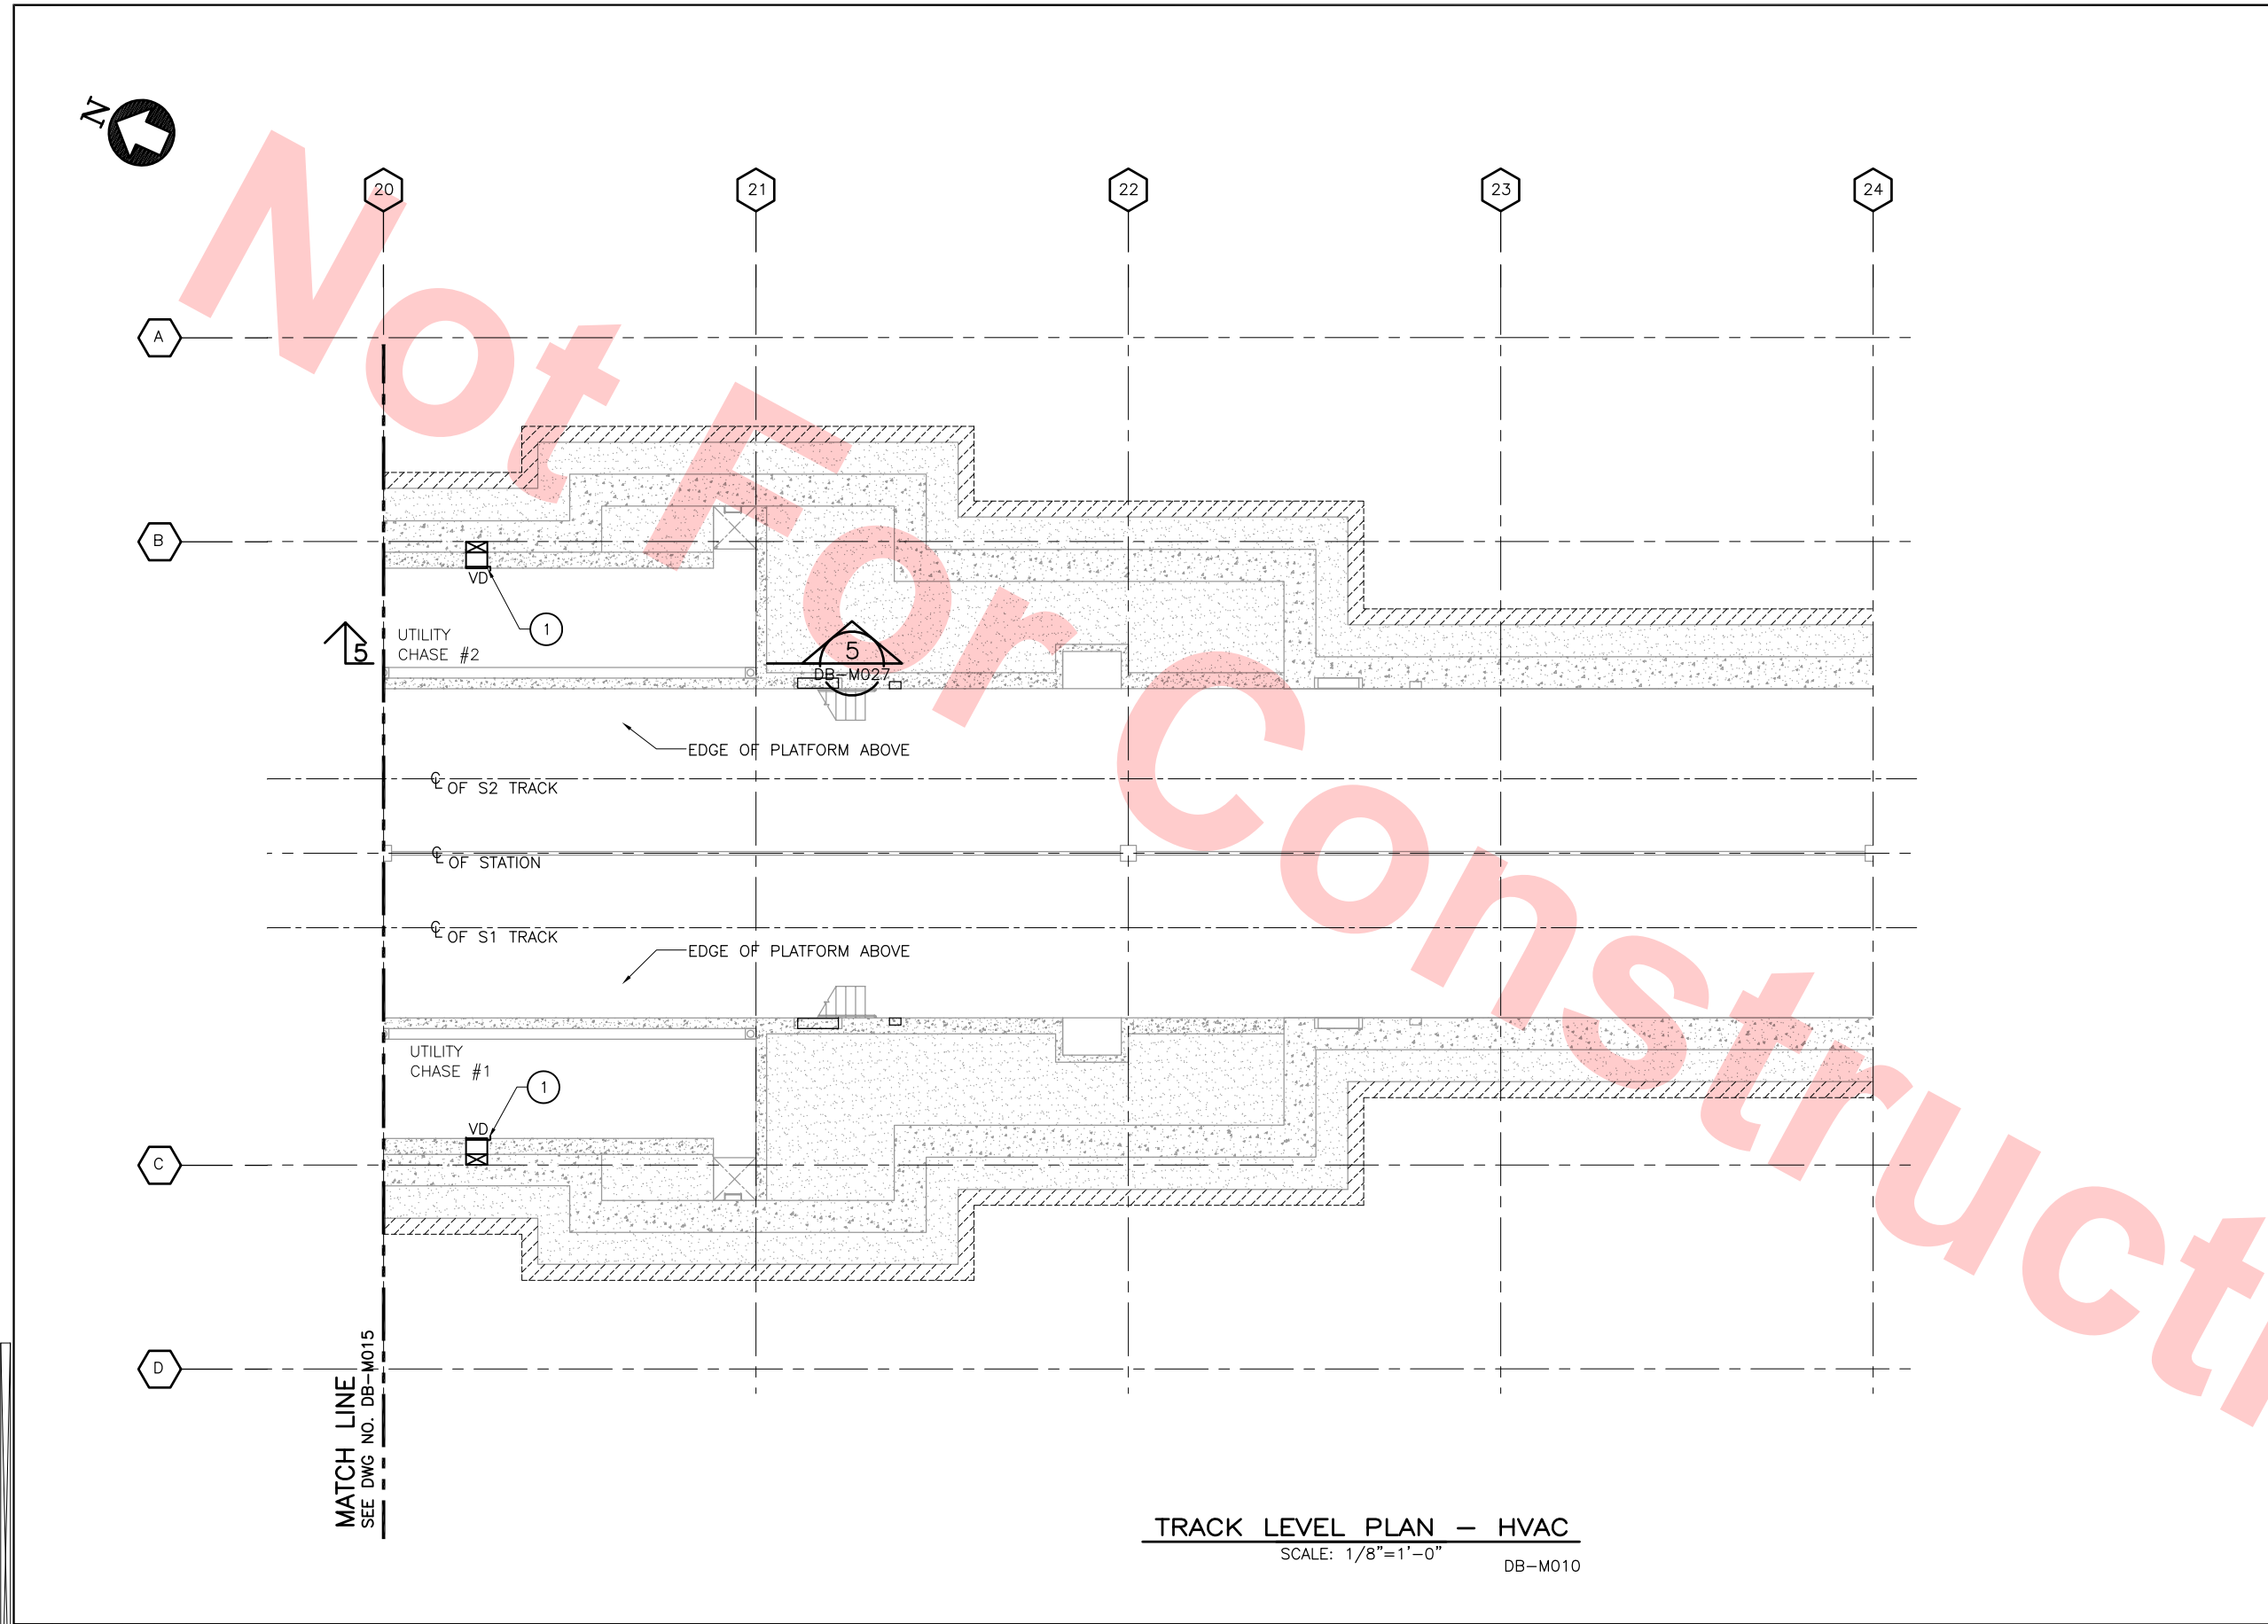

TRACK LEVEL PLAN — HVAC
SCALE: 1/8"=1'-0" DB-M010

KEY NOTES

- 1 24x12 SA DUCT RISER FROM UTILITY CHASE UP TO PLATFORM. INSTALL BALANCING VOLUME DAMPER AT FACE OF INLET. TYPICAL

Santa Clara Valley Transportation Authority

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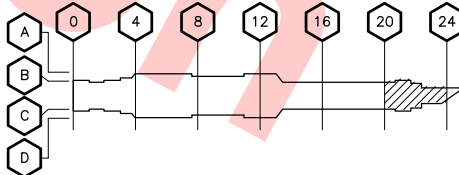
Contract No.: DB11002F

By: Date:




GRAPHIC SCALE

KEY PLAN



						DESIGNED BY J. CHOU
						DRAWN BY J. CHOU
						CHECKED BY G. HENNINGS
						IN CHARGE G. HENNINGS
0	20130710					DATE 20130710
REV	DATE	BY	SUB	APP		DESCRIPTION
						READINESS FOR CONSTRUCTION

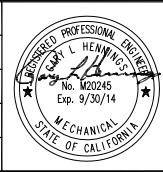

Skanska Shimmick Herzog

1436 California Circle
Milpitas, California 95035
A Joint Venture

BCT Block Construction Inc.
4455 Enterprise St., Fremont, CA 94538
(510) 857-9888 Fax: (510) 857-9888
CA Lic. #679326 Email: info@blockco.com

H&M Mechanical Group
8517 Eastmont Rd., #230
Oakland, CA 94621
510-569-2000

Lookwood, Andrews & Newnam, Inc.
A LEQ A BALLY COMPANY

T-Y LIN INTERNATIONAL



SUBMITTED *[Signature]*

APPROVED *[Signature]*



LINE, TRACK, STATIONS AND SYSTEMS
DESIGN UNIT 023
MILPITAS STATION
TRACK LEVEL PLAN
HVAC
SHEET 6 OF 6

CADD FILENAME		
C700-S-DB-M016.dwg		
SIZE	SCALE	
D	1/8"=1'-0"	
CONTRACT NO.		REV.
C700		0
AREA CODE	SHEET NO.	PAGE NO.
DB	M016	0667

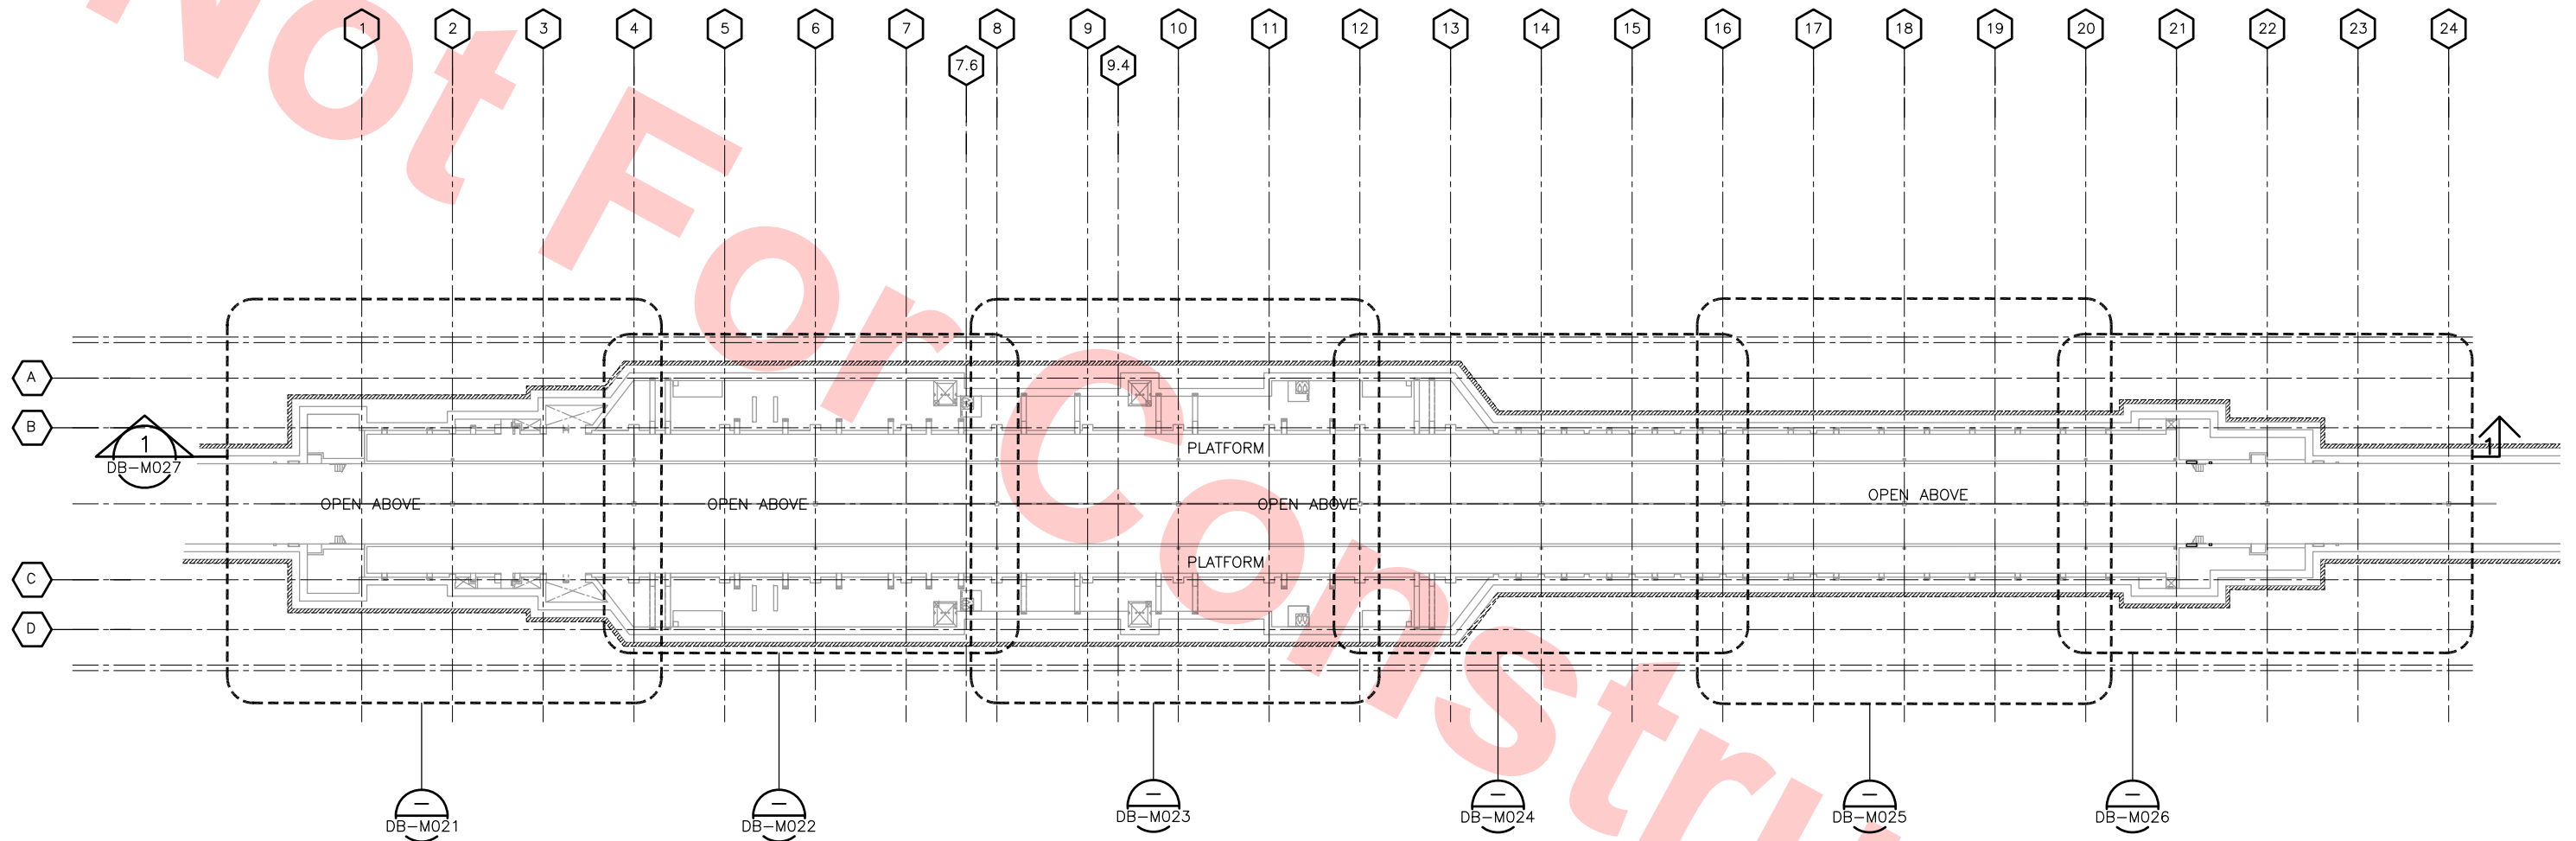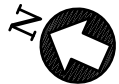

KEY PLAN TRACK LEVEL — PLUMBING
SCALE: 1/32"=1'-0"


Santa Clara Valley Transportation Authority

- ___ NO EXCEPTIONS TAKEN (NET)
- ___ MAKE CORRECTIONS NOTED (MCN)
- ___ AMEND AND RESUBMIT (A/R)

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Contract No.: DB11002F

By: _____ Date: _____

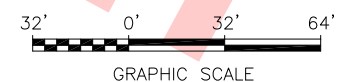

DESIGNED BY P. BLAUVELT	
DRAWN BY P. BLAUVELT	
CHECKED BY G. HENNINGS	
IN CHARGE G. HENNINGS	
DATE 20130710	

0	20130710				READINESS FOR CONSTRUCTION
REV	DATE	BY	SUB	APP	DESCRIPTION



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HMM HMM Mechanical Group
6517 Eastmont Rd. #230
Oakland, CA 94621
510-569-2000

Lookwood, Andrews & Newman, Inc.
A LEOP A BALLY COMPANY
APPROVED *Ry Holmuth*

T-Y-LIN INTERNATIONAL




LINE, TRACK, STATIONS AND SYSTEMS
DESIGN UNIT 023
MILPITAS STATION
KEY PLAN TRACK LEVEL
PLUMBING

CADD FILENAME C700-S-DB-M020.dwg	
SIZE D	SCALE 1/32"=1'-0"
CONTRACT NO. C700	REV. 0
AREA CODE DB	SHEET NO. M020
	PAGE NO. 0668

KEY NOTES

- 1 3" SS UP TO FD
- 2 3" SS UP TO MOP SINK
- 8 2" VENT UP
- 6 3" SS UP
- 11 1/2" TRAP PRIMER

KEY PLAN

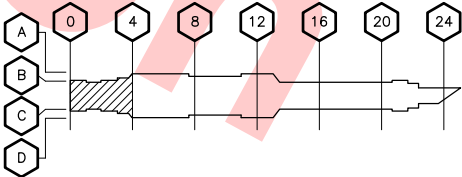

TRACK LEVEL PLAN — PLUMBING

SCALE: 1/8"=1'-0" DB-M020

Santa Clara Valley Transportation Authority

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Contract No.: DB11002F

By: Date:

						DESIGNED BY P. BLAUVELT
						DRAWN BY P. BLAUVELT
						CHECKED BY G. HENNINGS
						IN CHARGE G. HENNINGS
0	20130710				READINESS FOR CONSTRUCTION	DATE 20130710
REV	DATE	BY	SUB	APP	DESCRIPTION	



Skanska Shimmick Herzog

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Milpitas, California 95035
A Joint Venture

Block Construction Inc.
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H&M Mechanical Group
8517 Eastmont Rd. #230
Oakland, CA 94621
510-569-2000

Lookwood, Andrews & Newman, Inc.
A LEOP A BALLY COMPANY

T-Y LIN INTERNATIONAL

SUBMITTED

APPROVED

BART

SILICON VALLEY

BART SILICON VALLEY BERRYESSA EXTENSION

LINE, TRACK, STATIONS AND SYSTEMS

DESIGN UNIT 023


MILPITAS STATION

TRACK LEVEL PLAN

PLUMBING

SHEET 1 OF 6

CADD FILENAME		
C700-S-DB-M021.dwg		
SIZE	SCALE	
D	1/8"=1'-0"	
CONTRACT NO.		REV.
C700		0
AREA CODE	SHEET NO.	PAGE NO.
DB	M021	0669

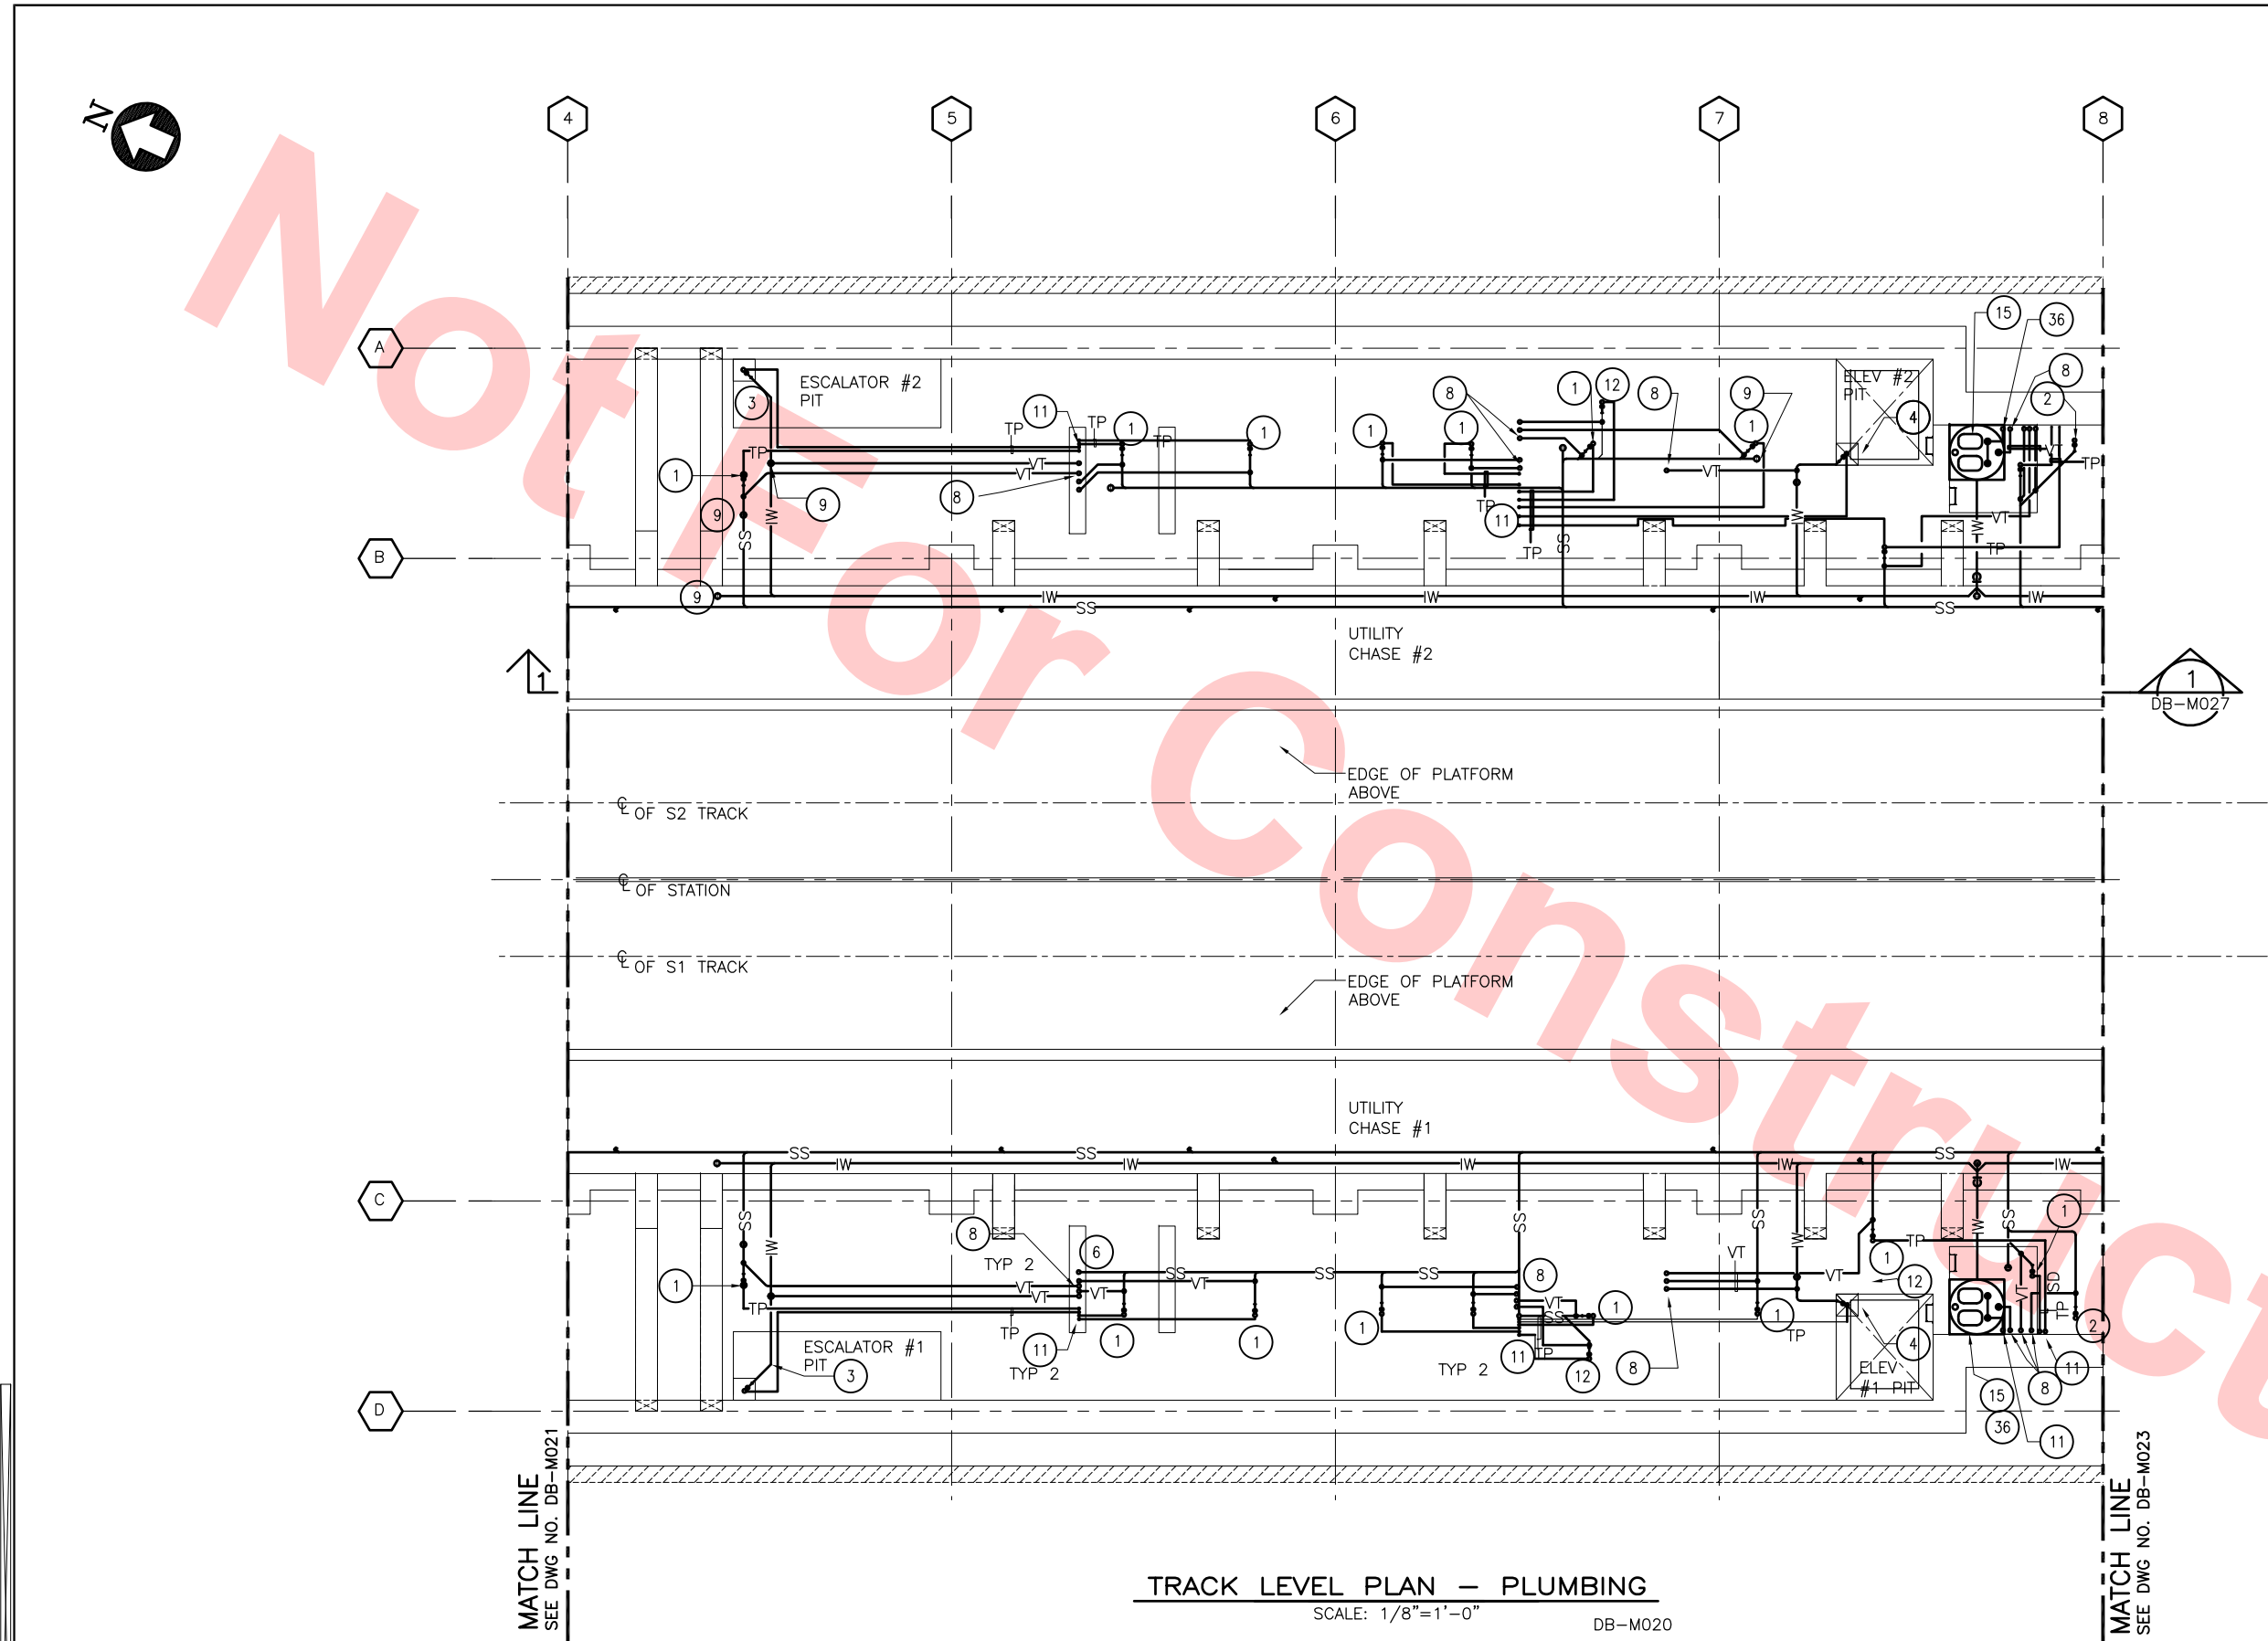

KEY NOTES

- 1 3" SS UP TO FD
- 2 3" SS UP TO MOP SINK
- 3 3" IW UP TO ESCALATOR PIT DRAIN
- 4 3" IW UP TO ELEVATOR PIT DRAIN
- 6 3" SS UP
- 8 2" VENT UP
- 9 3" FCO TO FINISH FLOOR
- 11 1/2" TRAP PRIMER
- 12 3" SS UP TO FLOOR SINK
- 15 IW EJECTOR SUMP
- 36 4" IW EJECTOR DISCHARGE

Santa Clara Valley Transportation Authority

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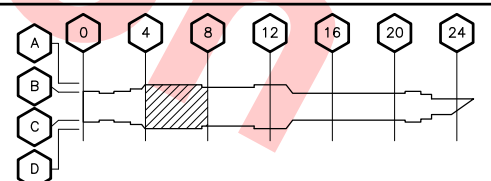
Contract No.: DB11002F

By: _____ Date: _____




GRAPHIC SCALE

KEY PLAN



REV	DATE	BY	SUB	APP	DESCRIPTION
0	20130710				READINESS FOR CONSTRUCTION

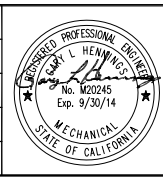

DESIGNED BY
P. BLAUVELT

DRAWN BY
P. BLAUVELT

CHECKED BY
C. HENNINGS

IN CHARGE
C. HENNINGS

DATE
20130710

Skanska
Shimmick
Herzog

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T-Y-LIN INTERNATIONAL


SUBMITTED

APPROVED



LINE, TRACK, STATIONS AND SYSTEMS
DESIGN UNIT 023
MILPITAS STATION
TRACK LEVEL PLAN
PLUMBING
SHEET 2 OF 6

CADD FILENAME C700-S-DB-M022.dwg	REV. 0
SIZE D	SCALE 1/8"=1'-0"
CONTRACT NO. C700	SHEET NO. M022
AREA CODE DB	PAGE NO. 0670

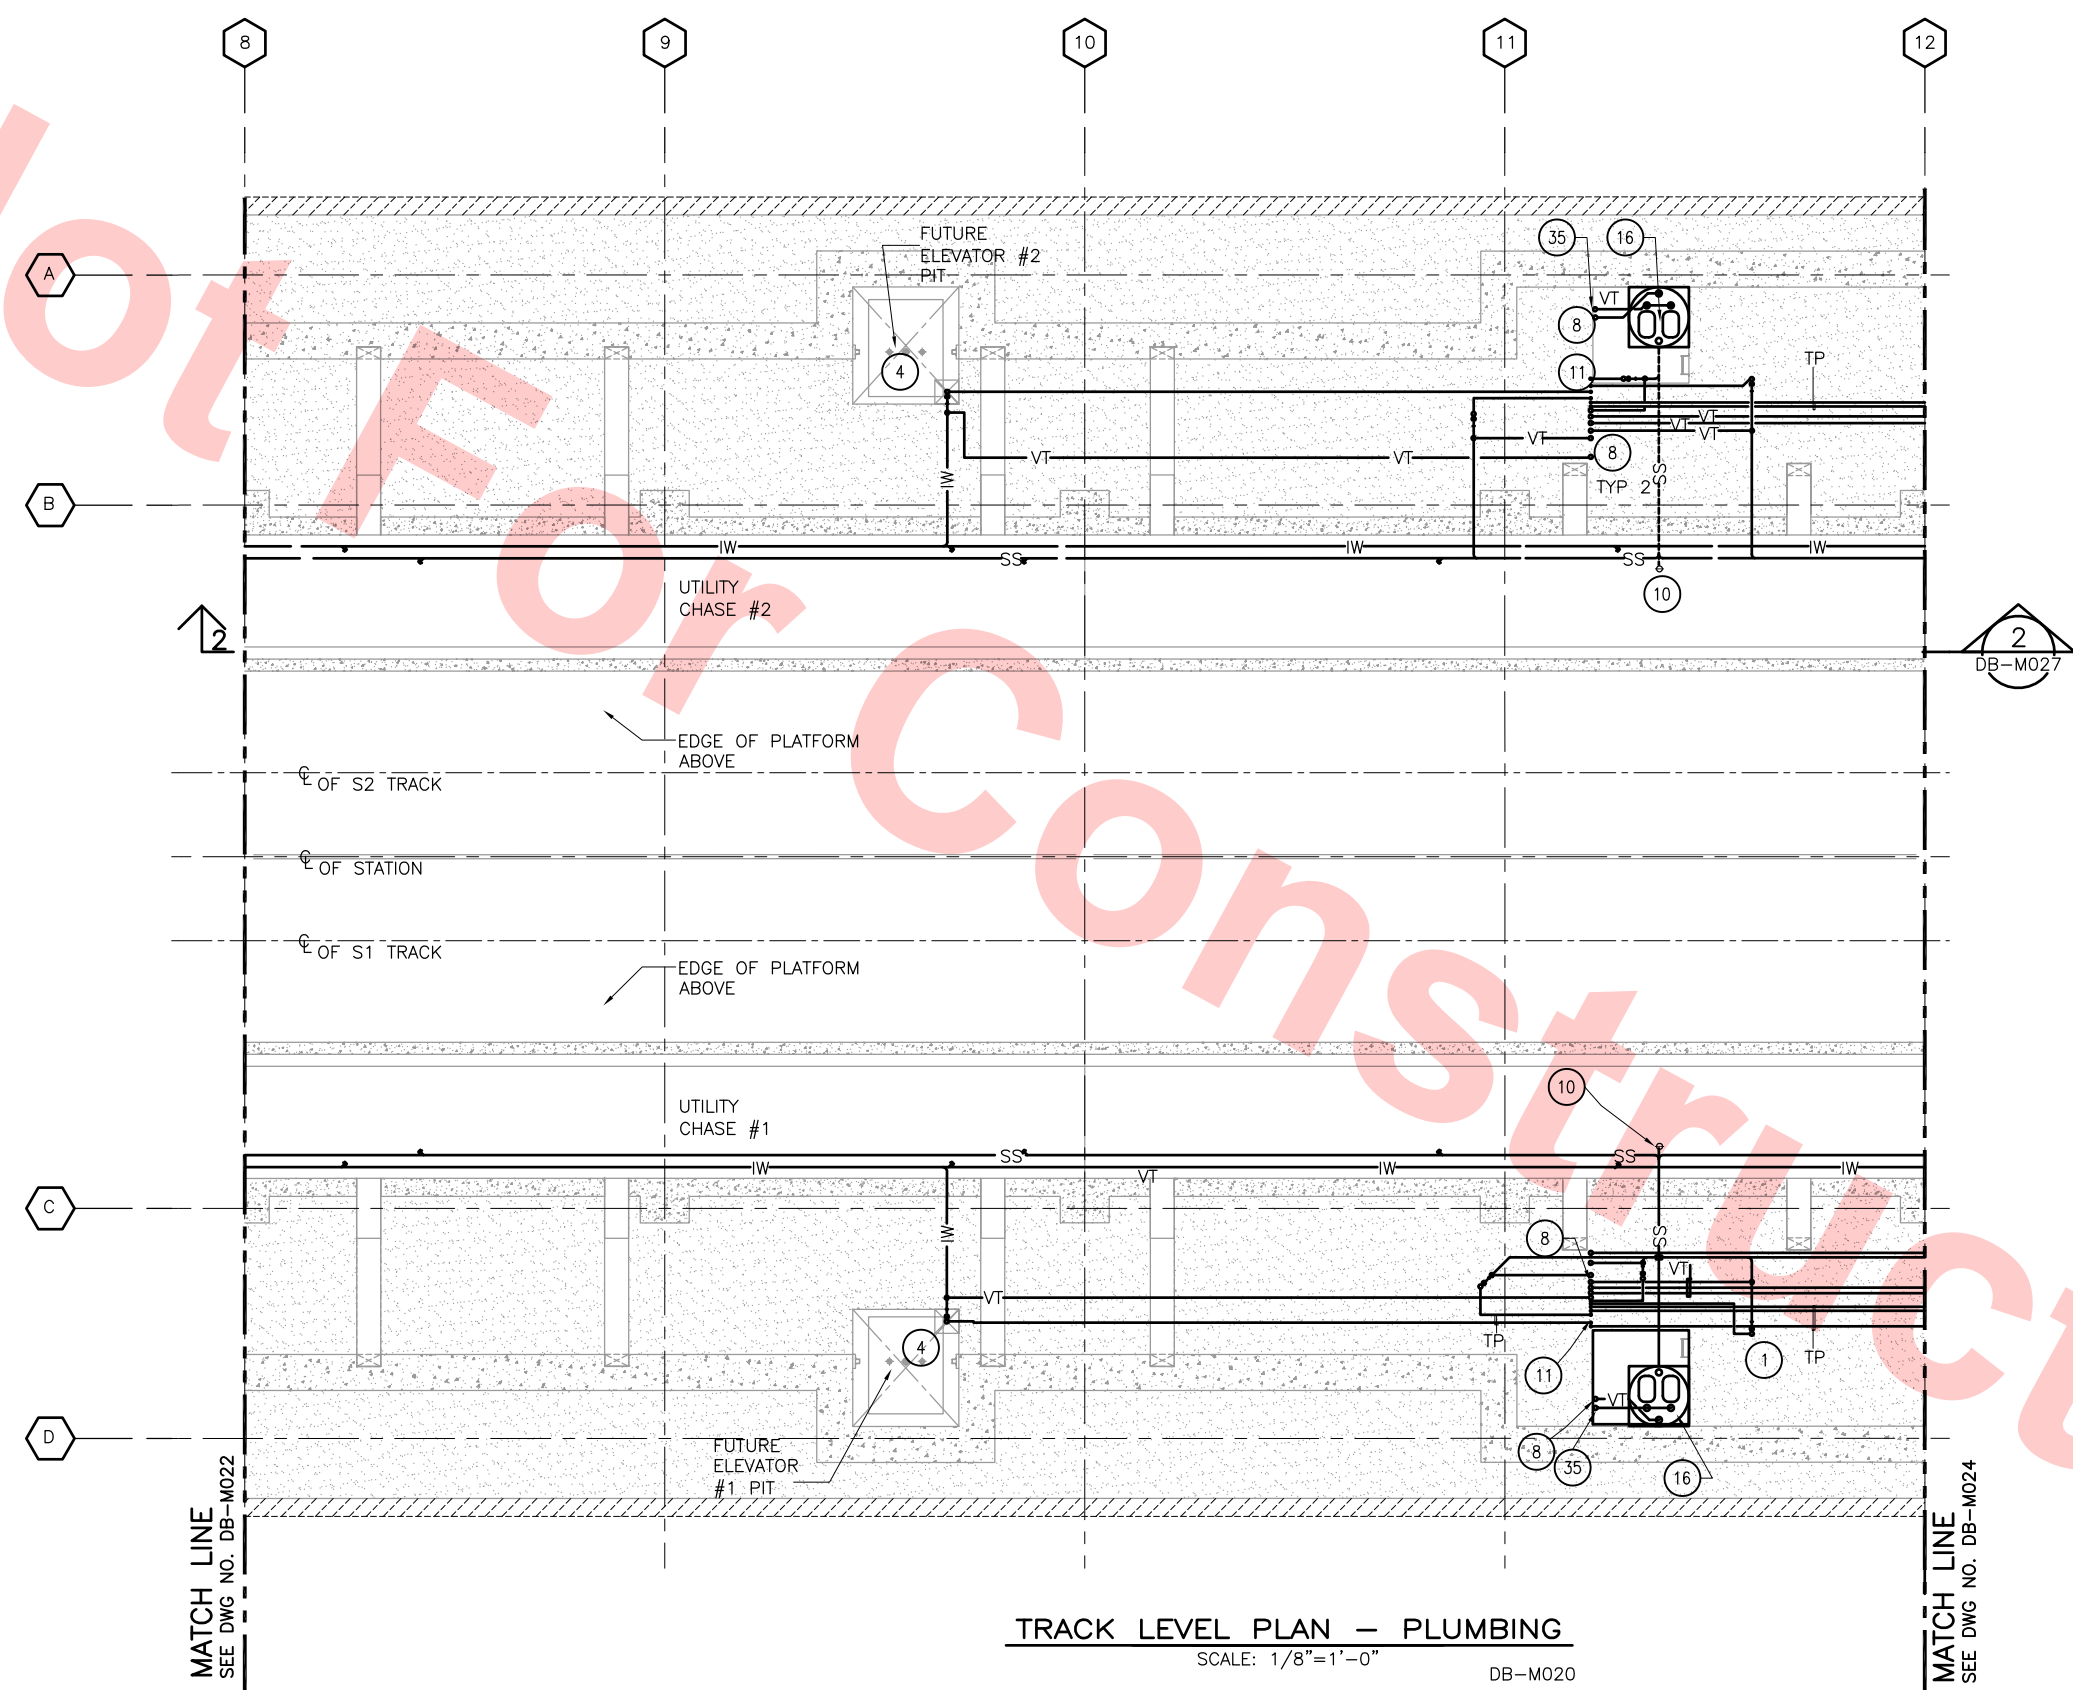

TRACK LEVEL PLAN — PLUMBING
SCALE: 1/8"=1'-0"
DB-M020

KEY NOTES

- 1 3" SS UP TO FD
- 4 3" IW UP TO ELEVATOR PIT DRAIN
- 8 2" VENT UP
- 10 4" FCO TO FINISH FLOOR
- 11 1/2" TRAP PRIMER
- 16 SS EJECTOR SUMP
- 35 SS EJECTOR DISCHARGE

Santa Clara Valley Transportation Authority

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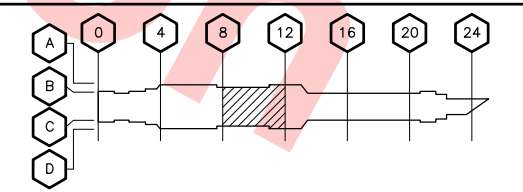
Contract No.: **DB11002F**

By: _____ Date: _____


8' 0' 8' 16'

GRAPHIC SCALE

KEY PLAN



REV	DATE	BY	SUB	APP	DESCRIPTION
0	20130710				READINESS FOR CONSTRUCTION

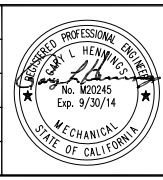

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Lookwood, Andrews & Newnam, Inc.
A LEO A DALY COMPANY

T-Y LIN INTERNATIONAL

SUBMITTED: *[Signature]* APPROVED: *[Signature]*



LINE, TRACK, STATIONS AND SYSTEMS
DESIGN UNIT 023
MILPITAS STATION
TRACK LEVEL PLAN
PLUMBING
SHEET 3 OF 6

CADD FILENAME C700-S-DB-M023.dwg			
SIZE	SCALE D 1/8"=1'-0"		
CONTRACT NO. C700		REV. 0	
AREA CODE DB	SHEET NO. M023	PAGE NO. 0671	

KEY NOTES

- 1 3" SS UP TO FD
- 3 3" IW UP TO ESCALATOR PIT DRAIN
- 9 3" FCO TO FINISH FLOOR
- 12 3" SS TO FLOOR SINK


Santa Clara Valley Transportation Authority

NO EXCEPTIONS TAKEN (NET)
MAKE CORRECTIONS NOTED (MCN)
AMEND AND RESUBMIT (A/R)



Any action shown above is subject to the terms of the contract and does not relieve the Contractor of any of its obligations under the contract, including design and detailing.

Contract No.: DB11002F

By: _____ Date: _____

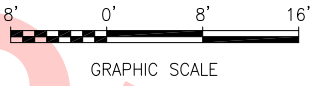


KEY PLAN

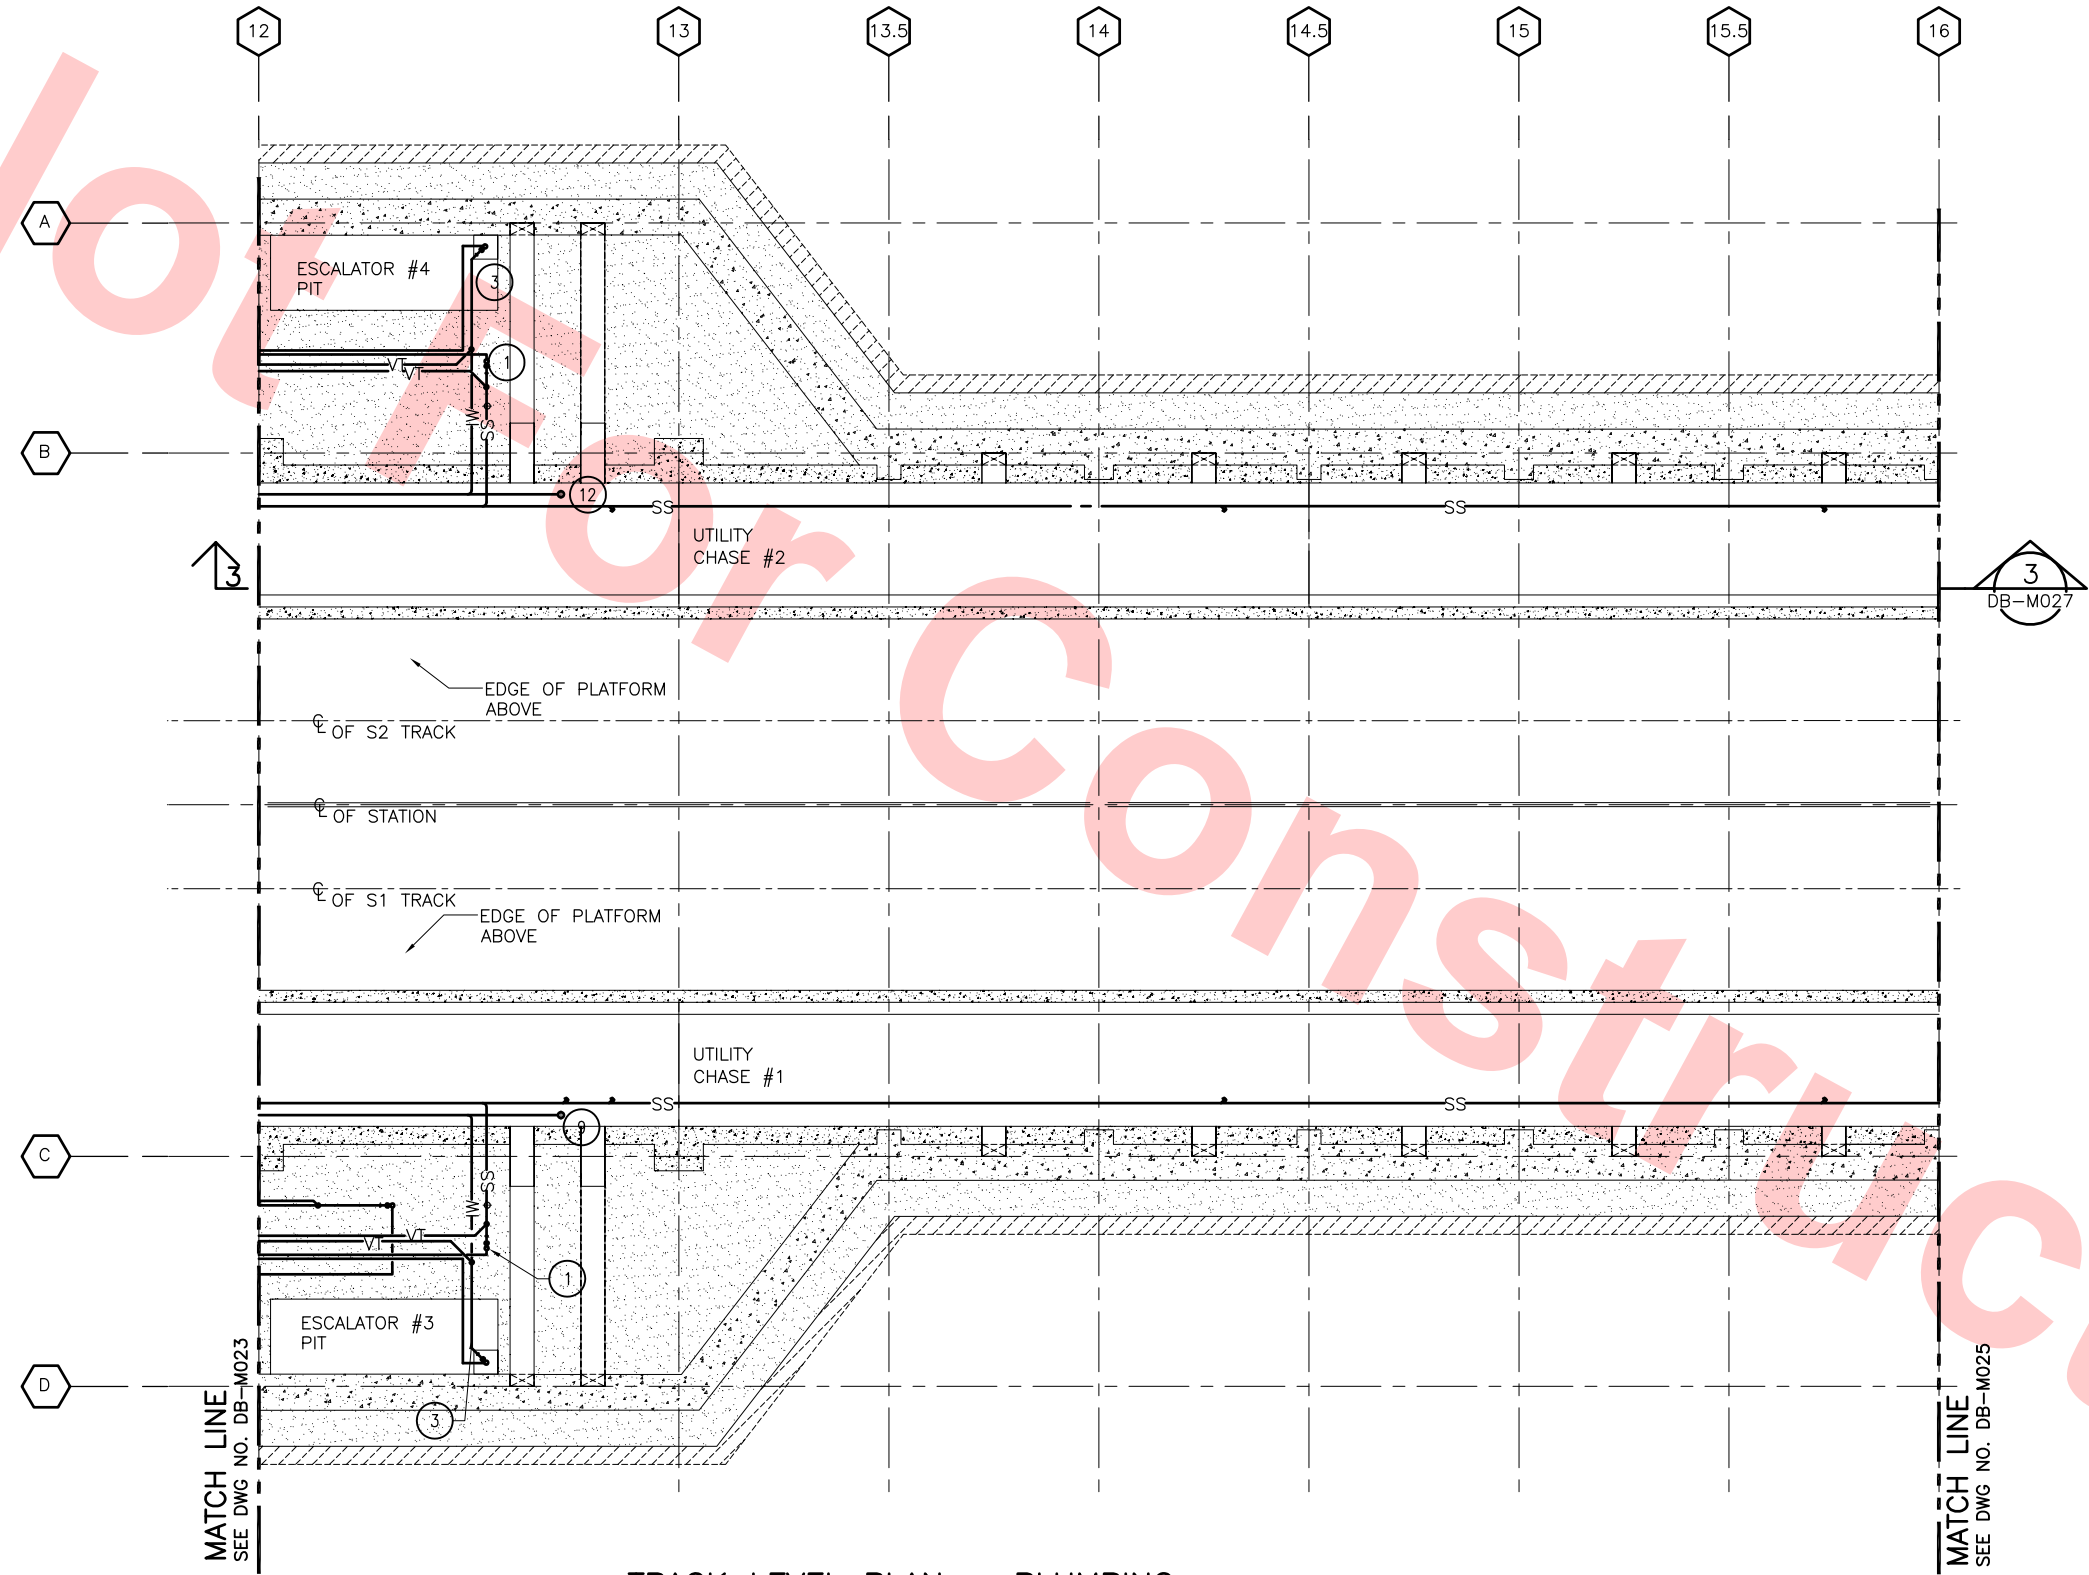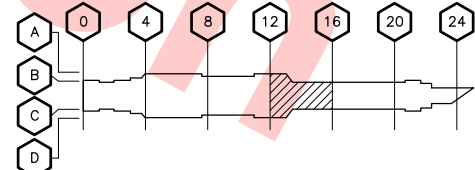

TRACK LEVEL PLAN — PLUMBING
SCALE: 1/8"=1'-0" DB-M020

DESIGNED BY	P. BLAUVELT
DRAWN BY	P. BLAUVELT
CHECKED BY	C. HENNINGS
IN CHARGE	C. HENNINGS
DATE	20130710

REV	DATE	BY	SUB	APP	DESCRIPTION
0	20130710				READINESS FOR CONSTRUCTION

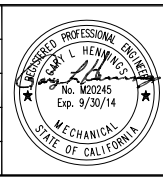

Skanska
Shimmick
Herzog

1436 California Circle
Milpitas, California 95035
A Joint Venture

Block Construction Inc.
4455 Enterprise St., Fremont, CA 94538
(510) 857-3666 Fax: (510) 857-3668
CA Lic. #679326 email: info@blockco.com


H&M Mechanical Group
8517 Eastmont Rd. #230
Oakland, CA 94621
510-569-2000

Lookwood, Andrews
& Newnam, Inc.
A LEO A DALY COMPANY

T-Y LIN INTERNATIONAL


SUBMITTED

APPROVED

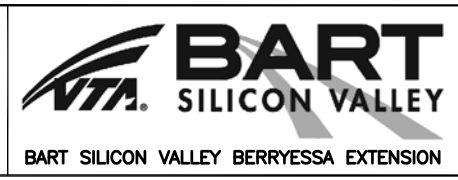

LINE, TRACK, STATIONS AND SYSTEMS
DESIGN UNIT 023
MILPITAS STATION
TRACK LEVEL PLAN
PLUMBING
SHEET 4 OF 6

CADD FILENAME	C700-S-DB-M024.dwg
SIZE	SCALE
D	1/8"=1'-0"
CONTRACT NO.	C700
AREA CODE	DB
SHEET NO.	M024
PAGE NO.	0672

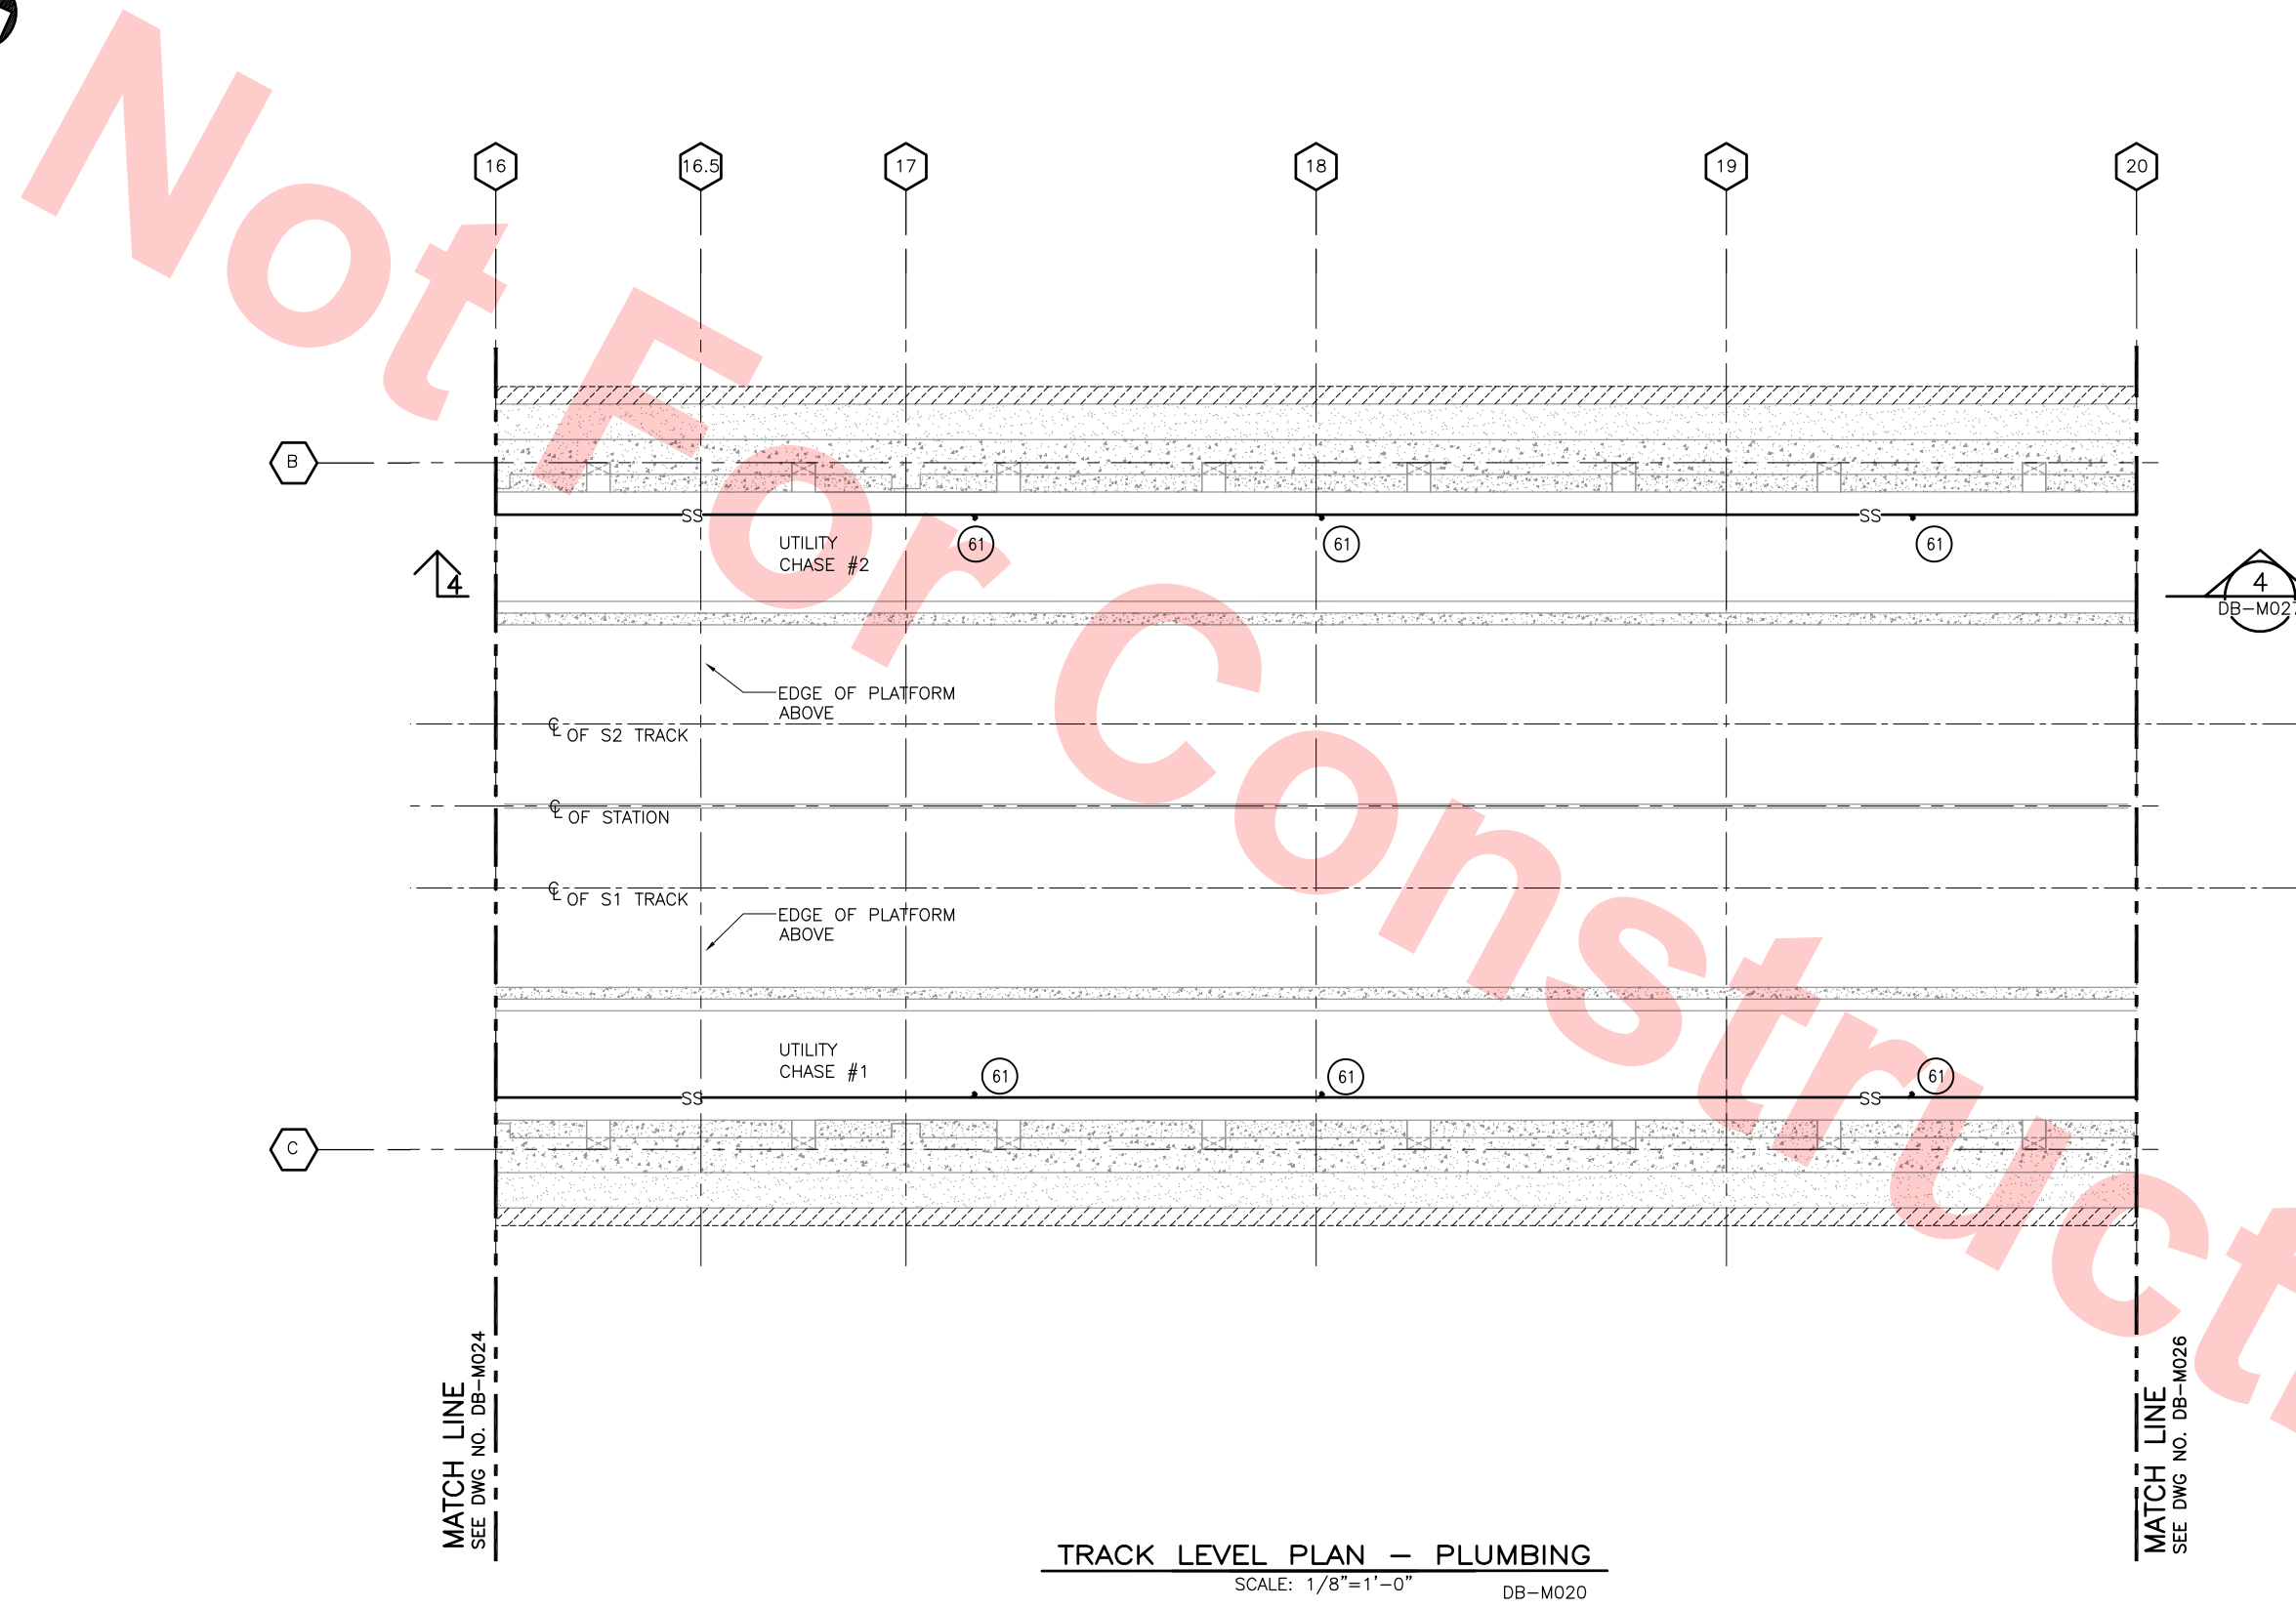

61 CLEAN OUT

MATCH LINE
SEE DWG NO. DB-M026

SCALE: 1/8"=1'-0" DB-M020

						DESIGNED BY P. BLAUVELT
						DRAWN BY P. BLAUVELT
						CHECKED BY G. HENNINGS
						IN CHARGE G. HENNINGS
0	20130710				READINESS FOR CONSTRUCTION	DATE 20130710
REV	DATE	BY	SUB	APP	DESCRIPTION	



Skanska
Shimmick
Herzog

1436 California Circle
Milpitas, California 95035
A Joint Venture



OWS | T.Y. LIN INTERNATIONAL
PANY | *E. Schenck*




BART SILICON VALLEY BERRYESSA EXTENSION

LINE, TRACK, STATIONS AND SYSTEMS
DESIGN UNIT 023
MILPITAS STATION
TRACK LEVEL PLAN
PLUMBING
SHEET 5 OF 6

CADD FILENAME C700-S-DB-M025.dwg		
SIZE D	SCALE 1/8"=1'-0"	
CONTRACT NO. C700		REV. 0
AREA CODE DB	SHEET NO. M025	PAGE NO. 0673

- 1 3" SS UP TO FD
- 2 3" SS UP TO MOP SINK
- 8 2" VENT UP
- 11 1/2" TRAP PRIMER

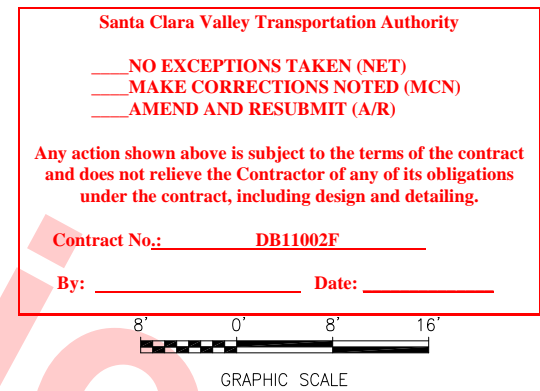

SCALE: 1/8"=1'-0"

						DESIGNED BY P. BLAUVELT
						DRAWN BY P. BLAUVELT
						CHECKED BY G. HENNINGS
						IN CHARGE G. HENNINGS
0	20130710				READINESS FOR CONSTRUCTION	DATE 20130710
REV	DATE	BY	SUB	APP	DESCRIPTION	



Skanska
Shimmick
Herzog

1436 California Circle
Milpitas, California 95035
A Joint Venture

Block Construction Inc.
4455 Enterprise St., Fremont, CA 94538
(510) 657-3686 Fax: (510) 657-3688
CA Lic. #679326 email: info@blockgainc.com

SUBMITTED

H&M H&M Mechanical Group
8517 Earhart Rd., #23
Oakland, CA 94621
510-569-2000

LAN Lockwood, Andrew & Newnam, Inc.
A LEO A DALY COMPANY


T.Y. LIN INTERNATIONAL



BART SILICON VALLEY BERRYESSA EXTENSION


LINE, TRACK, STATIONS AND SYSTEMS
DESIGN UNIT 023
MILPITAS STATION
TRACK LEVEL PLAN
PLUMBING
SHEET 6 OF 6

CADD FILENAME C700-S-DB-M020.dwg		
SIZE D	SCALE 1/32"=1'-0"	
CONTRACT NO. C700		REV. 0
AREA CODE DB	SHEET NO. M026	PAGE NO. 0674

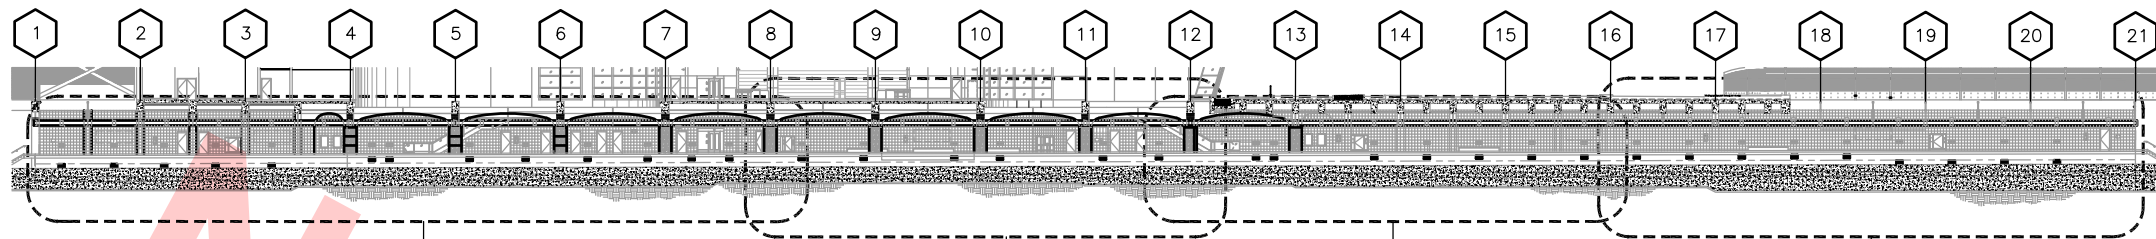


KEY NOTES	
9	3" FCO TO FINISH FLOOR
10	4" FCO TO FINISH FLOOR
61	CLEAN OUT


KEY LONGITUDINAL SECTION A
SCALE: 1/32"=1'-0"

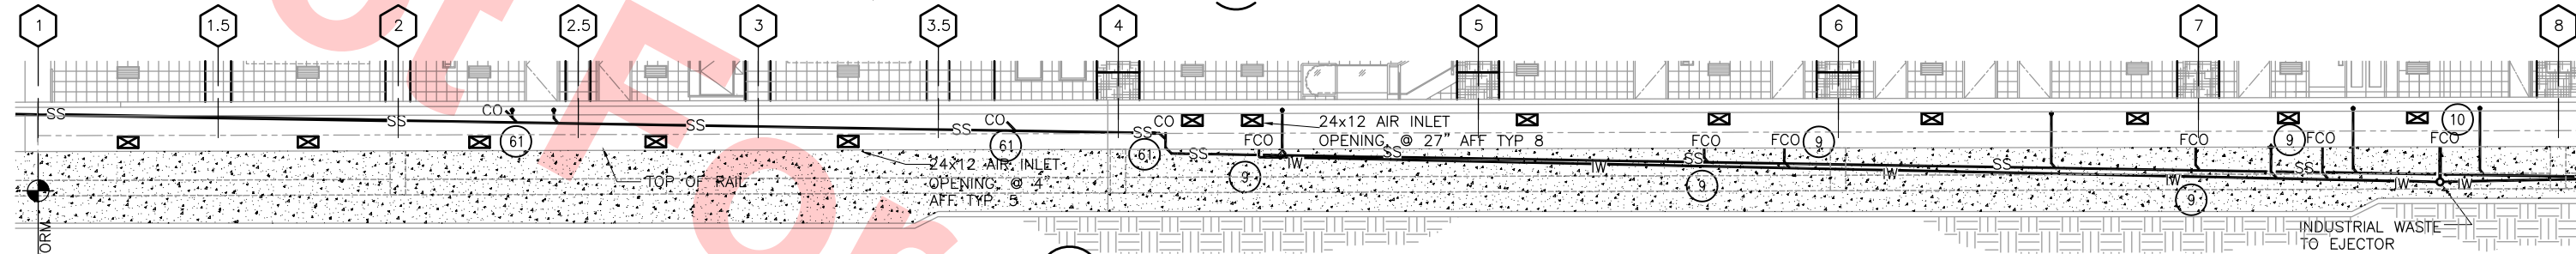


ELEVATION
SCALE: 1/8"=1'-0"

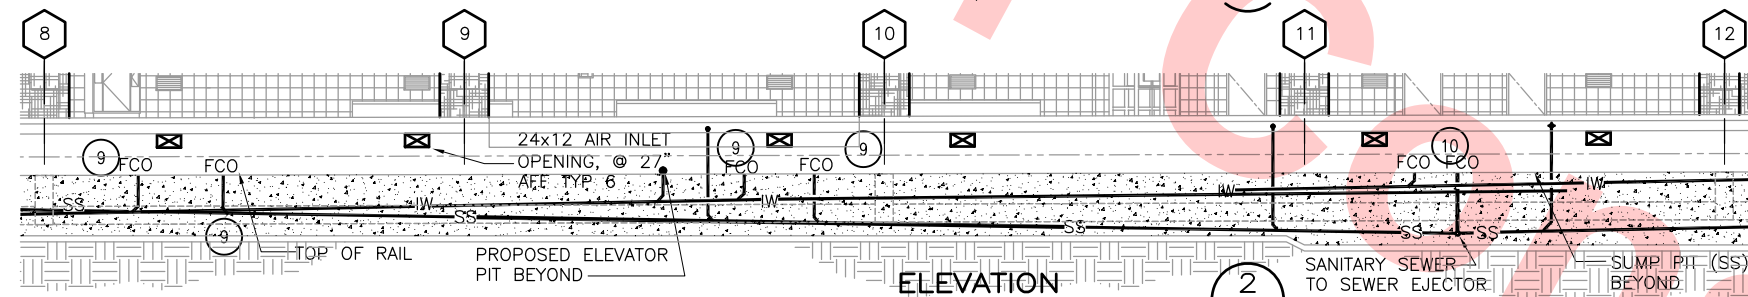

ELEVATION
SCALE: 1/8"=1'-0"

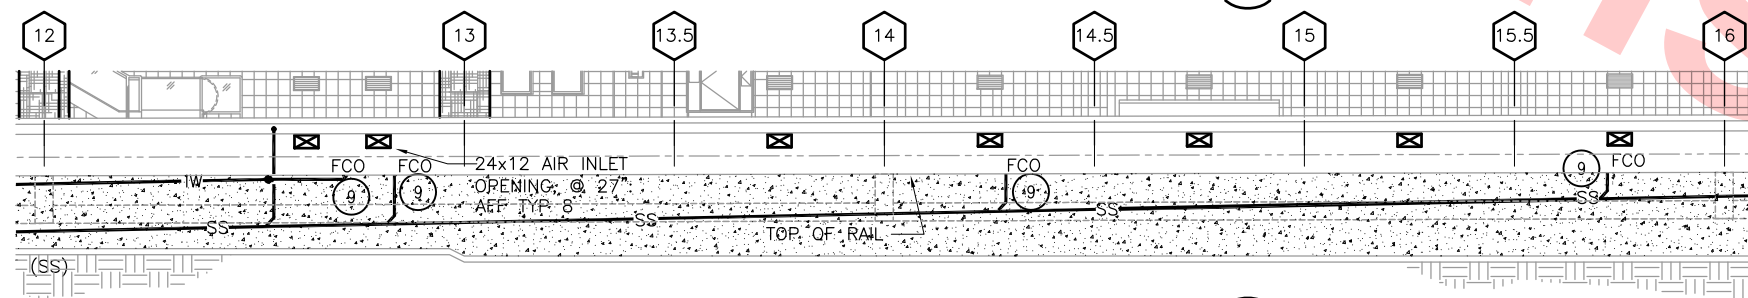

ELEVATION
SCALE: 1/8"=1'-0"

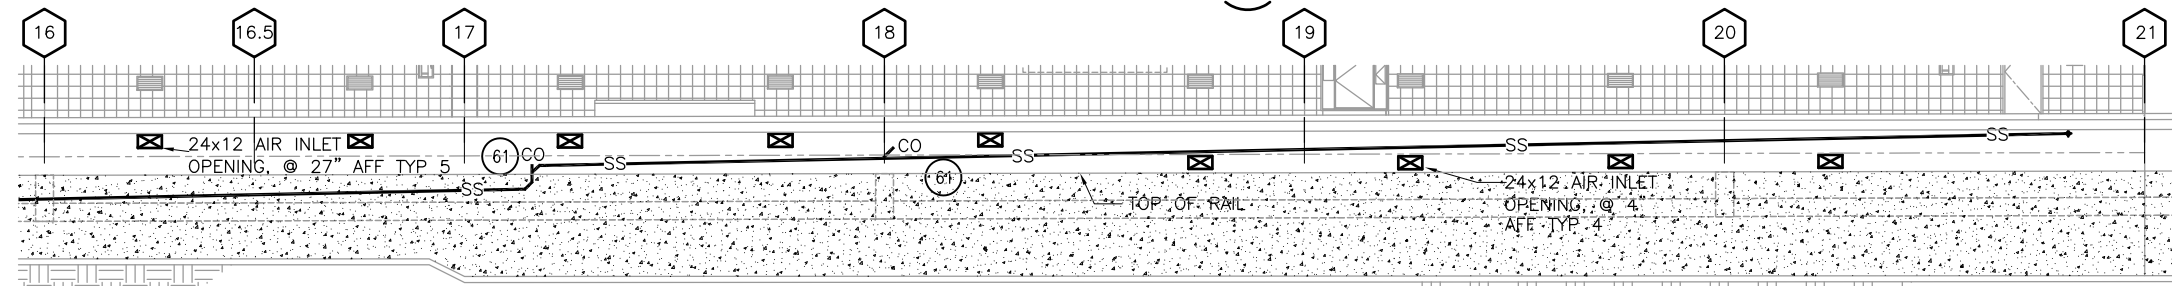

ELEVATION
SCALE: 1/8"=1'-0"

Santa Clara Valley Transportation Authority


— NO EXCEPTIONS TAKEN (NET)
— MAKE CORRECTIONS NOTED (MCN)
— AMEND AND RESUBMIT (A/R)

Any action shown above is subject to the terms of the contract and does not relieve the Contractor of any of its obligations under the contract, including design and detailing.

Contract No.: DB11002F

By: _____ Date: _____

DESIGNED BY P. BLAUVELT	0	20130710	BY	SUB	APP	READINESS FOR CONSTRUCTION
DRAWN BY P. BLAUVELT	REV	DATE	DATE	DATE	DATE	DESCRIPTION
CHECKED BY C. HENNINGS						
IN CHARGE C. HENNINGS						
DATE 20130710						

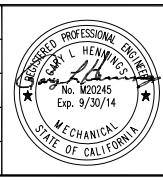

Skanska Shimmick Herzog

1436 California Circle
Milpitas, California 95035
A Joint Venture

Block Construction Inc.
4455 Enterprise St., Fremont, CA 94538
(910) 857-1888 Fax: (910) 857-1888
CA Lic. #679326 email: info@blockco.com

H&M Mechanical Group
8517 Easton Rd. #230
Oakland, CA 94621
510-569-2000

Lookwood, Andrews & Newnam, Inc.
A LEQ A BALLY COMPANY

T-Y LIN INTERNATIONAL



APPROVED *Ray Apolunth*

BART
SILICON VALLEY

BART SILICON VALLEY BERRYESSA EXTENSION

LINE, TRACK, STATIONS AND SYSTEMS
DESIGN UNIT 023
MILPITAS STATION
LONGITUDINAL SECTION
UTILITY CHASE #2 WEST WALL
HVAC & PLUMBING LAYOUT

CADD FILENAME C700-S-DB-M020.dwg	CONTRACT NO. C700	REV. 0
SIZE D	SCALE AS NOTED	
AREA CODE DB	SHEET NO. M027	PAGE NO. 0675

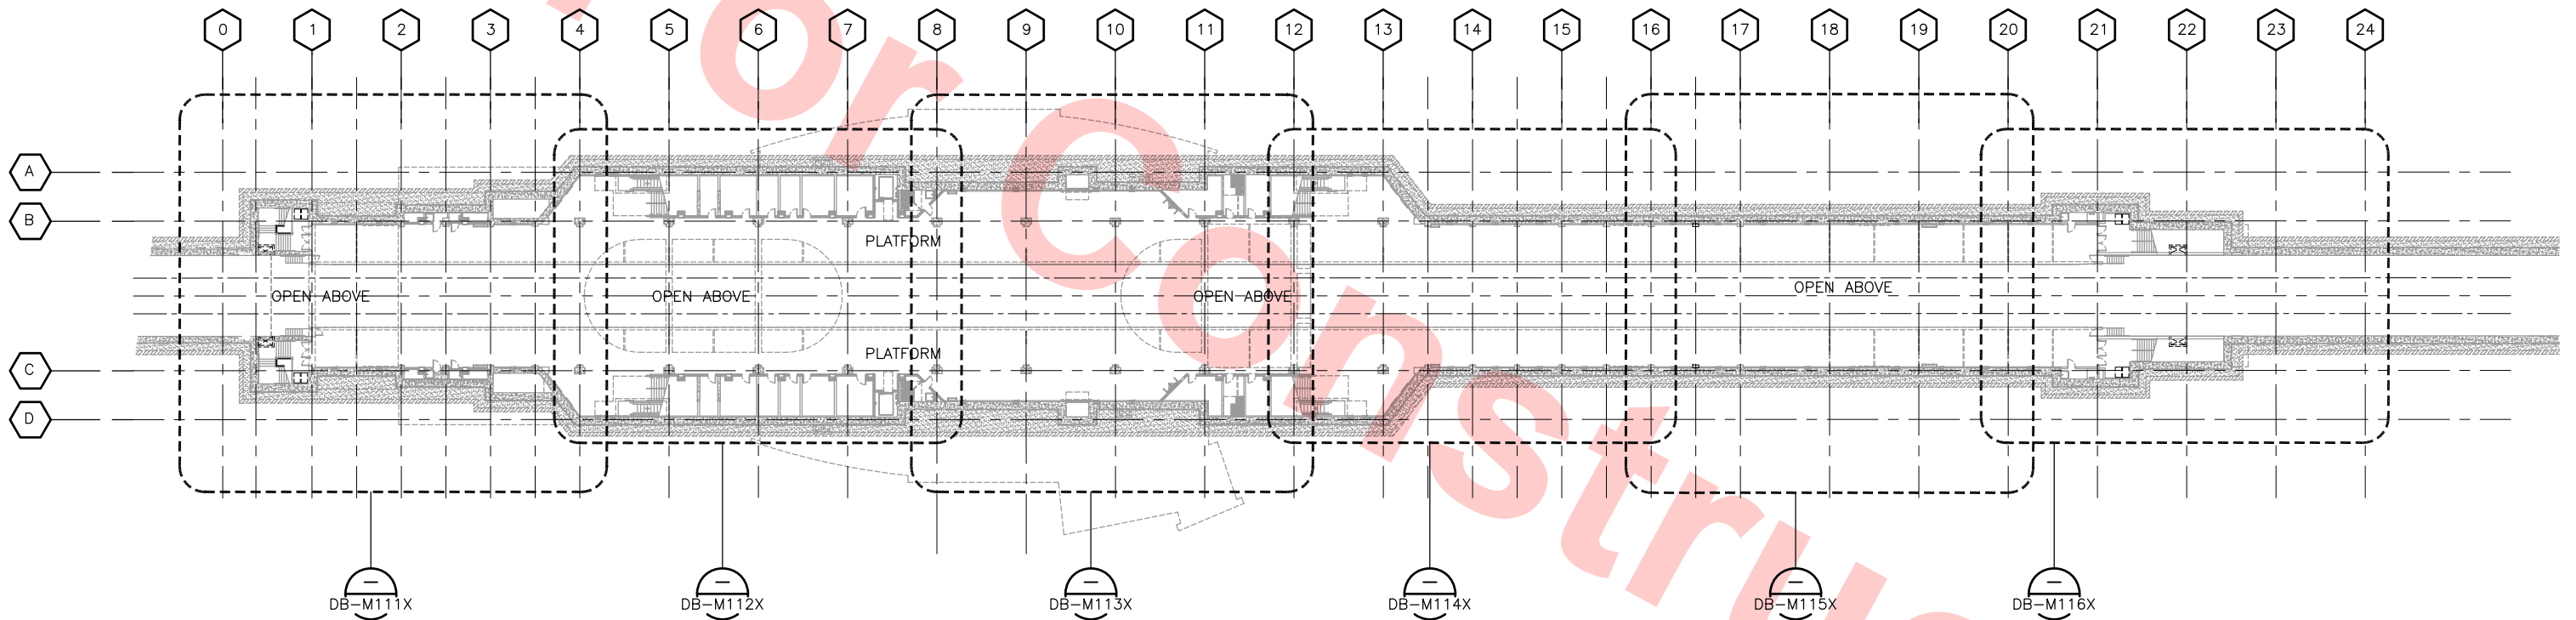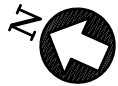

KEY PLAN PLATFORM LEVEL – HVAC
SCALE: 1/32"=1'-0"

Santa Clara Valley Transportation Authority

- ___ NO EXCEPTIONS TAKEN (NET)
- ___ MAKE CORRECTIONS NOTED (MCN)
- ___ AMEND AND RESUBMIT (A/R)

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Contract No.: DB11002F

By: _____ Date: _____



GRAPHIC SCALE

REV	DATE	BY	SUB	APP	DESCRIPTION
0	20130710				READINESS FOR CONSTRUCTION

DESIGNED BY J. CHOU	
DRAWN BY J. CHOU	
CHECKED BY G. HENNINGS	
IN CHARGE G. HENNINGS	
DATE 20130710	



Skanska Shimmick Herzog 1436 California Circle Milpitas, California 95035 A Joint Venture	Block Construction Inc. 4455 Enterprise St., Fremont, CA 94538 (510) 857-5886 Fax: (510) 857-3888 CA Lic. #679328 email: info@blockco.com	H&M Mechanical Group 8517 Canyon Rd., #225 Oakland, CA 94663 510-569-2000	Lookwood, Andrews & Newnam, Inc. A LEQ A BALLY COMPANY	T-Y LIN INTERNATIONAL
SUBMITTED 			APPROVED 	



LINE, TRACK, STATION AND SYSTEMS
DESIGN UNIT 023
MILPITAS STATION
KEY PLAN PLATFORM LEVEL
HVAC

CADD FILENAME C700-S-DB-M110.dwg	
SIZE D	SCALE 1/32"=1'-0"
CONTRACT NO. C700	REV. 0
AREA CODE DB	SHEET NO. M110
	PAGE NO. 0676

KEY NOTES

- 1 24x12 SA DUCT RISER FROM UTILITY CHASE BELOW, 24x12 SIDEWALL REGISTER (TYP). PRICE INDUSTRIES MODEL 720, REAR FIXED BLADE AT 30° (FIXED TOWARD THE NORTH). FIXED FRONT BLADE WITH A 25° LIFT ANGLE. MOUNT AT 24" AFF.
- 2 L-1 MOUNTED AT 10'-0" AFF. FSD IN WALL, 18x18 MERV 8 FILTER AT OPENING

Santa Clara Valley Transportation Authority

- NO EXCEPTIONS TAKEN (NET)
MAKE CORRECTIONS NOTED (MCN)
AMEND AND RESUBMIT (A/R)

Any action shown above is subject to the terms of the contract and does not relieve the Contractor of any of its obligations under the contract, including design and detailing.


Contract No.: DB11002F

By: Date:



GRAPHIC SCALE

KEY PLAN

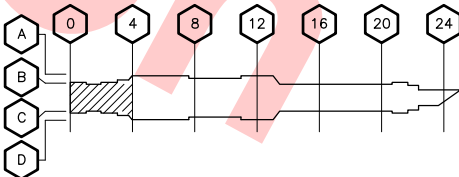

PLATFORM LEVEL PLAN - HVAC

SCALE: 1/8"=1'-0" DB-M110

DESIGNED BY
J. CHOU
DRAWN BY
J. CHOU
CHECKED BY
C. HENNINGS
IN CHARGE
C. HENNINGS
DATE
20130710



Block Construction Inc.
4455 Enterprise St., Fremont, CA 94538
(510) 857-3888 Fax: (510) 857-3889
CA Lic. #679326 email: info@blockco.com

Skanska
Shimmick
Herzog

1436 California Circle
Milpitas, California 95035
A Joint Venture

H&M Mechanical Group
8517 Eastmont Rd. #230
Oakland, CA 94621
510-569-2000

Lookwood, Andrews
& Newnam, Inc.
A LEO A DALY COMPANY



T-Y-LIN INTERNATIONAL



BART SILICON VALLEY BERRYESSA EXTENSION

LINE, TRACK, STATION AND SYSTEMS
DESIGN UNIT 023
MILPITAS STATION
PLATFORM LEVEL PLAN
HVAC
SHEET 1 OF 6

CADD FILENAME
C700-S-DB-M111X.dwg
SIZE SCALE
D 1/8"=1'-0"
CONTRACT NO. C700 REV. 0
AREA CODE SHEET NO. PAGE NO.
DB M111X 0677

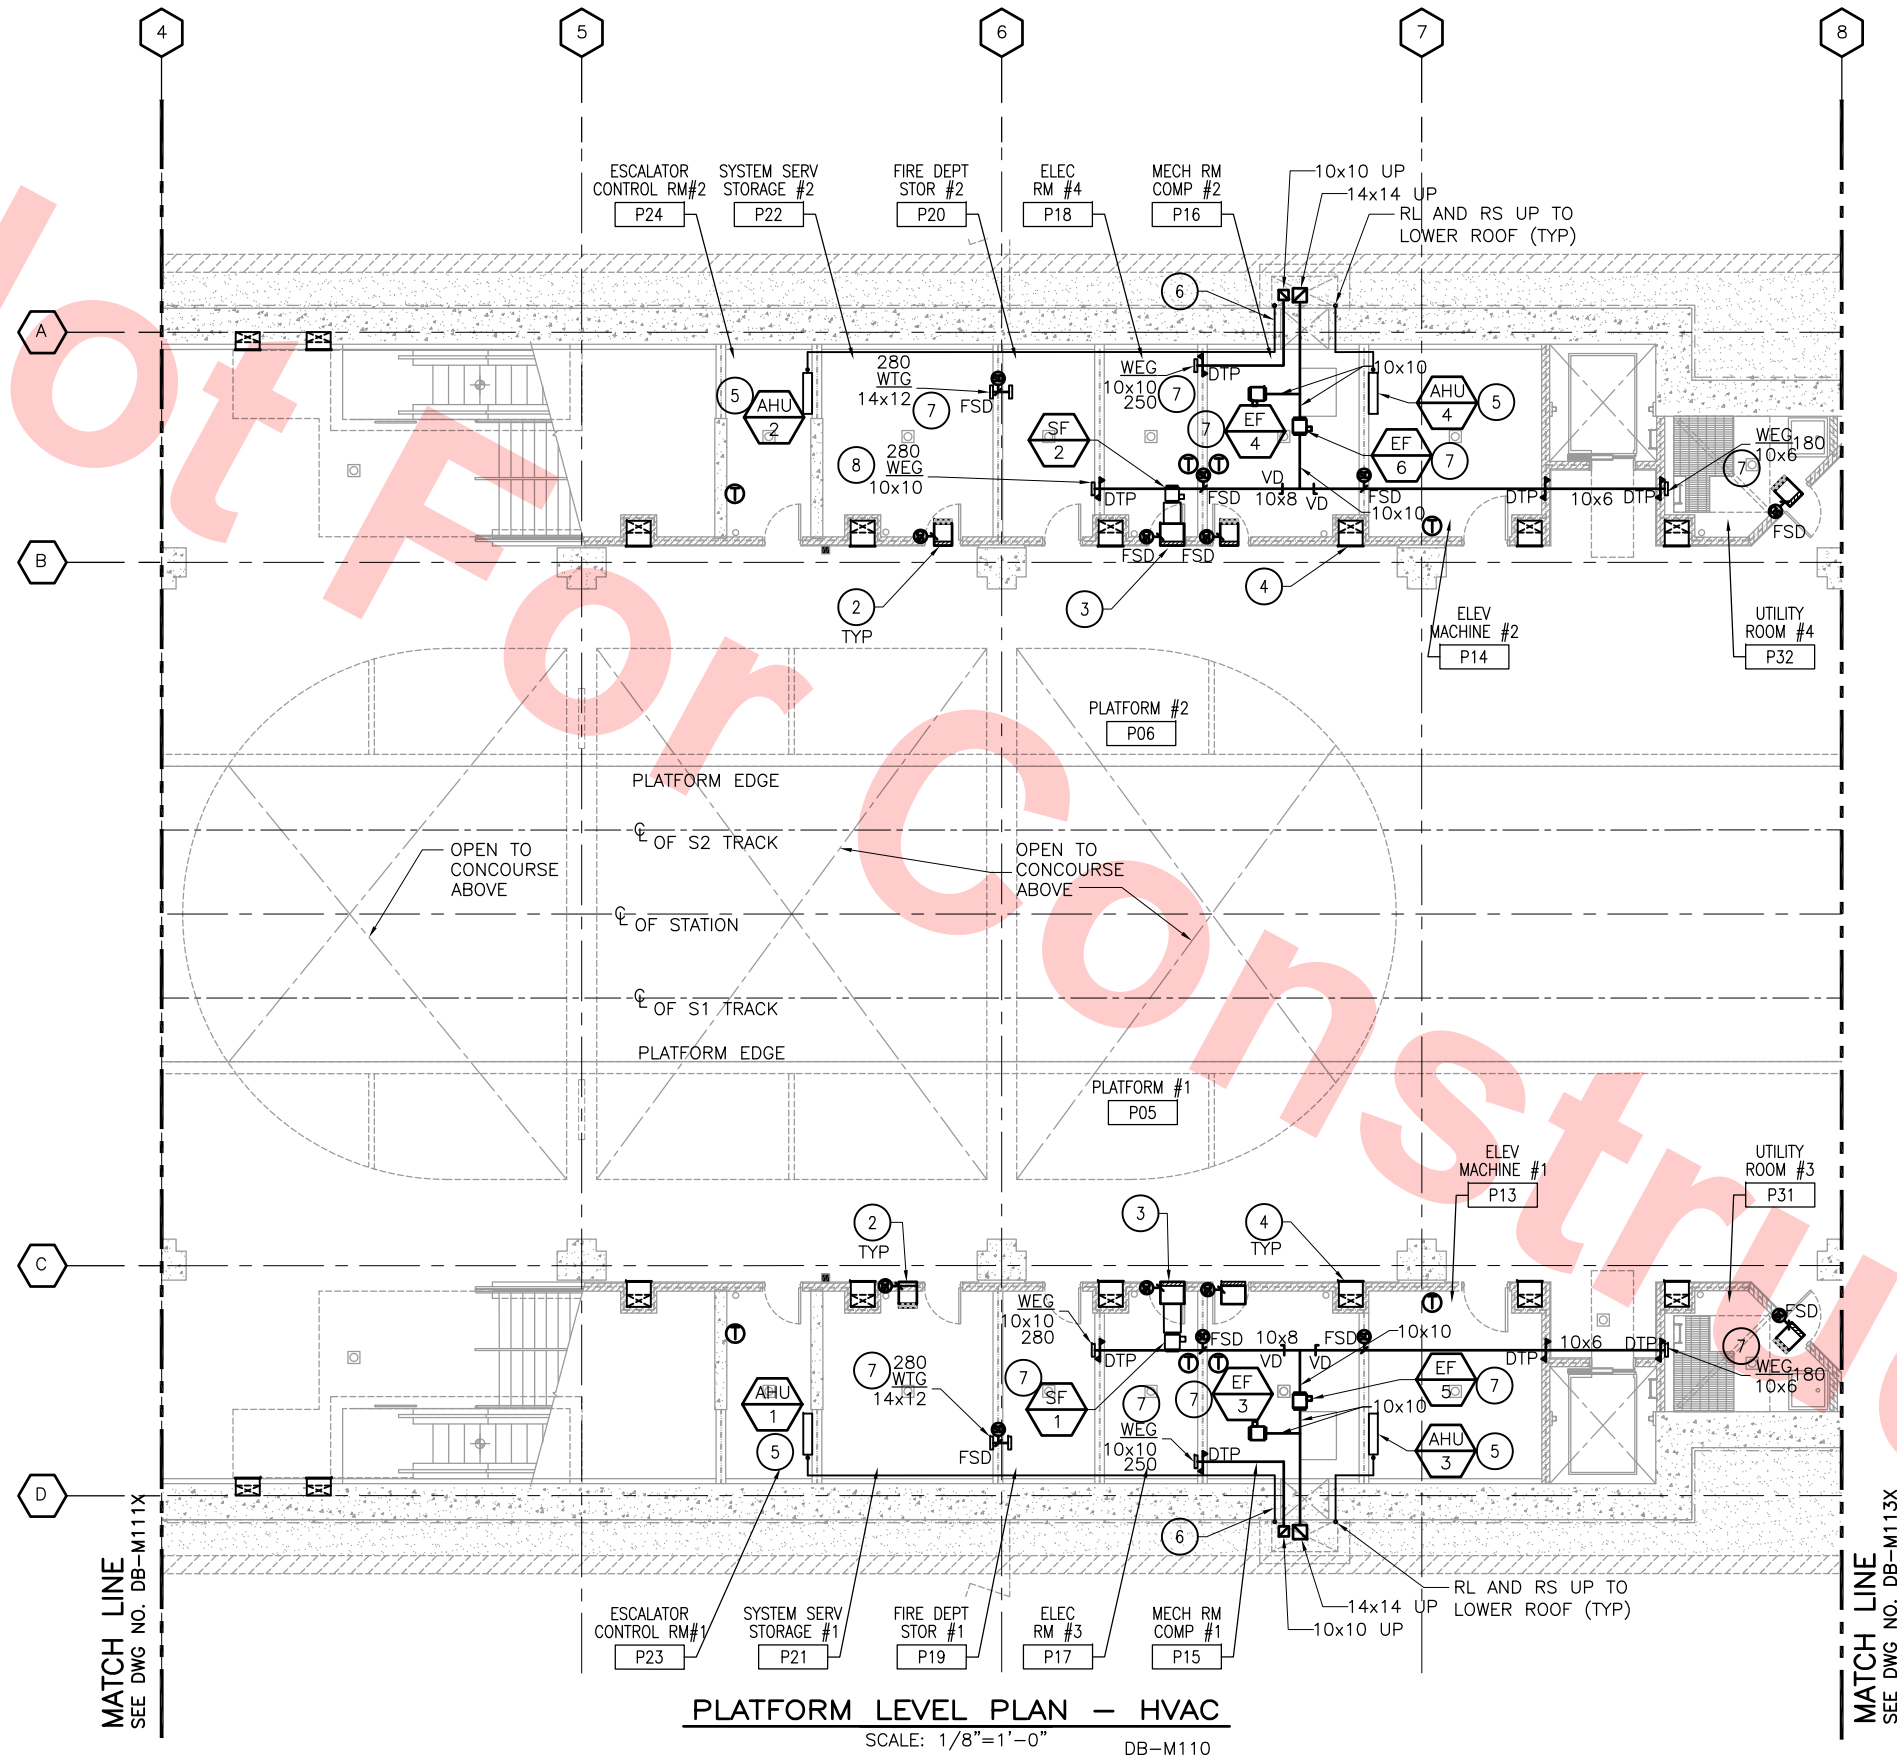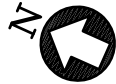

PLATFORM LEVEL PLAN - HVAC

SCALE: 1/8"=1'-0"

DB-M110

KEY NOTES

- 2 L-1 MOUNTED AT 10'-0" AFF. FSD IN WALL, 18x18 MERV 8 FILTER AT OUTLET OPENING
- 3 L-2 MOUNTED AT 10'-0" AFF. FSD IN WALL
- 4 24x12 SA DUCT RISER FROM UTILITY CHASE BELOW, 24x12 SIDEWALL REGISTER (TYP). PRICE INDUSTRIES MODEL 720, REAR BLADES FIXED STRAIGHT. FIXED FRONT BLADES WITH A 25° LIFT ANGLE. MOUNT AT 24" AFF.
- 5 MOUNT AHU 7'-6" AFF. EXTEND RL AND RS LINES TO ASSOCIATED OUTDOOR UNIT ON LOWER ROOF.
- 6 SEAL PIPE AND DUCT PENETRATIONS WITH 3M FIREMASTER CP 25WB+ SEALANT
- 7 MOUNT AT 12'-0" AFF


Santa Clara Valley Transportation Authority

- NO EXCEPTIONS TAKEN (NET)
- MAKE CORRECTIONS NOTED (MCN)
- AMEND AND RESUBMIT (A/R)

Any action shown above is subject to the terms of the contract and does not relieve the Contractor of any of its obligations under the contract, including design and detailing.


Contract No.: DB11002F

By: _____ Date: _____

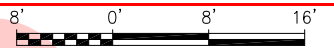

GRAPHIC SCALE

KEY PLAN

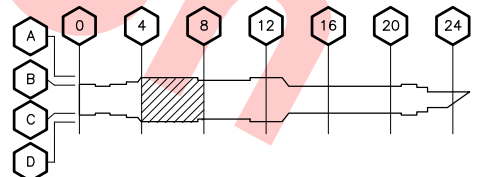

REV	DATE	BY	SUB	APP	DESCRIPTION
0	20130710				READINESS FOR CONSTRUCTION

DESIGNED BY J. CHOU	
DRAWN BY J. CHOU	
CHECKED BY G. HENNINGS	
IN CHARGE G. HENNINGS	
DATE 20130710	



Block Construction Inc.
4455 Enterprise St., Fremont, CA 94538
(510) 807-5666 Fax: (510) 807-5668
CA Lic. #679326 email: info@blockco.com

Skanska
Shimmick
Herzog
H&M Mechanical Group
8517 Eastmont Rd. #230
Oakland, CA 94621
510-569-2000


1436 California Circle
Milpitas, California 95035
A Joint Venture

Lookwood, Andrews
& Newman, Inc.
T-Y LIN INTERNATIONAL
APPROVED

BART
SILICON VALLEY
BART SILICON VALLEY BERRYESSA EXTENSION

LINE, TRACK, STATION AND SYSTEMS
DESIGN UNIT 023
MILPITAS STATION
PLATFORM LEVEL PLAN
HVAC
SHEET 2 OF 6

CADD FILENAME C700-S-DB-M112X.dwg	REV. 0
SIZE SCALE D 1/8"=1'-0"	
CONTRACT NO. C700	
AREA CODE DB	SHEET NO. M112X
	PAGE NO. 0678

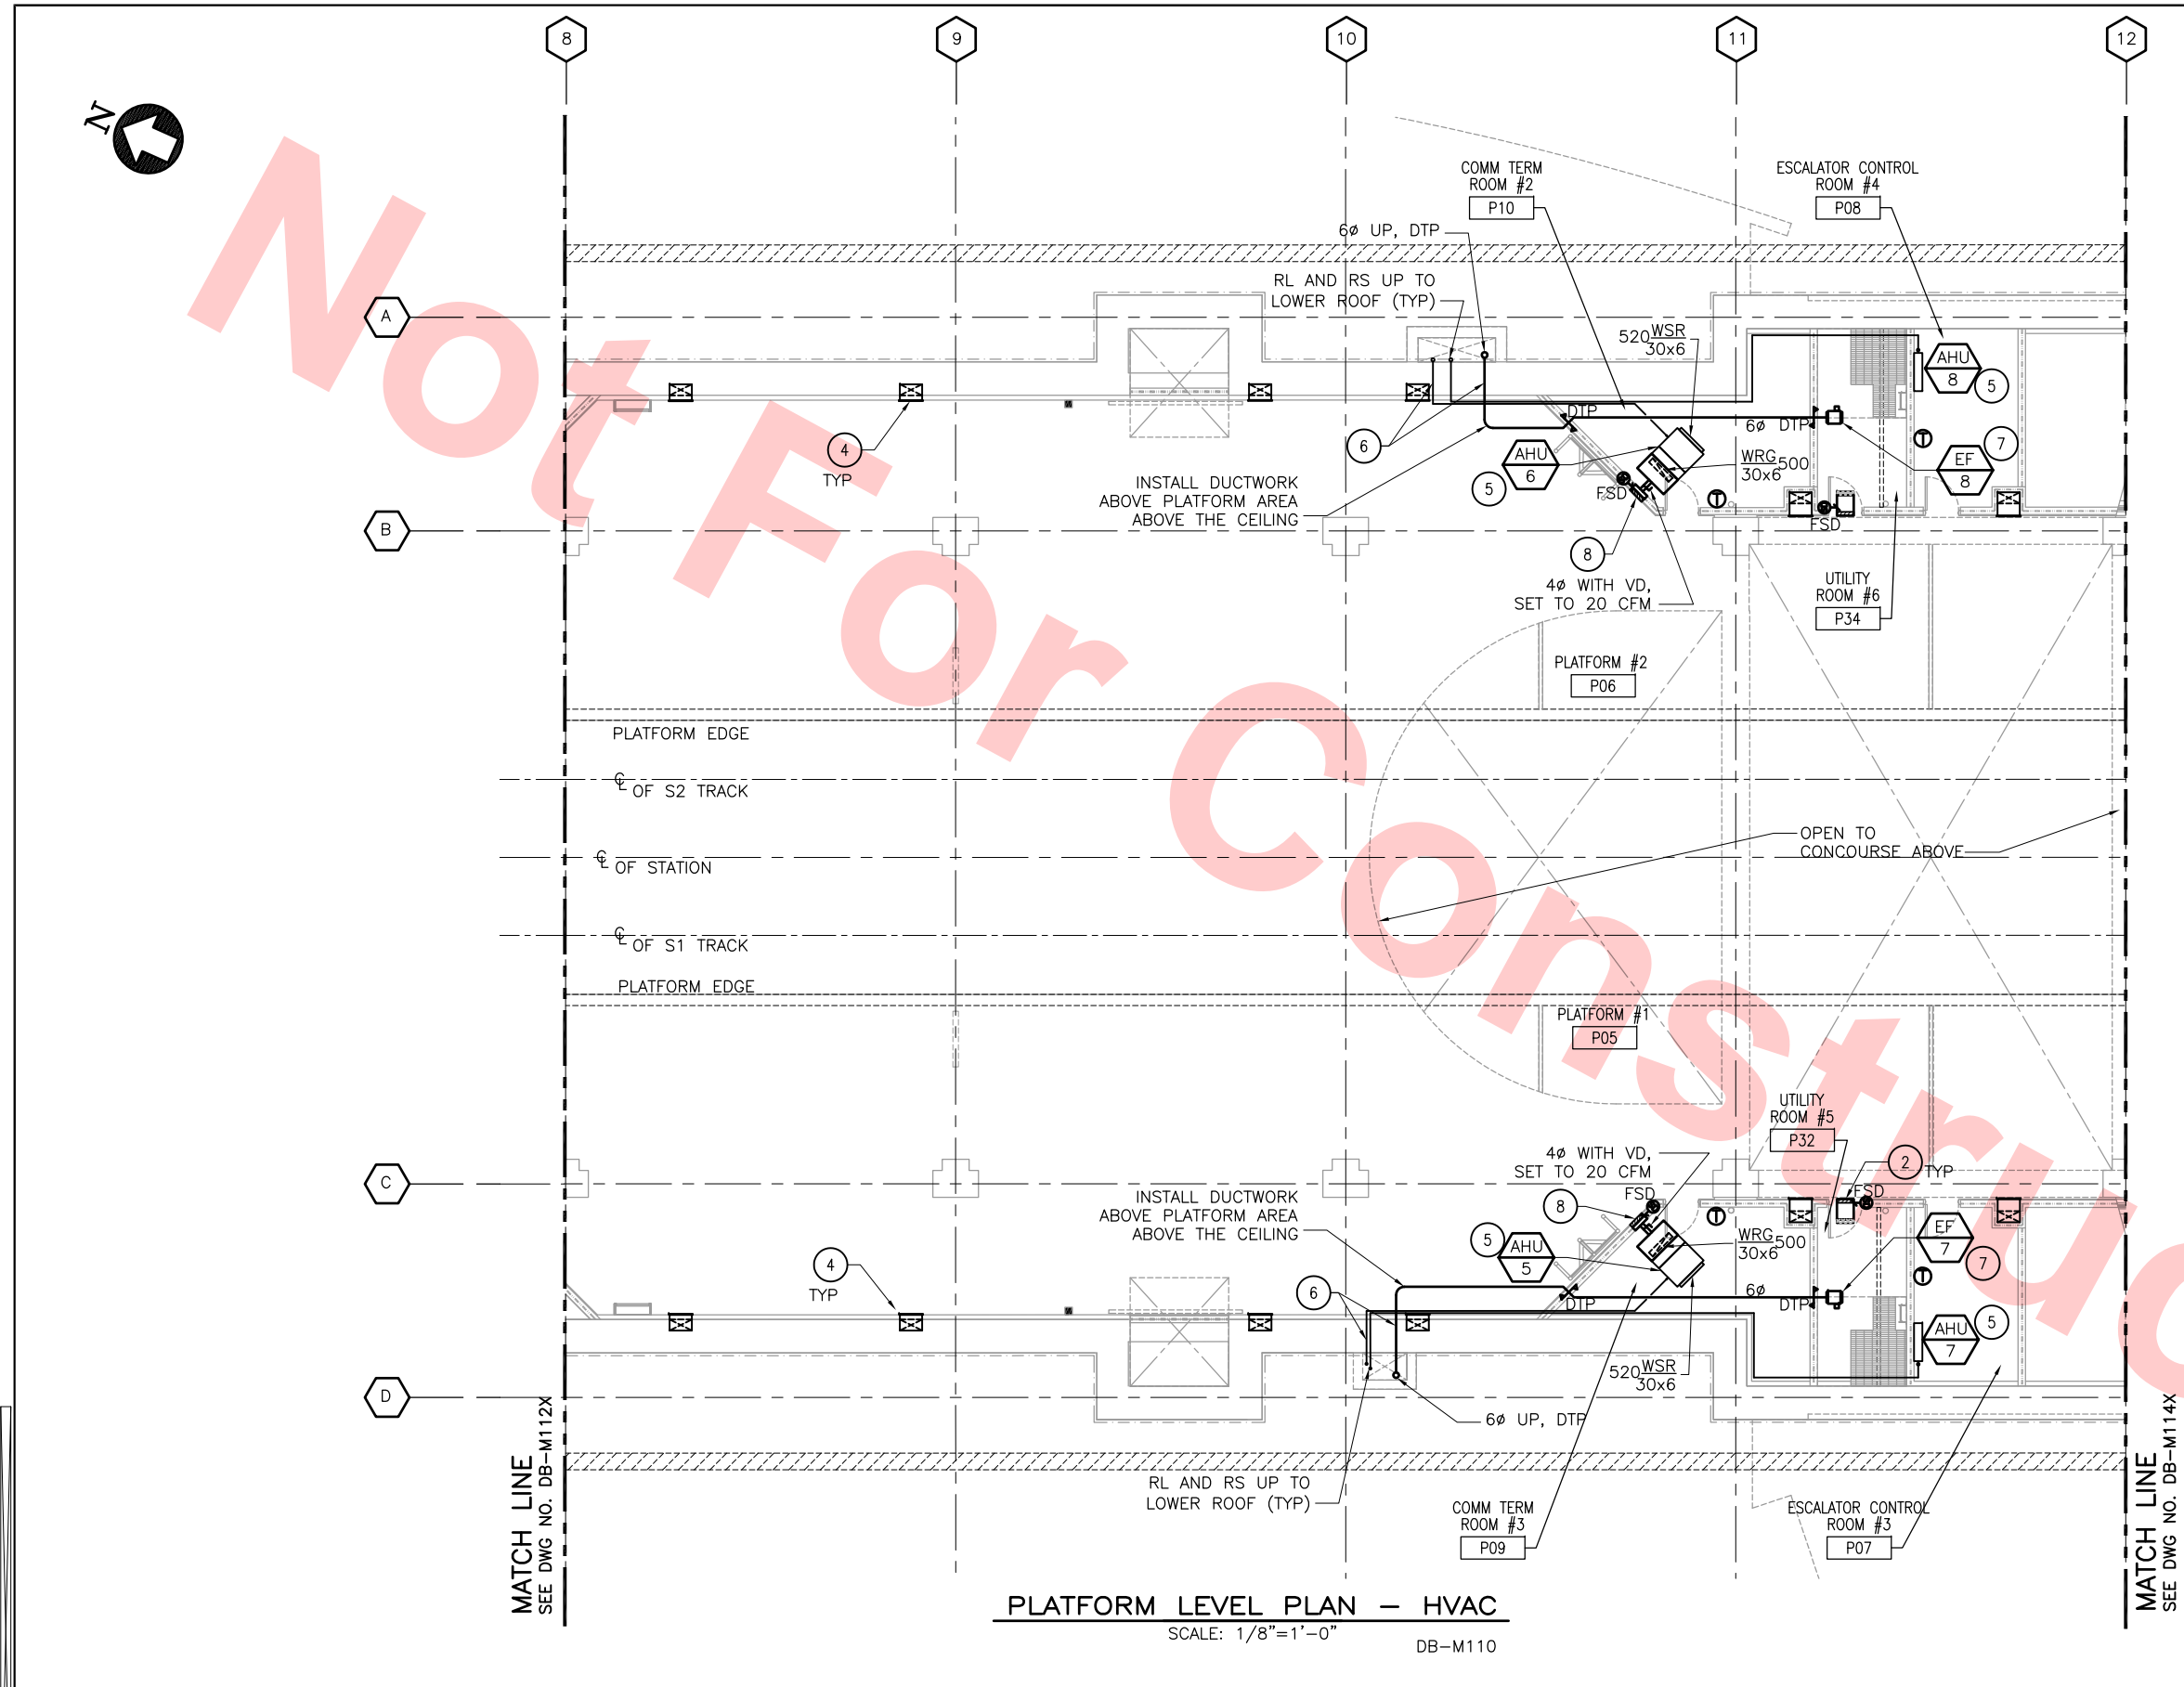

PLATFORM LEVEL PLAN - HVAC
SCALE: 1/8"=1'-0"
DB-M110

KEY NOTES

- 2 L-1 MOUNTED AT 10'-0" AFF. FSD IN WALL, 18x18 MERV 8 FILTER AT OUTLET OPENING
- 3 L-2 MOUNTED AT 10'-0" AFF. FSD IN WALL
- 4 24x12 SA DUCT RISER FROM UTILITY CHASE BELOW, 24x12 SIDEWALL REGISTER (TYP). PRICE INDUSTRIES MODEL 720, REAR BLADES FIXED STRAIGHT. FIXED FRONT BLADES WITH A 25° LIFT ANGLE. MOUNT AT 24" AFF.
- 5 MOUNT AHU 7'-6" AFF. EXTEND RL AND RS LINES TO ASSOCIATED OUTDOOR UNIT ON LOWER ROOF.
- 6 SEAL PIPE AND DUCT PENETRATIONS WITH 3M FIREMASTER CP 25WB+ SEALANT
- 7 MOUNT AT 12'-0" AFF
- 8 L-1 MOUNTED AT 7'-6" AFF

Santa Clara Valley Transportation Authority

NO EXCEPTIONS TAKEN (NET)
MAKE CORRECTIONS NOTED (MCN)
AMEND AND RESUBMIT (A/R)


Any action shown above is subject to the terms of the contract and does not relieve the Contractor of any of its obligations under the contract, including design and detailing.

Contract No.: DB11002F


By: _____ Date: _____



KEY PLAN

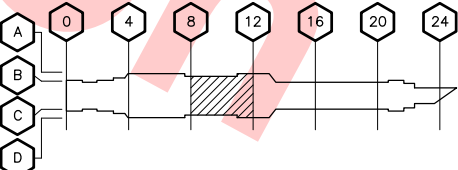

DESIGNED BY J. CHOU	0	20130710				READINESS FOR CONSTRUCTION
DRAWN BY J. CHOU	REV	DATE	BY	SUB	APP	DESCRIPTION
CHECKED BY G. HENNINGS						
IN CHARGE G. HENNINGS						
DATE 20130710						

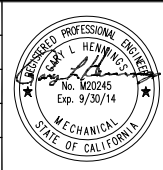

Skanska Shimmick Herzog

1436 California Circle
Milpitas, California 95035
A Joint Venture

Block Construction Inc.
4455 Enterprise St., Fremont, CA 94538
(510) 857-3888 Fax: (510) 857-3889
CA Lic. #679326 email: info@blockco.com

HMM Mechanical Group
8517 Eastmont Rd. #230
Oakland, CA 94621
510-569-2000

Lookwood, Andrews & Newnam, Inc.
A LEOP A BALLY COMPANY

T-Y LIN INTERNATIONAL

APPROVED *[Signature]*



LINE, TRACK, STATION AND SYSTEMS
DESIGN UNIT 023
MILPITAS STATION
PLATFORM LEVEL PLAN
HVAC
SHEET 3 OF 6

CADD FILENAME
C700-S-DB-M113X.dwg

SIZE SCALE
D 1/8"=1'-0"

CONTRACT NO. C700 REV. 0

AREA CODE SHEET NO. PAGE NO.
DB M113X 0679

KEY NOTES

- 4 24x12 SA DUCT RISER FROM UTILITY CHASE BELOW, 24x12 SIDEWALL REGISTER (TYP). PRICE INDUSTRIES MODEL 720, REAR FIXED BLADE AT 30° (FIXED TOWARD THE SOUTH). FIXED FRONT BLADE WITH A 25° LIFT ANGLE. MOUNT AT 24" AFF.
- 9 24x12 SA RISER FROM UTILITY CHASE BELOW, 24x12 SIDEWALL REGISTER (TYP). PRICE INDUSTRIES MODEL 720, REAR FIXED BLADE AT 30° (FIXED TOWARD THE SOUTH). FIXED FRONT BLADE WITH A 25° LIFT ANGLE. MOUNT AT 24" AFF.

Santa Clara Valley Transportation Authority

- NO EXCEPTIONS TAKEN (NET)
MAKE CORRECTIONS NOTED (MCN)
AMEND AND RESUBMIT (A/R)

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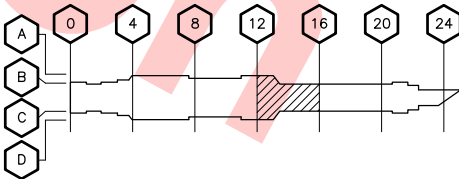
Contract No.: DB11002F

By: Date:



GRAPHIC SCALE

KEY PLAN



PLATFORM LEVEL PLAN — HVAC

SCALE: 1/8"=1'-0"

DB-M110

MATCH LINE
SEE DWG NO. DB-M113X

MATCH LINE
SEE DWG NO. DB-M115X

DESIGNED BY
J. CHOU
DRAWN BY
J. CHOU
CHECKED BY
G. HENNINGS
IN CHARGE
G. HENNINGS
DATE
20130710



BCT Block Construction Inc.
4455 Enterprise St., Fremont, CA 94538
(510) 857-5666 Fax: (510) 857-5666
CA Lic. #679326 email: info@bctca.com

Skanska
Shimmick
Herzog

1436 California Circle
Milpitas, California 95035
A Joint Venture

H&M Mechanical Group
8517 Eastmont Rd. #230
Oakland, CA 94621
510-569-2000

Lookwood, Andrews
& Newman, Inc.
A LEOPOLD & WOLFF COMPANY

T-Y-LIN INTERNATIONAL

APPROVED

By: [Signature]



BART SILICON VALLEY BERRYESSA EXTENSION

LINE, TRACK, STATIONS AND SYSTEMS
DESIGN UNIT 023
MILPITAS STATION
PLATFORM LEVEL PLAN
HVAC
SHEET 4 OF 6

CADD FILENAME
C700-S-DB-M114X.dwg
SIZE SCALE
D 1/8"=1'-0"
CONTRACT NO. C700 REV. 0
AREA CODE SHEET NO. PAGE NO.
DB M114X 0680

REV	DATE	BY	SUB	APP	DESCRIPTION
0	20130710				READINESS FOR CONSTRUCTION

KEY NOTES

- 9 24x12 SA DUCT RISER FROM UTILITY CHASE BELOW, 24x12 SIDEWALL REGISTER (TYP). PRICE INDUSTRIES MODEL 720, REAR FIXED BLADE AT 30° (FIXED TOWARD THE SOUTH). FIXED FRONT BLADE WITH A 25° LIFT ANGLE. MOUNT AT 24" AFF.

Santa Clara Valley Transportation Authority

- NO EXCEPTIONS TAKEN (NET)
MAKE CORRECTIONS NOTED (MCN)
AMEND AND RESUBMIT (A/R)

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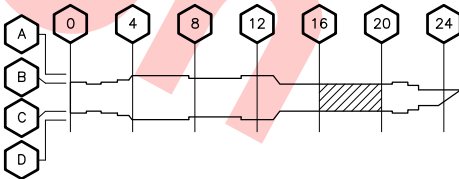
Contract No.: DB11002F

By: Date:



GRAPHIC SCALE

KEY PLAN



PLATFORM LEVEL PLAN — HVAC

SCALE: 1/8"=1'-0"

DB-M110

REV	DATE	BY	SUB	APP	DESCRIPTION
0	20130710				READINESS FOR CONSTRUCTION

DESIGNED BY
J. CHOU
DRAWN BY
J. CHOU
CHECKED BY
G. HENNINGS
IN CHARGE
G. HENNINGS
DATE
20130710



Block Construction Inc.
4455 Enterprise St., Fremont, CA 94538
(510) 807-9888 Fax: (510) 807-9889
CA Lic. #679326 email: info@blockco.com

Skanska
Shimmick
Herzog
H&M Mechanical Group
6517 Eastmont Rd. #230
Oakland, CA 94621
510-569-2000

1436 California Circle
Milpitas, California 95035
A Joint Venture

Lookwood, Andrews
& Newnam, Inc.
A LEOP A BALLY COMPANY

T-Y-LIN INTERNATIONAL

SUBMITTED

APPROVED



BART SILICON VALLEY BERRYESSA EXTENSION

LINE, TRACK, STATIONS AND SYSTEMS
DESIGN UNIT 023
MILPITAS STATION
PLATFORM LEVEL PLAN
HVAC
SHEET 5 OF 6

CADD FILENAME C700-S-DB-M115X.dwg	CONTRACT NO. C700	REV. 0
SIZE SCALE D 1/8"=1'-0"	AREA CODE DB	SHEET NO. M115X
		PAGE NO. 0681

KEY NOTES

- 2 L-1 MOUNTED AT 10'-0" AFF. FSD IN WALL, 18x18 MERV 8 FILTER AT OPENING
- 9 24x12 SA DUCT RISER FROM UTILITY CHASE BELOW, 24x12 SIDEWALL REGISTER (TYP). PRICE INDUSTRIES MODEL 720, REAR FIXED BLADE AT 30° (FIXED TOWARD THE SOUTH). FIXED FRONT BLADE WITH A 25° LIFT ANGLE. MOUNT AT 24" AFF.

Santa Clara Valley Transportation Authority

- NO EXCEPTIONS TAKEN (NET)
MAKE CORRECTIONS NOTED (MCN)
AMEND AND RESUBMIT (A/R)

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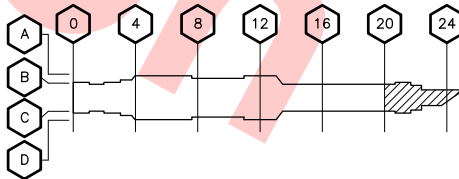
Contract No.: DB11002F

By: Date:



GRAPHIC SCALE

KEY PLAN



PLATFORM LEVEL PLAN - HVAC

SCALE: 1/8"=1'-0" DB-M110

MATCH LINE
SEE DWG NO. DB-M115X

DESIGNED BY
J. CHOU
DRAWN BY
J. CHOU
CHECKED BY
G. HENNINGS
IN CHARGE
G. HENNINGS
DATE
20130710



SUBMITTED
Block Construction Inc.
4455 Enterprise St., Fremont, CA 94538
(510) 857-5656 Fax: (510) 857-5656
CA Lic. #679326 email: info@blockco.com

Skanska
Shimmick
Herzog

1436 California Circle
Milpitas, California 95035
A Joint Venture

HMM Mechanical Group
8517 Eastmont Rd., #230
Oakland, CA 94621
510-569-2000

APPROVED
Lookwood, Andrews
& Newnam, Inc.
A LEOPOLD COMPANY



T-Y LIN INTERNATIONAL



LINE, TRACK, STATIONS AND SYSTEMS
DESIGN UNIT 023
MILPITAS STATION
PLATFORM LEVEL PLAN
HVAC
SHEET 6 OF 6

CADD FILENAME
C700-S-DB-M116X.dwg
SIZE SCALE
D 1/8"=1'-0"
CONTRACT NO. C700 REV. 0
AREA CODE SHEET NO. PAGE NO.
DB M116X 0682

REV	DATE	BY	SUB	APP	DESCRIPTION
0	20130710				READINESS FOR CONSTRUCTION

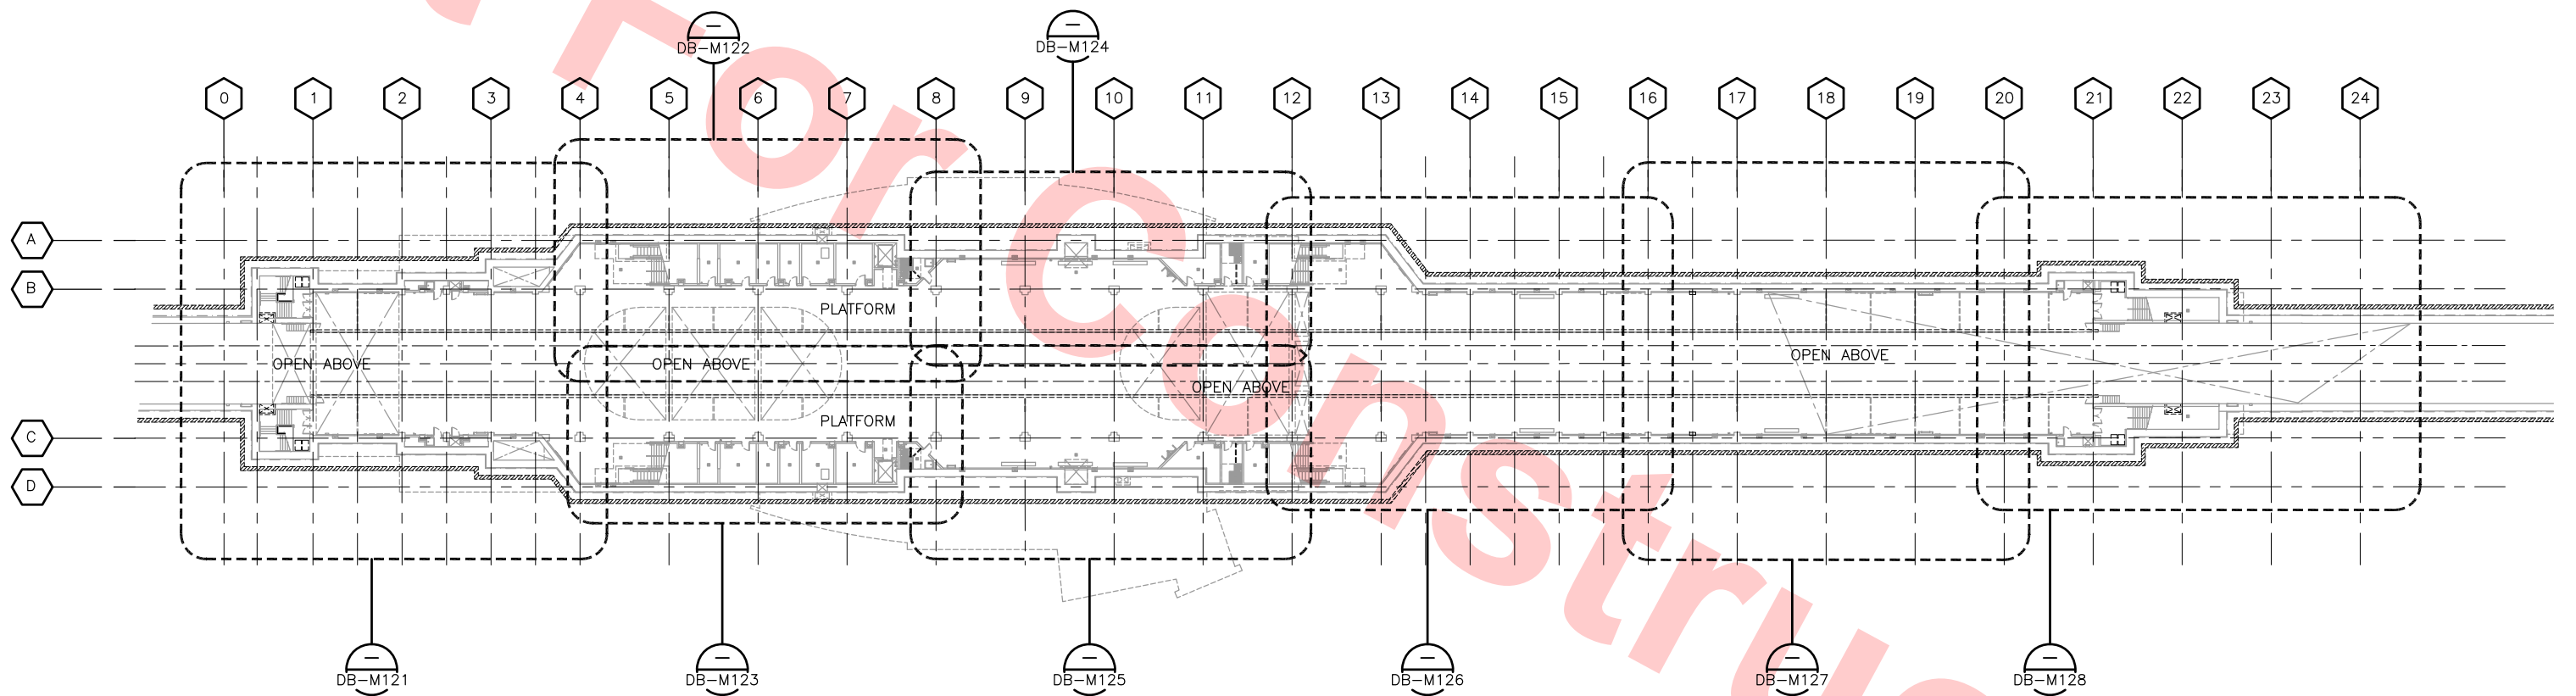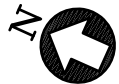

KEY PLAN PLATFORM LEVEL — PLUMBING
SCALE: 1/32"=1'-0"


Santa Clara Valley Transportation Authority

___ NO EXCEPTIONS TAKEN (NET)
___ MAKE CORRECTIONS NOTED (MCN)
___ AMEND AND RESUBMIT (A/R)

Any action shown above is subject to the terms of the contract and does not relieve the Contractor of any of its obligations under the contract, including design and detailing.

Contract No.: DB11002F

By: _____ Date: _____

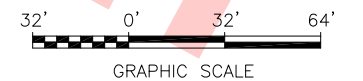

DESIGNED BY P. BLAUVELT
DRAWN BY P. BLAUVELT
CHECKED BY G. HENNINGS
IN CHARGE G. HENNINGS
DATE 20130710

0	20130710				READINESS FOR CONSTRUCTION
REV	DATE	BY	SUB	APP	DESCRIPTION



Skanska Shimmick Herzog
1436 California Circle
Milpitas, California 95035
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BCT Block Construction Inc.
4455 Enterprise St., Fremont, CA 94538
(510) 807-9888 Fax: (510) 807-9889
CA Lic. #679326 email: info@blockco.com


HM H&M Mechanical Group
6517 Eastmont Rd. #230
Oakland, CA 94621
510-569-2000

Lookwood, Andrews & Newman, Inc.
A LEOPALDY COMPANY
T-Y-LIN INTERNATIONAL

SUBMITTED *[Signature]* APPROVED *[Signature]*



LINE, TRACK, STATION AND SYSTEMS DESIGN UNIT 023 MILPITAS STATION KEY PLAN PLATFORM LEVEL PLUMBING			
CADD FILENAME C700-S-DB-M120.dwg			
SIZE D	SCALE 1/32"=1'-0"		
CONTRACT NO. C700		REV. 0	
AREA CODE DB	SHEET NO. M120	PAGE NO. 0683	

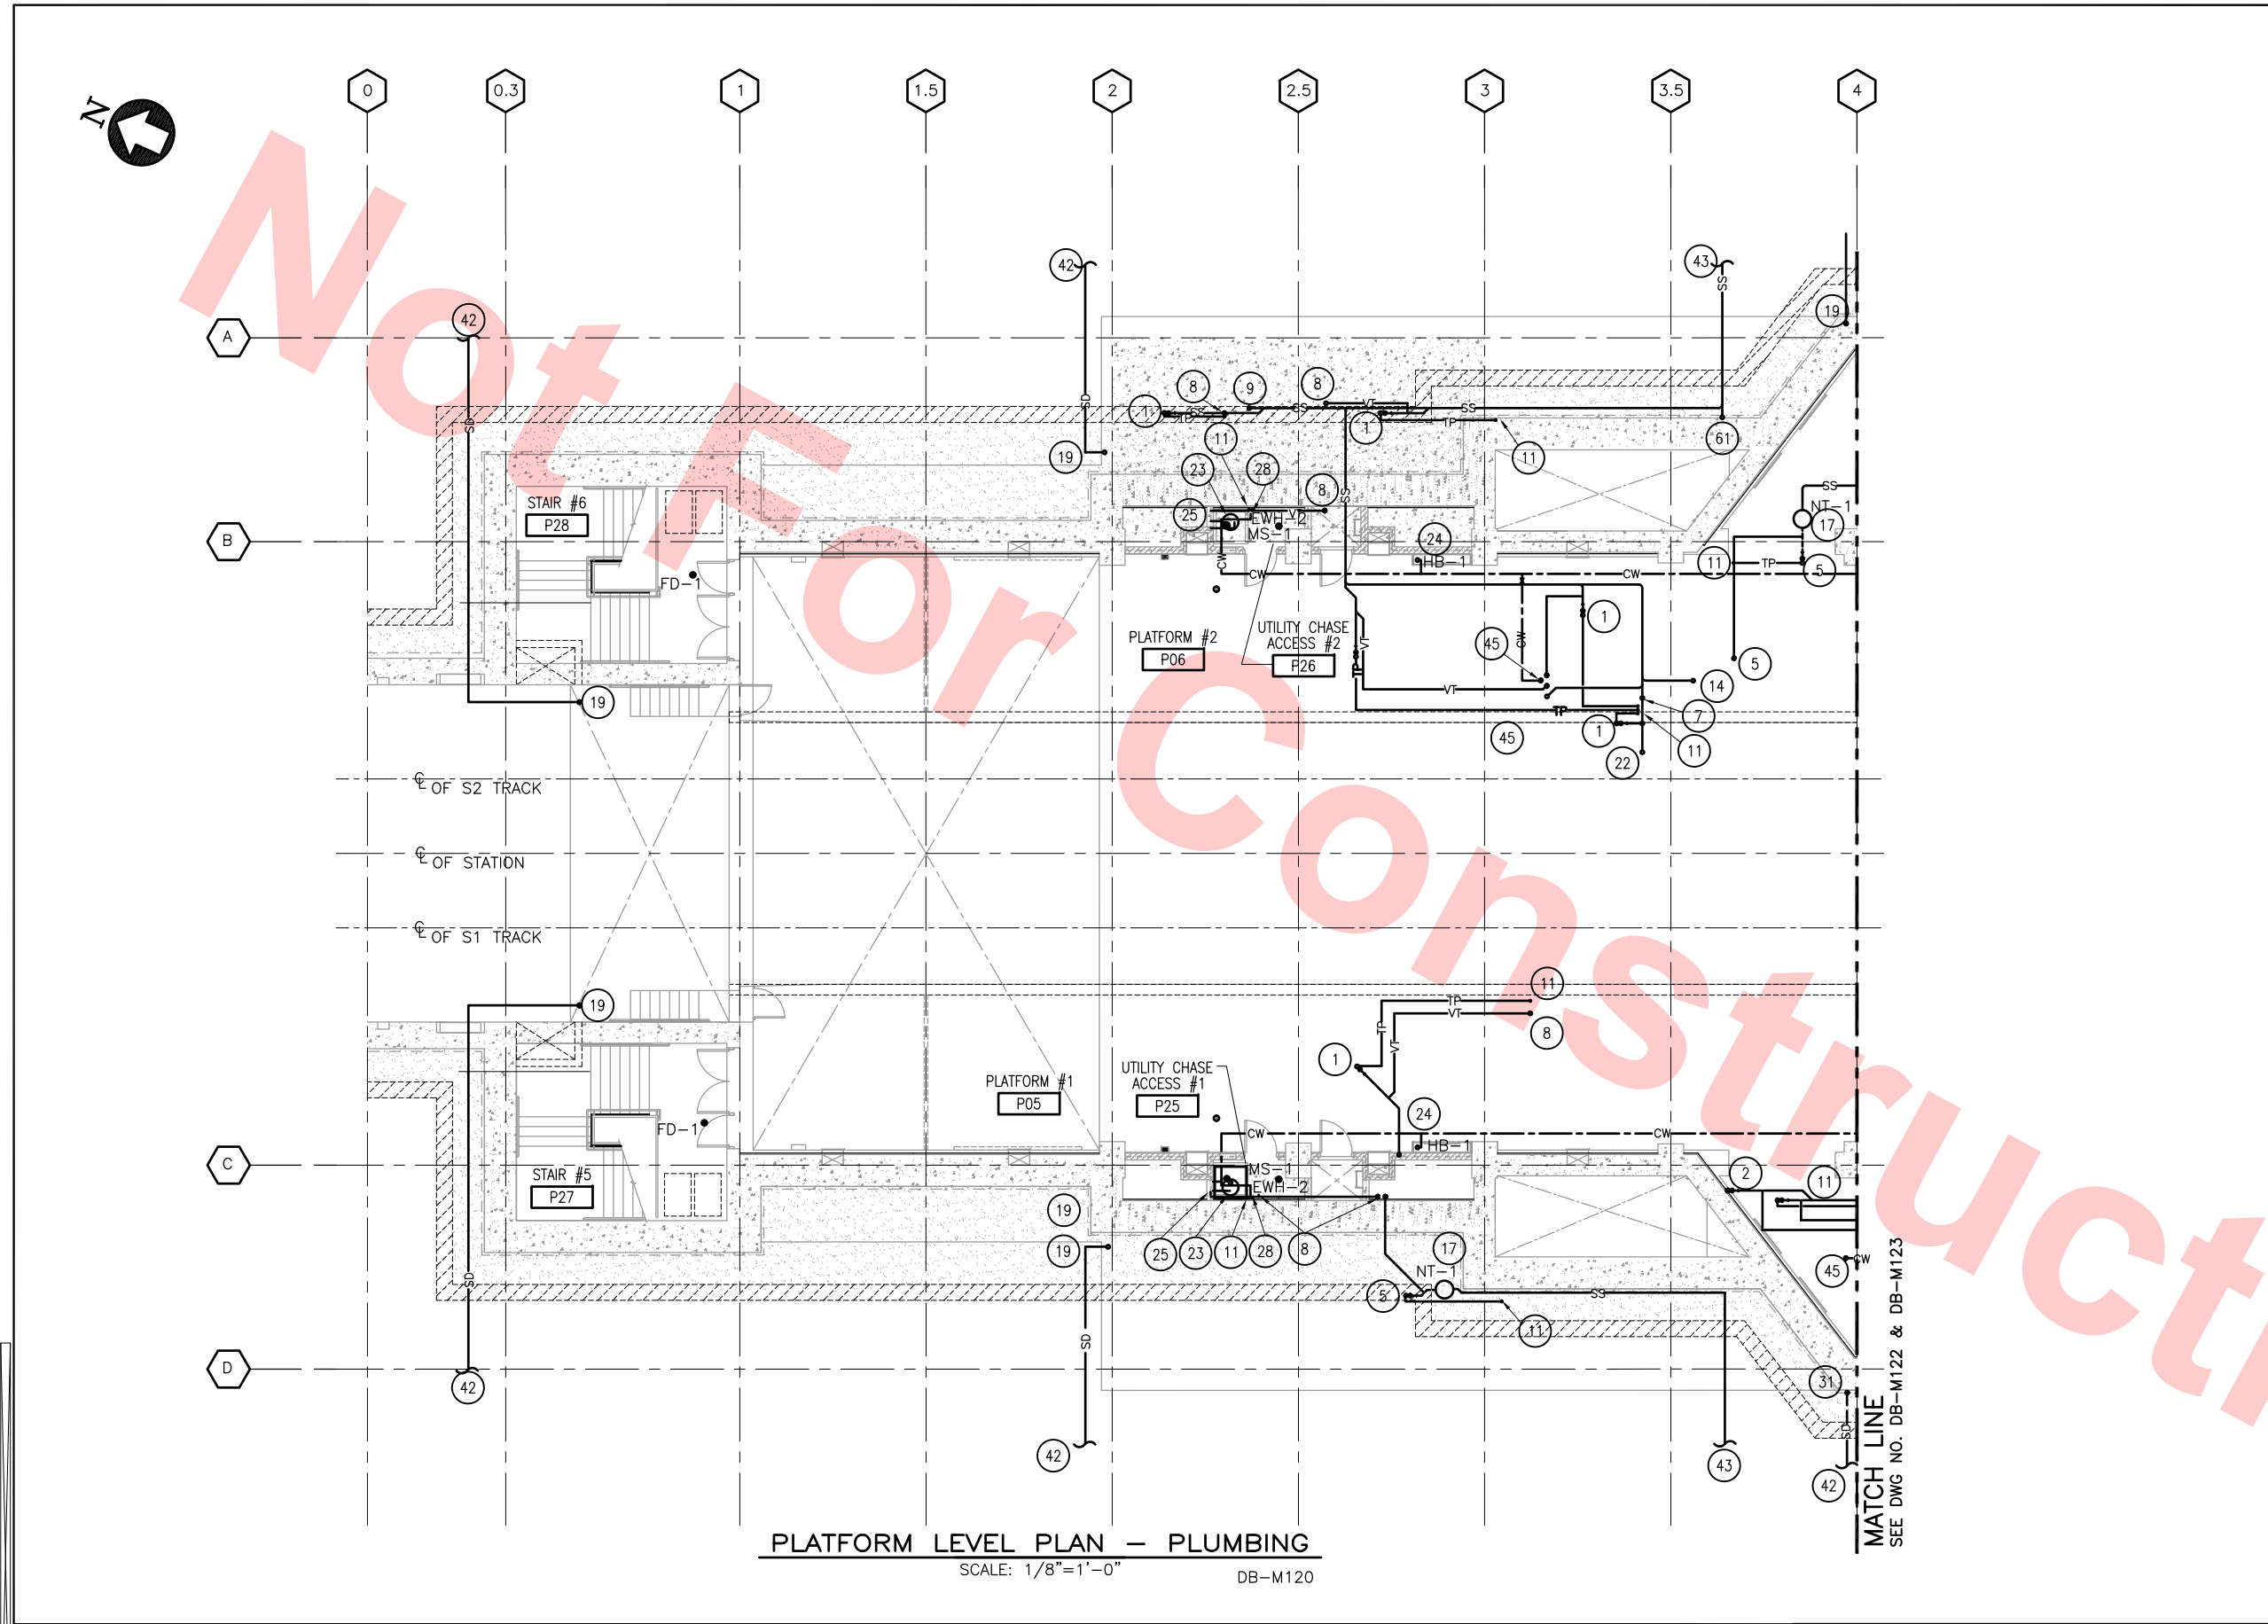

PLATFORM LEVEL PLAN — PLUMBING
SCALE: 1/8"=1'-0" DB-M120

KEY NOTES

- 1 3" SS UP TO FD
- 2 3" SS UP TO MOP SINK
- 5 3" IW UP TO FD
- 7 4" SS UP
- 8 2" VENT UP
- 9 3" FCO TO FINISH FLOOR
- 11 1/2" TRAP PRIMER
- 14 2" SS TO SINK
- 17 NEUTRILIZATION TANK
- 19 3" ROOF DRAIN TO SD
- 22 2" SS UP TO LAVA
- 23 3/4" HW & CW DN TO WATER HEATER, RELIEF PIPE TO MOP SINK,
- 24 3/4" CW DN TO HOSE BIBB (IN FHC STRUCTURE)
- 25 3/4" HW & CW DN TO MOP SINK
- 28 1/2" CW TO TRAP PRIMERS
- 42 3" SD TO CIVIL
- 43 3" SS TO CIVIL
- 45 CW UP
- 61 CLEANOUT

Santa Clara Valley Transportation Authority

- NO EXCEPTIONS TAKEN (NET)
- MAKE CORRECTIONS NOTED (MCN)
- AMEND AND RESUBMIT (A/R)

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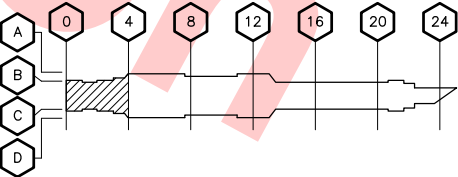
Contract No.: DB11002F

By: Date:




GRAPHIC SCALE

KEY PLAN



REV	DATE	BY	SUB	APP	DESCRIPTION
0	20130710				READINESS FOR CONSTRUCTION

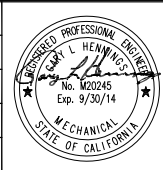

DESIGNED BY
P. BLAUVELT
DRAWN BY
P. BLAUVELT
CHECKED BY
C. HENNINGS
IN CHARGE
C. HENNINGS
DATE
20130710

Skanska
Shimmick
Herzog

1436 California Circle
Milpitas, California 95035
A Joint Venture

Block Construction Inc.
4455 Enterprise St., Fremont, CA 94538
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8517 Eastmont Rd. #230
Oakland, CA 94621
510-569-2000

Lookwood, Andrews
& Newnam, Inc.
A LEOP A BALLY COMPANY

T-Y LIN INTERNATIONAL

APPROVED
Ray Apolunth



LINE, TRACK, STATION AND SYSTEMS
DESIGN UNIT 023
MILPITAS STATION
PLATFORM LEVEL PLAN
PLUMBING
SHEET 1 OF 8

CADD FILENAME C700-S-DB-M121.dwg	CONTRACT NO. C700	REV. 0
SIZE SCALE D 1/8"=1'-0"	AREA CODE DB	SHEET NO. M121
		PAGE NO. 0684

KEY NOTES

- 1 3" SS UP TO FD
- 7 4" SS UP
- 8 2" VENT UP
- 9 3" FCO TO FINISH FLOOR
- 10 4" FCO TO FINISH FLOOR
- 11 1/2" TRAP PRIMER
- 13 2" SS TO DF
- 19 ROOF DRAIN TO SD
- 21 4" SS TO CIVIL
- 23 3/4" HW & CW DN TO WATER HEATER, RELIEF PIPE TO MOP SINK,
- 24 3/4" CW DN TO HOSE BIBB (IN FHC STRUCTURE)
- 25 3/4" HW & CW DN TO MOP SINK
- 28 CW TO TRAP PRIMERS
- 36 IW EJECTOR DISCHARGE
- 39 AIR COMPRESSOR BY OTHERS
- 40 COMPRESSED AIR TO GATES
- 42 3" SD TO CIVIL
- 43 3" SS TO CIVIL
- 45 CW UP
- 51 IW TO CIVIL
- 54 1" CONDENSATE CONNECTION
- 55 1" CONDENSATE DRAIN
- 64 TO GREASE/OIL SEPERATOR

Santa Clara Valley Transportation Authority

NO EXCEPTIONS TAKEN (NET)

MAKE CORRECTIONS NOTED (MCN)

AMEND AND RESUBMIT (A/R)

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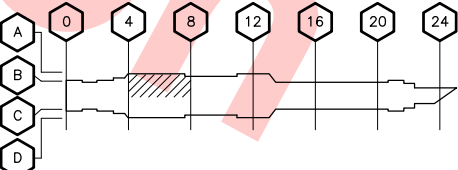
Contract No.: DB11002F

By: Date:




GRAPHIC SCALE

KEY PLAN



PLATFORM LEVEL PLAN — PLUMBING
SCALE: 1/8"=1'-0" DB-M120

<div>DESIGNED BY P. BLAUVELT DRAWN BY P. BLAUVELT CHECKED BY C. HENNINGS IN CHARGE C. HENNINGS DATE 20130710</div>					<div>Skanska Shimmick Herzog 1436 California Circle Milpitas, California 95035 A Joint Venture</div>		<div>BART SILICON VALLEY BART SILICON VALLEY BERRYESSA EXTENSION</div>		<div>LINE, TRACK, STATION AND SYSTEMS DESIGN UNIT 023 MILPITAS STATION PLATFORM LEVEL PLAN PLUMBING SHEET 2 OF 8</div>		<div>CADD FILENAME C700-S-DB-M122.dwg SIZE SCALE D 1/8"=1'-0" CONTRACT NO. C700 REV. 0 AREA CODE SHEET NO. PAGE NO. DB M122 0685</div>	
<div>0 20130710 READINESS FOR CONSTRUCTION</div>					<div>Block Construction Inc. 4455 Enterprise St., Fremont, CA 94538 (510) 867-3666 Fax: (510) 867-3666 CA Lic. #679326 email: info@blockco.com</div>		<div>HMM Mechanical Group 8517 Easthart Rd. #230 Oakland, CA 94621 510-569-2000</div>		<div>Lookwood, Andrews & Newnam, Inc. A LEQ A BALLY COMPANY</div>		<div>T-Y LIN INTERNATIONAL</div>	

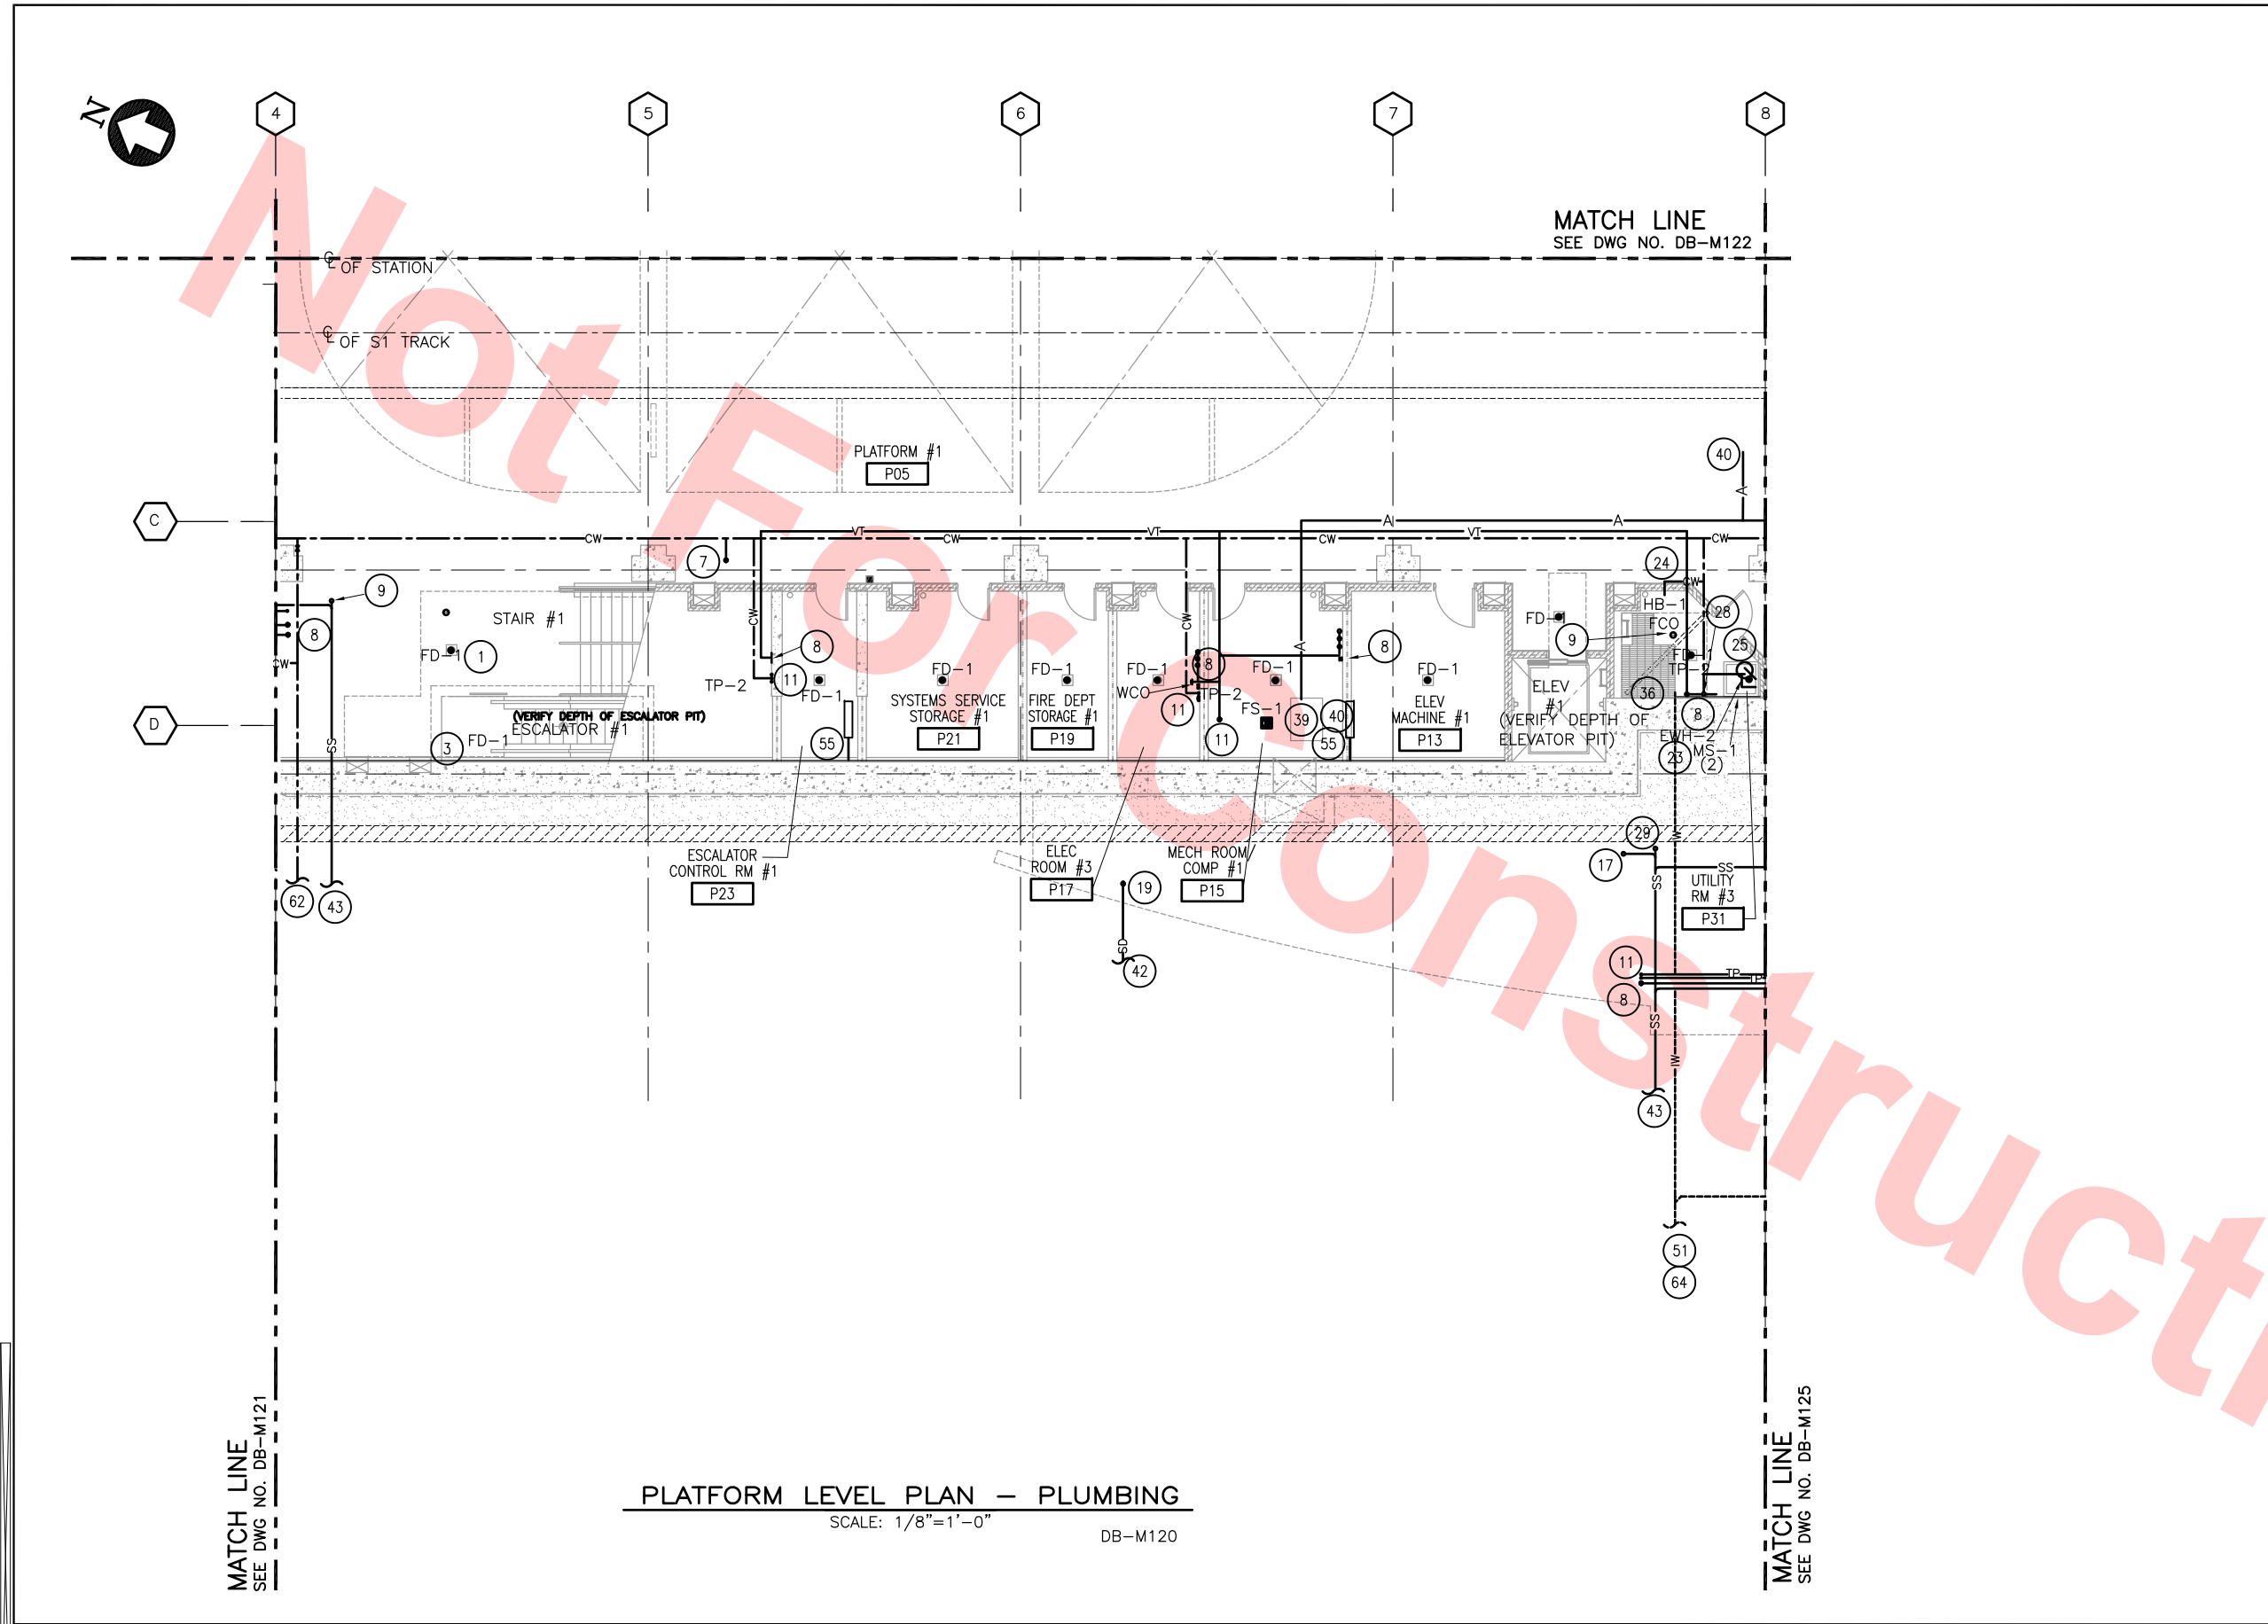

PLATFORM LEVEL PLAN - PLUMBING

SCALE: 1/8"=1'-0"

DB-M120

KEY NOTES

- 3" SS UP TO FD
- 3" IW UP TO ESCALATOR PIT DRAIN
- 4" SS UP
- 2" VENT UP
- 3" FCO TO FINISH FLOOR
- 1/2" TRAP PRIMER
- NEUTRILIZATION TANK
- ROOF DRAIN TO SD
- 3/4" HW & CW DN TO WATER HEATER, RELIEF PIPE TO MOP SINK,
- 3/4" CW DN TO HOSE BIBB (IN FHC STRUCTURE)
- 3/4" HW & CW DN TO MOP SINK
- CW TO TRAP PRIMERS
- IW EJECTOR DISCHARGE
- AIR COMPRESSOR BY OTHERS
- COMPRESSED AIR TO GATES
- 3" SD TO CIVIL
- 3" SS TO CIVIL
- IW TO CIVIL
- CONDENSATE TO DRAIN
- CLEANOUT
- CW INTO BUILDING
- TO GREASE/OIL SEPERATOR

Santa Clara Valley Transportation Authority

- NO EXCEPTIONS TAKEN (NET)
- MAKE CORRECTIONS NOTED (MCN)
- AMEND AND RESUBMIT (A/R)

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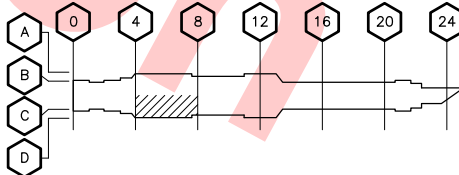
Contract No.: DB11002F

By: Date:



GRAPHIC SCALE

KEY PLAN



REV	DATE	BY	SUB	APP	DESCRIPTION
0	20130710				READINESS FOR CONSTRUCTION



Skanska Shimmick Herzog

1436 California Circle
Milpitas, California 95035
A Joint Venture

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H&M Mechanical Group
8517 Eastmont Rd. #230
Oakland, CA 94621
510-569-2000

Lookwood, Andrews & Newman, Inc.
A LEQ A BALLY COMPANY

T-Y LIN INTERNATIONAL



LINE, TRACK, STATION AND SYSTEMS
DESIGN UNIT 023
MILPITAS STATION
PLATFORM LEVEL PLAN
PLUMBING
SHEET 3 OF 8

CADD FILENAME C700-S-DB-M123.dwg	REV. 0
SIZE SCALE 1/8"=1'-0"	
CONTRACT NO. C700	
AREA CODE DB	SHEET NO. M123
	PAGE NO. 0686

KEY NOTES

- 8 2" VENT UP
- 19 3" ROOF DRAIN TO SD
- 28 1/2" CW TO TRAP PRIMERS
- 32 SUMP ACCESS
- 35 4" SS EJECTOR DISCHARGE
- 40 COMPRESSED AIR TO GATES
- 42 3" SD TO CIVIL
- 43 4" SS TO CIVIL
- 45 CW UP
- 54 1" CONDENSAT3E CONNECTION
- 55 CONDENSATE TO DRAIN
- 56 1 1/4" CONDENSATE TO DRAIN

Santa Clara Valley Transportation Authority

NO EXCEPTIONS TAKEN (NET)

MAKE CORRECTIONS NOTED (MCN)

AMEND AND RESUBMIT (A/R)

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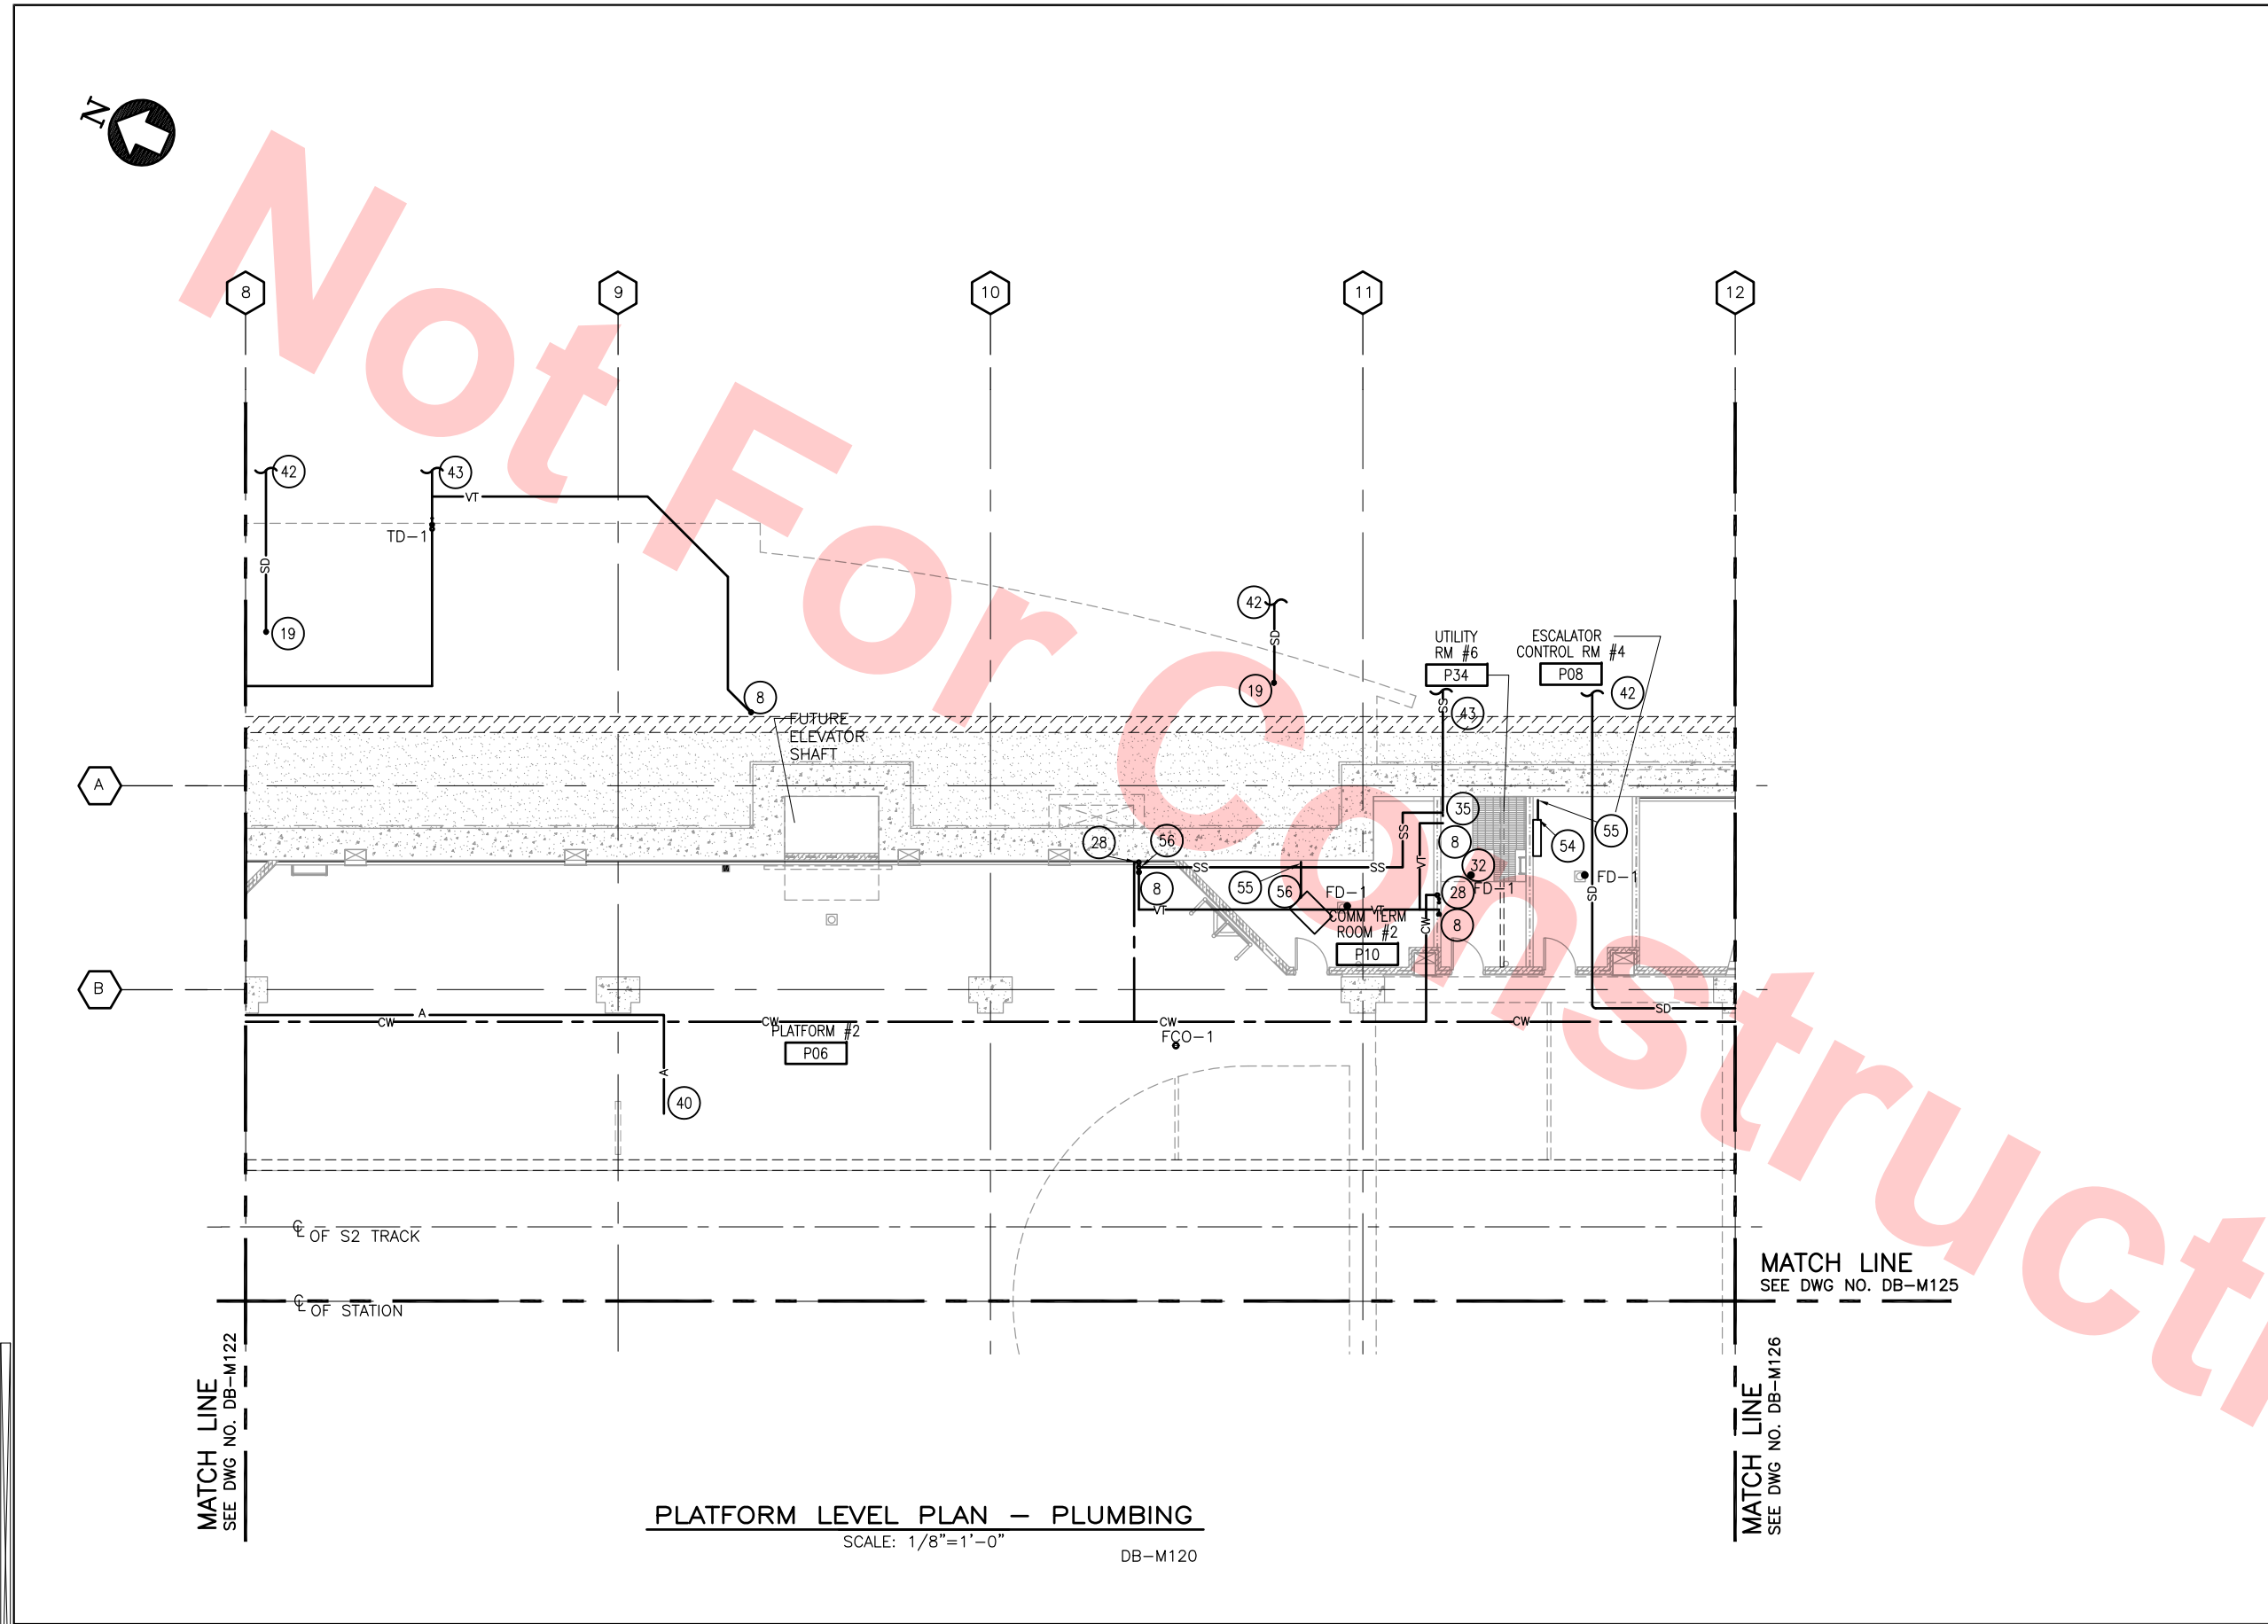
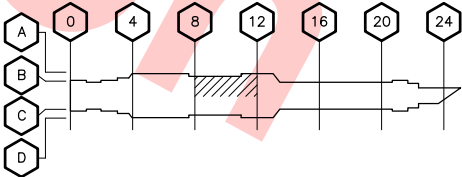
Contract No.: DB11002F

By: Date:

8'0'8'16'

GRAPHIC SCALE

KEY PLAN



PLATFORM LEVEL PLAN — PLUMBING

SCALE: 1/8"=1'-0" DB-M120

						DESIGNED BY P. BLAUVELT		<div>Skanska Shimmick Herzog</div> <div>1436 California Circle Milpitas, California 95035 A Joint Venture</div>			<div>T-Y LIN INTERNATIONAL</div> <div>APPROVED </div>	 BART SILICON VALLEY BERRYESSA EXTENSION	<div>LINE, TRACK, STATION AND SYSTEMS</div> <div>DESIGN UNIT 023</div> <div>MILPITAS STATION</div> <div>PLATFORM LEVEL PLAN</div> <div>PLUMBING</div> <div>SHEET 4 OF 8</div>		<div>CADD FILENAME C700-S-DB-M124.dwg</div> <div>SIZE SCALE D 1/8"=1'-0"</div> <div>CONTRACT NO. C700 REV. 0</div> <div>AREA CODE DB SHEET NO. M124 PAGE NO. 0687</div>			
					DRAWN BY P. BLAUVELT													
					CHECKED BY G. HENNINGS													
					IN CHARGE G. HENNINGS													
0	20130710				READINESS FOR CONSTRUCTION	DATE 20130710												
REV	DATE	BY	SUB	APP	DESCRIPTION													

KEY NOTES

- 8 2" VENT UP
- 5 3" IW UP TO FLOOR DRAIN
- 6 3" SS UP
- 9 3" FCO TO FINISH FLOOR
- 11 1/2" TRAP PRIMER
- 12 3" SS TO FLOOR SINK
- 13 2" SS TO DF
- 19 3" ROOF DRAIN TO SD
- 35 SS EJECTOR DISCHARGE
- 35 SS EJECTOR DISCHARGE
- 38 2" VENT TO ROOF
- 40 COMPRESSED AIR TO GATES
- 42 SD TO CIVIL
- 43 3" SS TO CIVIL
- 45 CW UP
- 50 FUTURE FOR FOOD COURT
- 55 1" CONDENSATE DRAIN
- 56 1 1/4" CONDENSATE DRAIN

Santa Clara Valley Transportation Authority

NO EXCEPTIONS TAKEN (NET)
MAKE CORRECTIONS NOTED (MCN)
AMEND AND RESUBMIT (A/R)

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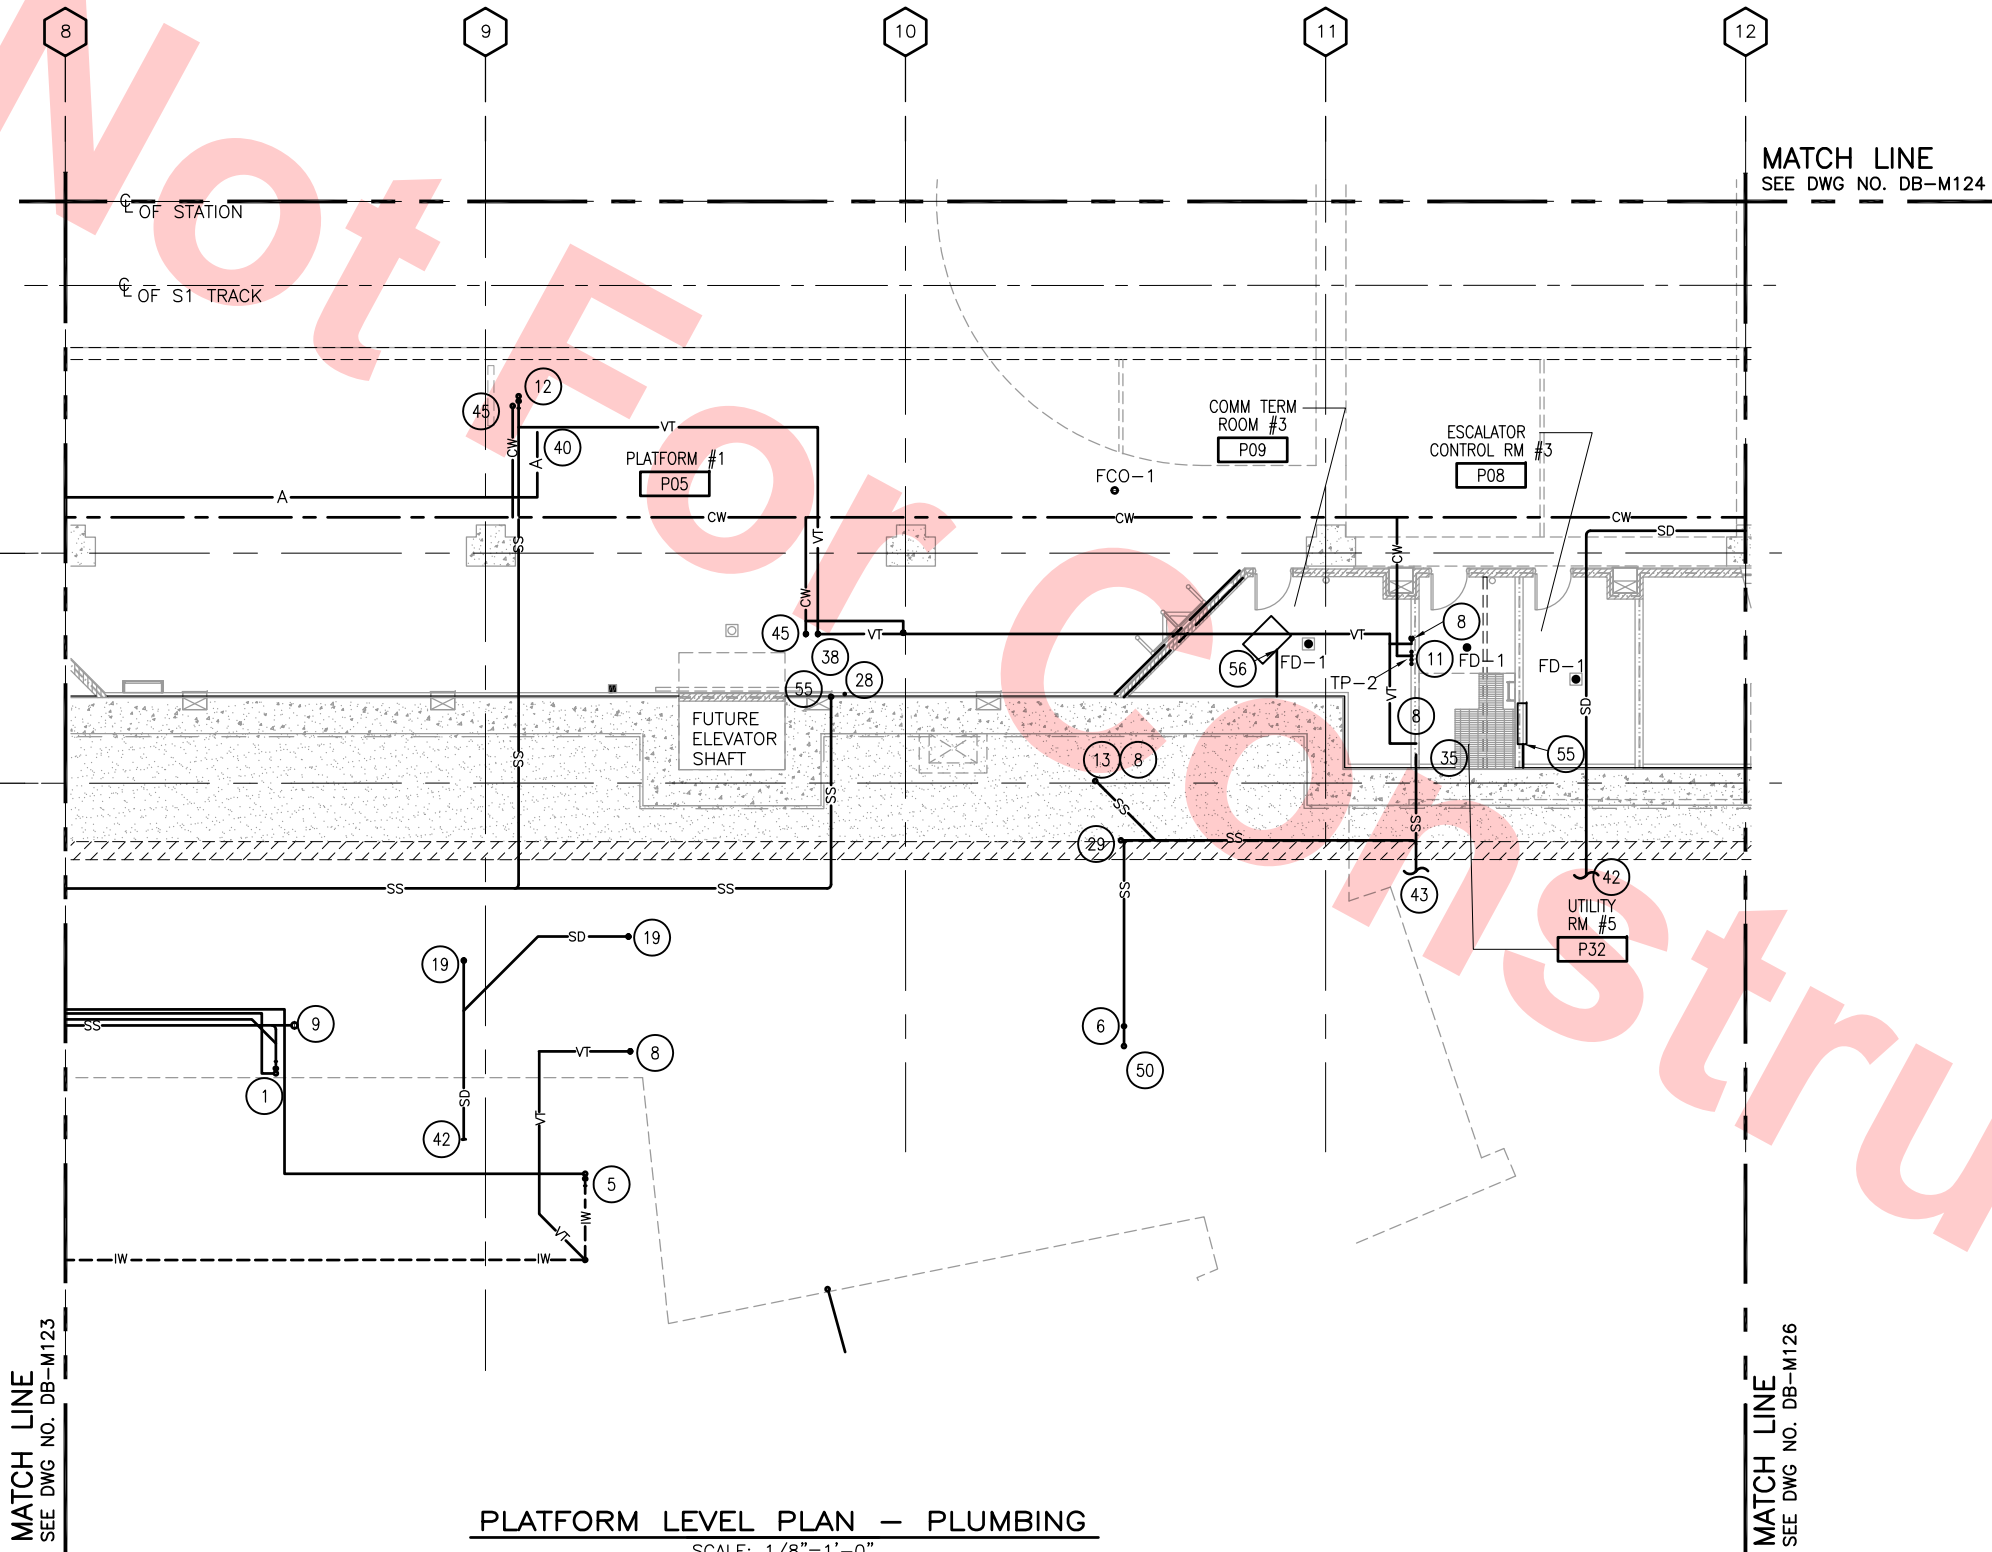
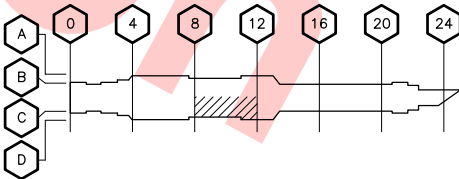
Contract No.: DB11002F

By: _____ Date: _____



GRAPHIC SCALE

KEY PLAN



PLATFORM LEVEL PLAN — PLUMBING

SCALE: 1/8"=1'-0"

DB-M120

						DESIGNED BY P. BLAUVELT
						DRAWN BY P. BLAUVELT
						CHECKED BY G. HENNINGS
						IN CHARGE G. HENNINGS
0	20130710				READINESS FOR CONSTRUCTION	DATE 20130710
REV	DATE	BY	SUB	APP	DESCRIPTION	



Skanska Shimmick Herzog

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A Joint Venture

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8517 Easthart Rd. #230
Oakland, CA 94621
510-569-2000

Lookwood, Andrews & Newman, Inc.
A LEOP A BALLY COMPANY

T-Y-LIN INTERNATIONAL

SUBMITTED

APPROVED

BART SILICON VALLEY BERRYESSA EXTENSION

LINE, TRACK, STATION AND SYSTEMS

DESIGN UNIT 023


MILPITAS STATION

PLATFORM LEVEL PLAN

PLUMBING

SHEET 5 OF 8

CADD FILENAME			
C700-S-DB-M125.dwg			
SIZE	SCALE		
D	1/8"=1'-0"		
CONTRACT NO.			REV.
C700			0
AREA CODE	SHEET NO.	PAGE NO.	
DB	M125	0688	

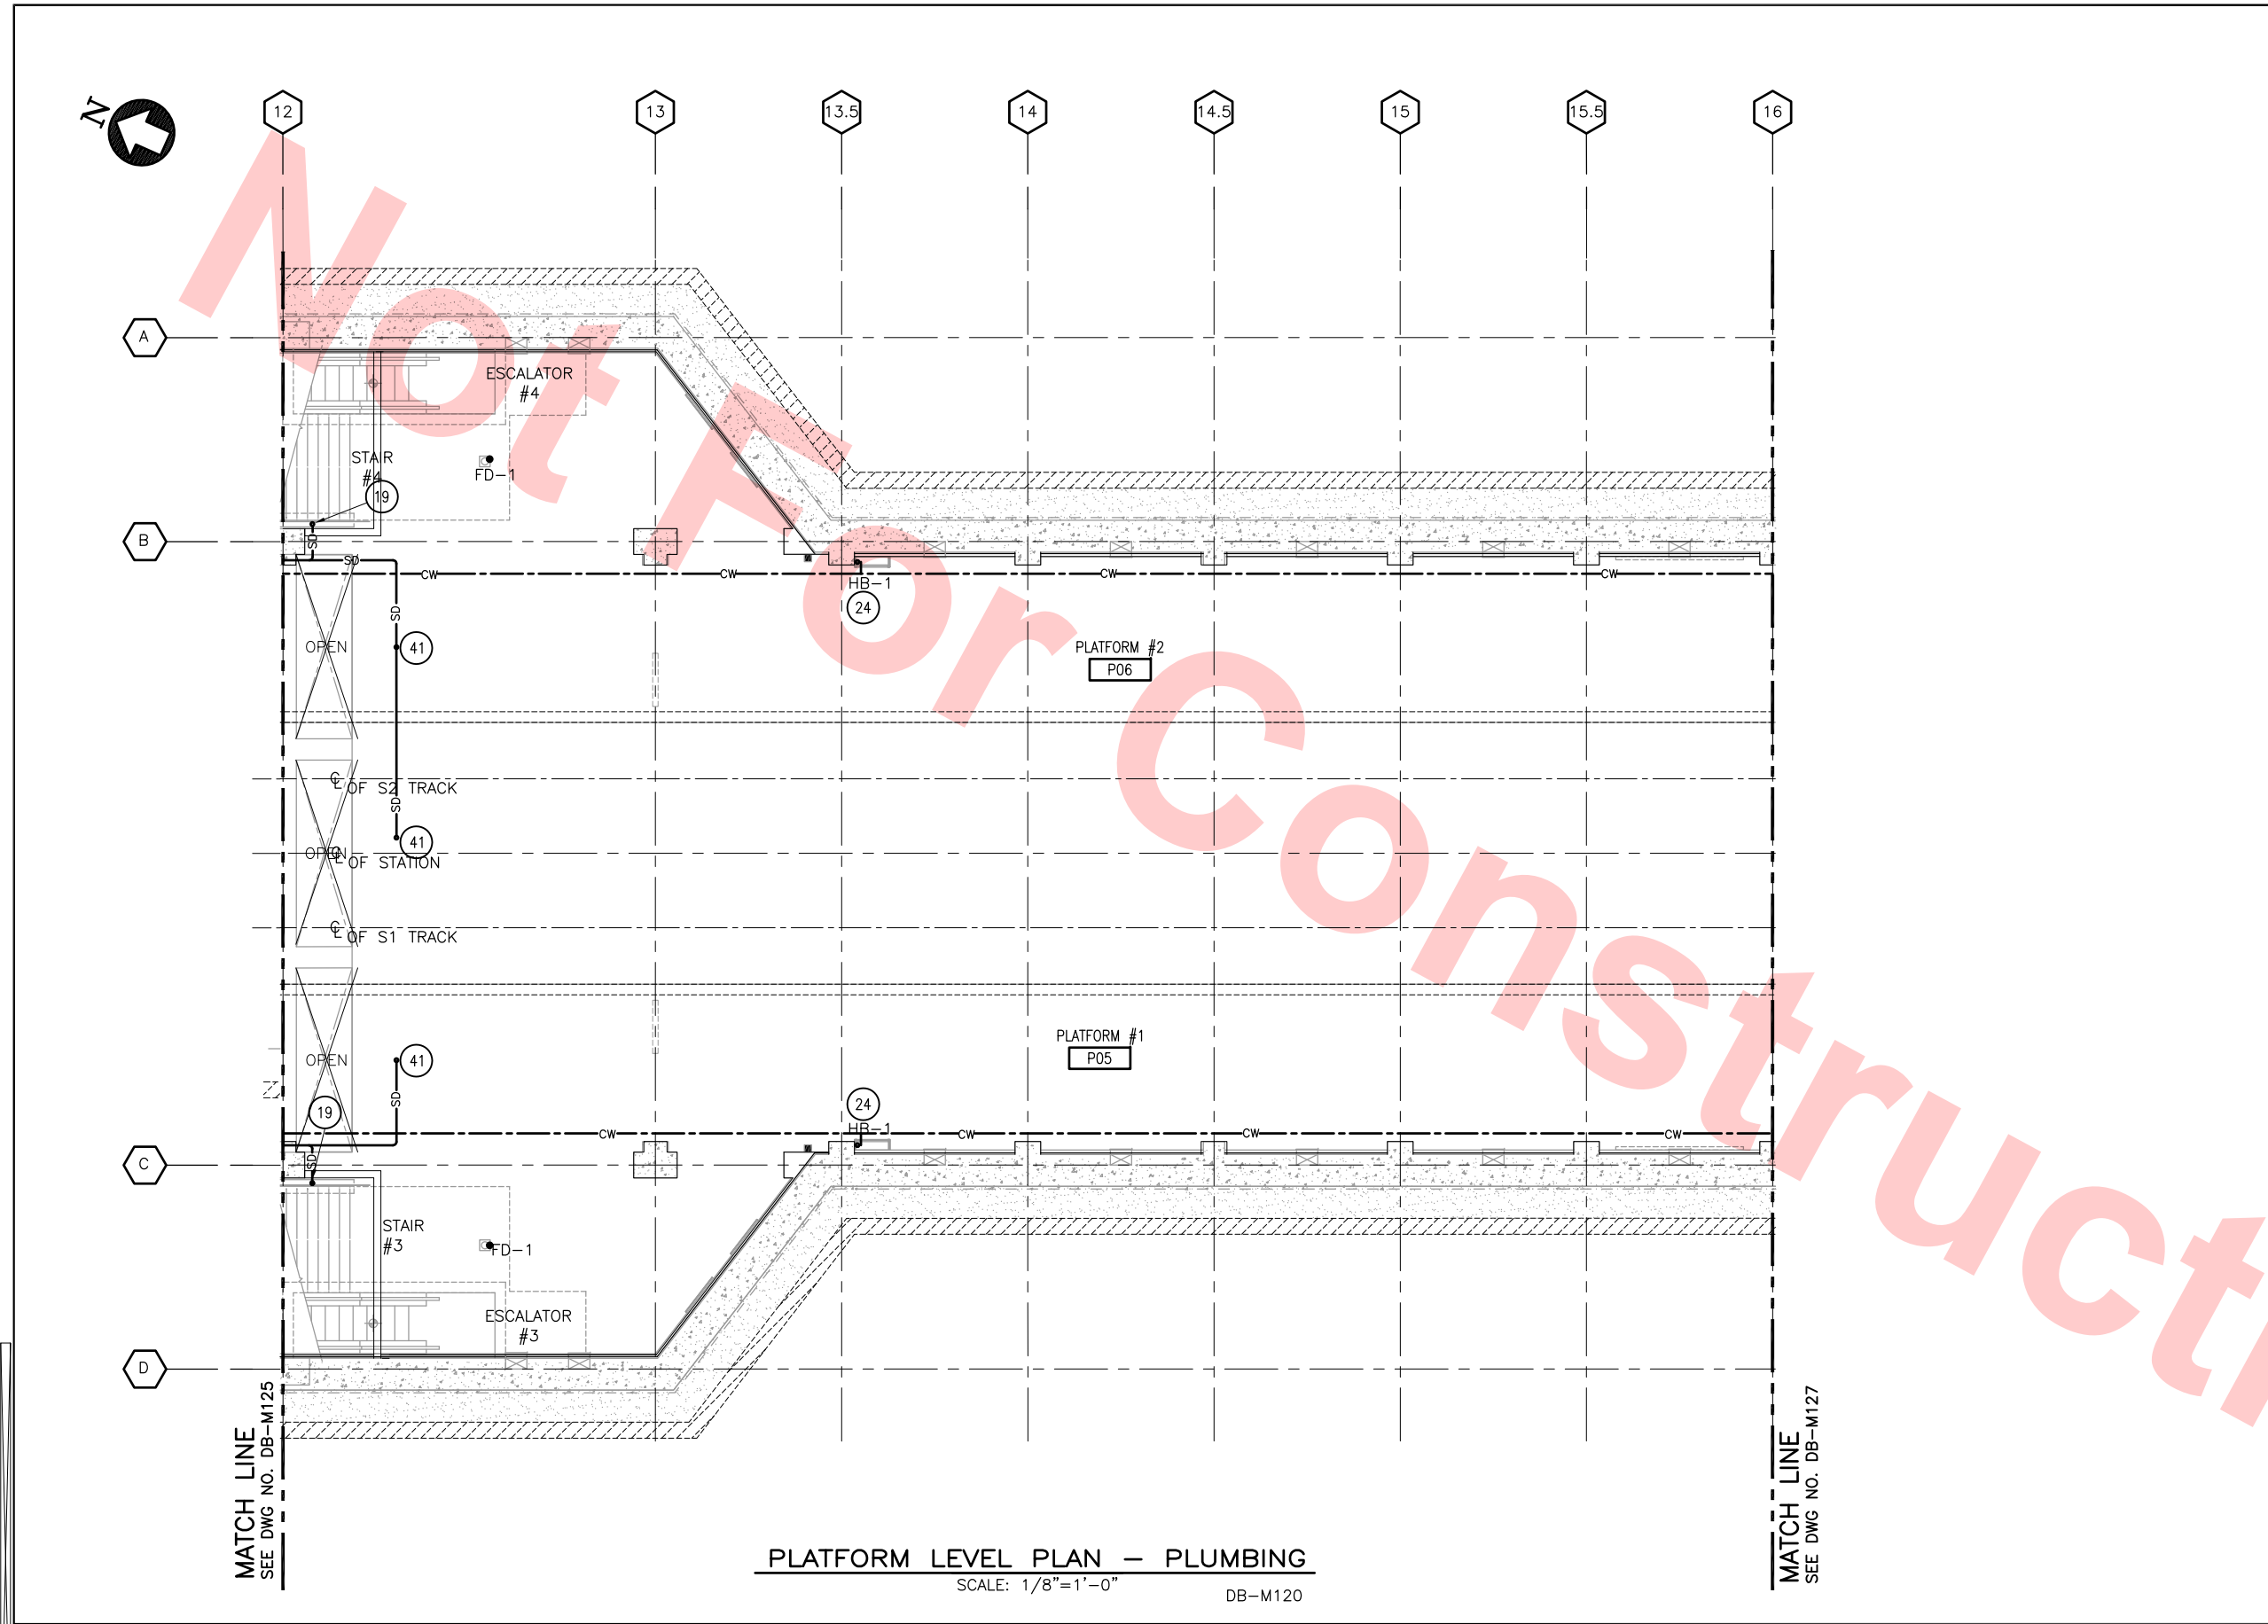

KEY NOTES

- 19 3" ROOF DRAIN TO SD
- 24 3/4" CW DN TO HOSE BIBB (IN FHC STRUCTURE)
- 41 3" SD FOR PLANTER DRAINS

Santa Clara Valley Transportation Authority

NO EXCEPTIONS TAKEN (NET)
MAKE CORRECTIONS NOTED (MCN)
AMEND AND RESUBMIT (A/R)


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Contract No.: DB11002F

By: Date:



KEY PLAN

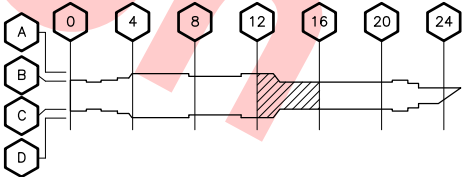

REV	DATE	BY	SUB	APP	DESCRIPTION
0	20130710				READINESS FOR CONSTRUCTION



DESIGNED BY
P. BLAUVELT

DRAWN BY
P. BLAUVELT

CHECKED BY
G. HENNINGS

IN CHARGE
G. HENNINGS

DATE
20130710

Skanska
Shimmick
Herzog

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Milpitas, California 95035
A Joint Venture

Block Construction Inc.

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HMM Mechanical Group

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510-569-2000

Lookwood, Andrews
& Newnam, Inc.

4455 Enterprise St., Fremont, CA 94538
(510) 807-3686 Fax: (510) 807-3686
CA Lic. #679326 email: info@lookwood.com

T-Y LIN INTERNATIONAL

APPROVED



LINE, TRACK, STATIONS AND SYSTEMS				CADD FILENAME C700-S-DB-M126.dwg	
DESIGN UNIT 023				SIZE SCALE	
MILPITAS STATION				D 1/8"=1'-0"	
PLATFORM LEVEL PLAN				CONTRACT NO.	REV.
PLUMBING				C700	0
SHEET 6 OF 8				AREA CODE	PAGE NO.
				DB	0689

KEY NOTES

24 3/4" CW DN TO HOSE BIBB (IN FHC STRUCTURE)

Santa Clara Valley Transportation Authority

NO EXCEPTIONS TAKEN (NET)

MAKE CORRECTIONS NOTED (MCN)

AMEND AND RESUBMIT (A/R)




Any action shown above is subject to the terms of the contract and does not relieve the Contractor of any of its obligations under the contract, including design and detailing.

Contract No.: DB11002F

By: Date:



KEY PLAN

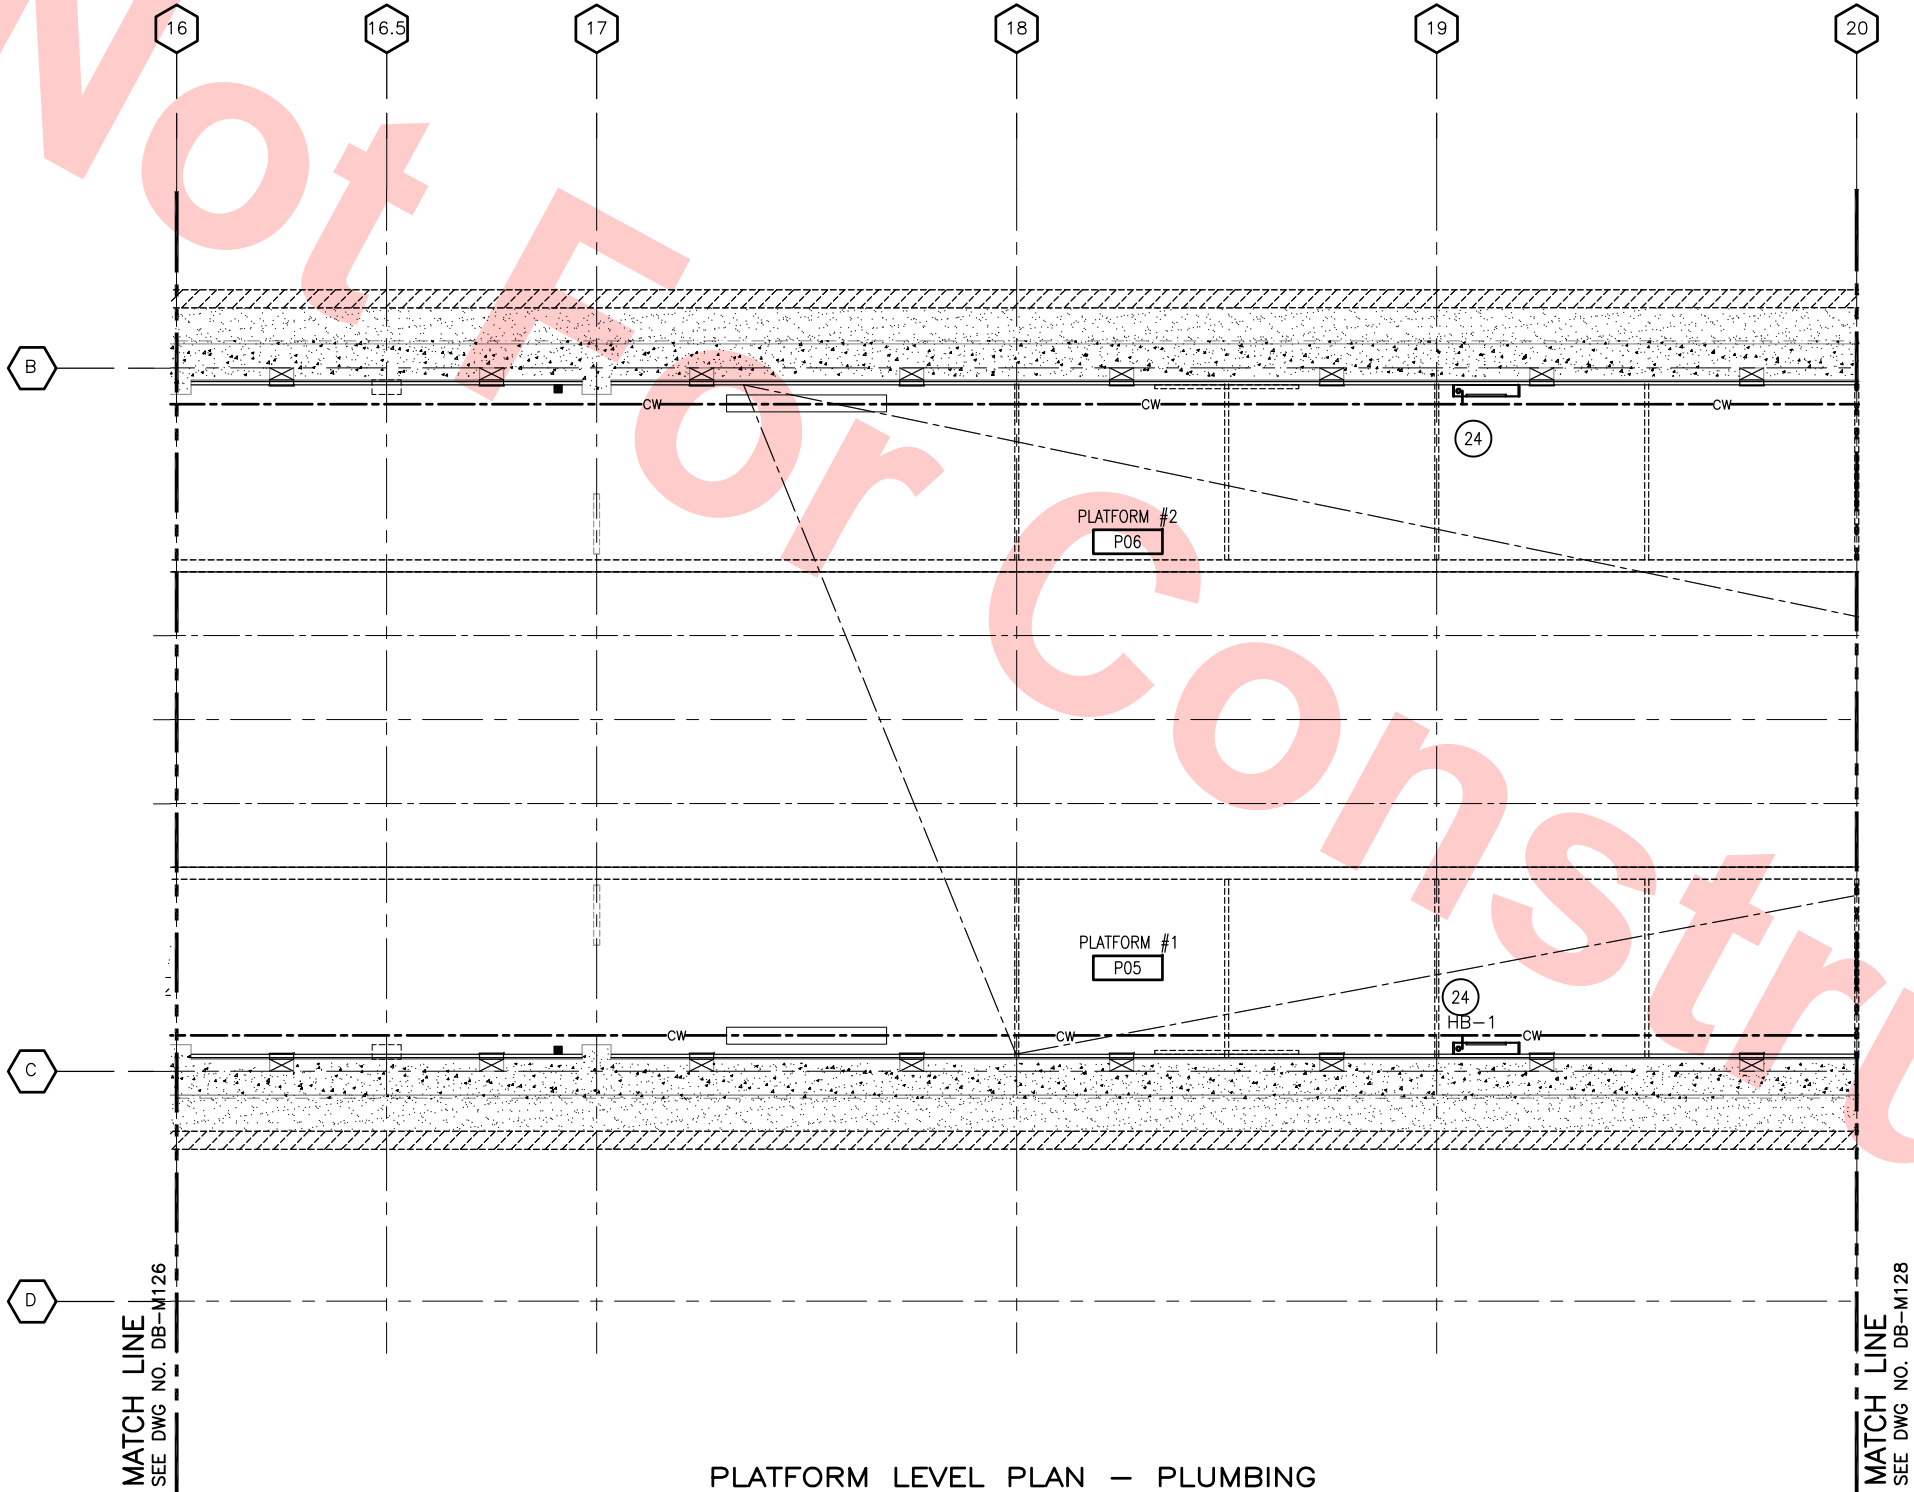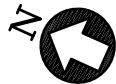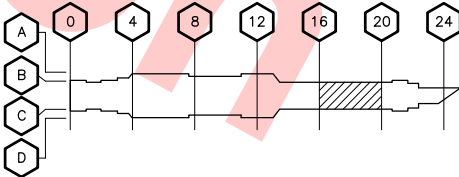

PLATFORM LEVEL PLAN — PLUMBING

SCALE: 1/8"=1'-0"

DB-M120

DESIGNED BY P. BLAUVELT	<div>0</div> <div>20130710</div> <div>BY</div> <div>SUB</div> <div>APP</div>	READINESS FOR CONSTRUCTION
DRAWN BY P. BLAUVELT		
CHECKED BY C. HENNINGS		
IN CHARGE C. HENNINGS		
DATE 20130710		
REV	DATE	DESCRIPTION



Skanska
Shimmick
Herzog

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Milpitas, California 95035
A Joint Venture

Block Construction Inc.

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HM

H&M Mechanical Group
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Oakland, CA 94621
510-569-2000

Lookwood, Andrews
& Newman, Inc.

A LEQ A BALLY COMPANY

T-Y LIN INTERNATIONAL

APPROVED

BART

VTA

SILICON VALLEY

BART SILICON VALLEY BERRYESSA EXTENSION

LINE, TRACK, STATIONS AND SYSTEMS

DESIGN UNIT 023


MILPITAS STATION

PLATFORM LEVEL PLAN

PLUMBING

SHEET 7 OF 8

CADD FILENAME C700-S-DB-M127.dwg	CONTRACT NO. C700	REV. 0
SIZE SCALE D 1/8"=1'-0"		
AREA CODE DB	SHEET NO. M127	PAGE NO. 0690

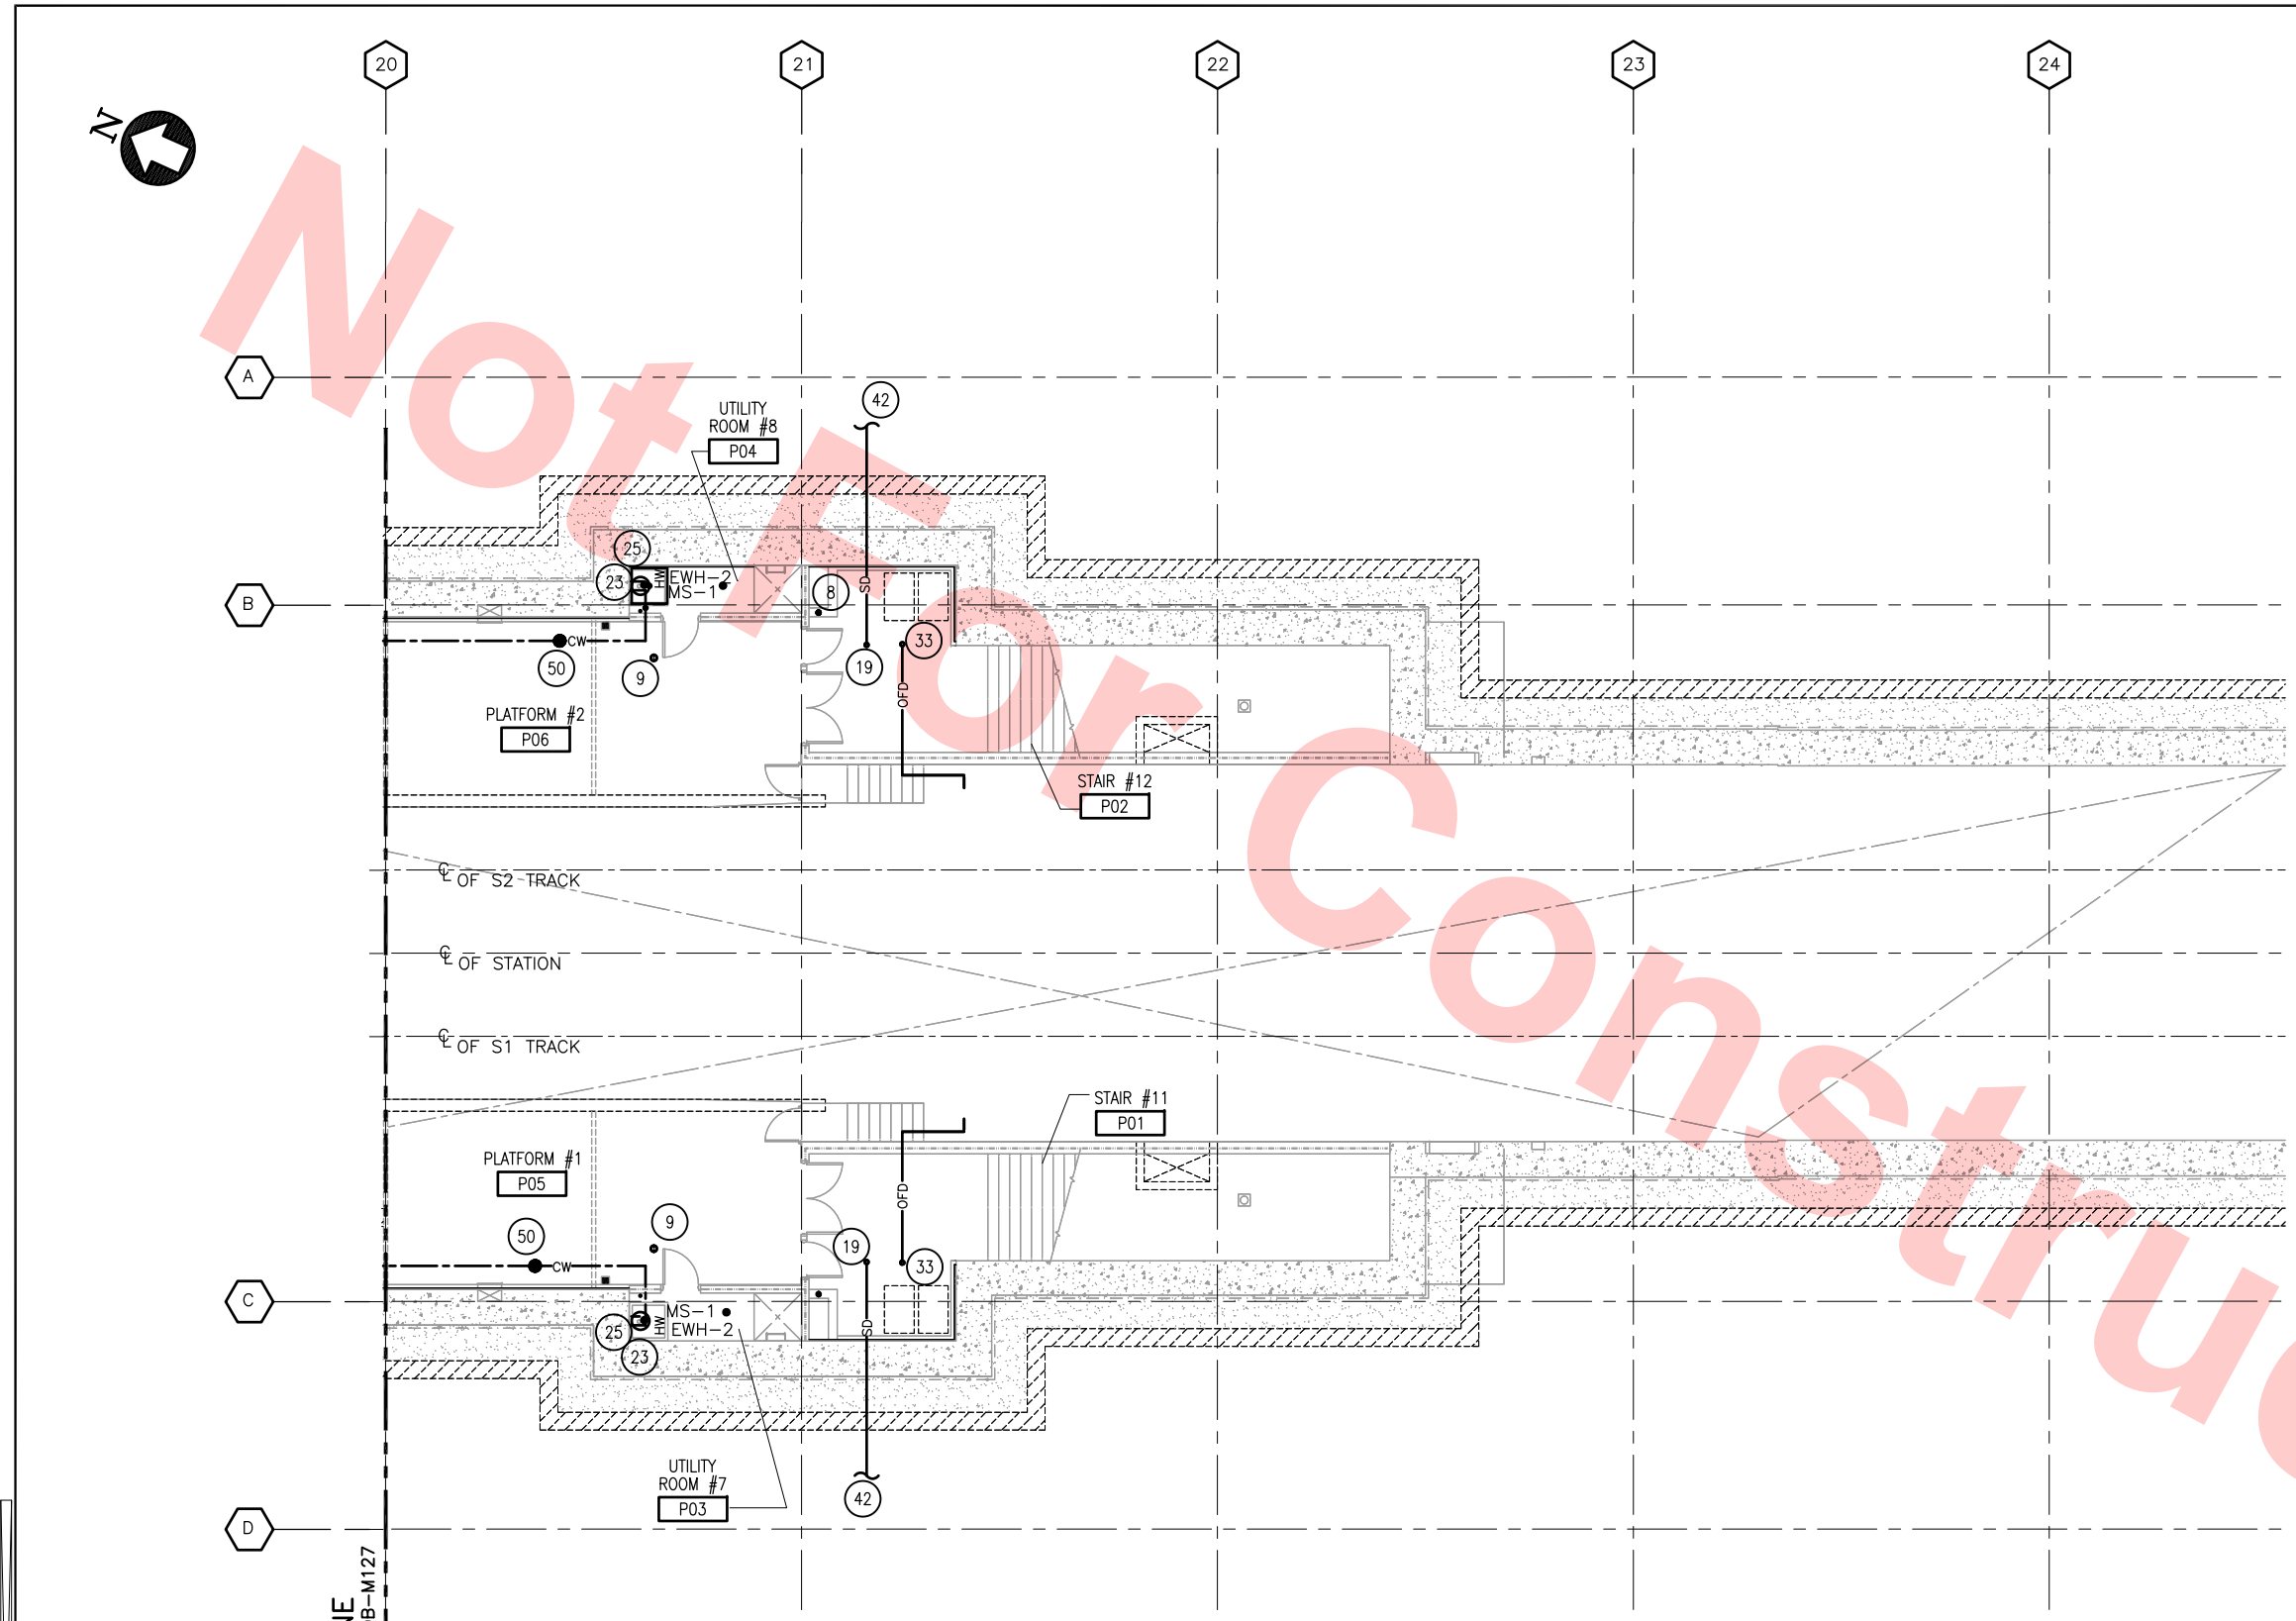

MATCH LINE
SEE DWG NO. DB-M127

PLATFORM LEVEL PLAN - PLUMBING
SCALE: 1/8"=1'-0"
DB-M120

KEY NOTES

- 8 2" VENT UP
- 9 3" FCO TO FINISH FLOOR
- 19 ROOF DRAIN TO SD
- 23 3/4" HW & CW DN TO WATER HEATER, RELIEF PIPE TO MOP SINK,
- 25 3/4" HW & CW DN TO MOP SINK
- 33 OFD TO DAYLIGHT
- 50 WATER HAMMER


Santa Clara Valley Transportation Authority

NO EXCEPTIONS TAKEN (NET)
MAKE CORRECTIONS NOTED (MCN)
AMEND AND RESUBMIT (A/R)


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Contract No.: DB11002F


By: _____ Date: _____

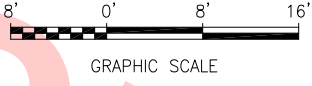

KEY PLAN

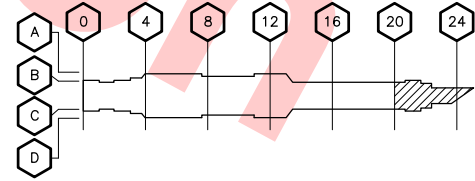

REV	DATE	BY	SUB	APP	DESCRIPTION
0	20130710				READINESS FOR CONSTRUCTION

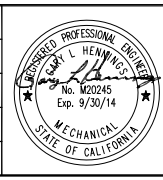

DESIGNED BY
P. BLAUVELT

DRAWN BY
P. BLAUVELT

CHECKED BY
C. HENNINGS

IN CHARGE
C. HENNINGS

DATE
20130710

Skanska
Shimmick
Herzog

1436 California Circle
Milpitas, California 95035
A Joint Venture

Block Construction Inc.
4455 Enterprise St., Fremont, CA 94538
(510) 857-3666 Fax: (510) 857-3668
CA Lic. #679326 email: info@blockco.com

H&M Mechanical Group
8517 Eastmont Rd., #230
Oakland, CA 94621
510-569-2000

Lookwood, Andrews
& Newnam, Inc.
A LEQ A BALLY COMPANY

T-Y LIN INTERNATIONAL


SUBMITTED

APPROVED



LINE, TRACK, STATIONS AND SYSTEMS
DESIGN UNIT 023
MILPITAS STATION
PLATFORM LEVEL PLAN
PLUMBING
SHEET 8 OF 8

CADD FILENAME C700-S-DB-M128.dwg	REV. 0
SIZE D	SCALE 1/8"=1'-0"
CONTRACT NO. C700	SHEET NO. M128
AREA CODE DB	PAGE NO. 0691

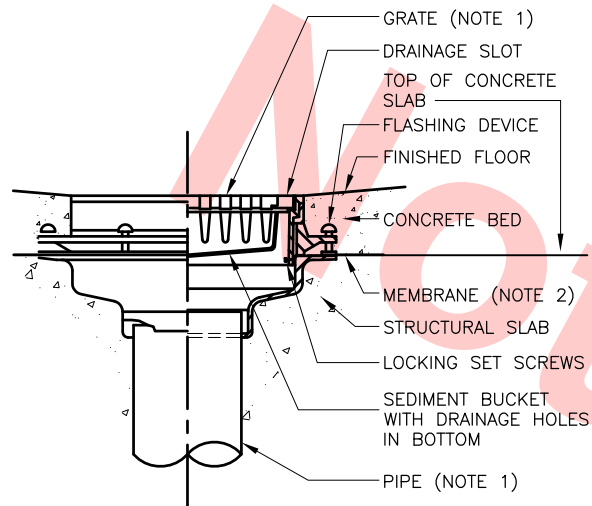


FLOOR DRAIN FD-2

DETAIL

NO SCALE

7

M160

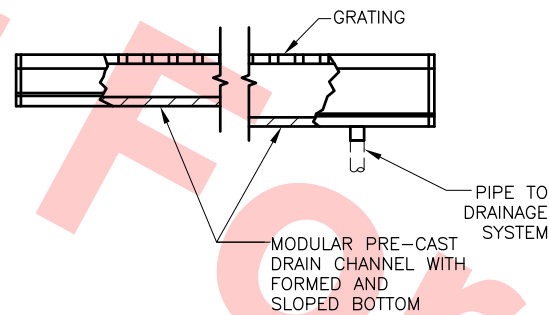


TRENCH DRAIN
AREA DRAIN AD-2

DETAIL

NO SCALE

2

M160

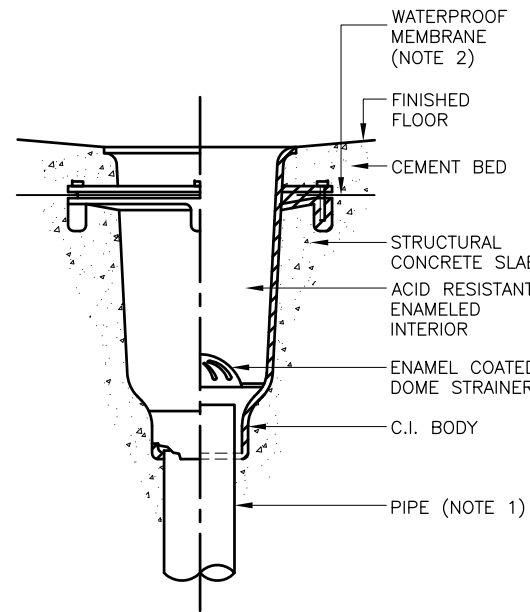


FLOOR DRAIN FD-3

DETAIL

NO SCALE

8

M160

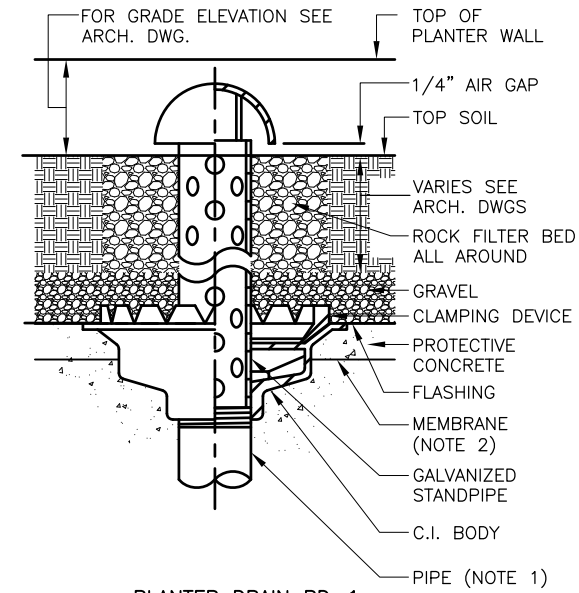

PLANTER DRAIN PD-1

DETAIL

NO SCALE

9

M160

NOTES:

1. GRATE FREE AREA AND OUTLET SIZE SHALL BE AS SHOWN ON DRAWINGS.

EXAMPLE: AD-1 12 X 4 = AREA DRAIN
1 12SQ. INCHES GRATE FREE
AREA BY 4 INCH OUTLET
2. SEE ARCHITECTURAL STANDARD FOR SLAB AND ROOF WATERPROOF MEMBRANES.
3. PROVIDE DECK CLAMPS FOR ROOF DRAINS WHERE REQUIRED.

Santa Clara Valley Transportation Authority

NO EXCEPTIONS TAKEN (NET)
MAKE CORRECTIONS NOTED (MCN)
AMEND AND RESUBMIT (A/R)

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Contract No.: DB11002F

By: _____ Date: _____

NO SCALE

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DRAWN BY
P. BLAUVELT
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G. HENNINGS
IN CHARGE
G. HENNINGS
DATE
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510-569-2000


1436 California Circle
Milpitas, California 95035
A Joint Venture
Lockwood, Andrews
& Newnam, Inc.
A LEO A DALY COMPANY

T-Y-LIN INTERNATIONAL
APPROVED
By: _____

BART
SILICON VALLEY
BART SILICON VALLEY BERRYESSA EXTENSION


LINE, TRACK, STATIONS AND SYSTEMS
DESIGN UNIT 023
MILPITAS STATION
PLUMBING DETAILS
1 OF 4

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C700-S-DB-M020.dwg
SIZE SCALE
D NO SCALE
CONTRACT NO. C700 REV. 0
AREA CODE SHEET NO. PAGE NO.
DB M160 0692

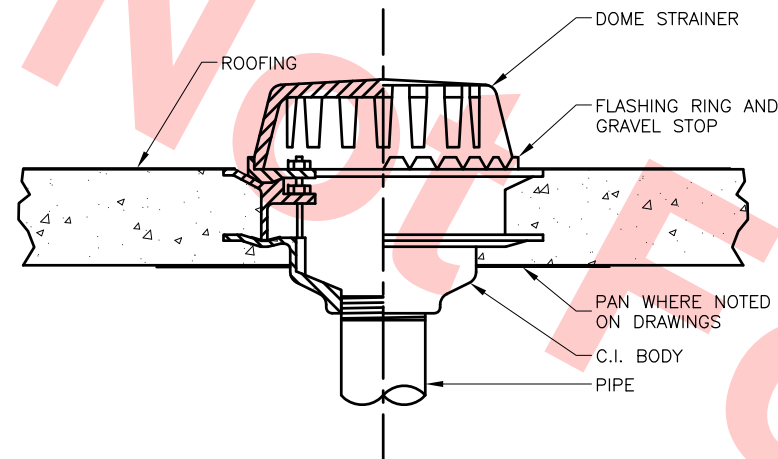


ROOF DRAIN RD-1

DETAIL 1
NO SCALE M161

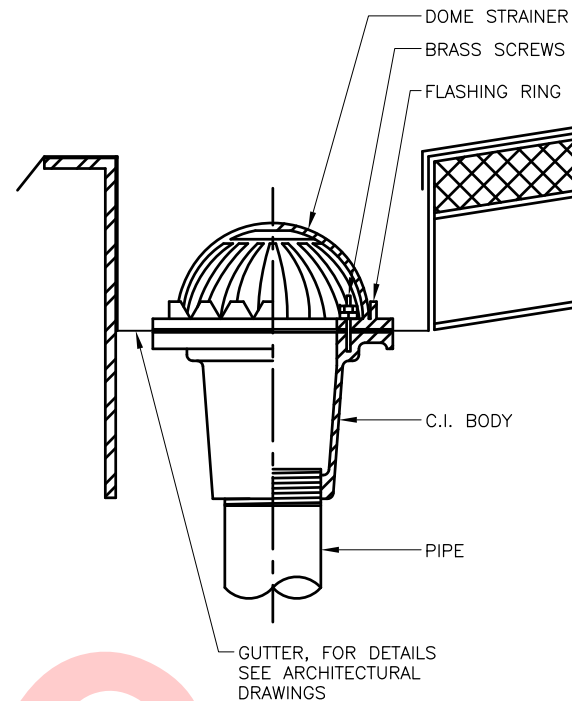


ROOF DRAIN RD-2

DETAIL 2
NO SCALE M161

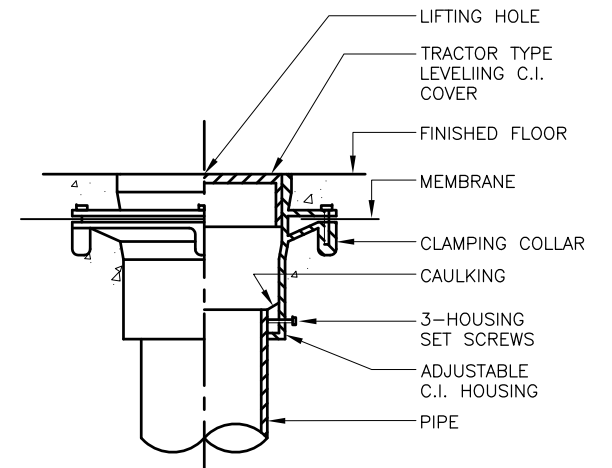

CLEANOUT CO

DETAIL 4
NO SCALE M161

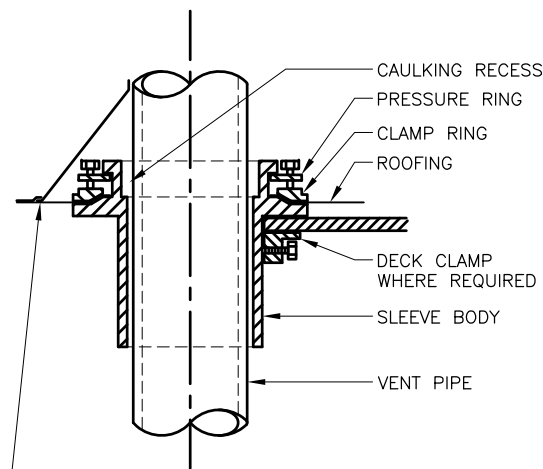


NOTE: SEE ARCHITECTURE DRAWINGS FOR FLASHING DETAILS.

CAST IRON STACK SLEEVE

VENT THRU ROOF


DETAIL 5
NO SCALE M161

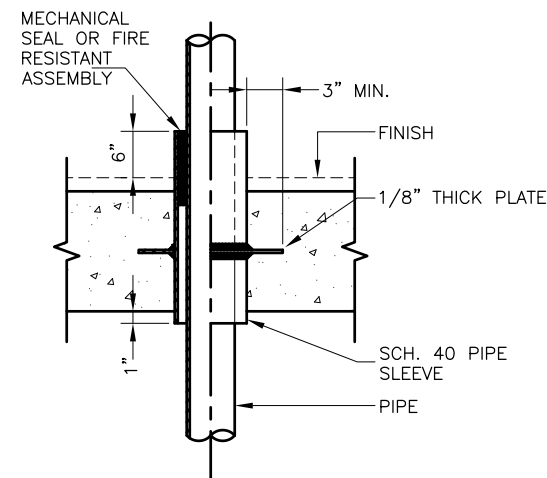

NOTE: GALVANIZED SLEEVE ASSEMBLY AFTER FABRICATION.

INTERIOR PIPE SLEEVE

DETAIL 6
NO SCALE M161

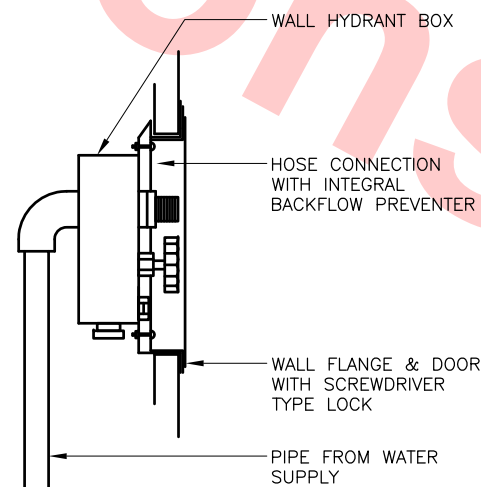

BOX HYDRANT WH-1

DETAIL 7
NO SCALE M161


Santa Clara Valley Transportation Authority

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DETAIL 9
NO SCALE M161

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DESIGNED BY
P. BLAUVELT
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G. HENNING
IN CHARGE
G. HENNING
DATE
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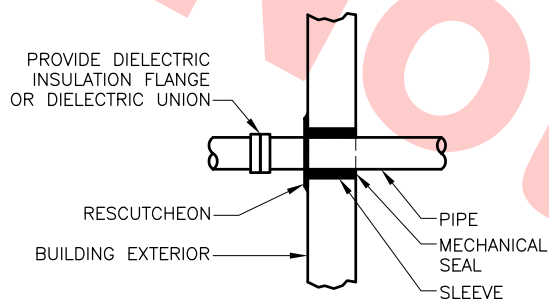
Skanska
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Lockwood, Andrews
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APPROVED
By: _____

BART
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BART SILICON VALLEY BERRYESSA EXTENSION


LINE, TRACK, STATIONS AND SYSTEMS
DESIGN UNIT 023
MILPITAS STATION
PLUMBING DETAILS
2 OF 4

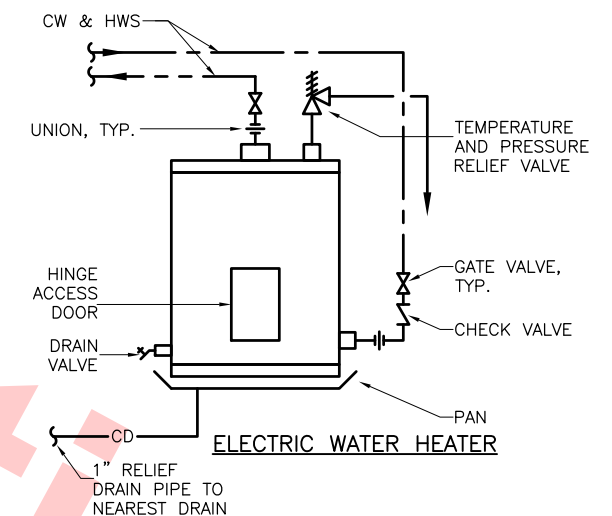CADD FILENAME
C700-S-DB-M161.dwg
SIZE SCALE
D NO SCALE
CONTRACT NO. C700 REV. 0
AREA CODE SHEET NO. M161 PAGE NO. 0693




TYPICAL BUILDING PIPE EXIT

DETAIL 8
NO SCALE M162

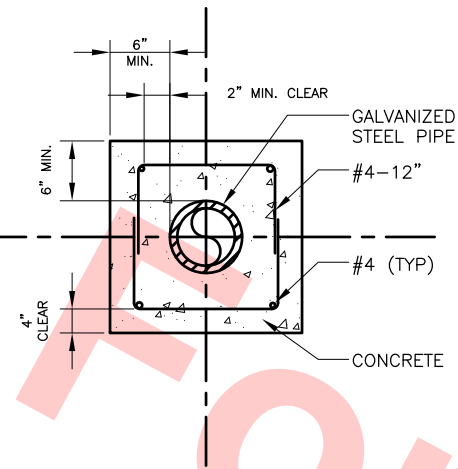


TYPICAL PIPE ENCASEMENT DETAIL

DETAIL 2
NO SCALE M162

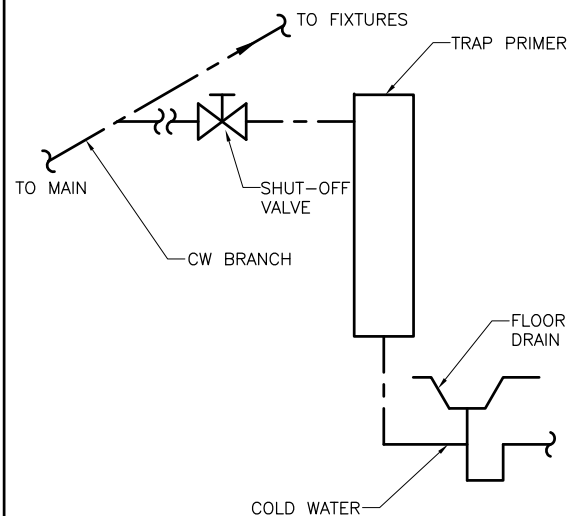


TRAP PRIMER

DETAIL 9
NO SCALE M162

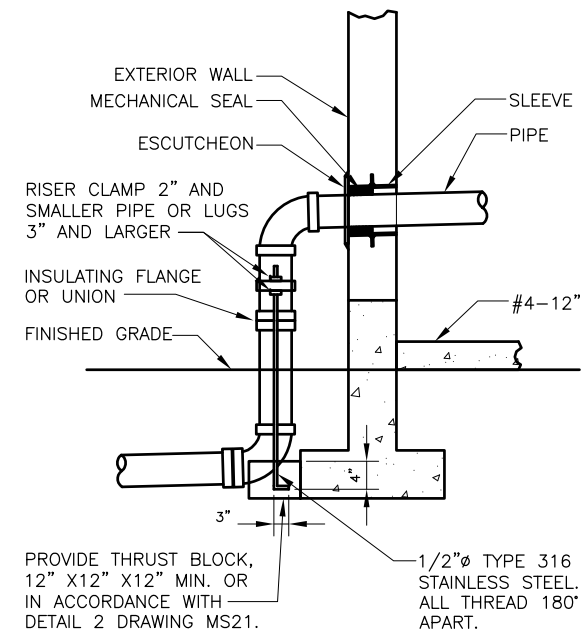


TYPICAL BUILDING PIPE ENTRY

DETAIL 4
NO SCALE M162

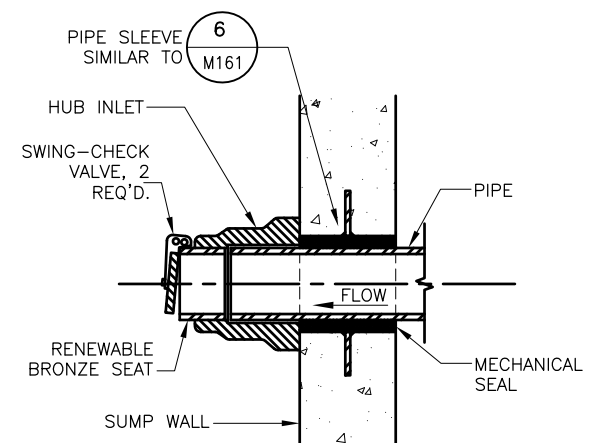

TYPICAL SUMP INLET

DETAIL 5
NO SCALE M162

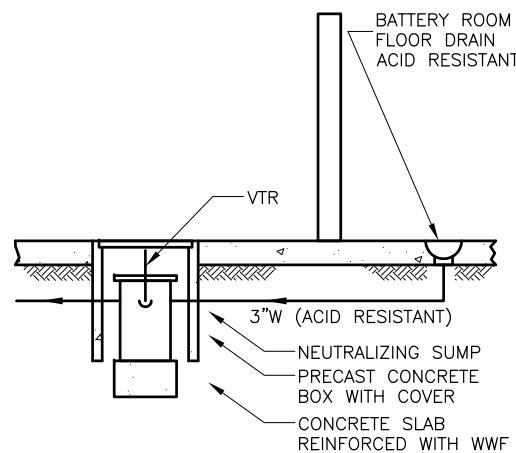


NOTES:

1. LOCATE NEUTRALIZING SUMP IN ACCESSIBLE NON-PUBLIC AREA.
2. PROVIDE TRAP AND VENT PER CODE, EXTEND ACID RESISTANT "W" TO NEUTRALIZING SUMP

BATTERY ROOM FLOOR DRAIN

DETAIL 6
NO SCALE M162

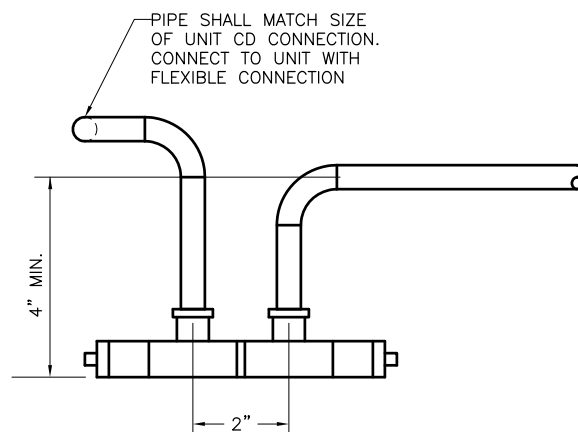

EXTERNALLY TRAPPED CONDENSATE DRAIN PIPING

DETAIL 7
NO SCALE M162

Santa Clara Valley Transportation Authority

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P. BLAUVELT
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G. HENNINGS
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G. HENNINGS
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Skanska Shimmick Herzog

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Milpitas, California 95035
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Lockwood, Andrews & Newnam, Inc.
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T-Y LIN INTERNATIONAL



APPROVED *Ry Apolunth*







LINE, TRACK, STATIONS AND SYSTEMS
DESIGN UNIT 023
MILPITAS STATION

PLUMBING DETAILS
3 OF 4

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CONTRACT NO. C700	SHEET NO. M162	REV. 0
AREA CODE DB	PAGE NO. 0694	

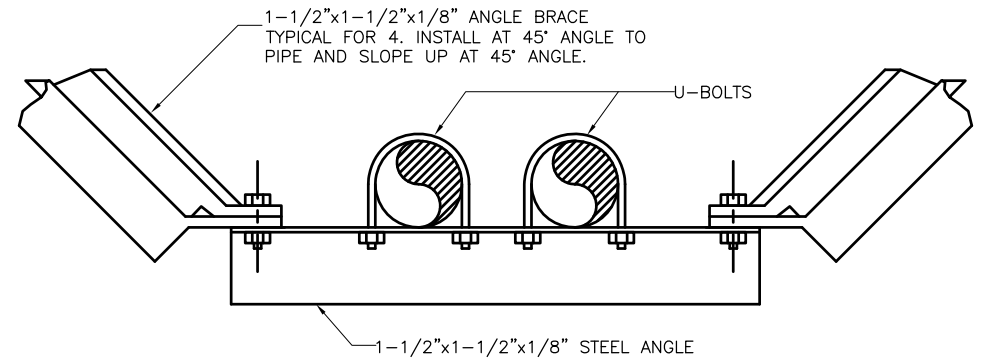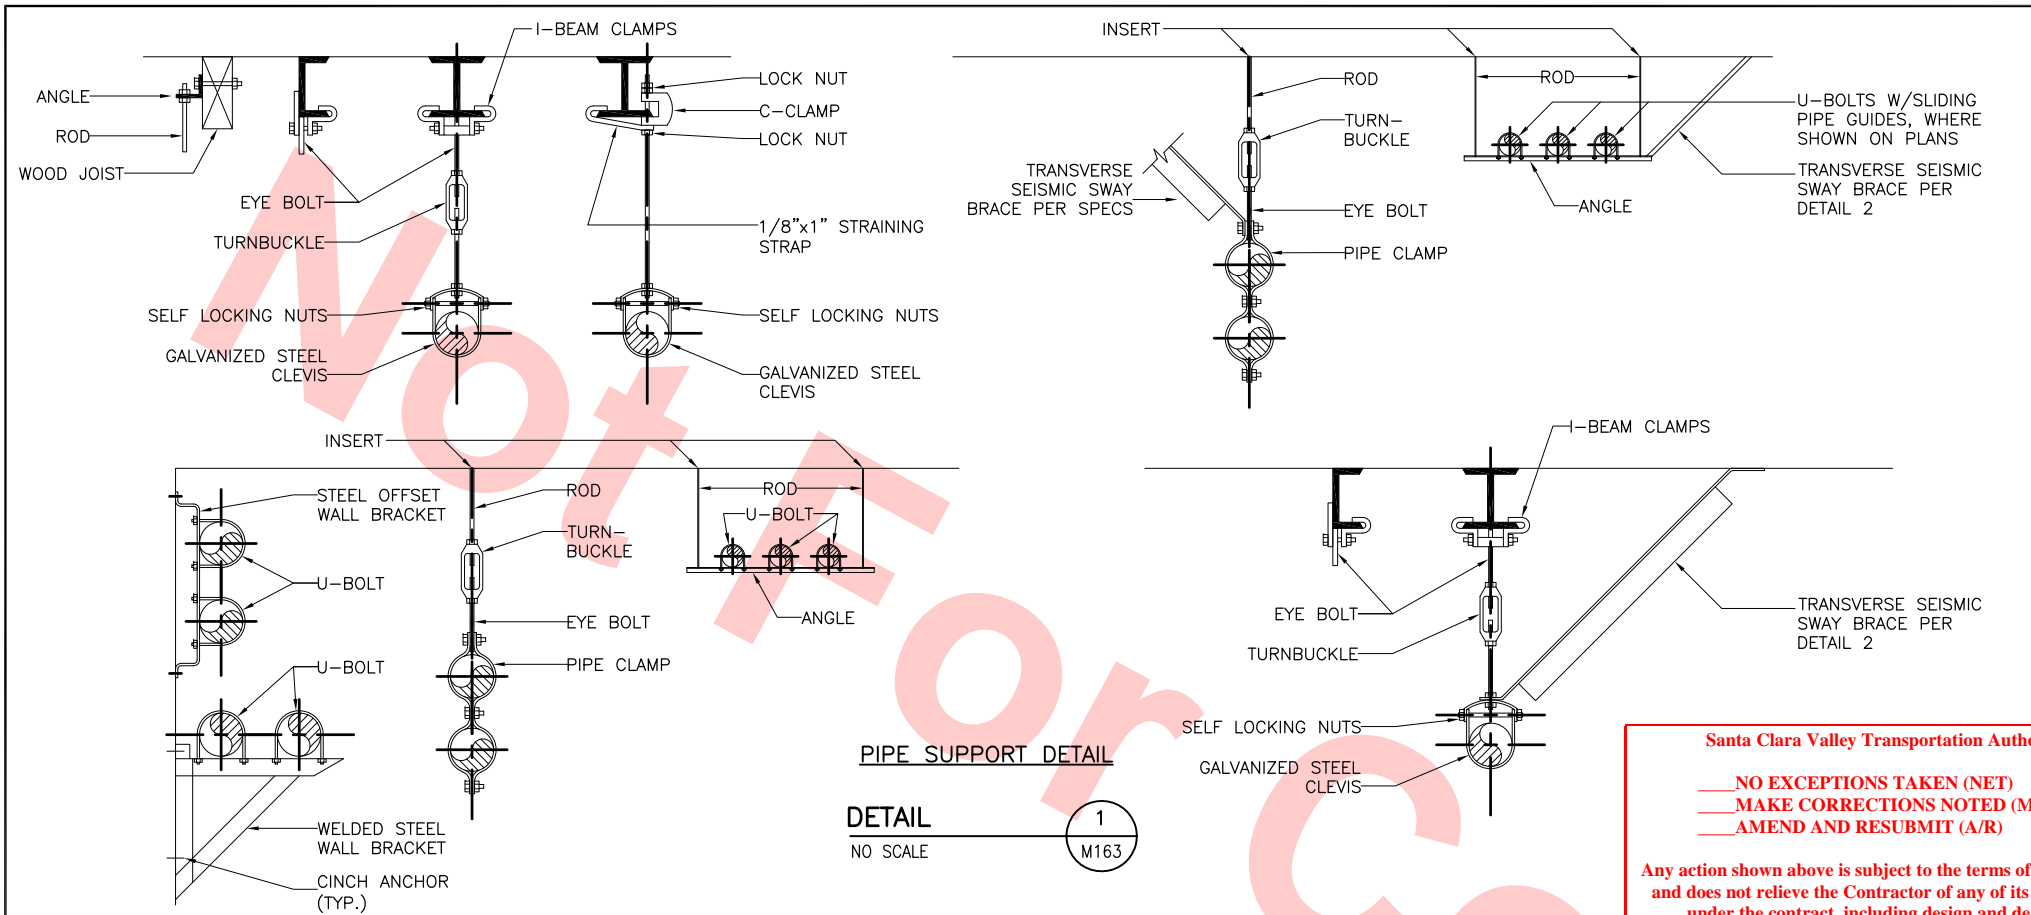


Santa Clara Valley Transportation Authority
 NO EXCEPTIONS TAKEN (NET)
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 Contract No.: **DB11002F**
 By: _____ Date: _____

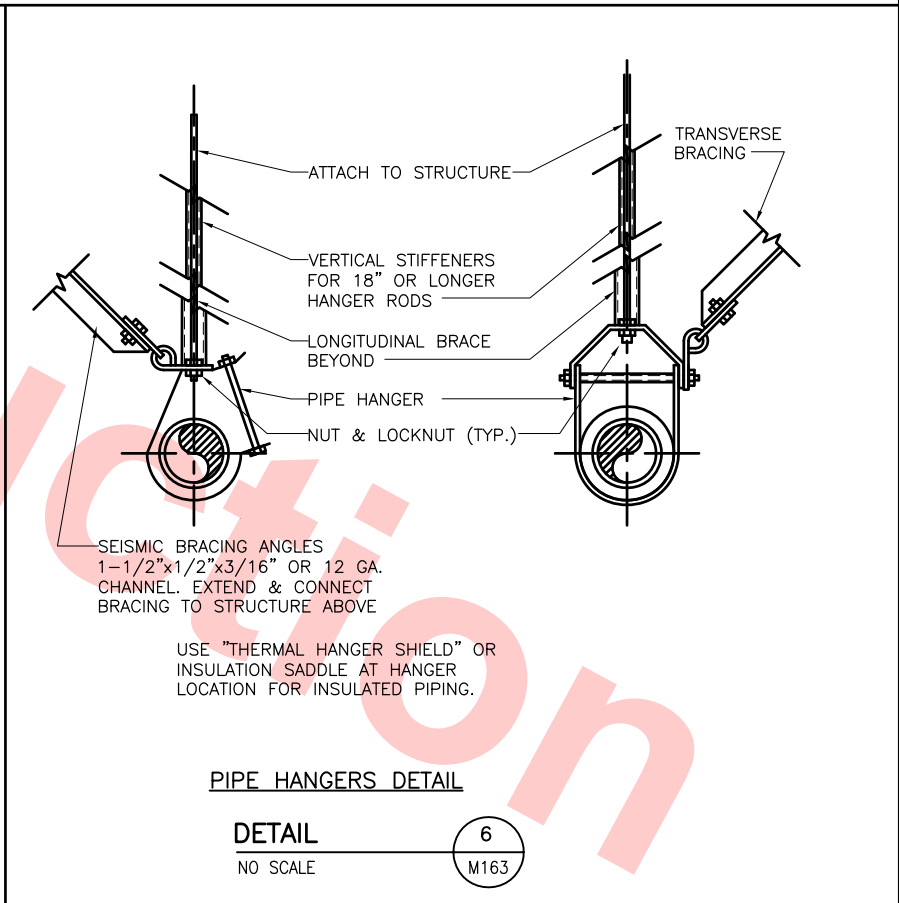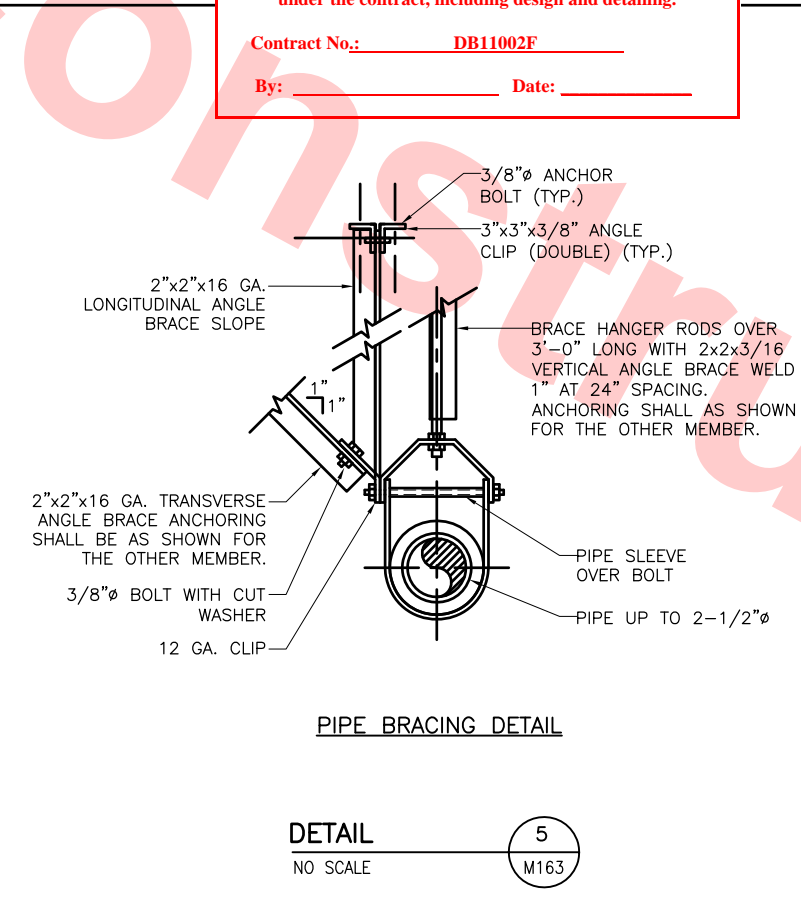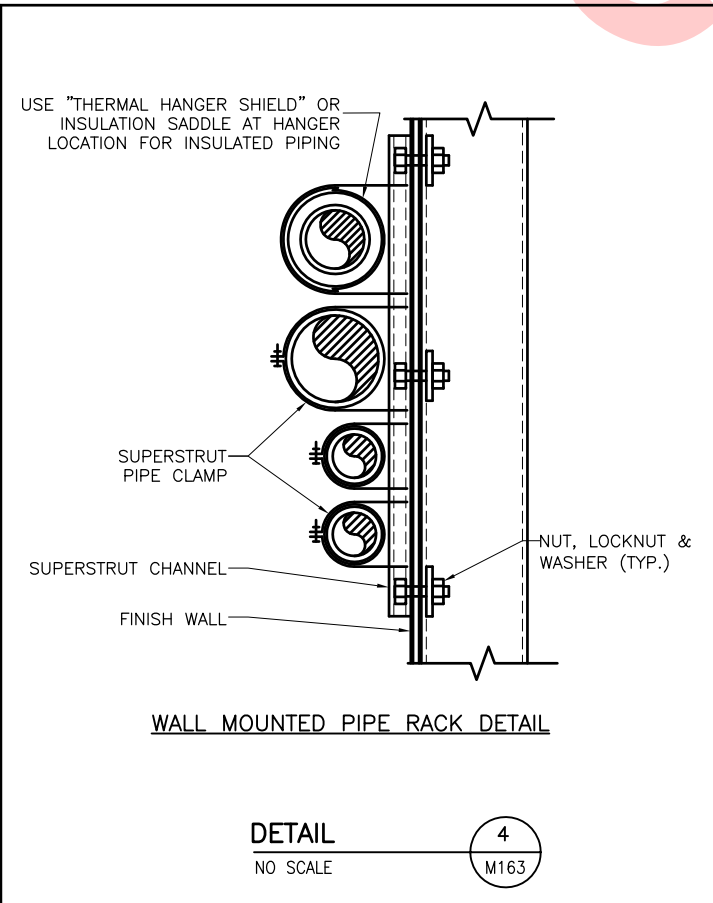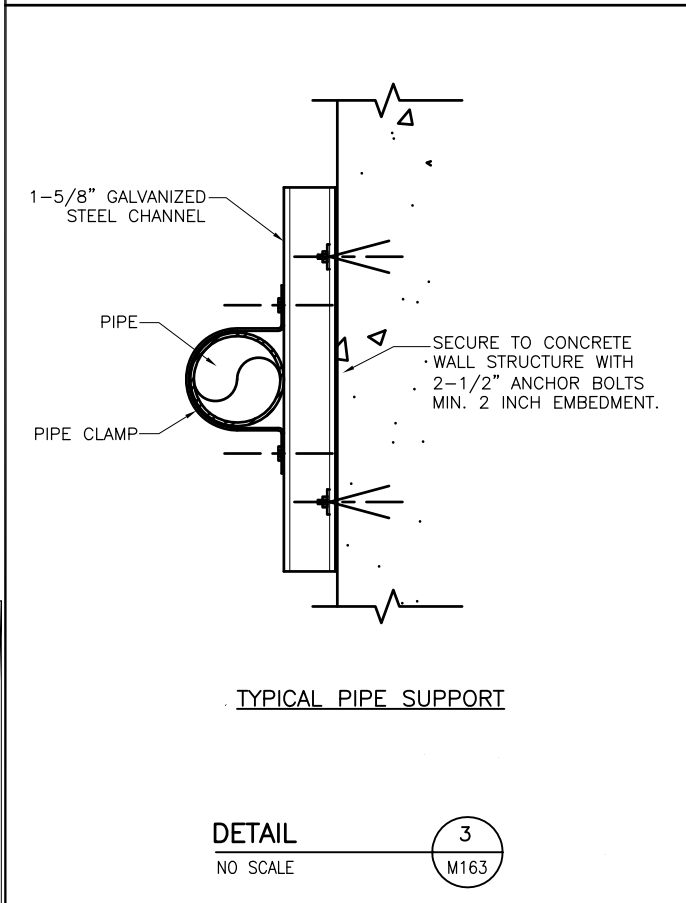


REV	DATE	BY	SUB	APP	DESCRIPTION
0	20130710				READINESS FOR CONSTRUCTION

DESIGNED BY
P. BLAUVELT
 DRAWN BY
P. BLAUVELT
 CHECKED BY
G. HENNINGS
 IN CHARGE
G. HENNINGS
 DATE
20130710

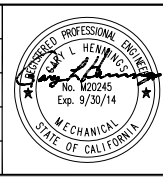

Skanska Shimmick Herzog
 1436 California Circle
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 8517 Earhart Rd. #230
 Oakland, CA 94621
 510-569-2000

Lockwood, Andrews & Newnam, Inc.
 T-Y-LIN INTERNATIONAL
 APPROVED *Ry. Apolunth*

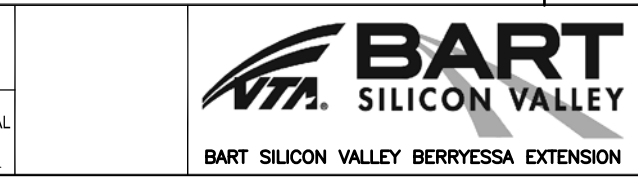

LINE, TRACK, STATIONS AND SYSTEMS
DESIGN UNIT 023
MILPITAS STATION
PLUMBING DETAILS
4 OF 4

CADD FILENAME C700-S-DB-M163.dwg	REV. 0
SIZE SCALE D NO SCALE	PAGE NO. 0695
CONTRACT NO. C700	
AREA CODE DB	SHEET NO. M163

WASTE AND WATER CALCULATIONS					
FIXTURE	QUAN.	WASTE		COLD WATER	
		F.U.EA.	TOTAL	F.U.EA.	TOTAL
WATER CLOSET (F.V.)	3	5	15	5	15
URINAL	2	4	8	4	8
LAVATORY	3	1	3	1	3
DRINKING FOUNTAIN	3	.05	1.5	0.5	1.5
SINK	1	3	3	1.5	1.5
MOP SINK	7	3	21	3	27
FLOOR SINK	3	3	9	-	-
FLOOR DRAIN	40	0	0	0	0
HOSE BIBB	12	1 + *	13.5	1 + *	13.5
*2.5 for the first hose bib and 1 F.U. for each additional					
TOTAL F.U.			89	-	69.5
GPM			44.5	-	108
PIPE SIZE			4"	-	3"

DOMESTIC WATER PRESSURE CALCULATIONS					
1. RESIDUAL PRESSURE	66	PSI			
2. STATIC PRESSURE LOSS (2 FT X .433)	.87	PSI			
3. LOSS THRU METER	3	PSI			
4. LOSS THRU BFP	8	PSI			
5. PRESSURE REQUIREMENT AT LAST FIXTURE	25	PSI			
PRESSURE AVAILABLE FOR DISTRIBUTION	29.13	PSI			
TOTAL DEVELOPED LENGTH OF PIPE	777	FT.			
ALLOWABLE FRICTION LOSS PER 100 FT. :					
100FT. x ($\frac{29.13}{777}$ FT.) = 777	3.75	PSI			
PIPE SIZE	MAX. FLOW (GPM)	F.U. (FT)	F.U. (FV)	LOSS/100'	VELOCITY FPS
1/2"	12	1	-	3.0	1.5
3/4"	3.5	3	-	↓	2.5
1"	7	13	-		3.0
1 1/4"	12	21	-		4.0
1 1/2"	25	42	8		4.5
2"	60	175	76	2.5	6.0
2 1/2"	110	431	295		6.5
3"	150	638	559		8.0

ROOF CALCULATIONS				
LOCATION	DESCRIPTION	SQ. FT.	GPM	DIFFERENCE
	COLUMNS 21-23			
	B-B.2	551	34	3"
	B.8-C	551	34	3"
	COLUMNS 1-6			
	A-D	8026	139	5"
	MAIN BODY OF ROOF			
	COLLINS 5-12	46,423	1384	12"
	BIG (CENTER)	3019	78	4"
	SMALL (A)	738	34	3"
	SMALL (B)	738	34	3"
	POC	3906	144	4"
	ANCILLARY BUILDING	3866	144	4"
NOTE: SEE PLUMBING DRAWINGS FOR DETAILS . ALL CALCULATIONS ARE BASED ON A 2"/YEAR TABLE 11-1/11-2 CPC				

CA GREEN CODE WATER CONSERVATION CALCS									
BASELINE WATER USE CALCULATION TABLE									
FIXTURE TYPE	FLOW RATE (GPM)	DURATION	DAILY USES	OCCUPANTS				GALLONS PER DAY	
KITCHEN FAUCETS	2.2	x	4 MIN.	x	1	x	12	=	105.6
METERING	1.0	x	0.25 MIN.	x	3	x	5497	=	4122.75
FAUCETS**							2748	=	4396.8
FLUSH VALVE	1.6	x	1 FLUSH	x	1 MALE	x	2748	=	13190.4
WATER CLOSETS					3 FEMALE				
URINALS	1.0	x	1 FLUSH	x	2 MALE	x	2748	=	5496
TOTAL DAILY BASELINE WATER USE (BWU) =									27311.15
27311.75 (BWU) x .80 =21848.92 ALLOWABLE WATER USE									
WATER USE REDUCTION CALCULATION TABLE									
FIXTURE TYPE	FLOW RATE (GPM)	DURATION	DAILY USES	OCCUPANTS				GALLONS PER DAY	
KITCHEN FAUCETS	1.5	x	4 MIN.	x	1	x	12	=	72
METERING	0.5	x	0.25 MIN.	x	3	x	5497	=	206.14
FAUCETS***							2748	=	3517.44
FLUSH VALVE	1.28	x	1 FLUSH	x	1 MALE	x	2748	=	10552.32
WATER CLOSETS					3 FEMALE				
URINALS	0.125	x	1 FLUSH	x	2 MALE	x	2748	=	687
PROPOSED WATER USE =									15034.9
* BASED ON 6 MALE STAFF, 2748 MALE RIDERS, AND 6 FEMALE STAFF AND 2748 FEMALE RIDERS									
**ACTUAL WATER USE REDUCTION = 44.9%									
***BASELINE IS 0.25 GAL PER 0.25 MIN CYCLE, 0.25 GAL/CYCLE x CYCLE/0.25MIN = 1.0 GPM									
****0.2 GAL/CYCLE REQUIRED, 0.5 GPM x 0.25 MIN = 0.13 GAL/CYCLE.									

MISCELLANEOUS PLUMBING EQUIPMENT SCHEDULE				
TAG	LOCATION	TAG	DESCRIPTION	REMARKS
TP-1	MULTIPLE LOCATIONS	TP-1	PPP ELECTRONIC TRAP PRIMER 6 PORT (PT-6)	ELECTRONIC PRIMING MANIFOLD 120 VOLT 3 WIRE CONNECTION.
TP-2		TP-2	PPP ELECTRONIC TRAP PRIMER 6 PORT (PT-8)	ELECTRONIC PRIMING MANIFOLD 120 VOLT 3 WIRE CONNECTION.
TP-3		TP-3	PPP ELECTRONIC TRAP PRIMER 6 PORT (PT-10)	ELECTRONIC PRIMING MANIFOLD 120 VOLT 3 WIRE CONNECTION.

ELECTRIC WATER HEATER SCHEDULE													
ITEM	LOCATION	MANUFACTURER	MODEL NO.	SERVICE	STORAGE	ELECTRICAL DEMANDS				RECOVERY CAPACITY 80 DEG. (UON)	INLET TEMP °F	OUTLET TEMPER °F	
						VOLT	PHASE	KW	AMP				
EW1-1	MULTIPLE LOCATIONS	BRADFORD WHITE	LD-10U3-1	DOMESTIC HOT WATER	10 GALLONS	277	1	2.0	—	10	60	120	
EW1-2		BRADFORD WHITE	LD-15U3-1		15 GALLONS	277	1	3.0	—	15	60	120	
EW1-3		BRADFORD WHITE	LD-30U3-1		30 GALLONS	277	1	6.0	—	31	60	120	

Santa Clara Valley Transportation Authority

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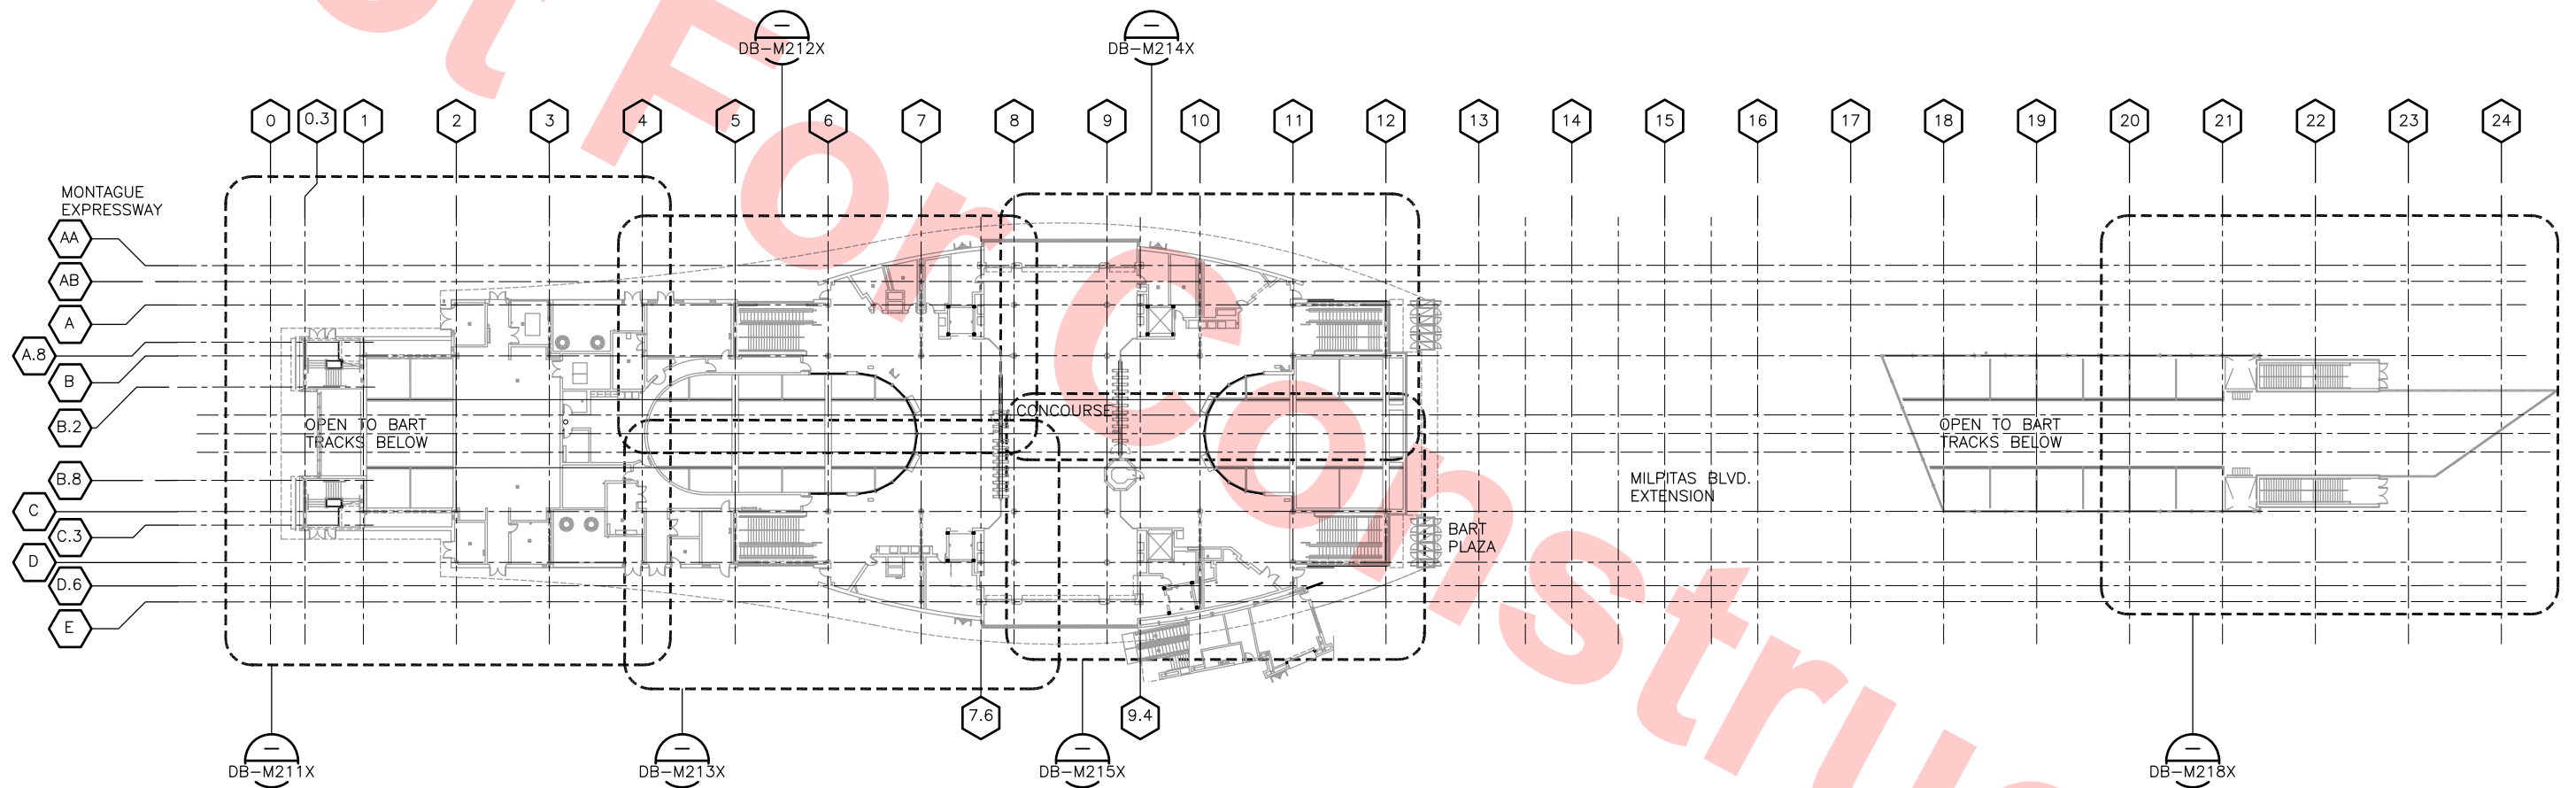
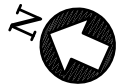
Contract No.:

DB11002F

By:

Date:

PUMP SCHEDULE												
EQUIPMENT I.D.	MANUFACTURER MODEL	LOCATION	SERVICE	TYPE	DESIGN FLOW RATE	TOTAL DYNAMIC HEAD	DISCHARGE SIZE	TRIM DIA.	MOTOR RATING	V./PH./HZ.	REMARKS	
					GPM	FEET	IN	IN	HP			
SE-1	HYDROMATIC S3HVX	RM P-11 UTILITY ROOM 3	SANITARY SEWER EJECTOR	DUPLEX WITH ALTERNATOR, RECESSED IMPELLER SEWERAGE PUMP	50	30	3	10.375	3	200/3/60	PROVIDE ELBOW FITTING, 316 STAINLESS STEEL LIFTING CABLE, CONTROL PANEL INCLUDING SOLID STATE MOTOR STARTER, OVERLOAD DISCONNECT, GUIDE RAILS AND SUPPORTS. FOR ADDITIONAL REQUIREMENTS SEE SUMP PUMP SPECIFICATION 22 14 29.COORDINATE WITH ELECTRICAL FOR CONTROLS. INSTALL PER MANUFACTURER'S RECOMMENDATION.	
		RM P-12 UTILITY ROOM 4										
IWE-1		RM P-32 UTILITY ROOM 5	INDUSTRIAL WASTE EJECTOR									
		RM P-31 UTILITY ROOM 6										



KEY PLAN CONCOURSE LEVEL — HVAC
SCALE: 1/32"=1'-0"


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DRAWN BY J. CHOU
CHECKED BY G. HENNINGS
IN CHARGE G. HENNINGS
DATE 20130710



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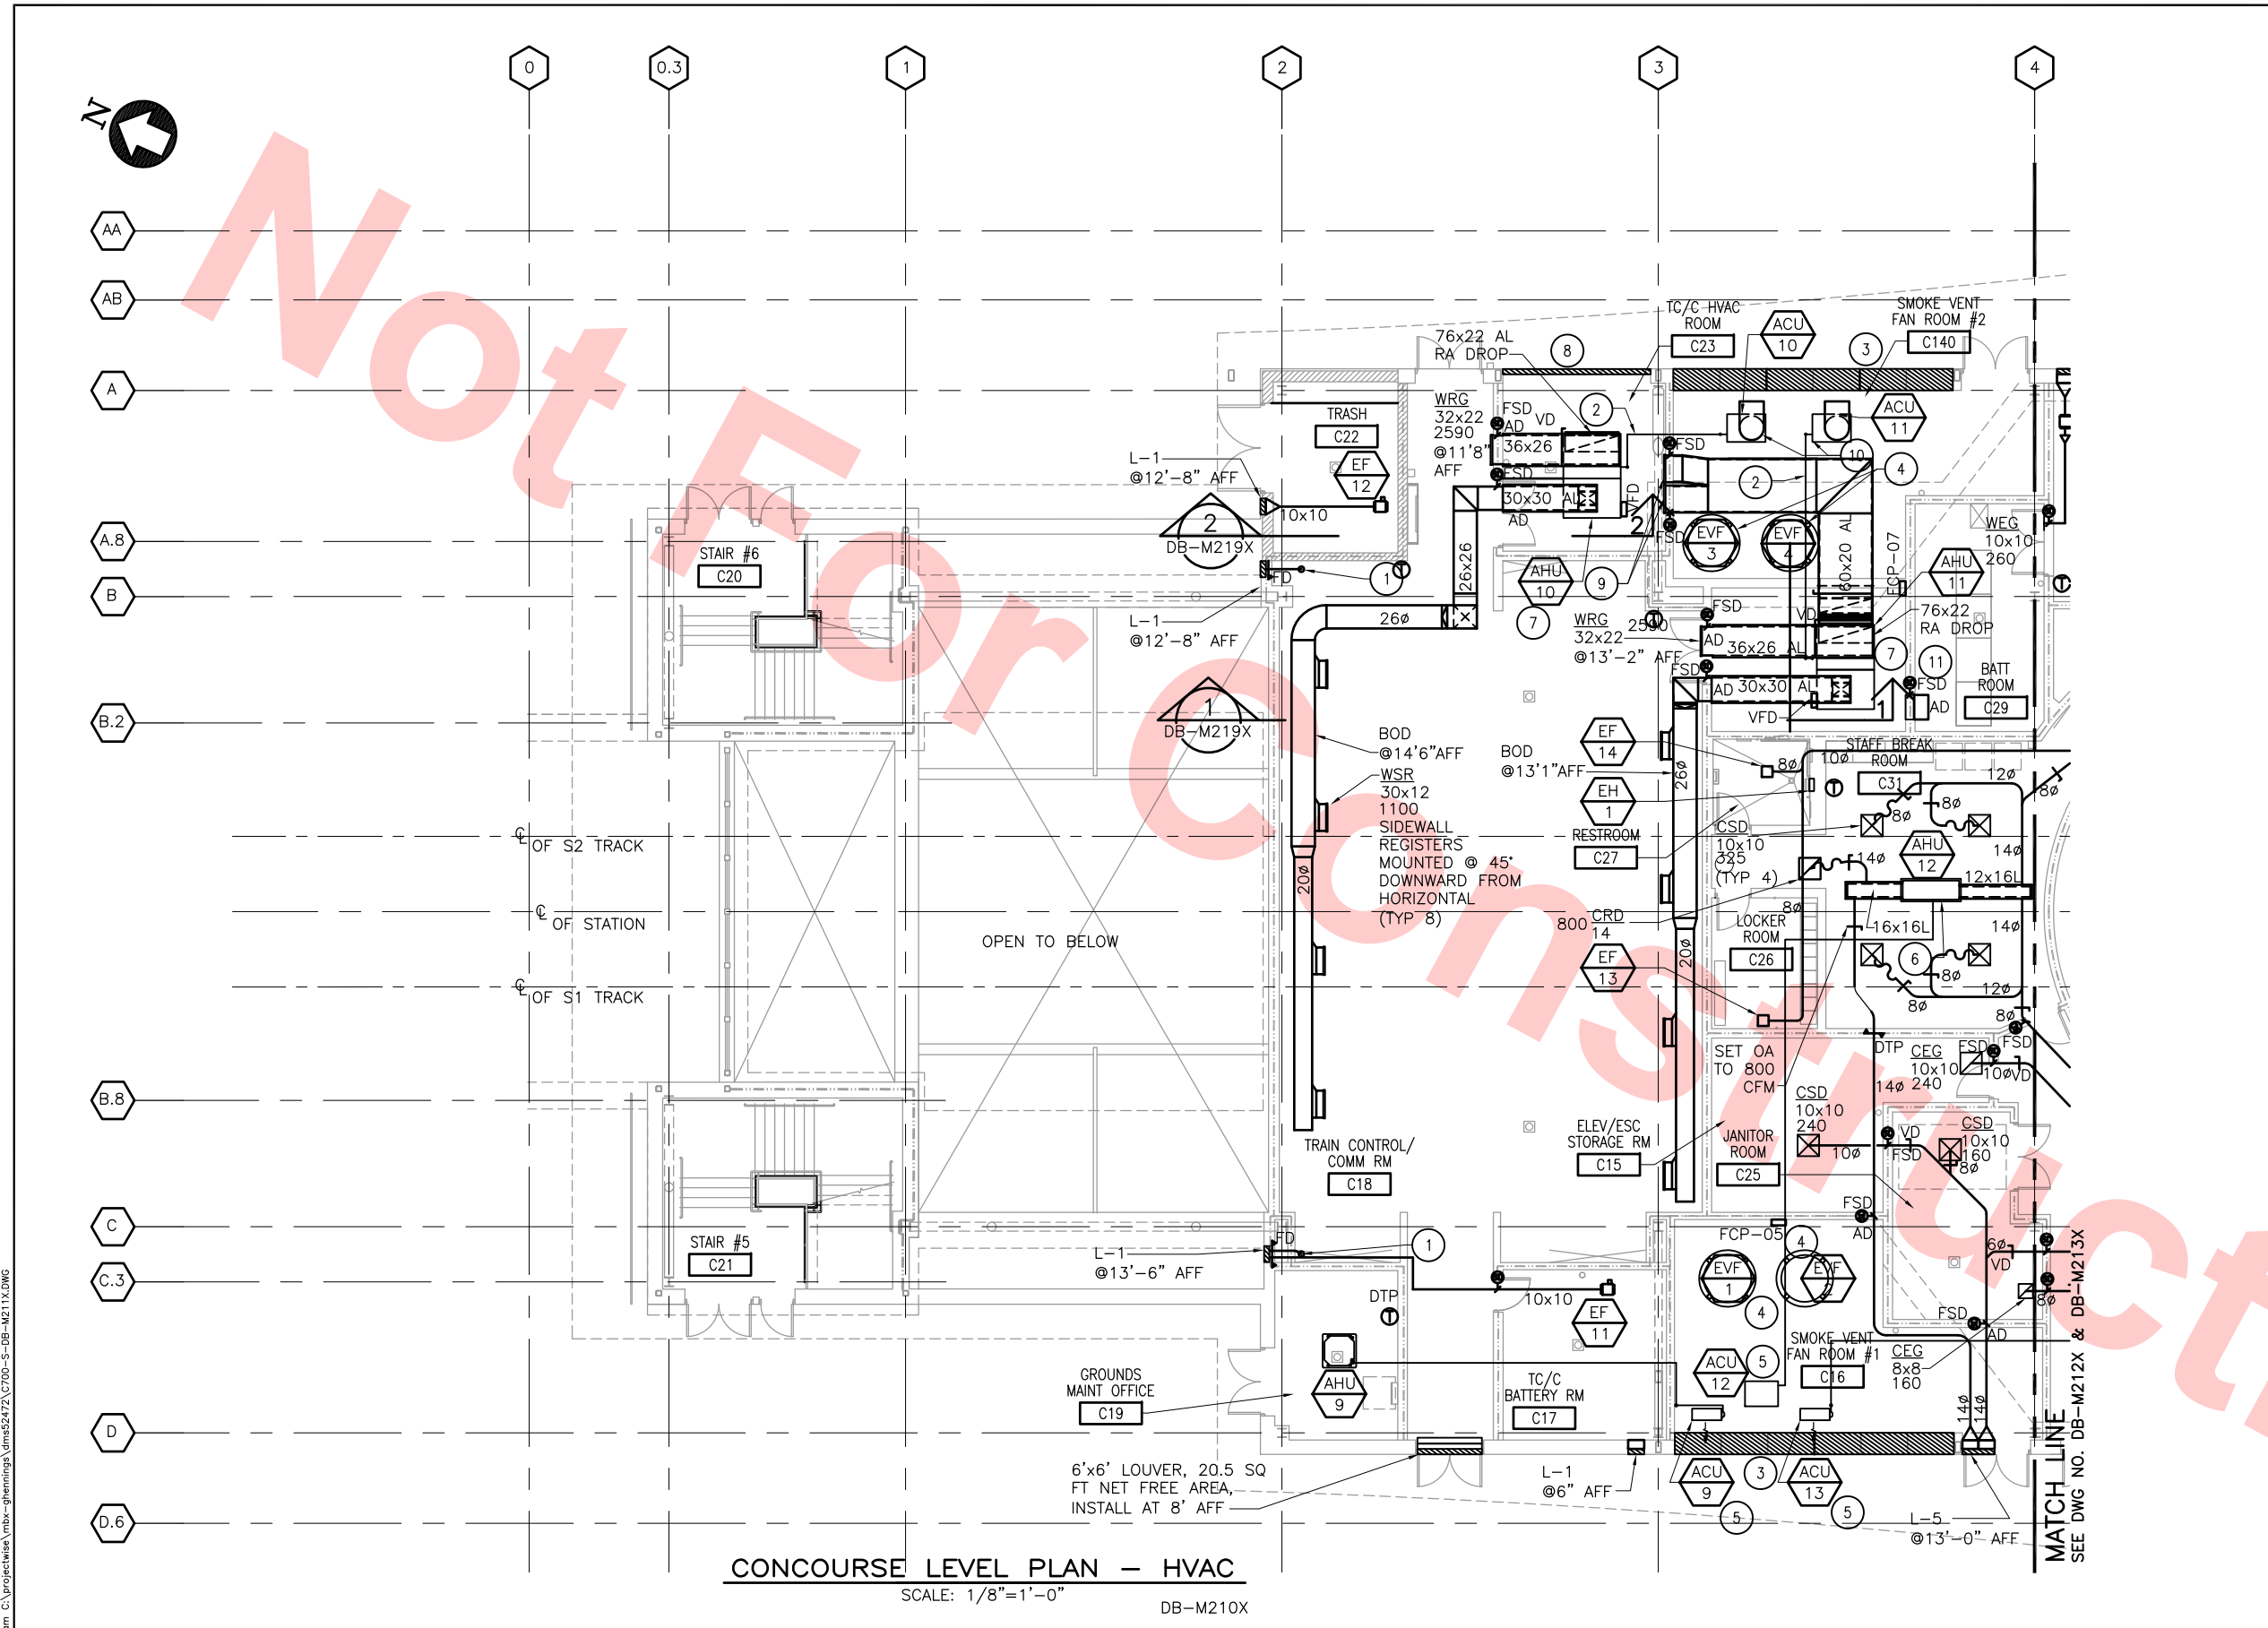
SUBMITTED *[Signature]*

APPROVED *[Signature]*

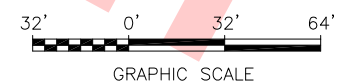

LINE, TRACK, STATIONS AND SYSTEMS
DESIGN UNIT 023
MILPITAS STATION
KEY PLAN CONCOURSE LEVEL
HVAC

CADD FILENAME C700-S-DB-M210X.dwg		
SIZE D	SCALE 1/32"=1'-0"	
CONTRACT NO. C700		REV. 0
AREA CODE DB	SHEET NO. M210X	PAGE NO. 0698



CONCOURSE LEVEL PLAN - HVAC
SCALE: 1/8"=1'-0" DB-M210X

KEY NOTES

- 1 6ø EA DUCT FROM JANITOR ROOM BELOW TO LOUVER
- 2 REFRIGERANT LINE SET, CONNECT FROM DX COIL AT AIR HANDLER AND EXTEND TO ASSOCIATED CONDENSING UNIT, SEE SHEET NO. DB-M365.
- 3 24" DEEP ACOUSTICAL INTAKE LOUVER, MINIMUM 64 SQFT NET FREE AREA, SEE SHEET NO. DB-A316X FOR SIZES
- 4 SEE SHEET NO. DB-M364, DETAIL 2
- 5 SEE SHEET NO. DB-M362, DETAIL 4
- 6 SECONDARY DRAIN PAN UNDER AIR HANDLER. MOUNT AT 10' AFF AND AIR HANDLER AT 10'-4" AFF
- 7 MOUNT AIR HANDLER ON HOUSEKEEPING PAD, SEE SHEET NO. DB-M363, DETAIL 6
- 8 INTAKE LOUVER, MINIMUM 15 SQFT NET FREE AREA, SEE SHEET NO. DB-A316X FOR SIZE
- 9 INTAKE GRILLE, 30x20 WRG, 2200 CFM (DURING AIR ECONOMIZER MODE) @ 13'2" AFF
- 10 EXTEND CONDENSING UNIT AIR DISCHARGE UP AND WITH A LONG RADIUS ELBOW DISCHARGE HORIZONTALLY TOWARDS THE LOUVER, CONNECTION SIZE OF CONDENSING UNIT
- 11 26x10 WTG GRILLE WITH OUT OF WALL FSD, ACCESS DOOR LOCATED ON BATT ROOM SIDE, MT @ 12" AFF

Santa Clara Valley Transportation Authority

NO EXCEPTIONS TAKEN (NET)
MAKE CORRECTIONS NOTED (MCN)
AMEND AND RESUBMIT (A/R)


Any action shown above is subject to the terms of the contract and does not relieve the Contractor of any of its obligations under the contract, including design and detailing.

Contract No.: DB11002F

By: _____ Date: _____



KEY PLAN

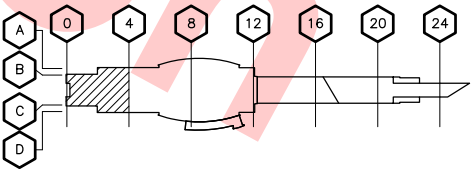

DESIGNED BY J. CHOU	0	20130710	BY	DATE	20130710
DRAWN BY J. CHOU	1		SUB		
CHECKED BY G. HENNINGS	2		APP		
IN CHARGE G. HENNINGS	3				
DATE 20130710	4				
DESCRIPTION READINESS FOR CONSTRUCTION	5				



Skanska Shimmick Herzog

1436 California Circle
Milpitas, California 95035
A Joint Venture


Block Construction Inc.
4455 Enterprise St., Fremont, CA 94538
(510) 857-5656 Fax: (510) 857-5656
CA Lic. #679326 email: info@blockco.com

HMM Mechanical Group
8517 East Rd. #230
Oakland, CA 94621
510-569-2000

Lookwood, Andrews & Nowman, Inc.
A LEOP A BALLY COMPANY

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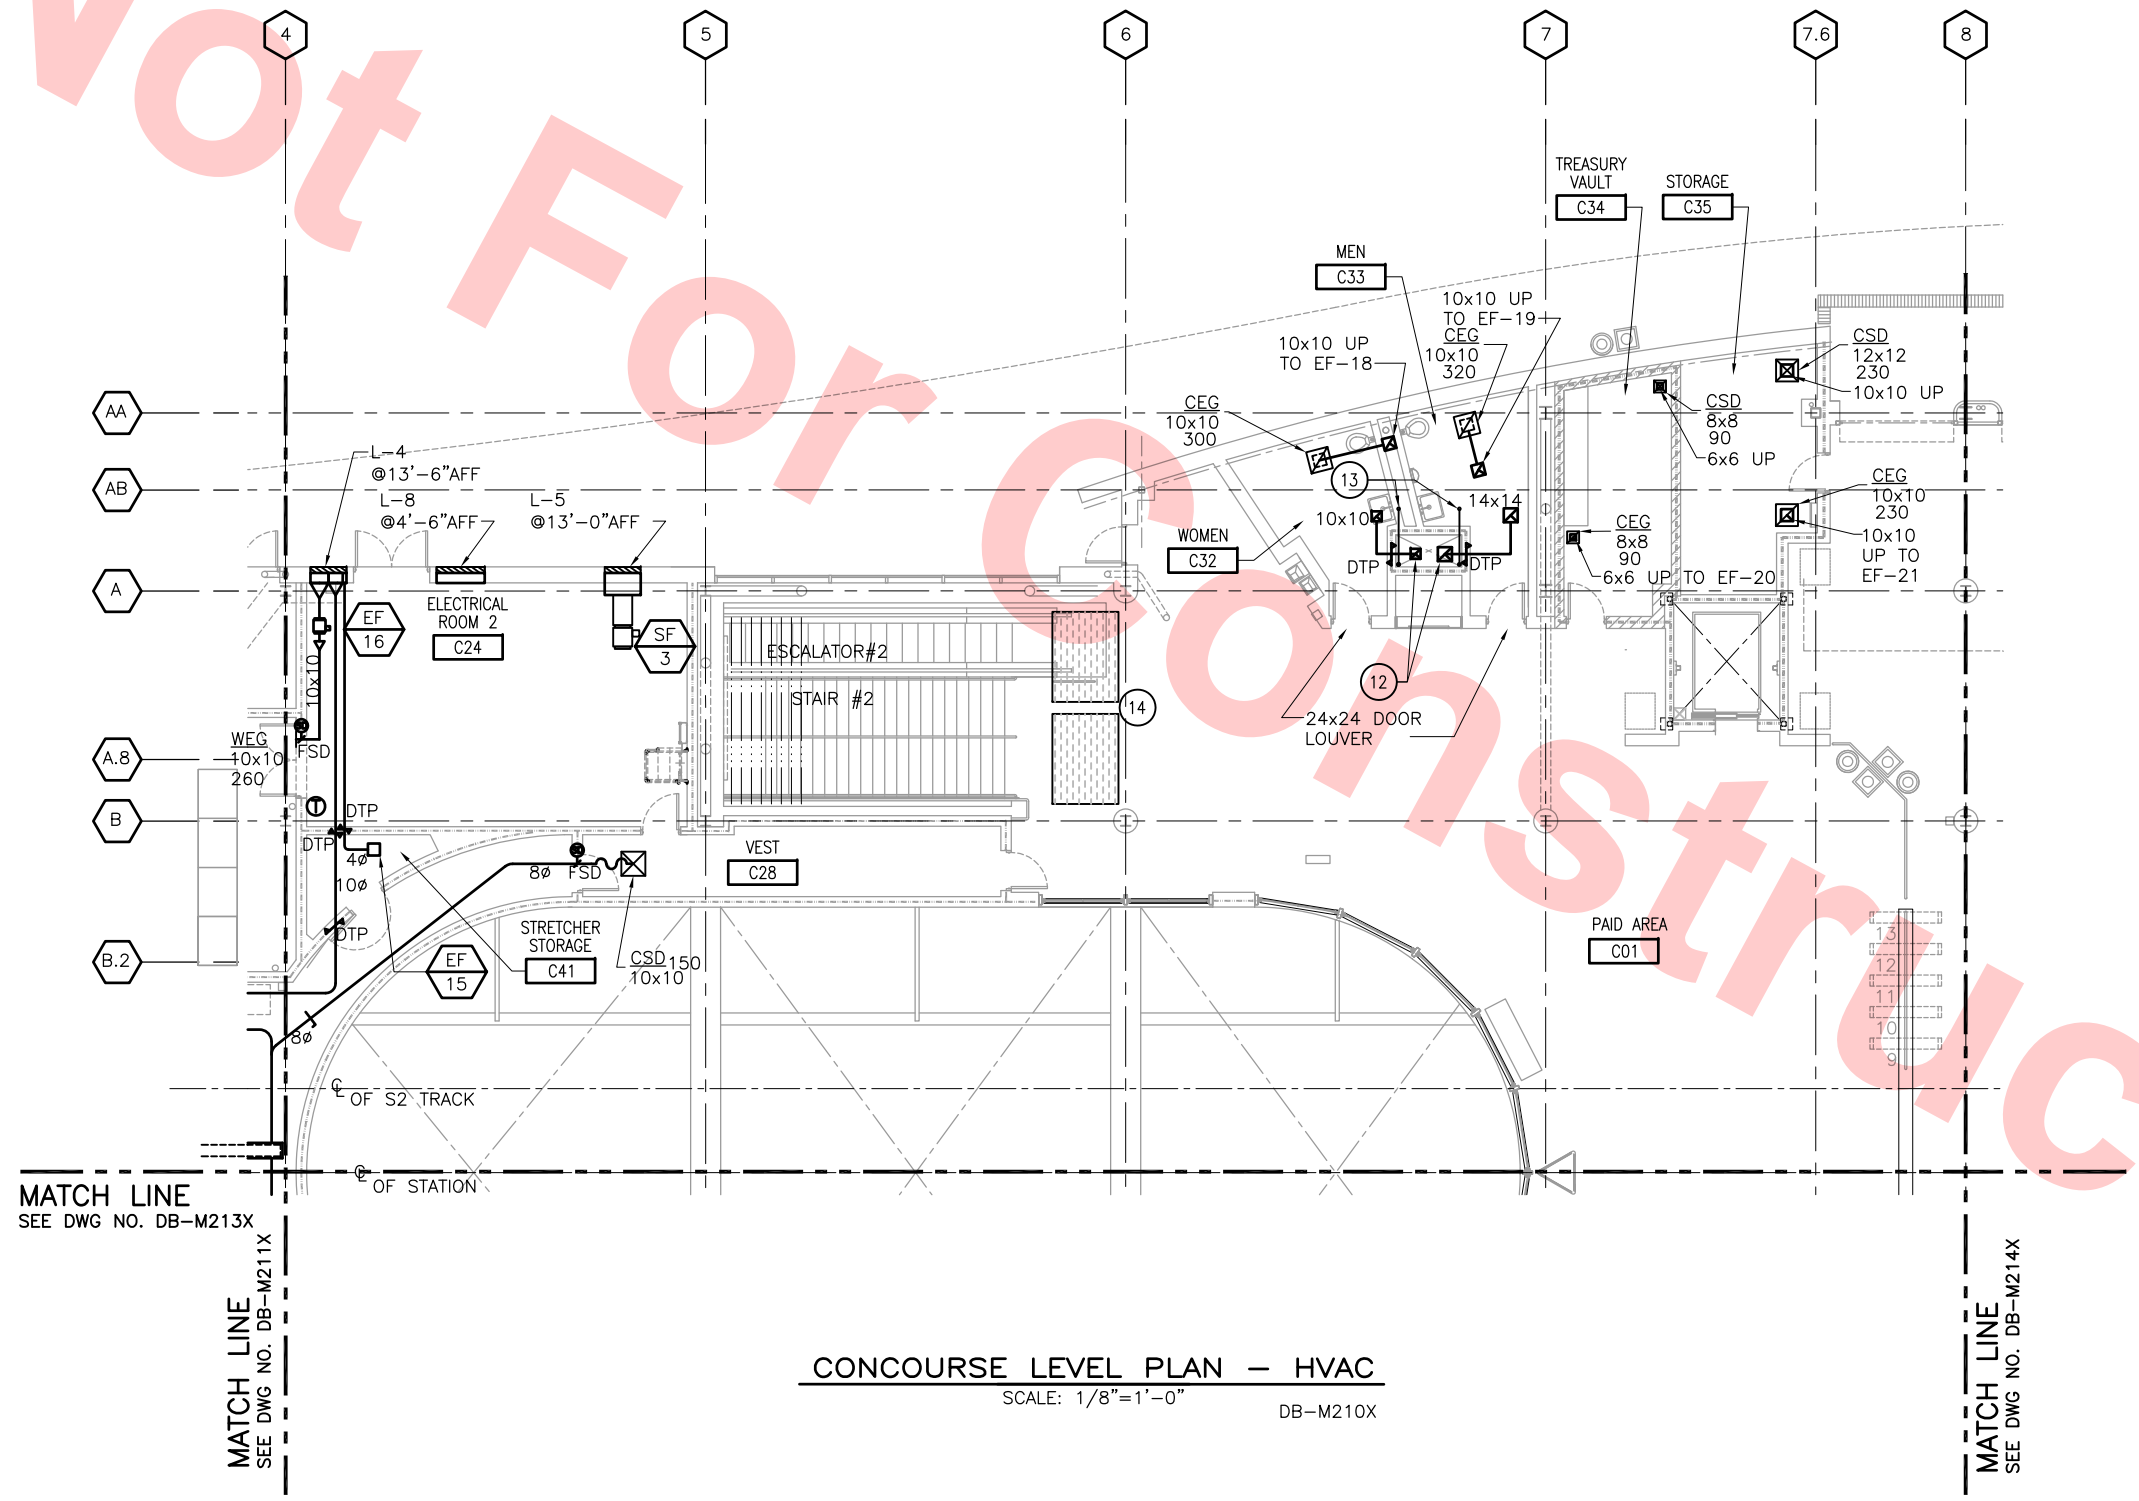
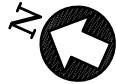
APPROVED

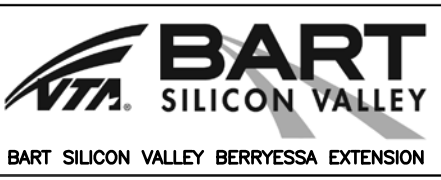

LINE, TRACK, STATIONS AND SYSTEMS
DESIGN UNIT 023
MILPITAS STATION
CONCOURSE LEVEL PLAN
HVAC
SHEET 1 OF 6

CADD FILENAME C700-S-DB-M211X.dwg	REV.	0
SIZE SCALE D 1/8"=1'-0"	CONTRACT NO.	C700
AREA CODE DB	SHEET NO.	M211X
PAGE NO.		0699

Jul 10, 2013 - 10:44am C:\projects\Bart\Bart-Hennings\Drawings\0700-S-DB-M212X.dwg User: jchou



MATCH LINE
SEE DWG NO. DB-M213X

MATCH LINE
SEE DWG NO. DB-M211X

MATCH LINE
SEE DWG NO. DB-M214X

CONCOURSE LEVEL PLAN - HVAC
SCALE: 1/8"=1'-0" DB-M210X

KEY NOTES

- 12 EA AIR DUCT UP FROM PLATFORM LEVEL TO LOWER ROOF
- 13 RS AND RL REFRIGERANT LINE SETS UP AND DOWN TO CONDENSING UNIT ON LOWER ROOF AND ASSOCIATED AIR HANDLER AT CONCOURSE LEVEL
- 14 (2)7'6"x5'6" LOUVERS AT CEILING


Santa Clara Valley Transportation Authority

NO EXCEPTIONS TAKEN (NET)
MAKE CORRECTIONS NOTED (MCN)
AMEND AND RESUBMIT (A/R)


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Contract No.: DB11002F


By: _____ Date: _____

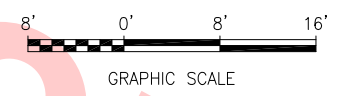

KEY PLAN

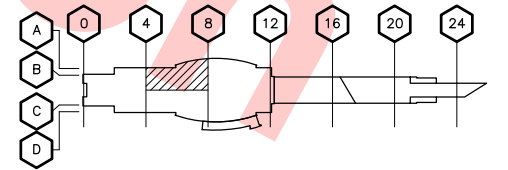

REV	DATE	BY	SUB	APP	DESCRIPTION
0	20130710				READINESS FOR CONSTRUCTION

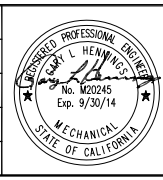

DESIGNED BY
J. CHOU

DRAWN BY
J. CHOU

CHECKED BY
G. HENNINGS

IN CHARGE
G. HENNINGS

DATE
20130710

Skanska
Shimmick
Herzog

1436 California Circle
Milpitas, California 95035
A Joint Venture

Block Construction Inc.
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H&M Mechanical Group
8517 Eastman Rd. #230
Oakland, CA 94621
510-569-2000

Lookwood, Andrews
& Newnam, Inc.
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T-Y LIN INTERNATIONAL

SUBMITTED


APPROVED




LINE, TRACK, STATIONS AND SYSTEMS
DESIGN UNIT 023
MILPITAS STATION
CONCOURSE LEVEL PLAN
HVAC
SHEET 2 OF 6

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SIZE D	SCALE 1/8"=1'-0"
CONTRACT NO. C700	SHEET NO. M212X
AREA CODE DB	PAGE NO. 0700

Jul 10, 2013 10:45am C:\projects\valley\mha-gennings\mha52472\0700-S-DB-M213X.dwg User: jchou

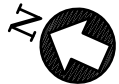

MATCH LINE
SEE DWG NO. DB-M212X

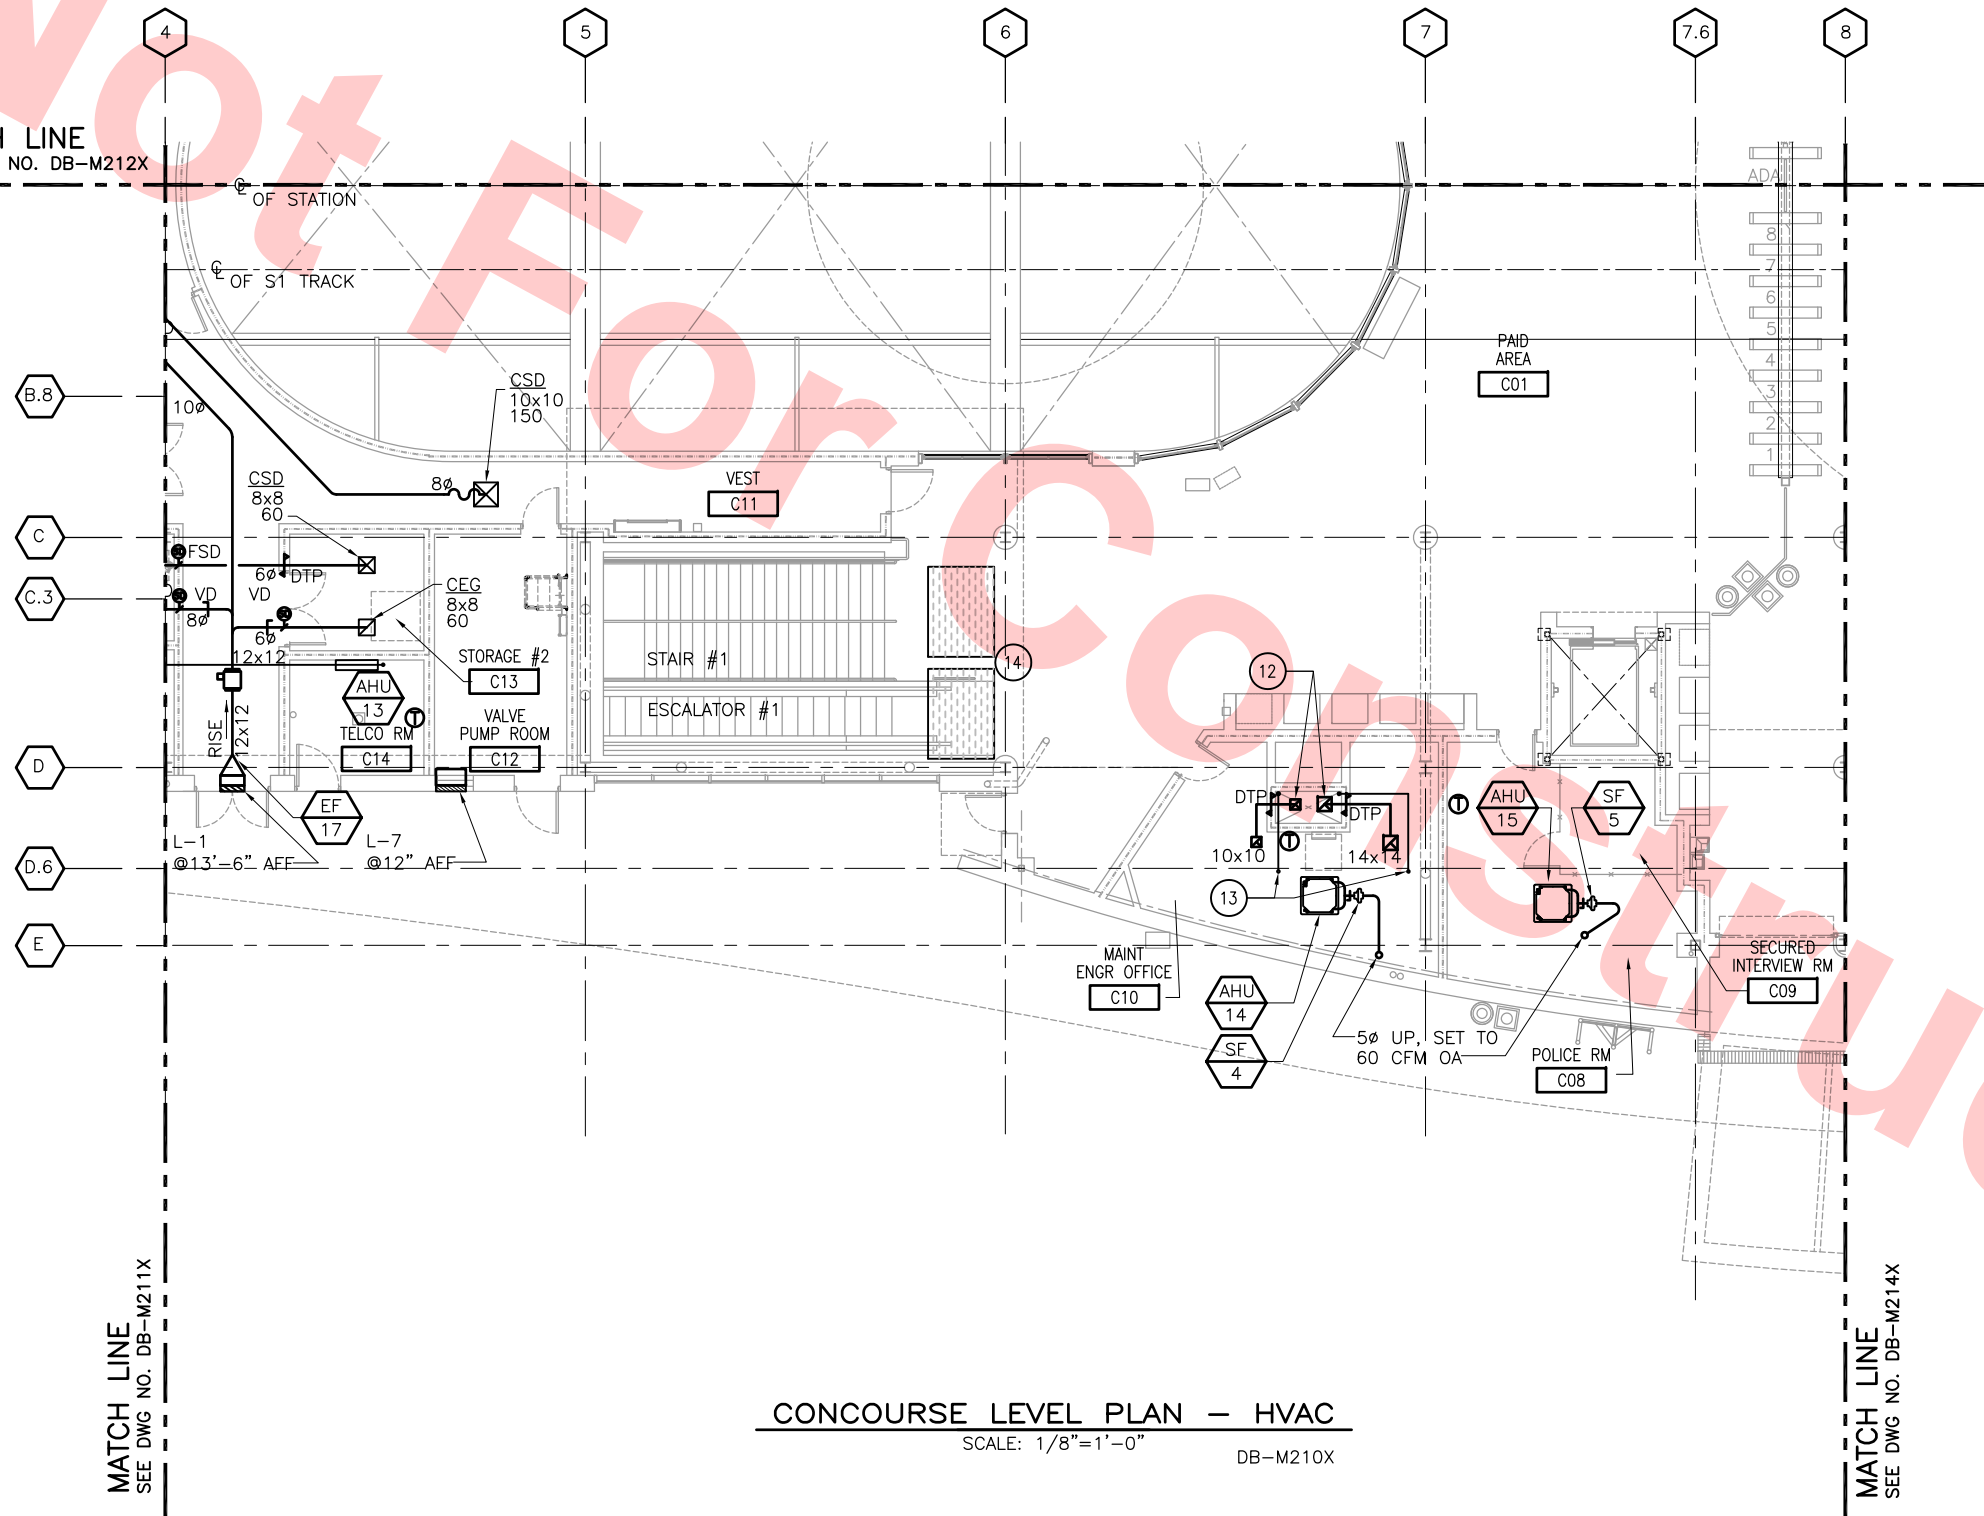

CONCOURSE LEVEL PLAN — HVAC
SCALE: 1/8"=1'-0" DB-M210X

KEY NOTES

- 12 EA AIR DUCT UP FROM PLATFORM LEVEL TO LOWER ROOF
- 13 RS AND RL REFRIGERANT LINE SETS UP AND DOWN TO CONDENSING UNIT ON LOWER ROOF AND ASSOCIATED AIR HANDLER AT CONCOURSE LEVEL
- 14 (2)7'6"x5'6" LOUVERS AT CEILING


Santa Clara Valley Transportation Authority

NO EXCEPTIONS TAKEN (NET)
MAKE CORRECTIONS NOTED (MCN)
AMEND AND RESUBMIT (A/R)


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Contract No.: DB11002F

By: _____ Date: _____

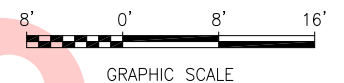

KEY PLAN

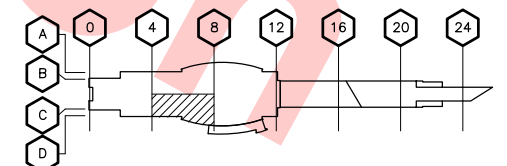

REV	DATE	BY	SUB	APP	DESCRIPTION
0	20130710				READINESS FOR CONSTRUCTION

DESIGNED BY J. CHOU	
DRAWN BY J. CHOU	
CHECKED BY G. HENNING	
IN CHARGE G. HENNING	
DATE 20130710	



Block Construction Inc.
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Skanska
Shimmick
Herzog
HMM Mechanical Group
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1436 California Circle
Milpitas, California 95035
A Joint Venture

Lookwood, Andrews
& Newnam, Inc.
T-Y LIN INTERNATIONAL
APPROVED *[Signature]*



LINE, TRACK, STATIONS AND SYSTEMS
DESIGN UNIT
MILPITAS STATION
CONCOURSE LEVEL PLAN
HVAC
SHEET 3 OF 6

CADD FILENAME C700-S-DB-M213X.dwg	
SIZE SCALE D 1/8"=1'-0"	
CONTRACT NO. C700	REV. 0
AREA CODE DB	SHEET NO. M213X
	PAGE NO. 0701

KEY NOTES

- (14) (2) 7'-6"x5'-6" SUPPLY LOUVERS AT CEILING
- (15) (2) RL AND RS REFRIGERANT LINE SETS FROM PLATFORM LEVEL, EXTEND OVER AND UP TO CONDENSING UNITS
- (16) MOUNT UNIT @ 9' AFF
- (17) 6ø EA DUCT FROM PLATFORM LEVEL, EXTEND TO GOOSENECK ON LOWER ROOF LEVEL, SEE DWG NO. M321

Santa Clara Valley Transportation Authority

- NO EXCEPTIONS TAKEN (NET)
- MAKE CORRECTIONS NOTED (MCN)
- AMEND AND RESUBMIT (A/R)

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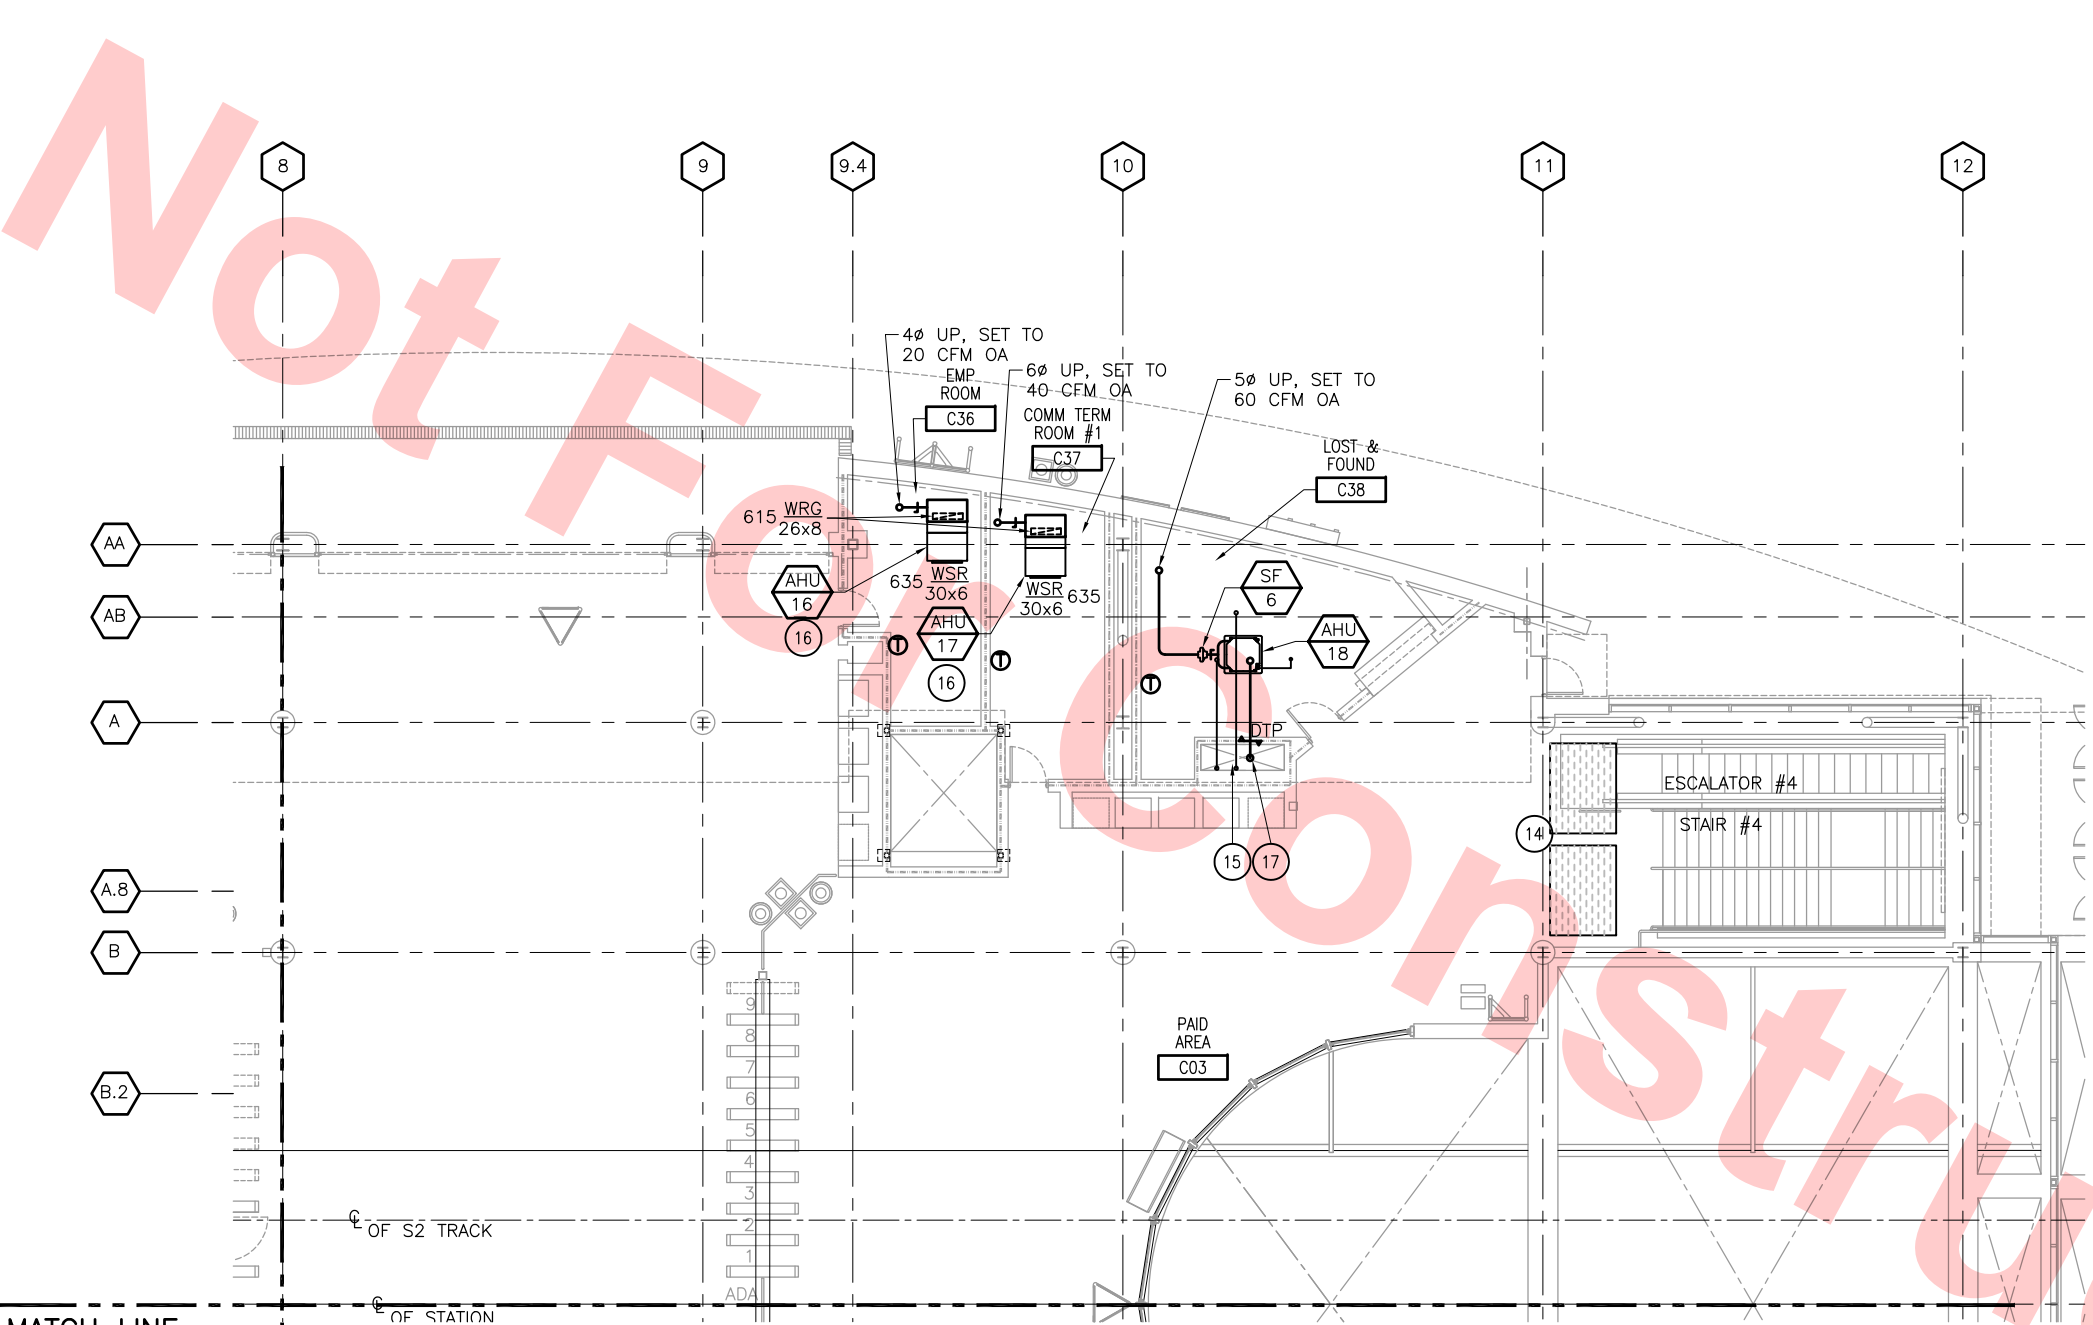
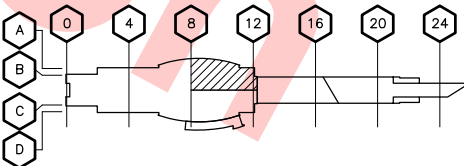
Contract No.: DB11002F

By: Date:



GRAPHIC SCALE

KEY PLAN



MATCH LINE
SEE DWG NO. DB-M215X

MATCH LINE
SEE DWG NO. DB-M213X


CONCOURSE LEVEL PLAN - HVAC

SCALE: 1/8"=1'-0"

DB-M210X

REV	DATE	BY	SUB	APP	DESCRIPTION
0	20130710				READINESS FOR CONSTRUCTION

DESIGNED BY
J. CHOU
DRAWN BY
J. CHOU
CHECKED BY
G. HENNINGS
IN CHARGE
G. HENNINGS
DATE
20130710

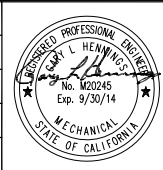

Block Construction Inc.
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Herzog
H&M Mechanical Group
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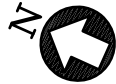
1436 California Circle
Milpitas, California 95035
A Joint Venture

Lookwood, Andrews
& Newnam, Inc.
T-Y LIN INTERNATIONAL
APPROVED




LINE, TRACK, STATIONS AND SYSTEMS
DESIGN UNIT 023
MILPITAS STATION
CONCOURSE LEVEL PLAN
HVAC
SHEET 4 OF 6

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SIZE SCALE D 1/8"=1'-0"	REV. 0
CONTRACT NO. C700	REV. 0
AREA CODE DB	SHEET NO. M214X
PAGE NO. 0702	



MATCH LINE
SEE DWG NO. DB-M214X

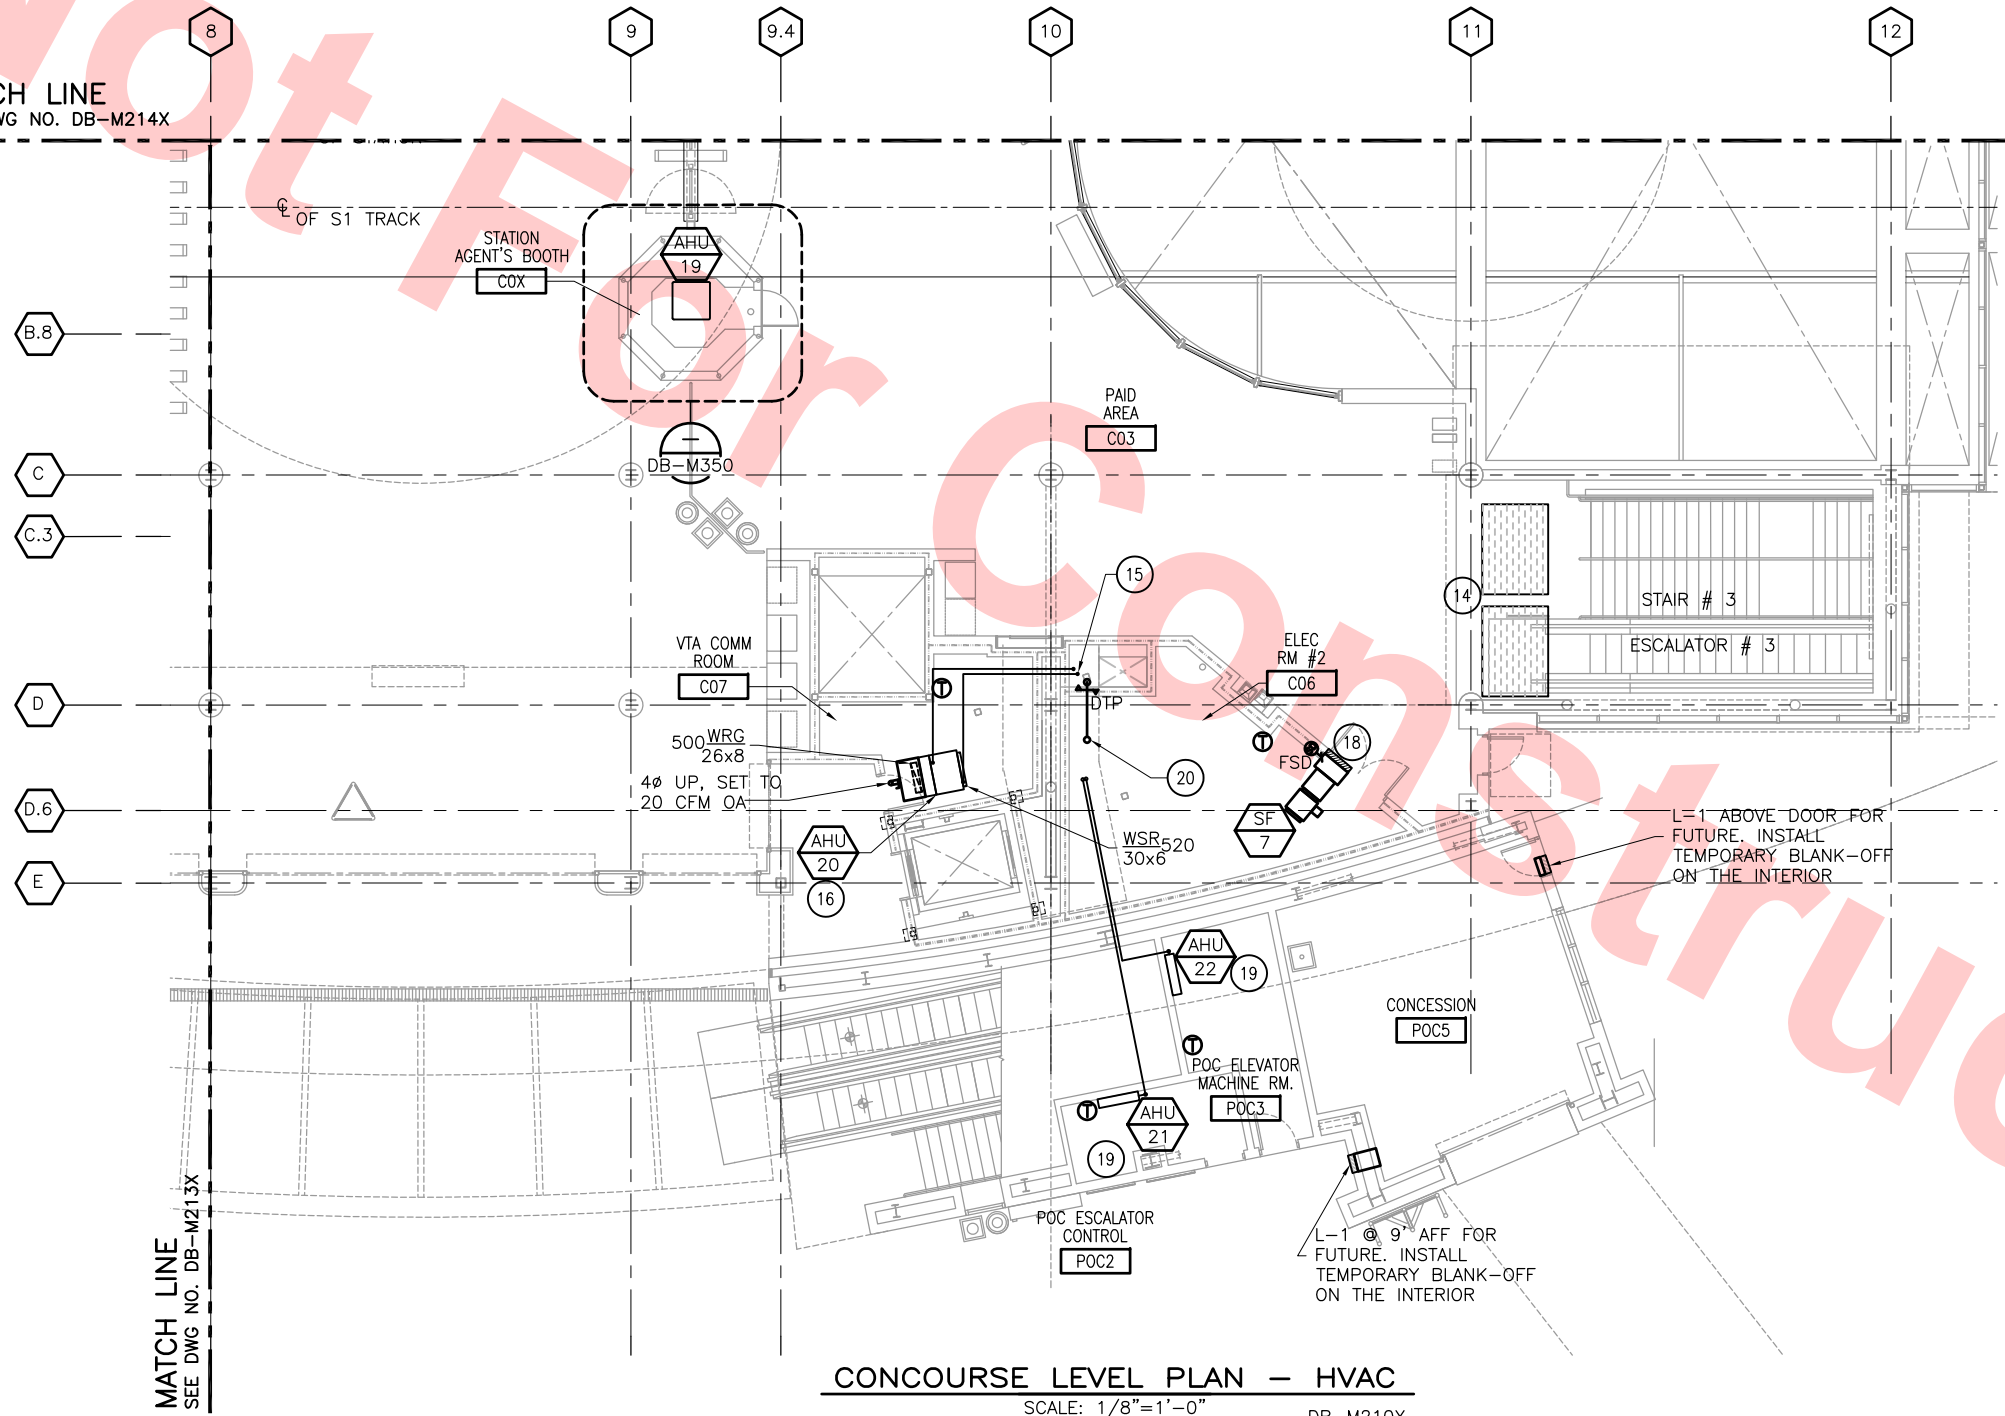

CONCOURSE LEVEL PLAN - HVAC
SCALE: 1/8"=1'-0" DB-M210X

KEY NOTES

- 14 (2) 7'-6"x5'-6" SUPPLY LOUVERS AT CEILING
- 15 (2) RL AND RS REFRIGERANT LINE SETS FROM PLATFORM LEVEL, EXTEND OVER AND UP TO CONDENSING UNITS
- 16 MOUNT UNIT @ 9' AFF
- 18 L-6 INTAKE LOUVER @ 10'-0" AFF WITH FIRE SMOKE DAMPER AND FILTERS
- 19 MOUNT AHU 7'-6" AFF, EXTEND RS AND RL LINES TO ASSOCIATED OUTDOOR UNIT ON LOWER ROOF.
- 20 6ø EA DUCT UP FROM PLATFORM LEVEL AND EXTEND TO RELIEF LOUVER ABOVE

Santa Clara Valley Transportation Authority

- NO EXCEPTIONS TAKEN (NET)
- MAKE CORRECTIONS NOTED (MCN)
- AMEND AND RESUBMIT (A/R)

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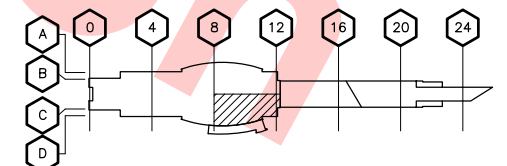
Contract No.: DB11002F

By: _____ Date: _____



GRAPHIC SCALE

KEY PLAN



REV	DATE	BY	SUB	APP	DESCRIPTION
0	20130710				READINESS FOR CONSTRUCTION

DESIGNED BY
J. CHOU
DRAWN BY
J. CHOU
CHECKED BY
G. HENNINGS
IN CHARGE
G. HENNINGS
DATE
20130710



Skanska Shimmick Herzog

1436 California Circle
Milpitas, California 95035
A Joint Venture

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510-569-2000

Lookwood, Andrews & Newnam, Inc.
A LEQ A BALLY COMPANY

T-Y-LIN INTERNATIONAL


SUBMITTED
[Signature]

APPROVED
[Signature]



LINE, TRACK, STATIONS AND SYSTEMS
DESIGN UNIT 023
MILPITAS STATION
CONCOURSE LEVEL PLAN
HVAC
SHEET 5 OF 6

CADD FILENAME C700-S-DB-M215X.dwg	REV. 0
SIZE SCALE D 1/8"=1'-0"	
CONTRACT NO. C700	
AREA CODE DB	SHEET NO. M215X
	PAGE NO. 0703

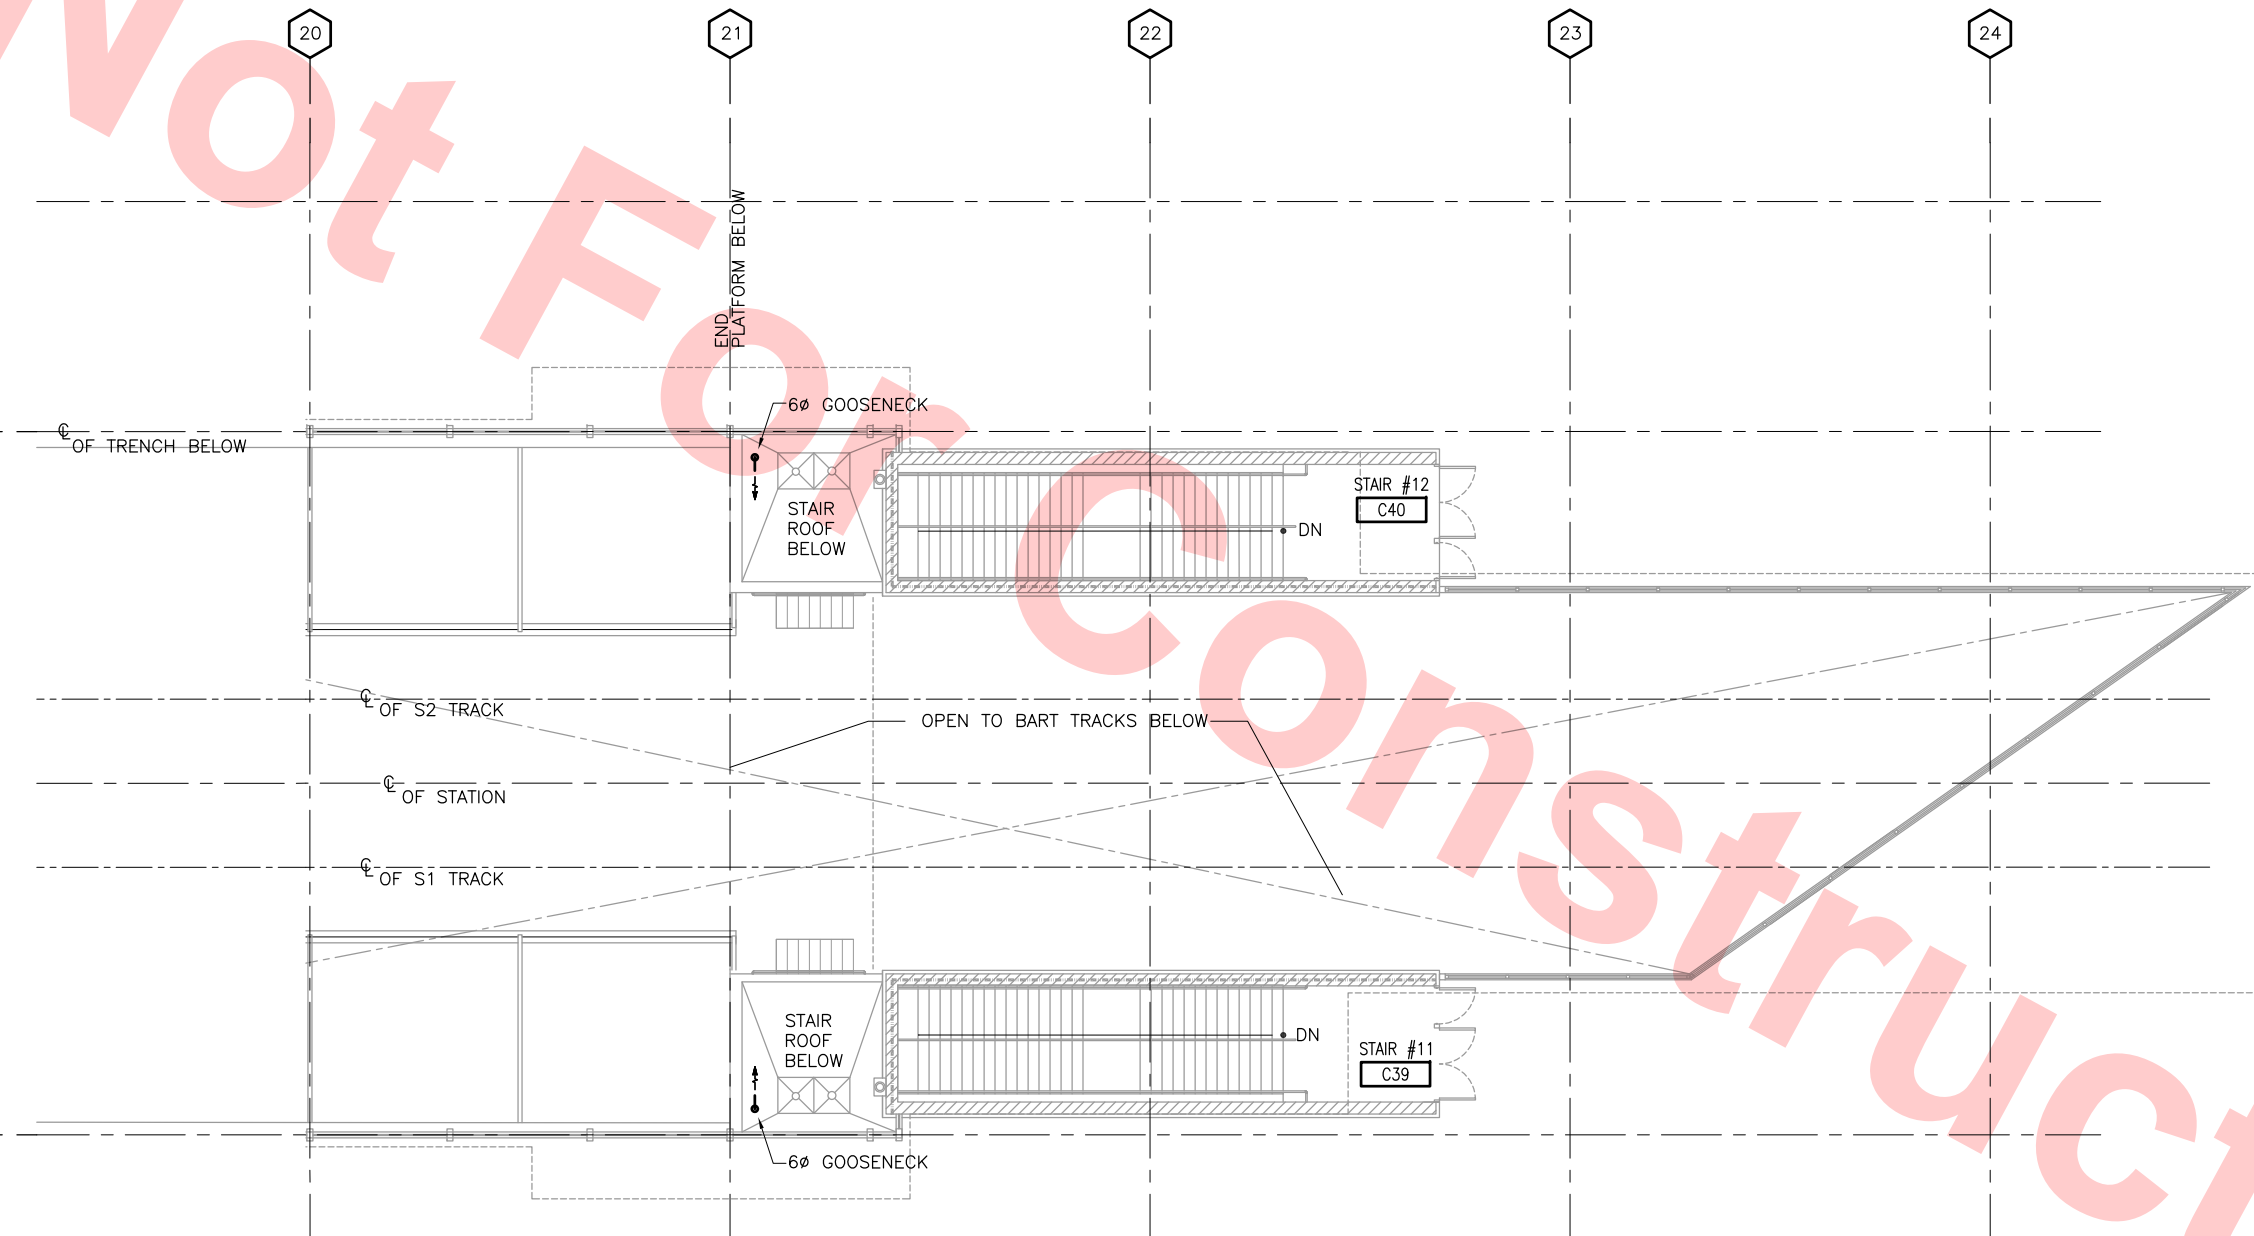


Santa Clara Valley Transportation Authority

_____ **NO EXCEPTIONS TAKEN (NET)**
_____ **MAKE CORRECTIONS NOTED (MCN)**
_____ **AMEND AND RESUBMIT (A/R)**





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Contract No.: _____ **DB11002F**

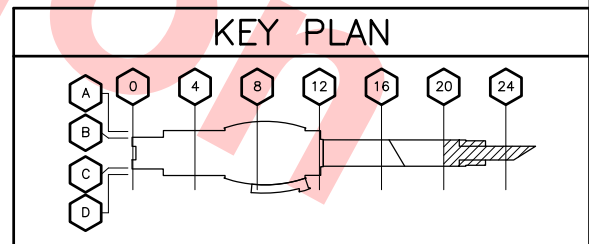
By: _____ Date: _____




CONCOURSE LEVEL PLAN – HVAC
SCALE: 1/8"=1'-0" DB-M210X

					DESIGNED BY J. CHOU		Skanska Shimmick Herzog	1436 California Circle Milpitas, California 95035 A Joint Venture	 H&M Mechanical Group 8517 Eanarth Rd., #230 Oakland, CA 94621 CA Lic. #679320 email info@hnmec.com	 Lookwood, Andrews & Newman, Inc. 1400 S. Bascom Ave., Suite 200 San Jose, CA 95128 (408) 951-1000	T-Y-LIN INTERNATIONAL 10000 N. Wolfe Rd., Suite 100 Cupertino, CA 95014 (408) 951-1000	 BART SILICON VALLEY BART SILICON VALLEY BERRYESSA EXTENSION	LINE, TRACK, STATIONS AND SYSTEMS DESIGN UNIT 023 MILPITAS STATION CONCOURSE LEVEL PLAN HVAC SHEET 6 OF 6	CADD FILENAME C700-S-DB-M218X.dwg SIZE SCALE D 1/8"=1'-0" CONTRACT NO. C700 AREA CODE DB	REV. 0 SHEET NO. PAGE NO. M218X 0704			
0	20130710			READINESS FOR CONSTRUCTION	IN CHARGE G. HENNINGS											DATE 20130710	SUBMITTED	APPROVED
REV	DATE	BY	SUB	APP	DESCRIPTION											DATE		

Not For Construction

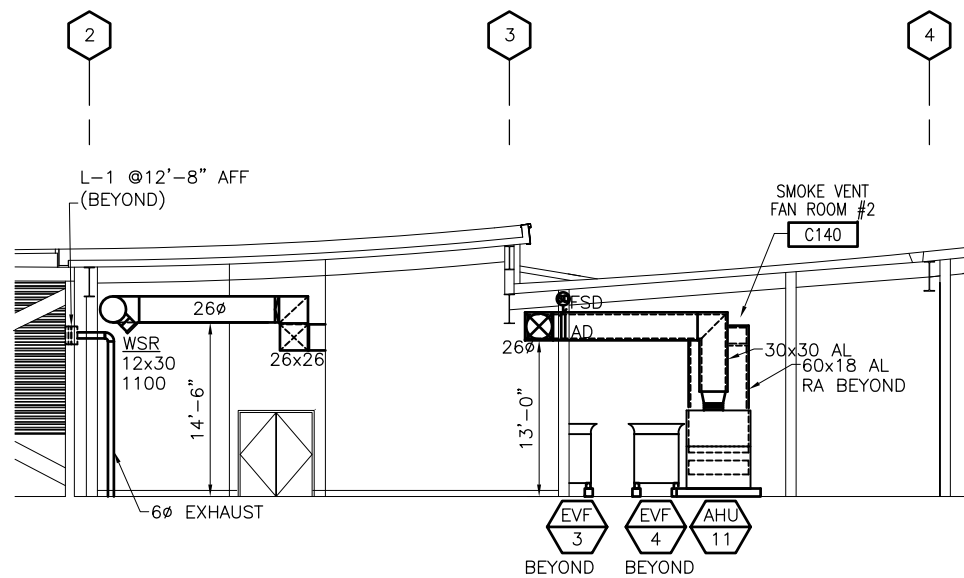

SECTION 1
SCALE: 1/8" = 1'-0"
DB-M219X
DB-M211X

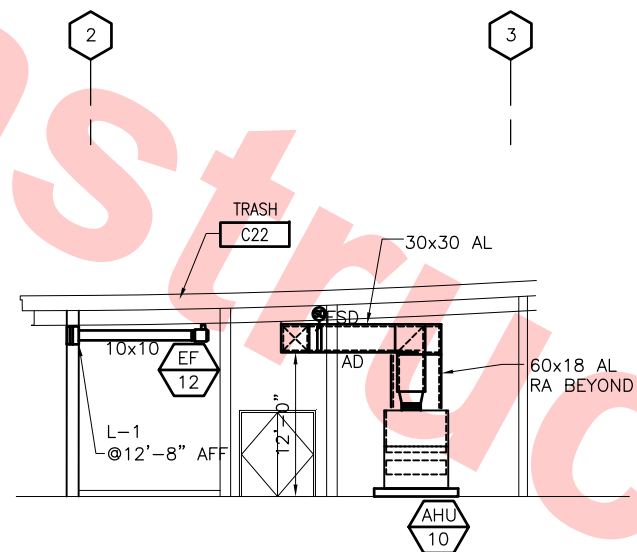

SECTION 2
SCALE: 1/8" = 1'-0"
DB-M219X
DB-M211X

Santa Clara Valley Transportation Authority


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Contract No.: DB11002F

By: _____ Date: _____

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KEY PLAN CONCOURSE LEVEL – PLUMBING
SCALE: 1/32"=1'-0"

Santa Clara Valley Transportation Authority

NO EXCEPTIONS TAKEN (NET)
MAKE CORRECTIONS NOTED (MCN)
AMEND AND RESUBMIT (A/R)
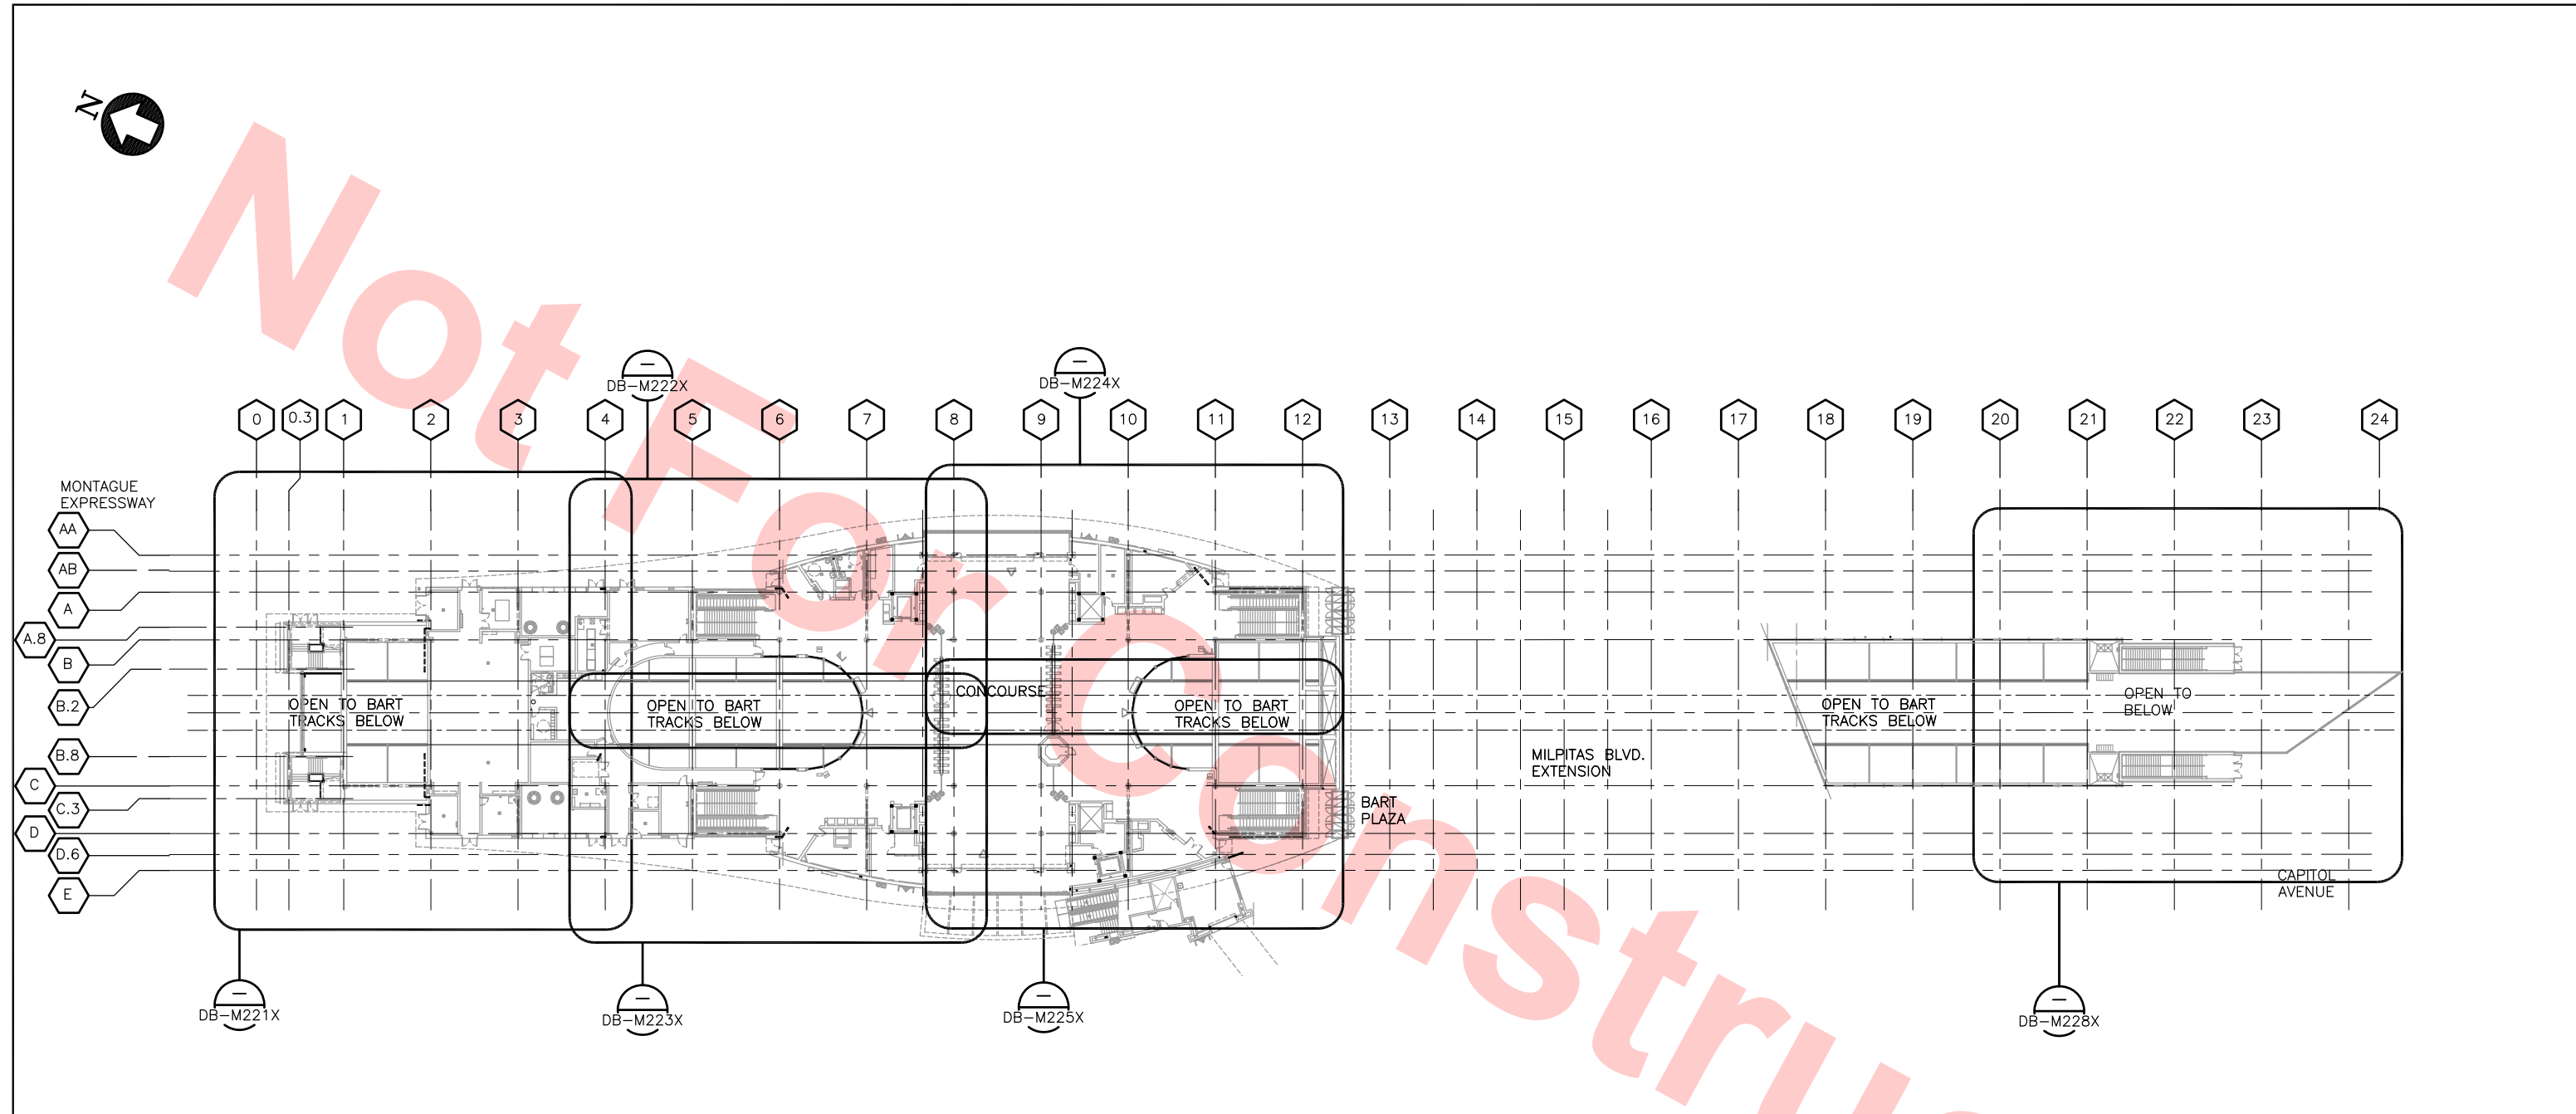
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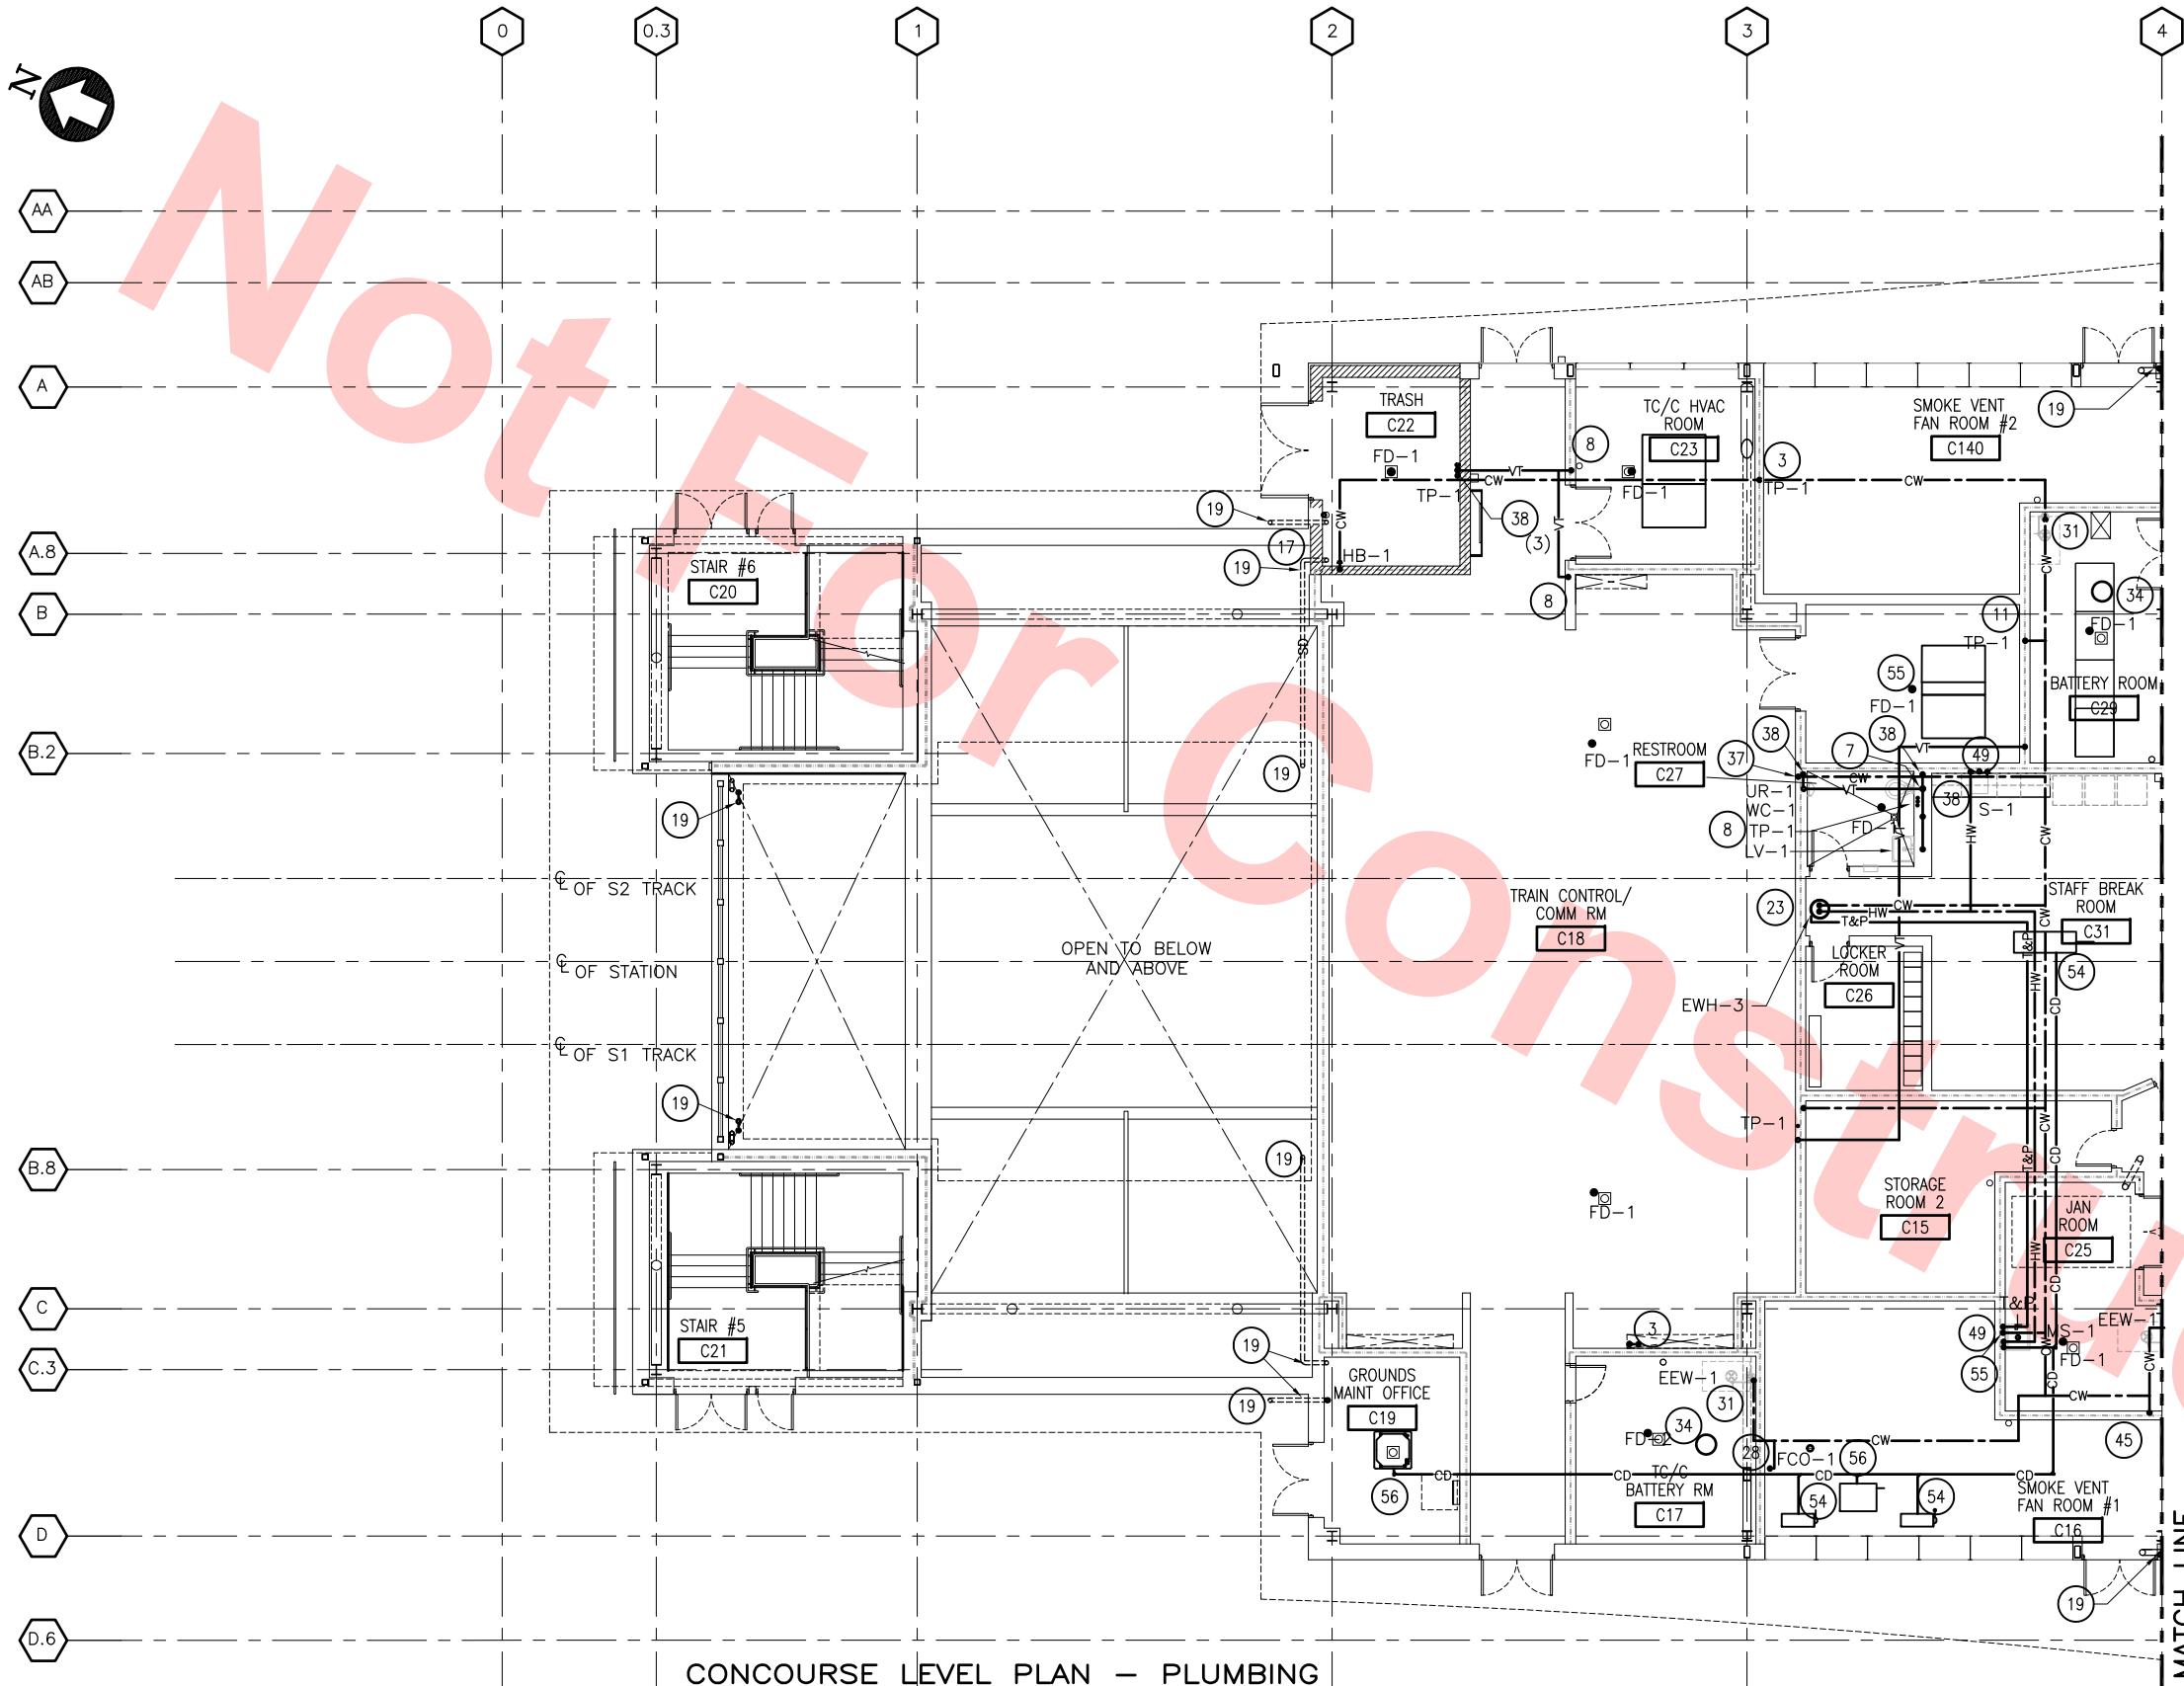
Contract No.: DB11002F

By: _____ Date: _____



					DESIGNED BY P. BLAUVELT		<div>Skanska Shimmick Herzog</div> <div>1436 California Circle Milpitas, California 95035 A Joint Venture</div>		<div> 4455 Enterprise St., Fremont, CA 94538 (510) 807-9888 Fax: (510) 807-9889 CA Lic. #679326 email: info@bctcorp.com</div> <div> 8517 Eastmont Rd. #230 Oakland, CA 94621 510-569-2000</div> <div> A LEOP A BALLY COMPANY</div> <div></div>	<div> BART SILICON VALLEY BERRYESSA EXTENSION</div>	LINE, TRACK, STATIONS AND SYSTEMS DESIGN UNIT 023 MILPITAS STATION KEY PLAN CONCOURSE LEVEL PLUMBING				CADD FILENAME C700-S-DB-M220.dwg	
					DRAWN BY P. BLAUVELT						SIZE SCALE D 1/32"=1'-0"	CONTRACT NO. C700	REV. 0			
					CHECKED BY G. HENNINGS						AREA CODE DB					
					IN CHARGE G. HENNINGS						DATE 20130710	SUBMITTED		APPROVED		SHEET NO. M220
					DATE 20130710		SUBMITTED		APPROVED							

Jul 10, 2013 9:48am C:\projects\mbs-gheinnings\mbs247\c700-s-db-m220.dwg User



CONCOURSE LEVEL PLAN - PLUMBING

SCALE: 1/8"=1'-0" DB-M220

KEY NOTES

- 3 3" IW UP TO ESCALATOR PIT DRAIN
- 8 2" VENT UP
- 7 4" SS UP
- 11 1/2" TO TRAP PRIMER
- 17 NEUTRILIZATION TANK
- 19 3" ROOF DRAIN TO SD
- 23 3/4" HW & CW DN TO WATER HEATER, RELIEF PIPE TO MOP SINK,
- 28 CW TO TRAP PRIMERS
- 31 1 1/4" CW TO EMERGENCY EYE WASH AND SHOWER
- 34 NEUTRALIZATION TANK ACCESS
- 37 CW DOWN
- 38 2" VENT TO ROOF
- 45 CW UP
- 49 CW & HW DN
- 54 1" CONDENSATE CONNECTION
- 55 1 1/2" CONDENSATE DRAIN
- 56 1 1/4" CONDENSATE CONNECTION

Santa Clara Valley Transportation Authority

- NO EXCEPTIONS TAKEN (NET)
- MAKE CORRECTIONS NOTED (MCN)
- AMEND AND RESUBMIT (A/R)

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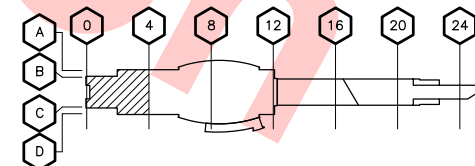
Contract No.: DB11002F

By: Date:



GRAPHIC SCALE

KEY PLAN



REV	DATE	BY	SUB	APP	DESCRIPTION
0	20130710				READINESS FOR CONSTRUCTION

DESIGNED BY P. BLAUVELT	
DRAWN BY P. BLAUVELT	
CHECKED BY C. HENNINGS	
IN CHARGE C. HENNINGS	
DATE 20130710	





Skanska Shimmick Herzog	1436 California Circle Milpitas, California 95035 A Joint Venture
Block Construction Inc. 4455 Enterprise St., Fremont, CA 94538 (510) 857-3666 Fax: (510) 857-3668 CA Lic. #679326 email: info@blockco.com	H&M Mechanical Group 8517 Eastmont Rd. #230 Oakland, CA 94621 510-569-2000
Lookwood, Andrews & Newnam, Inc. A LEOP A BALLY COMPANY	T-Y-LIN INTERNATIONAL
SUBMITTED	APPROVED



LINE, TRACK, STATIONS AND SYSTEMS
DESIGN UNIT 023
MILPITAS STATION
CONCOURSE LEVEL PLAN
PLUMBING
SHEET 1 OF 6

CADD FILENAME C700-S-DB-M221X.DWG	REV. 0
SIZE SCALE D 1/8"=1'-0"	
CONTRACT NO. C700	
AREA CODE SHEET NO. DB M221X	
PAGE NO. 0707	

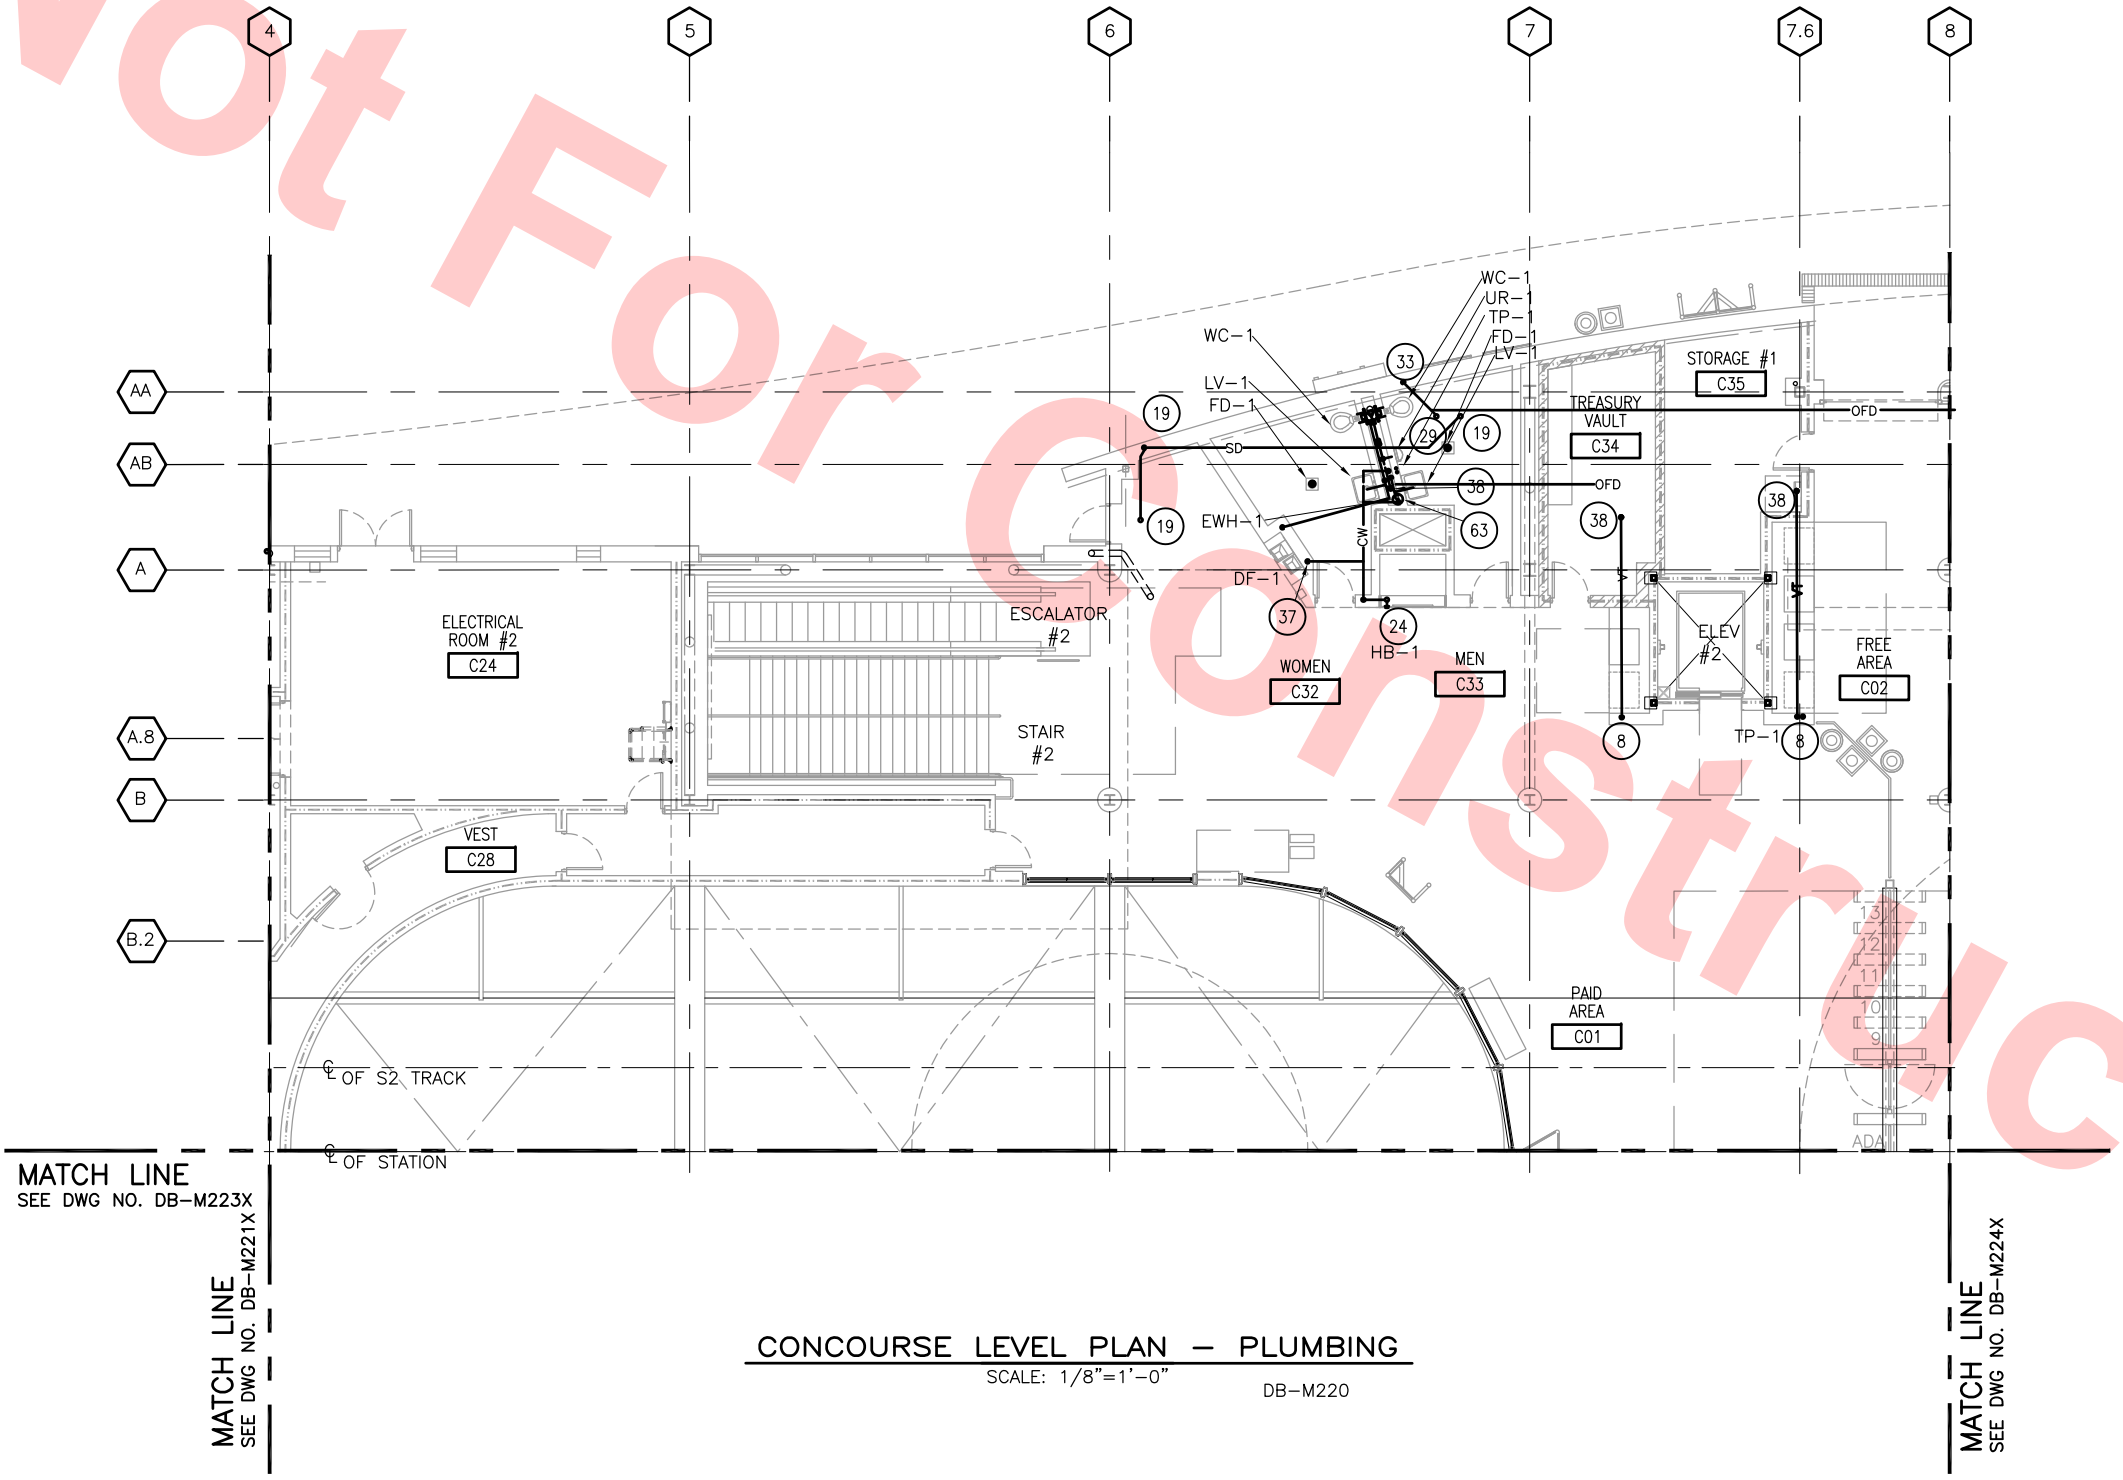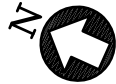

CONCOURSE LEVEL PLAN – PLUMBING
SCALE: 1/8"=1'-0" DB-M220

KEY NOTES

- 8 2" VENT UP
- 19 ROOF DRAIN TO SD
- 24 3/4" CW DN TO HOSE BIBB (IN FHC STRUCTURE)
- 29 OFD FOR ROOF
- 33 OFD TO DAYLIGHT
- 37 CW DOWN
- 38 VENT TO ROOF
- 63 EWH ABOVE CEILING BEHIND ACCESS PANAL, DRAIN TO LAV-1 TRAP

Santa Clara Valley Transportation Authority

NO EXCEPTIONS TAKEN (NET)
MAKE CORRECTIONS NOTED (MCN)
AMEND AND RESUBMIT (A/R)

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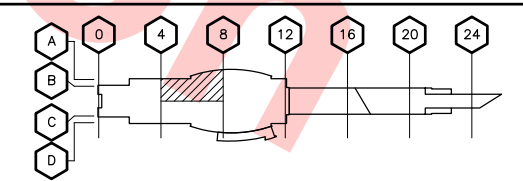
Contract No.: DB11002F

By: _____ Date: _____


8' 0' 8' 16'

GRAPHIC SCALE

KEY PLAN



REV	DATE	BY	SUB	APP	DESCRIPTION
0	20130710				READINESS FOR CONSTRUCTION

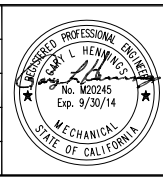

DESIGNED BY
P. BLAUVELT

DRAWN BY
P. BLAUVELT

CHECKED BY
G. HENNINGS

IN CHARGE
G. HENNINGS

DATE
20130710

Skanska Shimmick Herzog

1436 California Circle
Milpitas, California 95035
A Joint Venture

Block Construction Inc.
4455 Enterprise St., Fremont, CA 94538
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H&M Mechanical Group
8517 Eastmont Rd. #230
Oakland, CA 94621
510-569-2000

Lookwood, Andrews & Newnam, Inc.
A LEOPOLD COMPANY

T-Y LIN INTERNATIONAL

SUBMITTED


APPROVED

BART
VTA SILICON VALLEY


BART SILICON VALLEY BERRYESSA EXTENSION

LINE, TRACK, STATIONS AND SYSTEMS
DESIGN UNIT 023
MILPITAS STATION
CONCOURSE LEVEL PLAN
PLUMBING
SHEET 2 OF 6

CADD FILENAME C700-S-DB-M222X.dwg	REV. 0
SIZE D	SCALE 1/8"=1'-0"
CONTRACT NO. C700	SHEET NO. DB M222X
AREA CODE DB	PAGE NO. 0708

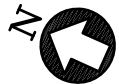

MATCH LINE
SEE DWG NO. DB-M222X

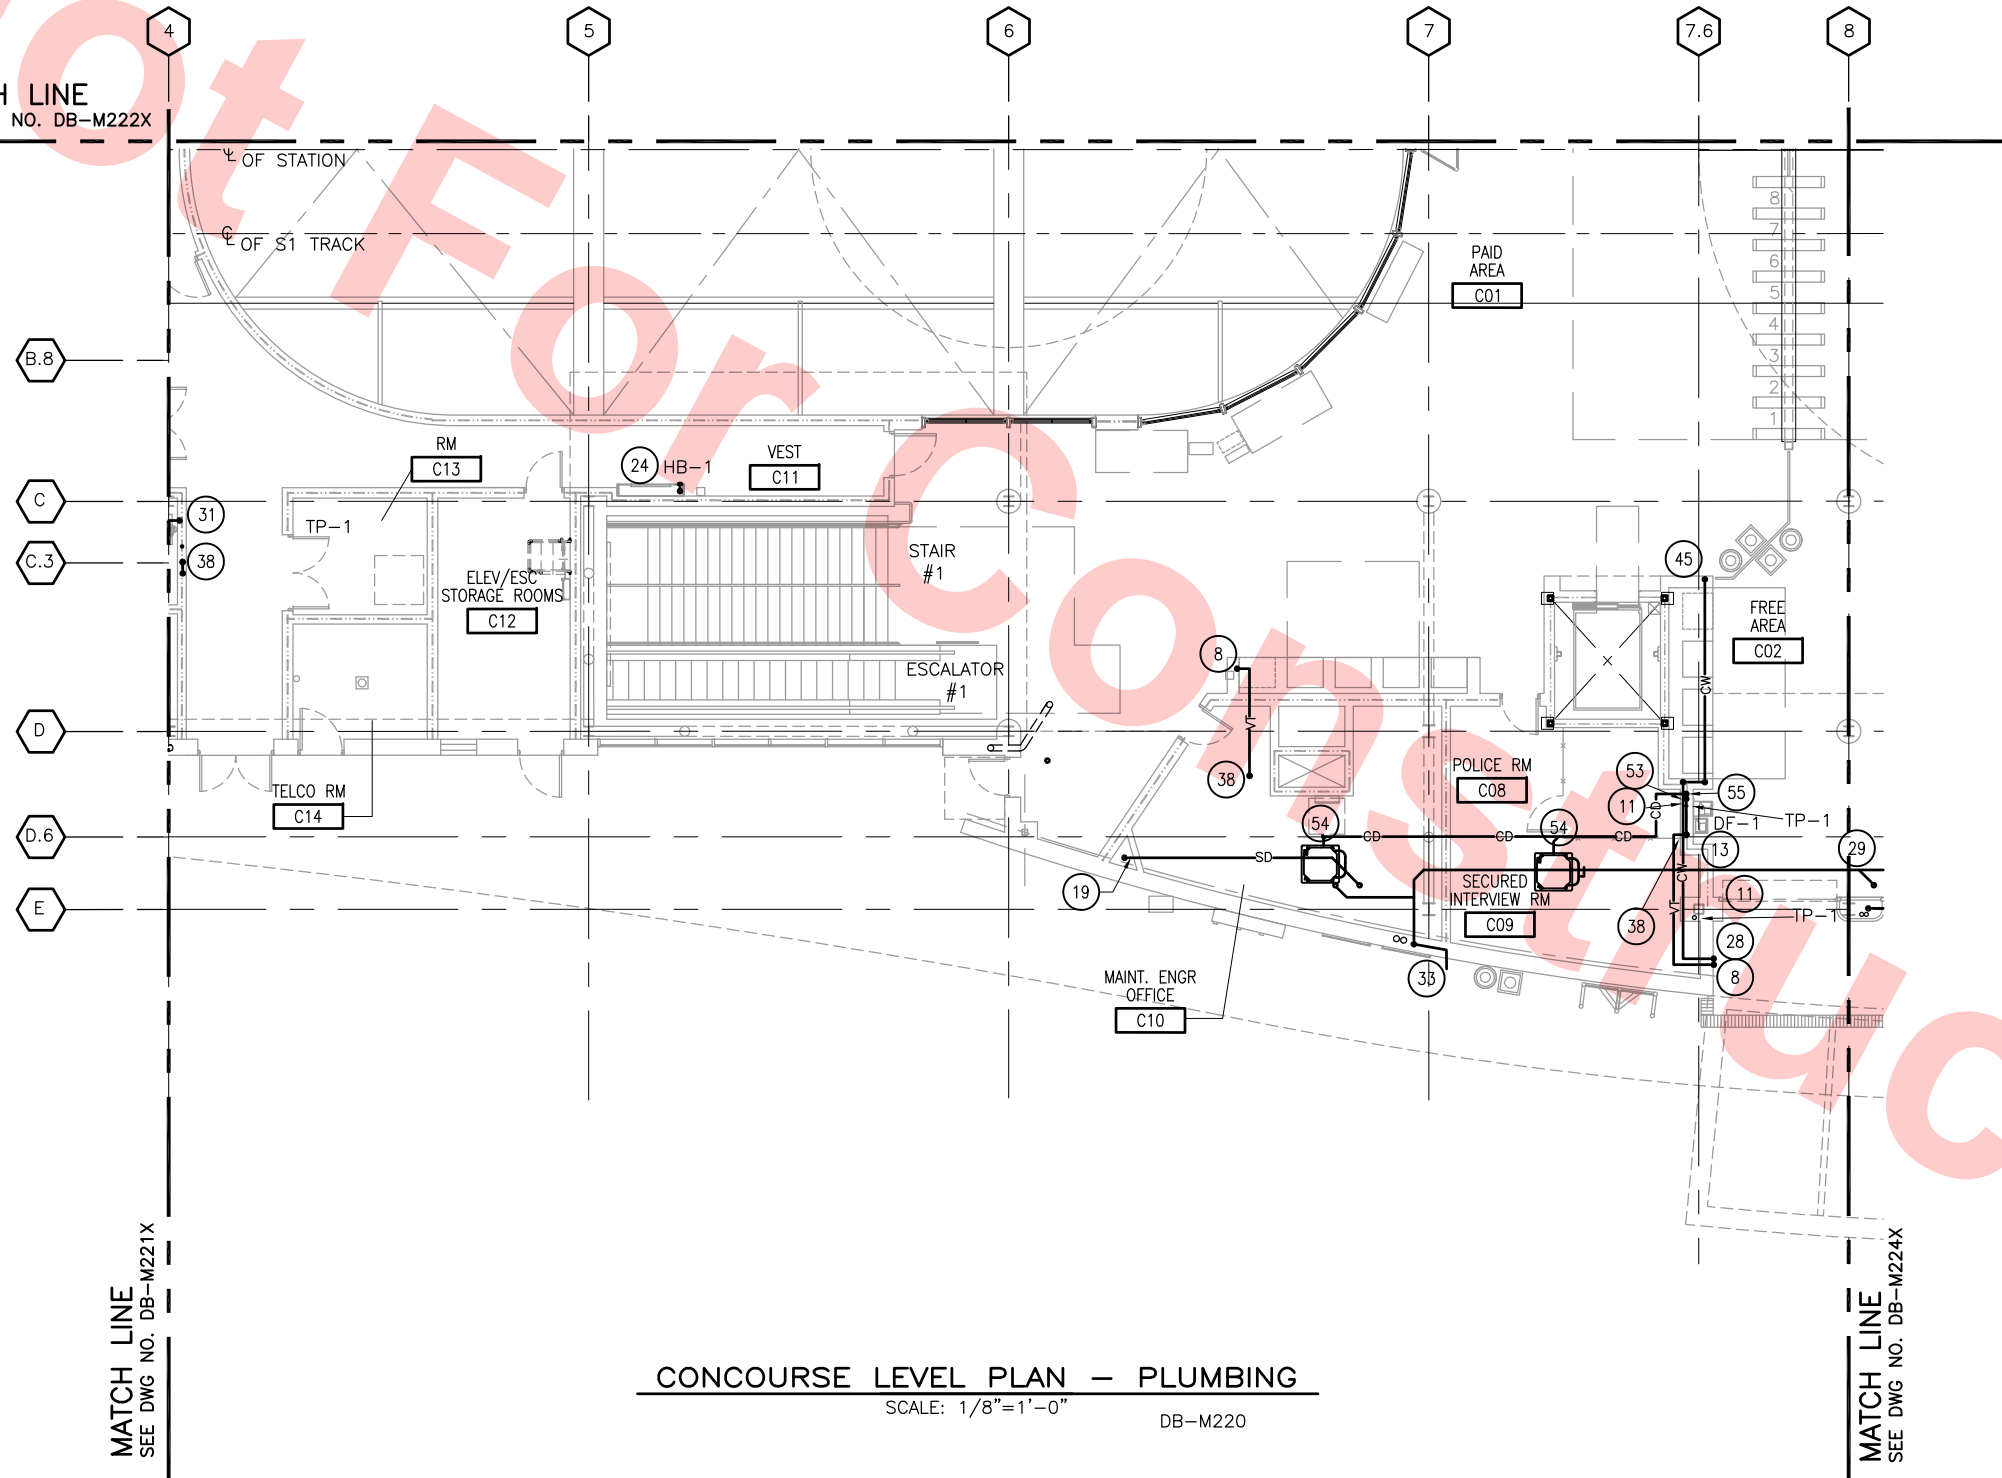

CONCOURSE LEVEL PLAN - PLUMBING
SCALE: 1/8"=1'-0"
DB-M220

KEY NOTES

- 3 3" IW UP TO ESCALATOR PIT DRAIN
- 8 2" VENT UP
- 11 1/2" TRAP PRIMER
- 13 2" SS TO DF
- 19 ROOF DRAIN TO SD
- 24 3/4" CW DN TO HOSE BIBB (IN FHC STRUCTURE)
- 28 CW TO TRAP PRIMERS
- 29 OFD FOR ROOF
- 33 OVERFLOW DRAIN TO DAYLIGHT
- 38 VENT TO ROOF
- 45 CW UP
- 53 CONDENSATE DRAIN IN WALL TO TRAP ASSEMBLY
- 54 1 1/4" CONDENSATE CONNECTION
- 55 1 1/2" CONDENSATE DRAIN

Santa Clara Valley Transportation Authority

NO EXCEPTIONS TAKEN (NET)
MAKE CORRECTIONS NOTED (MCN)
AMEND AND RESUBMIT (A/R)

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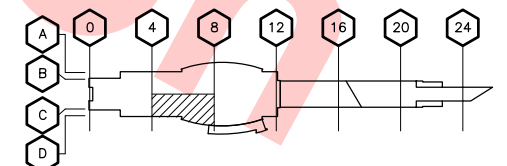
Contract No.: DB11002F

By: _____ Date: _____



GRAPHIC SCALE

KEY PLAN



DESIGNED BY P. BLAUVELT	
DRAWN BY P. BLAUVELT	
CHECKED BY C. HENNINGS	
IN CHARGE C. HENNINGS	
DATE 20130710	
0 20130710	READINESS FOR CONSTRUCTION
REV	DATE
BY	SUB
APP	DESCRIPTION




Skanska Shimmick Herzog	1436 California Circle Milpitas, California 95035 A Joint Venture
Block Construction Inc. 4455 Enterprise St., Fremont, CA 94538 (510) 807-3666 Fax: (510) 807-3666 CA Lic. #679326 email: info@blockco.com	H&M Mechanical Group 8517 Eastmont Rd. #230 Oakland, CA 94621 510-569-2000
Lookwood, Andrews & Newnam, Inc. A LEQ A BALLY COMPANY	T-Y LIN INTERNATIONAL
SUBMITTED	APPROVED



LINE, TRACK, STATIONS AND SYSTEMS
DESIGN UNIT 023
MILPITAS STATION
CONCOURSE LEVEL PLAN
PLUMBING
SHEET 3 OF 6

CADD FILENAME C700-S-DB-M223X.dwg	
SIZE SCALE D 1/8"=1'-0"	
CONTRACT NO. C700	REV. 0
AREA CODE DB	SHEET NO. M223X
	PAGE NO. 0709

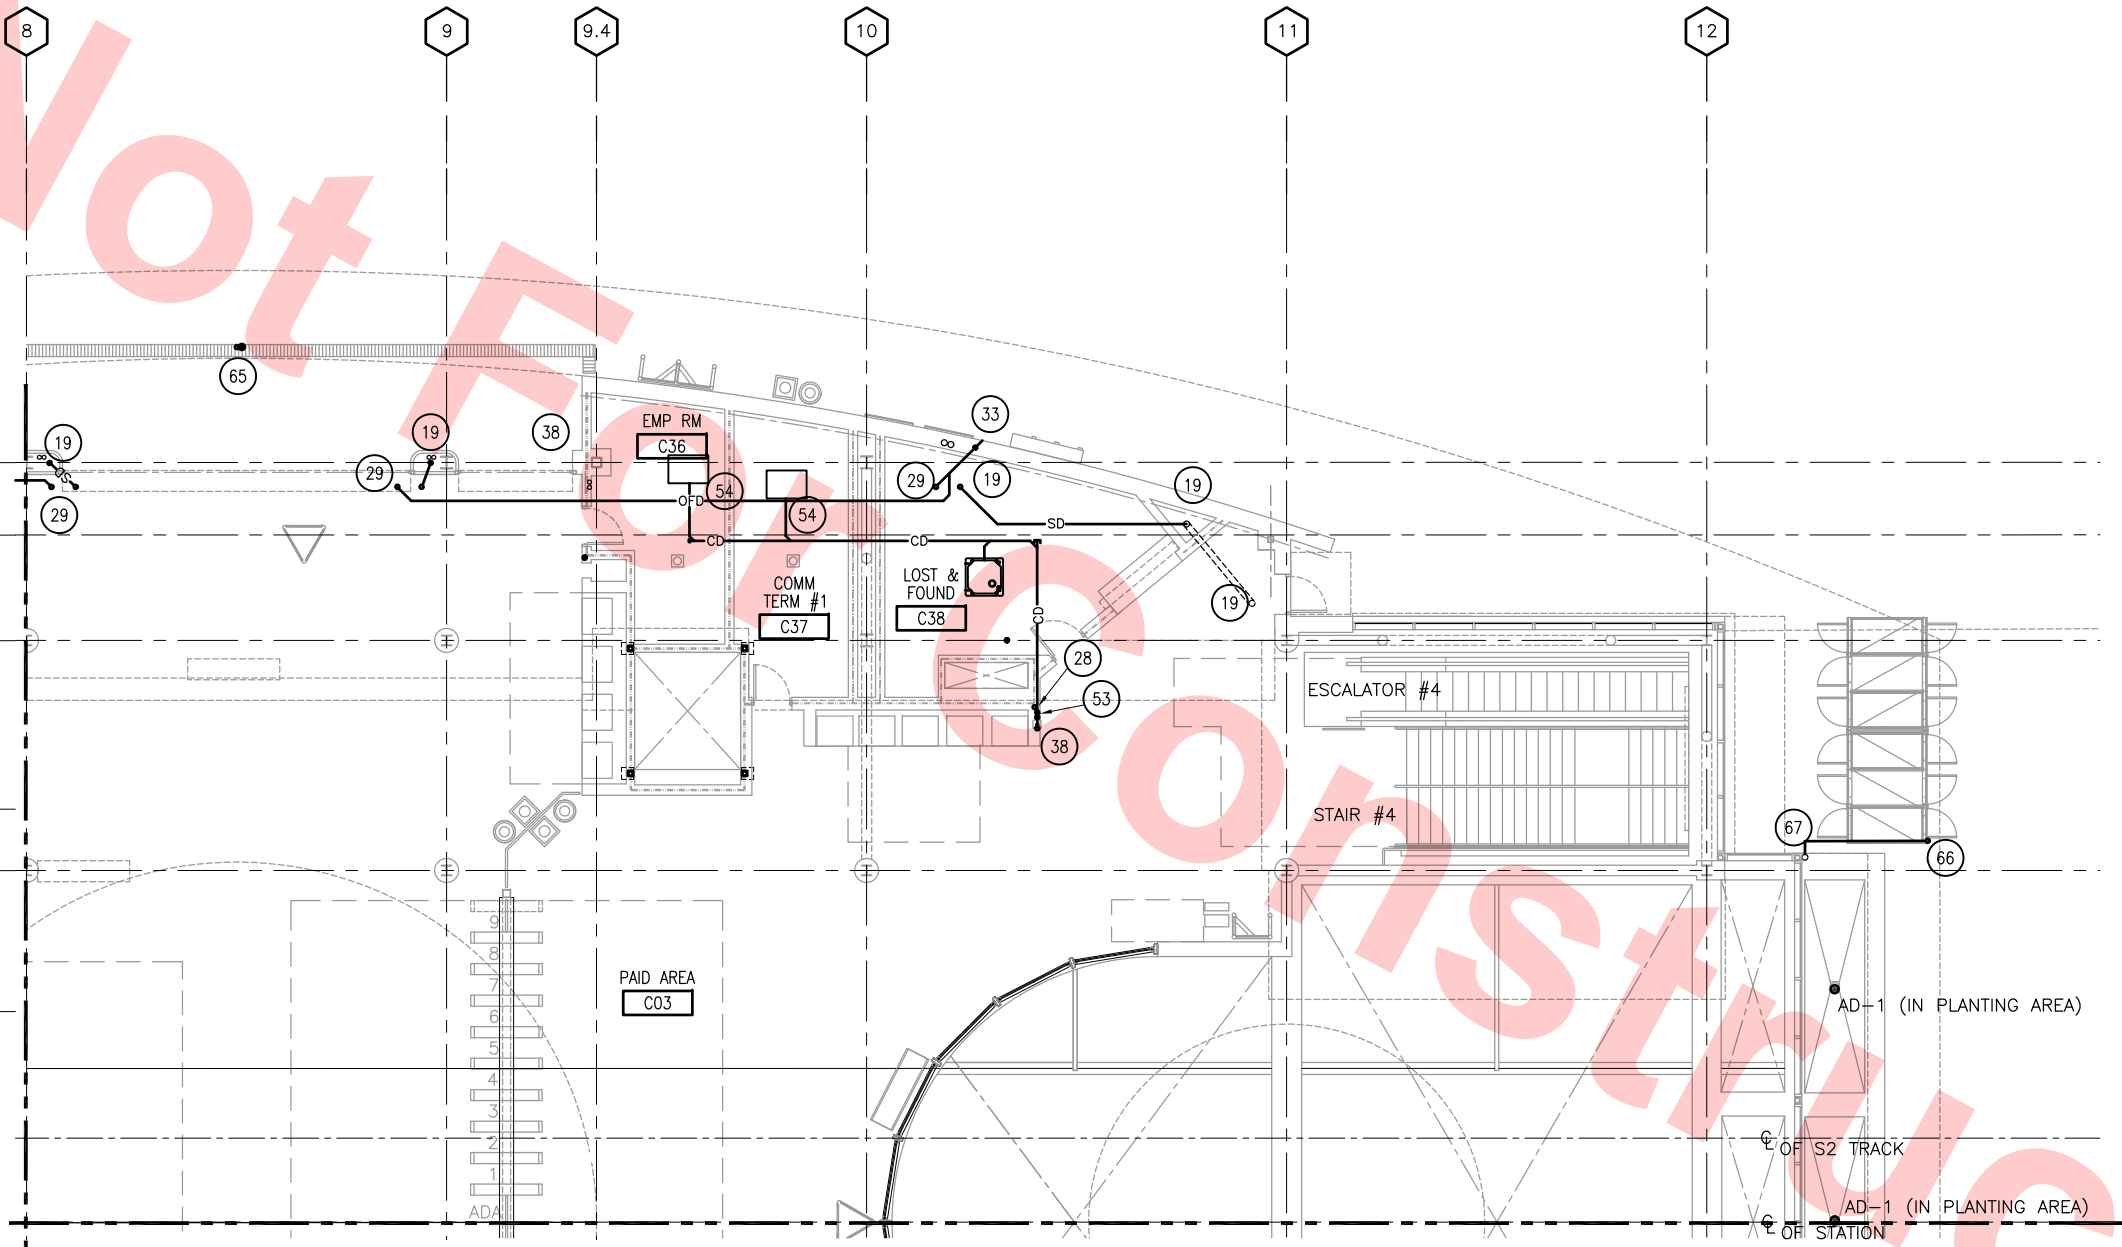

MATCH LINE
SEE DWG NO. DB-M225X

MATCH LINE
SEE DWG NO. DB-M223X

CONCOURSE LEVEL PLAN — PLUMBING
SCALE: 1/8"=1'-0" DB-M220

KEY NOTES

- 8 2" VENT UP
- 19 ROOF DRAIN TO SD
- 28 CW FOR TRAP PRIMER
- 29 OFD FOR ROOF
- 33 OFD TO DAYLIGHT
- 38 VENT TO ROOF
- 42 SD TO CIVIL
- 53 2" CONDENSATE DRAIN ASSEMBLY IN WALL
- 54 1 1/4" CONDENSATE CONNECTION
- 55 1 1/2" CONDENSATE DRAIN
- 65 4" SS TO TRENCH DRAIN
- 66 DOWNSPOUT TO DRAIN FROM CANOPY
- 67 SD PIPING FROM CANOPY TO GO DN. TO PLATFORM LEVEL AND TIE INTO SD PIPING

Santa Clara Valley Transportation Authority

NO EXCEPTIONS TAKEN (NET)
MAKE CORRECTIONS NOTED (MCN)
AMEND AND RESUBMIT (A/R)

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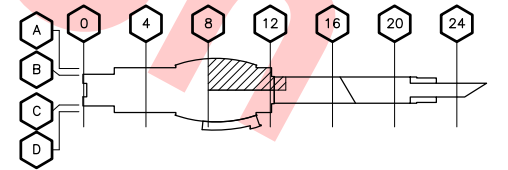
Contract No.: DB11002F

By: _____ Date: _____


8' 0' 8' 16'

GRAPHIC SCALE

KEY PLAN



DESIGNED BY P. BLAUVELT	0	20130710				READINESS FOR CONSTRUCTION
DRAWN BY P. BLAUVELT	REV	DATE	BY	SUB	APP	DESCRIPTION
CHECKED BY C. HENNINGS						
IN CHARGE C. HENNINGS						
DATE 20130710						

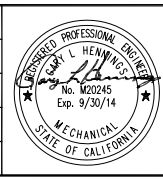

Skanska
Shimmick
Herzog

1436 California Circle
Milpitas, California 95035
A Joint Venture

Block Construction Inc.
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510-569-2000

Lookwood, Andrews
& Newnam, Inc.
A LEQ A BALLY COMPANY

T-Y LIN INTERNATIONAL

SUBMITTED
[Signature]

APPROVED
[Signature]



LINE, TRACK, STATIONS AND SYSTEMS
DESIGN UNIT 023
MILPITAS STATION
CONCOURSE LEVEL PLAN
PLUMBING
SHEET 4 OF 6

CADD FILENAME C700-S-DB-M224X.dwg	AREA CODE DB	SHEET NO. M224X	PAGE NO. 0710
SIZE D	SCALE 1/8"=1'-0"	CONTRACT NO. C700	REV. 0

KEY NOTES

- 8 2" VENT UP
13 2" SS TO DF
19 3" ROOF DRAIN TO SD
28 1/2" CW TO TRAP PRIMER
29 OFD FOR ROOF
33 OFD TO DAYLIGHT
37 CW DOWN
38 2" VENT TO ROOF
42 3" SD TO CIVIL
45 CW UP
52 3" FUTURE FOR CONCESSION
53 CONDENSATE DRAIN ASSEMBLY
54 1" CONDENSATE CONNECTION
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Santa Clara Valley Transportation Authority

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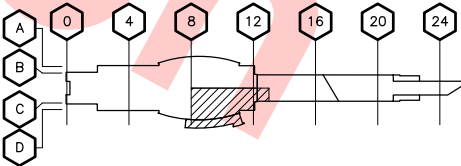
Contract No.: DB11002F

By: Date:



GRAPHIC SCALE

KEY PLAN



MATCH LINE
SEE DWG NO. DB-M214X

MATCH LINE
SEE DWG NO. DB-M213X

CONCOURSE LEVEL PLAN — PLUMBING

SCALE: 1/8"=1'-0" DB-M220

DESIGNED BY
P. BLAUVELT
DRAWN BY
P. BLAUVELT
CHECKED BY
G. HENNINGS
IN CHARGE
G. HENNINGS
DATE
20130710



BCT Block Construction Inc.
4455 Enterprise St., Fremont, CA 94538
(510) 867-5666 Fax: (510) 867-5668
CA Lic. #679326 email: info@blockct.com

Skanska
Shimmick
Herzog

1436 California Circle
Milpitas, California 95035
A Joint Venture

HBM Mechanical Group
8517 Eastmont Rd. #230
Oakland, CA 94621
510-569-2000

Lookwood, Andrews
& Newnam, Inc.
A LEED A RALLY COMPANY



T-Y-LIN INTERNATIONAL



BART SILICON VALLEY BERRYESSA EXTENSION

LINE, TRACK, STATIONS AND SYSTEMS
DESIGN UNIT 023
MILPITAS STATION
CONCOURSE LEVEL PLAN
PLUMBING
SHEET 5 OF 6

CADD FILENAME
C700-S-DB-M225X.dwg
SIZE SCALE
D 1/8"=1'-0"
CONTRACT NO. C700 REV. 0
AREA CODE SHEET NO. PAGE NO.
DB M225X 0711

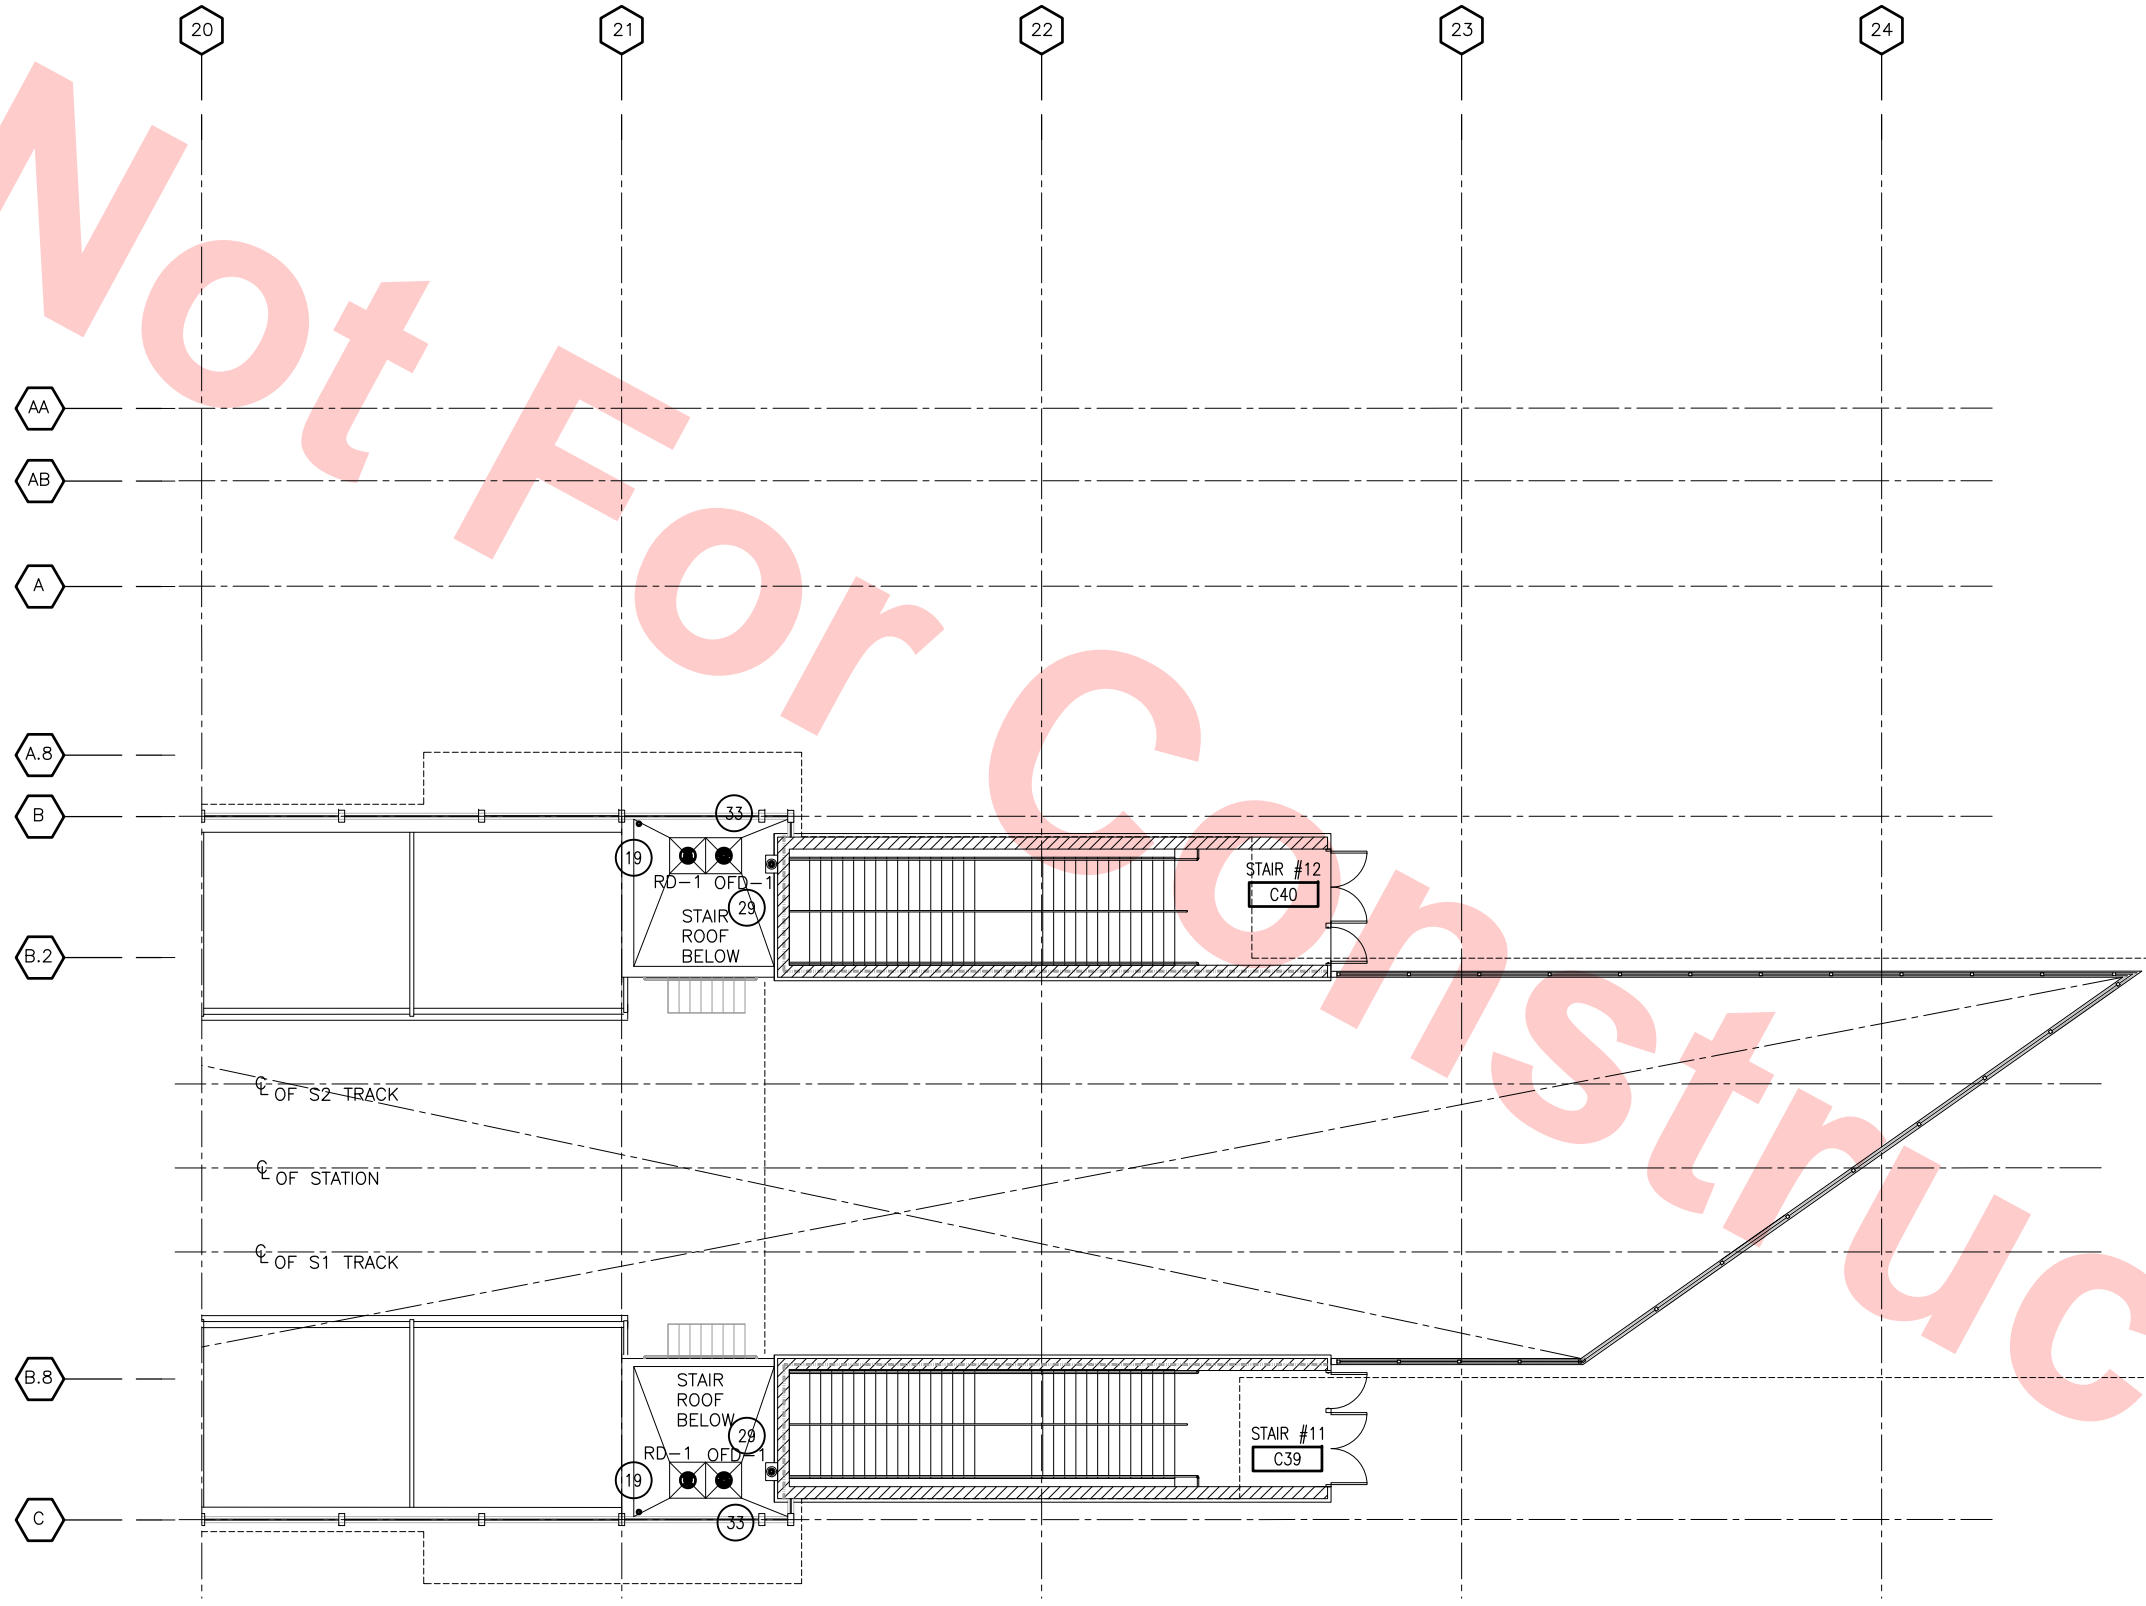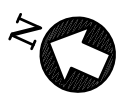

CONCOURSE LEVEL PLAN — PLUMBING

SCALE: 1/8"=1'-0"

DB-M220

KEY NOTES

- 19 3" ROOF DRAIN TO SD
- 29 3" OFD FOR ROOF
- 33 3" OFD TO DAYLIGHT

Santa Clara Valley Transportation Authority

NO EXCEPTIONS TAKEN (NET)
MAKE CORRECTIONS NOTED (MCN)
AMEND AND RESUBMIT (A/R)

Any action shown above is subject to the terms of the contract and does not relieve the Contractor of any of its obligations under the contract, including design and detailing.


Contract No.: DB11002F

By: _____ Date: _____



GRAPHIC SCALE

KEY PLAN

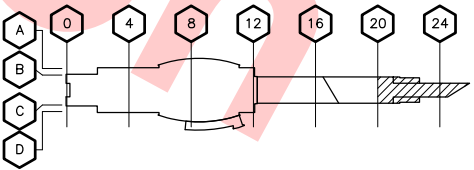

						DESIGNED BY P. BLAUVELT
						DRAWN BY P. BLAUVELT
						CHECKED BY G. HENNINGS
						IN CHARGE G. HENNINGS
0	20130710				READINESS FOR CONSTRUCTION	DATE 20130710
REV	DATE	BY	SUB	APP	DESCRIPTION	



Skanska
Shimmick
Herzog

1436 California Circle
Milpitas, California 95035
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Blocka Construction Inc.
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HMM Mechanical Group
6517 Easthill Rd. #230
Oakland, CA 94621
510-569-2000

Lookwood, Andrews
& Newman, Inc.
A LEOP A BULLY COMPANY

T-Y-LIN INTERNATIONAL

SUBMITTED



APPROVED

BART
SILICON VALLEY

BART SILICON VALLEY BERRYESSA EXTENSION

LINE, TRACK, STATIONS AND SYSTEMS
DESIGN UNIT 023
MILPITAS STATION
CONCOURSE LEVEL PLAN
PLUMBING
SHEET 6 OF 6

CADD FILENAME	C700-S-DB-M228.dwg		
SIZE	SCALE		
D	1/8"=1'-0"		
CONTRACT NO.	C700	REV.	0
AREA CODE	SHEET NO.	PAGE NO.	
DB	M228	0712	

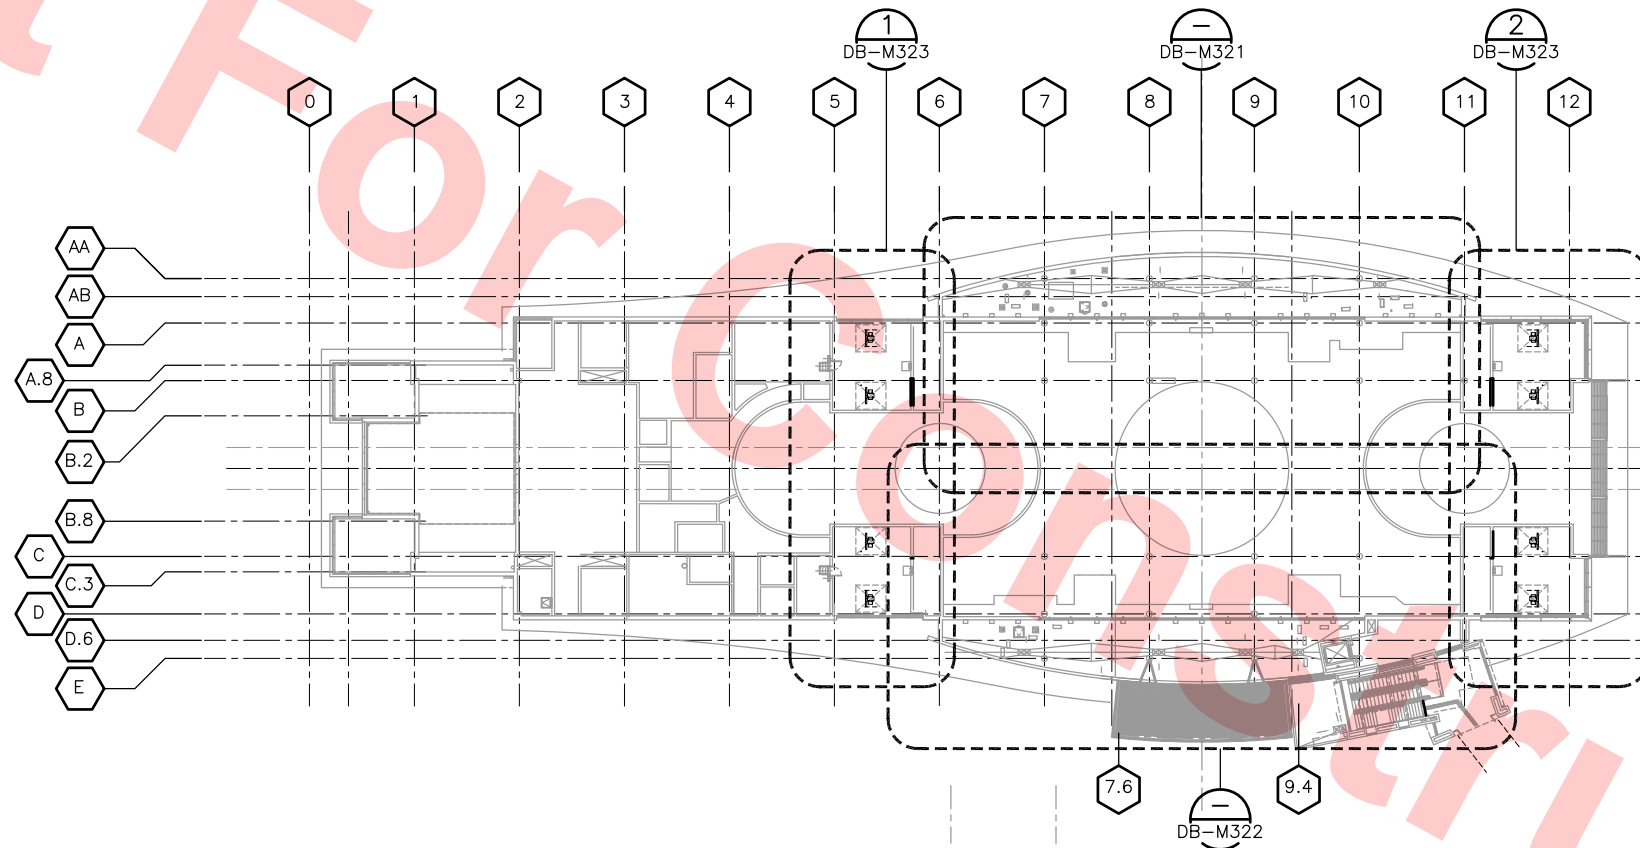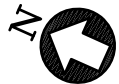

KEY PLAN MEZZANINE LEVEL – HVAC
SCALE: 1/32"=1'-0"

Santa Clara Valley Transportation Authority

NO EXCEPTIONS TAKEN (NET)
MAKE CORRECTIONS NOTED (MCN)
AMEND AND RESUBMIT (A/R)


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Contract No.: DB11002F

By: _____ Date: _____



REV	DATE	BY	SUB	APP	DESCRIPTION
0	20130710				READINESS FOR CONSTRUCTION

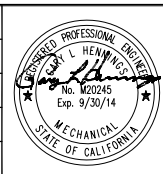


Skanska Shimmick Herzog
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Oakland, CA 94621
510-569-2000

Lookwood, Andrews & Newman, Inc.
A LEQ A BALLY COMPANY

T-Y LIN INTERNATIONAL



LINE, TRACK, STATIONS AND SYSTEMS				CADD FILENAME	
DESIGN UNIT 023				C700-S-DB-M320.dwg	
MILPITAS STATION				SIZE	SCALE
KEY PLAN MEZZANINE LEVEL				D	1/32"=1'-0"
HVAC				CONTRACT NO.	REV.
				C700	0
AREA CODE	SHEET NO.	PAGE NO.			
DB	M320	0713			

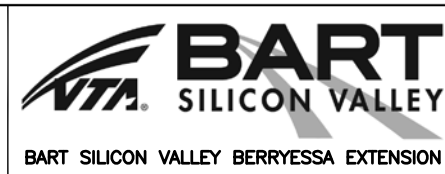KEY NOTES

- 1 SPLIT CONDENSING UNIT, EXTEND PRECHARGED & PREINSULATED REFRIGERANT TUBING TO AHU-2 SERVING ESCALATOR RM #2, P24
- 2 SPLIT CONDENSING UNIT, EXTEND PRECHARGED & PREINSULATED REFRIGERANT TUBING TO AHU-4 SERVING ELEVATOR MACHINE RM #2, P14
- 3 SPLIT CONDENSING UNIT, EXTEND PRECHARGED & PREINSULATED REFRIGERANT TUBING TO AHU-16 SERVING EMP RM, C36
- 4 SPLIT CONDENSING UNIT, EXTEND PRECHARGED & PREINSULATED REFRIGERANT TUBING TO AHU-17 SERVING COMM TERM RM #1, C37
- 5 SPLIT CONDENSING UNIT, EXTEND PRECHARGED & PREINSULATED REFRIGERANT TUBING TO AHU-6 SERVING COMM TERM RM #2, P10
- 6 SPLIT CONDENSING UNIT, EXTEND PRECHARGED & PREINSULATED REFRIGERANT TUBING TO AHU-8 SERVING ESCALATOR CONTROL RM #4, P08
- 7 SPLIT HEAT PUMP UNIT, EXTEND PRECHARGED & PREINSULATED REFRIGERANT TUBING TO AHU-18 SERVING LOST & FOUND, C38


Santa Clara Valley Transportation Authority

- NO EXCEPTIONS TAKEN (NET)
- MAKE CORRECTIONS NOTED (MCN)
- AMEND AND RESUBMIT (A/R)


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Contract No.: DB11002F

By: Date:

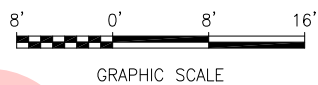

KEY PLAN

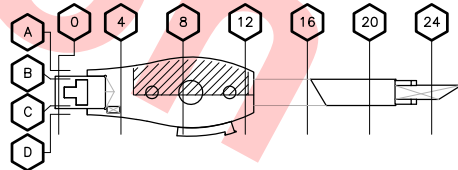

MATCH LINE
SEE DWG NO. DB-M322

MATCH LINE
SEE DWG NO. DB-M323

MATCH LINE
SEE DWG NO. DB-M323

LOWER ROOF LEVEL PLAN — HVAC
SCALE: 1/8"=1'-0" DB-M320

REV	DATE	BY	SUB	APP	DESCRIPTION
0	20130710				READINESS FOR CONSTRUCTION



DESIGNED BY
J. CHOU

DRAWN BY
J. CHOU

CHECKED BY
G. HENNINGS

IN CHARGE
G. HENNINGS

DATE
20130710

Skanska
Shimmick
Herzog

1436 California Circle
Milpitas, California 95035
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4455 Enterprise St., Fremont, CA 94538
(510) 857-5666 Fax: (510) 857-5669
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Lookwood, Andrews
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LINE, TRACK, STATIONS AND SYSTEMS
DESIGN UNIT 023
MILPITAS STATION
LOWER ROOF LEVEL PLAN
HVAC
SHEET 1 OF 2

CADD FILENAME C700-S-DB-M321.dwg	
SIZE D	SCALE 1/8"=1'-0"
CONTRACT NO. C700	REV. 0
AREA CODE DB	SHEET NO. M321
	PAGE NO. 0714

- 8) SPLIT HEAT PUMP UNIT, EXTEND PRECHARGED & PREINSULATED REFRIGERANT TUBING TO AHU-14 SERVING MAINT ENGR OFFICE, C10
- 9) SPLIT CONDENSING UNIT, EXTEND PRECHARGED & PREINSULATED REFRIGERANT TUBING TO AHU-1 SERVING ESCALATOR CONTROL RM #1, P23
- 10) SPLIT CONDENSING UNIT, EXTEND PRECHARGED & PREINSULATED REFRIGERANT TUBING TO AHU-3 SERVING ELEVATOR MACHINE RM #1, P13
- 11) SPLIT HEAT PUMP UNIT, EXTEND PRECHARGED & PREINSULATED REFRIGERANT TUBING TO AHU-15 SERVING POLICE RM, C08
- 12) SPLIT CONDENSING UNIT, EXTEND PRECHARGED & PREINSULATED REFRIGERANT TUBING TO AHU-5 SERVING COMM TERM RM #3, P09
- 13) SPLIT CONDENSING UNIT, EXTEND PRECHARGED & PREINSULATED REFRIGERANT TUBING TO AHU-7 SERVING ESCALATOR CONTROL RM #3, P07
- 14) SPLIT HEAT PUMP UNIT, EXTEND PRECHARGED & PREINSULATED REFRIGERANT TUBING TO AHU-20 SERVING COMM ROOM, C07
- 15) SPLIT CONDENSING UNIT, EXTEND PRECHARGED & PREINSULATED REFRIGERANT TUBING TO AHU-21 SERVING POC ESCALATOR CONTROL, POC2
- 16) SPLIT CONDENSING UNIT, EXTEND PRECHARGED & PREINSULATED REFRIGERANT TUBING TO AHU-22 SERVING POC ELEVATOR MACHINE RM, POC3


☐ NO EXCEPTIONS TAKEN (NET)
☐ MAKE CORRECTIONS NOTED (MCN)
☐ AMEND AND RESUBMIT (A/R)

By: _____ **Date:** _____



Technical drawing of a 1000 Series carbide tool bit. The drawing includes a side view of the tool bit and a detail view of the cutting edge. Features are labeled as follows:

- A**: Top face of the tool bit.
- B**: Side face of the tool bit.
- C**: End face of the tool bit.
- D**: Bottom face of the tool bit.
- 0**: Corner radius at the top front corner.
- 4**: Corner radius at the top side corner.
- 8**: Corner radius at the top rear corner.
- 12**: Corner radius at the bottom rear corner.
- 16**: Corner radius at the bottom side corner.
- 20**: Corner radius at the bottom front corner.
- 24**: Corner radius at the bottom side corner (detail view).

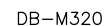

DESIGNED BY	J. CHOU
DRAWN BY	J. CHOU
CHECKED BY	G. HENNINGS
IN CHARGE	G. HENNINGS
DATE	20130710



1436 California Circle
Milpitas, California 95035
A Joint Venture

H&M H&M Mechanical Group
8517 Earhart Rd., #23
Oakland, CA 94621
510-569-2000

LEN Lockwood, Andrews & Newnam, Inc. T.Y. LIN INTERNATIONAL
A LEO A BAY COMPANY



CADD FILENAME C700-S-DB-M322.dwg		
SIZE D	SCALE 1/8"=1'-0"	
CONTRACT NO. C700		REV. 0
AREA CODE DB	SHEET NO. M322	PAGE NO. 0715

KEY NOTES

- 19 STAIRWAY SUPPLY FAN MOUNTED ON VIBRATION ISOLATORS, SEE SHEET NO. M364, DETAIL 1. FAN EQUIPPED WITH GRAVITY BACKDRAFT DAMPER, CONNECTED TO DUCTWORK WITH 6" FLEX CONNECTOR (RELAXED).
- 20 FAN ROOM ACCESS LADDER
- 21 ACOUSTICAL SUPPLY AIR PLENUM CAVITY, ENTIRE PLENUM TREATED WITH ACOUSTICAL FOAM.
- 22 (2)7'8"x7'11" PERFORATED PANEL/PRESSURE EQUALIZATION BAFFLE ABOVE LOWER LOUVER
- 23 SEAL DUCT WITH FIRE DAMPER PENETRATION OF WALL WITH DUCT SEALANT

Santa Clara Valley Transportation Authority

- NO EXCEPTIONS TAKEN (NET)
- MAKE CORRECTIONS NOTED (MCN)
- AMEND AND RESUBMIT (A/R)



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Contract No.: DB11002F


By: Date:



KEY PLAN

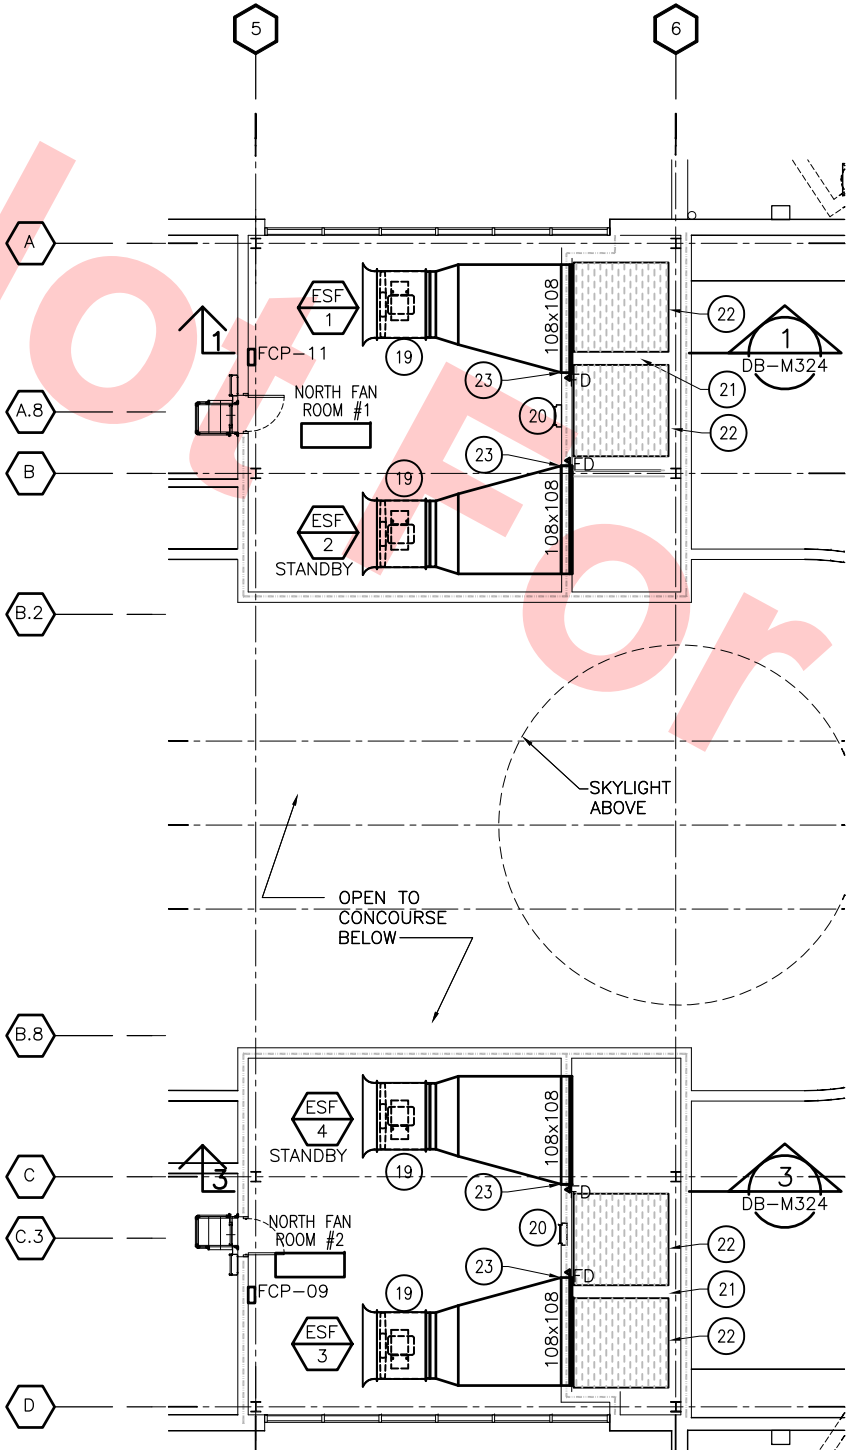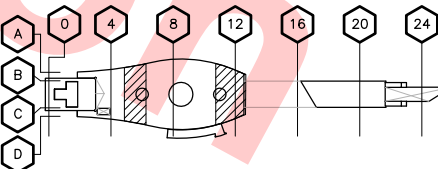

MEZZANINE PLAN
SCALE: 1/8" = 1'-0"

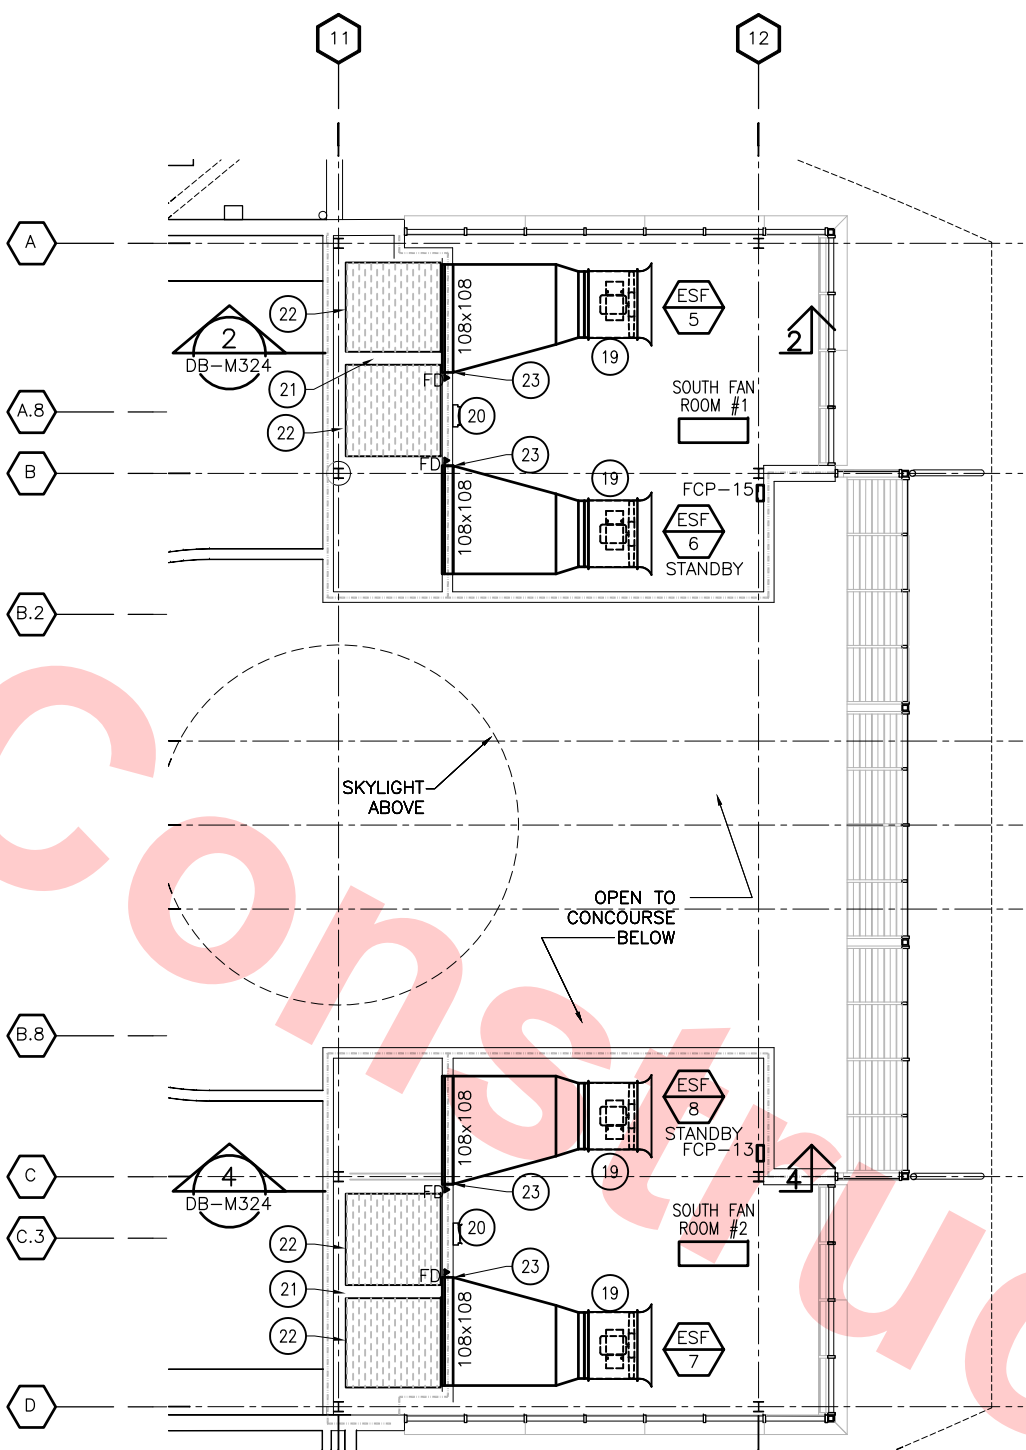

MEZZANINE PLAN
SCALE: 1/8" = 1'-0"

DESIGNED BY	J. CHOU
DRAWN BY	J. CHOU
CHECKED BY	G. HENNINGS
IN CHARGE	G. HENNINGS
DATE	20130710

REV	DATE	BY	SUB	APP	DESCRIPTION
0	20130710				READINESS FOR CONSTRUCTION



Skanska
Shimmick
Herzog

1436 California Circle
Milpitas, California 95035
A Joint Venture

Block Construction Inc.
4455 Enterprise St., Fremont, CA 94538
(510) 867-3666 Fax: (510) 867-3668
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H&M Mechanical Group
8517 Eastmont Rd. #230
Oakland, CA 94621
510-569-2000

Lookwood, Andrews
& Newnam, Inc.
A LEOP & BALLY COMPANY

T-Y-LIN INTERNATIONAL

APPROVED
[Signature]



LINE, TRACK, STATIONS AND SYSTEMS
DESIGN UNIT 023
MILPITAS STATION
MEZZANINE PLANS
HVAC

CADD FILENAME	C700-S-DB-M323.dwg
SIZE	SCALE
D	1/8"=1'-0"
CONTRACT NO.	C700
AREA CODE	DB
SHEET NO.	M323
PAGE NO.	0716

KEY NOTES

- (24) ACOUSTICALLY TREATED AIR PLENUM
(25) (2) PRICE MODEL MSPG PERFORATED GRILLE, 7'8"x7'11" EACH
(26) BACKDRAFT DAMPER AND 6" SLACK FLEX CONNECTOR AT DISCHARGE OF FAN
(27) FAN MOUNTED ON SPACE SAVING VIBRATION ISOLATION BASE, SEE DWG NO. M364, DETAIL 1
(28) 7'6"x5'6" LOUVER, TYP 2
(29) 12" WIDE x 11" HIGH x 80" LONG CONCRETE BASE, WITH 2" THICK VIBRATION ISOLATION PAD UNDER FAN SUPPORT BRACKET


Santa Clara Valley Transportation Authority

- NO EXCEPTIONS TAKEN (NET)
MAKE CORRECTIONS NOTED (MCN)
AMEND AND RESUBMIT (A/R)



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Contract No.: DB11002F

By: _____ Date: _____

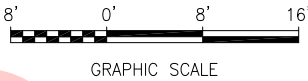

KEY PLAN

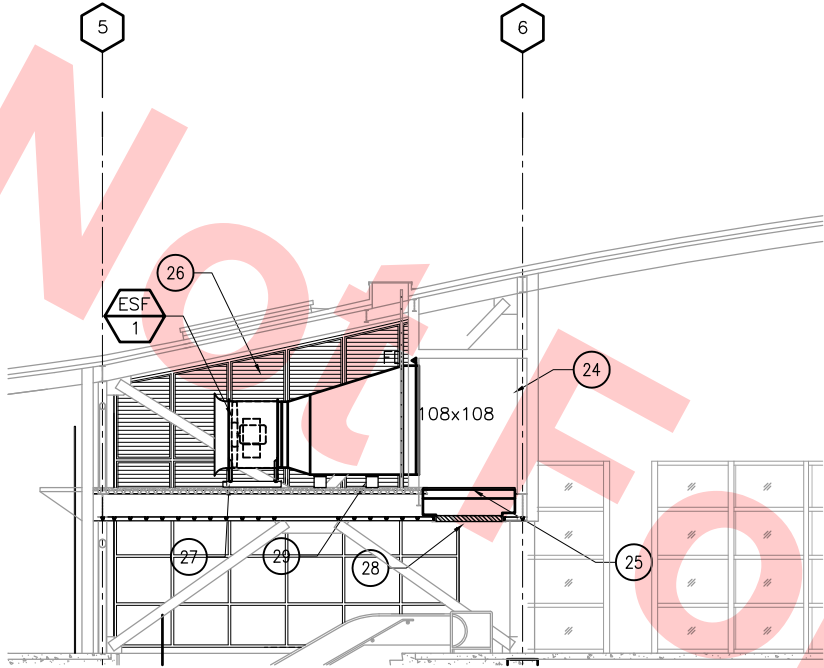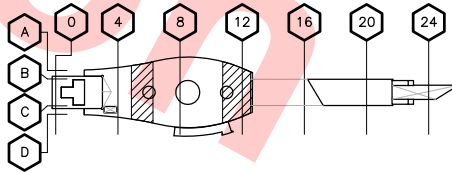


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SCALE: 1/8" = 1'-0"

1

DB-M324

DB-M323

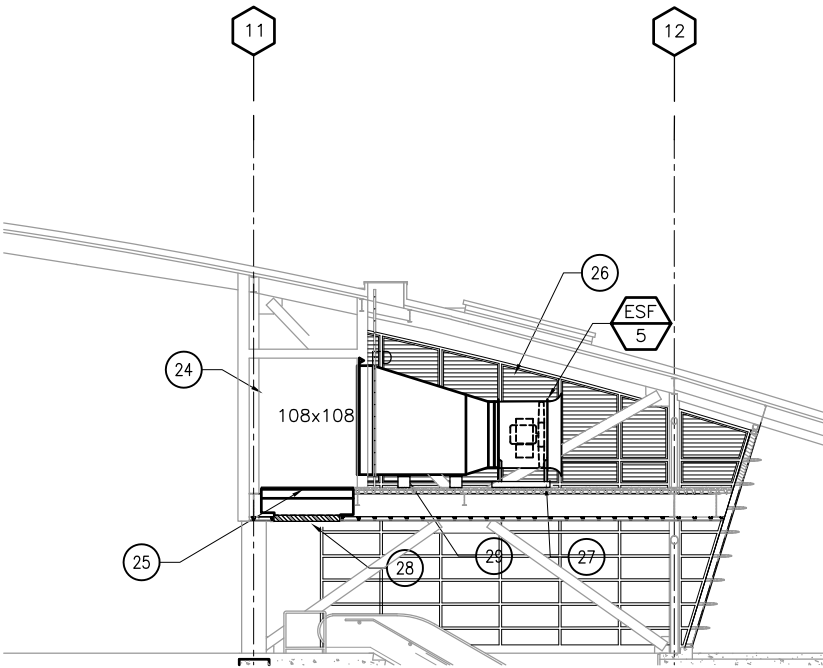


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SCALE: 1/8" = 1'-0"

2

DB-M324

DB-M323

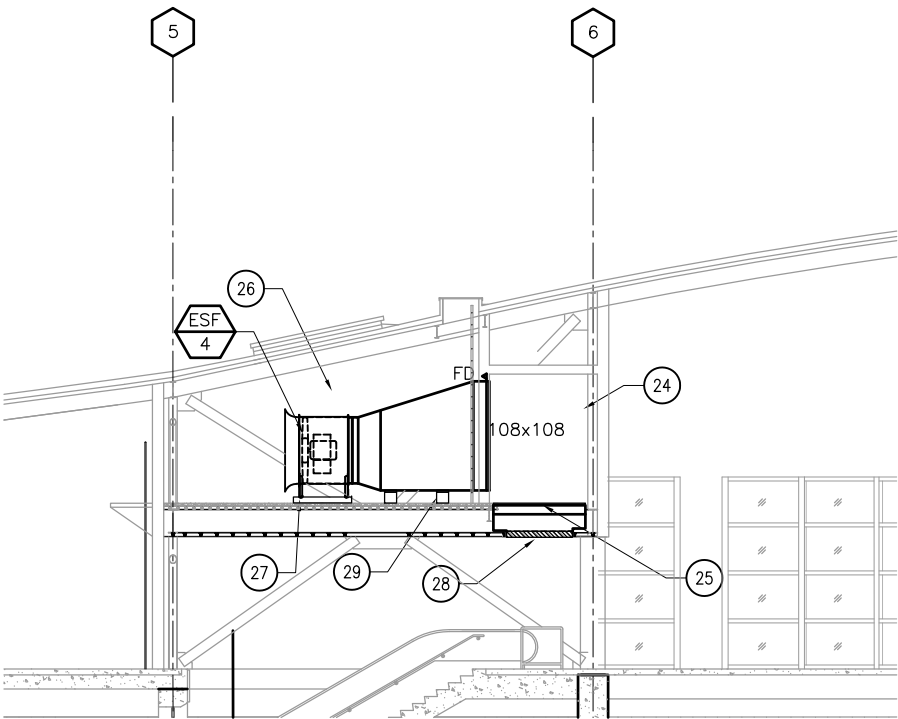


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SCALE: 1/8" = 1'-0"

3

DB-M324

DB-M323

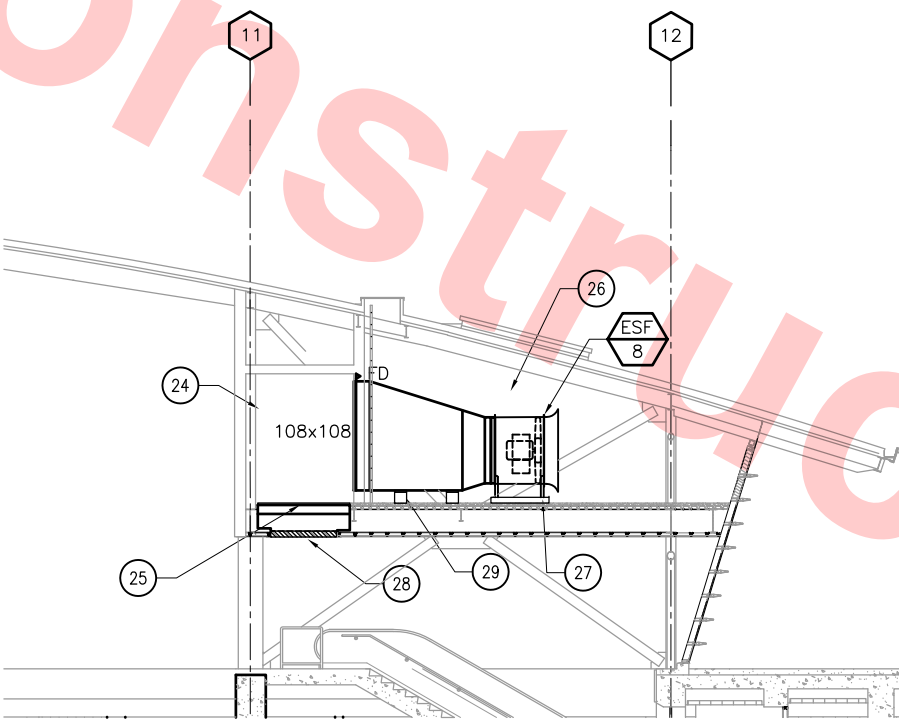

SECTION: SOUTH FAN ROOM #2

SCALE: 1/8" = 1'-0"

4

DB-M324

DB-M323

REV	DATE	BY	SUB	APP	DESCRIPTION
0	20130710				READINESS FOR CONSTRUCTION

DESIGNED BY
J. CHOU
DRAWN BY
J. CHOU
CHECKED BY
G. HENNINGS
IN CHARGE
G. HENNINGS
DATE
20130710



Block Construction Inc.
4455 Enterprise St., Fremont, CA 94538
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Skanska
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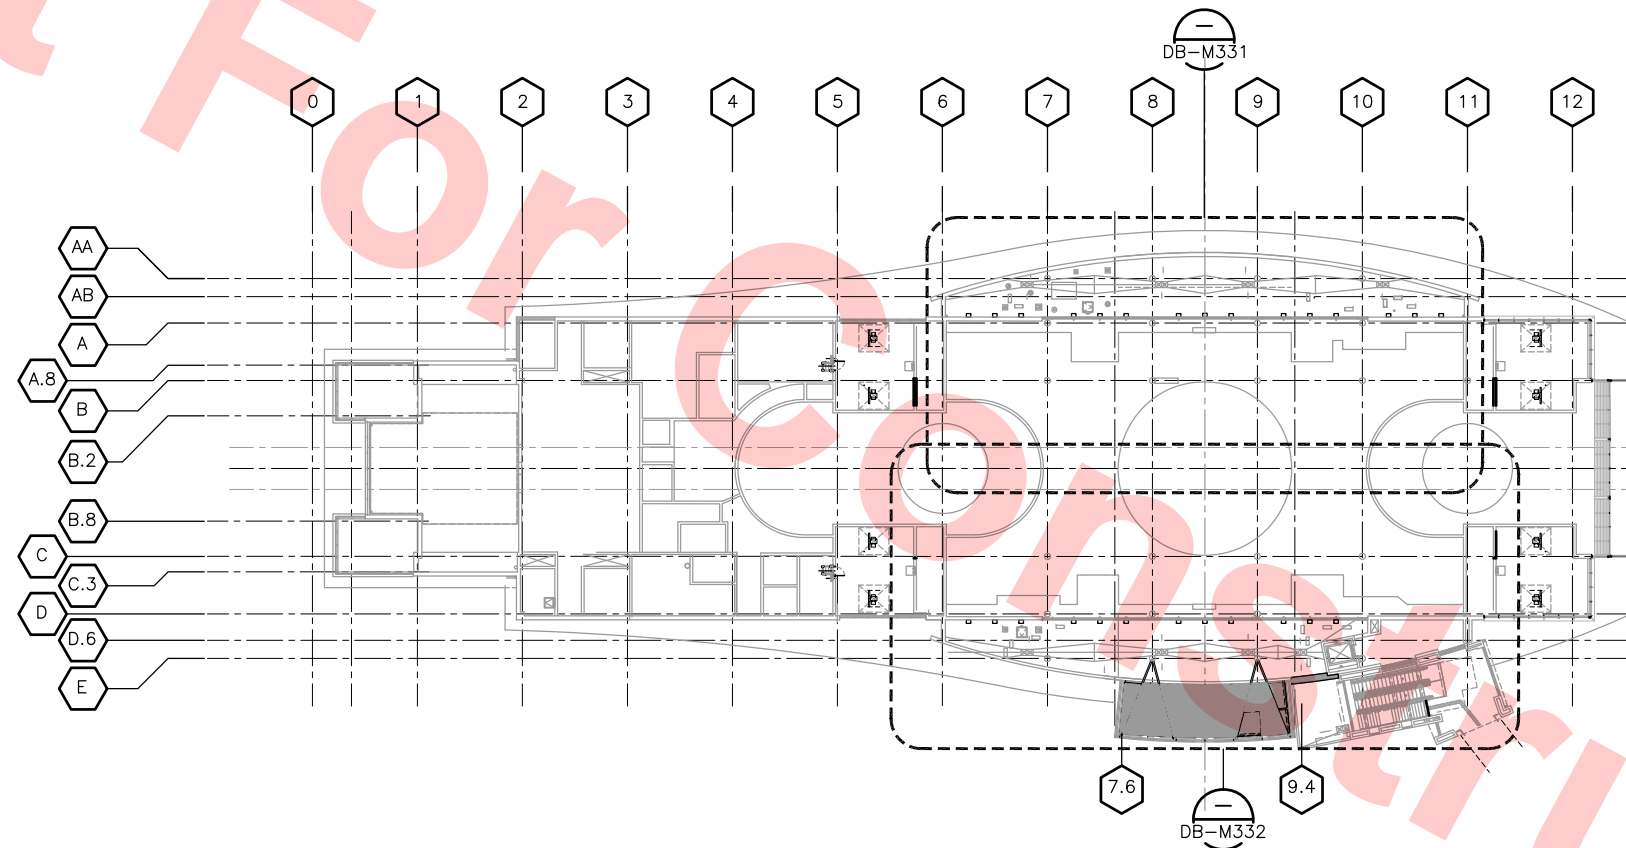
1436 California Circle
Milpitas, California 95035
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Lookwood, Andrews
& Newnam, Inc.
A LEOP RALLY COMPANY

T-Y-LIN INTERNATIONAL
APPROVED
By: *Y. Lin*



LINE, TRACK, STATIONS AND SYSTEMS
DESIGN UNIT 023
MILPITAS STATION
STAIRWAY SECTIONS
HVAC

CADD FILENAME
C700-S-DB-M324.dwg
SIZE SCALE
D 1/8"=1'-0"
CONTRACT NO. C700 REV. 0
AREA CODE SHEET NO. PAGE NO.
DB M324 0717



By: _____ **Date:** _____

32' 0' 32' 64'

GRAPHIC SCALE

[illegible]

KEY NOTES

- 19 ROOF DRAIN TO SD
29 OFD FOR ROOF
38 VENT TO ROOF MAINTAIN MINIMUM 10' CLEARANCES OUTSIDE AIR INTAKES

Santa Clara Valley Transportation Authority

- NO EXCEPTIONS TAKEN (NET)
MAKE CORRECTIONS NOTED (MCN)
AMEND AND RESUBMIT (A/R)


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Contract No.: DB11002F

By: Date:



KEY PLAN

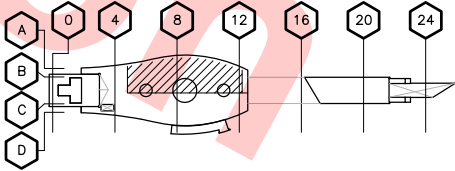

LOWER ROOF LEVEL PLAN — PLUMBING
SCALE: 1/8"=1'-0" DB-M330

MATCH LINE
SEE DWG NO. DB-M332

REV	DATE	BY	SUB	APP	DESCRIPTION
0	20130710				READINESS FOR CONSTRUCTION



Skanska Shimmick Herzog
1436 California Circle
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Oakland, CA 94621
510-569-2000

Lookwood, Andrews & Newman, Inc.
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T-Y-LIN INTERNATIONAL

APPROVED *[Signature]*





LINE, TRACK, STATIONS AND SYSTEMS
DESIGN UNIT 023
MILPITAS STATION
LOWER ROOF LEVEL PLAN
PLUMBING
SHEET 1 OF 2

CADD FILENAME C700-S-DB-M331.dwg
SIZE SCALE D 1/8"=1'-0"
CONTRACT NO. C700 REV. 0
AREA CODE SHEET NO. PAGE NO. DB M331 0719


19 ROOF DRAIN TO SD

29 OFD FOR ROOF

38 VENT TO ROOF MAINTAIN MINIMUM 10' CLEARANCES
OUTSIDE AIR INTAKES

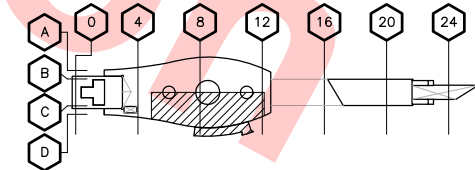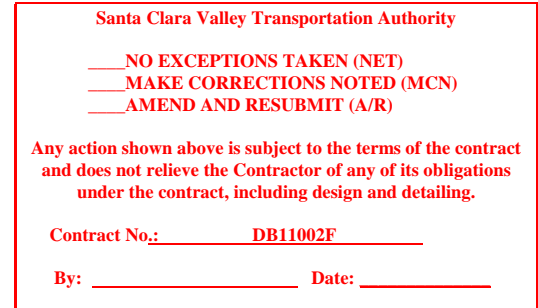

					DESIGNED BY P. BLAUVELT
					DRAWN BY P. BLAUVELT
					CHECKED BY G. HENNINGS
0	20130710				IN CHARGE G. HENNINGS
					DATE 20130710
REV	DATE	BY	SUB	APP	DESCRIPTION





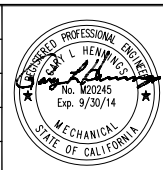


 BCCI Block Construction Inc. 4455 Enterprise St., Fremont, CA 94538 (510) 657-3686 Fax: (510) 657-3688 CA Lic. #679326 email: info@bcciinc.com		 HM Mechanical Group 8517 Harbor Rd, #201 Oakland, CA 94621 510-569-2000		 Lockwood, Andrews & Newnam, Inc. A LEO A RALY GROUP		T-Y-LIN INTERNATIONAL 	
SUBMITTED		APPROVED					



LINE, TRACK, STATIONS AND SYSTEMS
DESIGN UNIT 023
MILPITAS STATION
LOWER ROOF LEVEL PLAN
PLUMBING
SHEET 2 OF 2

CADD FILENAME C700-S-DB-M332.dwg		
SIZE D	SCALE 1/8"=1'-0"	
CONTRACT NO. C700		REV. 0
AREA CODE DB	SHEET NO. M332	PAGE NO. 0720

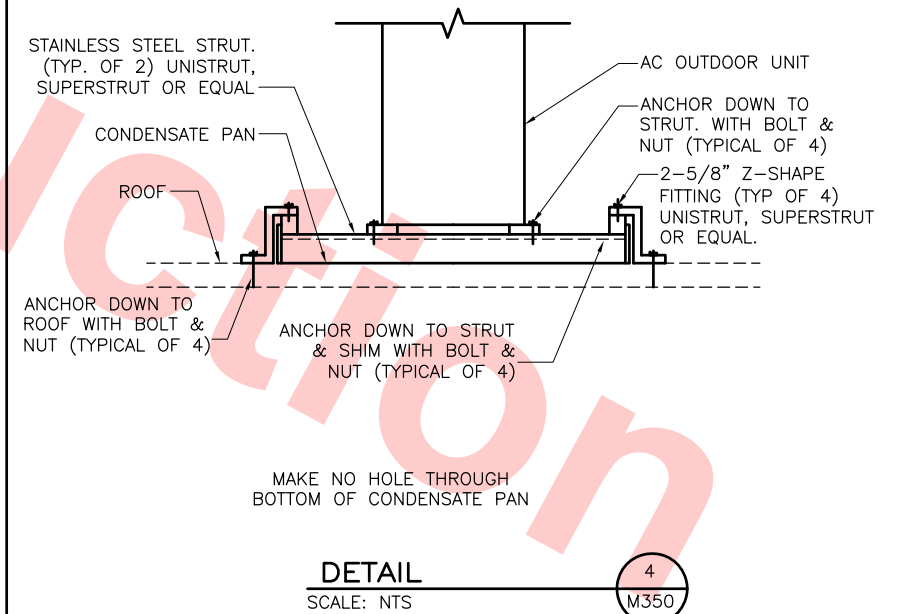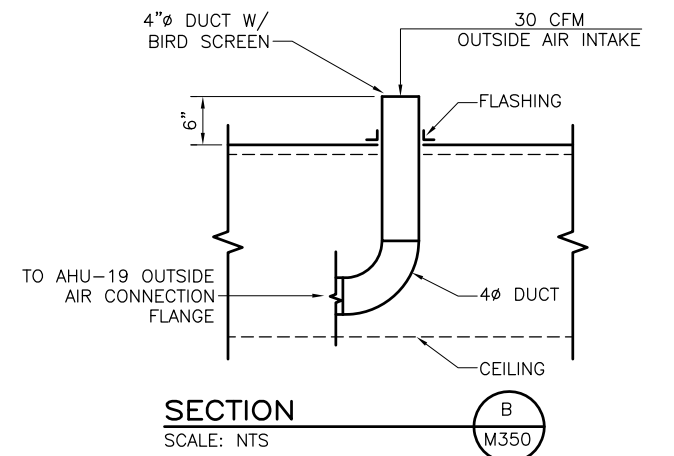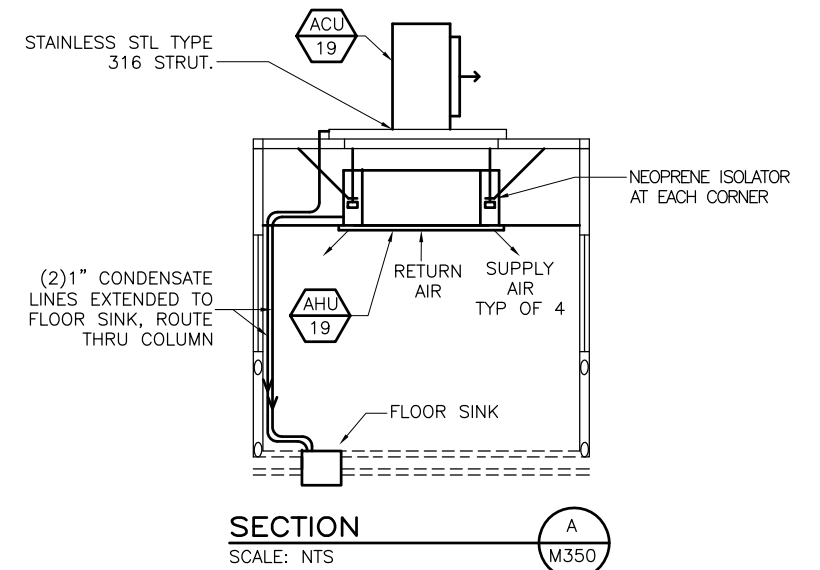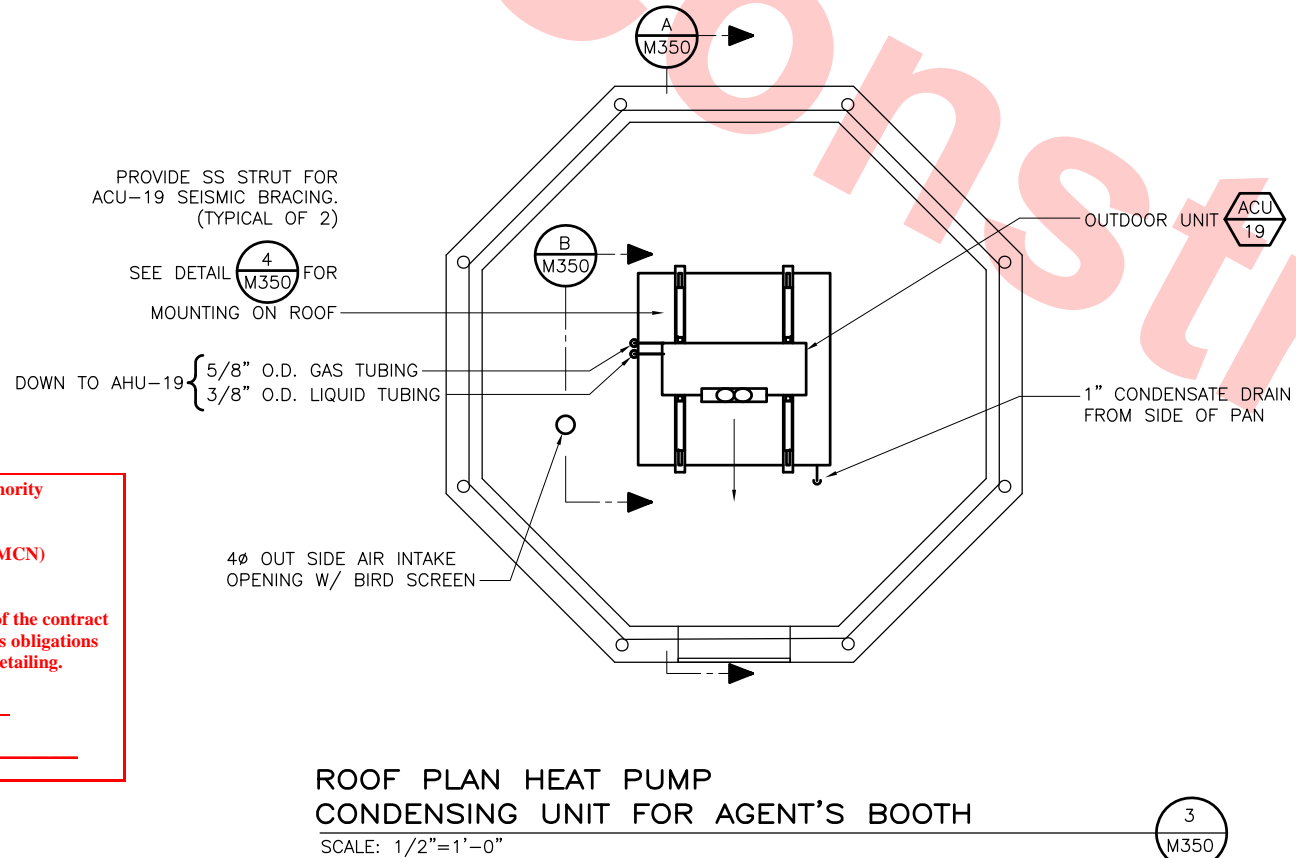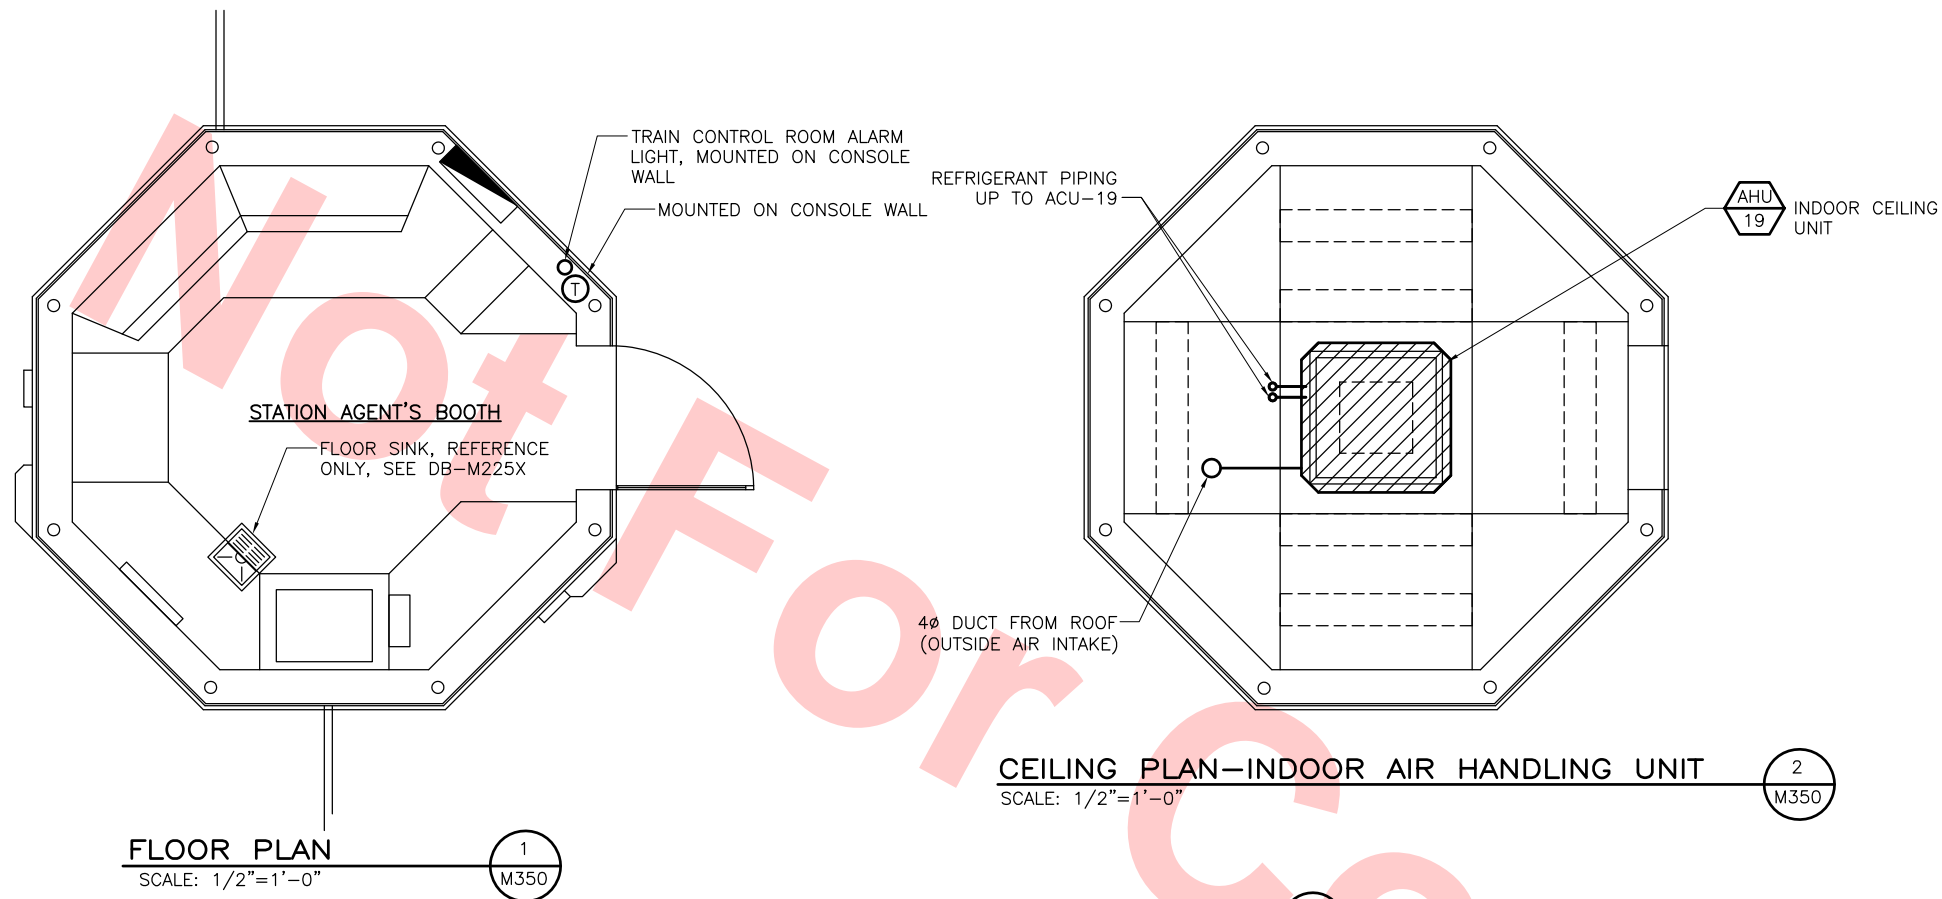

Santa Clara Valley Transportation Authority

___ NO EXCEPTIONS TAKEN (NET)
___ MAKE CORRECTIONS NOTED (MCN)
___ AMEND AND RESUBMIT (A/R)

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Contract No.: DB11002F

By: _____ Date: _____


REV	DATE	BY	SUB	APP	DESCRIPTION
0	20130710				READINESS FOR CONSTRUCTION



Skanska Shimmick Herzog 1436 California Circle Milpitas, California 95035 A Joint Venture BLOCK Construction Inc. 4455 Enterprise St., Fremont, CA 94538 (510) 807-9888 Fax: (510) 807-9889 CA Lic. #679326 email: info@blockcorp.com H&M Mechanical Group 8517 Easthill Rd. #230 Oakland, CA 94621 510-569-2000 Lookwood, Andrews & Newnam, Inc. A LEQ A BALLY COMPANY T-Y LIN INTERNATIONAL APPROVED <i>By: [Signature]</i>	BART SILICON VALLEY BART SILICON VALLEY BERRYESSA EXTENSION
---	---


LINE, TRACK, STATIONS AND SYSTEMS
DESIGN UNIT 023
 MILPITAS STATION
 STATION AGENT'S BOOTH
 HVAC

CADD FILENAME C700-S-DB-M350.dwg	SIZE D	SCALE AS SHOWN
CONTRACT NO. C700	SHEET NO. DB	PAGE NO. 0721

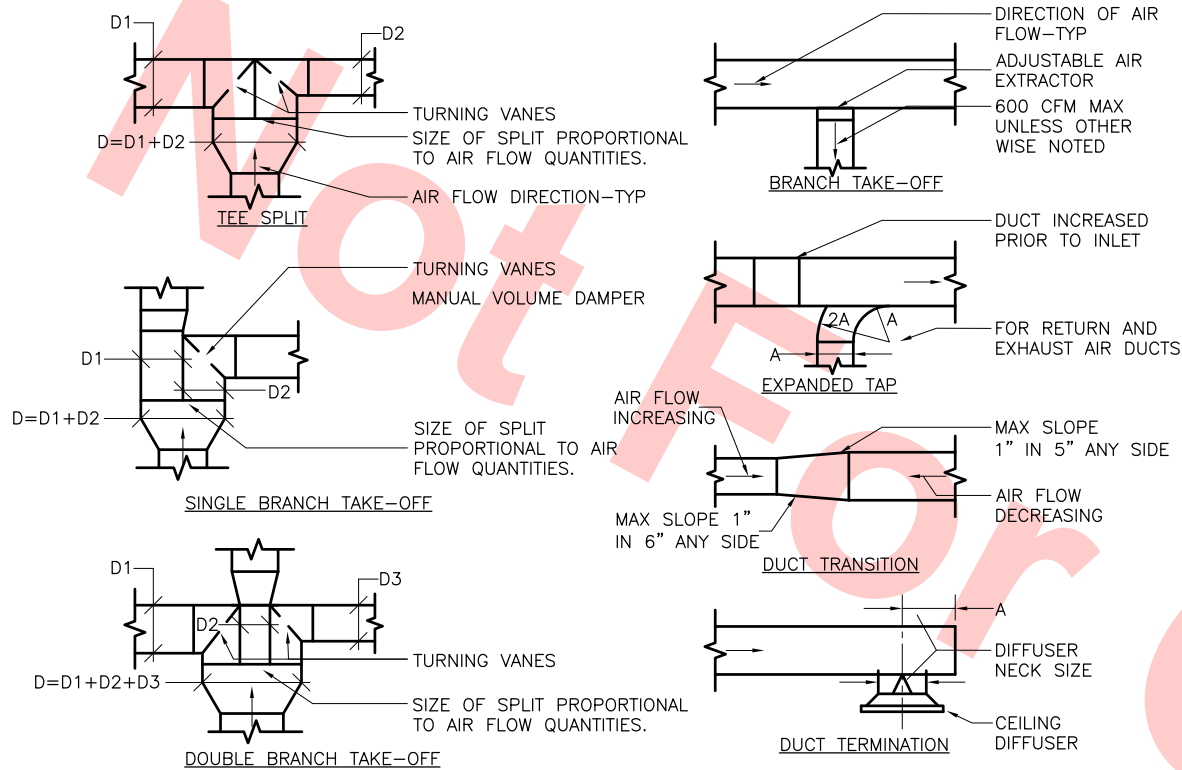

TYPICAL RECTANGULAR DUCT FITTING DETAIL
 SCALE: NTS


1
M360

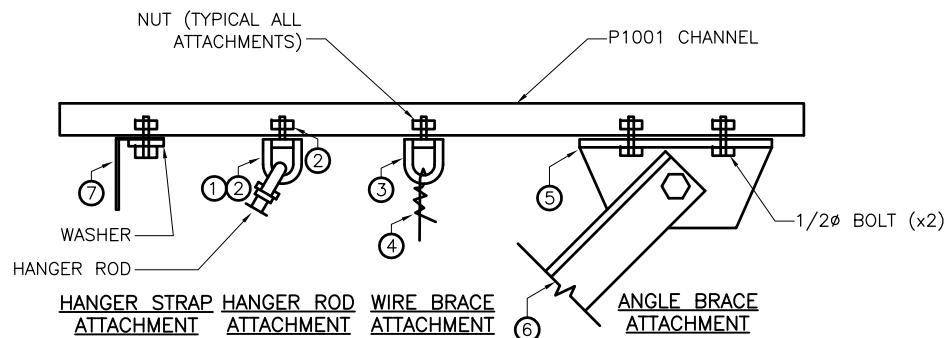

- NOTES:**
1. SWIVEL HANGER (PAIR). FEMALE AND MALE CONNECTIONS.
 2. SIZE AS REQUIRED FOR HANGER ROD.
 3. SWIVEL HANGER. MALE CONNECTION ONLY.
 4. 12 GA WIRE.
 5. GUSSETED SHELF ANGLE.
 6. BRACING ANGLE FOR PIPES OR DUCTS.
 7. MIN 16 GA HANGER STRAP.

ATTACHMENTS TO ROOF STRUCTURE (MAX 2 ATTACHMENTS PER CHANNEL)
ATTACHMENTS TO ROOF STRUCTURE DETAIL
 SCALE: NTS


2
M360

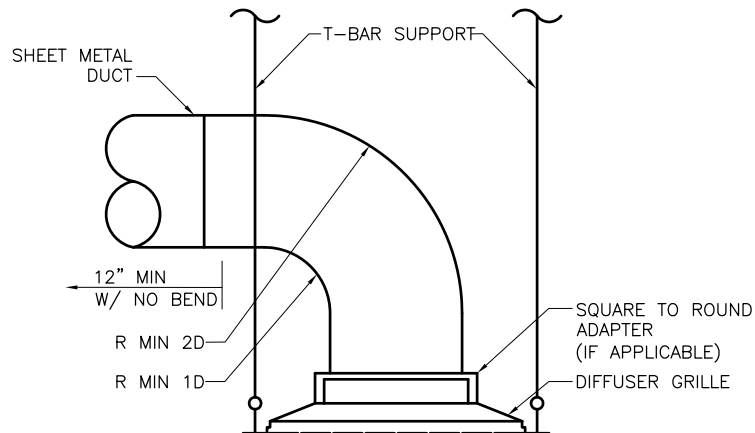

- NOTES:**
- FLEXIBLE DUCTS: FLAME SPREAD AND FRAME CONTRIBUTION RATINGS: 25-50 (OR EQUAL.)

CEILING DIFFUSER DETAIL
 SCALE: NTS


4
M360

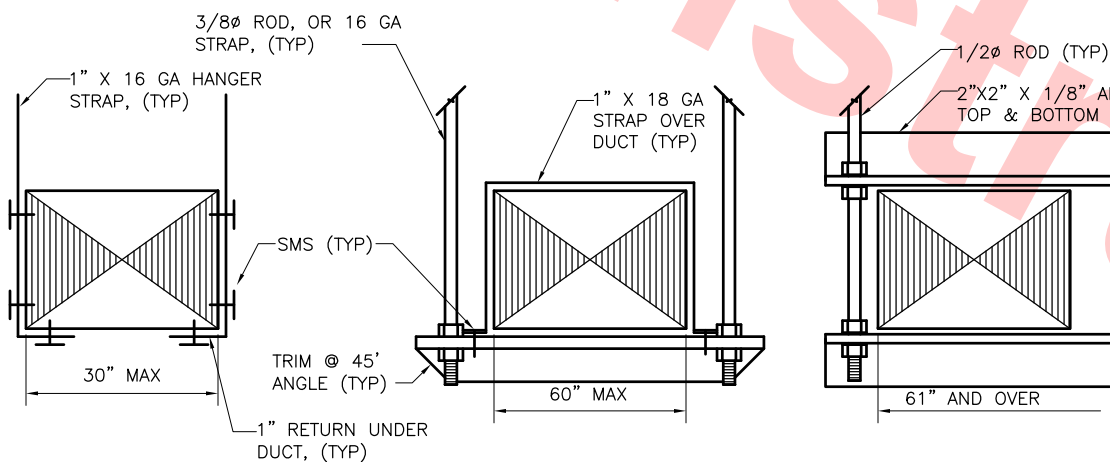


- NOTES:**
- SPACING OF HANGERS PER SMACNA. REFER TO DETAILS 2 & 3 FOR UPPER ATTACHMENT. PROVIDE SWAY & SEISMIC BRACING PER SMACNA SEISMIC GUIDELINES.

DUCT HANGER DETAIL
 SCALE: NTS


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M360

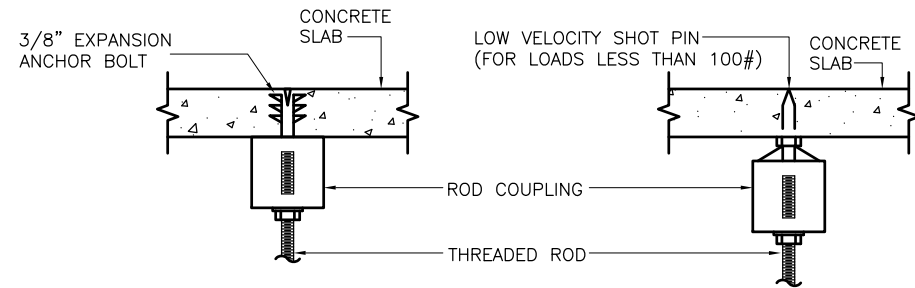

UPPER CONNECTION DETAIL ON CONCRETE SLAB

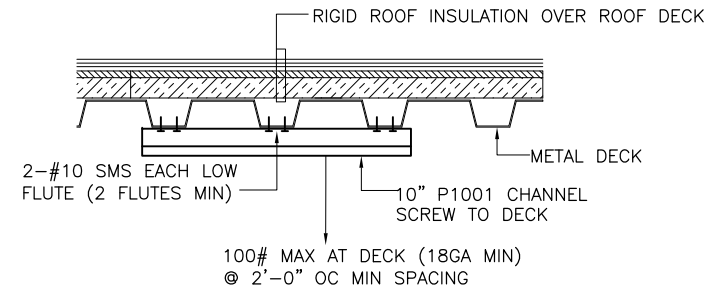

UPPER CONNECTION DETAIL ON BUILT-UP ROOF WITH METAL DECK

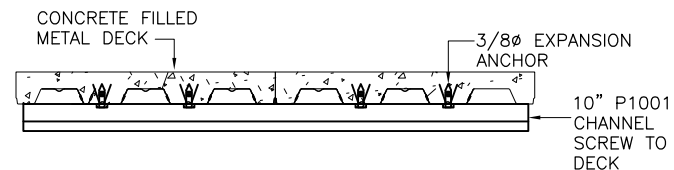

UPPER CONNECTION DETAIL ON CONCRETE FILLED METAL DECK

UPPER SUPPORT MOUNTING DETAIL
 SCALE: NTS

3
M360

Santa Clara Valley Transportation Authority

NO EXCEPTIONS TAKEN (NET)
 MAKE CORRECTIONS NOTED (MCN)
 AMEND AND RESUBMIT (A/R)

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Contract No.: **DB11002F**

By: _____ Date: _____

REV	DATE	BY	SUB	APP	DESCRIPTION
0	20130710				READINESS FOR CONSTRUCTION

DESIGNED BY
J. CHOU
 DRAWN BY
J. CHOU
 CHECKED BY
G. HENNINGS
 IN CHARGE
G. HENNINGS
 DATE
20130710

Block Construction Inc.
 4455 Enterprise St., Fremont, CA 94538
 (510) 867-5668 Fax: (510) 867-5669
 CA Lic. #679326 email: info@blockco.com

Skanska Shimmick Herzog
 1436 California Circle
 Milpitas, California 95035
 A Joint Venture


H&M Mechanical Group
 8517 Eastmont Rd. #230
 Oakland, CA 94621
 510-569-2000

Lookwood, Andrews & Newman, Inc.
 T-Y-LIN INTERNATIONAL
 APPROVED

BART SILICON VALLEY
 BART SILICON VALLEY BERRYESSA EXTENSION

LINE, TRACK, STATIONS AND SYSTEMS
 DESIGN UNIT 023
 MILPITAS STATION
 HVAC DETAILS
 SHEET 1 OF 6

CADD FILENAME C700-S-DB-M360.dwg	SIZE D	SCALE AS SHOWN
CONTRACT NO. C700	SHEET NO. DB	PAGE NO. 0722

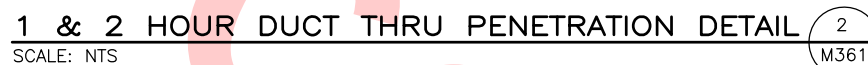

ONE STEEL DUCT TO BE INSTALLED EITHER CONCENTRICALLY OR ECCENTRICALLY WITHIN THE FIRESTOP SYSTEM. AN ANNUAL SPACE OF MIN 0" (POINT OF CONTACT) TO MAX 4" IS REQUIRED WITHIN THE FIRESTOP SYSTEM FOR 2 HR ASSEMBLIES AND MIN 0" (CONTACT POINT) TO MAX 2" IS REQUIRED WITHIN THE FIRESTOP SYSTEM FOR 3 HR ASSEMBLIES. STEEL DUCT TO BE RIGIDLY SUPPORTED ON BOTH SIDES OF FLOOR OR WALL ASSEMBLY. THE FOLLOWING STEEL DUCTS MAY BE USED:

- A. STEEL DUCT-NOM 32" BY 14"(OR SMALLER) NO. 22 GA
(OR HEAVIER) GALV STEEL DUCT.
- B. STEEL DUCT-NOM 30" BY 12"(OR SMALLER) NO. 24 GA
(OR HEAVIER) GALV STEEL DUCT.

Santa Clara Valley Transportation Authority

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Contract No.: DB11002F


By: _____ **Date:** _____



1. TOP OF CURB MUST BE LEVELED. SHIM BOTTOM OF CURB AS REQUIRED
2. SEE DB-M362, DETAIL 6 FOR ROOF CURB



CADD FILENAME C700-S-DB-M361.dwg		
SIZE D	SCALE AS SHOWN	
CONTRACT NO. C700		REV. C
AREA CODE DB	SHEET NO. M361	PAGE NO. 0723

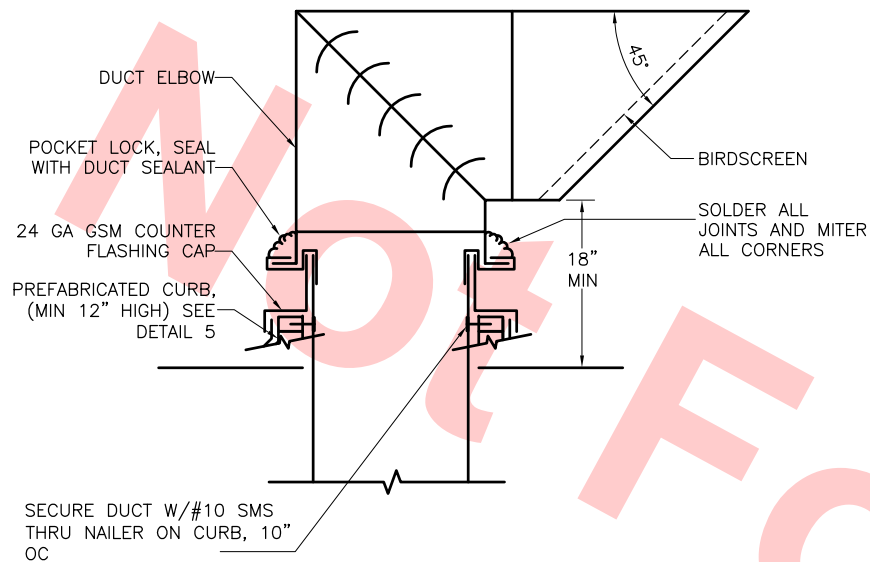


RECTANGULAR DUCT THRU ROOF DETAIL

DETAIL—GOOSENECK

SCALE: NTS

1
M362

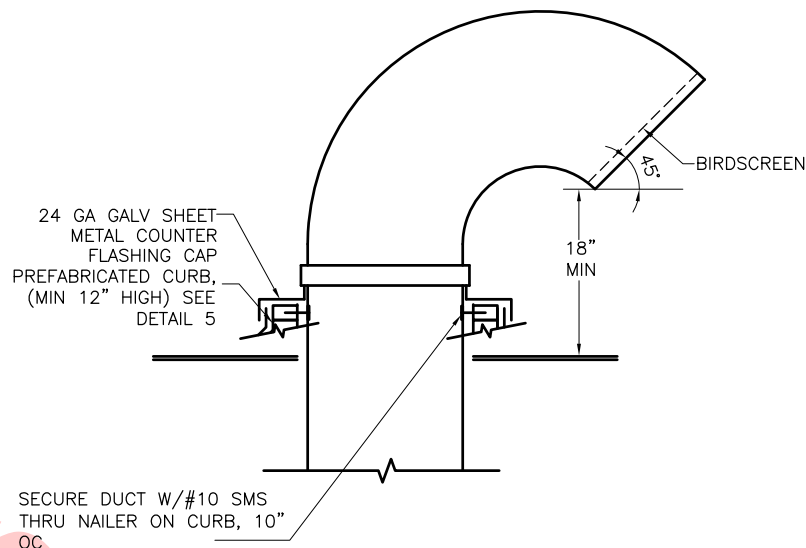


ROUND DUCT THRU ROOF DETAIL

DETAIL—GOOSENECK

SCALE: NTS


2
M362

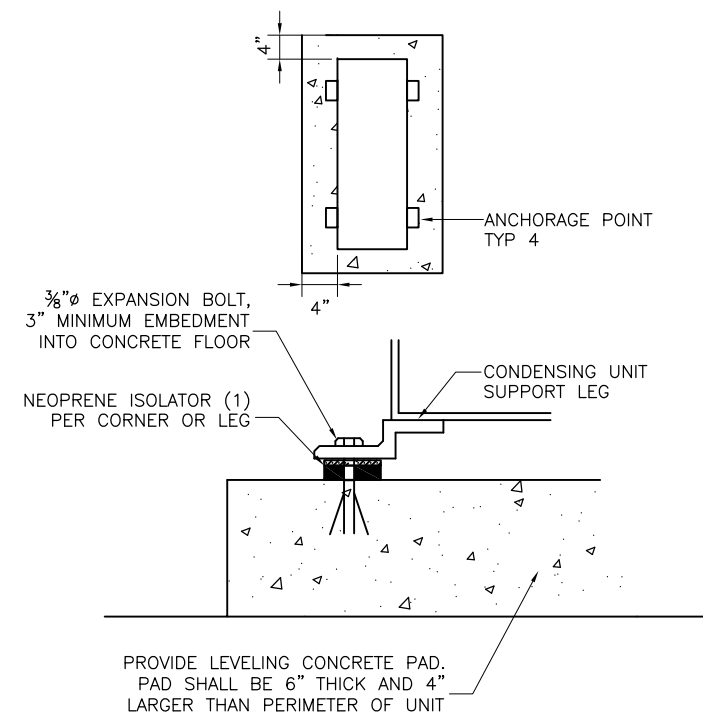

ACU FLOOR MOUNT DETAIL

SCALE: NTS


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M362

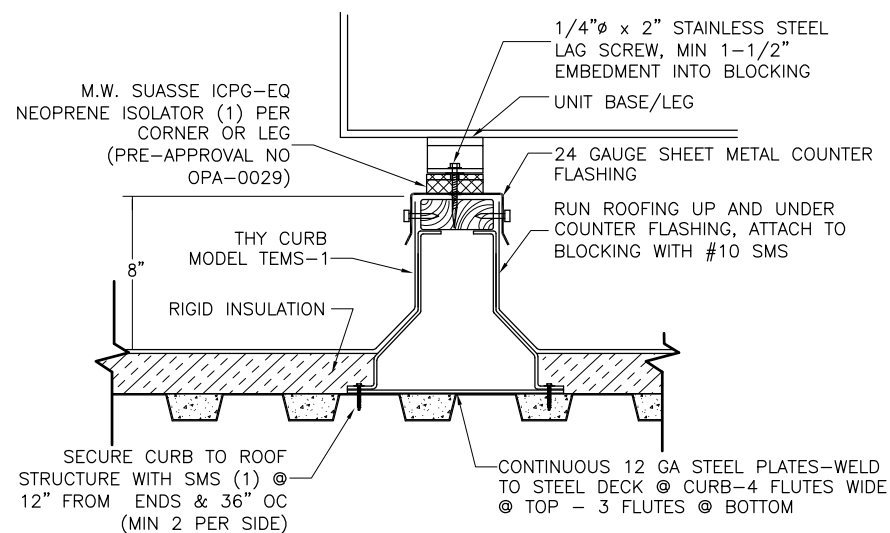

ROOF MOUNT CONDENSER

SCALE: NTS


4
M362

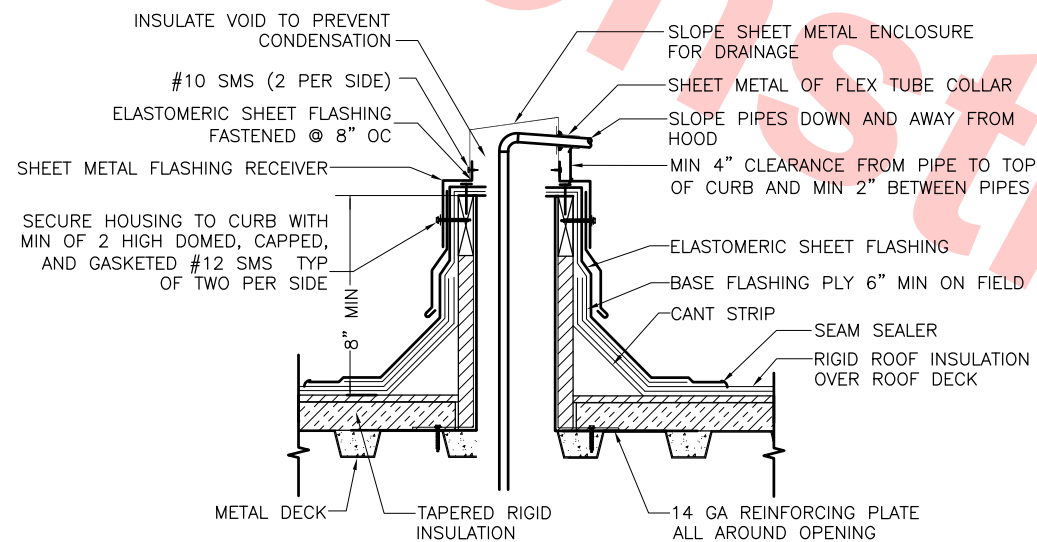

PIPE THRU ROOF DETAIL

SCALE: NTS

5
M362

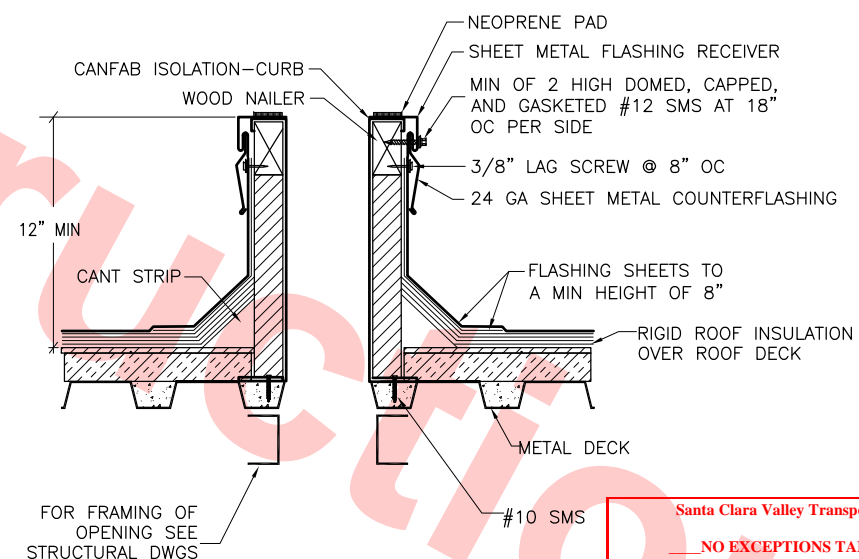

ROOF CURB DETAIL

SCALE: NTS

6
M362

Santa Clara Valley Transportation Authority

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By: _____ Date: _____

						DESIGNED BY J. CHOU
						DRAWN BY J. CHOU
						CHECKED BY G. HENNINGS
						IN CHARGE G. HENNINGS
0	20130710				READINESS FOR CONSTRUCTION	DATE 20130710
REV	DATE	BY	SUB	APP	DESCRIPTION	




Skanska Shimmick Herzog	1436 California Circle Milpitas, California 95035 A Joint Venture
BCT Block Construction Inc. 4455 Enterprise St., Fremont, CA 94538 (510) 807-9888 Fax: (510) 807-9889 CA Lic. #679326 email: info@bctgroup.com	H&M Mechanical Group 8517 Eastmont Rd. #230 Oakland, CA 94621 510-569-2000
Lookwood, Andrews & Newman, Inc. A LEQ A BALLY COMPANY	T-Y-LIN INTERNATIONAL
APPROVED	APPROVED




LINE, TRACK, STATIONS AND SYSTEMS
DESIGN UNIT 023
MILPITAS STATION
HVAC DETAILS
SHEET 3 OF 6

CADD FILENAME		
C700-S-DB-M362.dwg		
SIZE	SCALE	
D	AS SHOWN	
CONTRACT NO.		REV.
C700		0
AREA CODE	SHEET NO.	PAGE NO.
DB	M362	0724

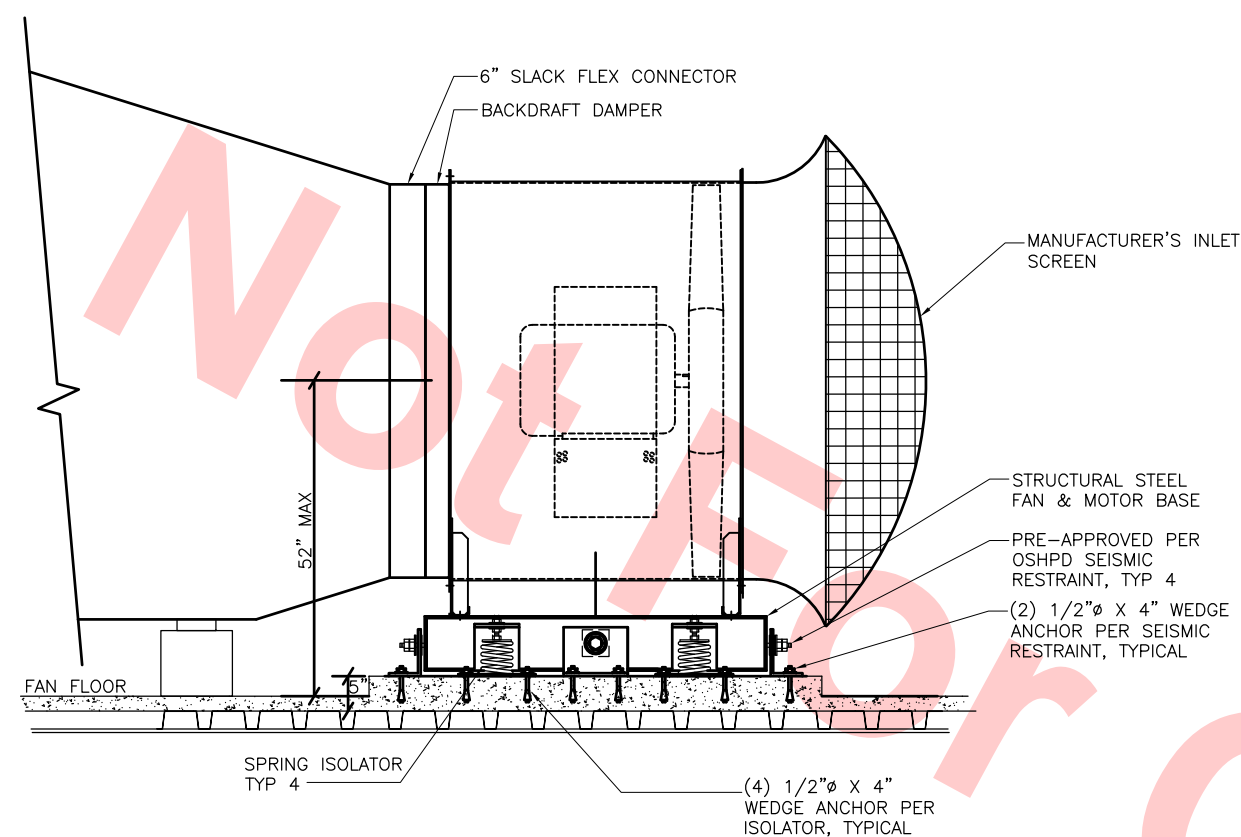

ESF-1,2,3,4,5,6,7 & 8 STAIRWAY VENTILATION FAN
SCALE: NTS

1
M364

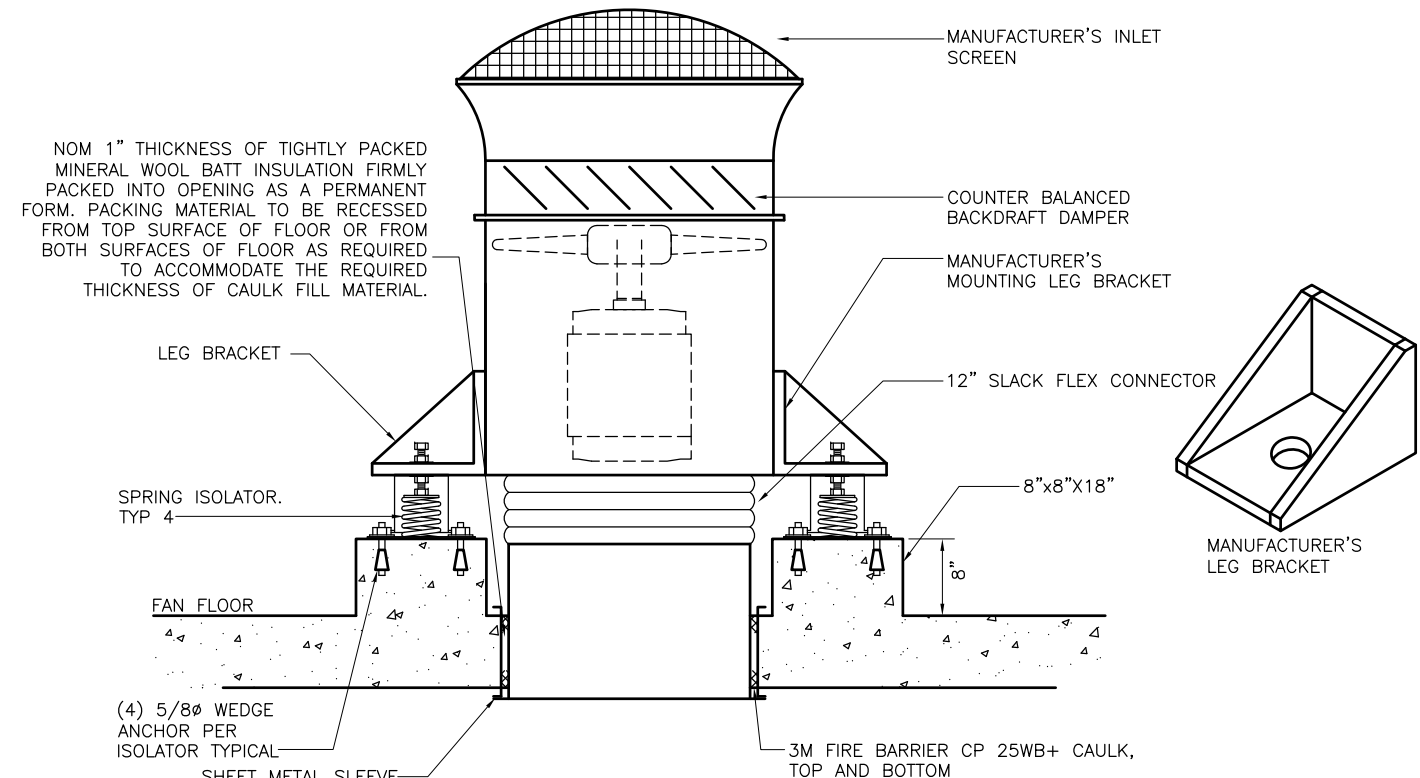


NOTES:

1. SEISMIC RESTRAINTS ARE OSHPD PRE-APPROVED, # OPA-0029 SEISMIC CALCULATIONS REQUIRED FOR ENTIRE ASSEMBLY INCLUDING ANCHOR BOLTS.

EVF-1,2,3 & 4 PLATFORM VENTILATION FAN
SCALE: NTS

2
M364

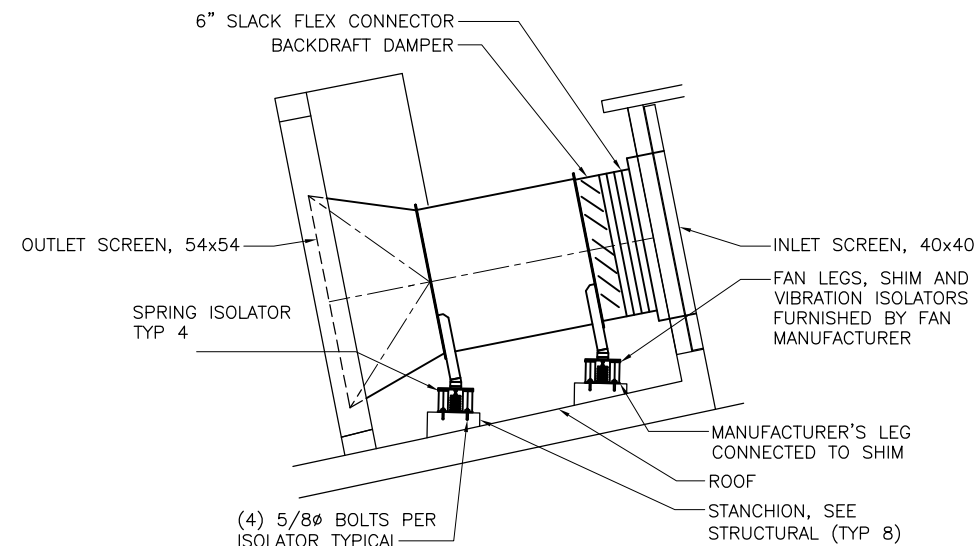

NOTES:

1. EEF-1 DEPICTED: SIMILAR FOR ALL OTHER EEF FANS

EEF-1,2,3,4,5,6,7,8,9,10,11 & 12 SKYLIGHT EXHAUST FAN
SCALE: NTS

3
M364

Santa Clara Valley Transportation Authority

- ___ NO EXCEPTIONS TAKEN (NET)
- ___ MAKE CORRECTIONS NOTED (MCN)
- ___ AMEND AND RESUBMIT (A/R)


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Contract No.: **DB11002F**

By: _____ Date: _____

DESIGNED BY	J. CHOU
DRAWN BY	J. CHOU
CHECKED BY	G. HENNINGS
IN CHARGE	G. HENNINGS
DATE	20130710

REV	DATE	BY	SUB	APP	DESCRIPTION
0	20130710				READINESS FOR CONSTRUCTION

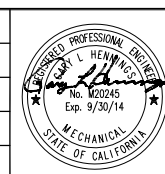

Skanska Shimmick Herzog

1436 California Circle
Milpitas, California 95035
A Joint Venture

BCT Block Construction Inc.
4455 Enterprise St., Fremont, CA 94538
(510) 807-9888 Fax: (510) 807-9889
CA Lic. #679326 email: info@bctca.com

H&M Mechanical Group
8517 Eastert Rd. #230
Oakland, CA 94621
510-569-2000

Lookwood, Andrews & Newnam, Inc.
A LEQ A BALLY COMPANY

T-Y-LIN INTERNATIONAL

SUBMITTED *[Signature]*

APPROVED *[Signature]*



BART SILICON VALLEY

BART SILICON VALLEY BERRYESSA EXTENSION

LINE, TRACK, STATIONS AND SYSTEMS
DESIGN UNIT 023
MILPITAS STATION
HVAC DETAILS

SHEET 5 OF 6

CADD FILENAME C700-S-DB-M364.dwg			
SIZE	SCALE	AS SHOWN	
D			
CONTRACT NO.	C700	REV.	0
AREA CODE	DB	SHEET NO.	M364
		PAGE NO.	0726

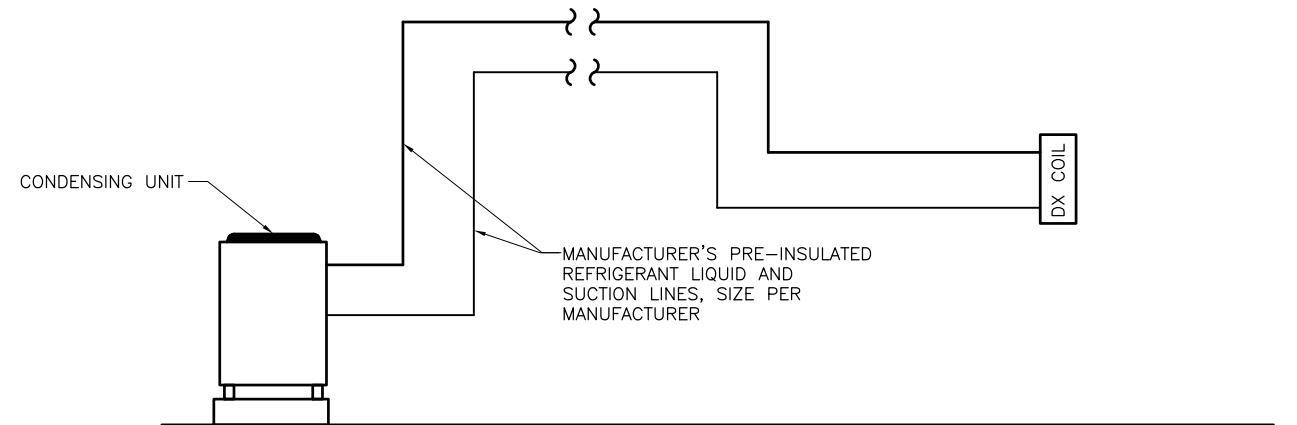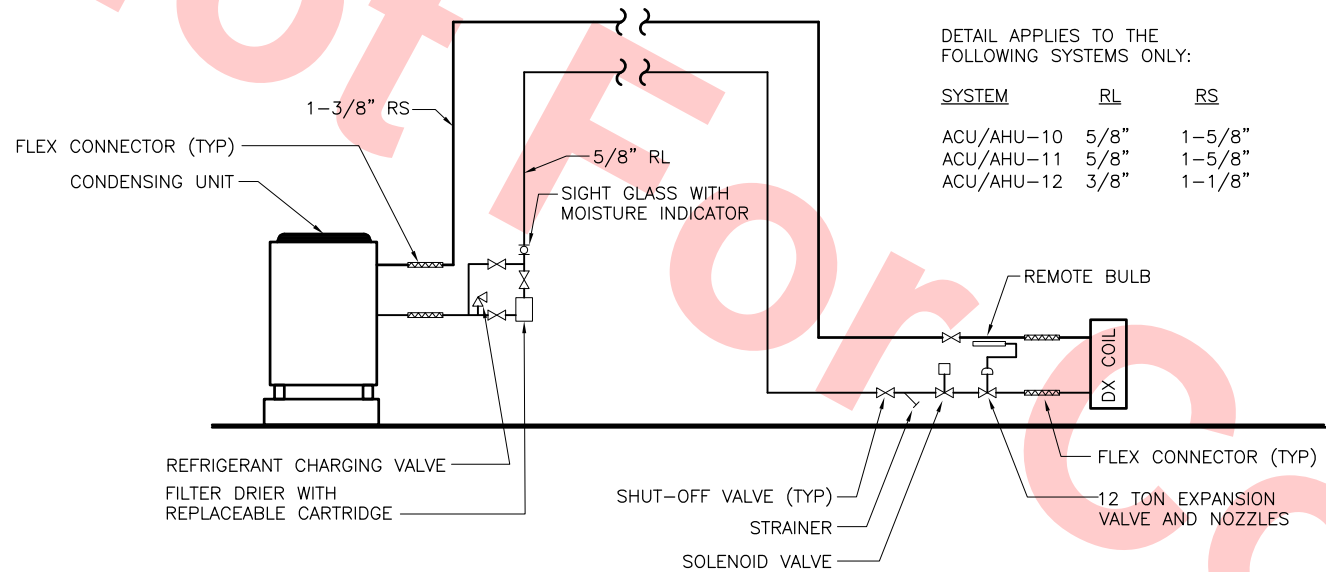

AHU-10,11: ACU-10,11: SPLIT SYSTEM REFRIGERANT PIPING 1
SCALE: NTS M365

ALL OTHER SPLIT SYSTEM REFRIGERANT PIPING 2
SCALE: NTS M365







Santa Clara Valley Transportation Authority

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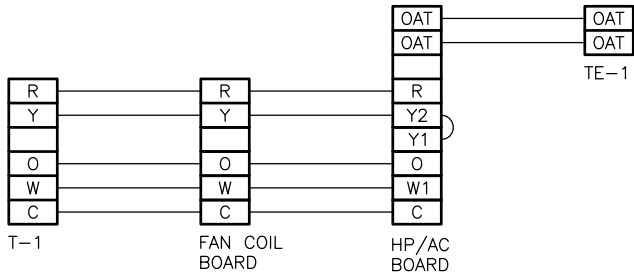
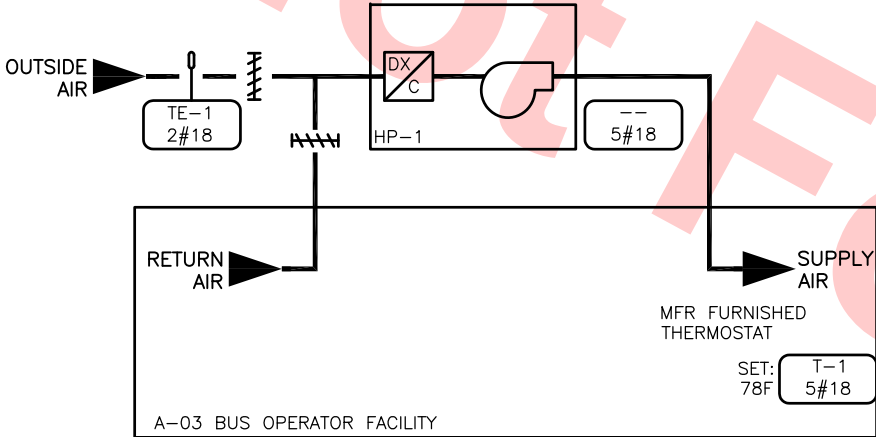
By: _____ Date: _____

						DESIGNED BY J. CHOU		<div>Skanska Shimmick Herzog</div> <div>1436 California Circle Milpitas, California 95035 A Joint Venture</div>	 <div>BART SILICON VALLEY BERRYESSA EXTENSION</div>	LINE, TRACK, STATIONS AND SYSTEMS DESIGN UNIT 023 MILPITAS STATION HVAC DETAILS SHEET 6 OF 6	CADD FILENAME C700-S-DB-M365.dwg			
					DRAWN BY J. CHOU	SIZE D					SCALE AS SHOWN			
					CHECKED BY G. HENNINGS	CONTRACT NO.					REV.			
					IN CHARGE G. HENNINGS	C700					0			
0	20130710				READINESS FOR CONSTRUCTION	DATE 20130710	   	SUBMITTED	APPROVED			AREA CODE	SHEET NO.	PAGE NO.
REV	DATE	BY	SUB	APP	DESCRIPTION	DB						M365	0727	

User: Jul 08, 2013 10:31 am C:\projects\wise\mbs-g-hennings\c700-s-db-m370.dwg

BILL OF MATERIALS


ITEM	QTY	DESCRIPTION	MANUFACTURER
T-1	1	THERMOSTAT	C/W HP




SEQUENCE OF OPERATION

THE HEAT PUMP IS CONTROLLED BY A PROGRAMMABLE THERMOSTAT. DURING THE OCCUPIED MODE WHEN THE ZONE TEMPERATURE IS ABOVE SETPOINT, THE COMPRESSOR WILL ENERGIZE. WHEN THE ZONE TEMPERATURE IS BELOW SETPOINT, THE COMPRESSOR AND REVERSING VALVE WILL ENERGIZE. THE SUPPLY FAN WILL OPERATE CONTINUOUSLY. DURING THE UNOCCUPIED MODE, THE SYSTEM WILL CYCLE ON WHEN THE UNOCCUPIED COOLING AND HEATING SETPOINTS ARE EXCEEDED.

HEAT PUMP HP-1 FLOW AND WIRING DIAGRAMS

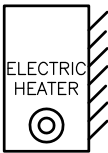


ROOM NAME	EQUIP ID
C22 STAFF TOILET	EH-1
A-04 MEN	EH-2
A-05 WOMEN	EH-3

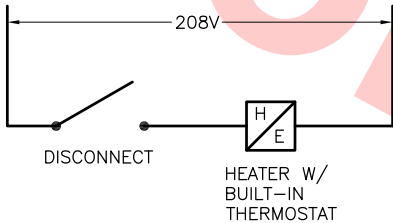


SEQUENCE OF OPERATION

THE STAFF TOILET ELECTRIC HEATER IS CONTROLLED BY A BUILT-IN THERMOSTAT. WHEN THE TEMPERATURE IS BELOW SETPOINT, THE ELECTRIC HEATER WILL START.

ELECTRIC HEATER

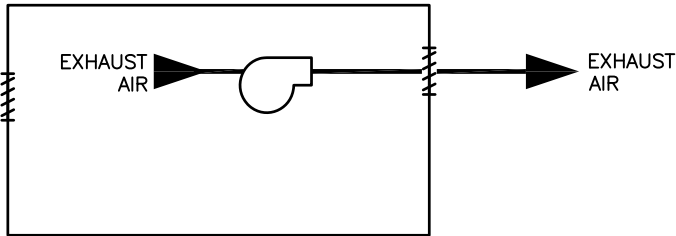

ROOM NAME	EQUIP ID
P25 UTILITY ROOM #1	EF-1
P26 UTILITY ROOM #2	EF-2
P32 UTILITY ROOM #5	EF-7
P31 UTILITY ROOM #6	EF-8
P03 UTILITY ROOM #7	EF-9
P04 UTILITY ROOM #8	EF-10
C22 TRASH	EF-12
C04 JANITOR CLOSET	EF-14
C32 WOMEN	EF-18
C33 MEN	EF-19
C34 TREASURY VAULT	EF-20
C35 STORAGE ROOM	EF-21
A05 JANITOR CLOSET	EF-23
A07 EMERG. GENERATOR RM.	EF-25
A08 FUEL TANK ROOM	EF-26

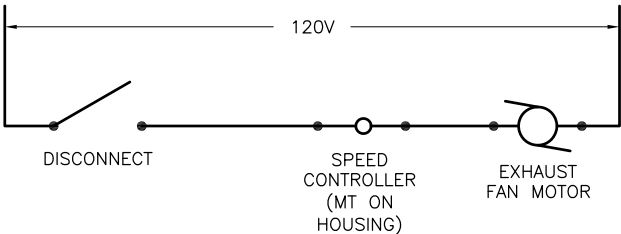

SEQUENCE OF OPERATION

FAN SHALL RUN CONTINUOUSLY

EXHAUST FAN EF-x FLOW AND WIRING DETAILS

Santa Clara Valley Transportation Authority

NO EXCEPTIONS TAKEN (NET)
 MAKE CORRECTIONS NOTED (MCN)
 AMEND AND RESUBMIT (A/R)


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DESIGNED BY J. CHOU
DRAWN BY J. CHOU
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IN CHARGE G. HENNINGS
DATE 20130710



BLOCK Construction Inc. 4455 Enterprise St., Fremont, CA 94538 (510) 857-9888 Fax: (510) 857-9889 CA Lic. #679326 email: info@blockco.com	H&M Mechanical Group 8517 Easthart Rd. #230 Oakland, CA 94621 510-569-2000
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Skanska Shimmick Herzog 1436 California Circle Milpitas, California 95035 A Joint Venture	Lookwood, Andrews & Newnam, Inc. A LEOP A BULLY COMPANY T-Y-LIN INTERNATIONAL
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SUBMITTED 	APPROVED
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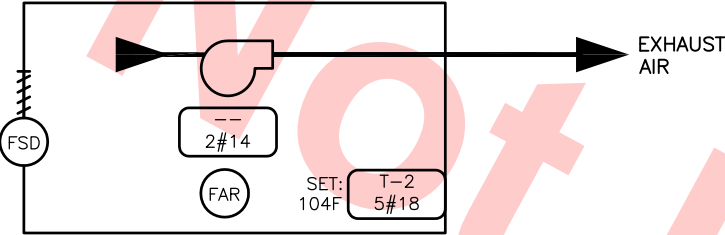
LINE, TRACK, STATIONS AND SYSTEMS DESIGN UNIT 023 MILPITAS STATION HVAC CONTROLS	SHEET 1 OF 11
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AREA CODE DB	SHEET NO. M370
	PAGE NO. 0728


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BILL OF MATERIALS

ITEM	QTY	CODE NO.	DESCRIPTION	MANUFACTURER
T-2	3	T26S-16C	THERMOSTAT, LINE VOLTAGE, SPDT	JOHNSON CONTROLS

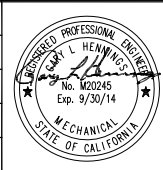

ROOM NAME	EQUIP ID	SET POINT
P15 MECH RM COMP #1	EF-3	104
P16 MECH RM COMP #2	EF-4	104

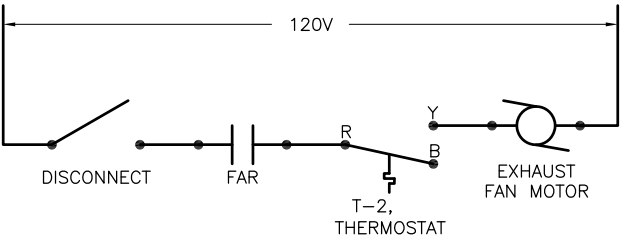


SEQUENCE OF OPERATION

THE EXHAUST FAN WILL START WHEN THE ROOM TEMPERATURE EXCEEDS THE THERMOSTAT SETPOINT. UPON A FIRE ALARM SIGNAL ALL FIRE/SMOKE DAMPERS WILL CLOSE AND THE FAN WILL SHUTDOWN.


EXHAUST FAN EF-x FLOW AND WIRING DETAILS

BILL OF MATERIALS

ITEM	QTY	CODE NO.	DESCRIPTION	MANUFACTURER
DPS-1	2	P32AC-2C	DIFFERENTIAL PRESSURE SWITCH SPDT	JOHNSON CONTROLS
R-1	2	RB2401D	CONTROL RELAY IN A BOX, 120 VAC, DPDT	FUNCTIONAL DEVICES

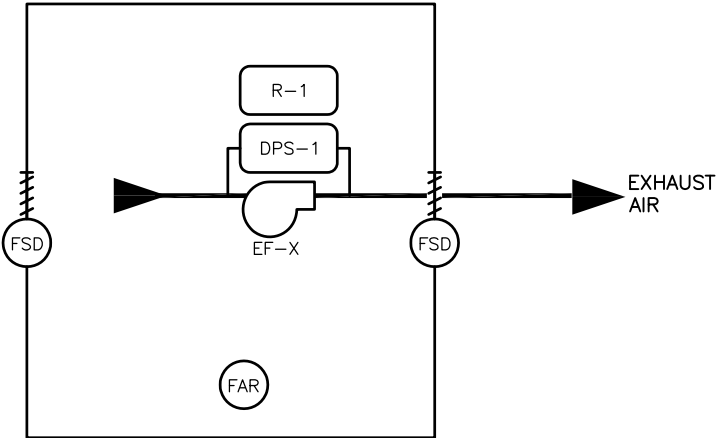

ROOM NAME	EQUIP ID
C17 TC/C BATTERY ROOM	EF-11
C13 TC/C BATTERY ROOM	EF-16

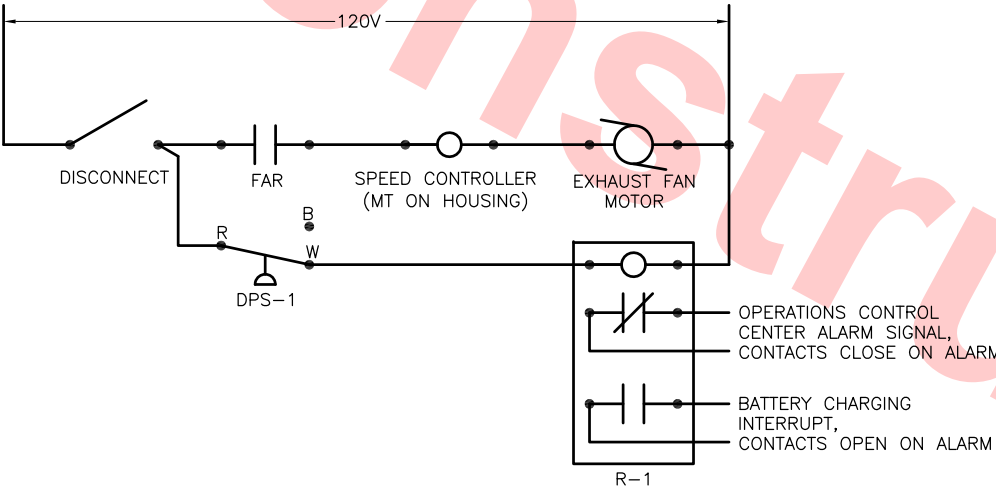


SEQUENCE OF OPERATION

FAN SHALL RUN CONTINUOUSLY. AIR FLOW SHALL BE MONITORED FOR POSITIVE PRESSURE. IF AIR FLOW IS LOST, A SIGNAL SHALL BE SENT TO PERMANENTLY MONITORED LOCATION (OPERATION CONTROL CENTER) AND SHALL INTERRUPT BATTERY CHARGING. ACTIVATION OF FIRE ALARM SHALL CLOSE ALL FIRE SMOKE DAMPERS AND FAN SHALL STOP.


EXHAUST FAN EF-x FLOW AND WIRING DETAILS

BILL OF MATERIALS

ITEM	QTY	DESCRIPTION	MANUFACTURER
LS-1	6	LIGHT SWITCH	BY OTHERS

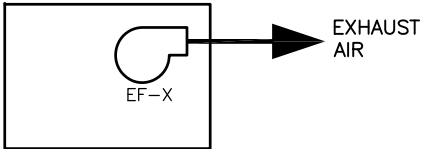

ROOM NAME	EQUIP ID	SPEED CONTROLLER
C26 LOCKER ROOM	EF-13	-
C27 RESTROOM	EF-15	-
A04 MEN	EF-22	YES
A06 WOMEN	EF-24	YES

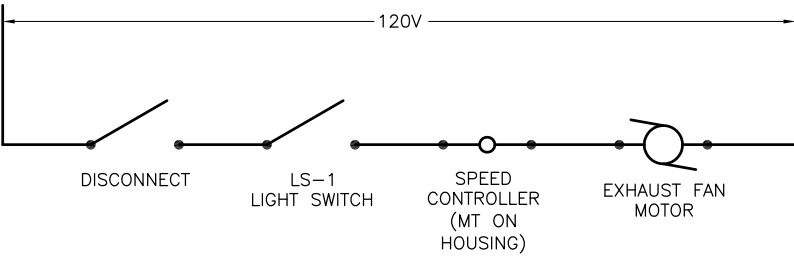

SEQUENCE OF OPERATION

FAN SHALL START/STOP BY LIGHT SWITCH

EXHAUST FAN EF-x FLOW AND WIRING DETAILS

Santa Clara Valley Transportation Authority



NO EXCEPTIONS TAKEN (NET)
 MAKE CORRECTIONS NOTED (MCN)
 AMEND AND RESUBMIT (A/R)

Any action shown above is subject to the terms of the contract and does not relieve the Contractor of any of its obligations under the contract, including design and detailing.

Contract No.: DB11002F

By: Date:

REV	DATE	BY	SUB	APP	DESCRIPTION
0	20130710				READINESS FOR CONSTRUCTION

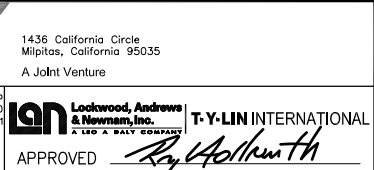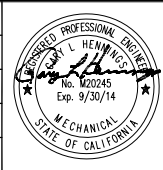



LINE, TRACK, STATIONS AND SYSTEMS				CADD FILENAME C700-S-DB-M371.dwg	
DESIGN UNIT 023				SIZE SCALE D NONE	
MILPITAS STATION				CONTRACT NO. C700	
HVAC CONTROLS				REV. 0	
SHEET 2 OF 11				AREA CODE DB	
				SHEET NO. M371	
				PAGE NO. 0729	

NO EXCEPTIONS TAKEN (NET)
MAKE CORRECTIONS NOTED (MCN)
AMEND AND RESUBMIT (A/R)

Any action shown above is subject to the terms of the contract and does not relieve the Contractor of any of its obligations under the contract, including design and detailing.

Contract No.: DB11002F



By: Date:

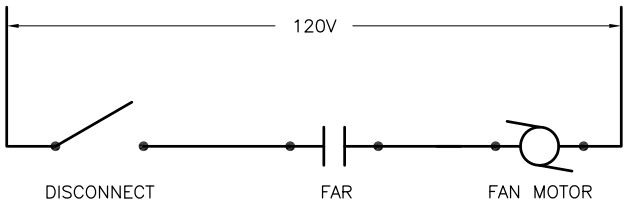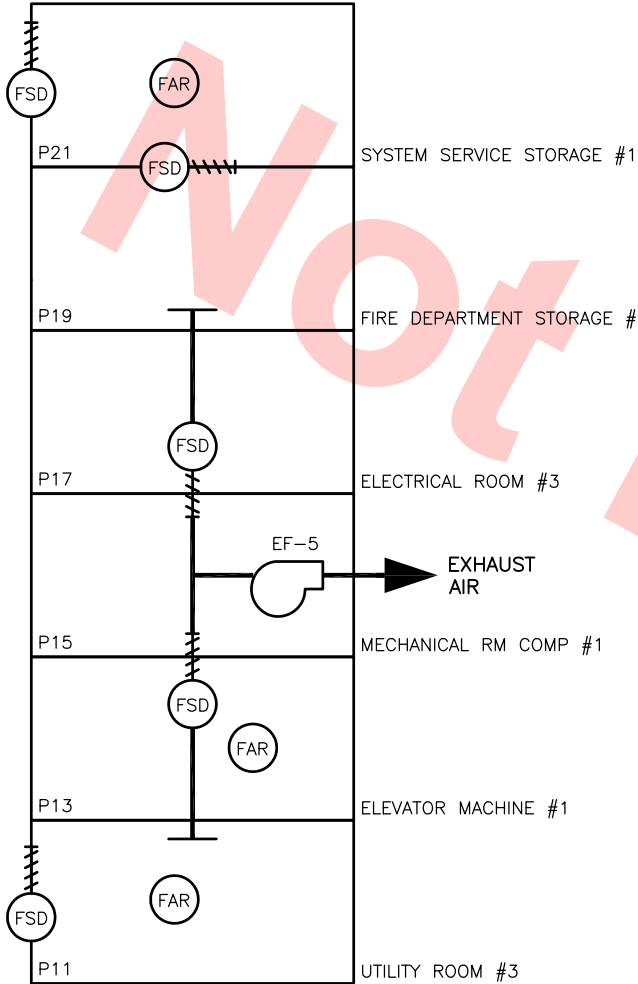

SEQUENCE OF OPERATION

FAN SHALL RUN CONTINUOUSLY, UPON A FIRE ALARM SIGNAL ALL FIRE/SMOKE DAMPERS WILL CLOSE AND THE FAN WILL SHUT DOWN.



EXHAUST FAN EF-5 FLOW AND WIRING DETAILS

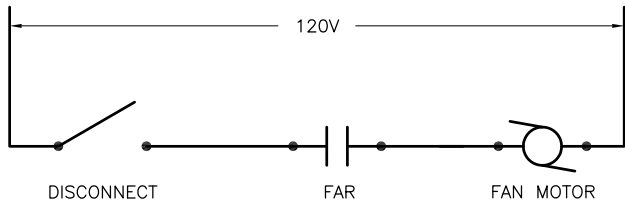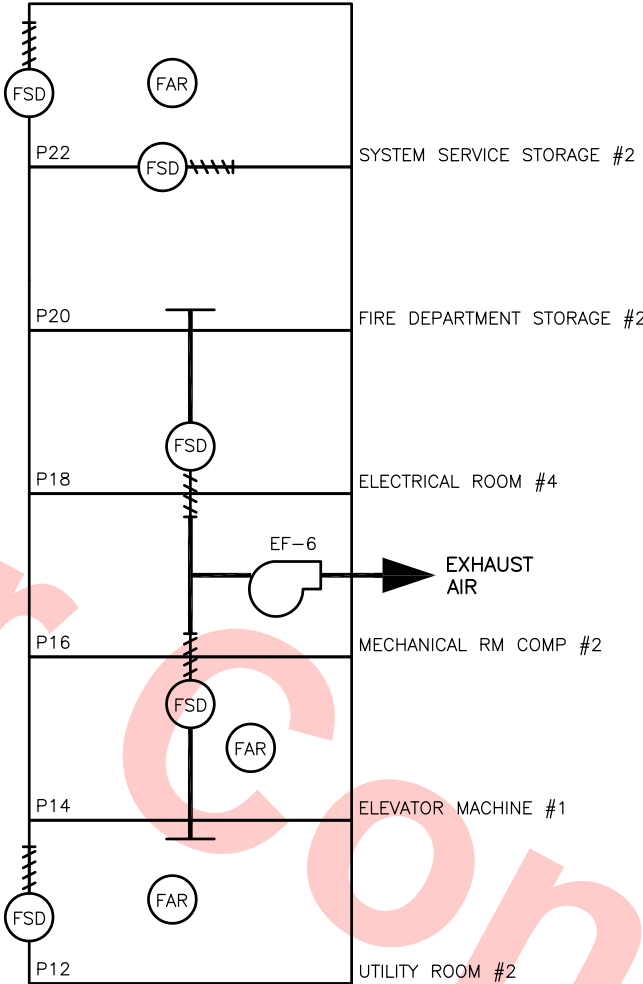

SEQUENCE OF OPERATION

FAN SHALL RUN CONTINUOUSLY, UPON A FIRE ALARM SIGNAL ALL FIRE/SMOKE DAMPERS WILL CLOSE AND THE FAN WILL SHUT DOWN.

EXHAUST FAN EF-6 FLOW AND WIRING DETAILS

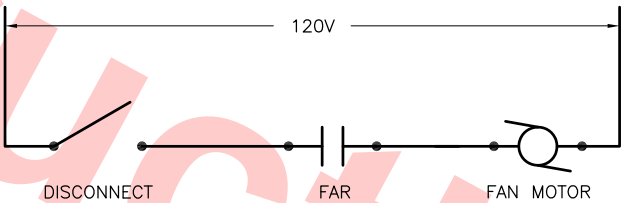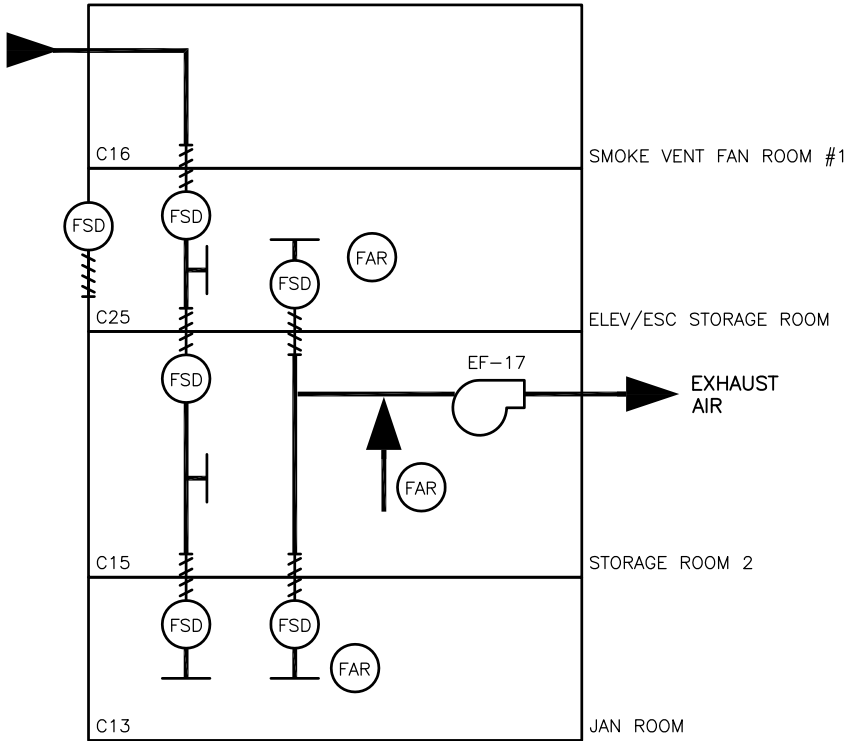

SEQUENCE OF OPERATION

FAN SHALL RUN CONTINUOUSLY, UPON A FIRE ALARM SIGNAL ALL FIRE/SMOKE DAMPERS WILL CLOSE AND THE FAN WILL SHUT DOWN.

EXHAUST FAN EF-17 FLOW AND WIRING DETAILS

DESIGNED BY	J. CHOU
DRAWN BY	J. CHOU
CHECKED BY	G. HENNINGS
IN CHARGE	G. HENNINGS
DATE	20130710

REV	DATE	BY	SUB	APP	DESCRIPTION
0	20130710				READINESS FOR CONSTRUCTION



Skanska Shimmick Herzog	1436 California Circle Milpitas, California 95035 A Joint Venture
Block Construction Inc. 4455 Enterprise St., Fremont, CA 94538 (510) 657-3666 Fax: (510) 657-3669 CA Lic. #679326 email: info@blockco.com	HMM Mechanical Group 8517 Eastlark Rd, #230 Oakland, CA 94621 510-569-2000
Lookwood, Andrews & Newnam, Inc. A LEO A DALY COMPANY	T-Y LIN INTERNATIONAL
SUBMITTED	APPROVED





LINE, TRACK, STATIONS AND SYSTEMS
DESIGN UNIT 023
MILPITAS STATION
HVAC CONTROLS
SHEET 3 OF 11

CADD FILENAME		
C700-S-DB-M372.dwg		
SIZE	SCALE	
D	NONE	
CONTRACT NO.		REV.
C700		0
AREA CODE	SHEET NO.	PAGE NO.
DB	M372	0730

BILL OF MATERIALS

ITEM	QTY	DESCRIPTION	MANUFACTURER
T-3	14	THERMOSTAT (CONTROLLER)	C/W ACU

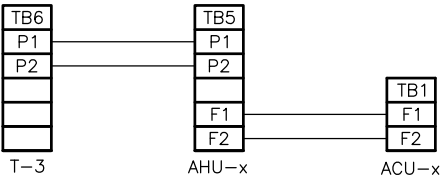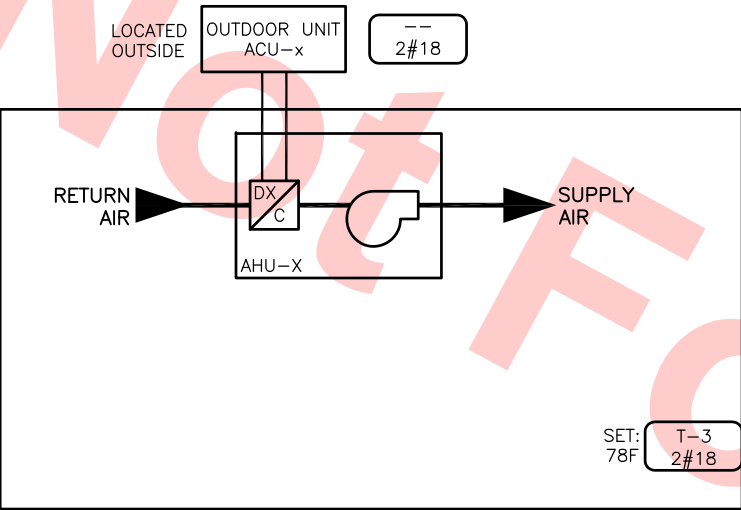

SEQUENCE OF OPERATION


THE ROOM THERMOSTAT WILL CONTROL THE AIR CONDITIONING UNIT AND CONDENSING UNIT TO MAINTAIN THE ROOM COOLING TEMPERATURE SETPOINT.

AIR HANDLER UNIT AHU-x. CONDENSING UNIT ACU-x FLOW AND WIRING DIAGRAMS

ROOM NAME	EQUIP ID
P23 ESCALATOR RM #1	AHU/ACU-1
P24 ESCALATOR RM #2	AHU/ACU-2
P13 ELEVATOR MACHINE #1	AHU/ACU-3
P14 ELEVATOR MACHINE #2	AHU/ACU-4
P07 ESCALATOR ROOM #3	AHU/ACU-7
P08 ESCALATOR ROOM #4	AHU/ACU-8
C10 MAINT ENGR OFFICE	AHU/ACU-14
C08 POLICE ROOM	AHU/ACU-15
C36 EMP ROOM	AHU/ACU-16
C37 COMM TERM ROOM #1	AHU/ACU-17
C38 LOST & FOUND	AHU/ACU-18
C07 COMM ROOM	AHU/ACU-20
POC 2 POC ESCALATOR CONTROL	AHU/ACU-21
POC 3 POC ELAVATOR MACHINE ROOM	AHU/ACU-22

BILL OF MATERIALS



ITEM	QTY	DESCRIPTION	MANUFACTURER
T-3	2	THERMOSTAT (CONTROLLER)	C/W ACU

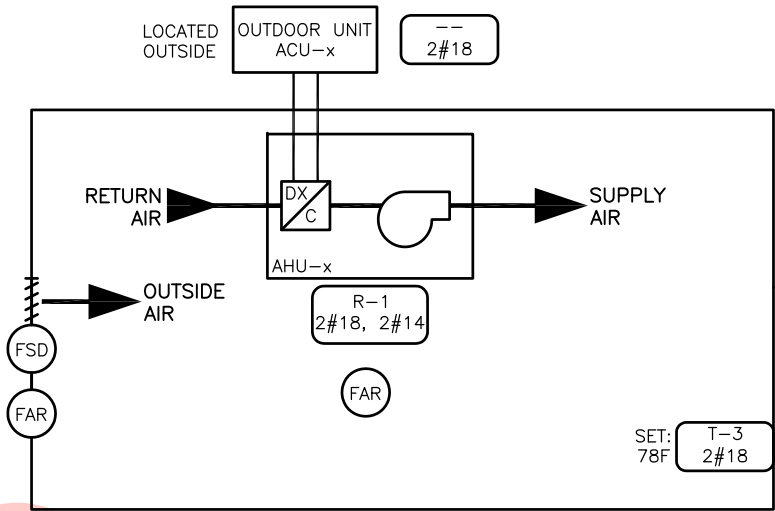

AIR HANDLER UNIT AHU-x. CONDENSING UNIT ACU-x FLOW AND WIRING DIAGRAMS

BILL OF MATERIALS

ITEM	QTY	DESCRIPTION	MANUFACTURER
T-3	3	THERMOSTAT (CONTROLLER)	C/W ACU

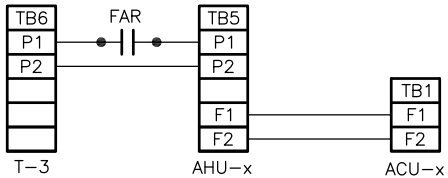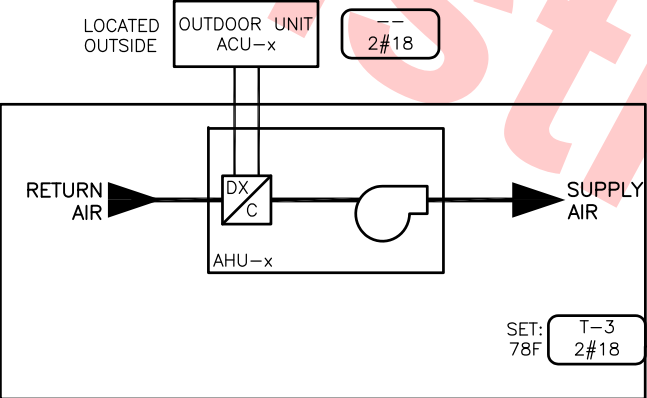

ROOM NAME	EQUIP ID
P09 COMM TERM RM #3	AHU/ACU-5
P10 COMM TERM RM #2	AHU/ACU-6

SEQUENCE OF OPERATION

THE ROOM THERMOSTAT WILL CONTROL THE AIR CONDITIONING UNIT AND CONDENSING UNIT TO MAINTAIN THE ROOM TEMPERATURE SETPOINT. UPON A FIRE ALARM SIGNAL ALL FIRE/SMOKE DAMPERS WILL CLOSE AND THE FAN WILL SHUTDOWN.


Santa Clara Valley Transportation Authority

- NO EXCEPTIONS TAKEN (NET)
- MAKE CORRECTIONS NOTED (MCN)
- AMEND AND RESUBMIT (A/R)

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Contract No.: DB11002F

By: Date:

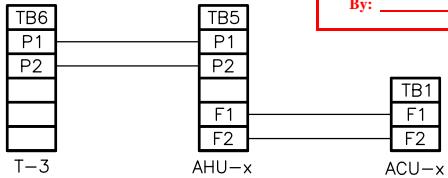


ROOM NAME	EQUIP ID
C19 GROUDS MAINT OFFICE	AHU/ACU-9
C14 TELCO RM	AHU/ACU-13
COX STATION AGENTS BOOTH	AHU/ACU-19

SEQUENCE OF OPERATION

THE ROOM THERMOSTAT WILL CONTROL THE AIR CONDITIONING UNIT AND CONDENSING UNIT TO MAINTAIN THE ROOM COOLING AND HEATING TEMPERATURE SETPOINTS.

AIR HANDLER UNIT AHU-x. CONDENSING UNIT ACU-x FLOW AND WIRING DIAGRAMS

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BILL OF MATERIALS

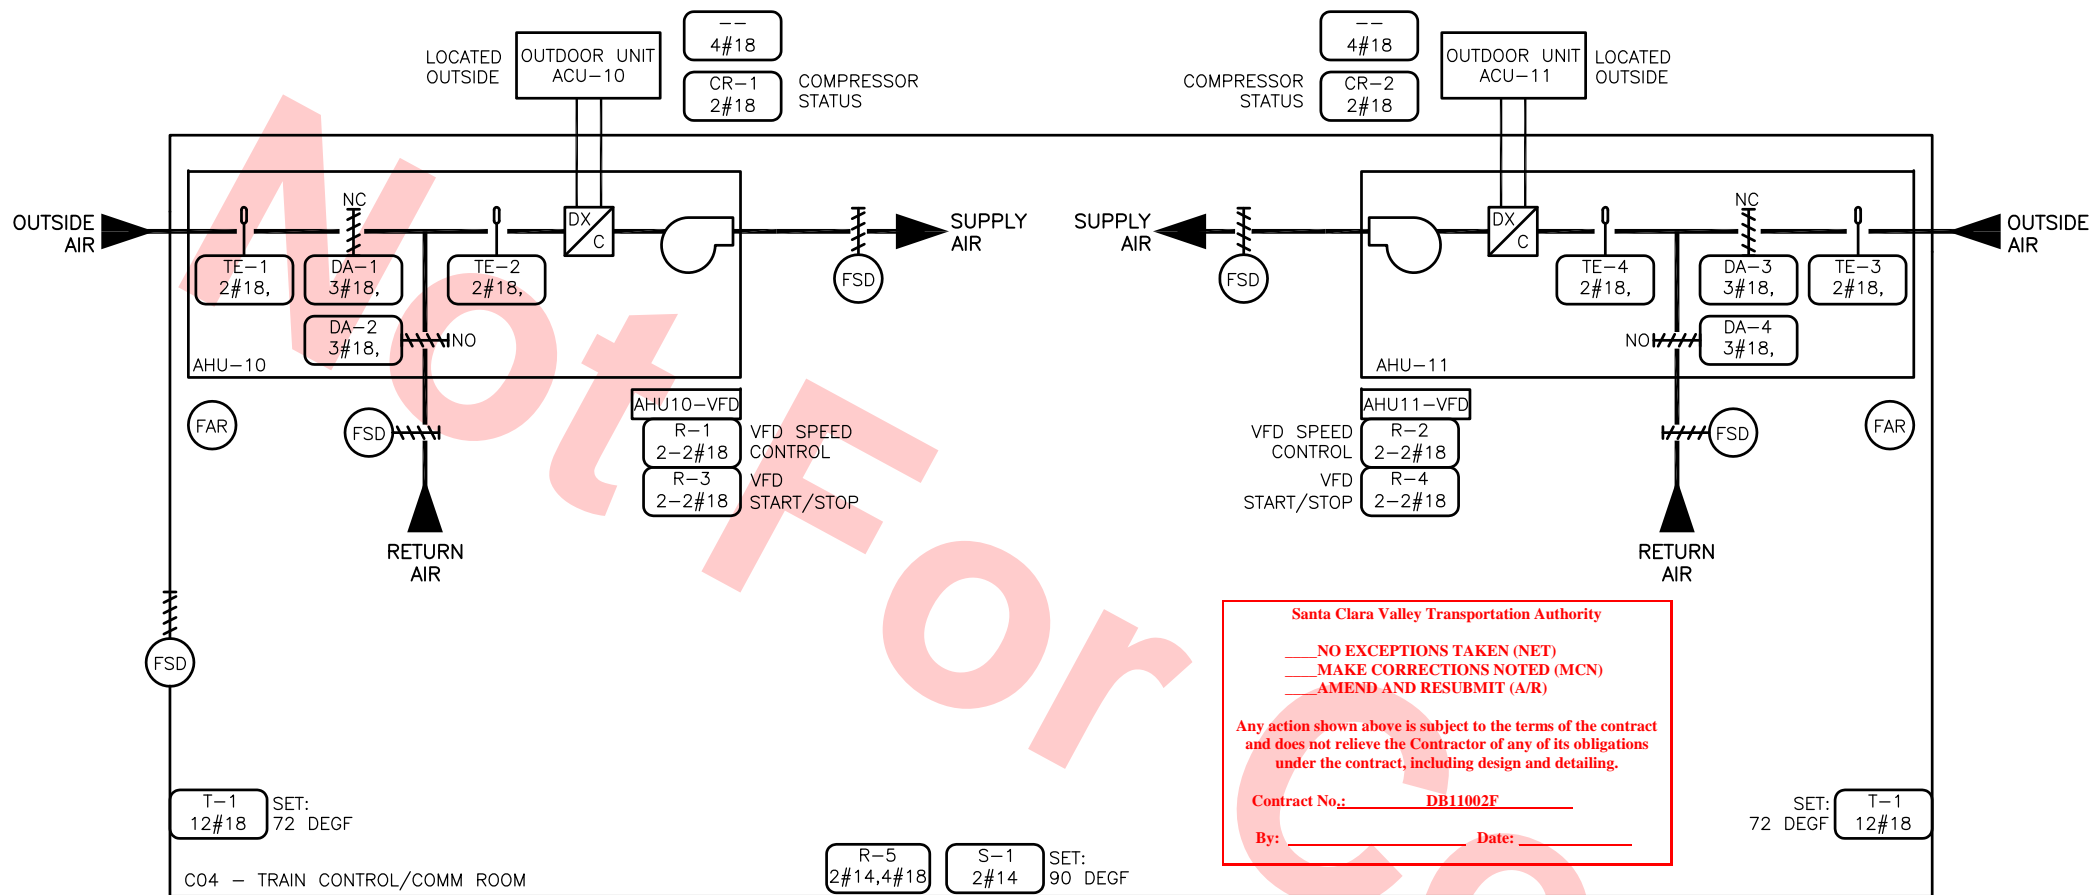ITEM	QTY	CODE NO.	DESCRIPTION	MANUFACTURER
CR-1,2	2	H908	CURRENT SENSING RELAY, SPST	VERIS
DA-1 TO 4	4	M9208-GGA-2	DAMPER ACTUATOR, 0/10 VDC, SPRING	JOHNSON CONTROLS
R-1, 2	2	RH2B-ULDC24V	CONTROL RELAY, 24 VDC, 2PDT, LIGHT	IDEC
R-1, 2	2	SH2B-05	CONTROL RELAY BASE, 2PDT	IDEC
R-3, 4	2	RH2B-ULDC24V	CONTROL RELAY, 24 VAC, 2PDT, LIGHT	IDEC
R-3, 4	2	SH2B-05	CONTROL RELAY BASE, 2PDT	IDEC
R-5	1	RIB2401D	CONTROL RELAY IN A BOX, 120 VAC, DPDT	FUNCTIONAL DEVICES
S-1	1	T26S-18C	LINE VOLTAGE TEMPERATURE SWITCH, SPDT	JOHNSON CONTROLS
S-1	1	PLT333-3R	BLANK VERTICAL FACEPLATE	JOHNSON CONTROLS
T-1	2	T600MEP-4	PROGRAMMABLE THERMOSTAT, ECONOMIZER	JOHNSON CONTROLS
TE-1 TO 4	4	TE-6361M-1	TEMPERATURE SENSOR, DUCT	JOHNSON CONTROLS


VARIABLE FREQUENCY DRIVE (VFD) SCHEDULE

ITEM	VFD MANUFACTURER	VFD MODEL NO.	NEMA RATING	CFM	HP	VOLT	PHASE	HERTZ
AHU10-VFD	JOHNSON CONTROL	VS005432A	NEMA 3R	4,400	5	460	3	60
AHU11-VFD	JOHNSON CONTROL	VS005432A	NEMA 3R	4,400	5	460	3	60


SEQUENCE OF OPERATION

DURING THE OCCUPIED MODE WHEN THE ZONE TEMPERATURE IS BELOW SETPOINT, THE ECONOMIZER DAMPERS SHALL MODULATE TOWARDS THE MINIMUM OUTSIDE AIR POSITION. DURING THE OCCUPIED MODE WHEN THE ZONE TEMPERATURE IS ABOVE SETPOINT, THE ECONOMIZER DAMPERS SHALL MODULATE OPEN IF FREE COOLING IS AVAILABLE AND THE FAN SPEED SHALL INCREASE TO MAXIMUM CFM RATING. IF THE ZONE TEMPERATURE REMAINS ABOVE SET POINT, THE DX COOLING SYSTEM SHALL BE ENABLED. WHEN THE DX COOLING SYSTEM IS ACTIVE, THE SUPPLY FAN VFD WILL BE SET TO THE REDUCED CFM RATING. THE FM200 SYSTEM SHALL SHUTDOWN THE AIR HANDLING UNIT AND CLOSE THE FIRE/SMOKE DAMPERS UPON DETECTION OF SMOKE IN THE ROOM.


WHEN ROOM TEMPERATURE EXCEEDS 90°F A SIGNAL SHALL BE SENT TO INDICATE A HIGH TEMPERATURE ALARM AT THE STATION AGENT'S BOOTH AND OF THE OPERATIONS CONTROL CENTER.

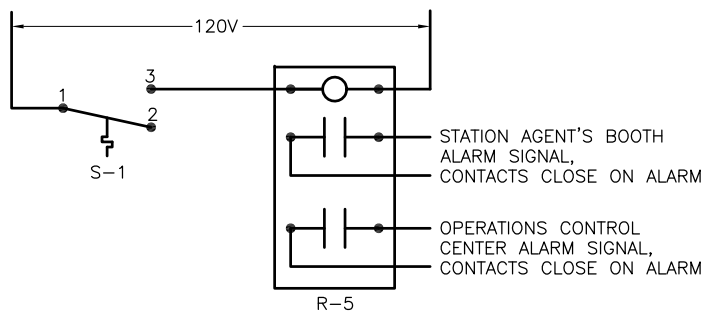

HIGH ROOM TEMPERATURE ALARM WIRING

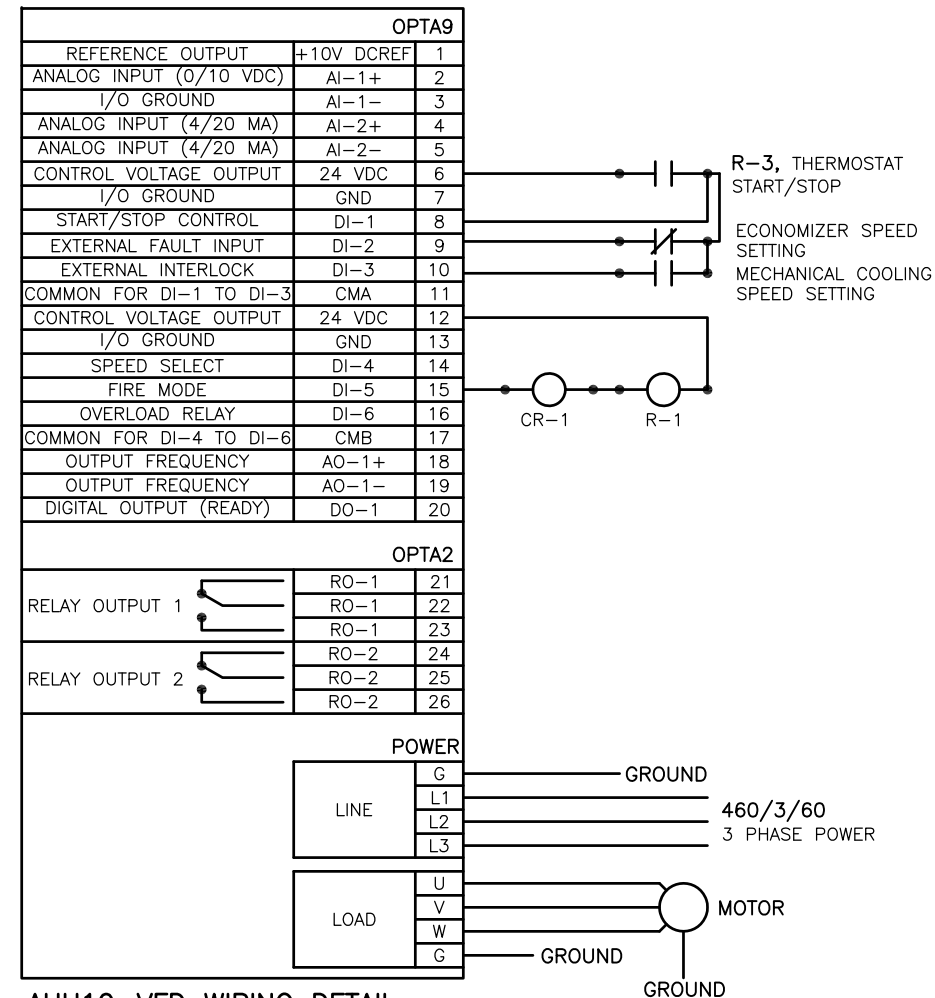

AHU10-VFD WIRING DETAIL
(TYPICAL OF AHU11-VFD)

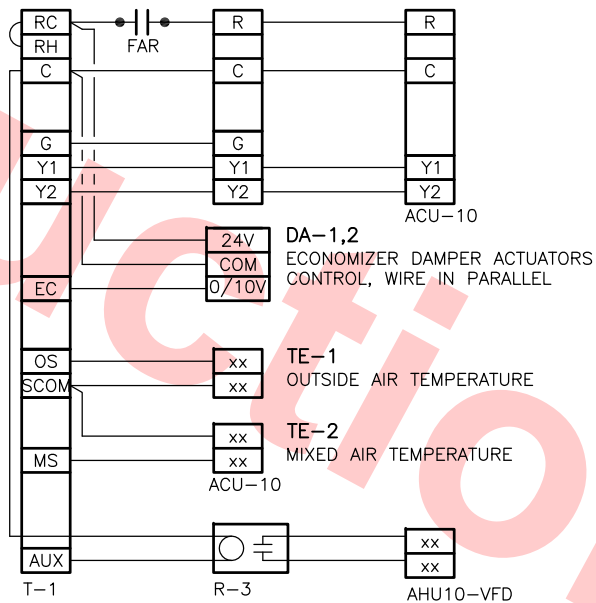

AHU-10 AND ACU-10 WIRING DETAIL
(TYPICAL OF AHU-11 AND ACU-11)

DESIGNED BY J. CHOU	0	20130710	BY	DATE	0	20130710	APP	DATE
DRAWN BY J. CHOU	0	20130710	BY	DATE	0	20130710	APP	DATE
CHECKED BY G. HENNINGS	0	20130710	BY	DATE	0	20130710	APP	DATE
IN CHARGE G. HENNINGS	0	20130710	BY	DATE	0	20130710	APP	DATE
DATE 20130710	0	20130710	BY	DATE	0	20130710	APP	DATE




Skanska Shimmick Herzog	1436 California Circle Milpitas, California 95035 A Joint Venture
Block Construction Inc. 4455 Enterprise St., Fremont, CA 94538 (510) 457-3888 Fax: (510) 857-3889 CA Lic. #679326 email: info@blockco.com	HMM Mechanical Group 8517 East Rd. #230 Oakland, CA 94621 510-569-2000
Lookwood, Andrews & Newman, Inc. A LEA A BALLY COMPANY	T-Y-LIN INTERNATIONAL

1436 California Circle Milpitas, California 95035 A Joint Venture	Lookwood, Andrews & Newman, Inc. A LEA A BALLY COMPANY	T-Y-LIN INTERNATIONAL
APPROVED	APPROVED	APPROVED



LINE, TRACK, STATIONS AND SYSTEMS DESIGN UNIT 023 MILPITAS STATION HVAC CONTROLS	CADD FILENAME C700-S-DB-M374.dwg
SHEET 5 OF 11	CONTRACT NO. C700
	REV. 0
	AREA CODE DB
	SHEET NO. M374
	PAGE NO. 0732

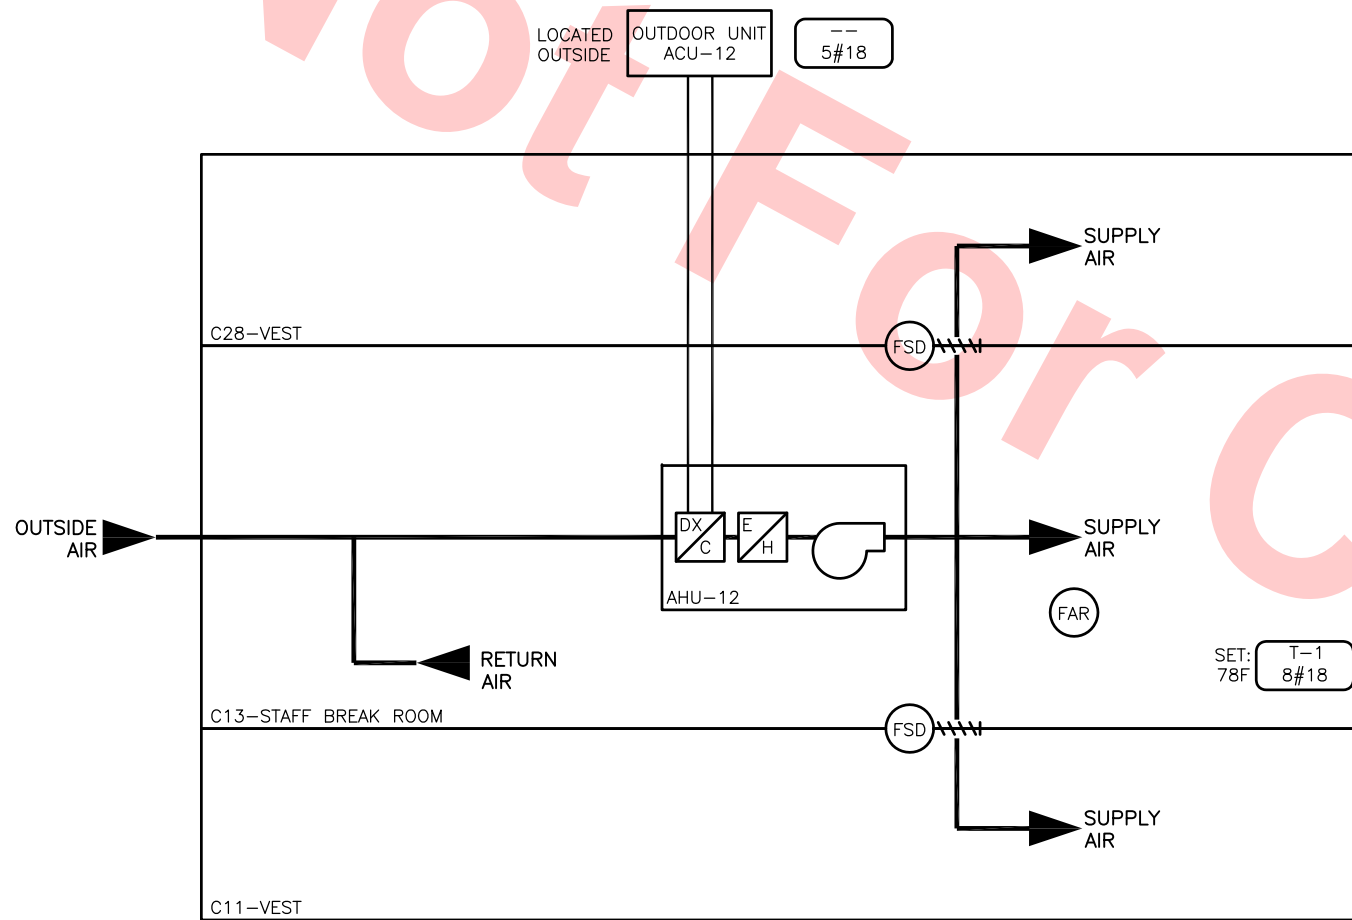


BILL OF MATERIALS

ITEM	QTY	CODE NO.	DESCRIPTION	MANUFACTURER
T-1	1	---	PROGRAMMABLE THERMOSTAT	C/W ACU

SEQUENCE OF OPERATION

THE ROOM THERMOSTATS WILL CONTROL THE AIR CONDITIONING UNIT AND CONDENSING UNIT TO MAINTAIN THE ROOM TEMPERATURE SETPOINT. THE AHU WILL OPERATE CONTINUOUSLY DURING OCCUPATION HOURS. UPON A FIRE ALARM SIGNAL ALL FIRE/SMOKE DAMPERS WILL CLOSE AND THE FAN WILL SHUTDOWN.

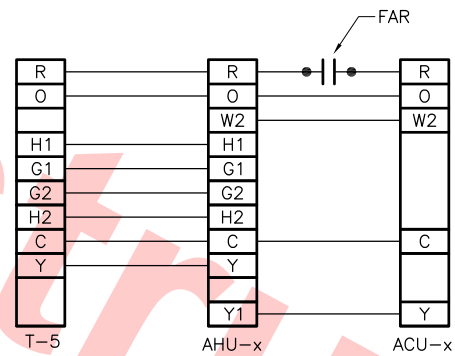

AIR CONDITIONING UNIT AHU-12, CONDENSING UNIT ACU-12 WIRING DIAGRAMS

Santa Clara Valley Transportation Authority

- NO EXCEPTIONS TAKEN (NET)
- MAKE CORRECTIONS NOTED (MCN)
- AMEND AND RESUBMIT (A/R)

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Contract No.: DB11002F

By: _____ Date: _____

DESIGNED BY	J. CHOU
DRAWN BY	J. CHOU
CHECKED BY	G. HENNINGS
IN CHARGE	G. HENNINGS
DATE	20130710

REV	DATE	BY	SUB	APP	DESCRIPTION
0	20130710				READINESS FOR CONSTRUCTION



Skanska Shimmick Herzog	1436 California Circle Milpitas, California 95035 A Joint Venture
Block Construction Inc. 4455 Enterprise St., Fremont, CA 94538 (510) 457-3888 Fax: (510) 857-3889 CA Lic. #679326 email: info@blockco.com	HMM Mechanical Group 8517 Earhart Rd. #230 Oakland, CA 94621 510-569-2000
Lookwood, Andrews & Newnam, Inc. A LEQ A DAILY COMPANY	T-Y-LIN INTERNATIONAL
SUBMITTED	APPROVED





LINE, TRACK, STATIONS AND SYSTEMS
DESIGN UNIT 023
MILPITAS STATION
HVAC CONTROLS
SHEET 6 OF 11

CADD FILENAME	C700-S-DB-M375.dwg
SIZE	SCALE
D	NONE
CONTRACT NO.	C700
REV.	0
AREA CODE	DB
SHEET NO.	M375
PAGE NO.	0733

BILL OF MATERIALS

ITEM	QTY	CODE NO.	DESCRIPTION	MANUFACTURER
T-2	4	T26S-16C	THERMOSTAT, LINE VOLTAGE, SPDT	JOHNSON CONTROLS

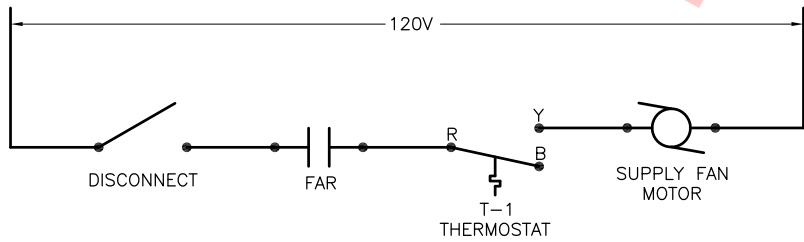
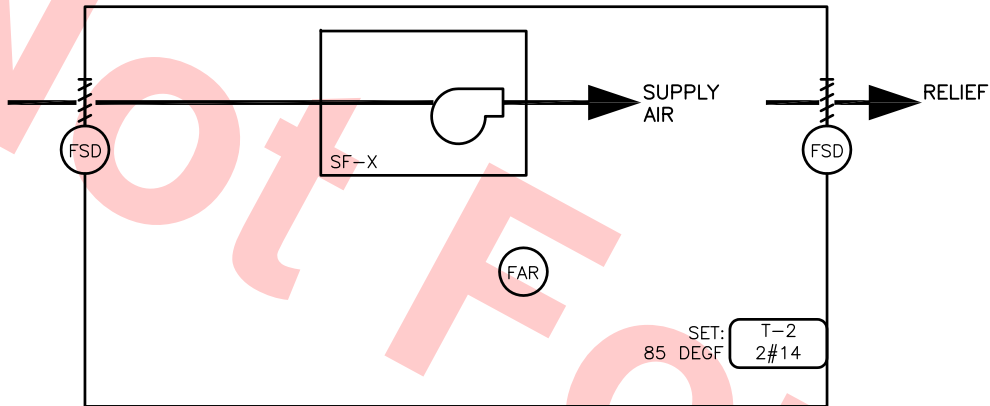


ROOM NAME	EQUIP ID
P17 ELECTRIC ROOM #3	SF-1
P18 ELECTRIC ROOM #4	SF-2
C24 ELECTRIC ROOM #2	SF-3
C06 ELECTRIC ROOM #1	SF-7

SEQUENCE OF OPERATION

FAN SHALL RUN WHEN TEMPERATURE EXCEEDS SETPOINT. ACTIVATION OF FIRE ALARM SHALL CLOSE FIRE SMOKE DAMPER(S) AND STOP FAN.

SUPPLY FAN SF-x FLOW AND WIRING DETAILS

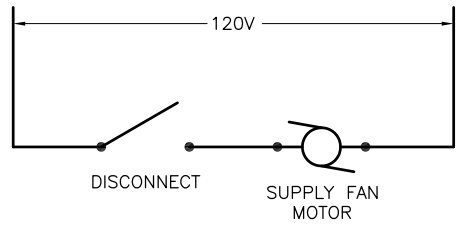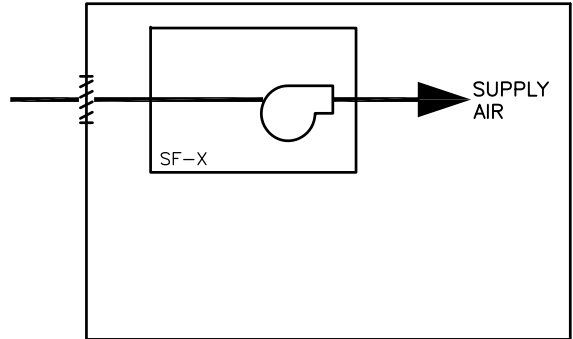

ROOM NAME	EQUIP ID
C10 MAINT ENGR OFFICE	SF-4
C08 POLICE ROOM	SF-5
C58 LOST & FOUND	SF-6

SEQUENCE OF OPERATION

FAN SHALL RUN CONTINUOUSLY

SUPPLY FAN SF-x FLOW AND WIRING DETAILS

Santa Clara Valley Transportation Authority

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___AMEND AND RESUBMIT (A/R)

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By: _____ Date: _____

DESIGNED BY J. CHOU	
DRAWN BY J. CHOU	
CHECKED BY G. HENNINGS	
IN CHARGE G. HENNINGS	
DATE 20130710	









Block Construction Inc.	HMM Mechanical Group
4455 Enterprise St., Fremont, CA 94538	8517 Eastport Rd. #230
(510) 457-3888 Fax: (510) 857-3889	Oakland, CA 94621
CA Lic. #679326 email: info@blockco.com	510-569-2000

1436 California Circle Milpitas, California 95035 A Joint Venture	Lookwood, Andrews & Newman, Inc. A LEOP A BALLY COMPANY	T-Y-LIN INTERNATIONAL
APPROVED		



LINE, TRACK, STATIONS AND SYSTEMS DESIGN UNIT 023 MILPITAS STATION HVAC CONTROLS	CADD FILENAME C700-S-DB-M376.dwg
	SIZE D SCALE NONE
	CONTRACT NO. C700 REV. 0
	AREA CODE DB SHEET NO. M376 PAGE NO. 0734

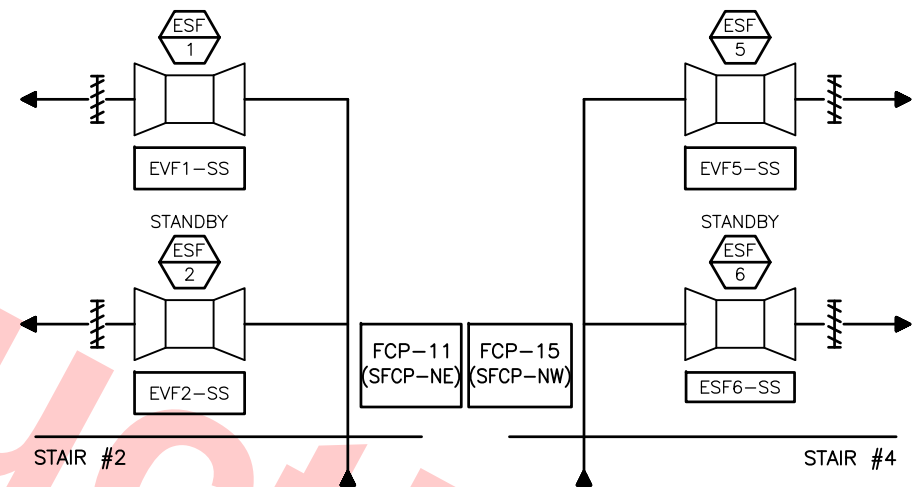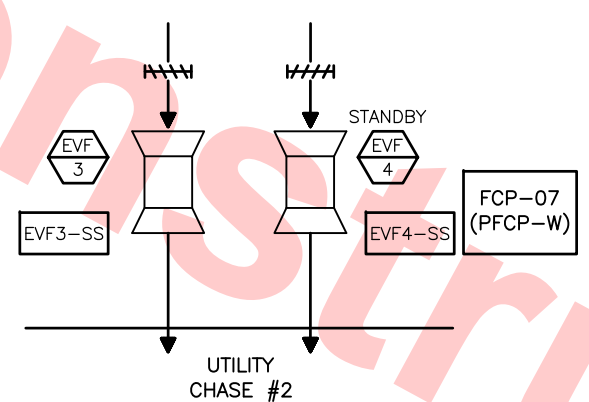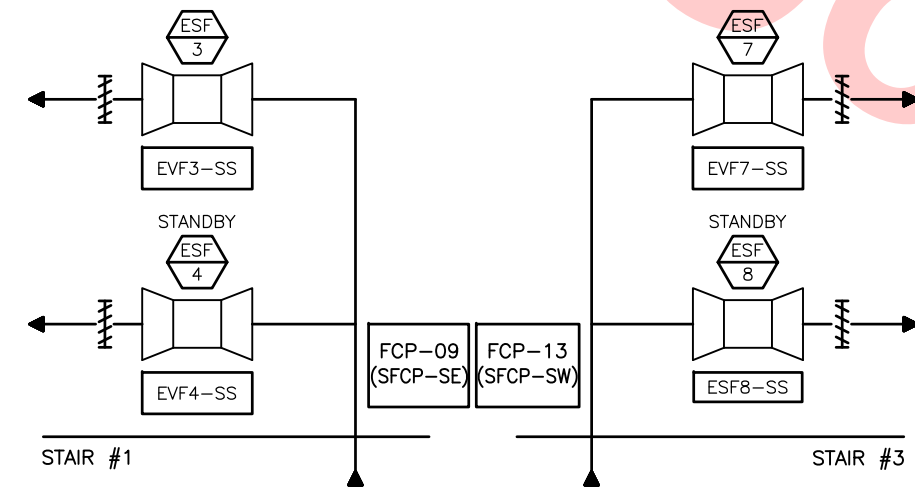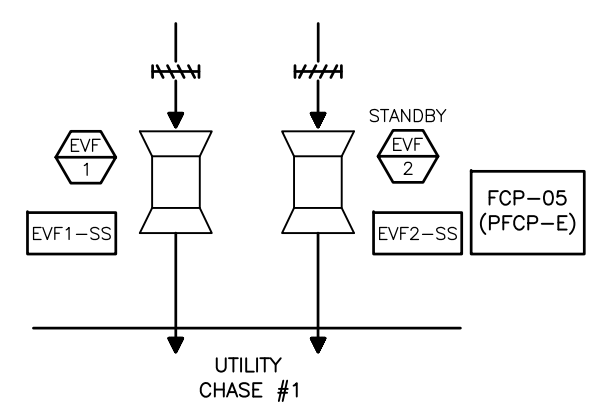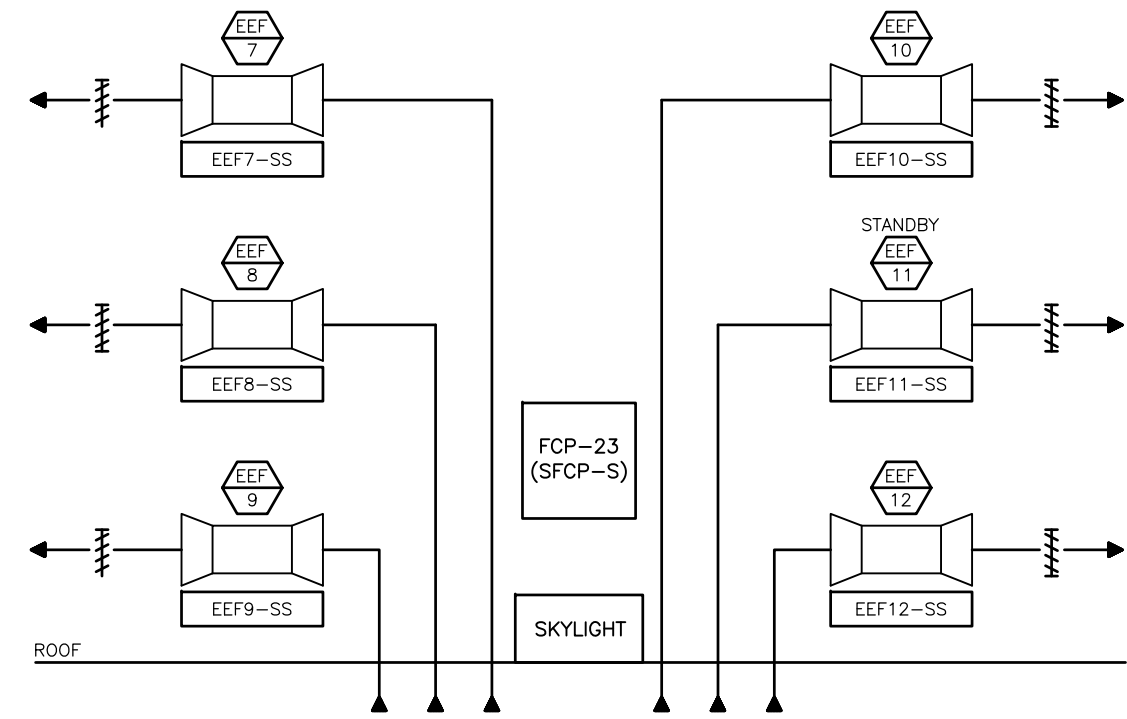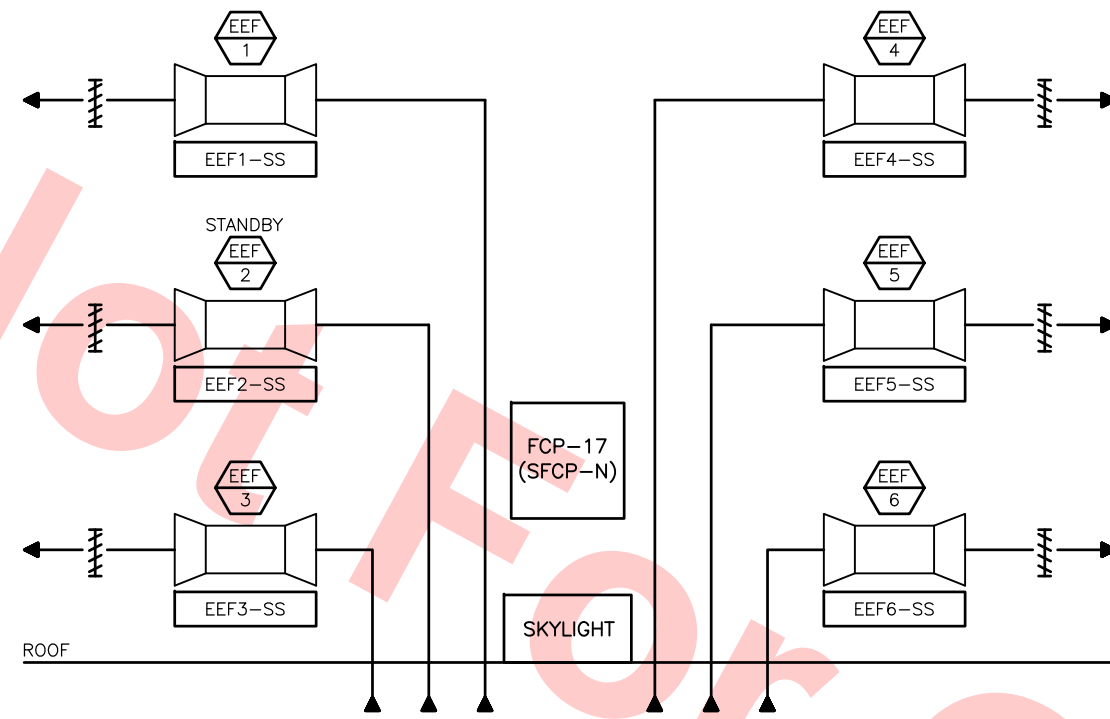

Santa Clara Valley Transportation Authority

___ NO EXCEPTIONS TAKEN (NET)
 ___ MAKE CORRECTIONS NOTED (MCN)
 ___ AMEND AND RESUBMIT (A/R)


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Contract No.: DB11002F

By: _____ Date: _____

DESIGNED BY	J. CHOU
DRAWN BY	J. CHOU
CHECKED BY	G. HENNINGS
IN CHARGE	G. HENNINGS
DATE	20130710

REV	DATE	BY	SUB	APP	DESCRIPTION
0	20130710				READINESS FOR CONSTRUCTION

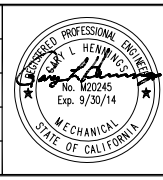

Skanska Shimmick Herzog

1436 California Circle
 Milpitas, California 95035
 A Joint Venture

HMM Mechanical Group

8517 Eastport Rd. #230
 Oakland, CA 94621
 510-569-2000

Lookwood, Andrews & Newman, Inc.

A LEOP A BALLY COMPANY

T-Y LIN INTERNATIONAL

BART SILICON VALLEY BERRYESSA EXTENSION

LINE, TRACK, STATIONS AND SYSTEMS


DESIGN UNIT 023

MILPITAS STATION

HVAC CONTROLS


PAGE 8 OF 11

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SIZE	D
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CONTRACT NO.	C700
REV.	0
AREA CODE	DB
SHEET NO.	M377
PAGE NO.	0735

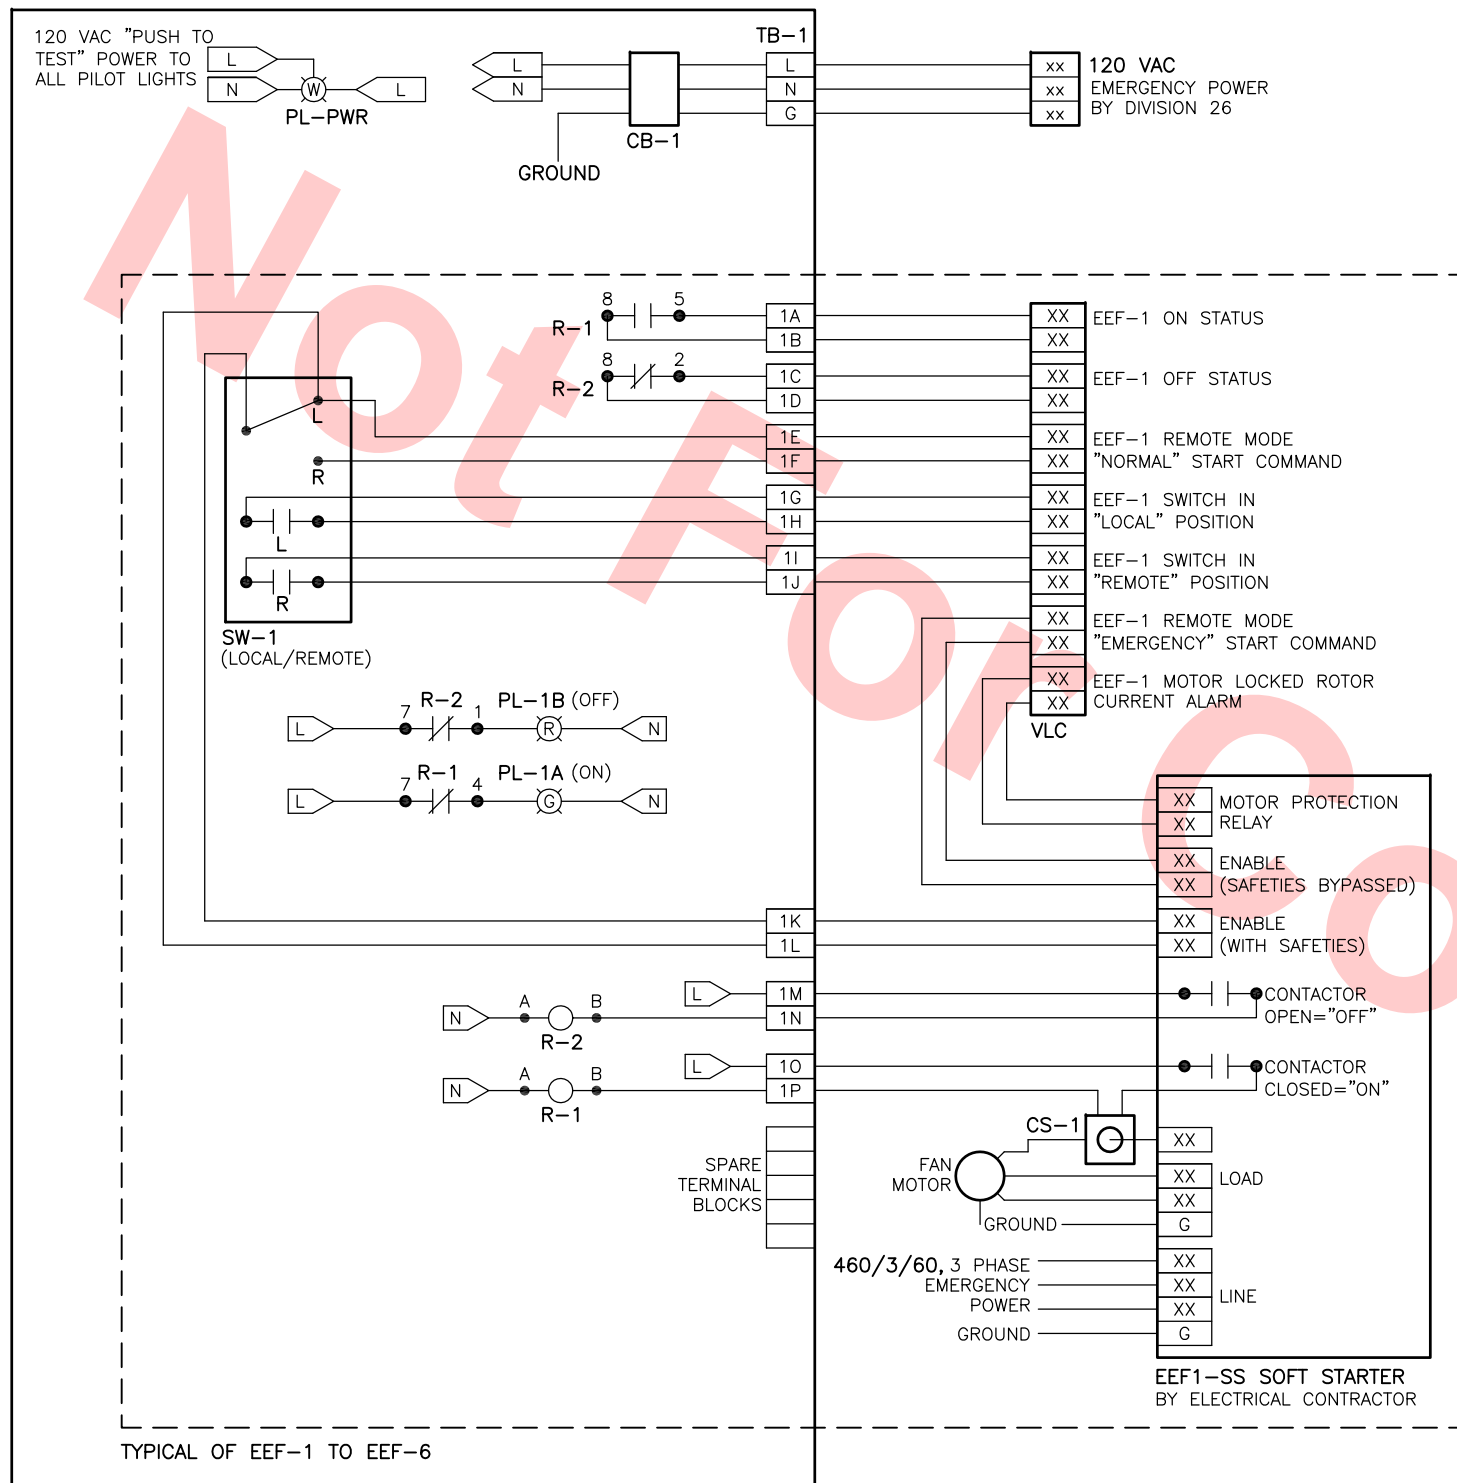


FCP-17 WIRING (EEP-1 TO EEF-6)
 FCP-23 SIMILAR (EEP-7 TO EEF-12)

PANEL	FANS
FCP-17	EEP-1, EEF-2, EEF-3, EEF-4, EEF-5, & EEF-6
FCP-23	EEP-7, EEF-8, EEF-9, EEF-10, EEF-11, & EEF-12

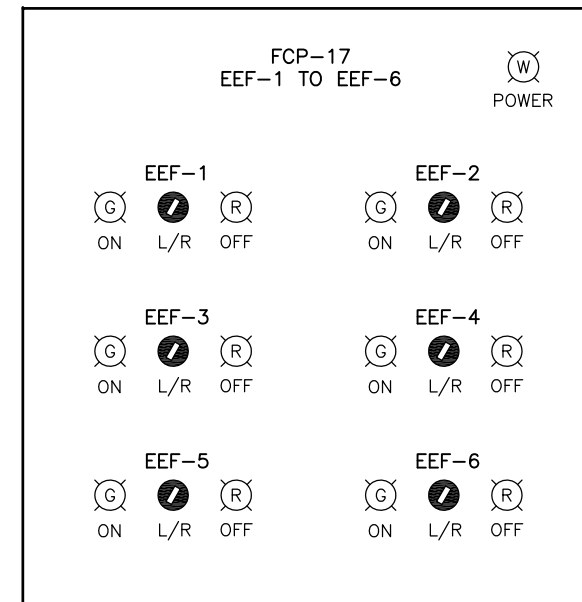

FCP-17 FACE LAYOUT

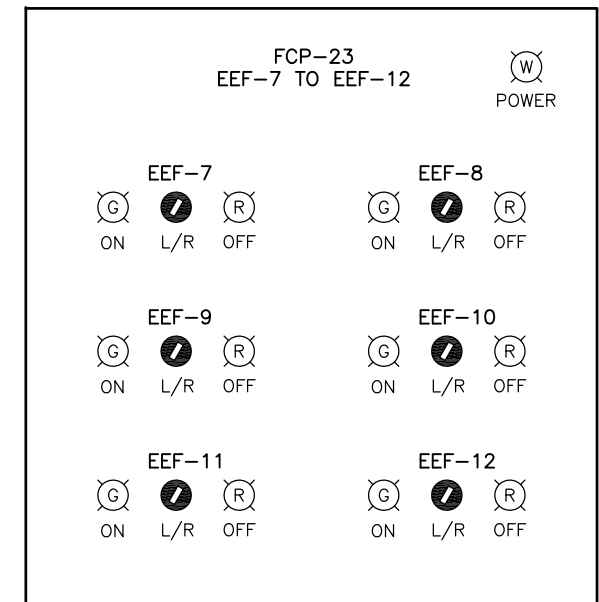

FCP-23 FACE LAYOUT

Santa Clara Valley Transportation Authority

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Contract No.: DB11002F

By: _____ Date: _____

REV	DATE	BY	SUB	APP	DESCRIPTION
0	20130710				READINESS FOR CONSTRUCTION



DESIGNED BY J. CHOU DRAWN BY J. CHOU CHECKED BY G. HENNINGS IN CHARGE G. HENNINGS DATE 20130710	SUBMITTED 	APPROVED
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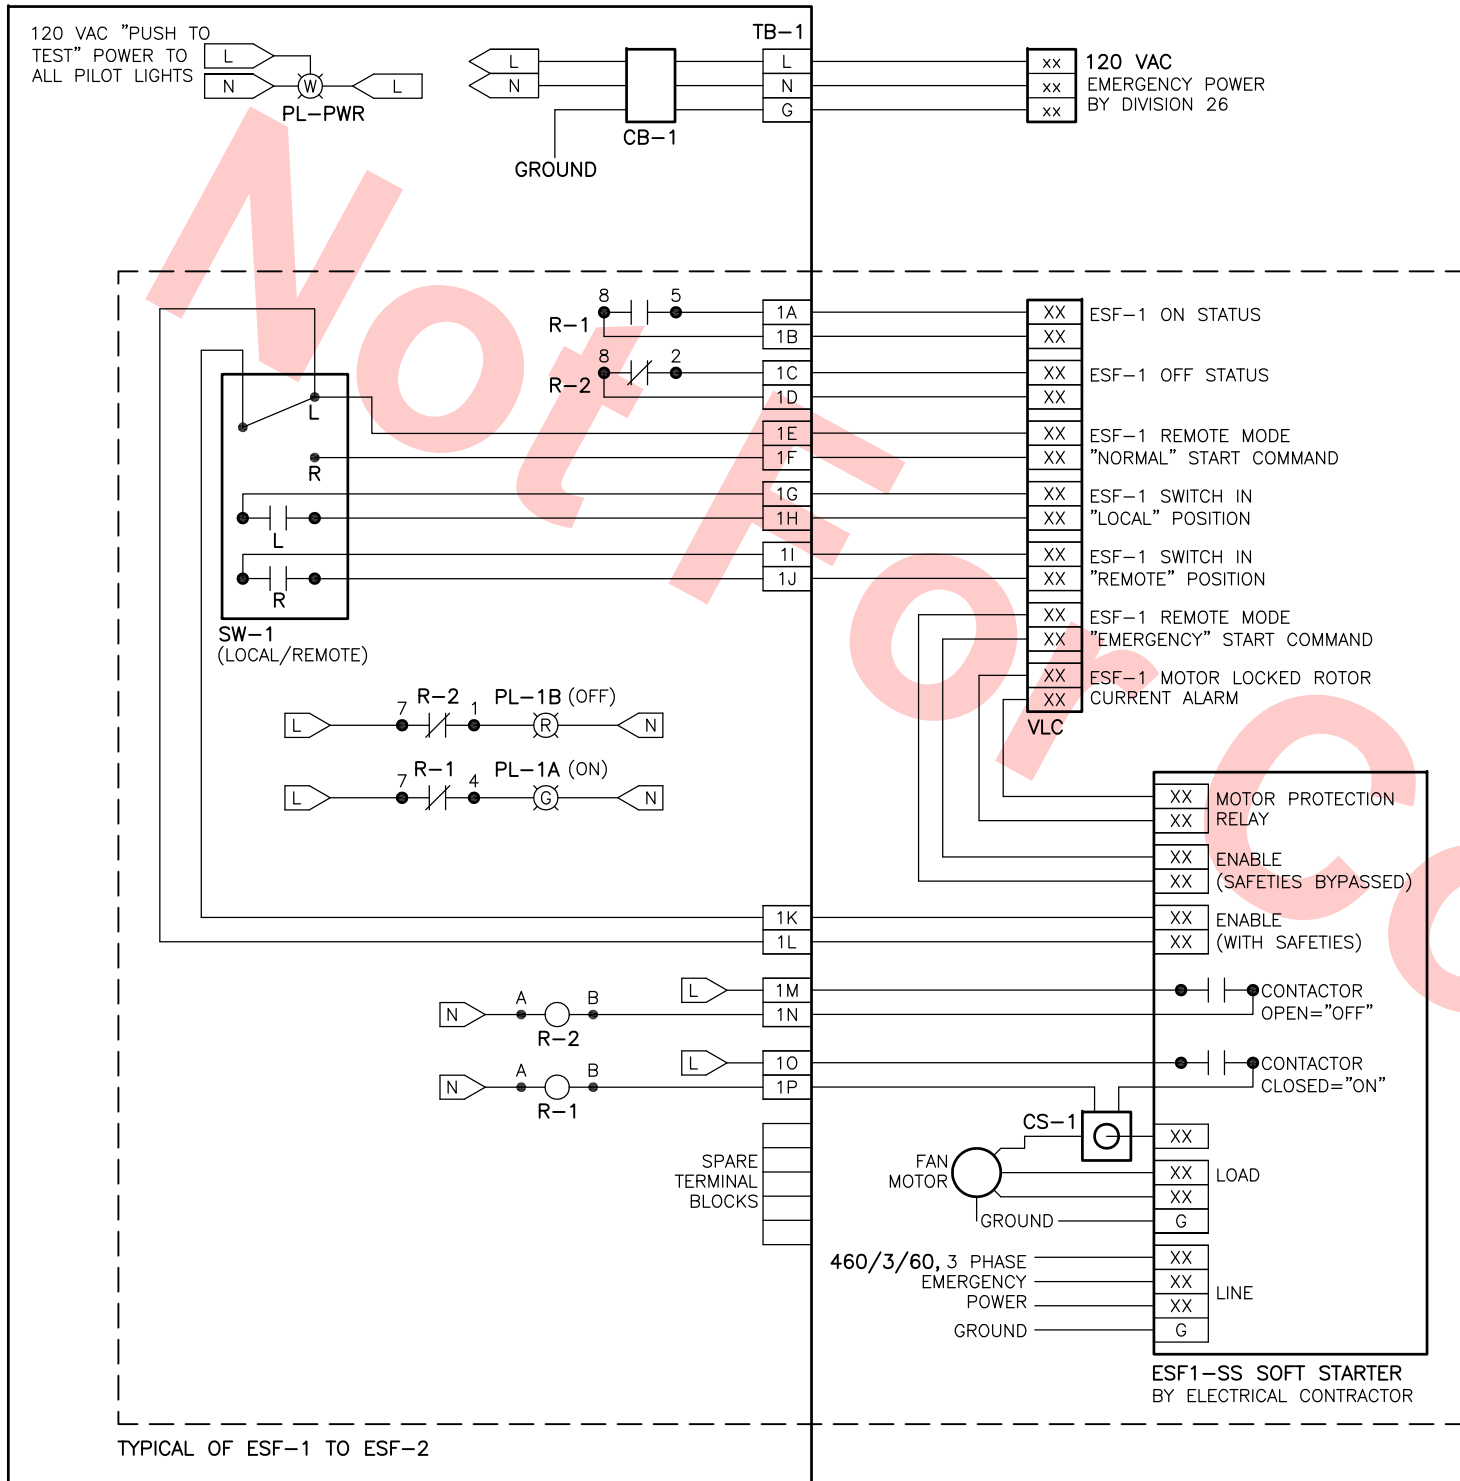
1436 California Circle
 Milpitas, California 95035
 A Joint Venture




LINE, TRACK, STATIONS AND SYSTEMS
 DESIGN UNIT 023
 MILPITAS STATION
 HVAC CONTROLS

PAGE 9 OF 11


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SIZE D	SCALE NONE
CONTRACT NO. C700	SHEET NO. M378
AREA CODE DB	PAGE NO. 0736




PANEL	FANS
FCP-11	ESF-1, ESF-2
FCP-09	ESF-3, ESF-4
FCP-15	ESF-5, ESF-6
FCP-13	ESF-7, ESF-8
FCP-05	EVF-1, EVF-2
FCP-07	EVF-3, EVF-4

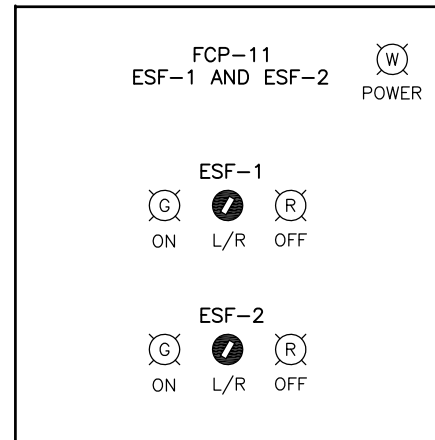


FCP-11 FACE LAYOUT

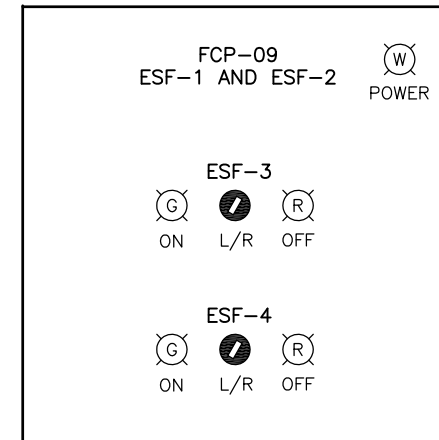


FCP-09 FACE LAYOUT

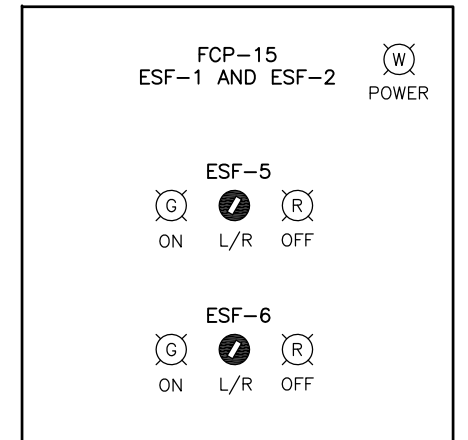


FCP-15 FACE LAYOUT

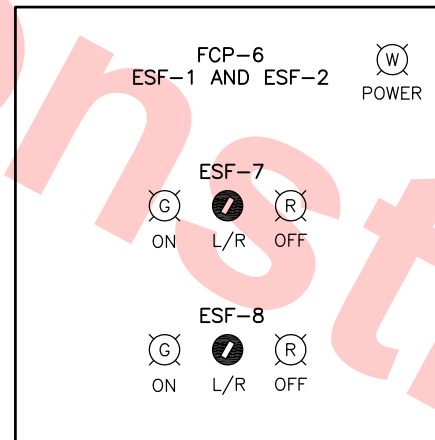

FCP-6 FACE LAYOUT

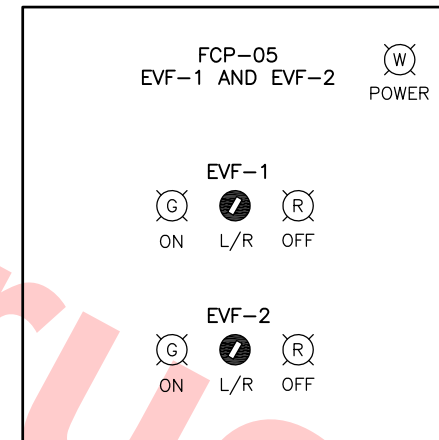

FCP-05 FACE LAYOUT

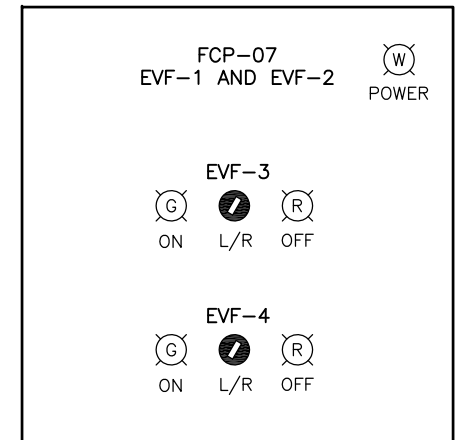

FCP-07 FACE LAYOUT

Santa Clara Valley Transportation Authority

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Contract No.: DB11002F

By: Date:

FCP-11 WIRING (ESF-1 AND ESF-2)
FCP-09, FCP-15, FCP-13, FCP-05 & FCP-07 SIMILAR
(ESF-3 TO ESF-8 AND EVF-1 TO EVF4)

DESIGNED BY J. CHOU	0	20130710	READINESS FOR CONSTRUCTION
DRAWN BY J. CHOU	REV	DATE	DESCRIPTION
CHECKED BY G. HENNING	BY		
IN CHARGE G. HENNING	SUB		
DATE 20130710	APP		



1436 California Circle
Milpitas, California 95035
A Joint Venture



LINE, TRACK, STATIONS AND SYSTEMS
DESIGN UNIT 023
MILPITAS STATION
HVAC CONTROLS

PAGE 10 OF 11

CADD FILENAME C700-S-DB-M379.dwg	CONTRACT NO. C700	REV. 0
SIZE D	SCALE NONE	AREA CODE DB
SHEET NO. M379	PAGE NO. 0737	

BILL OF MATERIALS

ITEM	QTY	CODE NO.	DESCRIPTION	MANUFACTURER
FCP	8	A242408LP	PANEL, NEMA 12, 24"X24"X8"	HOFFMAN
FCP	8	A24P24	PERFORATED BACKPLATE, 21"X21"	HOFFMAN
CB-1	8	PSMN01SB10	CIRCUIT BREAKER, 10 AMP	FUNCTIONAL DEVICES
CS-1	24	H909HV	CURRENT SENSING RELAY, LINE VOLTAGE CONTACT	VERIS INDUSTRIES
PL-PWR	8	CR104PLT82W	PILOT LIGHT, PUSH-TO-TEST, 120VAC, LED, WHITE	GENERAL ELECTRIC
PL-xA	24	CR104PLT82R	PILOT LIGHT, PUSH-TO-TEST, 120VAC, LED, RED	GENERAL ELECTRIC
PL-xB	24	CR104PLT82G	PILOT LIGHT, PUSH-TO-TEST, 120VAC, LED, GREEN	GENERAL ELECTRIC
R-1, 2	16	RR3B-ULC-AC120V	CONTROL RELAY, 3PDT, LIGHT, PUSH-TO-TEST	IDEC
R-1, 2	16	SR3B-05	CONTROL RELAY BASE, 3PDT	IDEC
SW-X	24	CR104PSG21B92	2-POSITION SWITCH, MAINTAINED, 2PDT	GENERAL ELECTRIC
TB-1	576	1492-H	TERMINAL BLOCK, 600 VAC, 30 AMP, FINGER-SAFE	ALLEN-BRADLEY

OVERALL SEQUENCE OF OPERATION OF SMOKE EXHAUST SYSTEM:

(FOR INFORMATION PURPOSES ONLY)

UPON SIGNAL FROM VLC PANEL (LOCATED IN EMP ROOM) THE FOLLOWING SEQUENCE STEPS SHALL BE INITIATED:

- STEP 1
- ALL SKYLIGHT FANS (5 FANS AT EACH SKYLIGHT WELL) SHALL START. IN THE EVENT OF A FAILURE OF A FAN, THE STANDBY FAN SHALL BE STARTED.
- STEP 2
- 15 SECONDS AFTER STEP 1: STAIRWAY FAN ESF-1 SHALL BE STARTED. IF AFTER 5 SECONDS THE FAN HAS FAILED TO START, ESF-2 SHALL BE INITIATED.
- STEP 3
- 15 SECONDS AFTER STEP 2: STAIRWAY FAN ESF-3 SHALL BE STARTED. IF AFTER 5 SECONDS THE FAN HAS FAILED TO START, ESF-4 SHALL BE INITIATED.
- STEP 4
- 15 SECONDS AFTER STEP 3, STAIRWAY FAN ESF-5 SHALL BE STARTED. IF AFTER 5 SECONDS AND FAN HAS FAILED TO START, ESF-6 SHALL BE INITIATED.
- STEP 5
- 15 SECONDS AFTER STEP 4, STAIRWAY FAN ESF-7 SHALL BE STARTED. IF AFTER 5 SECONDS AND FAN HAS FAILED TO START, ESF-8 SHALL BE INITIATED.
- STEP 6
- 15 SECONDS AFTER STEP 5, PLATFORM FANS EVF-1 AND EVF-3 SHALL START, IF AFTER 5 SECONDS THE FAN(S) HAS FAILED TO START THE ASSOCIATED STANDBY FAN(S) EVF-2 OR EVF-4 SHALL RESPECTFULLY START.

SEQUENCE OF OPERATION (OPERATION STATUS, TYPICAL OF ALL FANS)

THE FAN IS CONTROLLED BY A PANEL MOUNTED "LOCAL/REMOTE" SWITCH. WHEN THE SWITCH IS PLACED IN THE "LOCAL" POSITION, THE FAN SHALL START. WHEN THE SWITCH IS PLACED IN THE "REMOTE" POSITION, THE FAN SHALL START WHEN THE VLC PANEL ISSUES A "NORMAL" START COMMAND. IF THE FAN MOTOR LOCKED ROTOR CURRENT OCCURS FOR 30 SECONDS AS DETECTED BY THE MOTOR PROTECTION RELAY, THE FAN SHALL SHUTDOWN.

THE FAN SHALL START REGARDLESS OF THE "LOCAL/REMOTE" SWITCH POSITION WHEN THE VLC PANEL ISSUES AN "EMERGENCY" START COMMAND. THE "EMERGENCY" START COMMAND IS WIRED TO THE SOFT STARTER TO BYPASS THE FAN MOTOR PROTECTION DEVICES.

THE FAN RUNNING STATUS SHALL BE DETERMINED BY VERIFYING THAT THE FAN CONTACTOR IS CLOSED AND THE FAN CURRENT EXCEEDS A PRESET SETPOINT. THE FAN STOPPED STATUS SHALL BE DETERMINED BY VERIFYING THAT THE FAN CONTACTOR IS DE-ENERGIZED.

THE FOLLOWING POINTS SHALL BE RECEIVED/SENT BY THE VLC PANEL:

POINT TYPE	DESCRIPTION
DI	FAN ON STATUS
DI	FAN OFF STATUS
DI	FAN SWITCH IN LOCAL POSITION
DI	FAN SWITCH IN REMOTE POSITION
DI	FAN MOTOR LOCKED ROTOR CURRENT ALARM
DO	NORMAL START/STOP COMMAND
DO	EMERGENCY START/STOP COMMAND

DI = DIGITAL INPUT TO VLC PANEL
DO = DIGITAL OUTPUT FROM VLC PANEL

Santa Clara Valley Transportation Authority

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Contract No.: DB11002F

By: Date:

						DESIGNED BY J. CHOU		Skanska Shimmick Herzog 1436 California Circle Milpitas, California 95035 A Joint Venture	 BCH Block Construction Inc. 4455 Enterprise St., Fremont, CA 94538 (510) 657-3686 Fax: (510) 657-3689 CA Lic. #679326 email: info@blockcorp.com	 HMM Mechanical Group 8517 Earhart Rd. #200 Oakland, CA 94621 510-569-2000	 Lookwood, Andrews & Newnam, Inc. A LEO A DALY COMPANY	T-Y LIN INTERNATIONAL	 BART SILICON VALLEY BERRYESSA EXTENSION	LINE, TRACK, STATIONS AND SYSTEMS DESIGN UNIT 023 MILPITAS STATION HVAC CONTROLS PAGE 11 OF 11	CADD FILENAME C700-S-DB-M380.dwg		
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						CONTRACT NO. C700									REV. 0		
						AREA CODE DB									SHEET NO. M380	PAGE NO. 0738	
0	20130710					READINESS FOR CONSTRUCTION	IN CHARGE G. HENNINGS										
REV	DATE	BY	SUB	APP		DESCRIPTION	DATE 20130710		SUBMITTED 	APPROVED 							

KEY NOTES

- 1 OUTSIDE AIR FROM WALL LOUVER.
- 2 WALL TRANSFER GRILLE
- 3 FRESH AIR FROM DOOR LOUVER.
- 4 RELIEF AT UPPER WALL LOUVER.


Santa Clara Valley Transportation Authority

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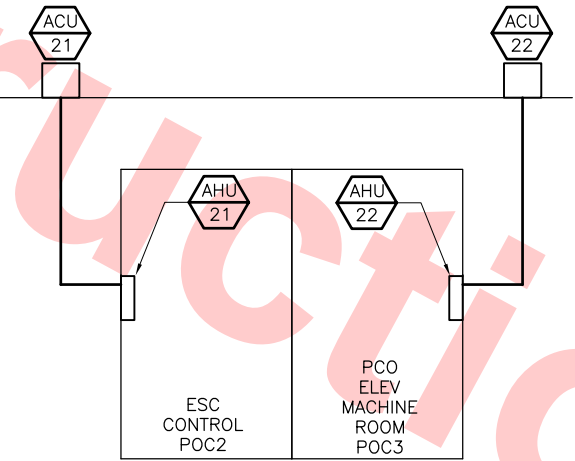
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Contract No.: DB11002F

By: Date:



HVAC AT NORTH END ANCILLARY ROOMS (CONCOURSE) FROM LINE 1 TO 5
SCALE: NONE

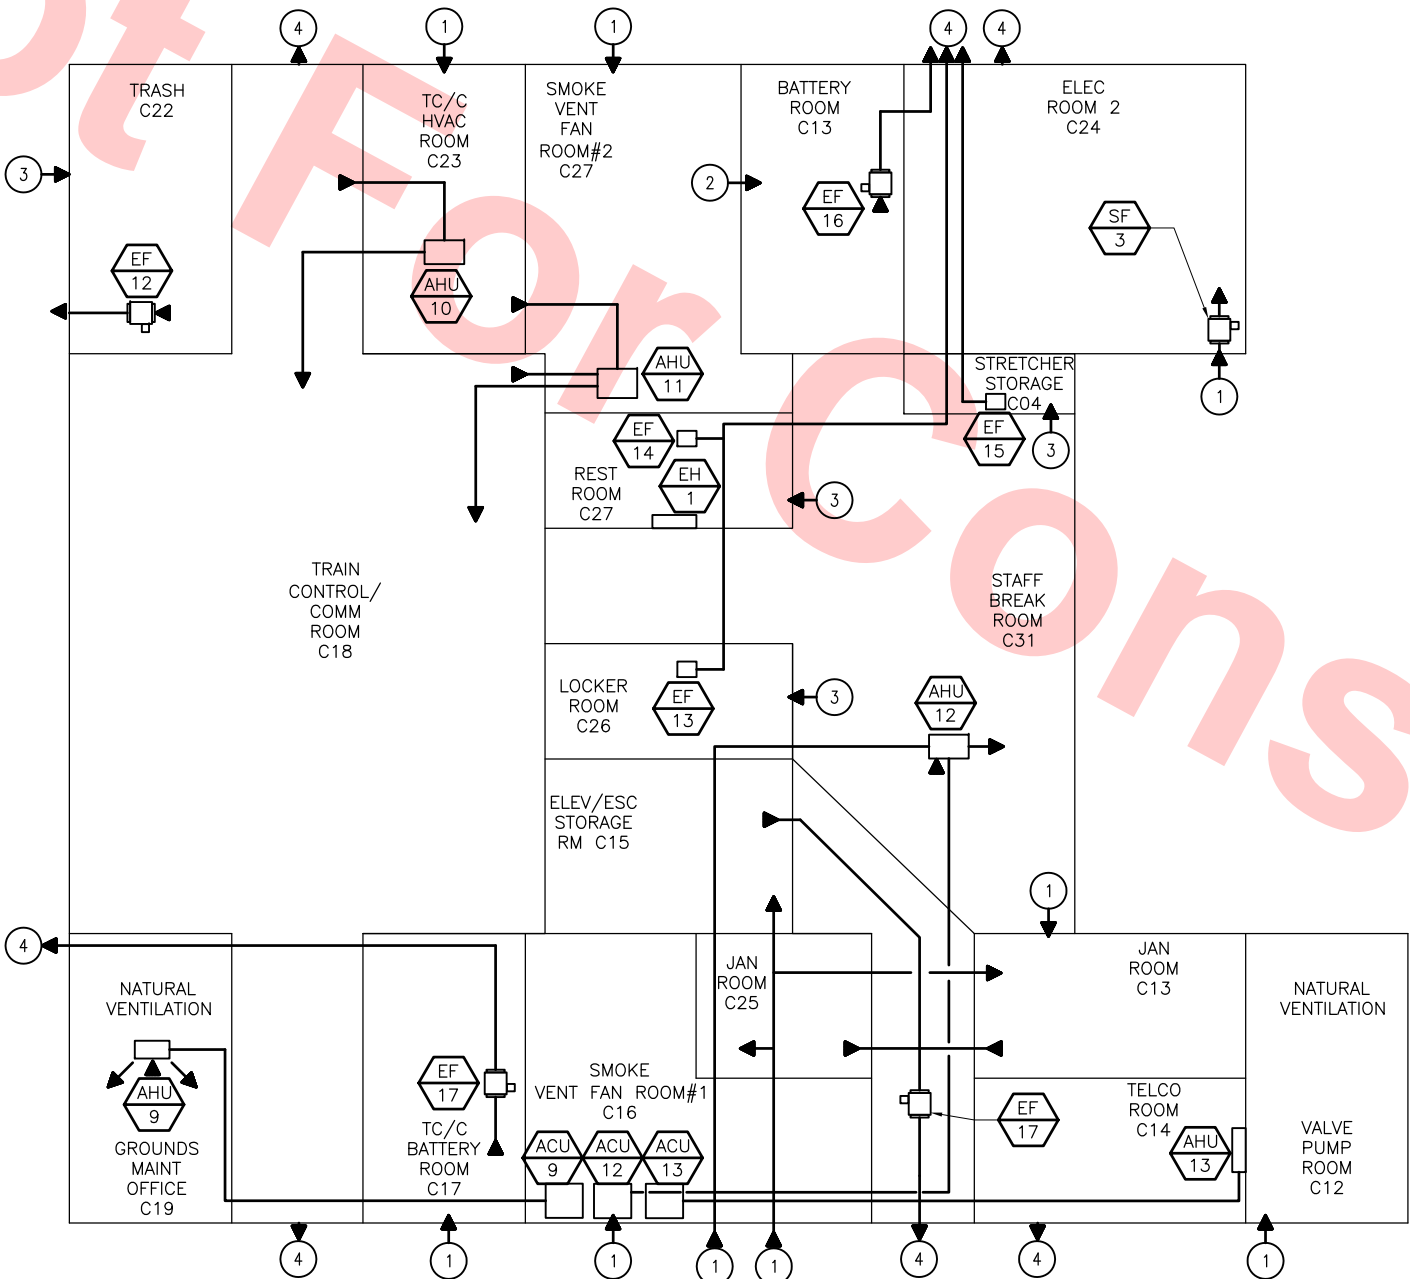

HVAC AT POC
SCALE: NONE

REV	DATE	BY	SUB	APP	DESCRIPTION
0	20130710				READINESS FOR CONSTRUCTION

DESIGNED BY
J. CHOU
DRAWN BY
J. CHOU
CHECKED BY
G. HENNINGS
IN CHARGE
G. HENNINGS
DATE
20130710



Block Construction Inc.
4455 Enterprise St., Fremont, CA 94538
(510) 607-3666 Fax: (510) 607-3668
CA Lic. #679326 email: info@blockco.com

Skanska
Shimmick
Herzog
HMM Mechanical Group
6517 Eastmont Rd., #230
Oakland, CA 94621
510-569-2000

Lockwood, Andrews
& Newnam, Inc.
A LEOP A DAILY COMPANY
APPROVED

T-Y LIN INTERNATIONAL
APPROVED



LINE, TRACK, STATIONS AND SYSTEMS
DESIGN UNIT 023
MILPITAS STATION
SYSTEM DIAGRAMS/RISERS
HVAC
SHEET 1 OF 4

CADD FILENAME C700-S-DB-M385.dwg	SIZE D	SCALE NONE
CONTRACT NO. C700	SHEET NO. DB	PAGE NO. 0739

KEY NOTES

- 1 OUTSIDE AIR FROM WALL LOUVER.
- 2 WALL TRANSFER GRILLE
- 3 FRESH AIR FROM DOOR LOUVER.
- 4 RELIEF AT UPPER WALL LOUVER.
- 5 FRESH AIR FROM ROOF LEVEL.
- 6 HVAC SHAFT.


Santa Clara Valley Transportation Authority

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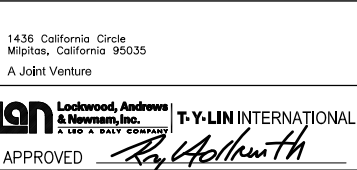
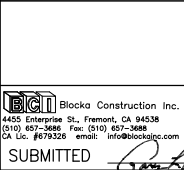
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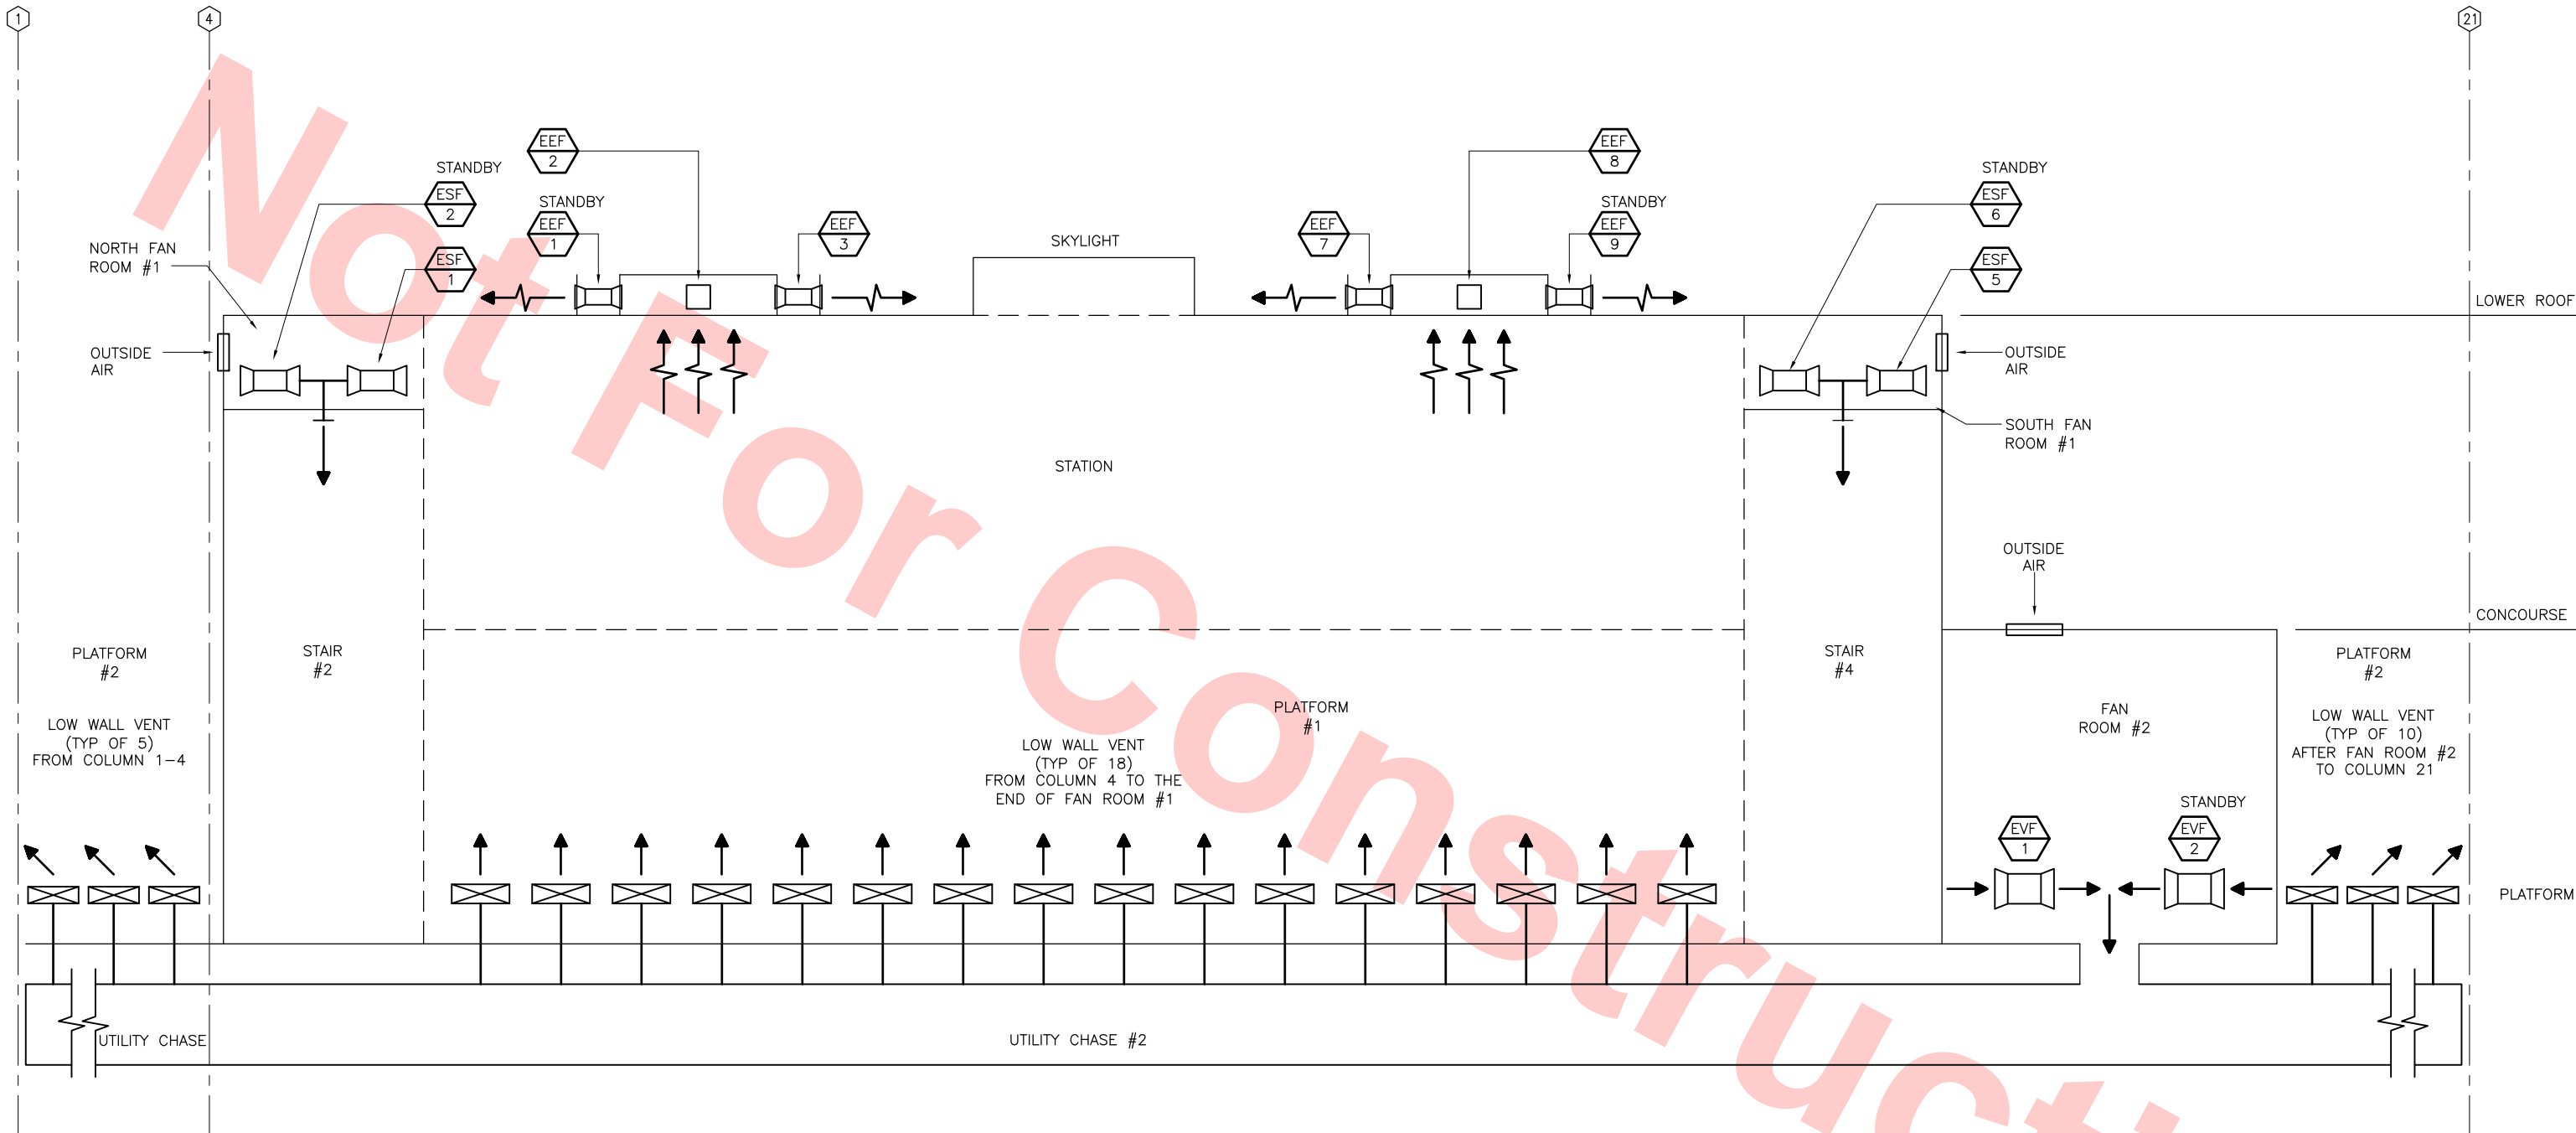
HVAC AT NORTH END ANCILLARY ROOMS FROM LINE 5 TO 12

SCALE: NONE

DESIGNED BY J. CHOU	0	20130710	BY	DATE	20130710
DRAWN BY J. CHOU			SUB	APP	
CHECKED BY G. HENNINGS					
IN CHARGE G. HENNINGS					
DATE 20130710					
DESCRIPTION READINESS FOR CONSTRUCTION					

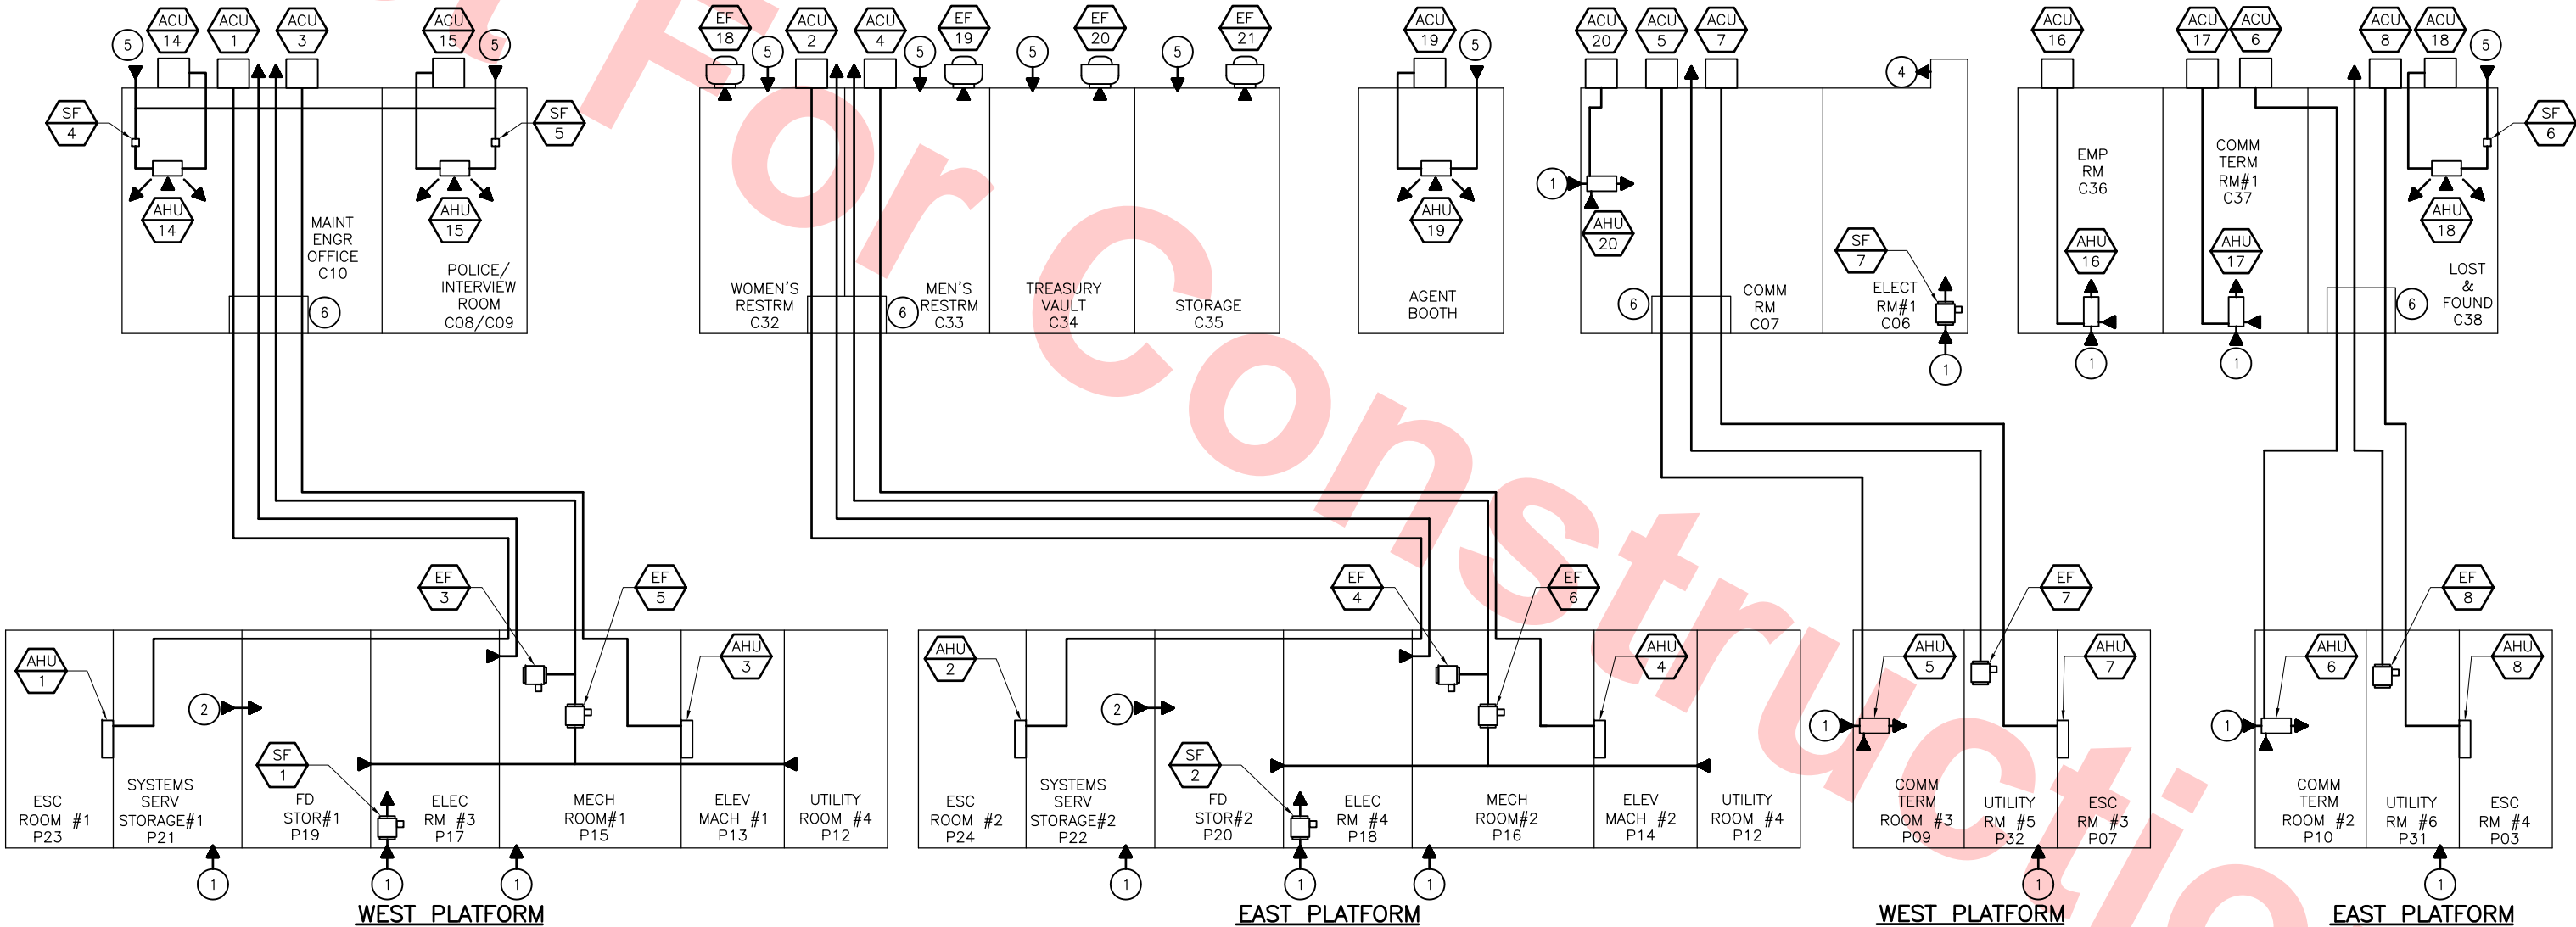

LINE, TRACK, STATIONS AND SYSTEMS DESIGN UNIT 023 MILPITAS STATION SYSTEM DIAGRAMS/RISERS HVAC SHEET 2 OF 4	CADD FILENAME C700-S-DB-M386.dwg
SIZE D	SCALE NONE
CONTRACT NO. C700	REV. 0
AREA CODE DB	SHEET NO. M386
PAGE NO. 0740	



SMOKE EVACUATION SYSTEM — EAST SIDE

SCALE: NONE

Santa Clara Valley Transportation Authority

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By: _____ Date: _____

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G. HENNINGS
DATE
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**Skanska
Shimmick
Herzog**

1436 California Circle
Milpitas, California 95035
A Joint Venture

H&M H&M Mechanical Group
8517 Eastmont Rd. #230
Oakland, CA 94621
510-569-2000

**Lockwood, Andrews
& Newnam, Inc.**
A LEO A DALY COMPANY

APPROVED *Ry Holmuth*







BART SILICON VALLEY BERRYESSA EXTENSION

LINE, TRACK, STATIONS AND SYSTEMS
DESIGN UNIT 023
MILPITAS STATION
SYSTEM DIAGRAMS/RISERS
HVAC
SHEET 4 OF 4

CADD FILENAME C700-S-DB-M388.dwg	SIZE D	SCALE NONE
CONTRACT NO. C700	REV. 0	
AREA CODE DB	SHEET NO. M388	PAGE NO. 0742

EQUIP ID	AREA SERVED	MFR	MODEL NO	SUPPLY FAN			NET TOTAL COOLING CAPACITY @ ARI (BTUH)	NET TOTAL HEATING CAPACITY @ ARI (BTUH)	AUXILIARY ELECT HTR (KW)	VOLT/PH/HZ	MIN CIRCUIT AMPS	MAX OVERCURRENT PROTECTION	CONDENSATE DRAIN LINE SIZE	OPER WEIGHT (LBS)	REMARKS
				CFM HI-LOW	ESP INWC	HP									
AHU-1	ESCALATOR RM #1 P23	DAIKIN	FAQ18PVJU	500-400	-	1/12	18,000	-	-	208/1/60	0.4	15	1	80	
AHU-2	ESCALATOR RM #2 P24	DAIKIN	FAQ18PVJU	500-400	-	1/12	18,000	-	-	208/1/60	0.4	15	1	80	
AHU-3	ELEVATOR MACHINE #1 P13	DAIKIN	FAQ24PVJU	635-470	-	1/6	24,000	-	-	208/1/60	0.6	15	1	80	
AHU-4	ELEVATOR MACHINE #2 P14	DAIKIN	FAQ24PVJU	635-470	-	1/6	24,000	-	-	208/1/60	0.6	15	1	80	
AHU-5	COMM TERM RM #3 P09	DAIKIN	FBQ18PVJU	635-529	-	1/12	18,000	20,000	-	208/1/60	1.6	15	1	80	MERV 8 FILTERS W/ FILTER RACK
AHU-6	COMM TERM RM #2 P10	DAIKIN	FBQ18PVJU	635-529	-	1/12	18,000	20,000	-	208/1/60	1.6	15	1	80	
AHU-7	ESCALATOR RM #3 P07	DAIKIN	FAQ18PVJU	500-400	-	1/12	18,000	-	-	208/1/60	0.4	15	1	80	
AHU-8	ESCALATOR RM #4 P08	DAIKIN	FAQ18PVJU	500-400	-	1/12	18,000	-	-	208/1/60	0.4	15	1	80	
AHU-9	GRNDS MAINT OFFICE C19	DAIKIN	FCQ18PVJU	560-390	-	1/12	18,000	21,600	-	208/1/60	1.6	15	1	80	MERV 11 FILTERS, EXTENDED FILTER CASEMENT
AHU-10	TRAIN CONTROL/COMM C18	McQUAY	CAH010GDAC	4,400-3,000	1.5	5	72,330	-	-	460/3/60	22.2	25	1	2,350	MERV 11 & 14 FILTERS W/ FILTER RACKS, MANUFACTURERS VFD DRIVE
AHU-11	TRAIN CONTROL/COMM C18	McQUAY	CAH010GDAC	4,400-3,000	1.5	5	72,330	-	-	460/3/60	22.2	25	1	2,350	
AHU-12	STAFF BREAK RM C34	LENNOX	CBX27UH-048-460	1,600	0.8	1	47,500	45,000	18.4	460/3/60	34	35	1	220	MERV 11 FILTERS & FILTER RACK
AHU-13	TELCO RM C14	DAIKIN	FAQ18PVJU	500-400	-	1/12	18,000	20,000	-	208/1/60	0.4	15	1	31	
AHU-14	MAINT ENGR OFFICE C10	DAIKIN	FCQ18PVJU	560-390	-	1/12	18,000	20,000	-	208/1/60	1.6	15	1	80	MERV 11 FILTERS, EXTENDED FILTER CASEMENT
AHU-15	POLICE RM C08	DAIKIN	FCQ18PVJU	560-390	-	1/12	18,000	20,000	-	208/1/60	1.6	15	1	80	
AHU-16	EMP ROOM C36	DAIKIN	FBQ18PVJU	635-529	-	1/12	18,000	20,000	-	208/1/60	1.6	15	1	80	MERV 11 FILTERS W/ FILTER RACK
AHU-17	COMM TERM ROOM #1	DAIKIN	FBQ18PVJU	635-529	-	1/12	18,000	20,000	-	208/1/60	1.6	15	1	80	MERV 8 FILTERS W/ FILTER RACK
AHU-18	LOST & FOUND C38	DAIKIN	FCQ18PVJU	560-390	-	1/12	18,000	20,000	-	208/1/60	1.6	15	1	80	MERV 11 FILTERS, EXTENDED FILTER CASEMENT
AHU-19	STATION AGENTS BOOTH COX	DAIKIN	FCQ18PVJU	560-390	-	1/12	18,000	20,000	-	208/1/60	1.6	15	1	80	
AHU-20	COMM ROOM C07	DAIKIN	FBQ18PVJU	635-529	-	1/12	18,000	20,000	-	208/1/60	1.6	15	1	80	MERV 8 FILTERS W/ FILTER RACK
AHU-21	POC ESCALATOR CONTROL POC 2	DAIKIN	FAQ18PVJU	500-400	-	1/12	18,000	-	-	208/1/60	0.4	15	1	80	
AHU-22	POC ELEVATOR MACHINE RM POC 3	DAIKIN	FAQ24PVJU	635-470	-	1/6	24,000	-	-	208/1/60	0.6	15	1	80	
ACCESSORIES:															

By: _____ **Date:** _____

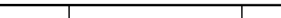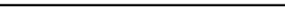					DESIGNED BY J. CHOU		Skanska Shimmick Herzog 1436 California Circle Milpitas, California 95035 A Joint Venture				LINE, TRACK, STATIONS AND SYSTEMS DESIGN UNIT 023 MILPITAS STATION EQUIPMENT SCHEDULES HVAC SHEET 1 OF 3	CADD FILENAME C700-S-DB-M390.dwg SIZE D SCALE NONE CONTRACT NO. C700 REV. 0 AREA CODE DB SHEET NO. M390 PAGE NO. 0743
					DRAWN BY J. CHOU							
					CHECKED BY G. HENNINGS							
					IN CHARGE G. HENNINGS							
0	20130710				READINESS FOR CONSTRUCTION	DATE 20130710						
REV	DATE	BY	SUB	APP	DESCRIPTION							

EXHAUST & SUPPLY FAN SCHEDULE

EQUIP ID	LOCATION	AREA SERVED	MFR	MODEL NO	DESIGN FAN (CFM)	ESP INWC	FAN RPM	FAN BHP	MOTOR DATA		OPER WEIGHT (LBS)	MOUNT TYPE	NOTES
									HP	VOLT/PH/HZ			
SF-1	ELEC RM #3 P17	P17	GREENHECK	SQ-85-VG	250	0.61	1218	0.07	1/6	120/1/60	60	CH	NEOPRENE ISOLATORS, FILTER BOX AND MERV-8 FILTERS, OUTLET SCREEN, CONSTANT PRESSURE CONTROLLER
SF-2	ELEC RM #4 P18	P18	GREENHECK	SQ-85-VG	250	0.61	1218	0.07	1/6	120/1/60	60	CH	
SF-3	ELEC RM #2 C24	C24	GREENHECK	SQ-120-VG	1,420	0.8	1650	0.41	1/2	120/1/60	70	CH	
SF-4	MAINT ENGR OFFICE C10	C10	FANTECH	FG4	60	0.1	-	-	1/30	120/1/60	60	CH	FURNISHED WITH FC VIBRATION ISOLATION CLAMPS AND INTEGRAL SPEED CONTROLLER; RUNS CONTINUOUSLY
SF-5	POLICE ROOM C08	C08	FANTECH	FG4	60	0.1	-	-	1/30	120/1/60	60	CH	
SF-6	LOST & FOUND C36	C36	FANTECH	FG4	60	0.1	-	-	1/30	120/1/60	60	CH	
SF-7	ELEC RM #1 C06	C06	GREENHECK	SQ-140-VG	1,900	0.73	1335	0.48	3/4	120/1/60	100	CH	NEOPRENE ISOLATORS, FILTER BOX AND MERV-8 FILTERS, OUTLET SCREEN, CONSTANT PRESSURE CONTROLLER
EF-1	UTLTITY RM #1 P25	P25	GREENHECK	SQ-70-D	100	0.30	1448	0.02	1/30	120/1/60	44	CH	INLET SCREEN, NEOPRENE ISOLATORS, SPEED CONTROLLER; RUNS CONTINUOUSLY
EF-2	UTLTITY RM #2 P26	P26	GREENHECK	SQ-70-D	100	0.30	1448	0.02	1/30	120/1/60	44	CH	
EF-3	MECH RM COMP #1 P15	P15	GREENHECK	SQ-95-VG	390	0.63	1599	0.11	1/6	120/1/60	60	CH	BDD, INLET SCREEN, NEOPRENE ISOLATORS; CONTROLLED BY LINE VOLTAGE THERMOSTAT SET AT 104°F
EF-4	MECH RM COMP #2 P16	P16	GREENHECK	SQ-95-VG	390	0.63	1599	0.11	1/6	120/1/60	60	CH	
EF-5	MECH RM COMP #1 P15	P21, P19, P11	GREENHECK	SQ-95-VG	460	0.65	1708	0.13	1/4	120/1/60	60	CH	NEOPRENE ISOLATORS; RUNS CONTINUOUSLY
EF-6	MECH RM COMP #2 P16	P22, P20, P12	GREENHECK	SQ-95-VG	460	0.65	1708	0.13	1/4	120/1/60	60	CH	
EF-7	UTLTITY RM #5 P32	P32	GREENHECK	SQ-85-D	240	0.30	1265	0.03	1/12	120/1/60	60	CH	INLET SCREEN, NEOPRENE ISOLATORS, SPEED CONTROLLER; RUNS CONTINUOUSLY
EF-8	UTLTITY RM #6 P31	P31	GREENHECK	SQ-85-D	240	0.30	1265	0.03	1/12	120/1/60	60	CH	
EF-9	UTLTITY RM #7 P03	P03	GREENHECK	SQ-70-D	100	0.30	1448	0.02	1/30	120/1/60	44	CH	
EF-10	UTLTITY RM #8 P04	P04	GREENHECK	SQ-70-D	100	0.30	1448	0.02	1/30	120/1/60	44	CH	
EF-11	TC/C BATTERY RM C17	C17	GREENHECK	SQ-75-D	260	.10	1375	0.02	1/30	120/1/60	41	CH	EPOXY COATING ON AIR STREAM COMPONENTS, EXPLOSION PROOF MOTOR, EMERGENCY POWER, NEOPRENE ISOLATORS, SPEED CONTROLLER; RUNS CONTINUOUSLY
EF-12	TRASH C22	C22	GREENHECK	SQ-70-D	200	0.1	1550	0.02	1/30	120/1/60	26	CH	SPRING ISOLATORS, INLET SCREEN; RUNS CONTINUOUSLY
EF-13	LOCKER RM C26	C26	GREENHECK	SP-A250	200	0.2	881	0.06	1/8	120/1/60	24	CM	BDD, SPRING ISOLATORS; CONTROL BY LIGHT SWITCH
EF-14	RESTROOM C27	C27	GREENHECK	SP-A250	200	0.2	881	0.06	1/8	120/1/60	24	CM	
EF-15	STRETCHER STORAGE C41	C41	GREENHECK	SP-A50	30	0.25	700	0.01	1/100	120/1/60	12	CM	BDD, SPRING ISOLATORS; RUNS CONTINUOUSLY
EF-16	TC/C BATTERY ROOM C29	C29	GREENHECK	SQ-75-D	260	.10	1375	0.02	1/30	120/1/60	41	CH	EPOXY COATING ON AIR STREAM COMPONENTS, EXPLOSION PROOF MOTOR, EMERGENCY POWER, SPRING ISOLATORS, SPEED CONTROLLER; RUNS CONTINUOUSLY
EF-17	VESTIBULE C11	C13, C25, C125	GREENHECK	SQ-100-A	760	0.25	1300	0.03	1/4	120/1/60	55	CH	SPRING ISOLATORS, SPEED CONTROLLER; RUNS CONTINUOUSLY
EF-18	WOMEN'S RESTROOM C32	C32	GREENHECK	G-080-D	300	0.2	1292	0.03	1/20	120/1/60	26	RC	SPRING ISOLATORS, SPEED CONTROLLER; CONTROL BY LIGHT SWITCH
EF-19	MEN'S RESTROOM C33	C33	GREENHECK	G-080-D	320	0.2	1340	0.03	1/20	120/1/60	26	RC	
EF-20	TREASURY VAULT C25	C25	GREENHECK	G-060-G	90	0.18	1300	0.01	1/100	120/1/60	26	RC	14" ROOF CURB; RUNS CONTINUOUSLY
EF-21	STORAGE RM C35	C35	GREENHECK	G-070-G	230	0.15	1256	0.02	1/60	120/1/60	26	RC	
EF-22	MEN A-04	A-04	GREENHECK	SP-B200	160	0.15	915	0.02	1/10	120/1/60	60	CM	BDD, SPRING ISOLATORS, SPEED CONTROLLER; CONTROL BY LIGHT SWITCH
EF-23	JANITOR CLOSET A-05	A-05	GREENHECK	SP-B110	100	0.15	903	0.05	1/8	120/1/60	60	CM	SPRING ISOLATORS, SPEED CONTROLLER; RUNS CONTINUOUSLY
EF-24	WOMEN A-06	A-06	GREENHECK	SP-A200	200	0.15	849	0.02	1/10	120/1/60	60	CM	BDD, SPRING ISOLATORS, SPEED CONTROLLER; CONTROL BY LIGHT SWITCH
EF-25	EMERG. GEN ROOM A-07	EMERG. GEN ROOM A-07	GREENHECK	G-085-D	510	0.15	1550	0.05	1/20	120/1/60	20	RC	14" ROOF CURB, EXPLOSION PROOF MOTOR; RUNS CONTINUOUSLY
EF-26	FUEL TANK ROOM A-08	FUEL TANK ROOM A-08	GREENHECK	G-080-D	420	0.15	1550	0.04	1/20	120/1/60	20	RC	

ELECTRIC HEATER SCHEDULE

EQUIP ID	AREA SERVED	MFR	MODEL NO	HEATER		STAGES	FAN		VOLT/PH/HZ	OPER WEIGHT (LBS)	REMARKS
				OUTPUT (KW)	AMPS		AIR FLOW	MTR HP			
EH-1	STAFF TOILET C27	QMARK	CRA2024T2	1.5	12.5	1	100	1/16	208/1/60	11	BUILT-IN THERMOSTAT WALL MOUNTED



Santa Clara Valley Transportation Authority

___ NO EXCEPTIONS TAKEN (NET)
___ MAKE CORRECTIONS NOTED (MCN)
___ AMEND AND RESUBMIT (A/R)

Any action shown above is subject to the terms of the contract and does not relieve the Contractor of any of its obligations under the contract, including design and detailing.

Contract No.: DB11002F

By: _____ Date: _____

						DESIGNED BY J. CHOU		<div>Skanska Shimmick Herzog</div> <div>1436 California Circle Milpitas, California 95035 A Joint Venture</div>							LINE, TRACK, STATION AND SYSTEMS DESIGN UNIT 023 MILPITAS STATION EQUIPMENT SCHEDULES HVAC SHEET 2 OF 3	CADD FILENAME C700-S-DB-M391.dwg		
						DRAWN BY J. CHOU										SIZE D	SCALE NONE	
						CHECKED BY G. HENNINGS										CONTRACT NO.	C700	REV. 0
0	20130710					IN CHARGE G. HENNINGS										AREA CODE DB	SHEET NO. M391	PAGE NO. 0744
REV	DATE	BY	SUB	APP	DESCRIPTION	DATE 20130710	SUBMITTED		APPROVED									

EMERGENCY SUPPLY & EXHAUST FAN SCHEDULE

EQUIP ID	LOCATION	AREA SERVED	MFR	MODEL NO	DESIGN FAN (CFM)	ESP INWC	FAN RPM	FAN BHP	MOTOR DATA		OPER WEIGHT (LBS)	REMARKS
									HP	VOLT/PH/HZ		
EEF-1	ROOF	OPEN CONCOURSE	TWIN CITY	TCTA36D4	20,000	0.9	1140	5.11	7-1/2	460/3/60	750	482°F CONSTRUCTION, HORIZ DISCHARGE, CBD, MOUNT ON SEISMIC SPRING VIBRATION ISOLATORS – SEE DWG NO. DB-M364, DETAIL 3 FOR ADDITIONAL ACCESSORIES. PROTECTIVE DEVICES TO BE INSTALLED: BEARING TEMPERATURE, BEARING VIBRATION, MOTOR TEMPERATURE, MOTOR CURRENT.
EEF-2	ROOF	OPEN CONCOURSE	TWIN CITY	TCTA36D4	20,000	0.9	1140	5.11	7-1/2	460/3/60	750	
EEF-3	ROOF	OPEN CONCOURSE	TWIN CITY	TCTA36D4	20,000	0.9	1140	5.11	7-1/2	460/3/60	750	
EEF-4	ROOF	OPEN CONCOURSE	TWIN CITY	TCTA36D4	20,000	0.9	1140	5.11	7-1/2	460/3/60	750	
EEF-5	ROOF	OPEN CONCOURSE	TWIN CITY	TCTA36D4	20,000	0.9	1140	5.11	7-1/2	460/3/60	750	
EEF-6	ROOF	OPEN CONCOURSE	TWIN CITY	TCTA36D4	20,000	0.9	1140	5.11	7-1/2	460/3/60	750	
EEF-7	ROOF	OPEN CONCOURSE	TWIN CITY	TCTA36D4	20,000	0.9	1140	5.11	7-1/2	460/3/60	750	
EEF-8	ROOF	OPEN CONCOURSE	TWIN CITY	TCTA36D4	20,000	0.9	1140	5.11	7-1/2	460/3/60	750	
EEF-9	ROOF	OPEN CONCOURSE	TWIN CITY	TCTA36D4	20,000	0.9	1140	5.11	7-1/2	460/3/60	750	
EEF-10	ROOF	OPEN CONCOURSE	TWIN CITY	TCTA36D4	20,000	0.9	1140	5.11	7-1/2	460/3/60	750	
EEF-11	ROOF	OPEN CONCOURSE	TWIN CITY	TCTA36D4	20,000	0.9	1140	5.11	7-1/2	460/3/60	750	
EEF-12	ROOF	OPEN CONCOURSE	TWIN CITY	TCTA36D4	20,000	0.9	1140	5.11	7-1/2	460/3/60	750	
ESF-1	NORTH FAN ROOM #1	CONCOURSE STAIR #2	TWIN CITY	TCVX66D4	104,000	1.5	871	56.71	60	460/3/60	2,150	HORIZ DISCHARGE, BBD, MOUNT ON SEISMIC SPRING VIBRATION ISOLATORS – SEE DWG NO. DB-M364, DETAIL 1 FOR ADDITIONAL ACCESSORIES PROTECTIVE DEVICES TO BE INSTALLED: BEARING TEMPERATURE, BEARING VIBRATION, MOTOR TEMPERATURE, MOTOR CURRENT.
ESF-2	NORTH FAN ROOM #1	CONCOURSE STAIR #2	TWIN CITY	TCVX66D4	104,000	1.6	878	58.66	60	460/3/60	2,150	
ESF-3	NORTH FAN ROOM #2	CONCOURSE STAIR #1	TWIN CITY	TCVX66D4	104,000	1.5	871	56.71	60	460/3/60	2,150	
ESF-4	NORTH FAN ROOM #2	CONCOURSE STAIR #1	TWIN CITY	TCVX66D4	104,000	1.6	878	58.66	60	460/3/60	2,150	
ESF-5	SOUTH FAN ROOM #1	CONCOURSE STAIR #4	TWIN CITY	TCVX66D4	104,000	1.5	871	56.71	60	460/3/60	2,150	
ESF-6	SOUTH FAN ROOM #1	CONCOURSE STAIR #4	TWIN CITY	TCVX66D4	104,000	1.6	878	58.66	60	460/3/60	2,150	
ESF-7	SOUTH FAN ROOM #2	CONCOURSE STAIR #3	TWIN CITY	TCVX66D4	104,000	1.5	871	56.71	60	460/3/60	2,150	
ESF-8	SOUTH FAN ROOM #2	CONCOURSE STAIR #3	TWIN CITY	TCVX66D4	104,000	1.6	878	58.66	60	460/3/60	2,150	
EVF-1	FAN ROOM #1	PLATFORM #1	TWIN CITY	TCVX48D6	38,000	1.0	1145	14.67	15	460/3/60	1,450	VERTICAL DOWN DISCHARGE, CBD, MOUNT ON SEISMIC SPRING VIBRATION ISOLATORS – SEE DWG.DB-M364, DETAIL 2 FOR ADDITIONAL ACCESSORIES PROTECTIVE DEVICES TO BE INSTALLED: BEARING TEMPERATURE, BEARING VIBRATION, MOTOR TEMPERATURE, MOTOR CURRENT.
EVF-2	FAN ROOM #1	PLATFORM #1	TWIN CITY	TCVX48D6	38,000	1.0	1145	14.67	15	460/3/60	1,450	
EVF-3	FAN ROOM #2	PLATFORM #2	TWIN CITY	TCVX48D6	38,000	1.0	1145	14.67	15	460/3/60	1,450	
EVF-4	FAN ROOM #2	PLATFORM #2	TWIN CITY	TCVX48D6	38,000	1.0	1145	14.67	15	460/3/60	1,450	

NOTES: BACKDRAFT DAMPERS SHALL BE CONSTRUCTED AND INSTALLED IN ACCORDANCE WITH DESIGN CRITERIA MANUAL, MECHANICAL, JULY 22, 2011, ARTICLE 3.5.8

ROOFTOP PACKAGE AIR SOURCE HEAT PUMP SCHEDULE

EQUIP ID	LOCATION	AREA SERVED	MFR	MODEL NO	SUPPLY FAN			MIN OUTSIDE AIR FLOW (CFM)	NET TOTAL COOLING CAPACITY @ ARI (BTUH)	EER/ SEER	NET TOTAL HEATING CAPACITY @ ARI (BTUH)	HSPF	AUXILIARY ELECT HTR (KW)	VOLT/PH/HZ	MCA	MAX OVERCURRENT PROTECTION	CONDENSATE DRAIN LINE SIZE	OPER WEIGHT (LBS)	REMARKS
					CFM	ESP INWC	HP												
HP-1	ANCILLARY BLDG ROOF	BUS OPERATOR FACILITY A-03	LENNOX	15CHPXA36	1020	0.8	1/2	110	36,000	12.6/14	23,000	8.0	7.5	208/1/60	39.1	30	3/4	500	

ACCESSORIES: 12” ROOF CURB, COMMERCIAL PROGRAMMABLE THERMOSTAT, OUTSIDE AIR HOOD

Santa Clara Valley Transportation Authority



___NO EXCEPTIONS TAKEN (NET)
___MAKE CORRECTIONS NOTED (MCN)
___AMEND AND RESUBMIT (A/R)

Any action shown above is subject to the terms of the contract and does not relieve the Contractor of any of its obligations under the contract, including design and detailing.

Contract No.: DB11002F

By: Date:

--	--	
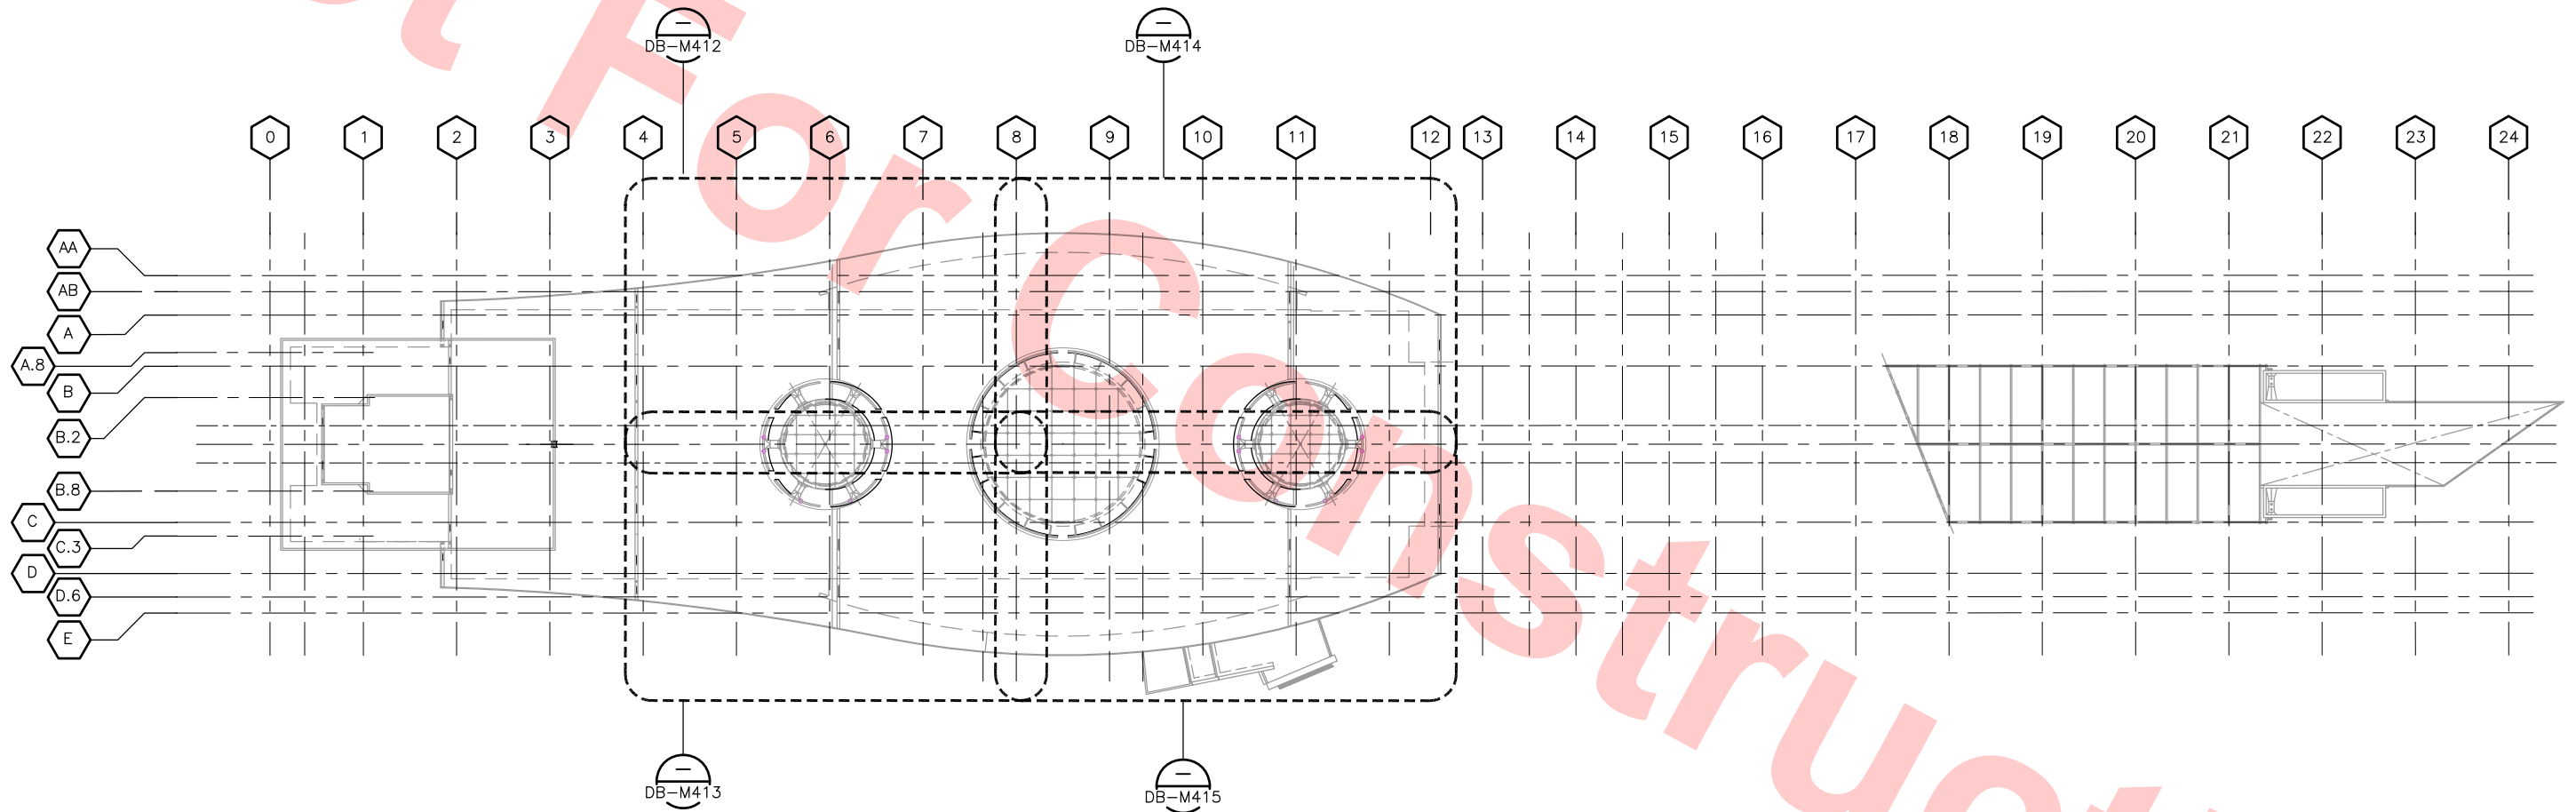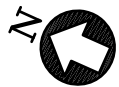

KEY PLAN ROOF LEVEL – HVAC
SCALE: 1/32"=1'-0"

Santa Clara Valley Transportation Authority

- ___ NO EXCEPTIONS TAKEN (NET)
- ___ MAKE CORRECTIONS NOTED (MCN)
- ___ AMEND AND RESUBMIT (A/R)

Any action shown above is subject to the terms of the contract and does not relieve the Contractor of any of its obligations under the contract, including design and detailing.

Contract No.: DB11002F

By: _____ Date: _____



DESIGNED BY	J. CHOU
DRAWN BY	J. CHOU
CHECKED BY	G. HENNINGS
IN CHARGE	G. HENNINGS
DATE	20130710

REV	DATE	BY	SUB	APP	DESCRIPTION
0	20130710				READINESS FOR CONSTRUCTION



Skanska Shimmick Herzog
1436 California Circle
Milpitas, California 95035
A Joint Venture

BCT Block Construction Inc.
4455 Enterprise St., Fremont, CA 94538
(510) 807-9888 Fax: (510) 807-9889
CA Lic. #679326 email: info@blockcorp.com


H&M Mechanical Group
8517 Eastmont Rd. #230
Oakland, CA 94621
510-569-2000

Lookwood, Andrews & Newman, Inc.
A LEOP A BALLY COMPANY
T-Y LIN INTERNATIONAL



LINE, TRACK, STATIONS AND SYSTEMS
DESIGN UNIT 023
MILPITAS STATION
KEY PLAN ROOF LEVEL
HVAC

CADD FILENAME		
C700-S-DB-M401.dwg		
SIZE	SCALE	
D	1/32"=1'-0"	
CONTRACT NO.		REV.
C700		0
AREA CODE	SHEET NO.	PAGE NO.
DB	M401	0746

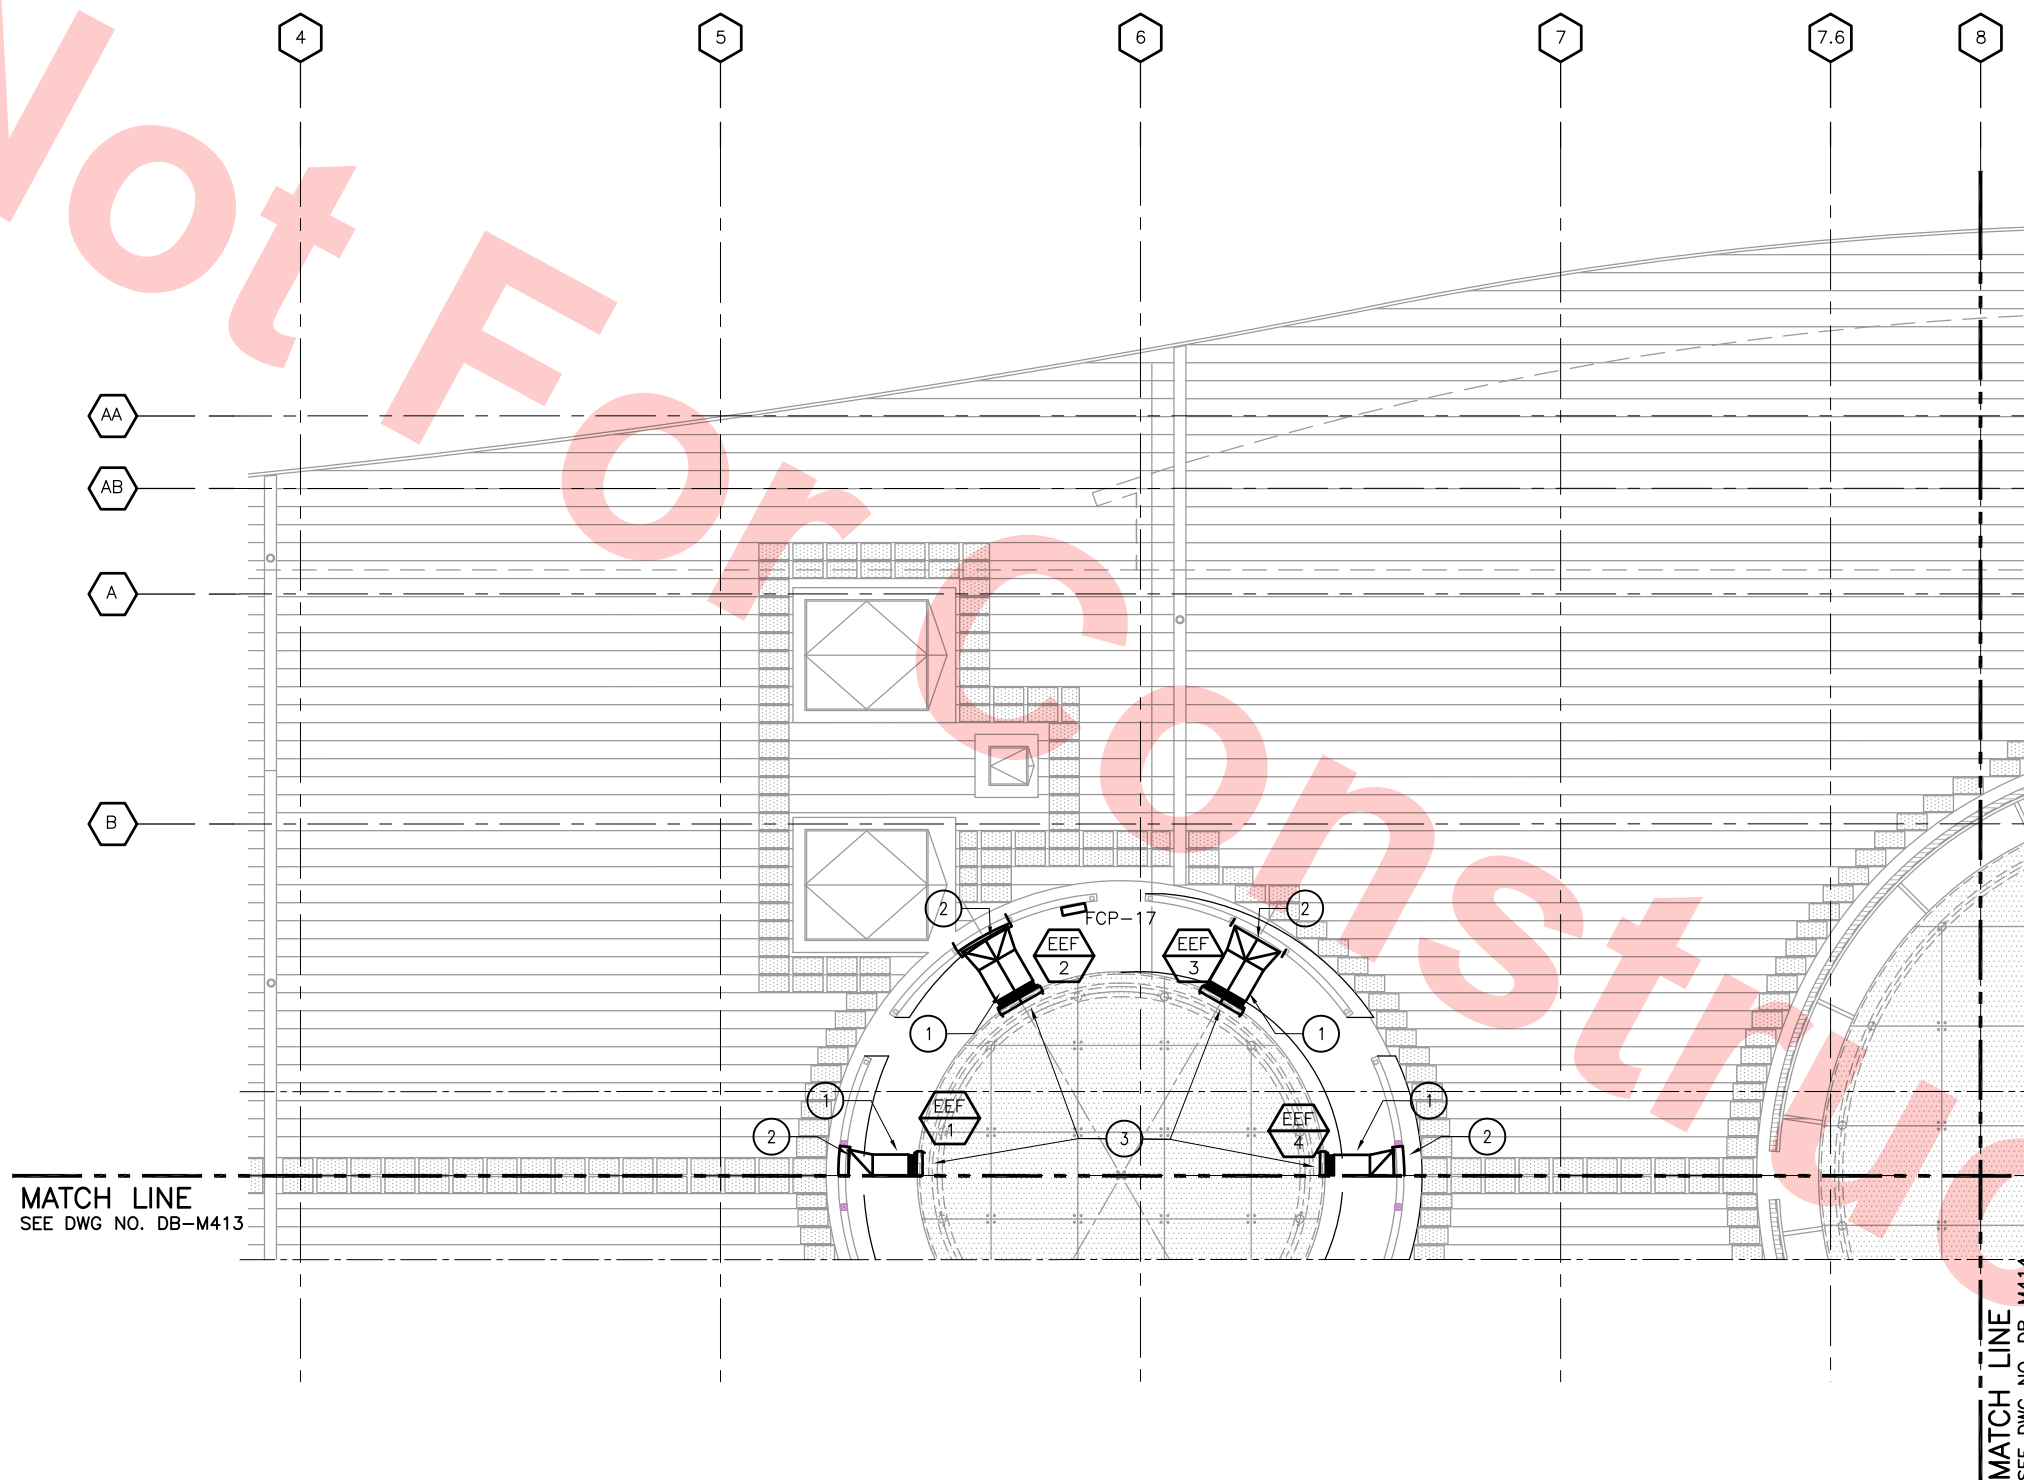

MATCH LINE
SEE DWG NO. DB-M413

MATCH LINE
SEE DWG NO. DB-M414

ROOF LEVEL PLAN — HVAC
SCALE: 1/8"=1'-0" DB-M401

KEY NOTES

- 1 SKYLIGHT SMOKE EVACUATION FAN WITH COUNTERBALANCED BACKDRAFT DAMPER, MOUNTED ON SPRING VIBRATION ISOLATORS. ALL DUCTWORK, FLEX CONNECTOR, FAN, INLET COVERING TO BE RATED FOR 482' CONDITIONS. SEE SHEET M364.
- 2 54x54 OUTLET WITH SCREEN MESH: 2x2 WITH NO 10 STUBS IRON WIRE GAUGE, STEEL WIRE. MOUNTING FLANGES SHALL BE HOT DIPPED GALVANIZED AFTER FABRICATION.
- 3 40x40 INLET WITH SCREEN MESH: 2x2 WITH NO 10 STUBS IRON WIRE GAUGE, STEEL WIRE. MOUNTING FLANGES SHALL BE HOT DIPPED GALVANIZED AFTER FABRICATION.

Santa Clara Valley Transportation Authority

- NO EXCEPTIONS TAKEN (NET)
- MAKE CORRECTIONS NOTED (MCN)
- AMEND AND RESUBMIT (A/R)


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Contract No.: DB11002F


By: _____ Date: _____



KEY ROOF PLAN

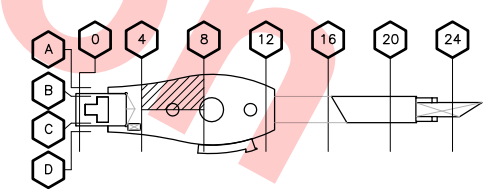

REV	DATE	BY	SUB	APP	DESCRIPTION
0	20130710				READINESS FOR CONSTRUCTION

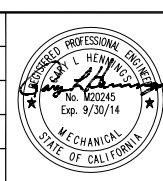

Skanska Shimmick Herzog

1436 California Circle
Milpitas, California 95035
A Joint Venture

Block Construction Inc.
4455 Enterprise St., Fremont, CA 94538
(510) 857-3666 Fax: (510) 857-3668
CA Lic. #679326 email: info@blockinc.com

H&M Mechanical Group
8517 Earhart Rd., #200
Oakland, CA 94621
510-569-2000

Lockwood, Andrews & Newnam, Inc.
A LEED A+ FIRM
T-Y-LIN INTERNATIONAL

Lockwood, Andrews & Newnam, Inc.
T-Y-LIN INTERNATIONAL



LINE, TRACK, STATIONS AND SYSTEMS
DESIGN UNIT 023
MILPITAS STATION
ROOF LEVEL PLAN
HVAC
SHEET 1 OF 4

CADD FILENAME C700-S-DB-M412.dwg		
SIZE D	SCALE 1/8"=1'-0"	
CONTRACT NO. C700	REV. 0	
AREA CODE DB	SHEET NO. M412	PAGE NO. 0747

KEY NOTES

- 1
- SKYLIGHT SMOKE EVACUATION FAN WITH COUNTERBALANCED BACKDRAFT DAMPER, MOUNTED ON SPRING VIBRATION ISOLATORS. ALL DUCTWORK, FLEX CONNECTOR, FAN, INLET COVERING TO BE RATED FOR 482" CONDITIONS.
- 2
- 54x54 OUTLET WITH SCREEN MESH: 2x2 WITH NO 10 STUBS IRON WIRE GAUGE, STEEL WIRE. MOUNTING FLANGES SHALL BE HOT DIPPED GALVANIZED AFTER FABRICATION.
- 3
- 40x40 INLET WITH SCREEN MESH: 2x2 WITH NO 10 STUBS IRON WIRE GAUGE, STEEL WIRE. MOUNTING FLANGES SHALL BE HOT DIPPED GALVANIZED AFTER FABRICATION.

Santa Clara Valley Transportation Authority

- NO EXCEPTIONS TAKEN (NET)
- MAKE CORRECTIONS NOTED (MCN)
- AMEND AND RESUBMIT (A/R)


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Contract No.: DB11002F

By: Date:



KEY ROOF PLAN

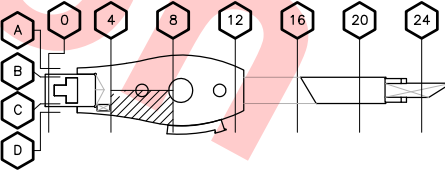

MATCH LINE
SEE DWG NO. DB-M412

ROOF LEVEL PLAN -- HVAC
SCALE: 1/8"=1'-0"
DB-M401

MATCH LINE
SEE DWG NO. DB-M415

REV	DATE	BY	SUB	APP	DESCRIPTION
0	20130710				READINESS FOR CONSTRUCTION



Skanska
Shimmick
Herzog

1436 California Circle
Milpitas, California 95035
A Joint Venture

Block Construction Inc.

4455 Enterprise St., Fremont, CA 94538
(510) 807-5666 Fax: (510) 807-3889
CA Lic. #679326 email: info@blockcorp.com

H&M Mechanical Group

8517 Eastert Rd. #230
Oakland, CA 94621
510-569-2000

Lookwood, Andrews
& Newnam, Inc.

A LEQ A BALLY COMPANY

T-Y-LIN INTERNATIONAL

APPROVED



LINE, TRACK, STATIONS AND SYSTEMS
DESIGN UNIT 023
MILPITAS STATION
ROOF LEVEL PLAN
HVAC
SHEET 2 OF 4

CADD FILENAME	C700-S-DB-M413.dwg
SIZE	SCALE
D	1/8"=1'-0"
CONTRACT NO.	C700
AREA CODE	DB
SHEET NO.	M413
PAGE NO.	0748

KEY NOTES

- 1 SKYLIGHT SMOKE EVACUATION FAN WITH COUNTERBALANCED BACKDRAFT DAMPER, MOUNTED ON SPRING VIBRATION ISOLATORS. ALL DUCTWORK, FLEX CONNECTOR, FAN, INLET COVERING TO BE RATED FOR 482" CONDITIONS.
- 2 54x54 OUTLET WITH SCREEN MESH: 2x2 WITH NO 10 STUBS IRON WIRE GAUGE, STEEL WIRE. MOUNTING FLANGES SHALL BE HOT DIPPED GALVANIZED AFTER FABRICATION.
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Santa Clara Valley Transportation Authority

- NO EXCEPTIONS TAKEN (NET)
MAKE CORRECTIONS NOTED (MCN)
AMEND AND RESUBMIT (A/R)


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Contract No.: DB11002F

By: Date:



KEY ROOF PLAN

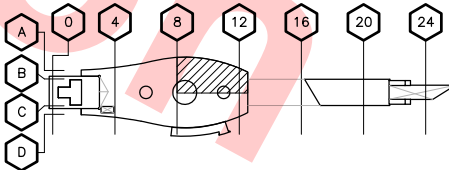

MATCH LINE
SEE DWG NO. DB-M415

MATCH LINE
SEE DWG NO. DB-M412

ROOF LEVEL PLAN -- HVAC

SCALE: 1/8"=1'-0"

DB-M410

REV	DATE	BY	SUB	APP	DESCRIPTION
0	20130710				READINESS FOR CONSTRUCTION

DESIGNED BY
J. CHOU
DRAWN BY
J. CHOU
CHECKED BY
G. HENNINGS
IN CHARGE
G. HENNINGS
DATE
20130710



Block Construction Inc.
4455 Enterprise St., Fremont, CA 94538
(510) 867-9888 Fax: (510) 867-9889
CA Lic. #679326 email: info@blockco.com

Skanska
Shimmick
Herzog
H&M Mechanical Group
8517 Eastert Rd. #230
Oakland, CA 94621
510-569-2000

1436 California Circle
Milpitas, California 95035
A Joint Venture

Lookwood, Andrews
& Newnam, Inc.
A LEQ A BALLY COMPANY

T-Y LIN INTERNATIONAL

APPROVED

By: [Signature]



LINE, TRACK, STATIONS AND SYSTEMS
DESIGN UNIT 023
MILPITAS STATION
ROOF LEVEL PLAN
HVAC
SHEET 3 OF 4

CADD FILENAME
C700-S-DB-M414.dwg
SIZE SCALE
D 1/8"=1'-0"
CONTRACT NO. C700 REV. 0
AREA CODE SHEET NO. PAGE NO.
DB M414 0749

KEY NOTES

- 1
- SKYLIGHT SMOKE EVACUATION FAN WITH COUNTERBALANCED BACKDRAFT DAMPER, MOUNTED ON SPRING VIBRATION ISOLATORS. ALL DUCTWORK, FLEX CONNECTOR, FAN, INLET COVERING TO BE RATED FOR 482" CONDITIONS.
- 2
- 54x54 OUTLET WITH SCREEN MESH: 2x2 WITH NO 10 STUBS IRON WIRE GAUGE, STEEL WIRE. MOUNTING FLANGES SHALL BE HOT DIPPED GALVANIZED AFTER FABRICATION.
- 3
- 40x40 INLET WITH SCREEN MESH: 2x2 WITH NO 10 STUBS IRON WIRE GAUGE, STEEL WIRE. MOUNTING FLANGES SHALL BE HOT DIPPED GALVANIZED AFTER FABRICATION.

Santa Clara Valley Transportation Authority

- NO EXCEPTIONS TAKEN (NET)

MAKE CORRECTIONS NOTED (MCN)

AMEND AND RESUBMIT (A/R)


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Contract No.: DB11002F

By: Date:



KEY ROOF PLAN

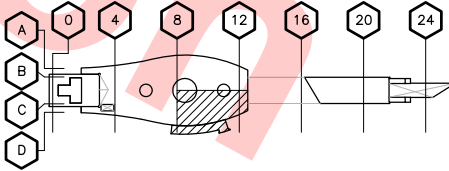

ROOF LEVEL PLAN -- HVAC
SCALE: 1/8"=1'-0" DB-M410

REV	DATE	BY	SUB	APP	DESCRIPTION
0	20130710				READINESS FOR CONSTRUCTION

DESIGNED BY
J. CHOU
DRAWN BY
J. CHOU
CHECKED BY
G. HENNINGS
IN CHARGE
G. HENNINGS
DATE
20130710



Block Construction Inc.
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Lookwood, Andrews
& Newnam, Inc.
A LEQ A BALLY COMPANY
1436 California Circle
Milpitas, California 95035
A Joint Venture

T-Y-LIN INTERNATIONAL
APPROVED
By: [Signature]



LINE, TRACK, STATIONS AND SYSTEMS
DESIGN UNIT 023
MILPITAS STATION
ROOF LEVEL PLAN
HVAC
SHEET 4 OF 4

CADD FILENAME C700-S-DB-M415.dwg	REV. 0
SIZE SCALE D 1/8"=1'-0"	
CONTRACT NO. C700	
AREA CODE DB	SHEET NO. M415
	PAGE NO. 0750

KEY NOTES

- 5 3" IW UP TO FD
- 8 2" VENT UP
- 9 3" FCO TO FINISH FLOOR
- 10 4" FCO TO FINISH FLOOR
- 19 3" RD TO SD
- 21 4" SS TO CIVIL
- 26 CW
- 42 SD TO CIVIL
- 45 CW UP
- 52 FUTURE FOR CONCESSIONS
- 58 3" AREA DRAIN
- 64 TO GREASE/OIL SEPERATOR

Santa Clara Valley Transportation Authority

NO EXCEPTIONS TAKEN (NET)


MAKE CORRECTIONS NOTED (MCN)

AMEND AND RESUBMIT (A/R)


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Contract No.: DB11002F

By: Date:

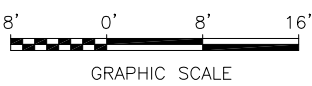

KEY PLAN

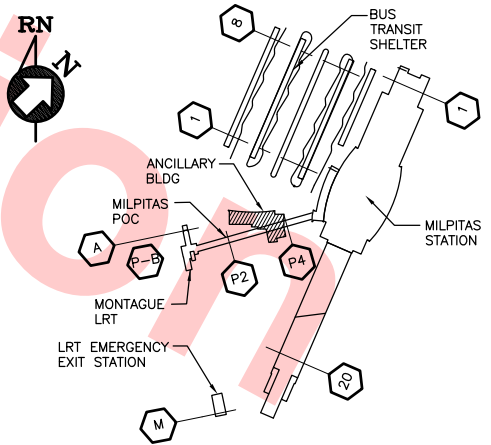

FIRST FLOOR PLAN – UNDERGROUND PLUMBING

SCALE: 1/8"=1'-0"

<div>DESIGNED BY P. BLAUVELT</div> <div>DRAWN BY P. BLAUVELT</div> <div>CHECKED BY G. HENNINGS</div> <div>IN CHARGE G. HENNINGS</div> <div>DATE 20130710</div>					<div></div> <div>Block Construction Inc. 4455 Enterprise St., Fremont, CA 94538 (510) 897-3688 Fax: (510) 897-3689 CA Lic. #679326 email: info@blockco.com</div>	<div>Skanska Shimmick Herzog</div> <div>1436 California Circle Milpitas, California 95035 A Joint Venture</div> <div> H&M Mechanical Group 8517 Easthart Rd, #230 Oakland, CA 94621 510-569-2000</div> <div> Lockwood, Andrews & Newnam, Inc. A LEO A DALY COMPANY</div> <div> T-Y-LIN INTERNATIONAL</div>	<div> BART SILICON VALLEY</div> <div>BART SILICON VALLEY BERRYESSA EXTENSION</div>	<div>LINE, TRACK, STATIONS AND SYSTEMS DESIGN UNIT 023 ANCILLARY BUILDING</div> <div>FIRST FLOOR PLAN UNDERGROUND PLUMBING</div>	<div>CADD FILENAME C700-S-DB-M810.dwg</div> <div>SIZE SCALE D 1/8"=1'-0"</div> <div>CONTRACT NO. C700</div> <div>REV. 0</div> <div>AREA CODE DB</div> <div>SHEET NO. M810</div> <div>PAGE NO. 0751</div>
<div>0 20130710 READINESS FOR CONSTRUCTION</div> <div>REV DATE BY SUB APP DESCRIPTION</div>									

KEY NOTES

- 19 ROOF DRAIN TO SD
- 23 3/4" HW & CW DN TO WATER HEATER, RELIEF PIPE TO MOP SINK,
- 25 3/4" HW & CW DN TO MOP SINK
- 28 CW TO TRAP PRIMERS
- 29 OFD FOR ROOF
- 33 OFD TO DAYLIGHT
- 38 VENT TO ROOF
- 52 FUTURE FOR CONCESSION
- 66 3/4" CONDENSATE FROM HP-1 ON ROOF TO SPILL TO MOPSINK

Santa Clara Valley Transportation Authority

- NO EXCEPTIONS TAKEN (NET)
- MAKE CORRECTIONS NOTED (MCN)
- AMEND AND RESUBMIT (A/R)


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Contract No.: DB11002F

By: Date:



KEY PLAN

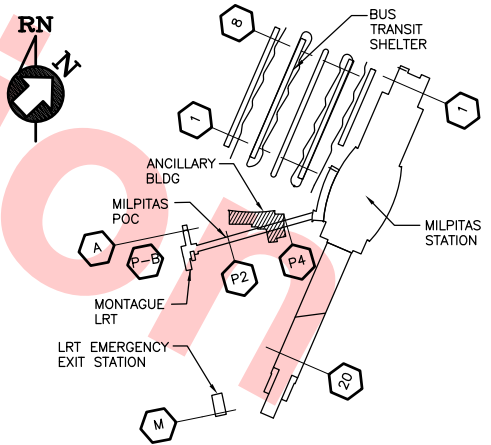

FIRST FLOOR PLAN — PLUMBING
SCALE: 1/8"=1'-0"

<div>DESIGNED BY P. BLAUVELT DRAWN BY P. BLAUVELT CHECKED BY G. HENNINGS IN CHARGE G. HENNINGS DATE 20130710</div>				<div></div>	<div>Skanska Shimmick Herzog 1436 California Circle Milpitas, California 95035 A Joint Venture</div>	<div></div>	<div></div>	<div>LINE, TRACK, STATIONS AND SYSTEMS DESIGN UNIT 023 ANCILLARY BUILDING FIRST FLOOR PLAN PLUMBING</div>	<div>CADD FILENAME C700-S-DB-M811.dwg SIZE SCALE D 1/8"=1'-0" CONTRACT NO. C700 REV. 0 AREA CODE DB SHEET NO. M811 PAGE NO. 0752</div>
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KEY NOTES

- 1 12" EXHAUST DUCT THRU ROOF TO GOOSENECK DISCHARGE
- 2 INLET LOUVER WITH NET FREE AREA OF 94 SQ FT MINIMUM, BOTTOM OPENING LOCATED @8" AFF
- 3 EXHAUST FROM EMERGENCY GENERATOR: CONNECT OUTLET OF RADIATOR WITH FLEX CONNECTOR TO 114x32 VERTICAL DUCT. AT 1' ABOVE GENERATOR RADIATOR TRANSITION TO (2)48x48 DUCTS THROUGH ROOF. PENETRATION THROUGH ROOF SHALL BE PROTECTED WITH 3 HOUR FIRE DAMPER.
- 4 18x18 INLET LOUVER, BOTTOM OF OPENING LOCATED @8" AFF, 3 HOUR FIRE DAMPER BEHIND
- 5 INLET LOUVER WITH NET FREE AREA OF 76 SQ FT MINIMUM, BOTTOM OPENING LOCATED @8" AFF

Santa Clara Valley Transportation Authority

- NO EXCEPTIONS TAKEN (NET)
- MAKE CORRECTIONS NOTED (MCN)
- AMEND AND RESUBMIT (A/R)


Any action shown above is subject to the terms of the contract and does not relieve the Contractor of any of its obligations under the contract, including design and detailing.

Contract No.: DB11002F

By: Date:



KEY PLAN

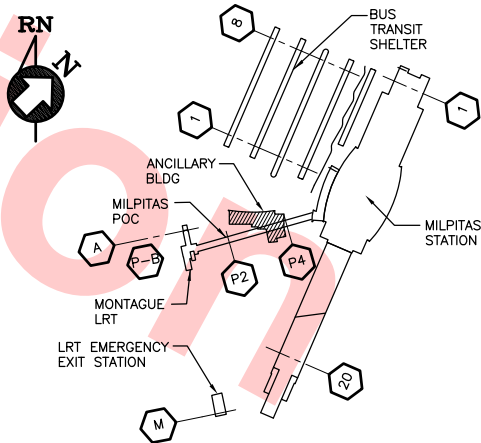

FIRST FLOOR PLAN — HVAC
SCALE: 1/8"=1'-0"

REV	DATE	BY	SUB	APP	DESCRIPTION
0	20130710				READINESS FOR CONSTRUCTION



Skanska Shimmick Herzog
1436 California Circle
Milpitas, California 95035
A Joint Venture

Block Construction Inc.
4405 Enterprise St., Fremont, CA 94538
(510) 897-3688 Fax: (510) 897-3689
CA Lic. #679326 email: info@blockcorp.com

H&M Mechanical Group
8517 Easthart Rd, #230
Oakland, CA 94621
510-569-2000

Lockwood, Andrews & Newnam, Inc.
A LEU A DAILY COMPANY
T-Y-LIN INTERNATIONAL
APPROVED *Ry Holmuth*



LINE, TRACK, STATIONS AND SYSTEMS
DESIGN UNIT 023
ANCILLARY BUILDING

FIRST FLOOR PLAN
HVAC

CADD FILENAME	C700-S-DB-M812.dwg
SIZE SCALE	D 1/8"=1'-0"
CONTRACT NO.	C700
AREA CODE	DB
SHEET NO.	M812
PAGE NO.	0753

KEY NOTES

- 1 48x48 GENERATOR EXHAUST AIR DUCT THRU ROOF. SEE DETAIL 1/M362
- 2 12" GOOSENECK DISCHARGE
- 3 EXHAUST FAN. SEE DETAIL 6/M362
- 4 PLUMBING VENT
- 5 FUEL TANK VENT
- 6 DAY TANK VENT

Santa Clara Valley Transportation Authority

- NO EXCEPTIONS TAKEN (NET)
- MAKE CORRECTIONS NOTED (MCN)
- AMEND AND RESUBMIT (A/R)


Any action shown above is subject to the terms of the contract and does not relieve the Contractor of any of its obligations under the contract, including design and detailing.

Contract No.: DB11002F

By: Date:



KEY PLAN

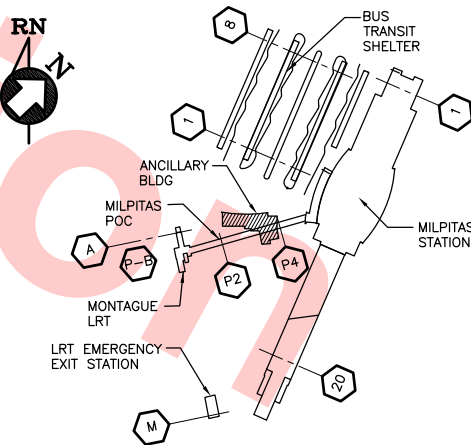

ROOF PLAN — HVAC
SCALE: 1/8"=1'-0"

REV	DATE	BY	SUB	APP	DESCRIPTION
0	20130710				READINESS FOR CONSTRUCTION

DESIGNED BY
J. CHOU
DRAWN BY
J. CHOU
CHECKED BY
G. HENNINGS
IN CHARGE
G. HENNINGS
DATE
20130710



Block Construction Inc.
4455 Enterprise St., Fremont, CA 94538
(510) 877-3688 Fax: (510) 877-3689
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Skanska
Shimmick
Herzog
H&M Mechanical Group
8517 Easthart Rd, #230
Oakland, CA 94621
510-569-2000

1436 California Circle
Milpitas, California 95035
A Joint Venture

Lockwood, Andrews
& Newnam, Inc.
A LEU A DALY COMPANY

T-Y-LIN INTERNATIONAL

APPROVED

Signature of T-Y-Lin International representative



BART SILICON VALLEY BERRYESSA EXTENSION

LINE, TRACK, STATIONS AND SYSTEMS
DESIGN UNIT 023
ANCILLARY BUILDING


ROOF PLAN
HVAC

CADD FILENAME C700-S-DB-M813.dwg	REV.
SIZE SCALE D 1/8"=1'-0"	0
CONTRACT NO. C700	
AREA CODE DB	SHEET NO. M813
	PAGE NO. 0754

1 DOWNSPOUT/RAINWATER LEADER
62 CW INTO BLD

1 DOWNSPOUT/RAINWATER LEADER
62 CW INTO BLD


By: _____ **Date:** _____

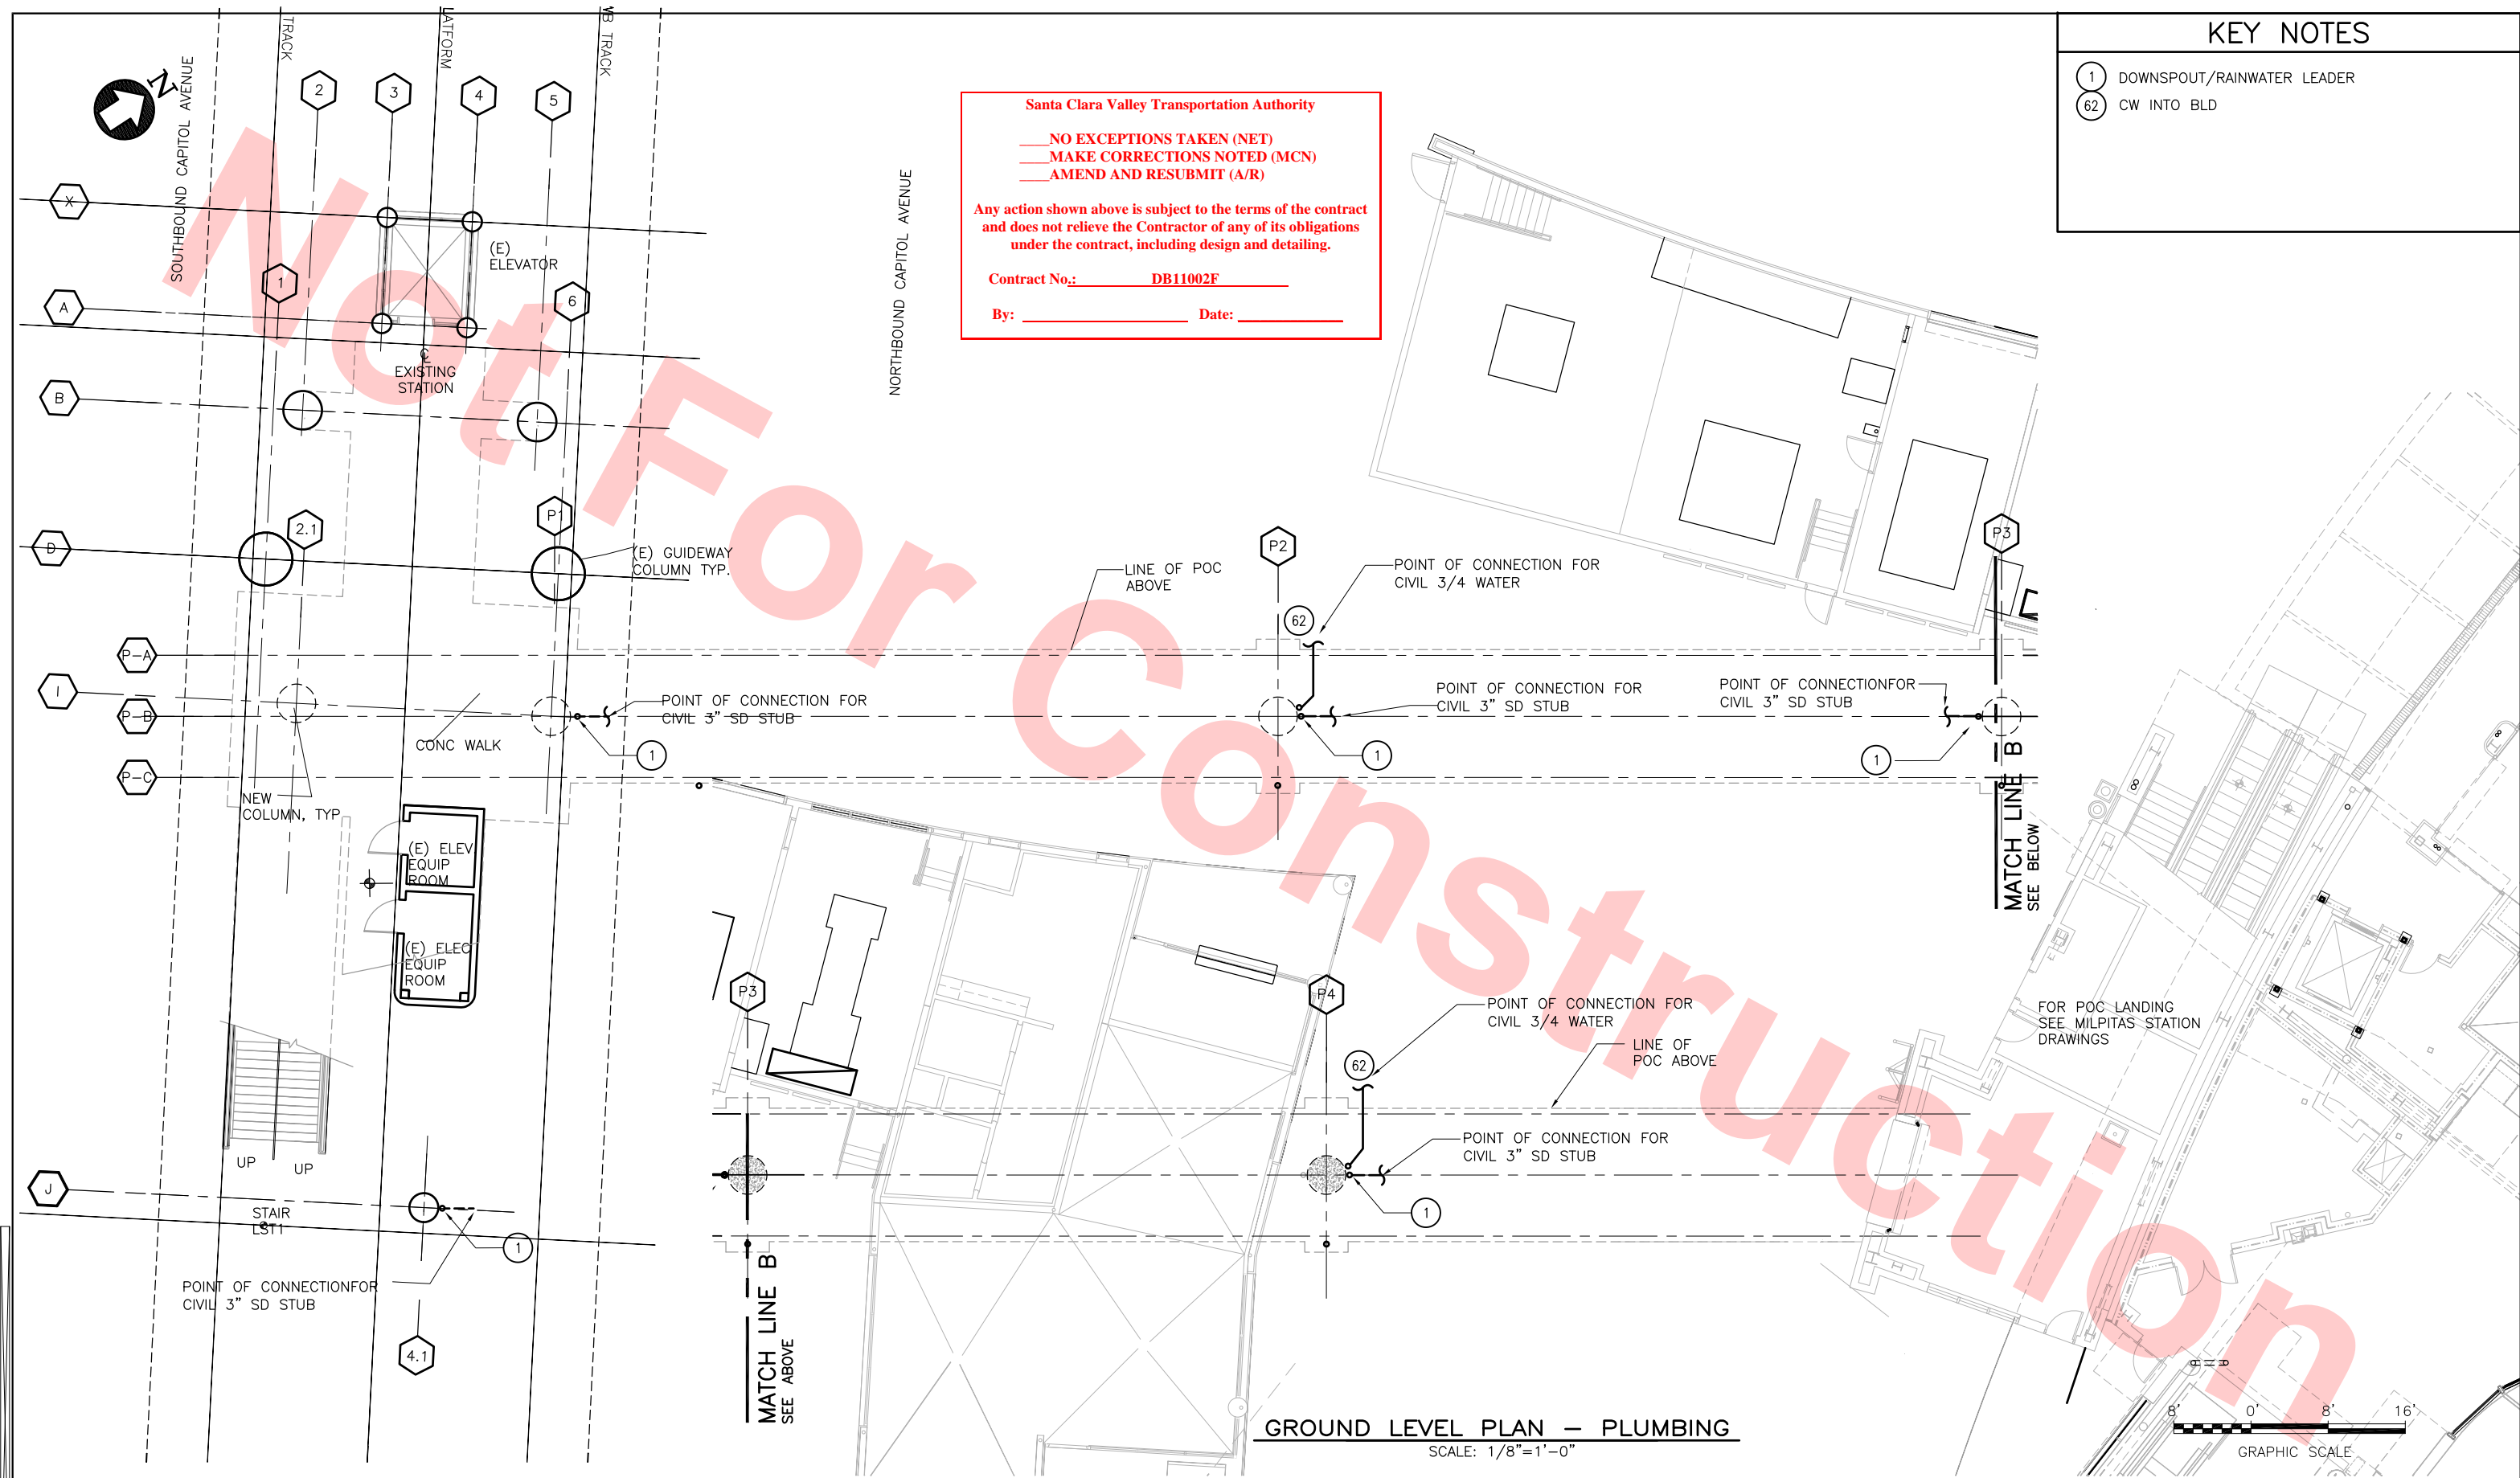

GROUND LEVEL PLAN – PLUMBING
SCALE: 1/8"=1'-0"

						DESIGNED BY P. BLAUVELT
						DRAWN BY P. BLAUVELT
						CHECKED BY G. HENNINGS
0	20130710				READINESS FOR CONSTRUCTION	IN CHARGE G. HENNINGS
REV	DATE	BY	SUB	APP	DESCRIPTION	DATE 20130710

DESIGNED BY	P. BLAUVELT
DRAWN BY	P. BLAUVELT
CHECKED BY	G. HENNINGS
IN CHARGE	G. HENNINGS
DATE	20130710

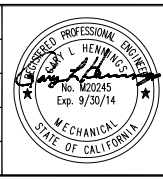

1436 California Circle
Milpitas, California 95035
A JOINT VENTURE

BCI Blockco Construction Inc.
4455 Enterprise St., Fremont, CA 94538
(510) 657-3686 Fax: (510) 657-3688
CA Lic. #679326 email: info@blockco.com

SUBMITTED

H&M H&M Mechanical Gro
8517 Earhart Rd, #2
Oakland, CA 946
510-569-2000


APPROVED  **Lookwood, Andrews & Newnam, Inc.** **T-Y-LIN INTERNATIONAL**
A LEO A. BAILY COMPANY



LINE, TRACK, STATIONS AND SYSTEMS
DESIGN UNIT 023
MONTAGUE LRT AND MILPITAS POC

GROUND LEVEL PLAN PLUMBING

CADD FILENAME C700-S-DB-M911.dwg		
SIZE D	SCALE 1/8"=1'-0"	
CONTRACT NO. C700		REV. 0
AREA CODE DB	SHEET NO. M911	PAGE NO. 0755

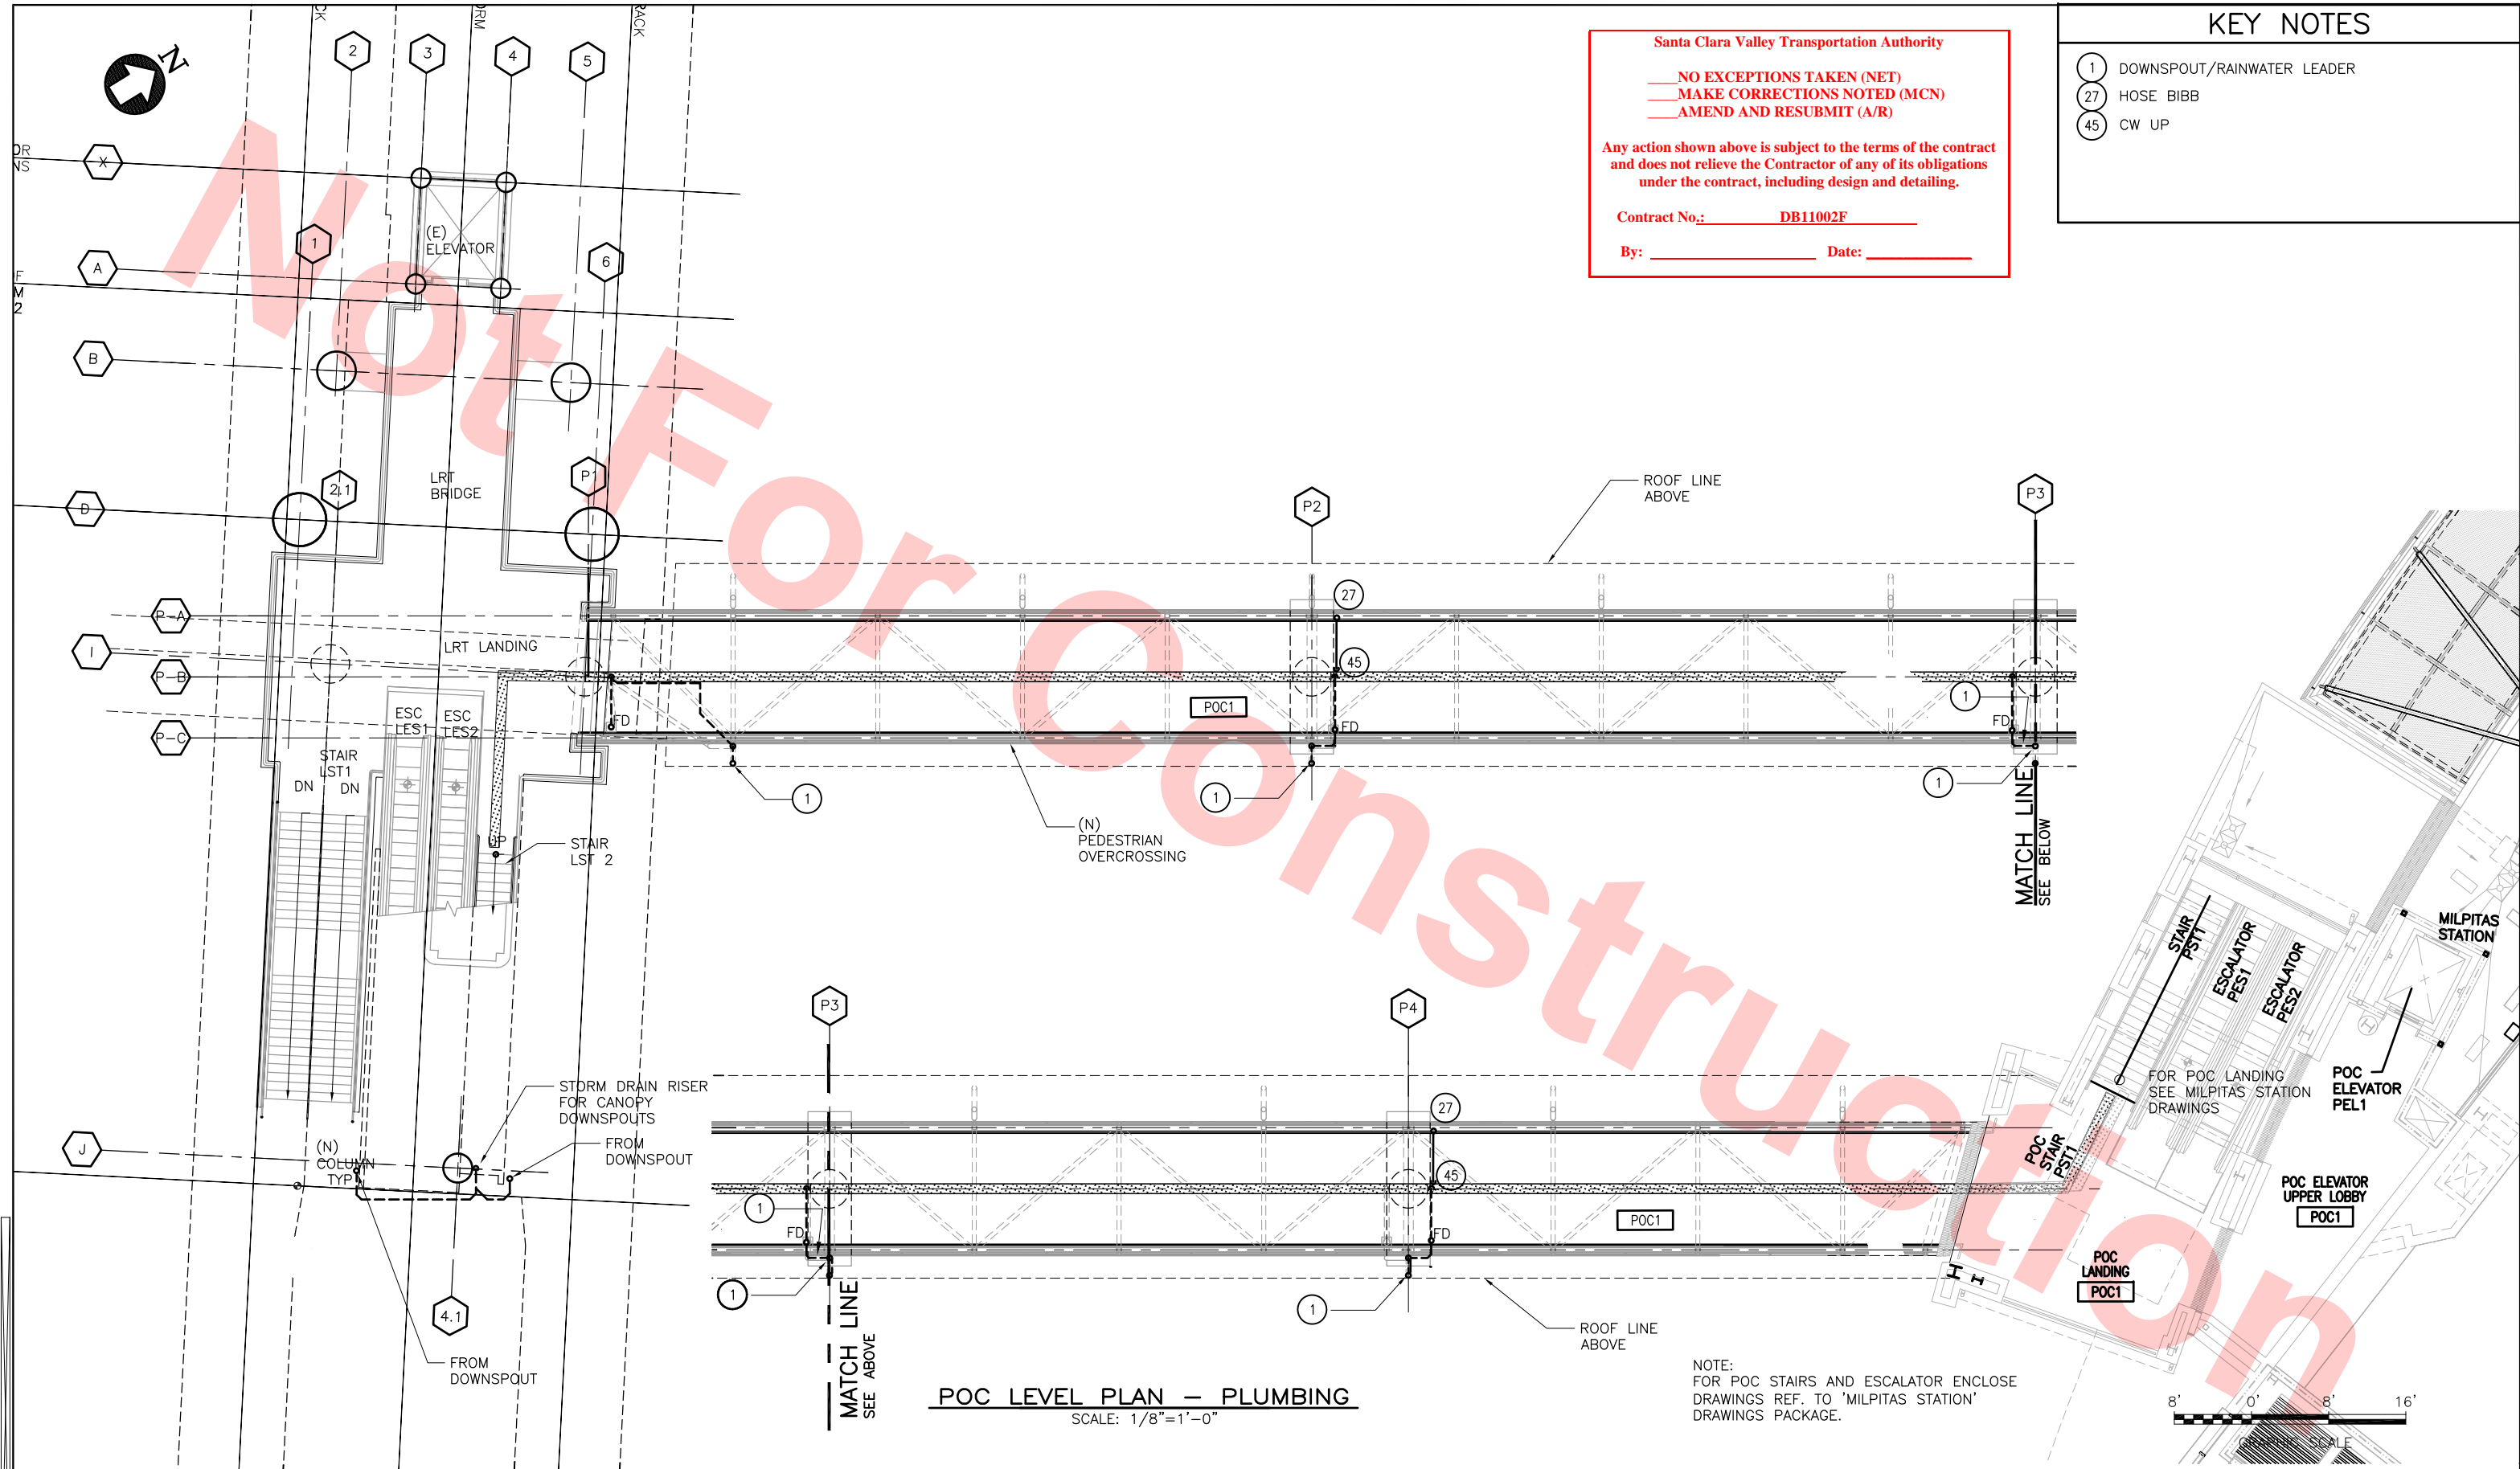

Santa Clara Valley Transportation Authority

NO EXCEPTIONS TAKEN (NET)
MAKE CORRECTIONS NOTED (MCN)
AMEND AND RESUBMIT (A/R)

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Contract No.: DB11002F

By: _____ Date: _____

KEY NOTES	
1	DOWNSPOUT/RAINWATER LEADER
27	HOSE BIBB
45	CW UP

DESIGNED BY P. BLAUVELT	0	20130710	READINESS FOR CONSTRUCTION
DRAWN BY P. BLAUVELT	REV	DATE	DESCRIPTION
CHECKED BY G. HENNINGS	BY	SUB	APP
IN CHARGE G. HENNINGS			
DATE 20130710			



Skanska
Shimmick
Herzog

1436 California Circle
Milpitas, California 95035
A Joint Venture

Block Construction Inc.

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CA Lic. #679326 email: info@blockco.com

HMM Mechanical Group

8517 Eastport Rd. #230
Oakland, CA 94621
510-569-2000

Lookwood, Andrews
& Nowman, Inc.

A LEOP A DAILY COMPANY

T-Y-LIN INTERNATIONAL

APPROVED

BART
SILICON VALLEY

BART SILICON VALLEY BERRYESSA EXTENSION

LINE, TRACK, STATIONS AND SYSTEMS
DESIGN UNIT 023
MONTAGUE LRT AND MILPITAS POC

POC LEVEL PLAN
PLUMBING

CADD FILENAME
C700-S-DB-M912.dwg


SIZE SCALE
D 1/8"=1'-0"

CONTRACT NO.
C700

AREA CODE
DB

SHEET NO.
M912

PAGE NO.
0756

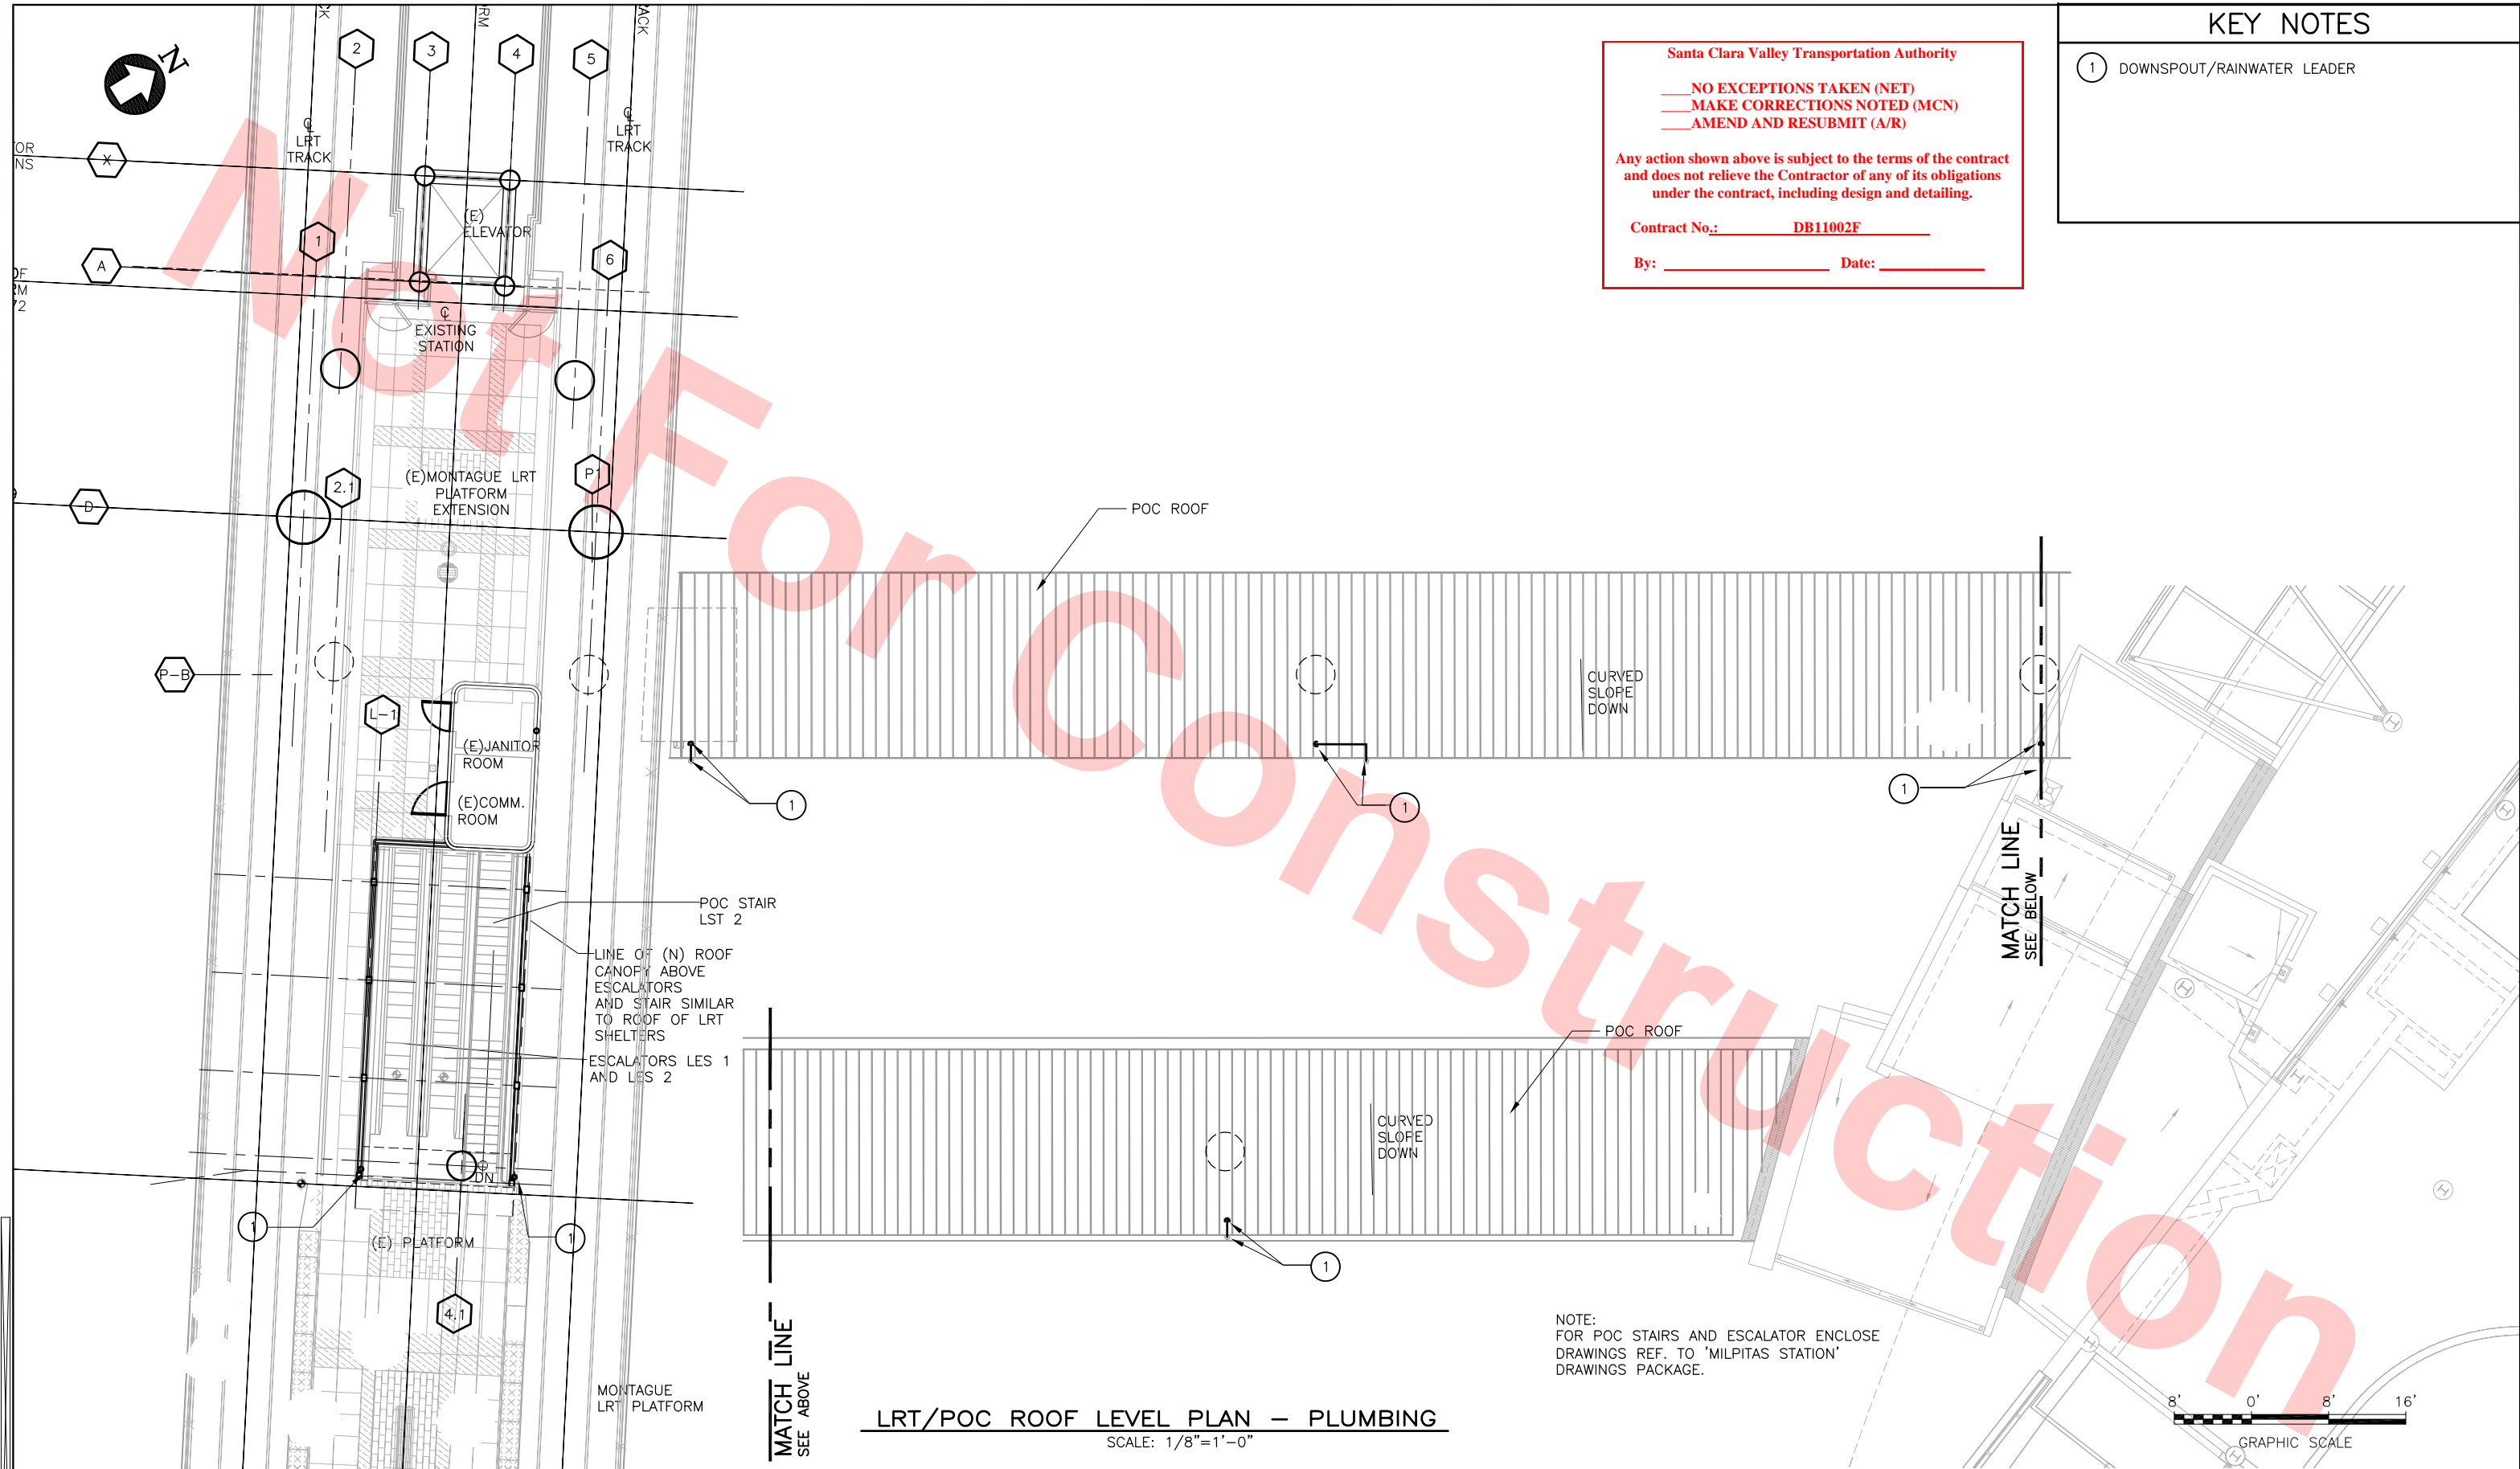

KEY NOTES

- 1 DOWNSPOUT/RAINWATER LEADER

Santa Clara Valley Transportation Authority

- NO EXCEPTIONS TAKEN (NET)
- MAKE CORRECTIONS NOTED (MCN)
- AMEND AND RESUBMIT (A/R)


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Contract No.: DB11002F


By: Date:

LRT/POC ROOF LEVEL PLAN — PLUMBING
SCALE: 1/8"=1'-0"

NOTE:
FOR POC STAIRS AND ESCALATOR ENCLOSE
DRAWINGS REF. TO 'MILPITAS STATION'
DRAWINGS PACKAGE.

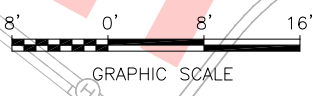

REV	DATE	BY	SUB	APP	DESCRIPTION
0	20130710				READINESS FOR CONSTRUCTION

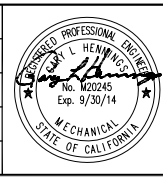

DESIGNED BY
P. BLAUVELT
DRAWN BY
P. BLAUVELT
CHECKED BY
G. HENNINGS
IN CHARGE
G. HENNINGS
DATE
20130710

Skanska
Shimmick
Herzog

1436 California Circle
Milpitas, California 95035
A Joint Venture


HMM Mechanical Group
8517 Earhart Rd. #230
Oakland, CA 94621
510-569-2000

Lockwood, Andrews
& Newnam, Inc.
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SUBMITTED

APPROVED



LINE, TRACK, STATIONS AND SYSTEMS
DESIGN UNIT 023
MONTAGUE LRT AND MILPITAS POC

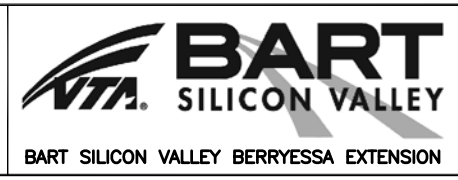POC LEVEL PLAN
PLUMBING

CADD FILENAME C700-S-DB-M913.dwg	REV. 0
SIZE D	SCALE 1/32"=1'-0"
CONTRACT NO. C700	SHEET NO. M913
AREA CODE DB	PAGE NO. 0757

KEY NOTES

1 DOWNSPOUT/RAINWATER LEADER

Santa Clara Valley Transportation Authority

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By: Date:

