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Milpitas Station Fire Protection Design Unit 023 – Work Package 03 Definitive Design


SVBX C700

Monday, February 11, 2013

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PAGE REV NO. TITLE NO. NO.

GENERAL (MILPITAS STATION, ANCILLARY BUILDING, AND TRANSIT CENTER BUS SHELTER)

DB-X001

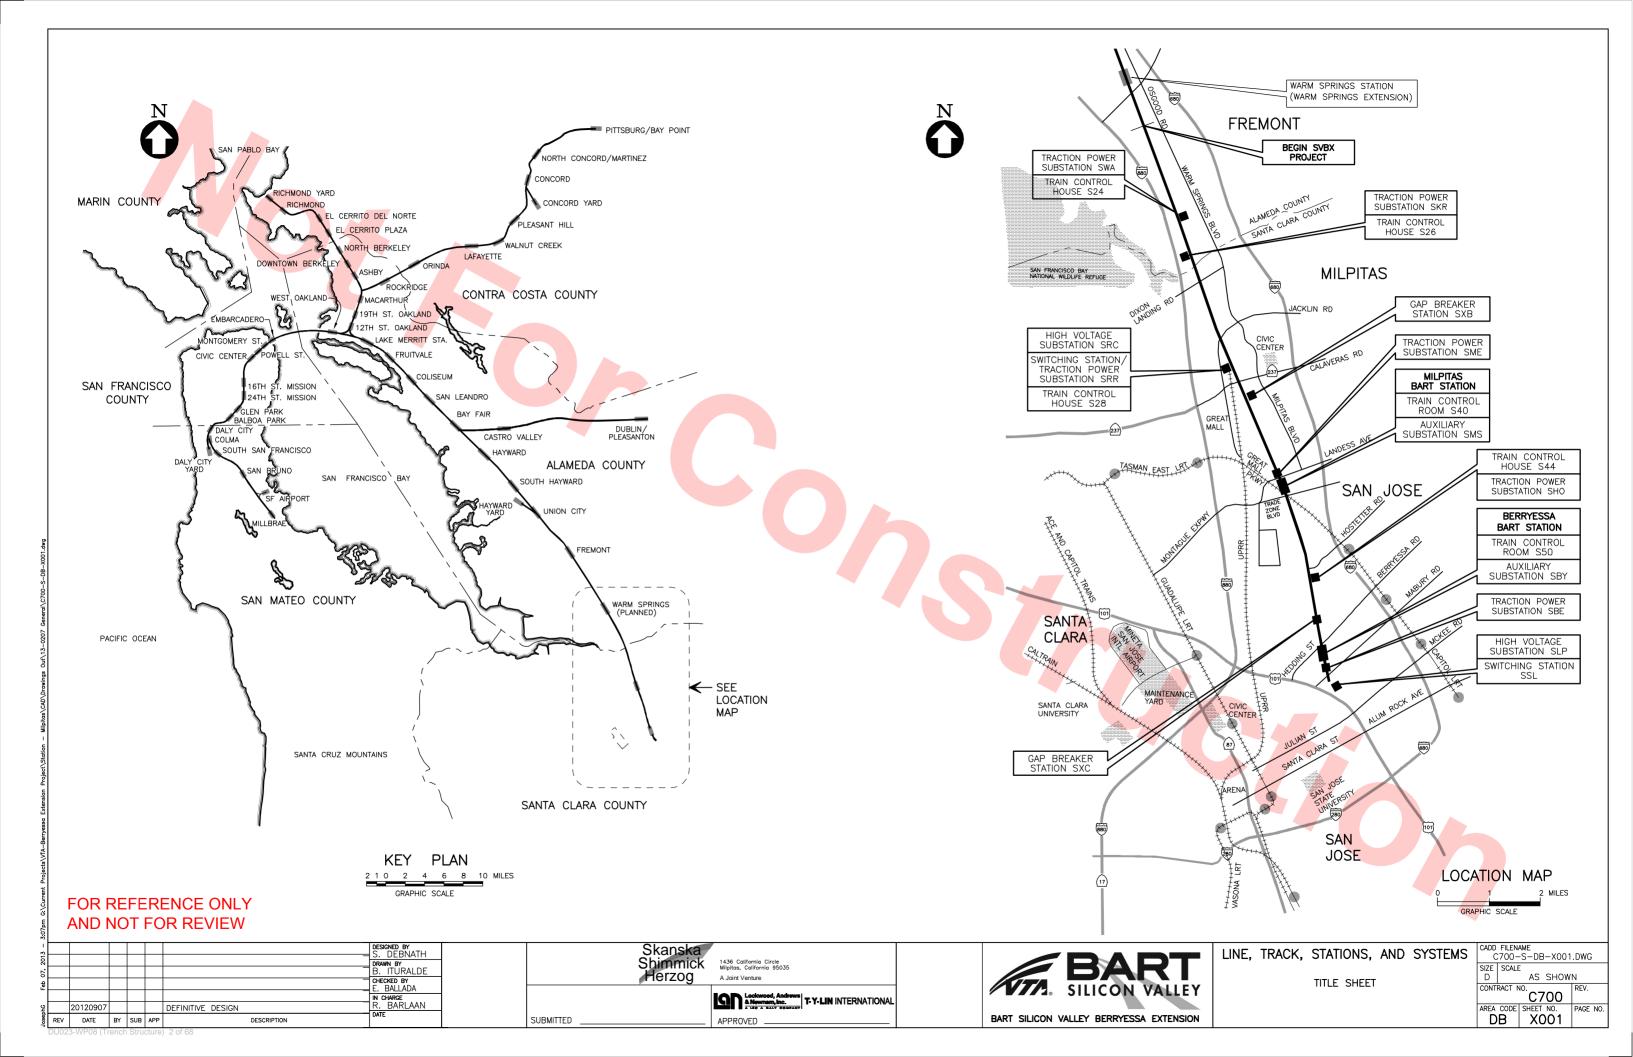TITLE SHEETS

DB-X027

INDEX OF DRAWINGS

DB-X030

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INDEX OF DRAWINGS

FOR REFERENCE ONLY AND NOT FOR REVIEW

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Lockwood, Andrews & Newman, Inc.

A Newman, Inc.

T-Y-LIN INTERNATIONAL





LINE, TRACK, STATIONS, AND SYSTEM MILPITAS STATION

INDEX OF DRAWINGS

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MILPITAS STATION - FIRE SUPPRESSION AND DETECTION

DB-M460

FM-200 FIRE DETECTION SUPPRESSION AND CONTROL

BILL OF MATERIALS/SEQUENCE OF OPERATION

FM-200 FIRE DETECTION DB-M461

SUPPRESSION AND CONTROL ELECTRICAL LAYOUT

FM-200 FIRE DETECTION SUPPRESSION AND CONTROL DB-M462

MECHANICAL LAYOUT

FM-200 FIRE DETECTION SUPPRESSION AND CONTROL DB-M463

RISER DIAGRAM

FM-200 FIRE DETECTION SUPPRESSION AND CONTROL

FOR REFERENCE ONLY AND NOT FOR REVIEW

DESIGNED BY S. DEBNATH RAWN BY B. ITURALDE CHECKED BY E. BALLADA DEFINITIVE DESIGN n charge R. BARLAAN DESCRIPTION

Skanska Shimmick Herzog

Lockwood, Andrews & Newman, Inc.

A Newman, Inc.

T-Y-LIN INTERNATIONAL





LINE, TRACK, STATIONS, AND SYSTEMS MILPITAS STATION

INDEX OF DRAWINGS

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Anil Verma Associates, Inc.
1970 Broodway, Suite 525 Ookkand, CA 94612
Phone: (510) 535-2537 Fax: (510) 535-2339

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				DB-M630		KEY PLAN CONCOURSE LEVEL FIRE PROTECTION		DB-M665		CONCOURSE LEVEL FIRE PROTECTION RCP SHEFT 5 OF 6
MILPITAS	S STATION — F	IRE PROTECTION		DB-M631		CONCOURSE LEVEL PLAN FIRE PROTECTION PIPING SHEET 1 OF 8		DB-M668		CONCOURSE LEVEL FIRE PROTECTION RCP
	COVER SHEET	GENERAL NOTES AND ABBREVIATIONS		DB-M632		CONCOURSE LEVEL PLAN FIRE PROTECTION PIPING		DB-M670		SHEET 6 OF 6 KEY PLAN
	DB-M600	FIRE PROTECTION FIRE DETAILS		DB-M633		SHEET 2 OF 8 CONCOURSE LEVEL PLAN FIRE PROTECTION PIPING				CONCOURSE LEVEL - HIGH CEILING FIRE PROTECTION
	DB-M602	- FIRE PROTECTION HANGER AND BRACING DETAILS		DB-M634		SHEET 3 OF 8 CONCOURSE LEVEL PLAN		DB-M671		CONCOURSE LEVEL PLAN FIRE PROTECTION RCP SHEET 1 OF 4
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		- FIRE PROTECTION		DB-M635		CONCOURSE LEVEL PLAN FIRE PROTECTION PIPING SHEET 5 OF 8		DB-M673		CONCOURSE LEVEL PLAN FIRE PROTECTION RCP
	PLANS DB-M610	KEY PLAN TRACK LEVEL		DB-M636		CONCOURSE LEVEL PLAN FIRE PROTECTION PIPING SHEET 6 OF 8		DB-M674		SHEET 3 OF 4 CONCOURSE LEVEL PLAN
		FIRE PROTECTION PLAN		DB-M637		CONCOURSE LEVEL PLAN				FIRE PROTECTION RCP SHEET 4 OF 4
	DB-M611	TRACK LEVEL PLAN — FIRE PROTECTION PIPING — SHEET 1 OF 6				FIRE PROTECTION PIPING SHEET 7 OF 8		DB-M681		TRANSVERSE SECTION FIRE PROTECTION SHEET 1 OF 3
	DB-M612 DB-M613	TRACK LEVEL PLAN — FIRE PROTECTION PIPING — SHEET 2 OF 6 TRACK LEVEL PLAN — FIRE PROTECTION		DB-M638		CONCOURSE LEVEL PLAN FIRE PROTECTION PIPING SHEET 8 OF 8		DB-M683		TRANSVERSE SECTION FIRE PROTECTION
	DB-M614	PIPING - SHEET 3 OF 6 TRACK LEVEL PLAN - FIRE PROTECTION		DB-M650		KEY PLAN PLATFORM LEVEL FIRE PROTECTION		DB-M684		SHEET 2 OF 3 TRANSVERSE SECTION
		PIPING - SHEET 4 OF 6		DB-M651		PLATFORM LEVEL				FIRE PROTECTION SHEET 3 OF 3
	DB-M615	TRACK LEVEL PLAN — FIRE PROTECTION PIPING — SHEET 5 OF 6				FIRE PROTECTION RCP SHEET 1 OF 6	ANCILLARY	BUILDING -	FIRE I	PROTECTION
	DB-M616 DB-M620	TRACK LEVEL PLAN — FIRE PROTECTION PIPING — SHEET 6 OF 6 KEY PLAN PLATFORM LEVEL		DB-M652		PLATFORM LEVEL FIRE PROTECTION RCP SHEET 2 OF 6		DB-M810		ANCILLARY BUILDING SITE PLAN FIRE PROTECTION
	DB-M621	FIRE PROTECTION PLATFORM LEVEL PLAN		DB-M653		PLATFORM LEVEL FIRE PROTECTION RCP SHEET 3 OF 6		DB-M811		ANCILLARY BUILDING FIRST FLOOR PLAN FIRE PROTECTION PIPING
	DB-M622	FIRE PROTECTION PIPING SHEET 1 OF 6 PLATFORM LEVEL PLAN		DB-M654		PLATFORM LEVEL FIRE PROTECTION RCP SHEET 4 OF 6		DB-M813		ANCILLARY BUILDING FIRST FLOOR
	DB WOZZ	FIRE PROTECTION PIPING SHEET 2 OF 6		DD 11055				DB-M822		FIRE PROTECTION RCP ANCILLARY BUILDING
	DB-M623	PLATFORM LEVEL PLAN FIRE PROTECTION PIPING SHEET 3 OF 6		DB-M655		PLATFORM LEVEL FIRE PROTECTION RCP SHEET 5 OF 6				SECTIONS FIRE PROTECTION
	DB-M624	PLATFORM LEVEL PLAN		DB-M656		PLATFORM LEVEL	LRT/POC	- FIRE PRO	TECTION	
	DB-M625	FIRE PROTECTION PIPING SHEET 4 OF 6 PLATFORM LEVEL PLAN				FIRE PROTECTION RCP SHEET 6 OF 6		DB-M902		MONTAGUE LRT AND MILPITAS POC LRT PLATFORM/POC ROOF LEVEL OVERALL PLAN FIRE PROTECTION
	DB WO23	FIRE PROTECTION PIPING SHEET 5 OF 6		DB-M660		KEY PLAN CONCOURSE LEVEL FIRE PROTECTION		DB-M911		MONTAGUE LRT AND MILPITAS POC GROUND LEVEL PLAN
	DB-M626	PLATFORM LEVEL PLAN FIRE PROTECTION PIPING SHEET 6 OF 6		DB-M661		CONCOURSE LEVEL FIRE PROTECTION RCP SHEET 1 OF 6		DB-M912		FIRE PROTECTION PIPING SHEET 1 OF 2 MONTAGUE LRT AND MILPITAS POC POC LEVEL PLAN
				DB-M662		CONCOURSE LEVEL FIRE PROTECTION RCP				FIRE PROTECTION PIPING SHEET 2 OF 2
				DB-M663		SHEET 2 OF 6 CONCOURSE LEVEL FIRE PROTECTION RCP		DB-M920		MONTAGUE LRT AND MILPITAS POC POC SECTION - FIRE PROTECTION PIPING SHEET 1 OF 2
				DB-M664		SHEET 3 OF 6 CONCOURSE LEVEL		DB-M922		MONTAGUE LRT AND MILPITAS POC POC SECTIONS — FIRE PROTECTION PIPING SHEET 2 OF 2
FOR	REFEREN	ICF ONLY				FIRE PROTECTION RCP SHEET 4 OF 6				SHLLI Z VI Z
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Shimmick Herzog

Anil Verma Associates, Inc. 1970 Brootway, Suite 525 Ookland, CA 94612 Phone: (510) 535-2537 Fax: (510) 535-2339

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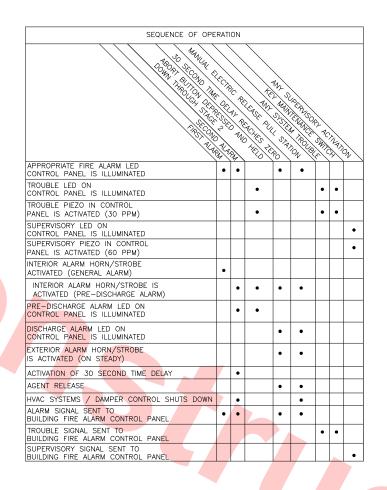


LINE, TRACK, STATIONS, AND SYSTEMS
MILPITAS STATION

INDEX OF DRAWINGS

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				_	BULL OF LUTERULO		
TELL			VES	lam.	BILL OF MATERIALS		
ITEM	\rightarrow	PART NUMBER	MFG.	QTY	DESCRIPTION	LISTEE MODEL	CSFM LISTING NO.
1	\bowtie	99248	JANUS		ADDRESSABLE RELEASING PANEL	JFS-A1	7165-0328:0195
2		18712	JANUS		EOL RESISTOR/DIODE ASSEMBLY FOR RELEASING	18712	7100 0020.0100
3		18703	JANUS		MANUAL PULL STATION	SG-42SK1	7150-1408:0107
4	♦	99238	JANUS		ADDRESSABLE PHOTOELECTRIC SMOKE DETECTOR	PSA	7272-0328:0194
5	_	99234	JANUS		DETECTOR BASE	AB-6	7272-0326.0134
6	MM	99244	JANUS		MINI MODULE	мсм	
7	_	99239	JANUS		MONITORED MODUEL	MOM-4	7165-0328:0196
8	DM	99242	JANUS		DUAL MODUEL	DCM-4	7100 0020.0100
9	TR	99245	JANUS		TWIN RELAY MODULE	TRM-4	
10	¥ΗZS	500-650226	SIEMENS		HORN STROBE (WALL)	MTH-MC-R-AR	7135-0067:0250
11	ZΣ	500-650224	SIEMENS		STROBE (WALL)	ST-MC-R-AR	7125-0067:0252
12	Œ	500-688449	SIEMENS		6" BELL	MBDC-6	7135-0067:0137
13	•	GEM-MR-ABORT2	GEM-COM		ABORT SWITCH	GEM-MR-ABORT2	
14	8-□	GEM-MAINT	GEM-COM		KEY MAINTENANCE SWITCH	GEM-MAINT	
15	0				LB CYL. FILLED WITH LBS OF FM-200 INCLUDES: LOW-PRESSURE SWITCH & PRESSURE GAUGE		
16	0		JANUS		LB CYL. FILLED WITH LBS OF FM-200 INCLUDES: LOW-PRESSURE SWITCH & PRESSURE GAUGE		
17	_	18481	JANUS		ELECTRIC VALVE ACTUATOR	18481	
18	_	17001	JANUS		MANUAL VALVE ACTUATOR	17001	
19	_						
20	PS	18773	JANUS		DISCHARGE PRESSURE SWITCH, W/ 1/2" CONDUIT CONNECTION	18773	
21	_						
22	_						
23	_	12V/75AH			SEALED LEAD ACID / SLA BATTERIES	12V/75AH	
24	_						



						DESIGNED BY G.HAYES	
						DRAWN BY	
						A.CORTEZ	
						CHECKED BY S.GALVAN	1
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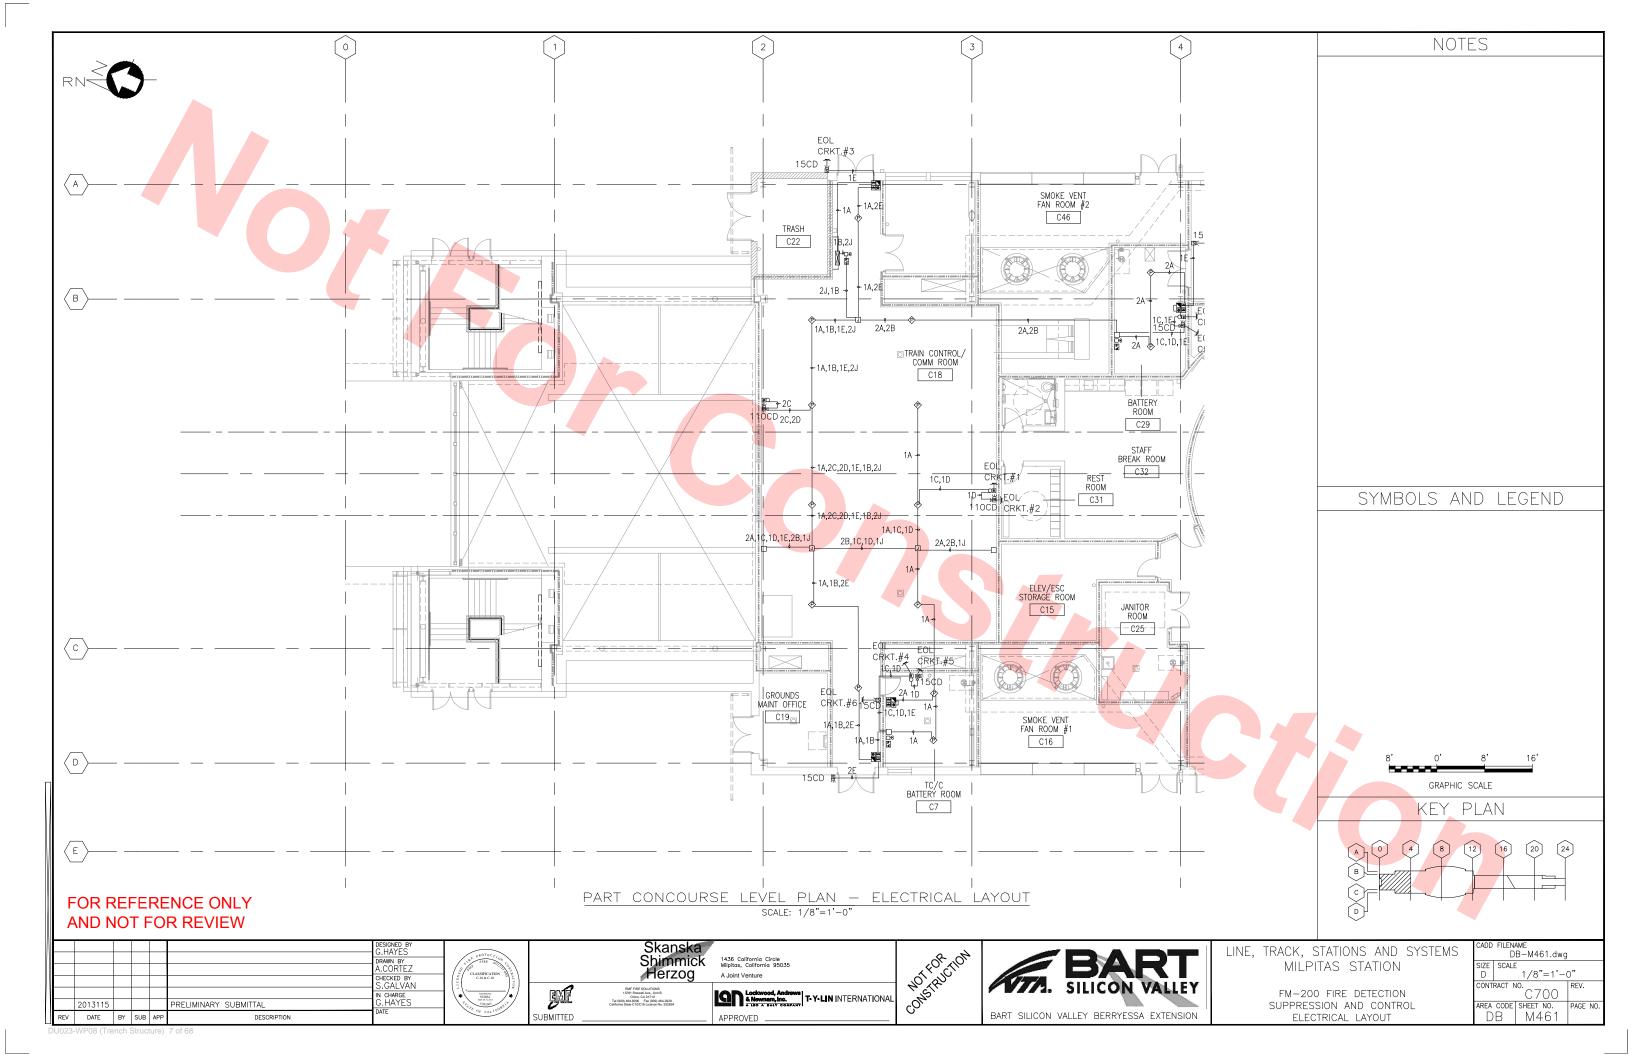






LINE, TRACK, STATIONS AND SYSTEM MILPITAS STATION


FM-200 FIRE DETECTION SUPPRESSION AND CONTROL BILL OF MATERIALS / SEQUENCE OF OPERAT

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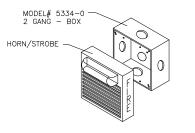




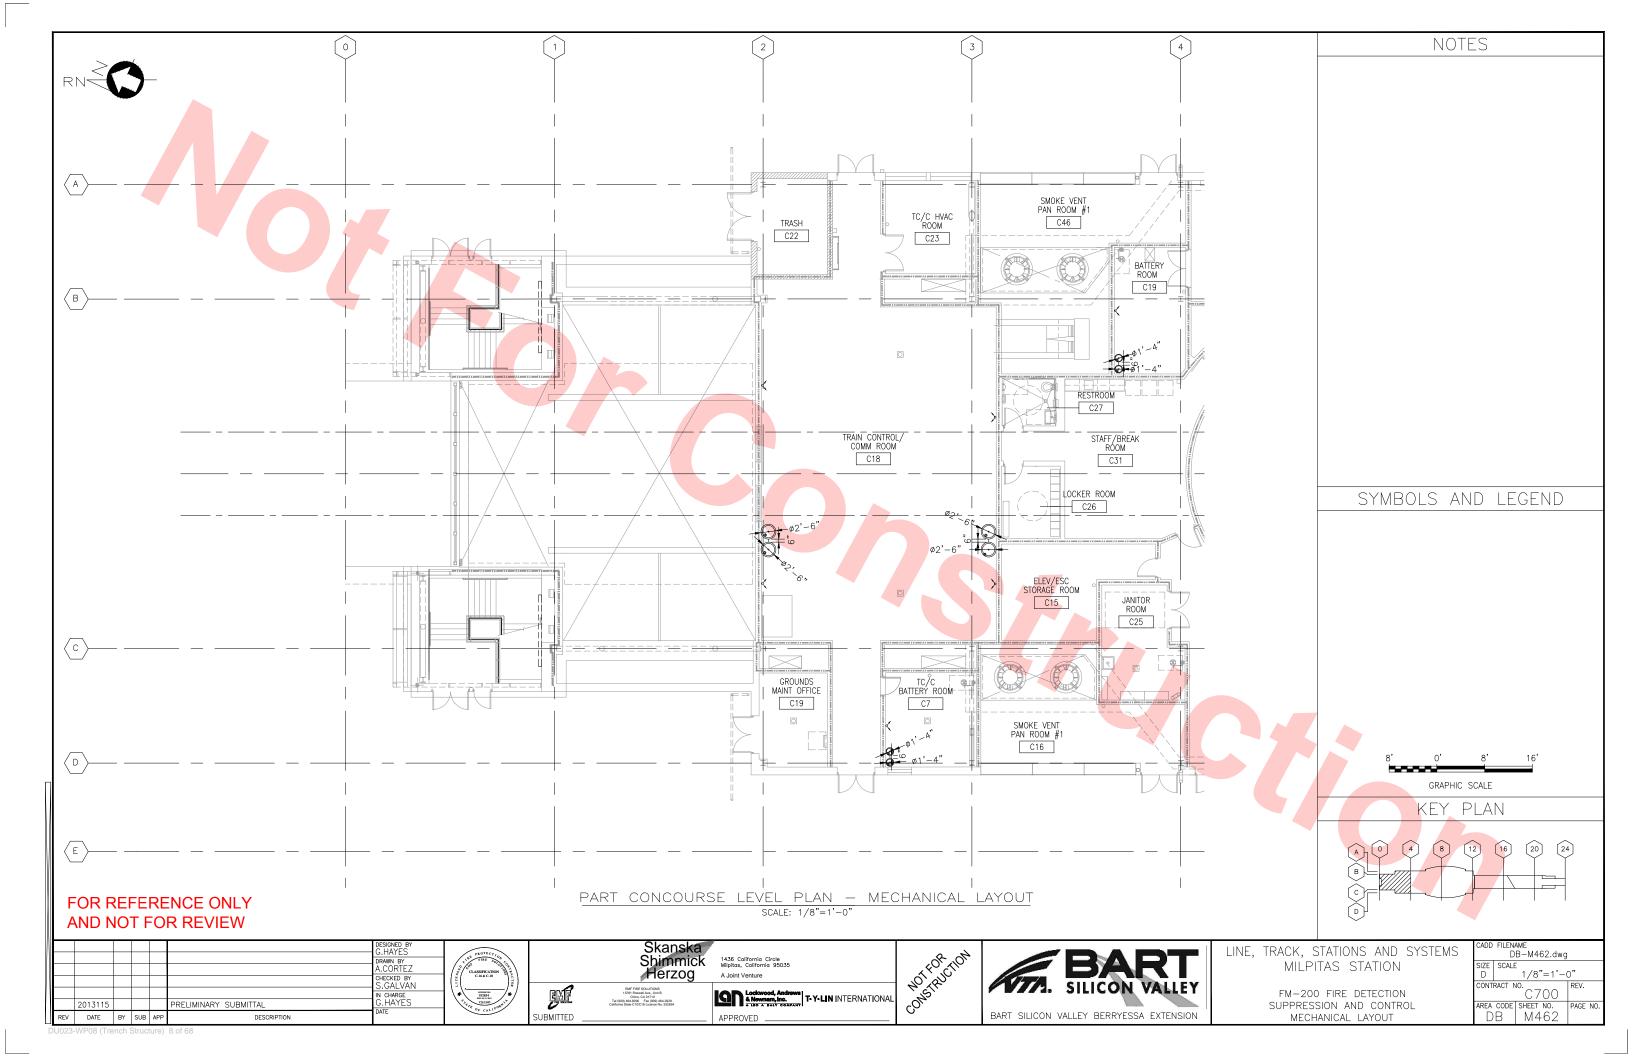

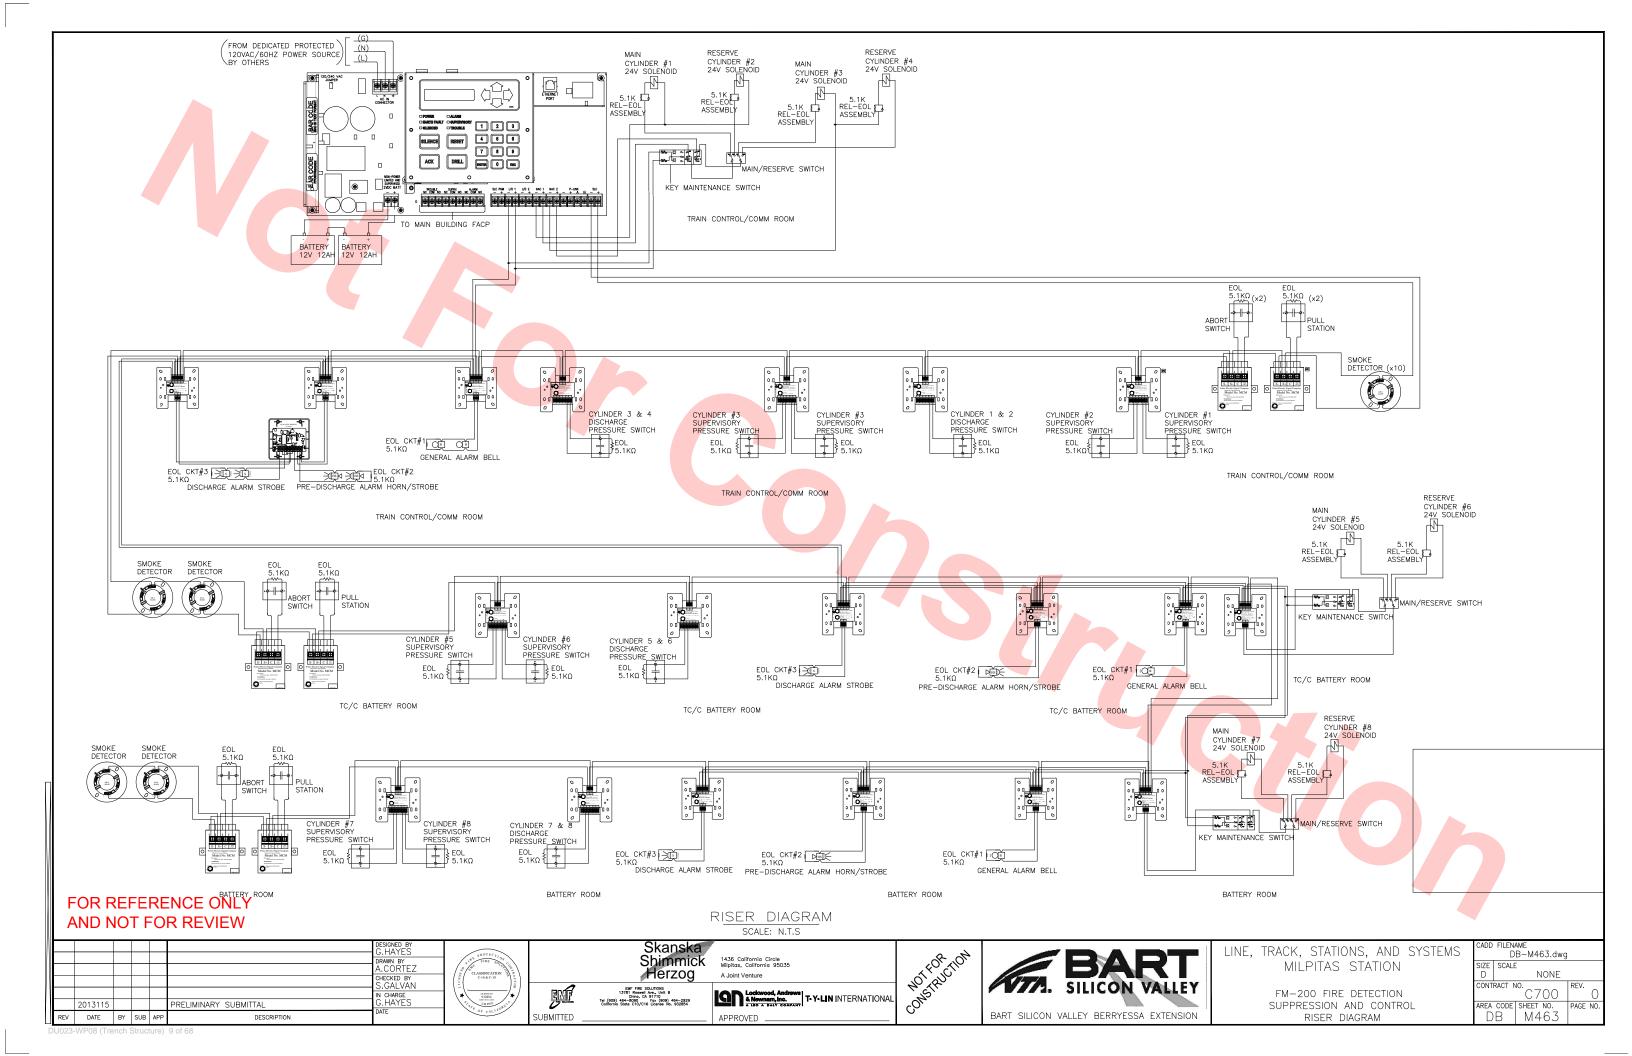

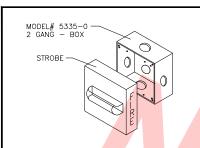
SURFACE MOUNT STROBE DETAIL SCALE: NTS




SURFACE MOUNT HORN STROBE DETAIL SCALE: NTS



<u>CEILING SMOKE DETECTOR MOUNTING DETAIL</u> SCALE: NTS

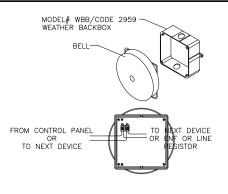

SURFACE MOUNT
BELL MOUNTING & WIRING DETAIL
SCALE: NTS

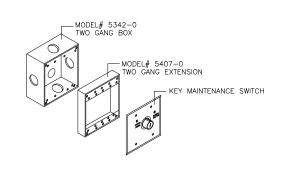

SURFACE MOUNT
KEY MAINTENANCE SWITCH DETAIL
SCALE: NTS

MOUNTING / HEIGHT REQUIREMENTS PULL STATION, HORN/STROBE, STROBE & SMOKE/HEAT DETECTORS

NUIES:

1. WALL-MOUNTED STROBES OR HORN/STROBES
SHALL BE MOUNTED THAT THE ENTIRE LENS IS
NOT LESS THAN 80 IN. AND NOT GREATER THAN
96 IN. AFF.

2. PULL STATIONS SHALL BE MOUNTED AT 48"
MAX. TO TOP OF BOX, 42" MIN TO THE CENTER
OF THE BOX AFF.


OF THE BUX AFF.

3. AUDIBLE ONLY DEVICES (HORNS,MINI HORNS, ETC.) SHALL BE MOUNTED AT 90" (MIN) TO THE TOP OF DEVICE AND NOT LESS THAN 6" BELOW THE CEILING.


4. REFERENCE NFPA 72 CHAPTER 4.

MOUNTING / HEIGHT REQUIREMENTS: HORN STROBE & STROBE

MAXIMUM ROOM SIZE		M CEILING	MINIMUM REQUIRED LIGHT OUTPUT (EFFECTIVE INTENSITY) ONE LIGHT
FT M	FT	M	CD
20 X 20 6.1 X 6.1	10	3.05	15
30 X 30 9.14 X 9.14	10	3.05	30
40 X 40 12.2 X 12.2	10	3.05	60
50 X 50 15.2 X 15.2	10	3.05	95
20 X 20 6.1 X 6.1	20	6.1	30
30 X 30 9.14 X 9.14	20	6.1	45
40 X 40 12.2 X 12.2	20	6.1	80
50 X 50 15.2 X 15.2	20	6.1	115
20 X 20 6.1 X 6.1	30	9.14	55
30 X 30 9.14 X 9.14	30	9.14	75
40 X 40 12.2 X 12.2	30	9.14	115
50 X 50 15.2 X 15.2	30	9.14	150

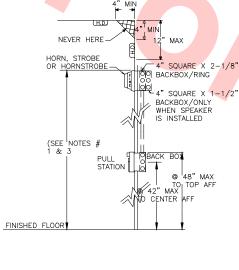

MOUNTING HEIGHT REQUIREMENTS DETAIL SCALE: NTS

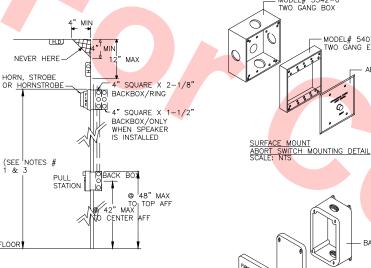

SURFACE MOUNT
EP/WP PULL STATION MOUNTING
SCALE: NTS

- MODEL# 5342-0 TWO GANG BOX

- MODEL# 5407-0 > TWO GANG EXTENSION


ABORT SWITCH




DO NOT ENTER SIGN DETAIL (OUTSIDE DOOR) SCALE: NTS




VACATE IMMEDIATELY SIGN DETAIL (INSIDE DOOR) SCALE: NTS

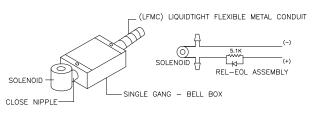



TYPICAL SOLENOID DETAIL SCALE: NTS

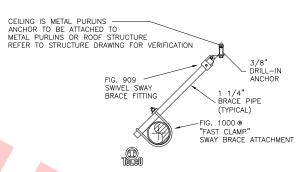


LATERAL EARTHQUAKE BRACE SCALE: NTS

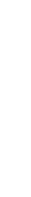

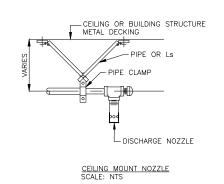

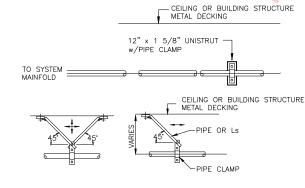

TYPICAL SWAY BRACE DETAIL SCALE: NTS

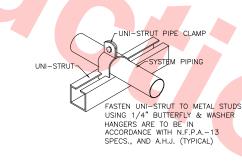

TYPICAL HANGER DETAIL SCALE: NTS

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FINISHED FLOOR

			DESIGNED BY G.HAYES	
			DRAWN BY	
			A.CORTEZ	
			CHECKED BY	
			S.GALVAN	
			IN CHARGE	
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CLASSIFICATION C-16 & C-10

UBMITTED

Skanska Shimmick Herzog EMF FIRE SOLUTIONS 13781 Roswell Ave., Unit B Chino, CA 91710 Tel (909) 464–8090 Fox (909) 464–2929 California State C10/C16 License No. 932854

DETAILS SCALE: N.T.S

Lockwood, Andrews & Nownam, Inc.






BART SILICON VALLEY BERRYESSA EXTENSION

LINE, TRACK, STATIONS, AND SYSTEMS MILPITAS STATION

> FM-200 FIRE DETECTION SUPPRESSION AND CONTROL DETAILS

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GENERAL NOTES CODE ANALYSIS **ABBREVIATIONS** MASTER KEY NOTES 1. IT IS THE RESPONSIBILITY OF THE OWNER TO MAINTAIN THE INTEGRITY OF THE SPRINKLER SYSTEM ONCE IN SERVICE. ABOVE FINISH FLOOR AUTOMATIC SPRINKLER RISER (1)SPRINKLER PIPE APPLICABLE CODES: ASR 2. ALL MATERIALS AND DEVICES SHALL BE NEW AND U.L. LISTED • NFPA 13 INSTALLATION OF SPRINKLER SYSTEM, 2007 AUXILIARY DRAIN AUXD AND IN CONFORMANCE WITH NFPA 13, NFPA 14, NFPA 20, AND NFPA 24. AND SHALL BE LISTED WITH THE STATE FIRE (2) WET STANDPIPE CHECK VALVE EDITION CALIFORNIA FIRE CODE 2001 EDITION CITY OF SAN JOSE ORDINANCE DRAIN MARSHALL FOR USE IN AUTOMATIC SPRINKLER SYSTEMS. (3)UNDERGROUND NFPA 20 INSTALLATION OF STATIONARY PUMPS FOR FIRE DV DELUGE VALVE 3. THIS FIRE SPRINKLER SYSTEM IS HYDRAULICALLY DESIGNED TO PROTECTION, 2010 EDITION DVC DELUGE VALVE CABINET (4) AUTOMATIC SPRINKLER RISER NFPA 14 INSTALLATION OF STANDPIPE, PRIVATE HYDRANT, ORDINARY HAZARD OR AS DETERMINED BY OCCUPANCY RATING FCV FHC FHR FIRE CONTROL VALVE AND HOSE SYSTEMS, 2003 EDITION FIRE HOSE CABINET 4. ALL WELDING SHALL CONFORM TO NFPA AND SHALL BE (5)SP SUPPLY TO (LOCATION) FIRE HOSE RACK PERFORMED BY CERTIFIED WELDERS. FHV FP FPC 2. JURISDICTION: FIRE HOSE VALVE (6) WSP SUPPLY TO (LOCATION) 5. ALL NEW PIPING SHALL BE HYDROSTATICALLY TESTED AT 200 FIRE PUMP CITY OF SAN JOSE FIRE PUMP CONTROLLER PSI FOR 2 HOURS. THIS TEST SHALL BE PERFORMED IN THE (7)FHC SUPPLY TO (LOCATION) FPTM FIRE PUMP TEST METER PRESENCE OF THE IOR AND/OR CITY FIRE INSPECTOR. OCCUPANCY CLASSIFICATION: GPM GALLONS PER MINUTE (8)ucds supply to (location) 6. IDENTIFICATION SIGNS SHALL BE PER NFPA 13. ORDINARY GROUP II - 0.20 GPM/SQ. FT. OVER 3000 SQ. FEET AT MOST REMOTE LOCATION. SPRINKLER SPACING TO JP JPC JOCKEY PUMP JOCKEY PUMP CONTROLLER (9)under car deluge system BE A MAXIMUM OF 130 SQ. FEET. WITH A HOSE PSI POUNDS PER SQUARE INCH 7. THE FIRE SPRINKLER SYSTEM SHALL HAVE 24 HOUR ALLOWANCE OF 250 GPM. SEISMIC LOOP MONITORING BY AN APPROVED CENTRAL STATION. (MONITORING 10) SEISMIC LOOP DELUGE SYSTEM IS 0.19 GPM FOR THE MOST REMOTE 2 SPRINKLER PIPE SYSTEM WORK BY OTHERS) ALL PIPE PENETRATIONS OF RATED ZONES, SPRINKLER SPACING TO BE HEADS 7'-0' ON UCDS UNDER CAR DELUGE SYSTEM (11) DELUGE VALVE WALLS, PARTITIONS, OR OCCUPANCY SEPARATIONS SHALL BE CENTER. WITH A HOSE ALLOWANCE OF 250 GPM FOR UG FIRE STOPPED. (WORK TO BE PERFORMED BY OTHERS) EACH ZONE. WET STANDPIPE (12) DELUGE VALVE CABINET 8. ALL PIPE PENETRATIONS OF RATED WALLS, PARTITIONS, OR OCCUPANCY SEPARATIONS SHALL BE FIRE STOPPED. (13) FIRE HOSE VALVE 9. THE UNDERGROUND SHALL CONFORM TO NFPA 24 WITH A MINUMUM BURY OF 3'-0" TO TOP OF PIPE. TRANSBAY FIRE (14) FIRE HOSE RACK FIRE SPRINKLER SYSTEM: (15) FIRE HOSE CABINET TO SUPPLY THE 5'-0" STUB OUT. AUTOMATIC FIRE SPRINKLER SYSTEM: 10. THE UNDERGROUND MAINS AND LEAD-IN CONNECTIONS NFPA 13, 2007 (16)CHECK VALVE SHALL BE FLUSHED BEFORE CONNECTION TO THE OVERHEAD CALIFORNIA FIRE CODE 2001 EDITION SYSTEM PER NFPA 13. FLUSH TO BE WITNESSED BY CITY OF SAN JOSE ORDINANCE (17) FIRE CONTROL VALVE STANDPIPE & WET STANDPIPE SYSTEM: (18) AUXILIARY DRAIN 11. ALL ELECTRICAL WIRING, PAINTING, LABELING, AND SUPPLING OF FIRE EXTINGUISHERS TO BE PERFORMED BY OTHERS. NFPA 14, 2003 EDITION (19) FIRE PUMP 12. A HEAD BOX STOCKED WITH SPRINKLER HEADS AND A HEAD FIRE PUMP: WRENCH ARE TO BE SUPPLIED PER NFPA 13. (20) JOCKEY PUMP NFPA 20, 2010 EDITION 13. ALL LOW POINTS OF THE SYSTEM SHALL HAVE PROVISIONS (21) FIRE PUMP CONTROLLER FOR DRAINAGE PER NFPA 13. UNDERGROUND SYSTEM: NFPA 24, 2007 EDITION (22) JOCKEY PUMP CONTROLLER 14. HANGERS AND BRACING: A. ALL HANGERS TO BE CLEVIS TYPE GALVANIZED LOCATED (23) HORIZONTAL SIDEWALL SPRINKLER 10'-0" ON CENTER AND SHALL BE WITH U.L. LISTED COMPONENTS AND IN ACCORDANCE WITH NFPA 13. (24) UPRIGHT SPRINKLER ALL SEISMIC BRACING OF NEW PIPE SHALL BE GALVANIZED WITH U.L. LISTED COMPONENTS AND IN ACCORDANCE WITH NFPA 13. (25) CONCEALED PENDENT SPRINKLER RESTRAINT OF BRANCHLINES SHALL BE IN ACCORDANCE (26)SEMI-RECESSED PENDENT SPRINKLER WITH NFPA 13. (27) DELUGE NOZZLE SPRINKLER 15. PIPE: A. ALL PIPING 3" THROUGH 6" USED FOR WELDED MAINS OR BRANCHLINES SHALL BE SCHEDULE 10 GRADE "B" GALVANIZED ASTM A53 AND NFPA 13. ALL PIPING 2" THROUGH 21/2" USED FOR THREADED BRANCHLINES SHALL BE SCHEDULE 40 GRADE "B" GALVANIZED ASTM A53 AND NFPA 13. ALL PIPING 1" THROUGH 11/2" USED FOR THREADED BRANCHLINES SHALL BE SCHEDULE 40 GRADE "B" GALVANIZED ASTM A106 AND NFPA 13. 16. FITTINGS: SCREWED FITTINGS SHALL BE MALLEABLE IRON CLASS 300 GALVANIZED ASTM A-197. GROOVED FITTINGS AND COUPLINGS GRUVLOK FIGURE 7001 OR 7401 WITH A 500 PSI RATING AND GRADE "E" WELDED OUTLETS SHALL BE MERIT THREADED OR GROOVED AND IN CONFORMANCE WITH ASME B31 AND RATED FOR 300 PSI. 17. SPRINKLERS: AREAS OF EXPOSED STRUCTURE OR ABOVE CEILING ARE TYCO SPRINKLER HEADS MODEL TY-FRB, 200°F TEMP RATING AREAS WITH SUSPENDED OR GYPBOARD CEILING ARE TYCO SPRINKLER HEADS, MODEL TY-FRB, 155°F TEMP RATING AREAS WITH SUSPENDED OR GYPBOARD CEILING WHERE CONCEALED HEADS ARE REQUIRED, ARE TYCO SPRINKLER HEADS, MODEL RFII, 155°F TEMP RATING. FOR REFERENCE ONLY AND NOT FOR REVIEW ESIGNED BY CADD FILENAME C700-S-DB-M600.dwg Skanska LINE, TRACK, STATIONS AND SYSTEMS Shimmick 1436 California Circle Milpitas, California 95035 RAWN BY J.CANRIGHT MILPITAS STATION Herzog NO SCALE A Joint Venture No. FP1364 Exp. 09/30/13 HECKED BY TRANSBAY FIRE PROTECTION, INC. 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UNDER DEVELOPMENT

UNDER DEVELOPMENT

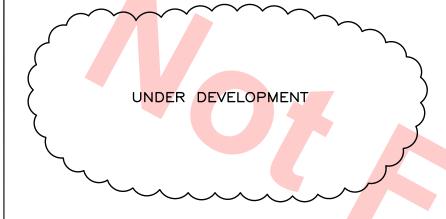ANCILLARY BUILDING FIRE PROTECTION RISER DETAIL SCALE: 1/4"=1'-0"

FIRE PROTECTION HOSE CABINET DETAIL SCALE: 1/4"=1'-0"

FIRE PROTECTION DELUGE CABINET DETAIL SCALE: 1/4"=1'-0"

UNDER DEVELOPMENT

FIRE PROTECTION VALVE ROOM DETAIL SCALE: 1/4"=1'-0"

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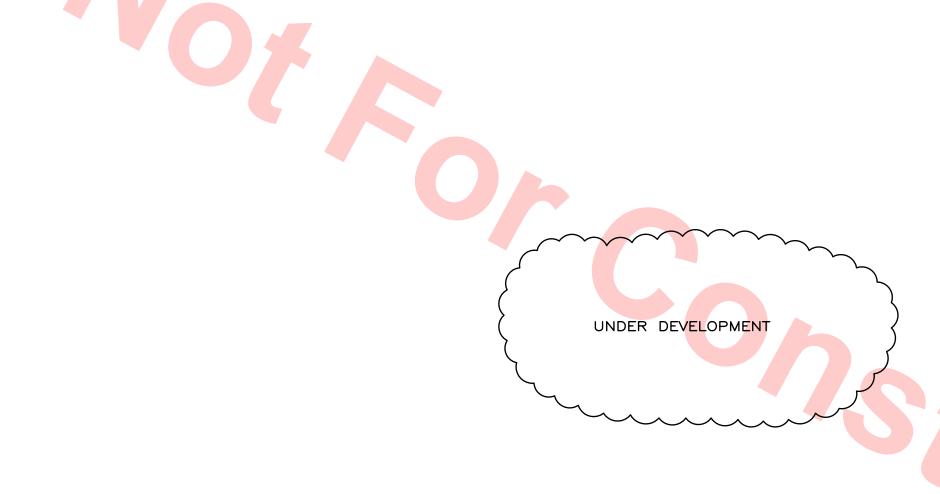


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HANGERS AND BRACING DETAILS



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TRANSBAY FIRE PROTECTION, INC.

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1436 California Circle Milpitas, California 95035 A Jolnt Venture






LINE, TRACK, STATIONS AND SYSTEMS
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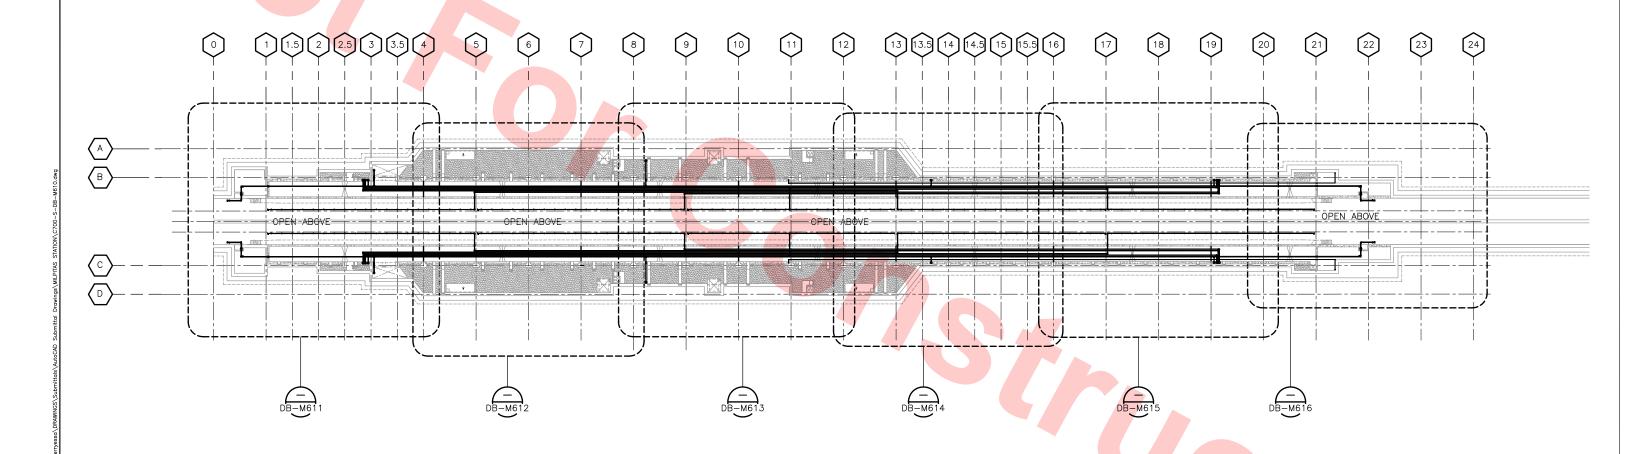


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KEY PLAN - TRACK LEVEL FIRE PROTECTION SCALE: 1/32"=1'-0"

Skanska Shimmick 1436 California Circle Milpitas, California 95035 Jolnt Venture

DESIGNED BY K.MALONE DRAWN BY J. CANRIGHT CHECKED BY A. VEGAS IN CHARGE K. MALONE DEFINITIVE DESIGN 20130111 REV DATE BY SUB APP

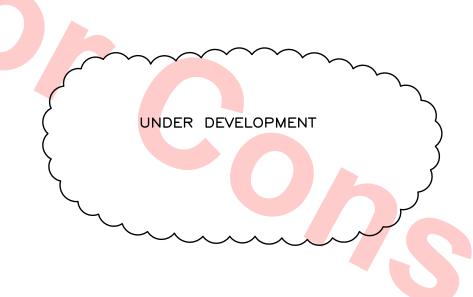

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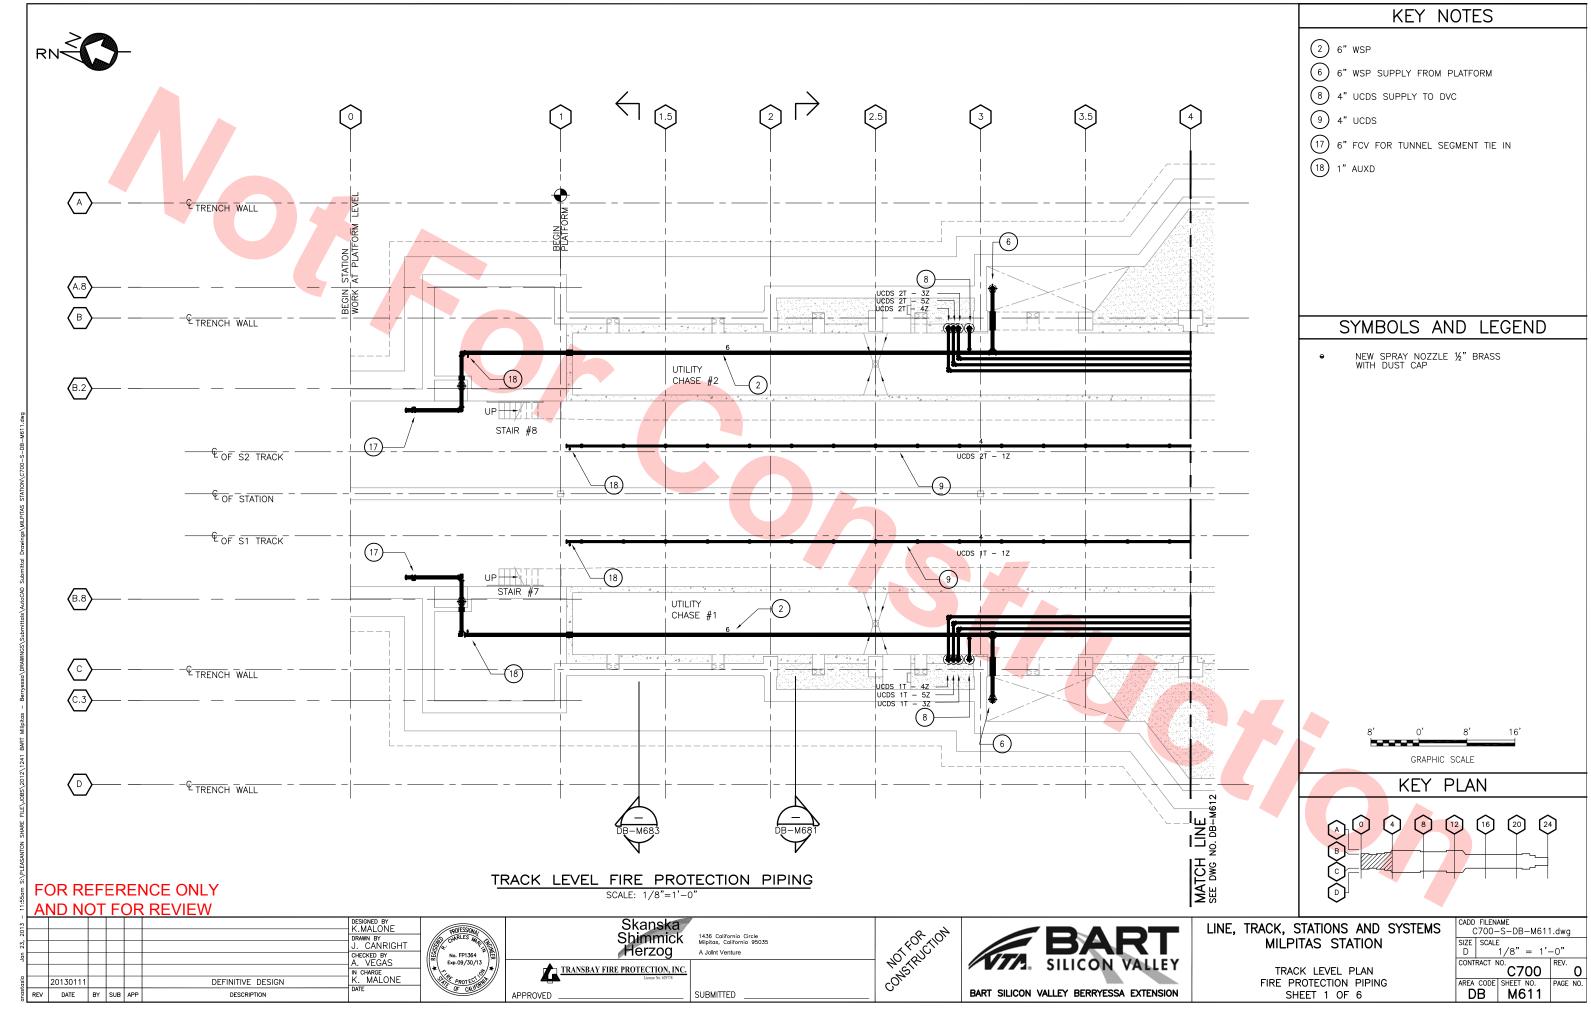






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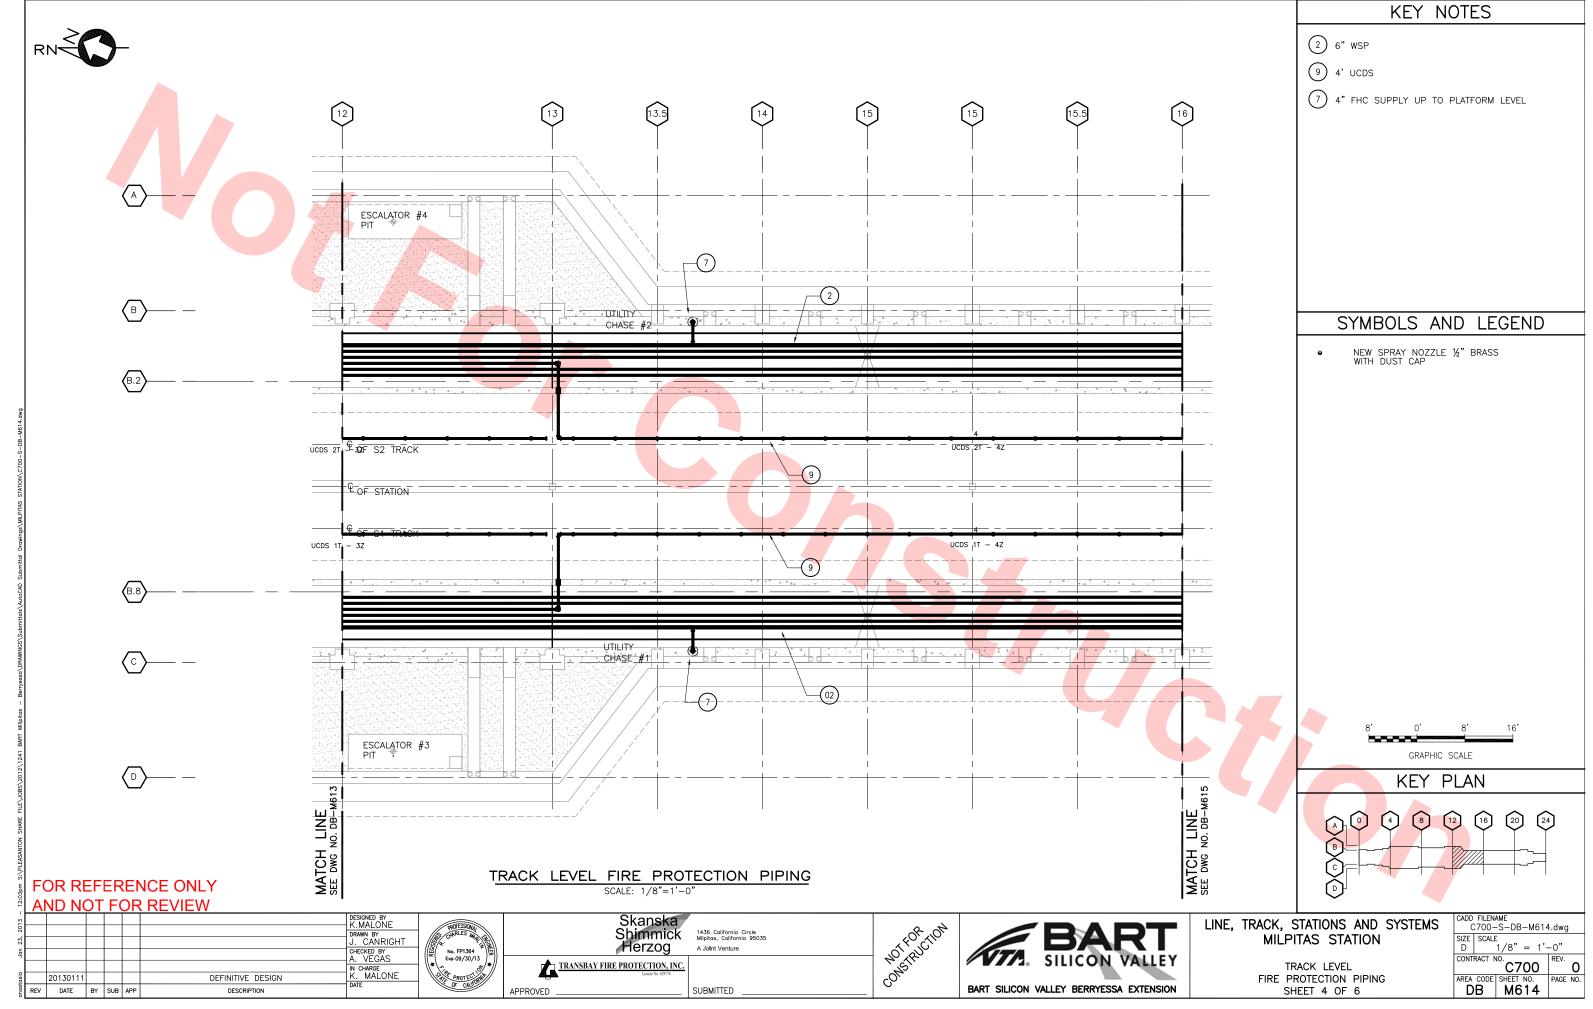
> KEY PLAN TRACK LEVEL FIRE PROTECTION PLAN


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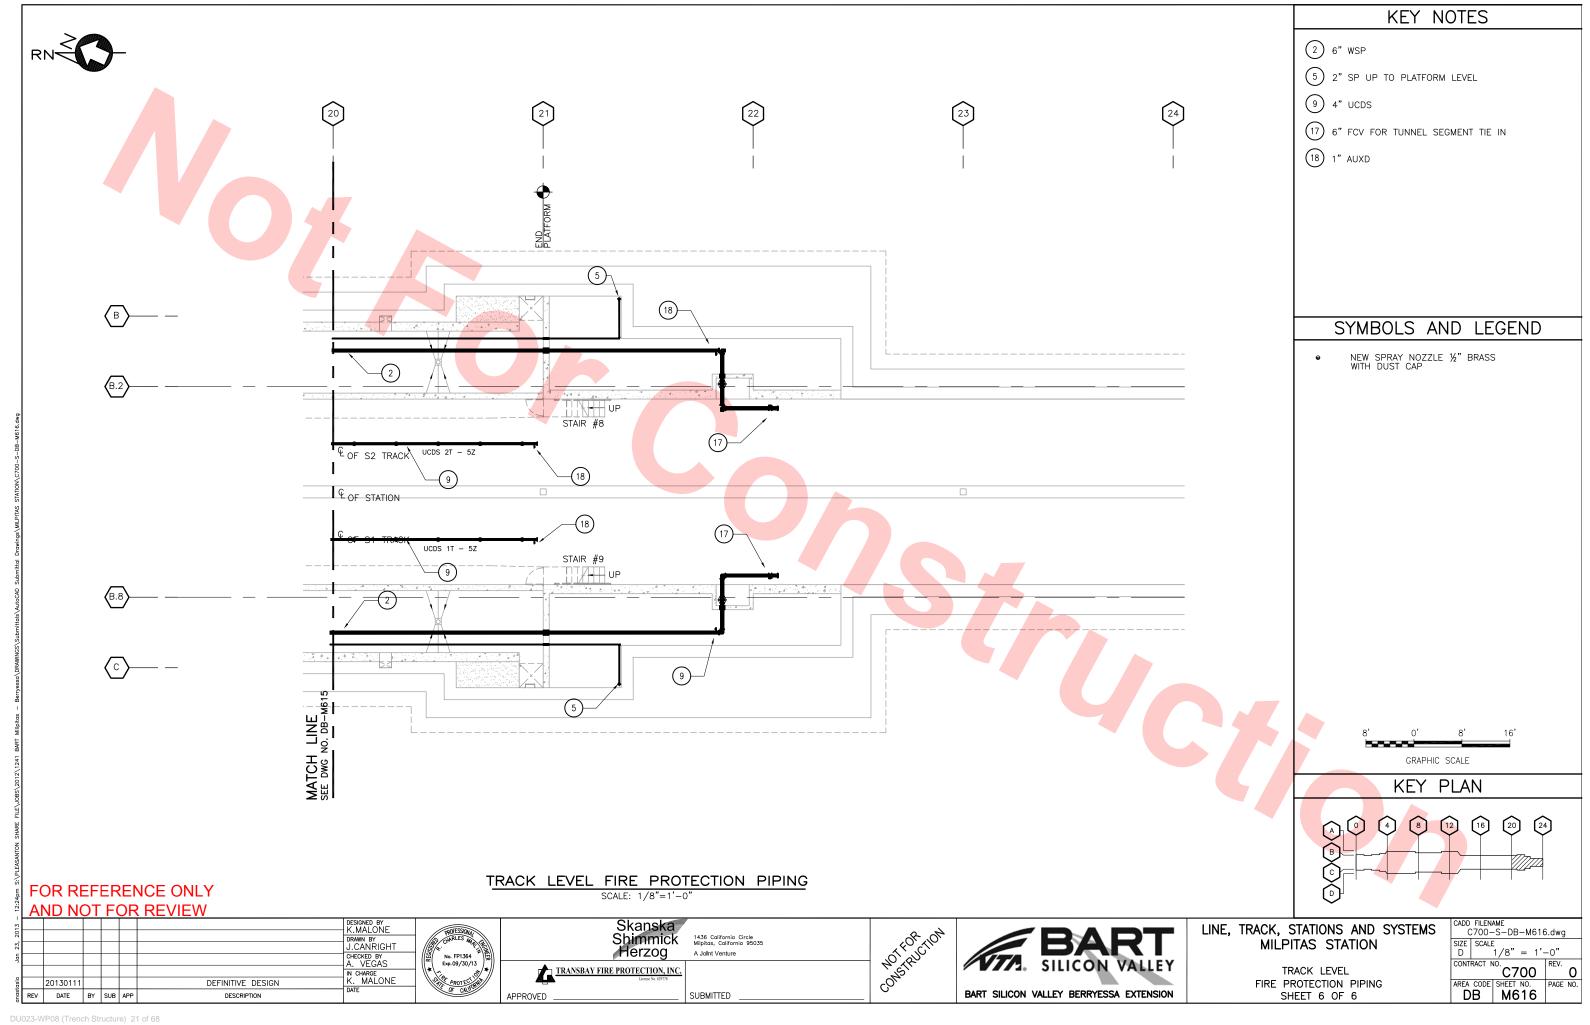







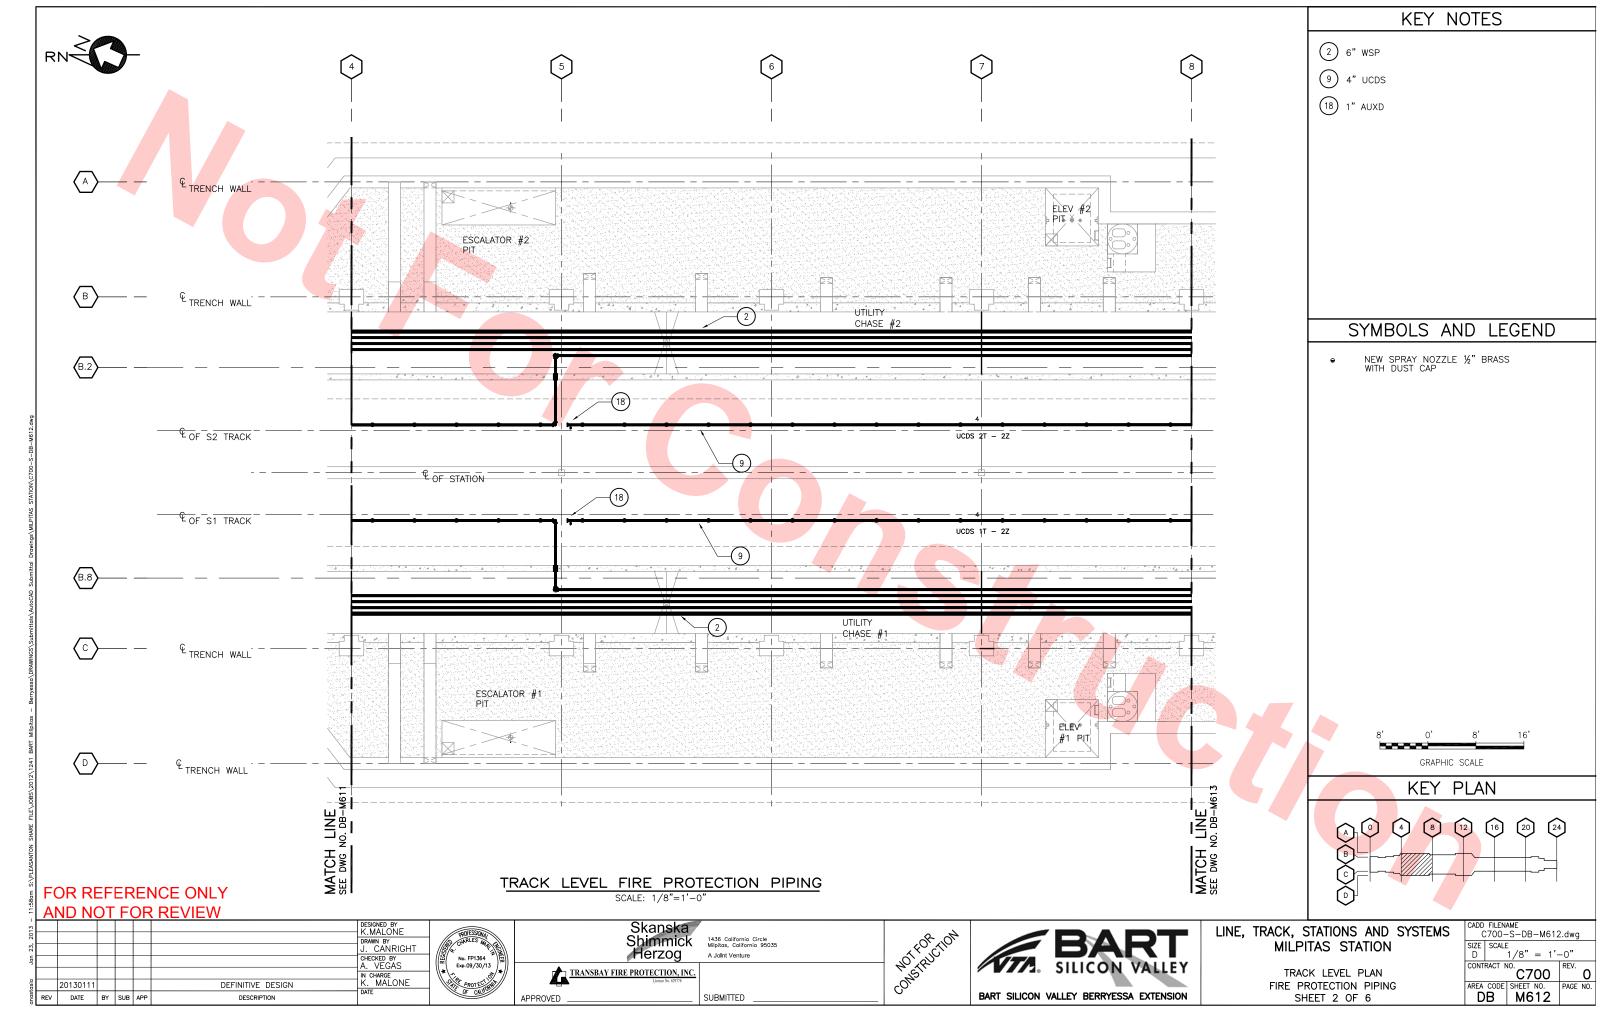

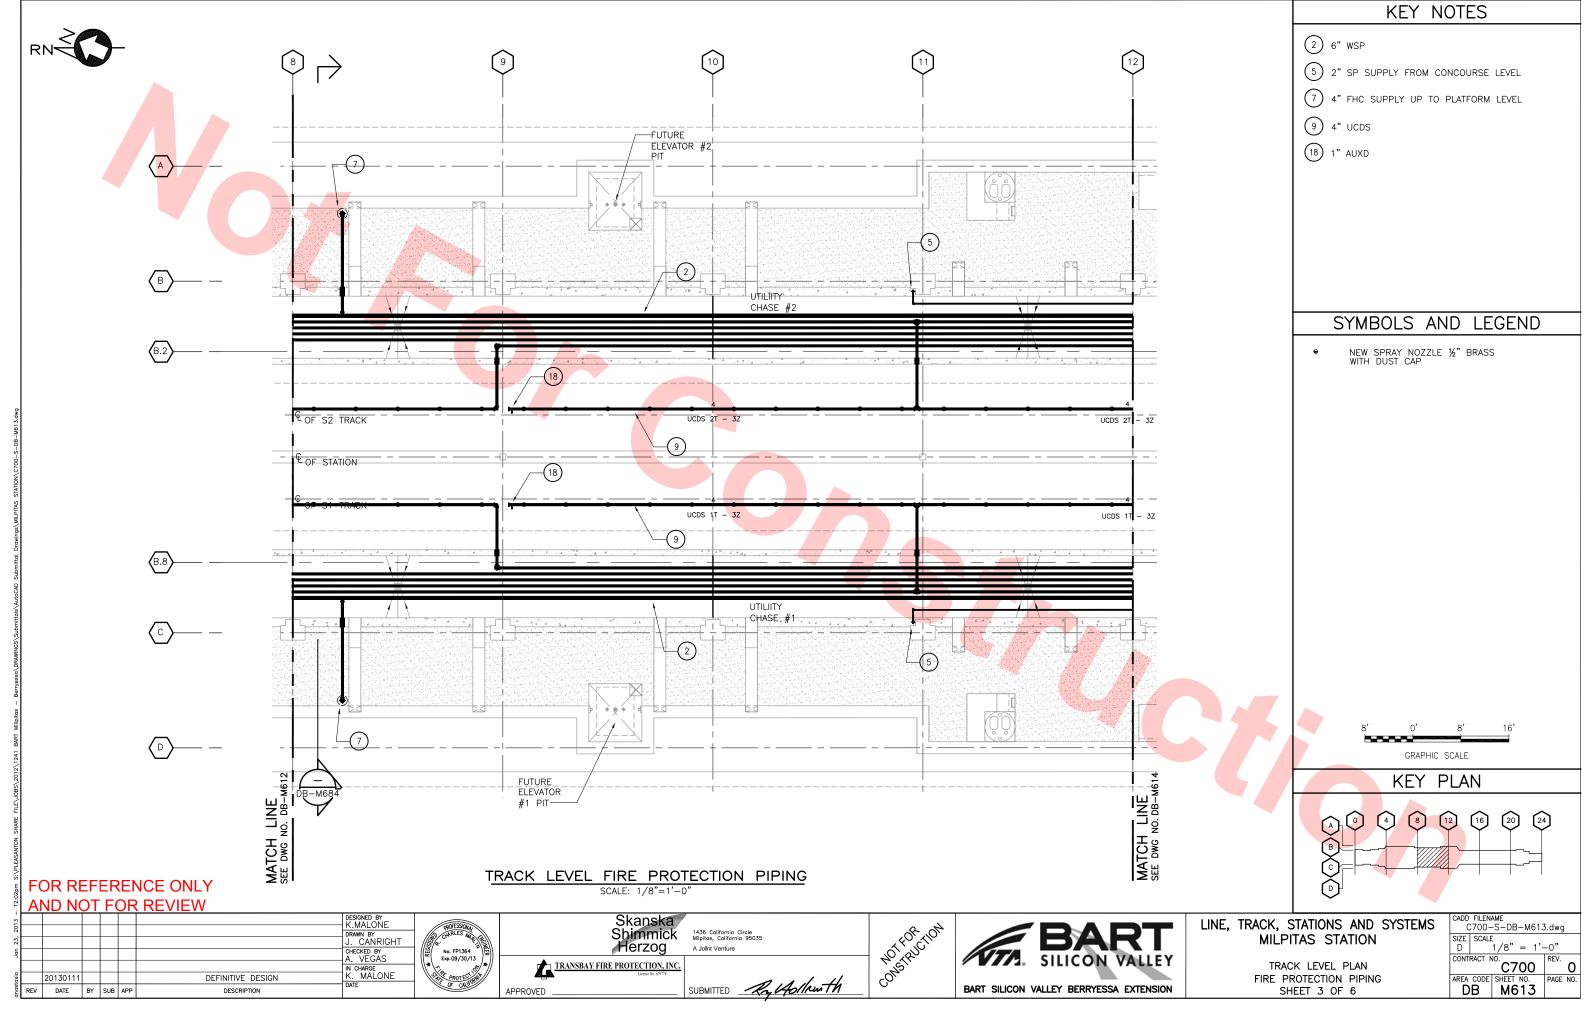

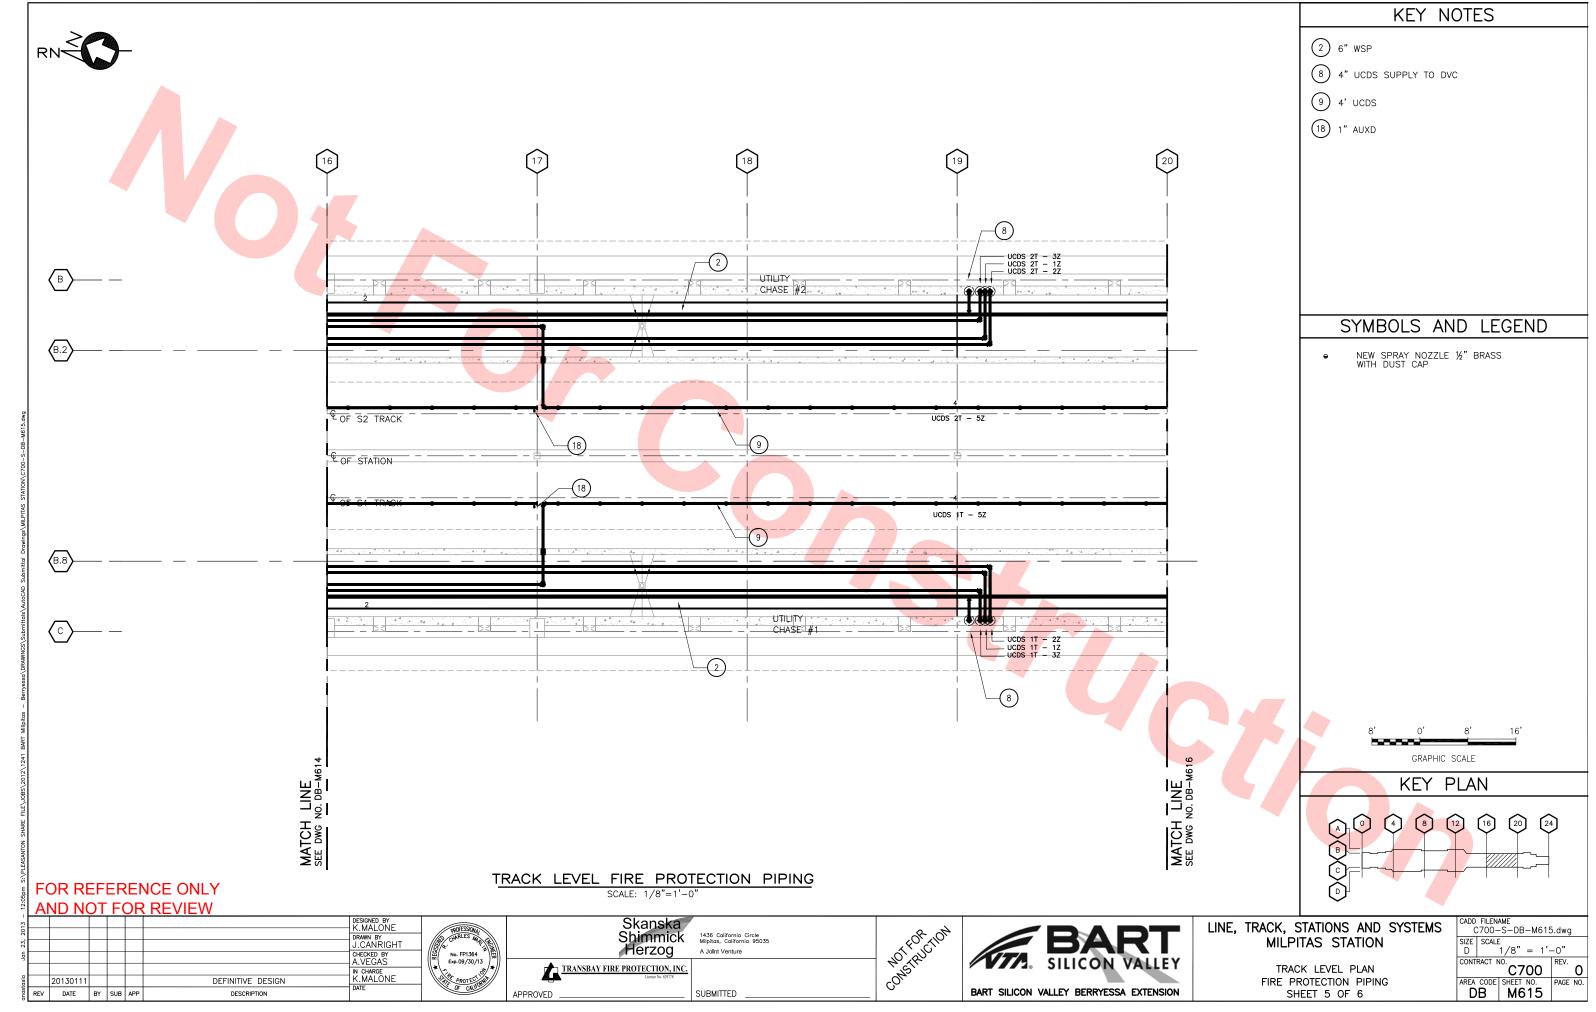



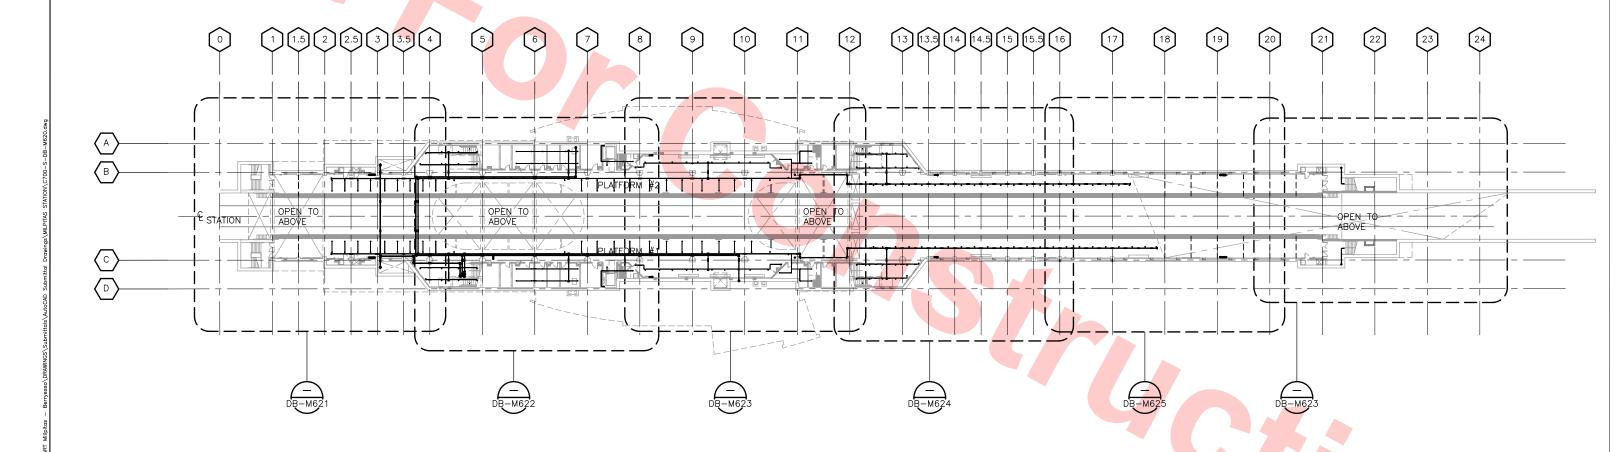

KEY PLAN - PLATFORM LEVEL FIRE PROTECTION PIPING

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DESIGNED BY K.MALONE RAWN BY J. CANRIGHT CHECKED BY A. VEGAS IN CHARGE K. MALONE DEFINITIVE DESIGN 20130111 REV DATE BY SUB APP



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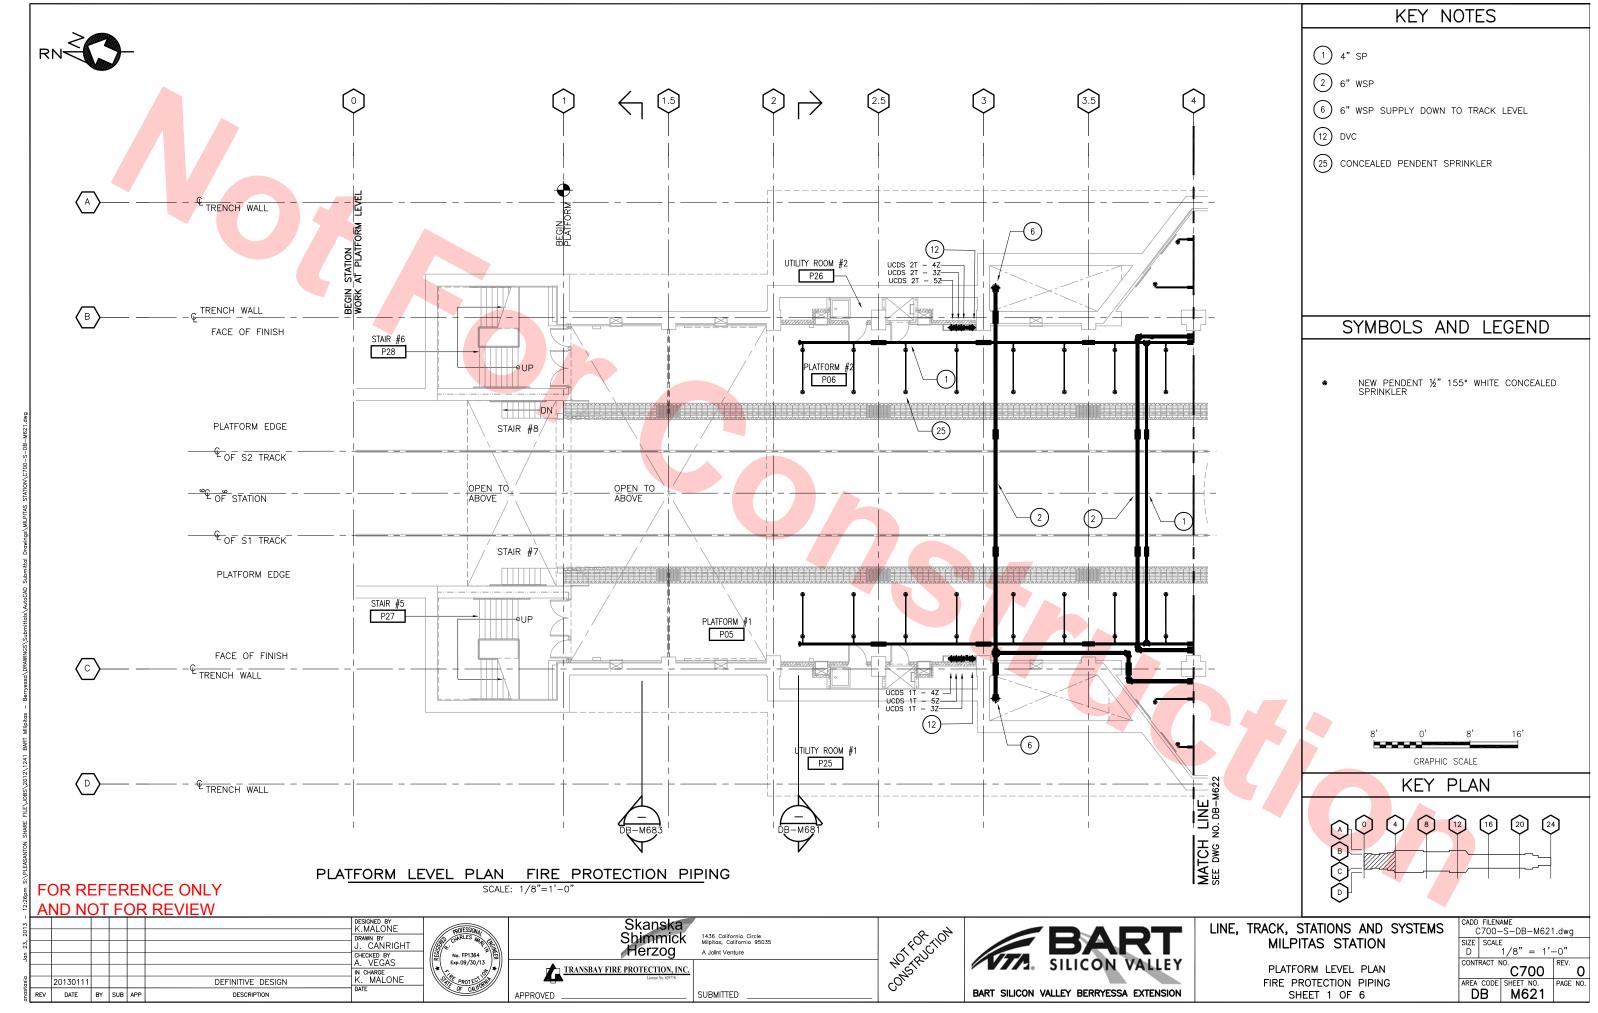
1436 California Circle Milpitas, California 95035 A Joint Venture SUBMITTED








LINE, TRACK, STATIONS AND SYSTE MILPITAS STATION KEY PLAN PLATFORM LEVEL FIRE PROTECTION


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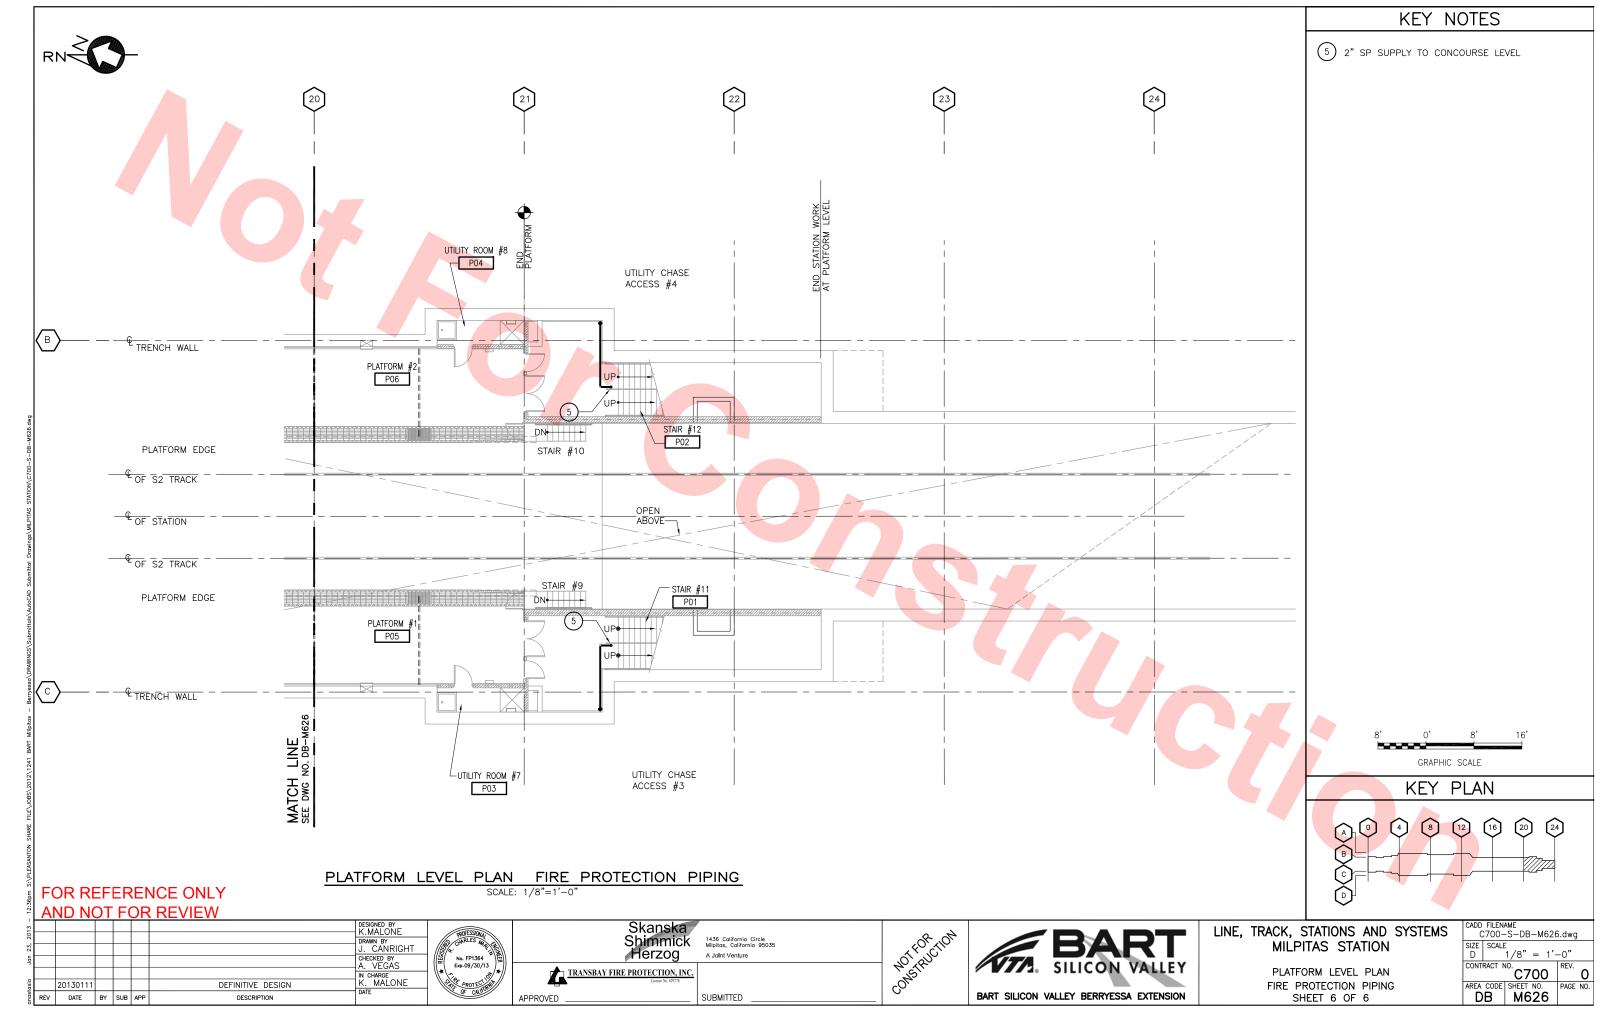




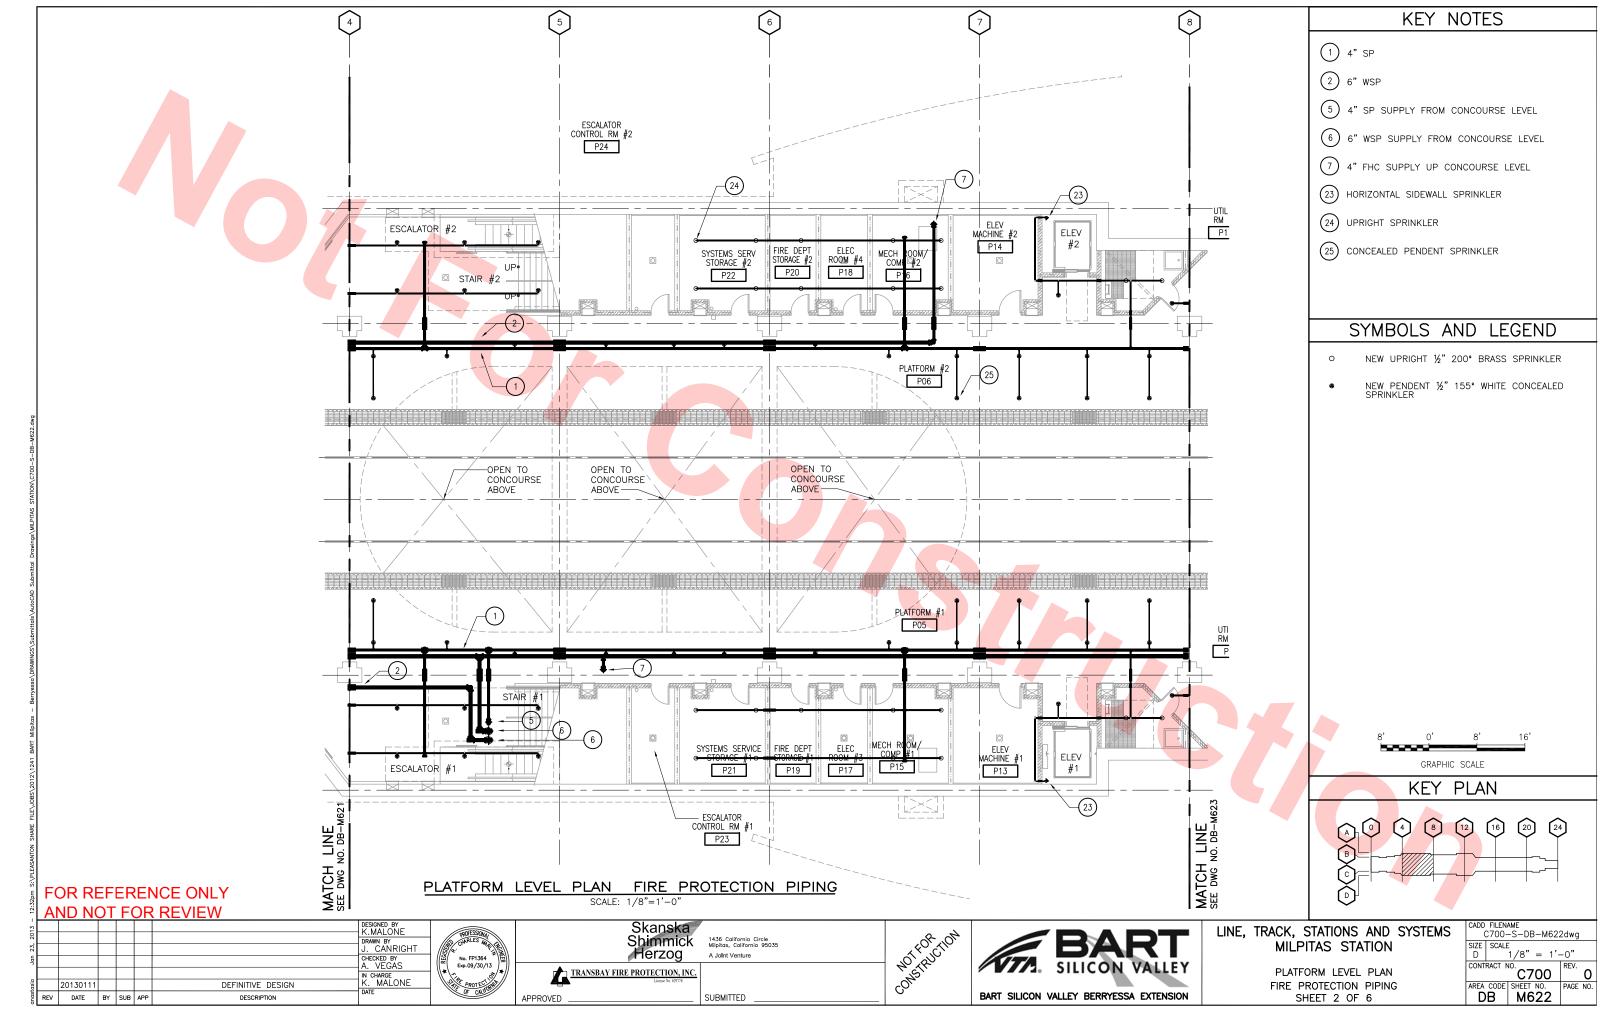


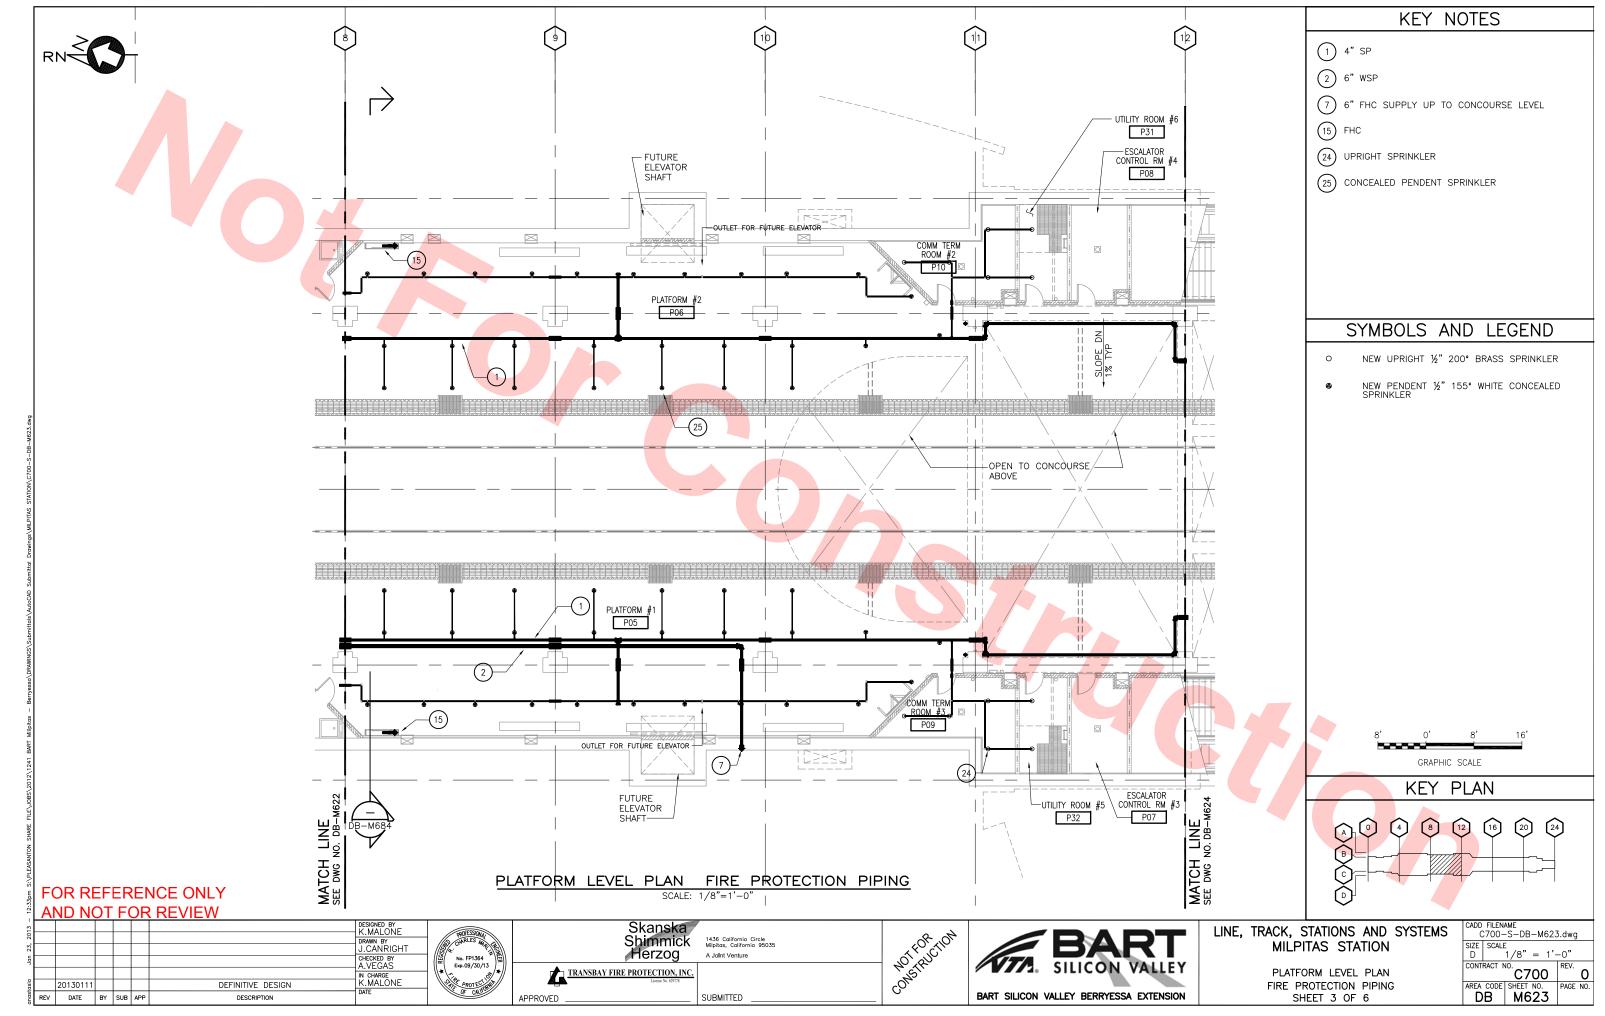

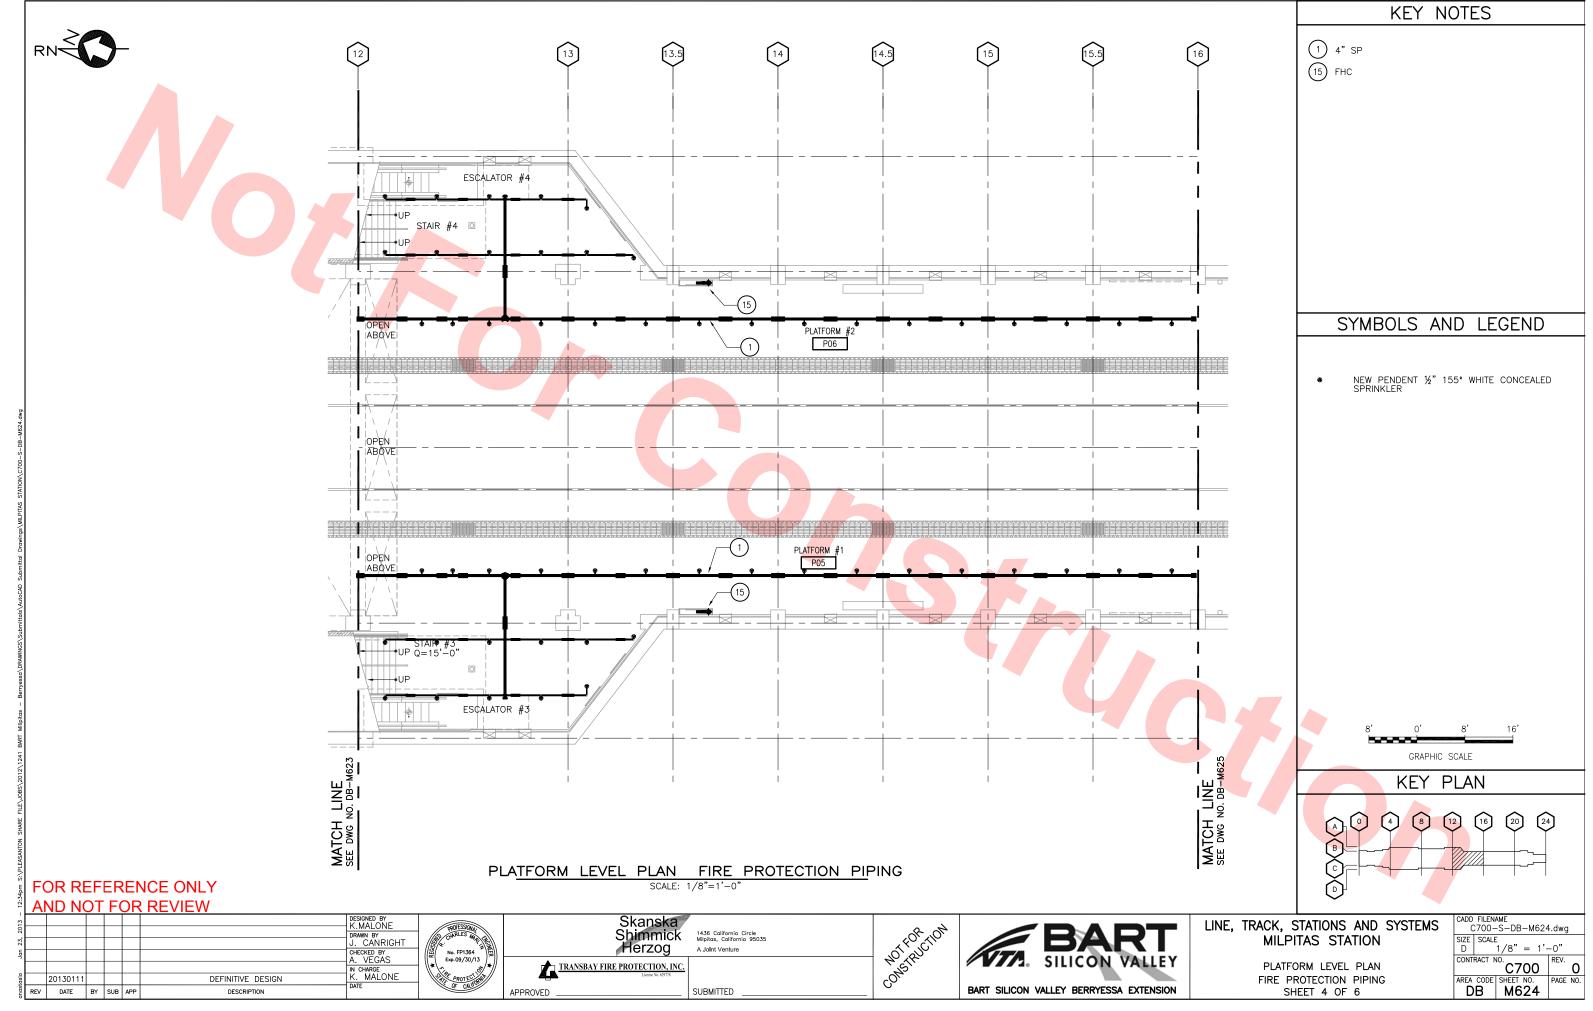

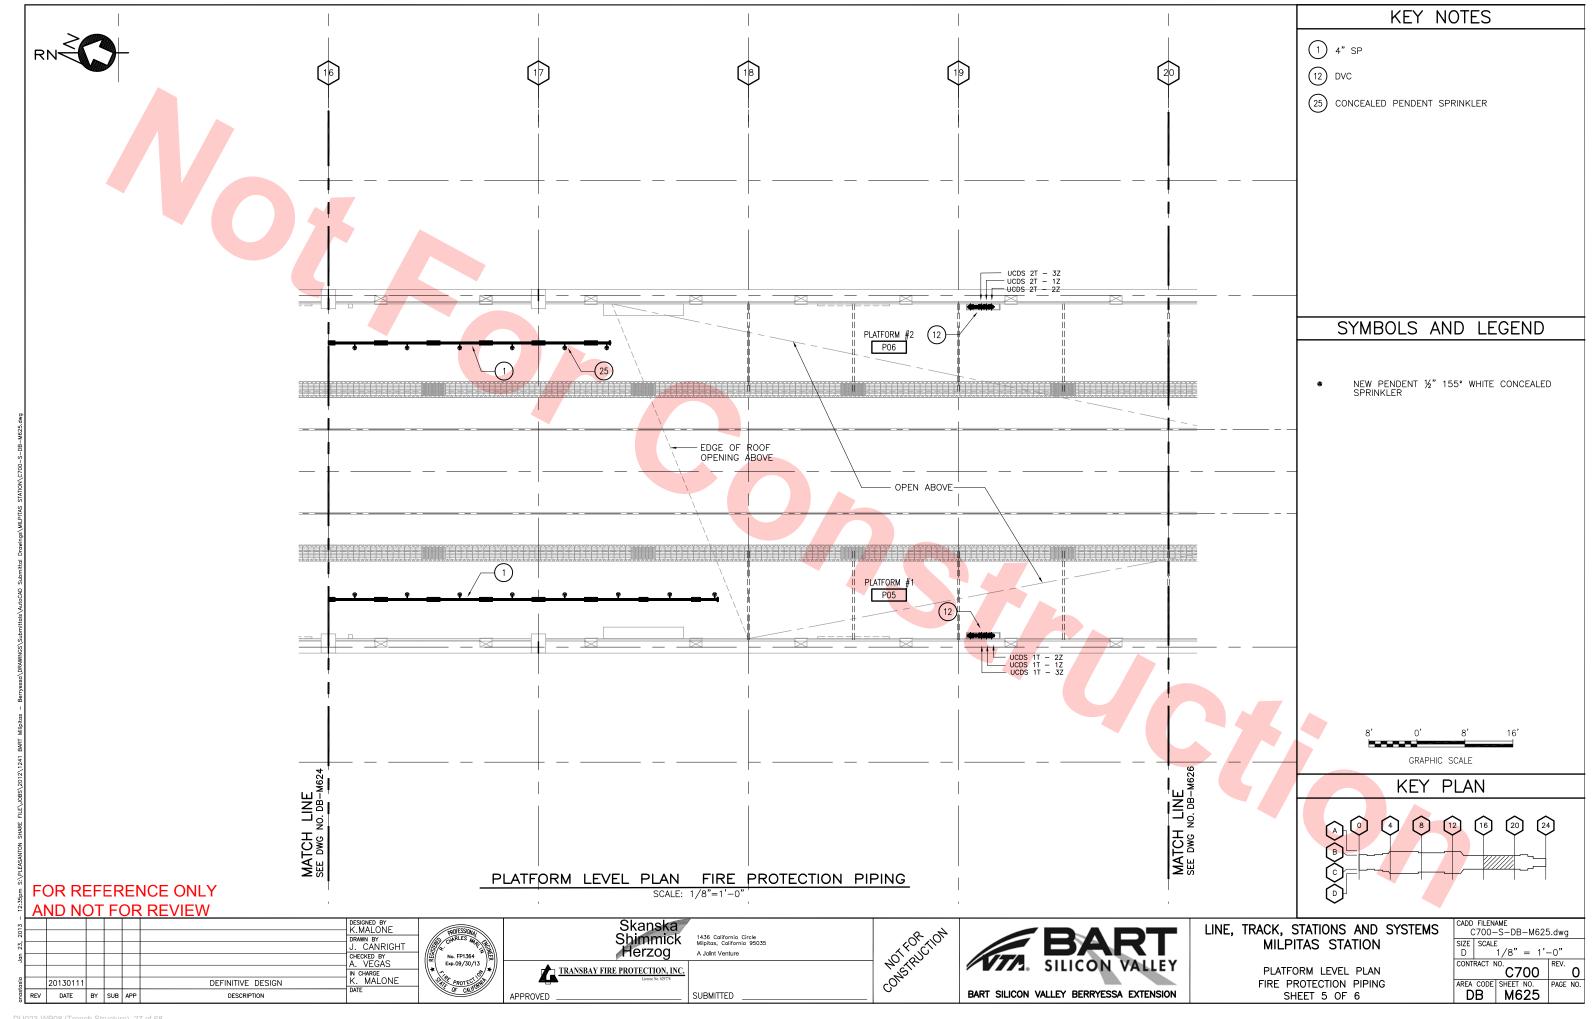



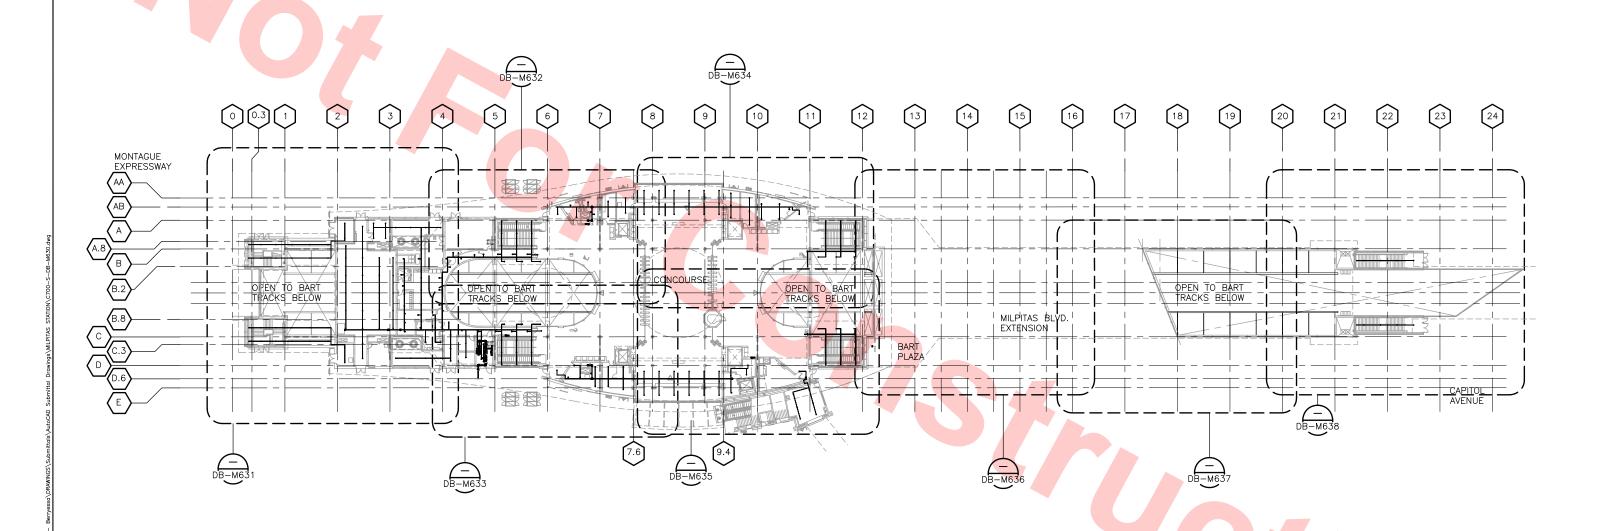

KEY PLAN - CONCOURSE LEVEL FIRE PROTECTION PIPING

LINE, TRACK, STATIONS AND SYSTEM MILPITAS STATION KEYPLAN CONCOURSE LEVEL FIRE PROTECTION


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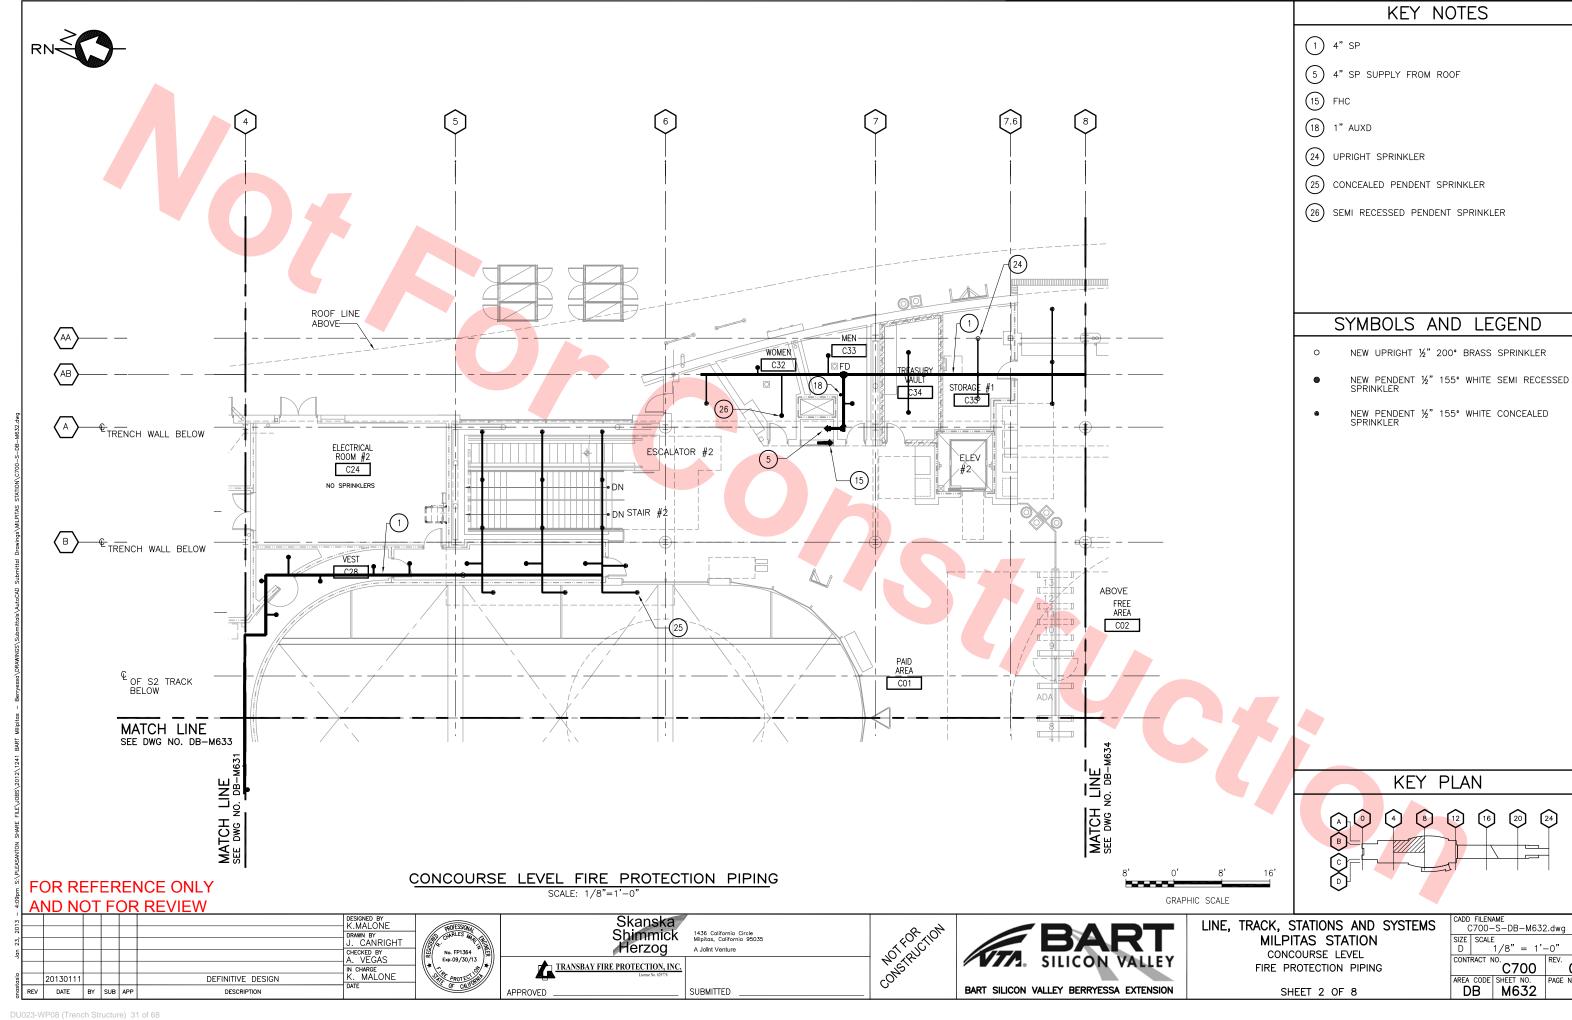
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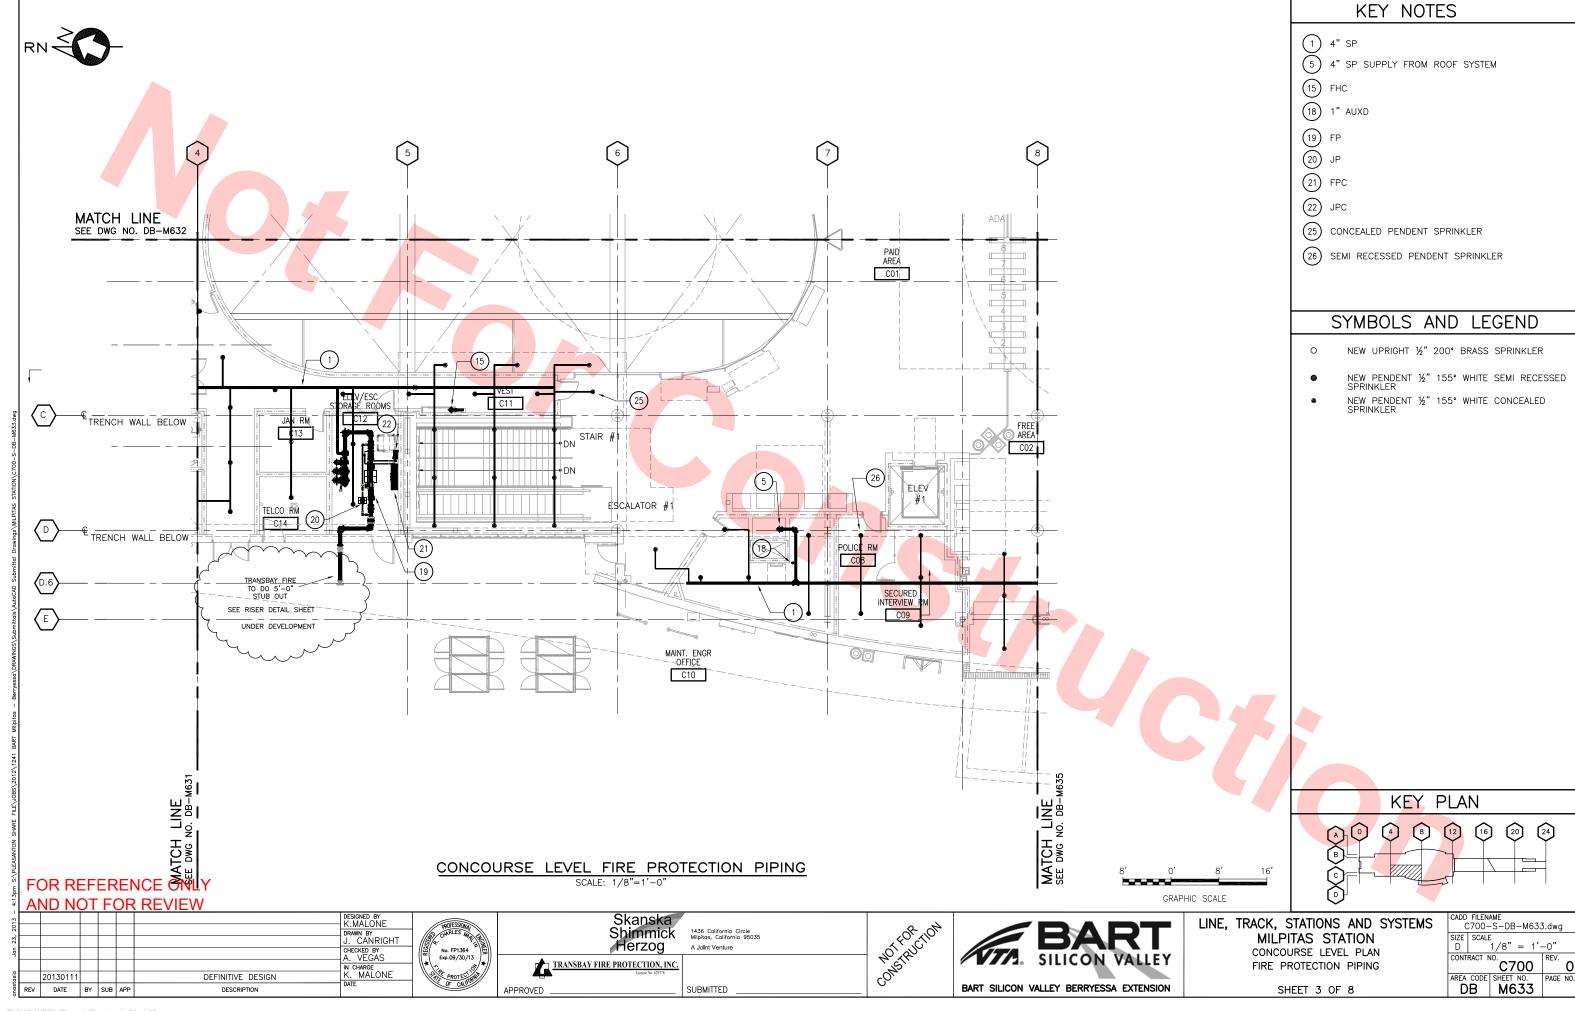


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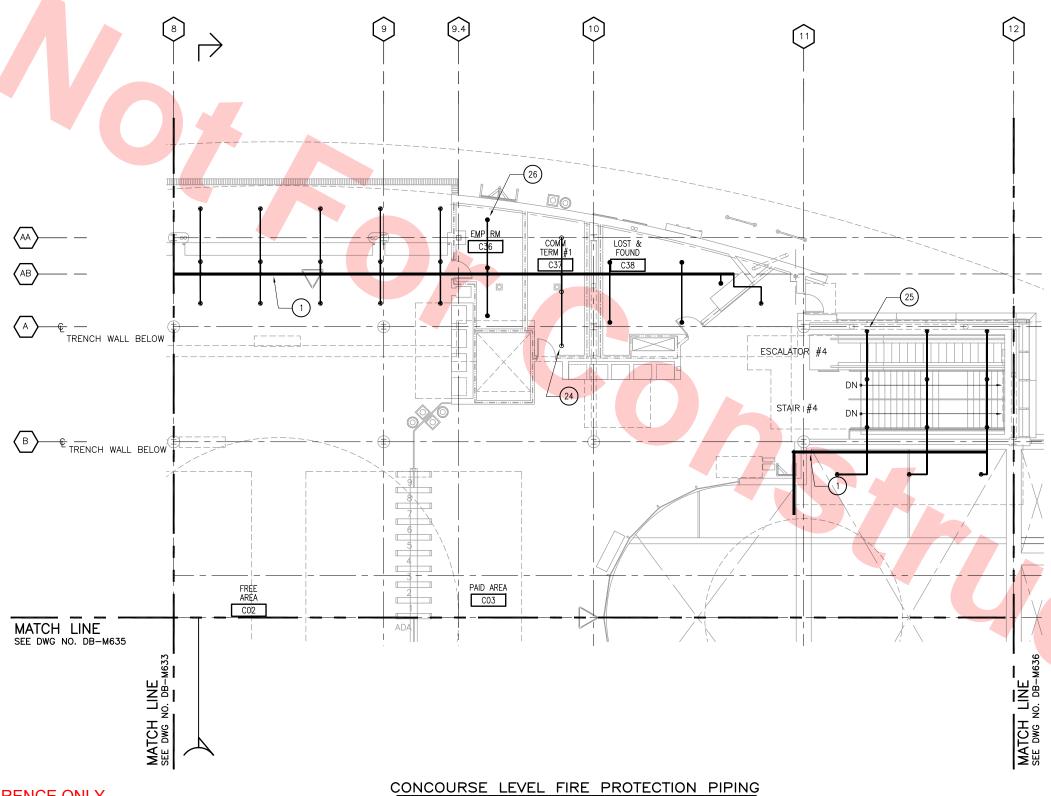






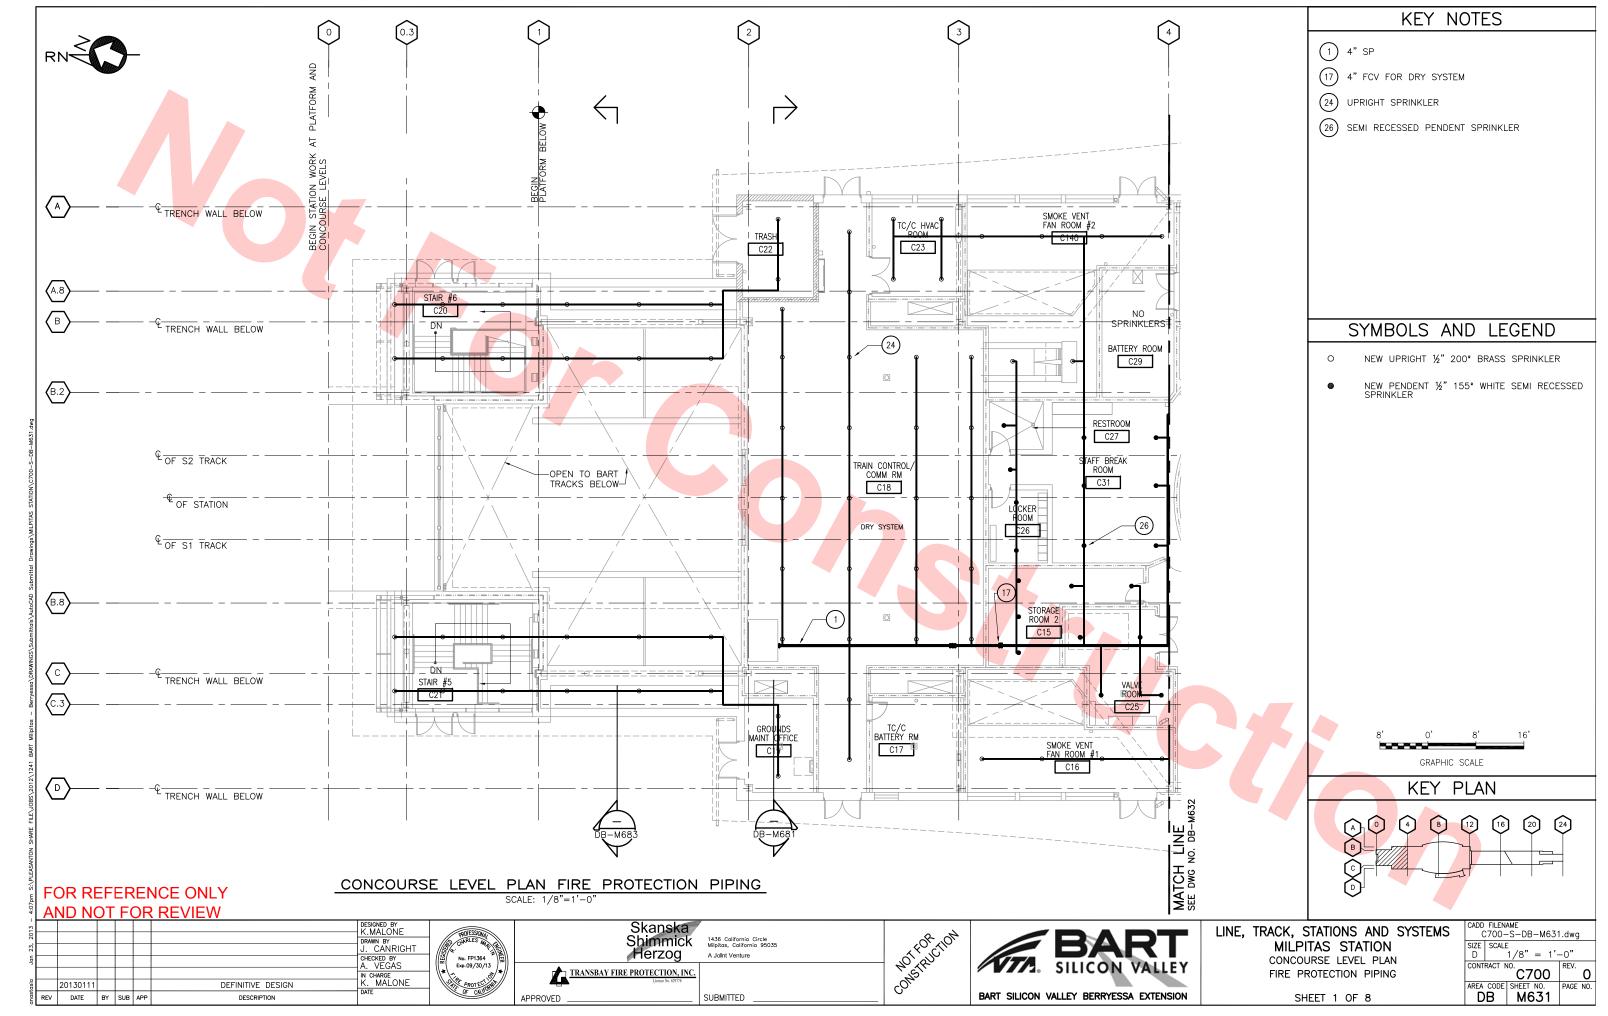

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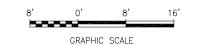


KEY NOTES


- 1 4" SP
- 24) UPRIGHT SPRINKLER
- (25) CONCEALED PENDENT SPRINKLER
- (26) SEMI RECESSED PENDENT SPRINKLER

SYMBOLS AND LEGEND

- NEW UPRIGHT 1/2" 200° BRASS SPRINKLER
- NEW PENDENT $\frac{1}{2}$ " 155° WHITE SEMI RECESSED SPRINKLER
- NEW PENDENT ½" 155° WHITE CONCEALED SPRINKLER



KEY PLAN

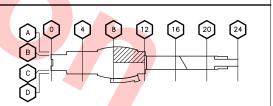

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1436 California Circle Milpitas, California 95035 A Joint Venture




LINE, TRACK, STATIONS AND SYSTEMS MILPITAS STATION


CONCOURSE LEVEL PLAN FIRE PROTECTION PIPING


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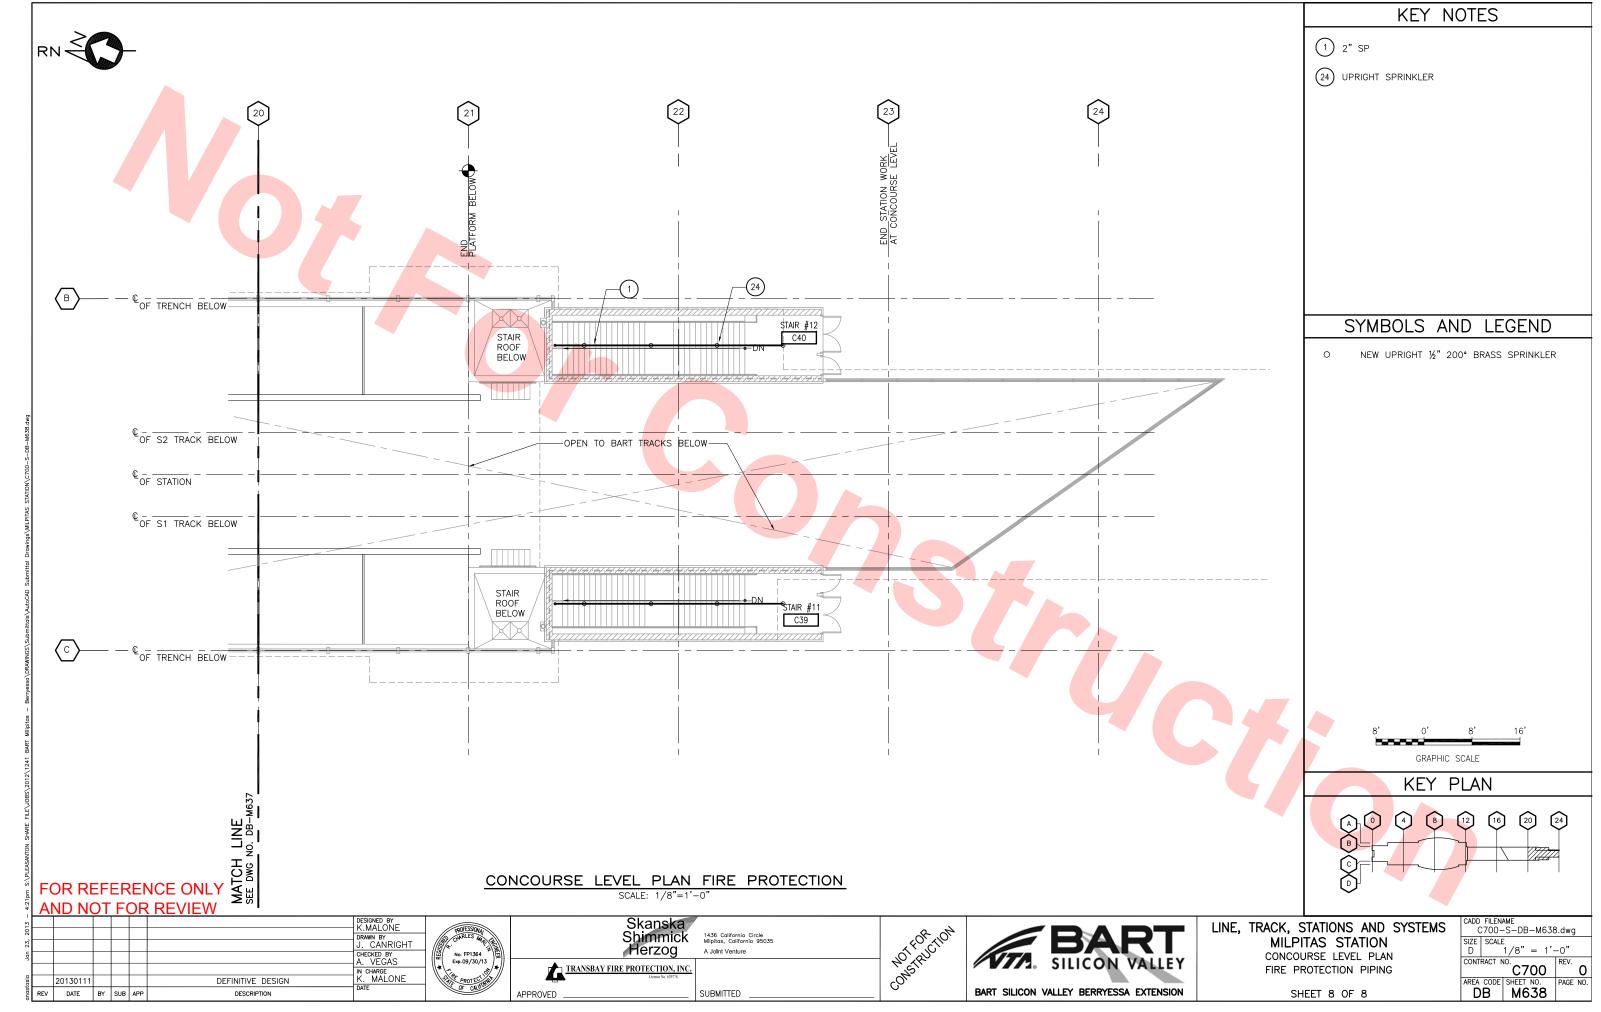
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DU023-WP08 (Trench Structure) 33 of 68






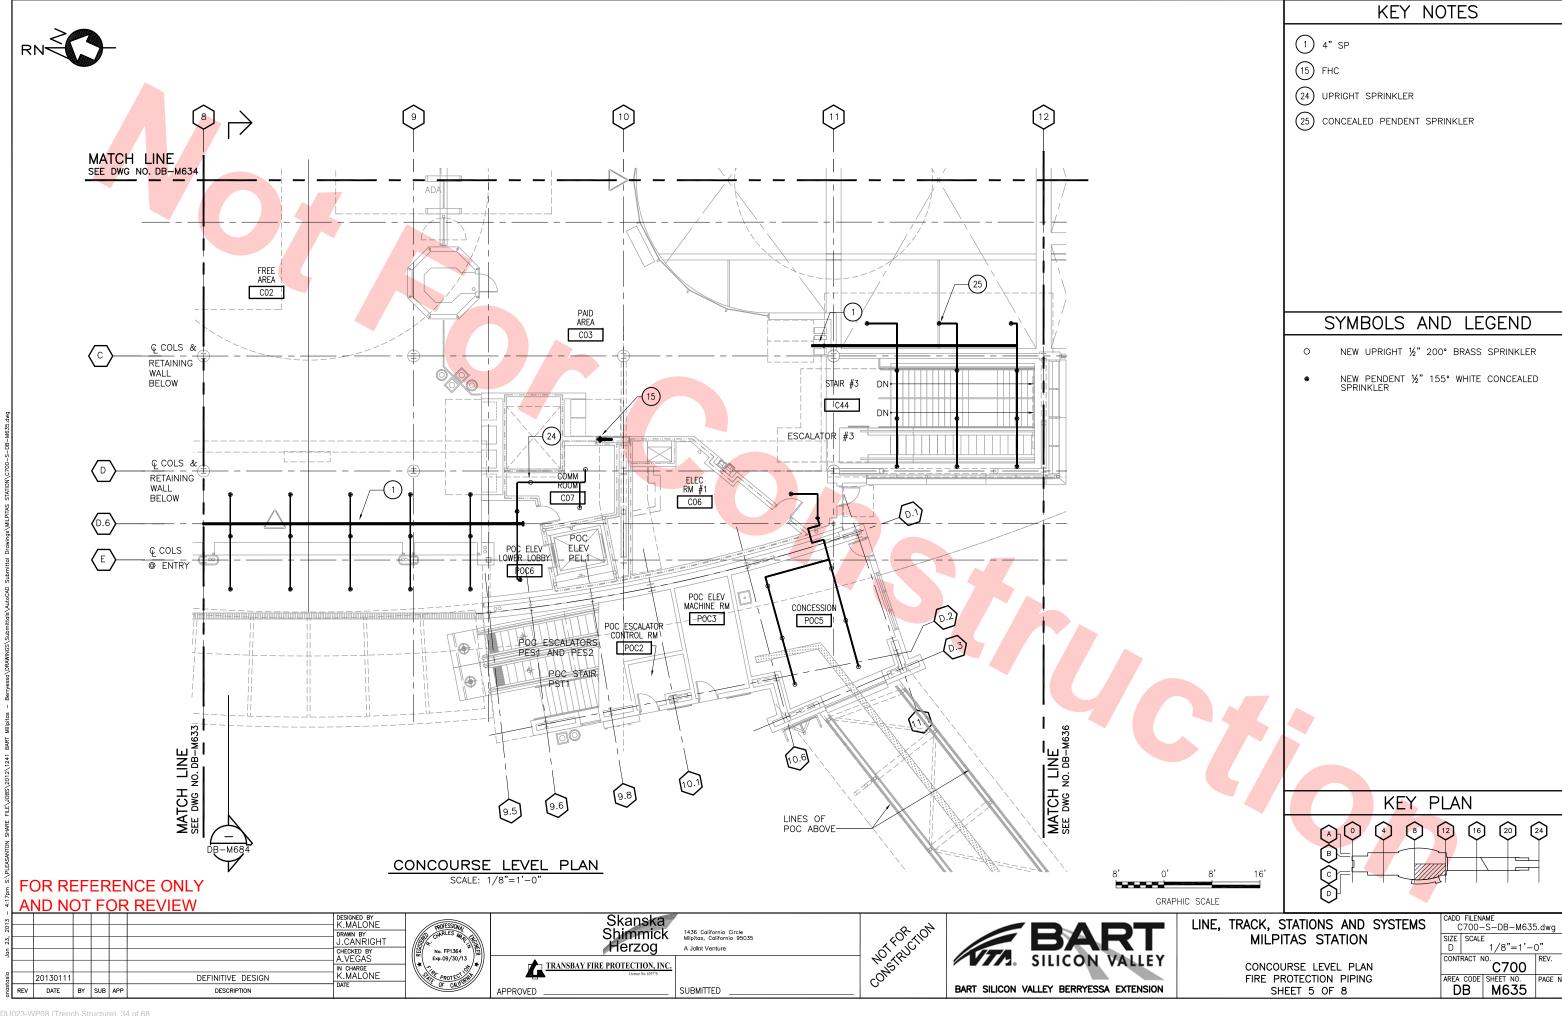

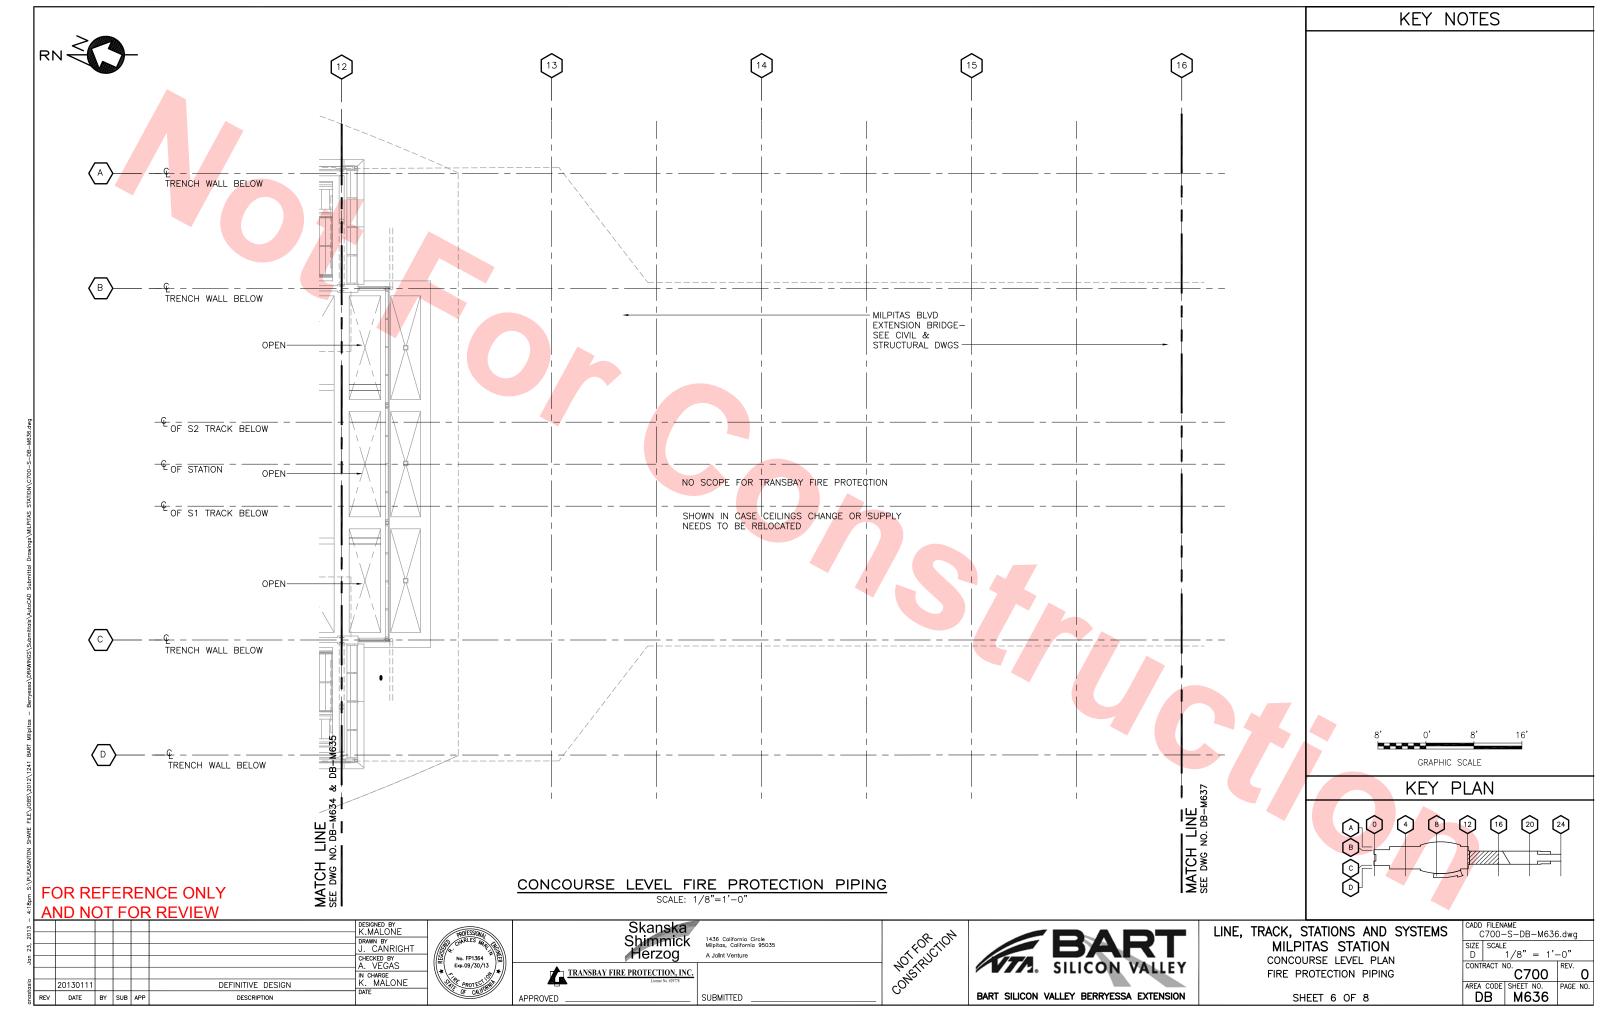

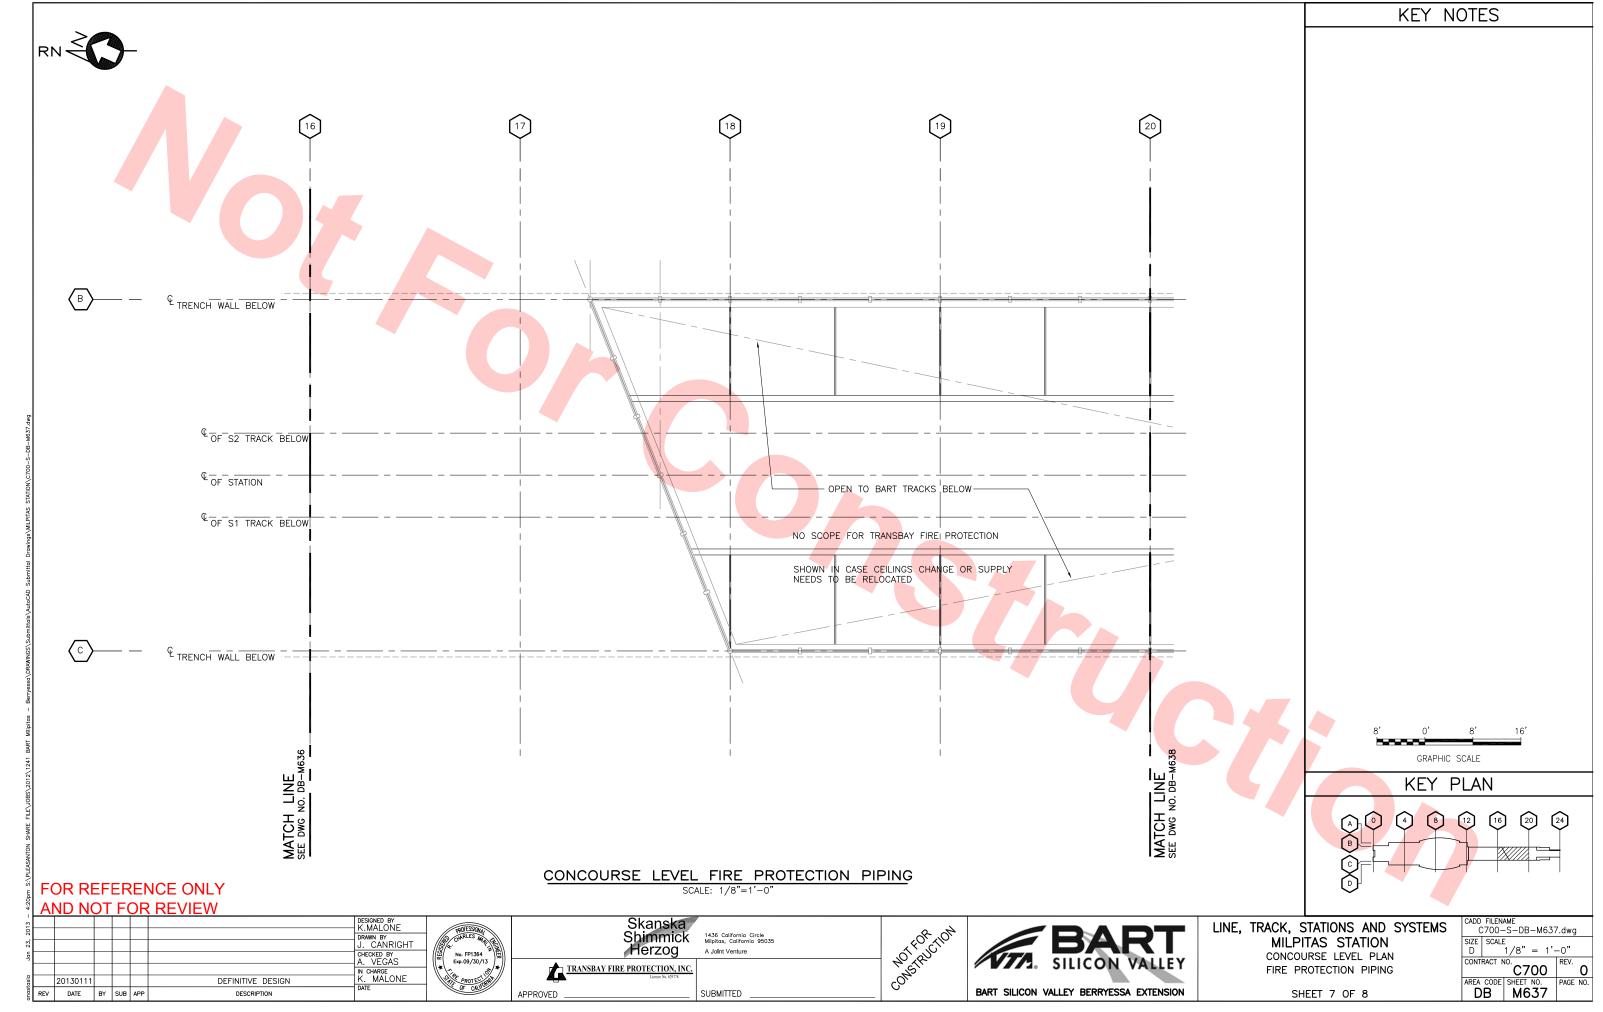

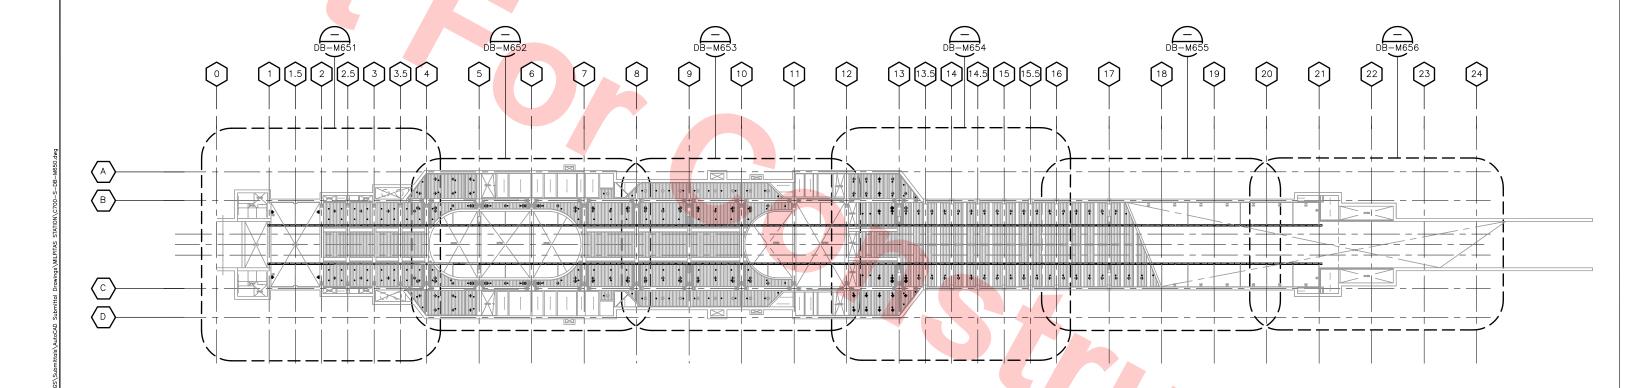

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KEYPLAN - PLATFORM LEVEL FIRE PROTECTION RCP

SCALE: 1/32"=1'-0"

DESIGNED BY K.MALONE DRAWN BY J. CANRIGHT CHECKED BY A. VEGAS N CHARGE K. MALONE DEFINITIVE DESIGN 20130111 REV DATE BY SUB APP



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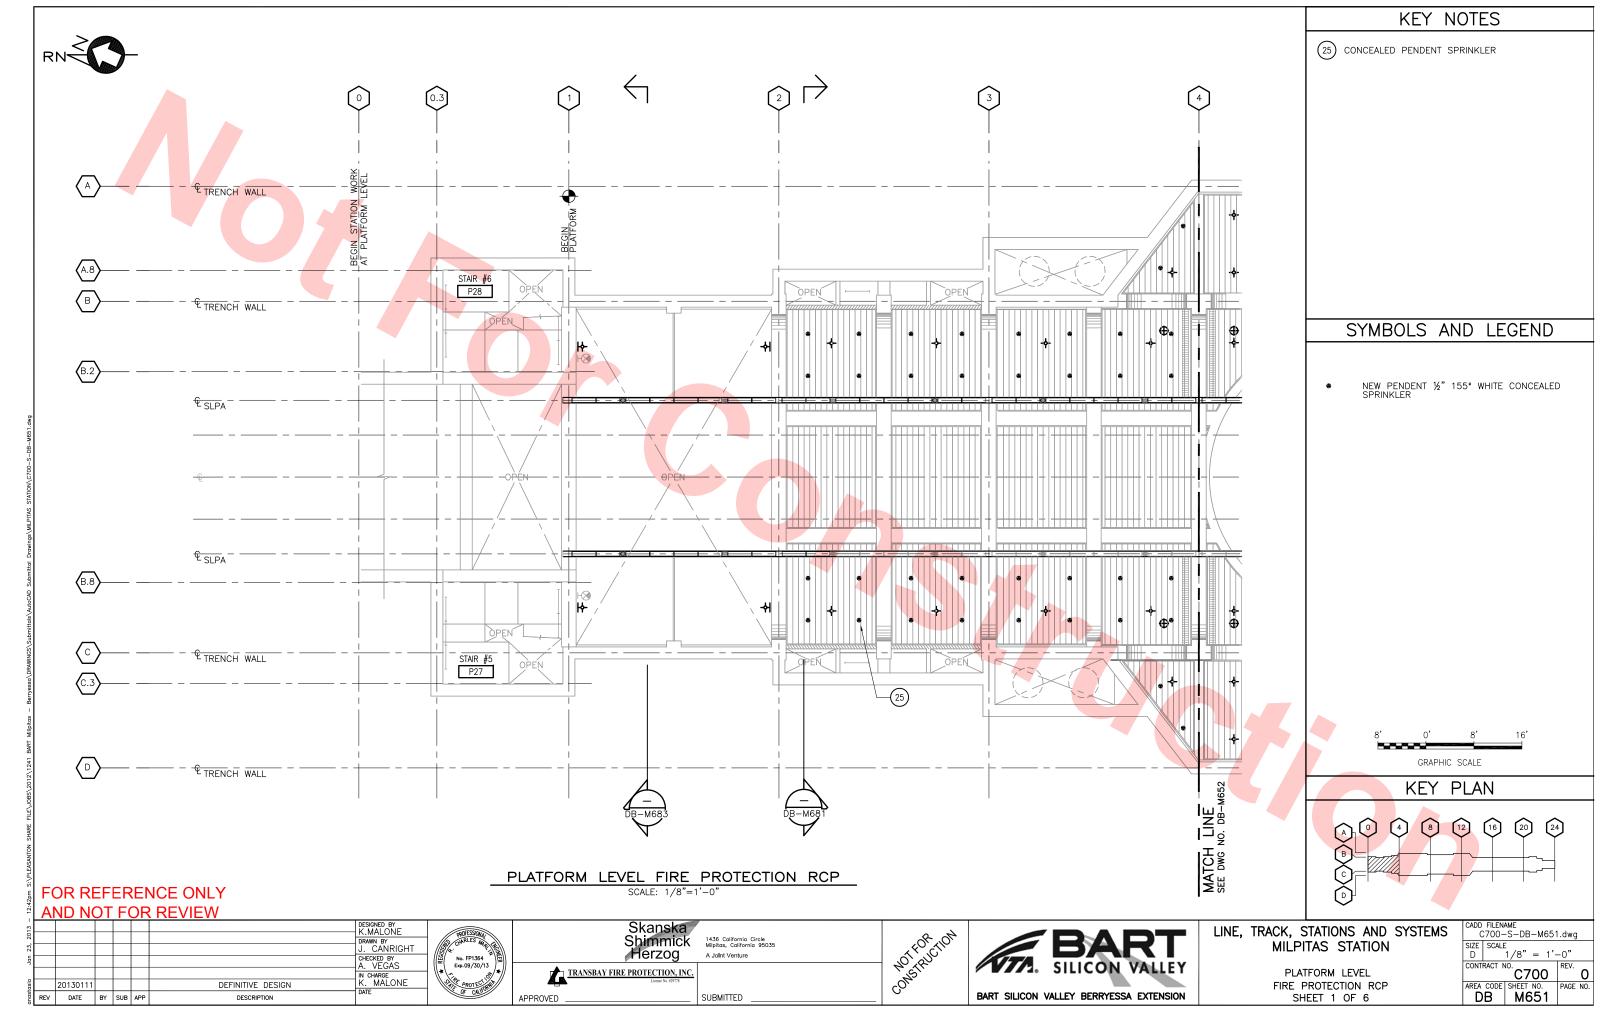






LINE, TRACK, STATIONS AND SYSTE MILPITAS STATION


KEYPLAN PLATFORM LEVEL FIRE PROTECTION


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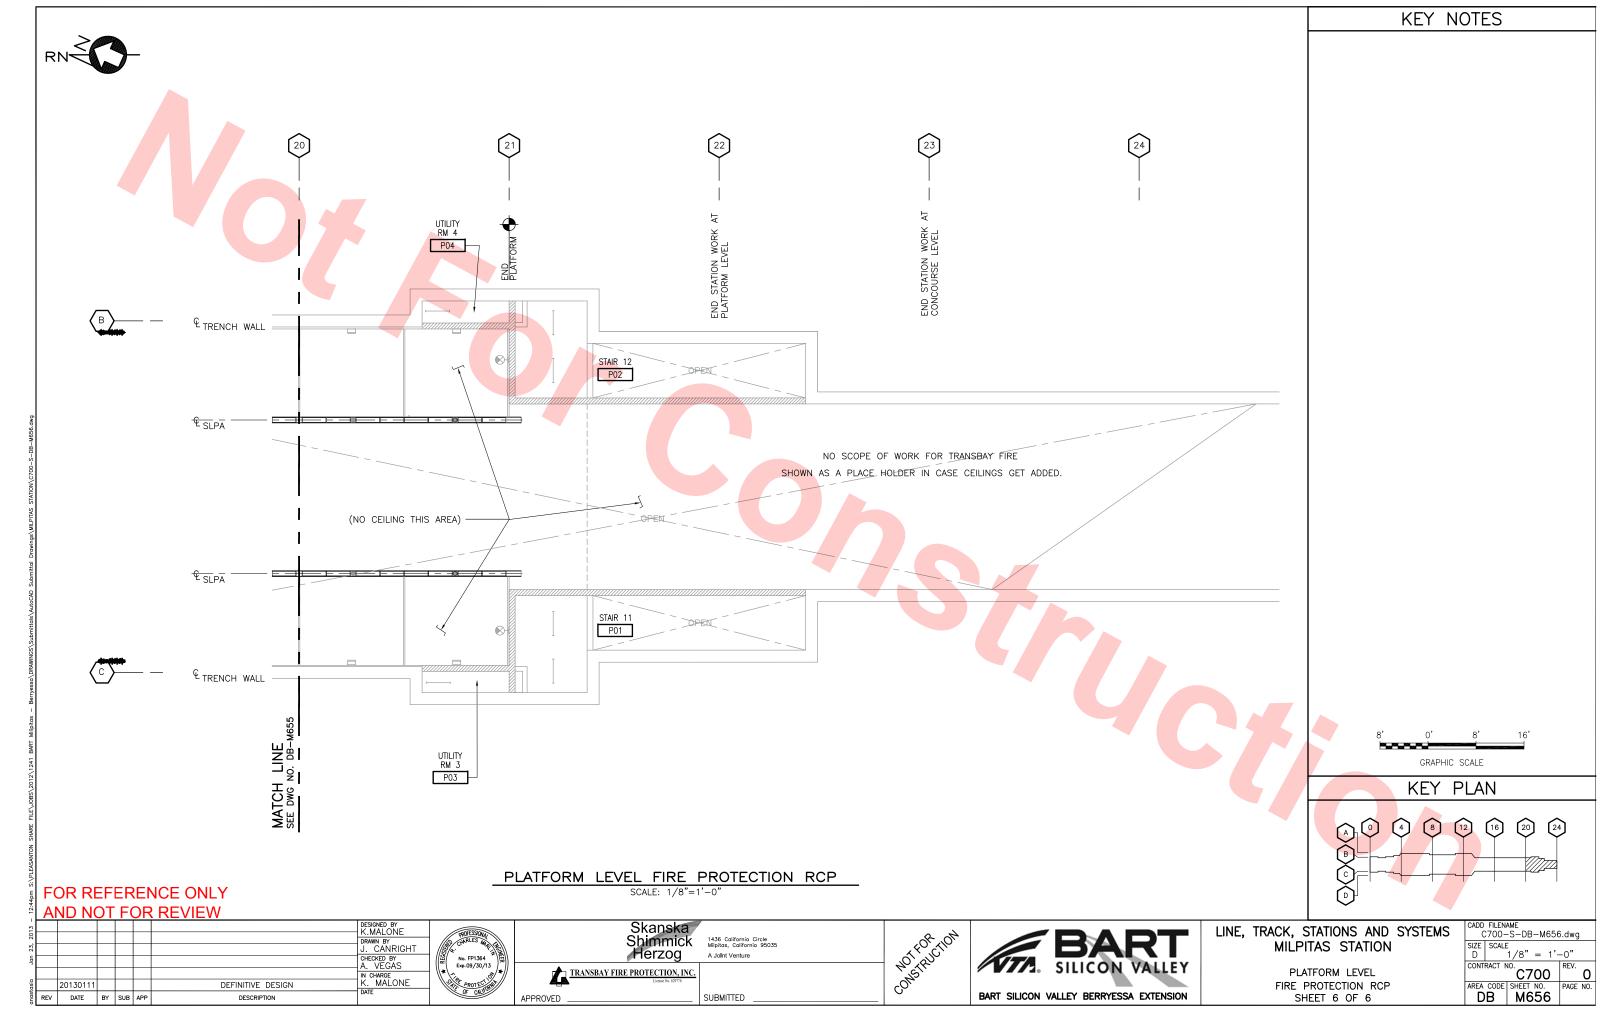




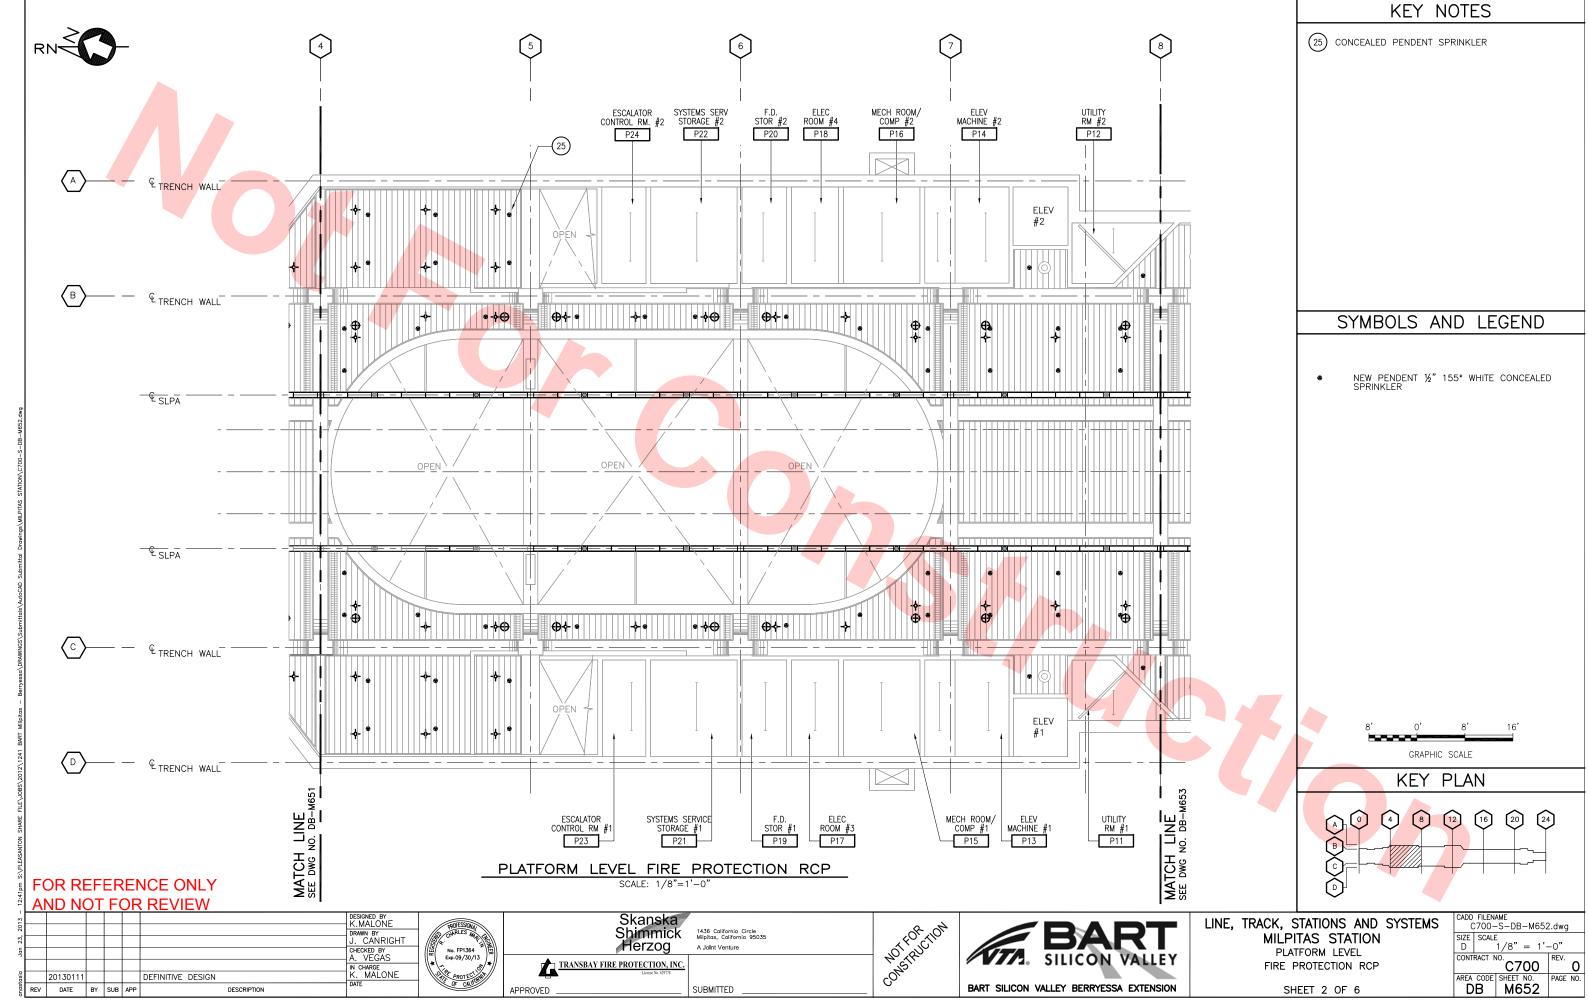


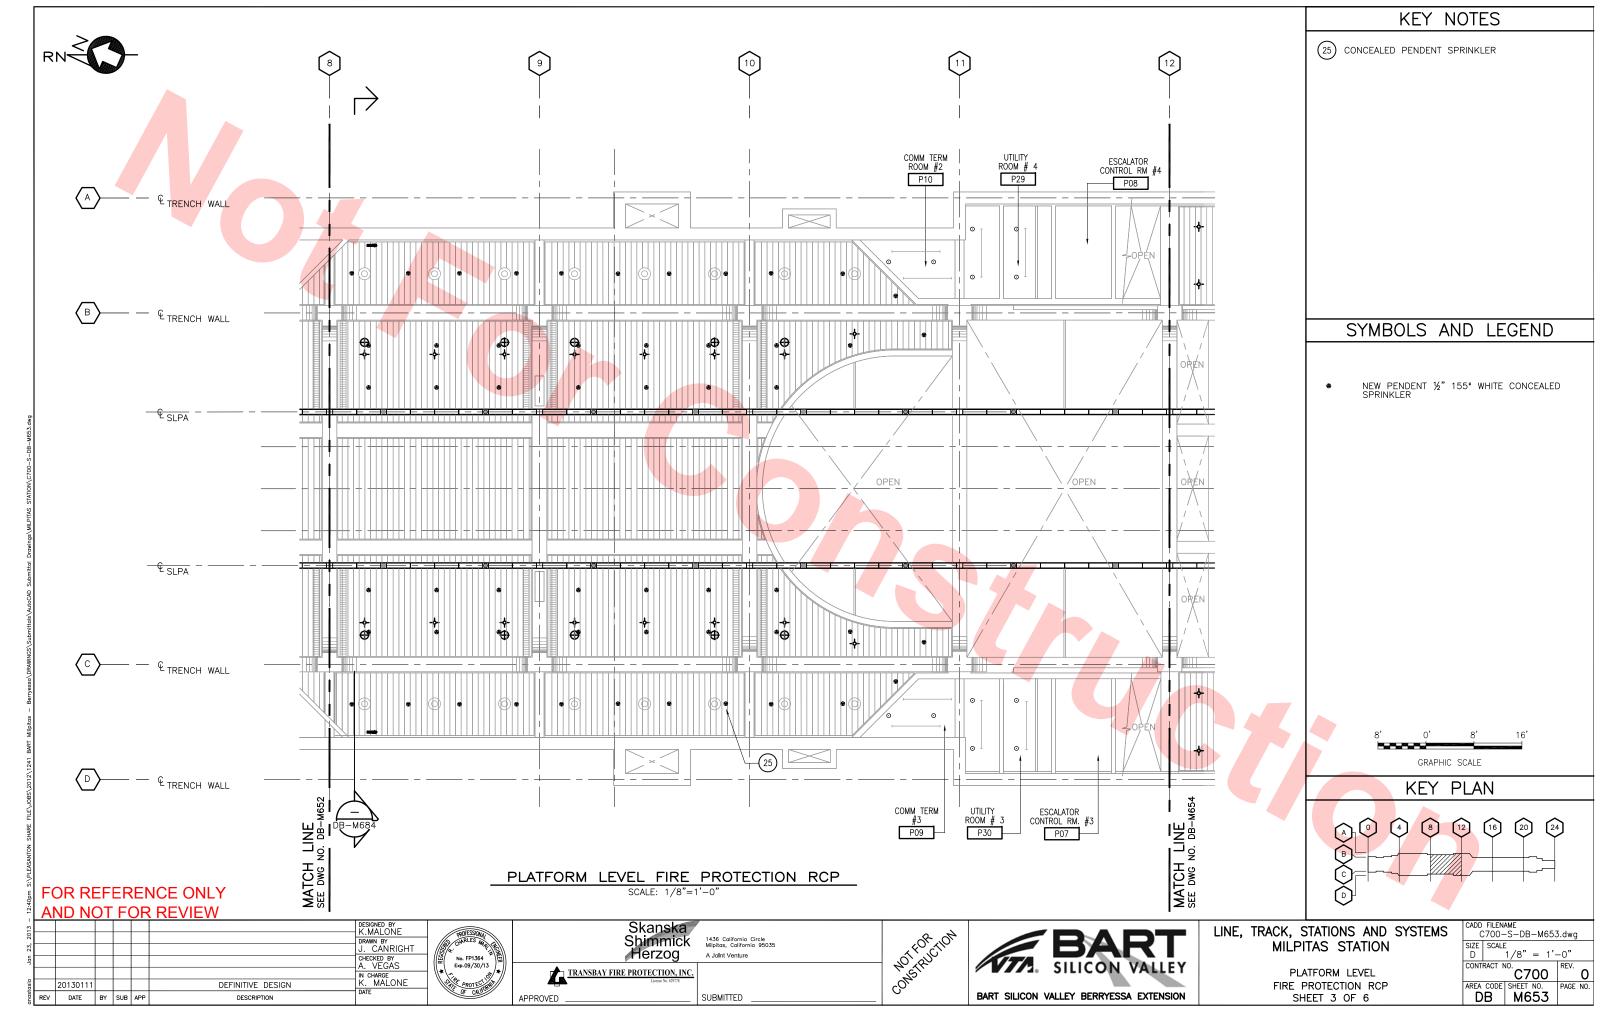

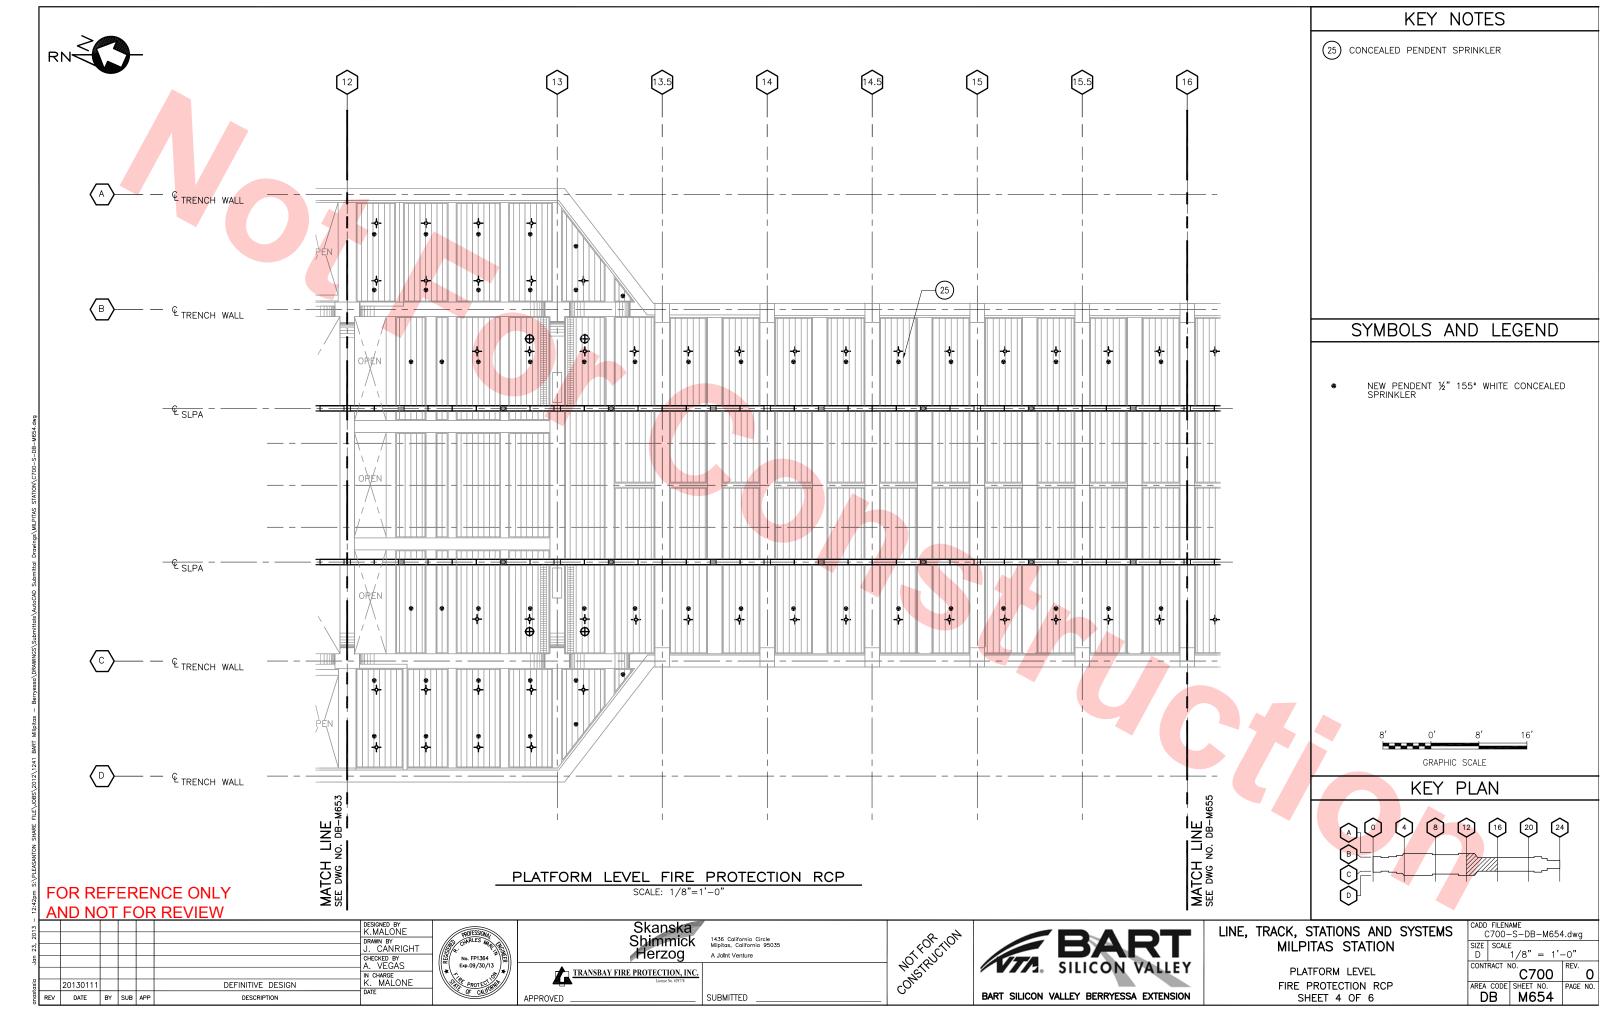

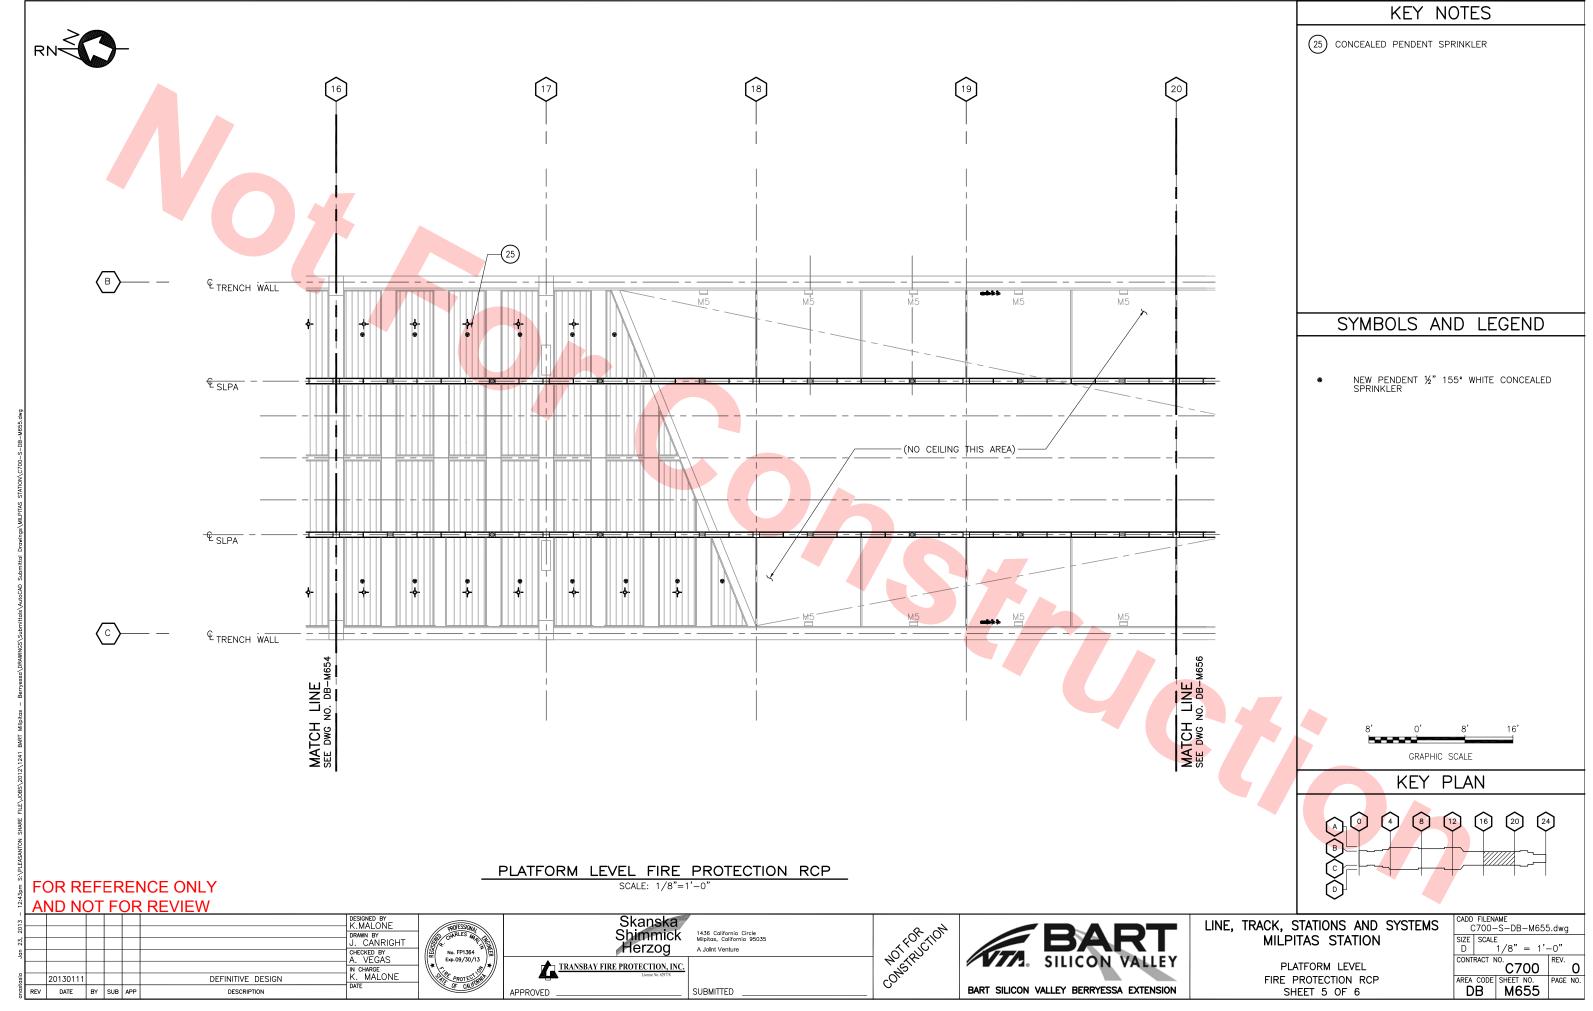



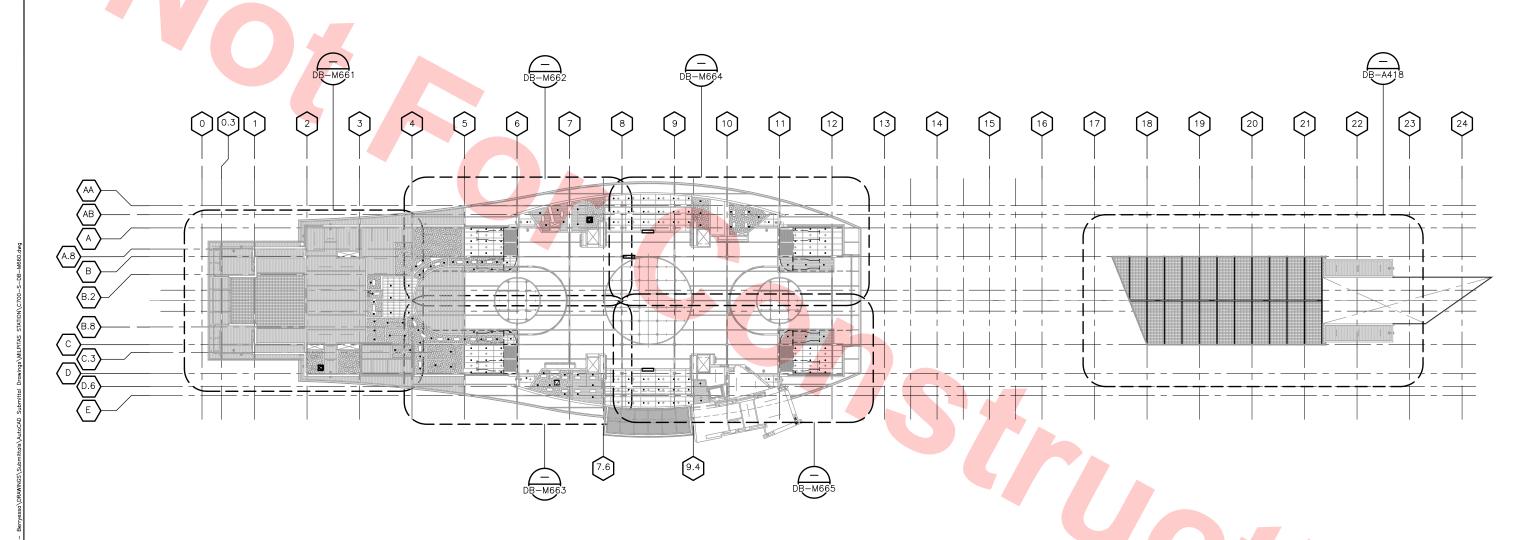

KEY PLAN - CONCOURSE LEVEL FIRE PROTECTION RCP

SCALE: 1/32"=1'-0"

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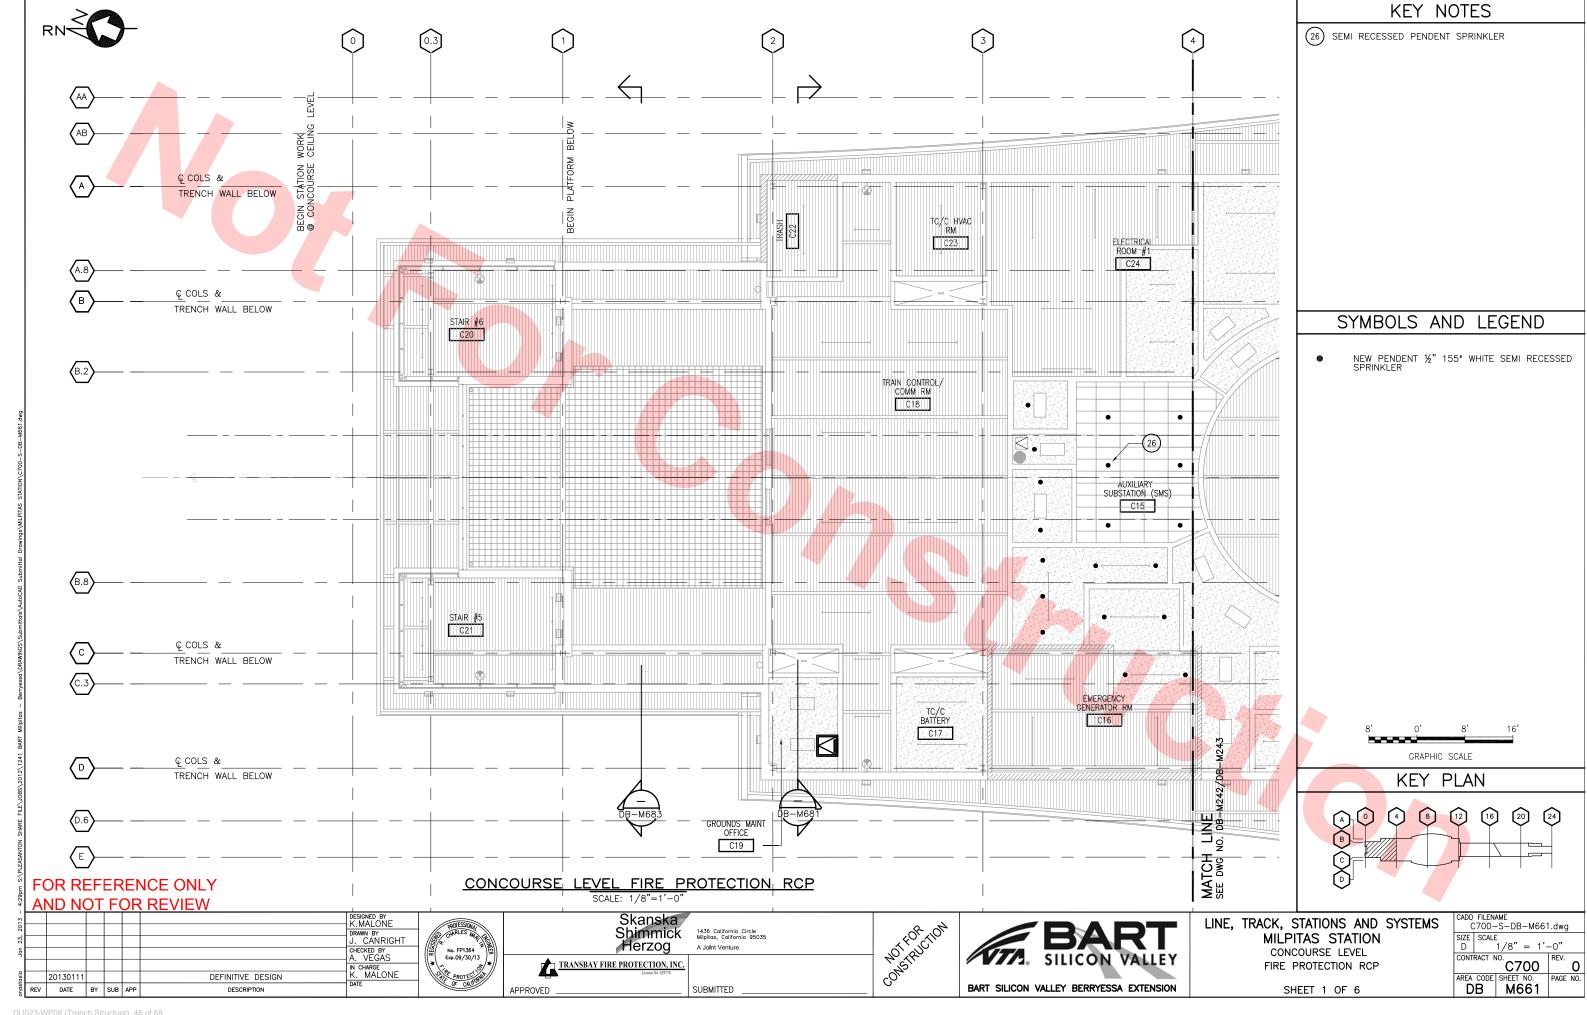






LINE, TRACK, STATIONS AND SYSTEM MILPITAS STATION KEY PLAN


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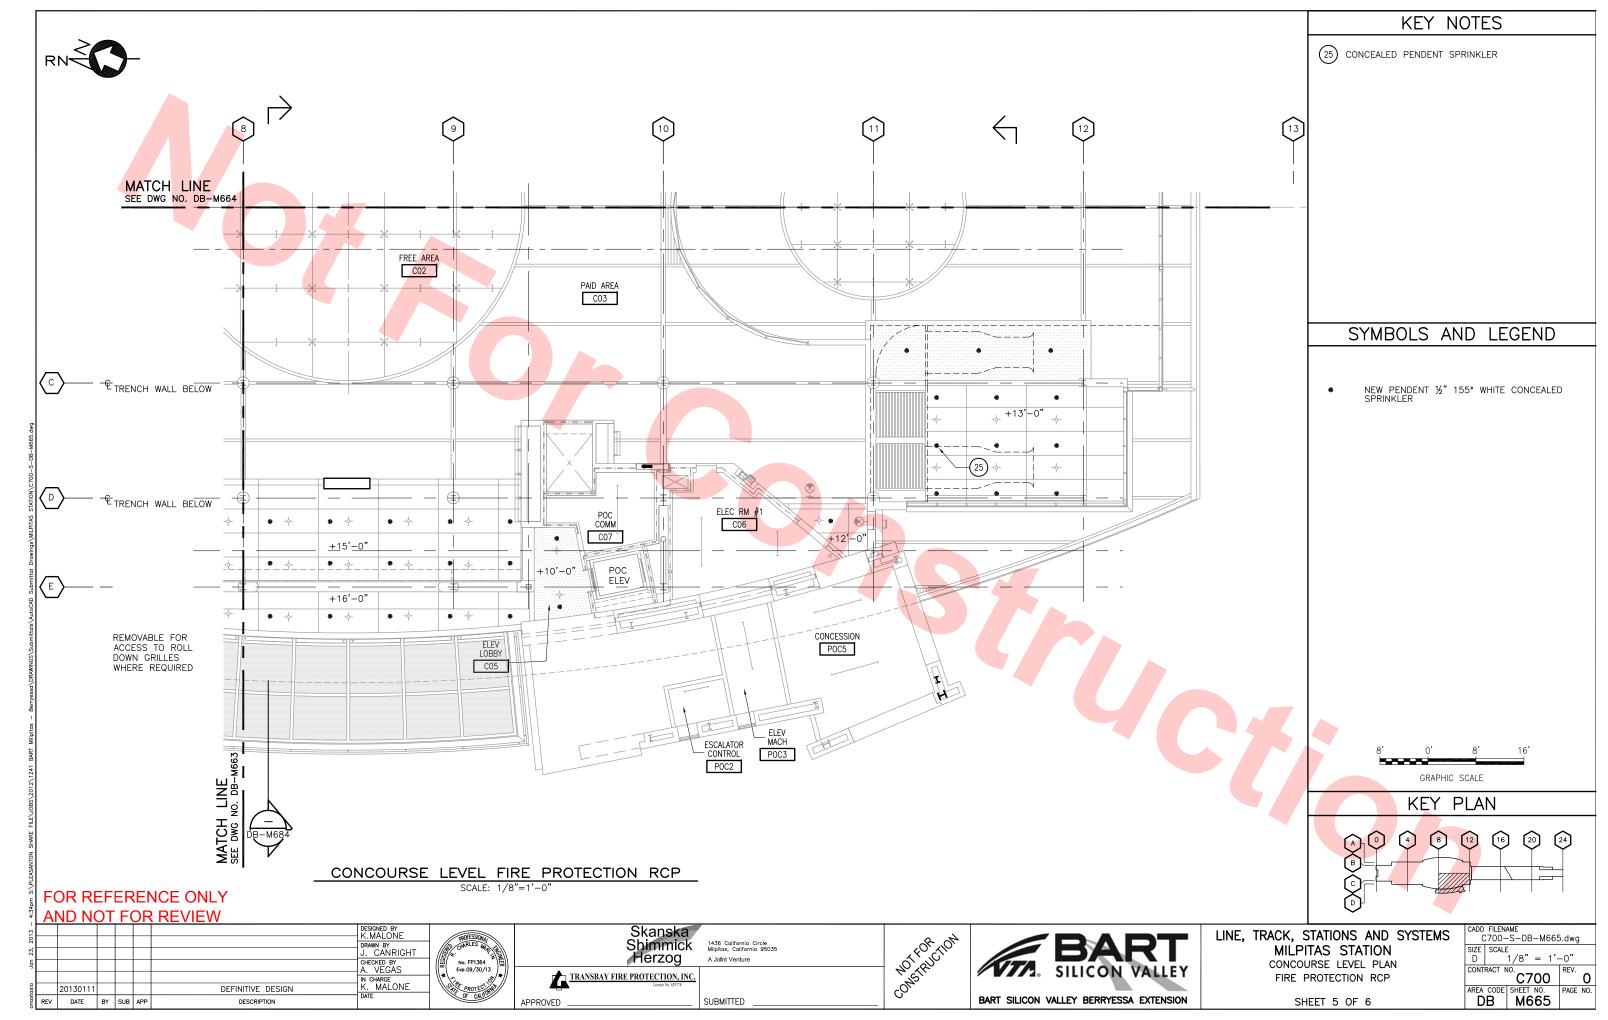
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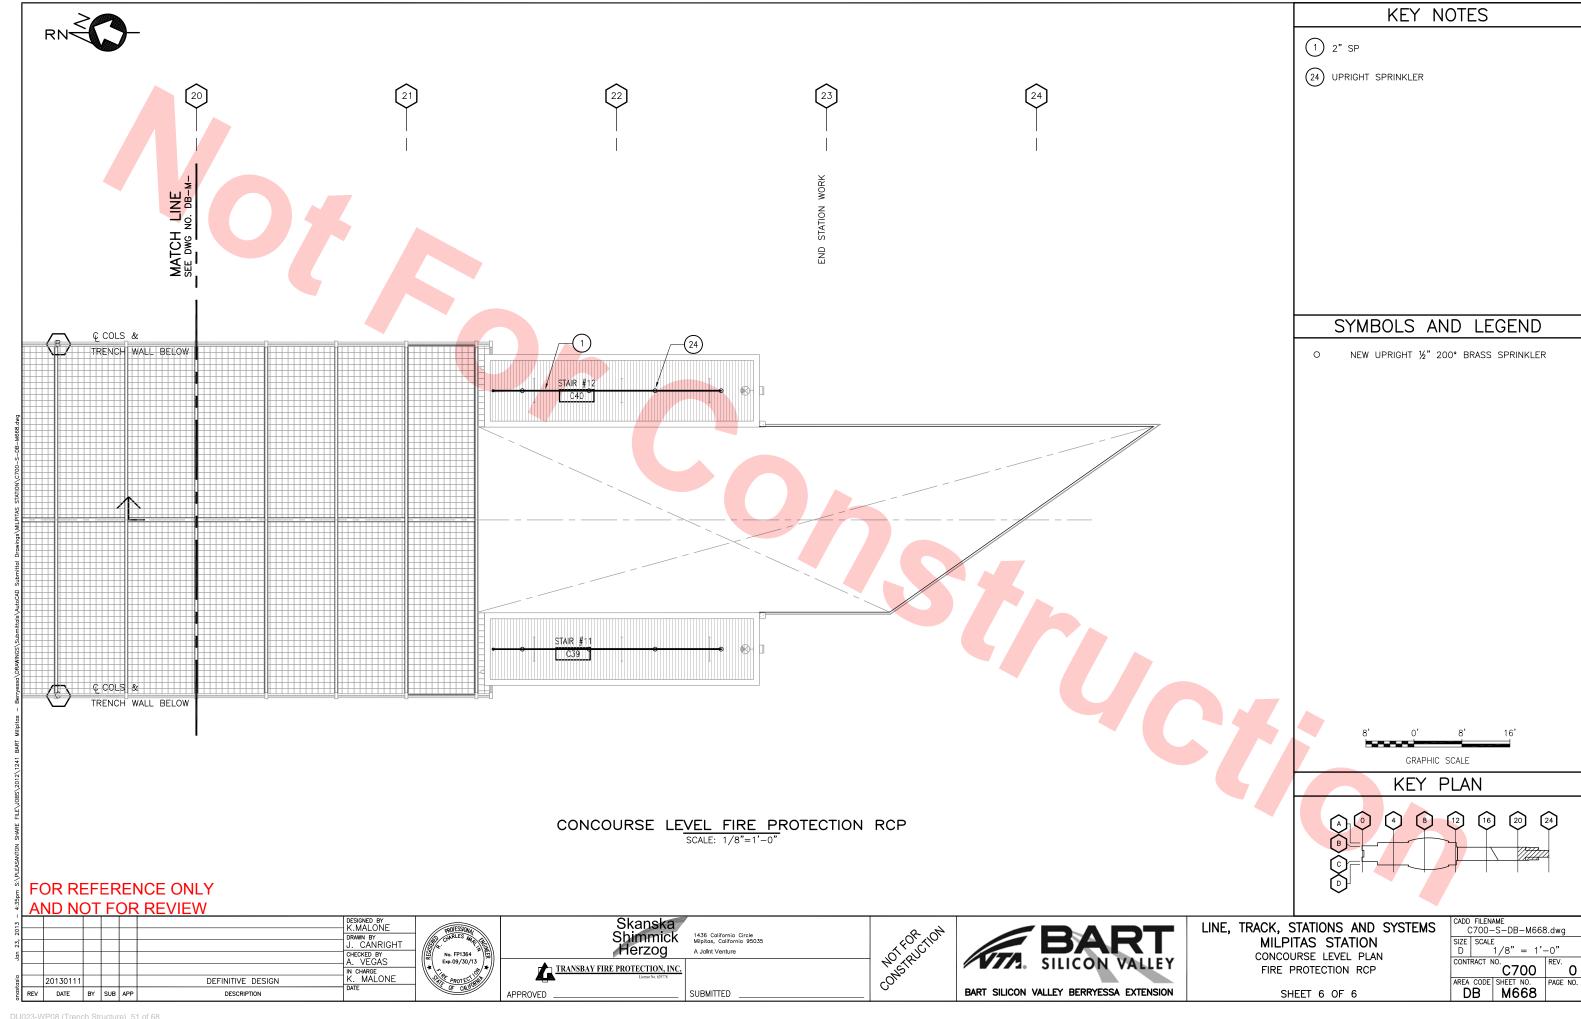







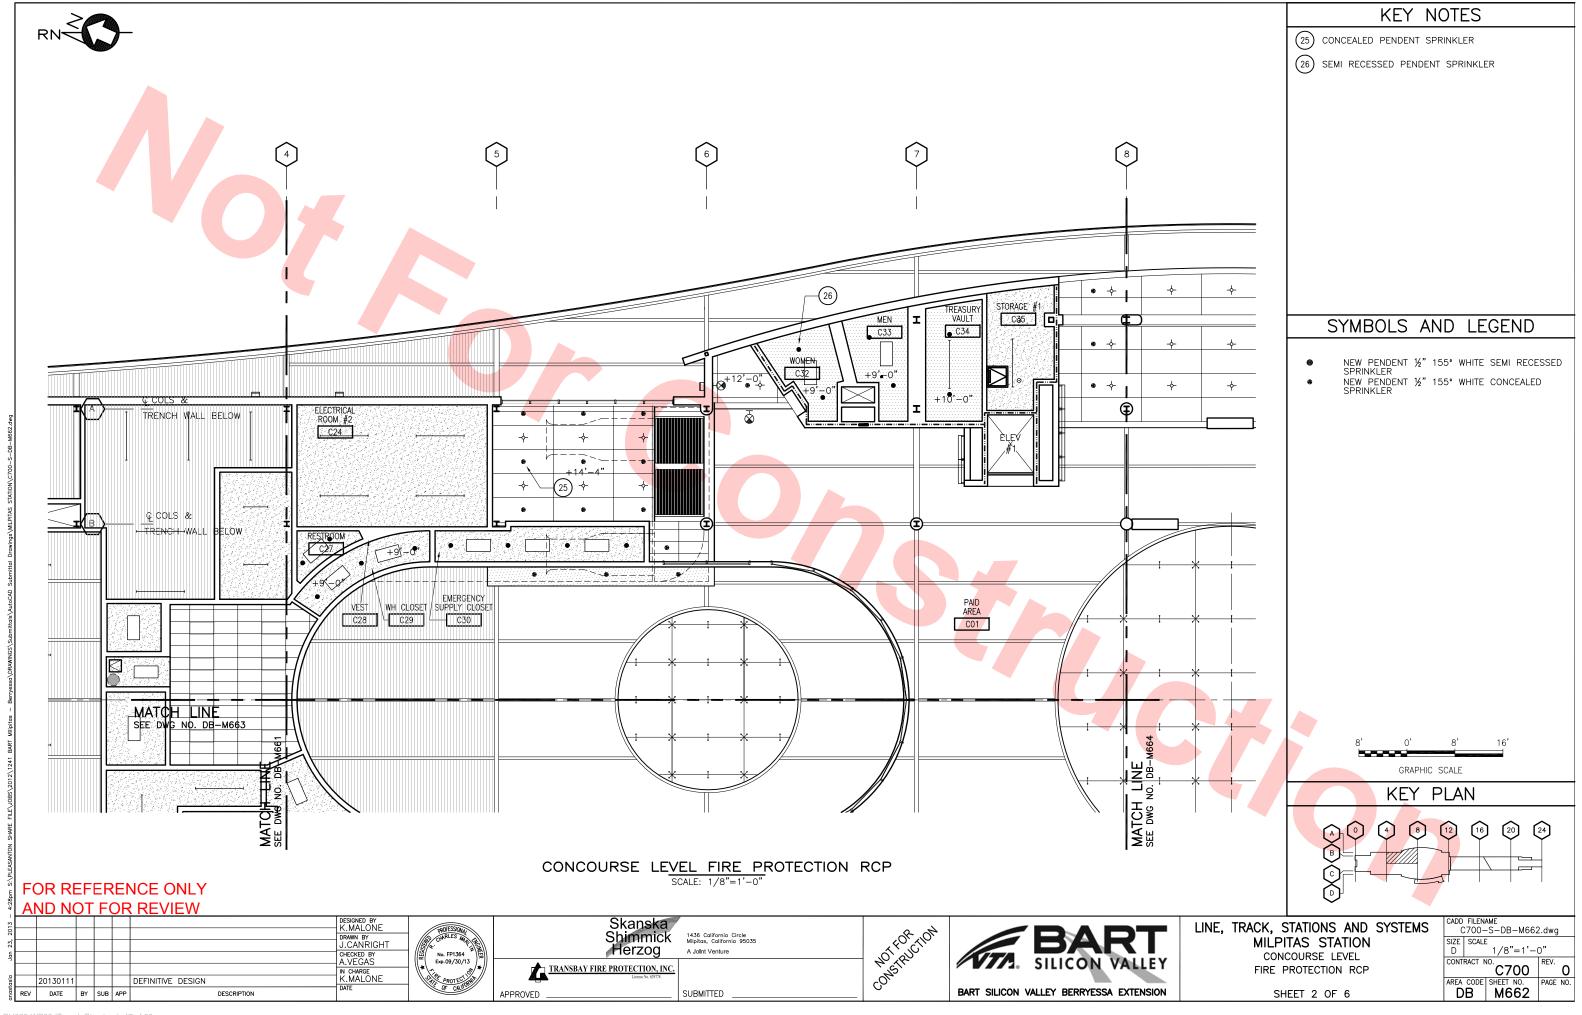

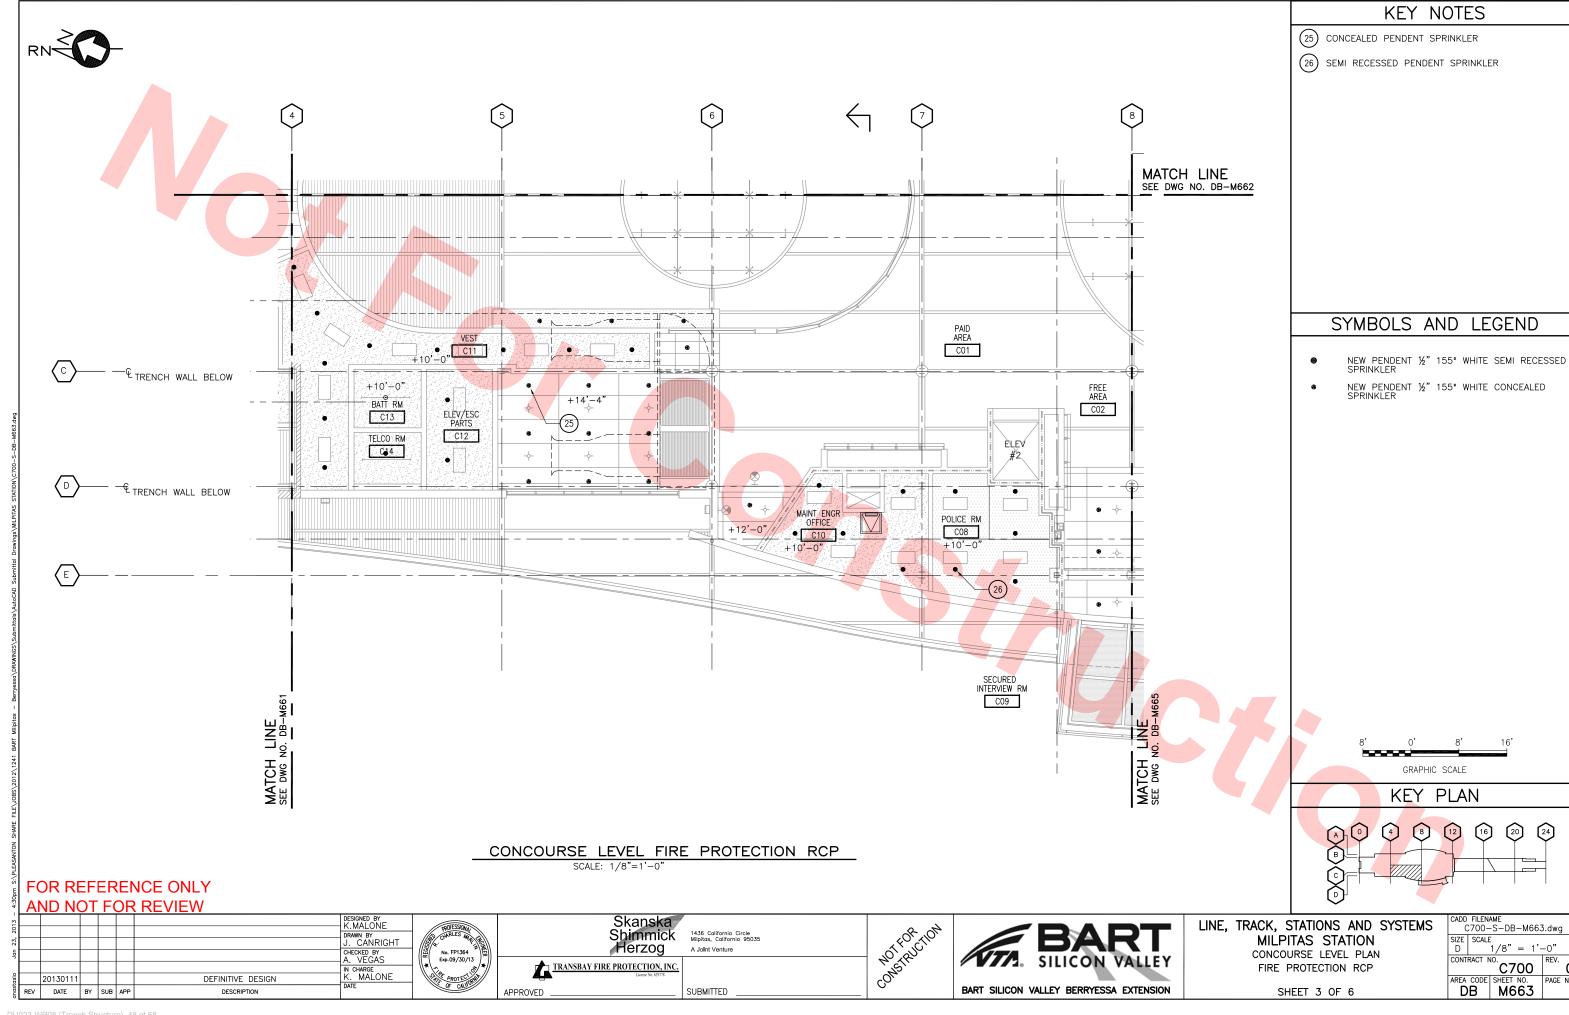

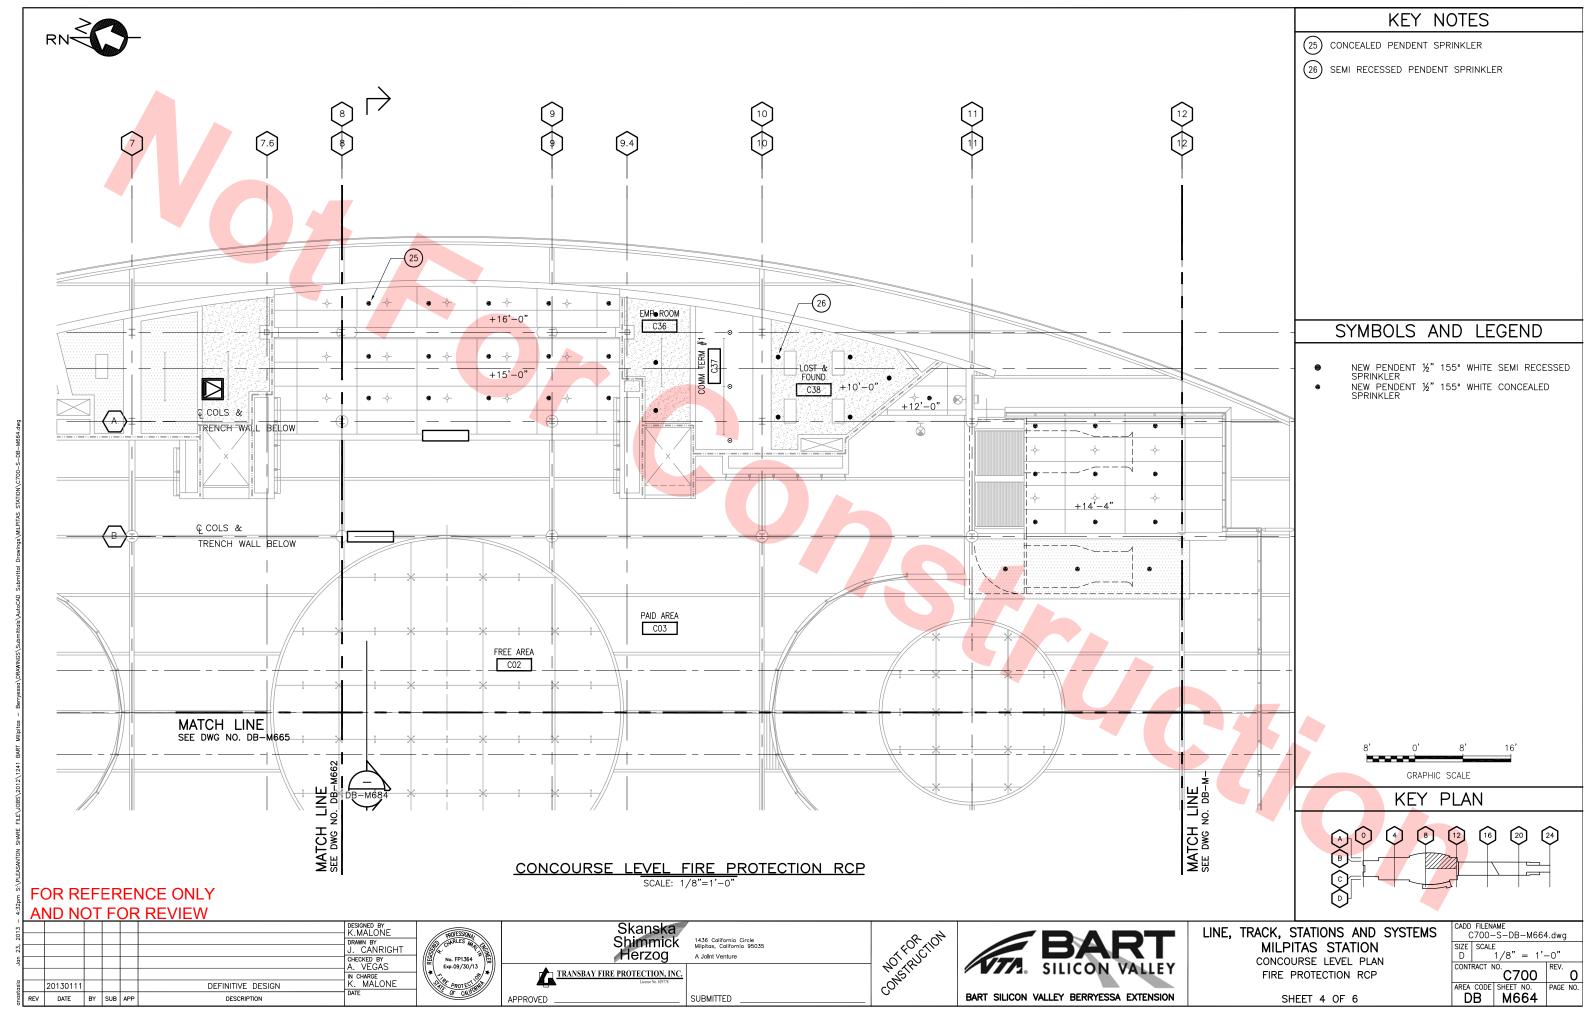



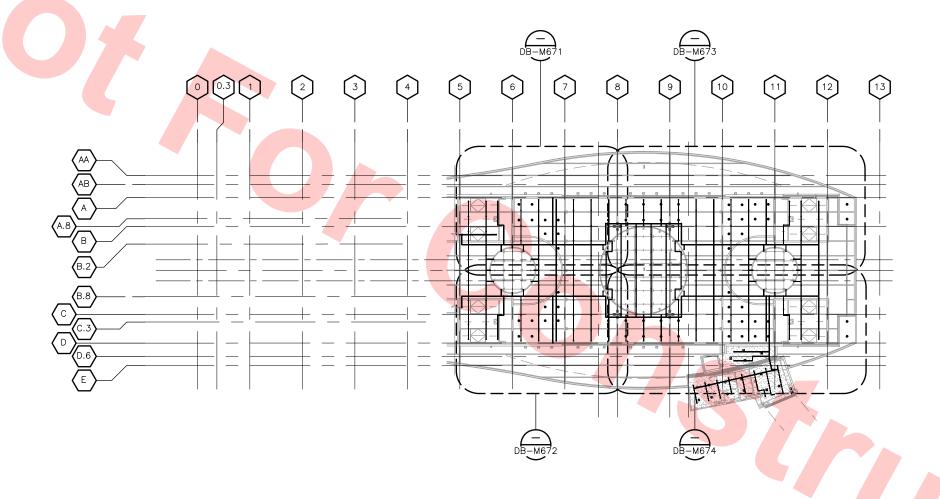

KEY PLAN - CONCOURSE LEVEL HIGH CEILING-FIRE PROTECTION RCP SCALE: 1/32"=1'-0"

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J. CANRIGHT
CHECKED BY
A. VEGAS IN CHARGE K. MALONE DEFINITIVE DESIGN 20130111 REV DATE BY SUB APP



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1436 California Circle Milpitas, California 95035 A Joint Venture SUBMITTED







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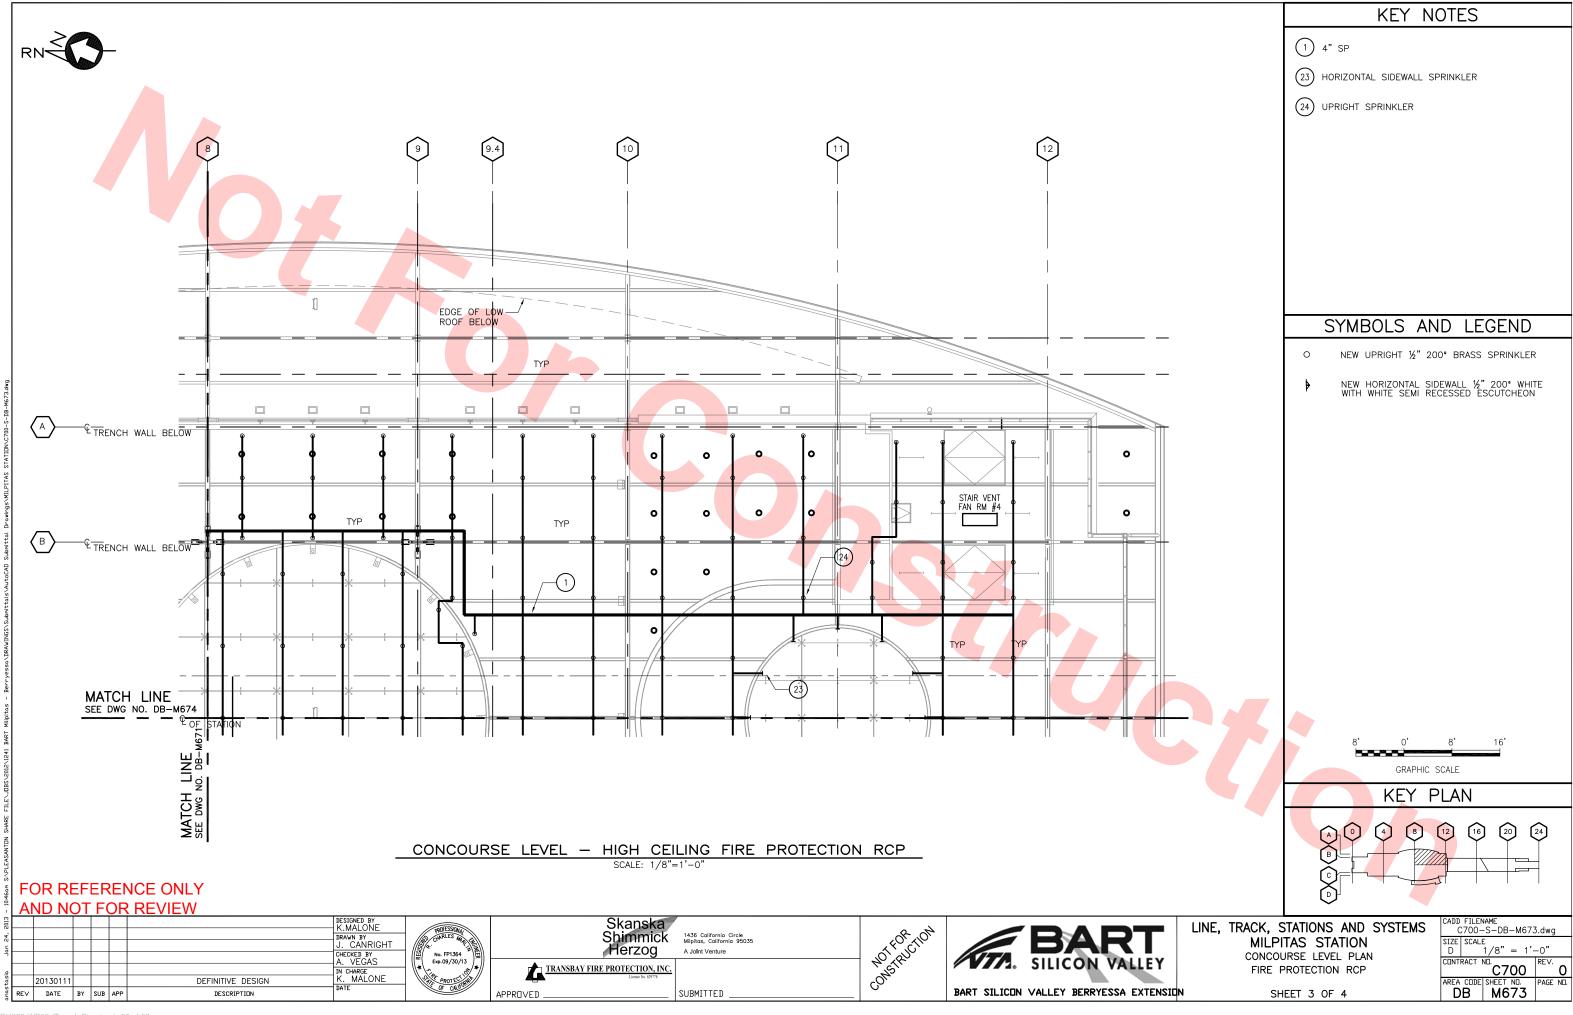
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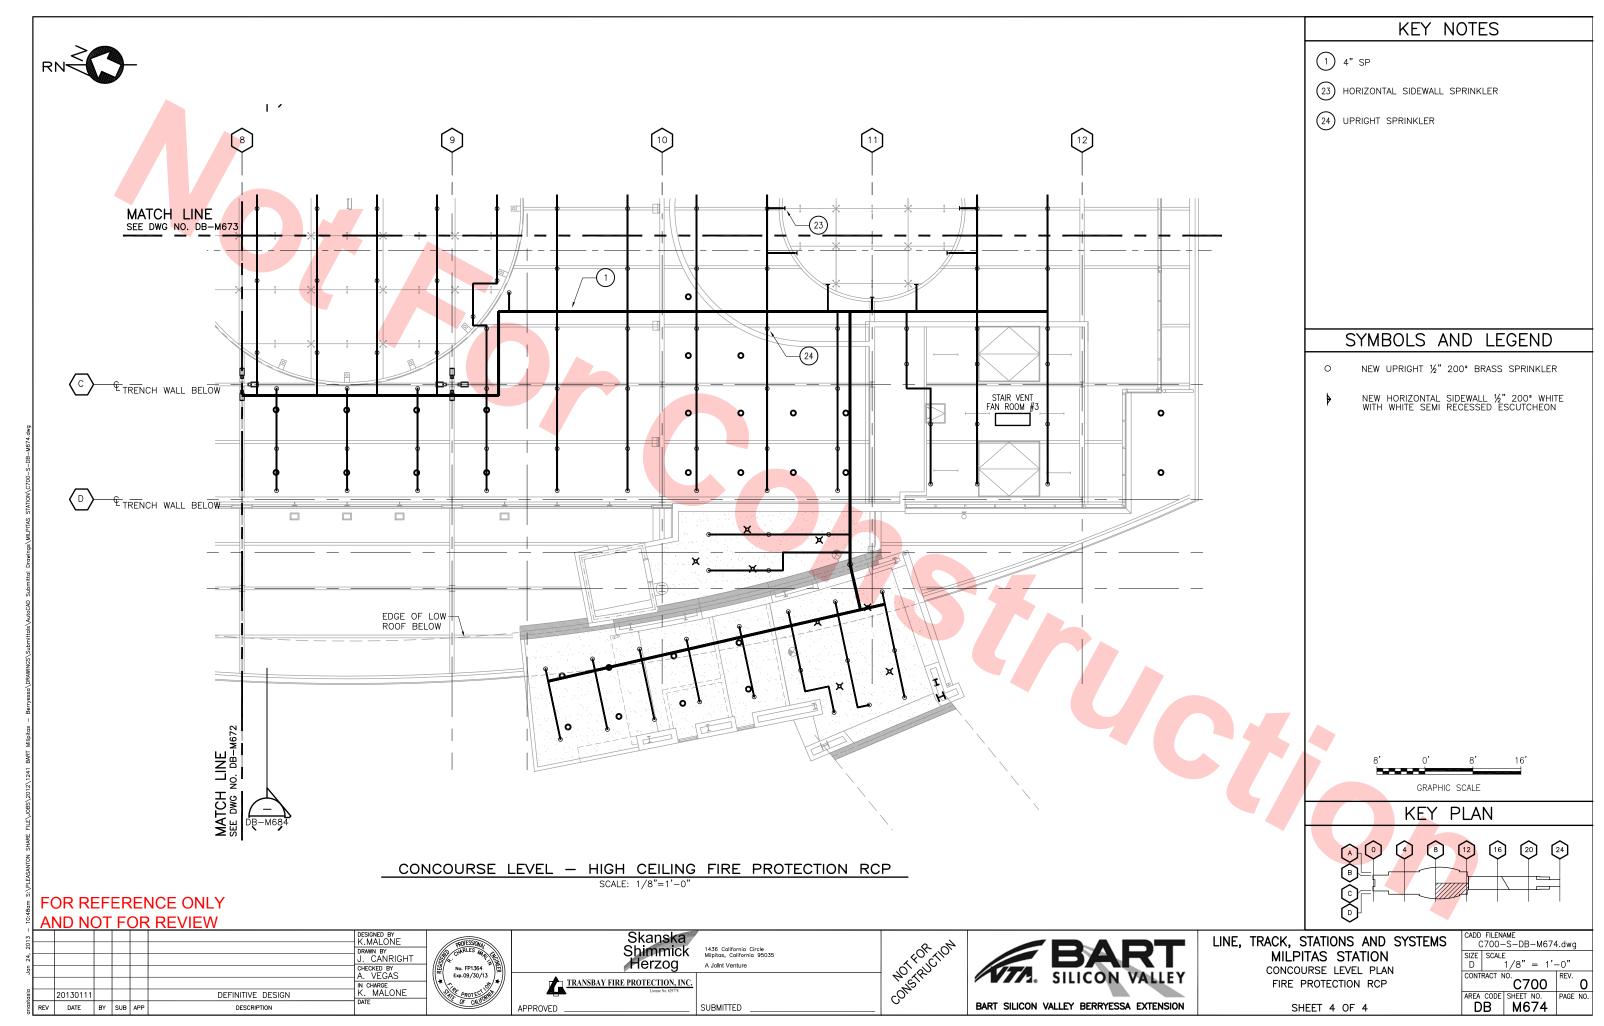
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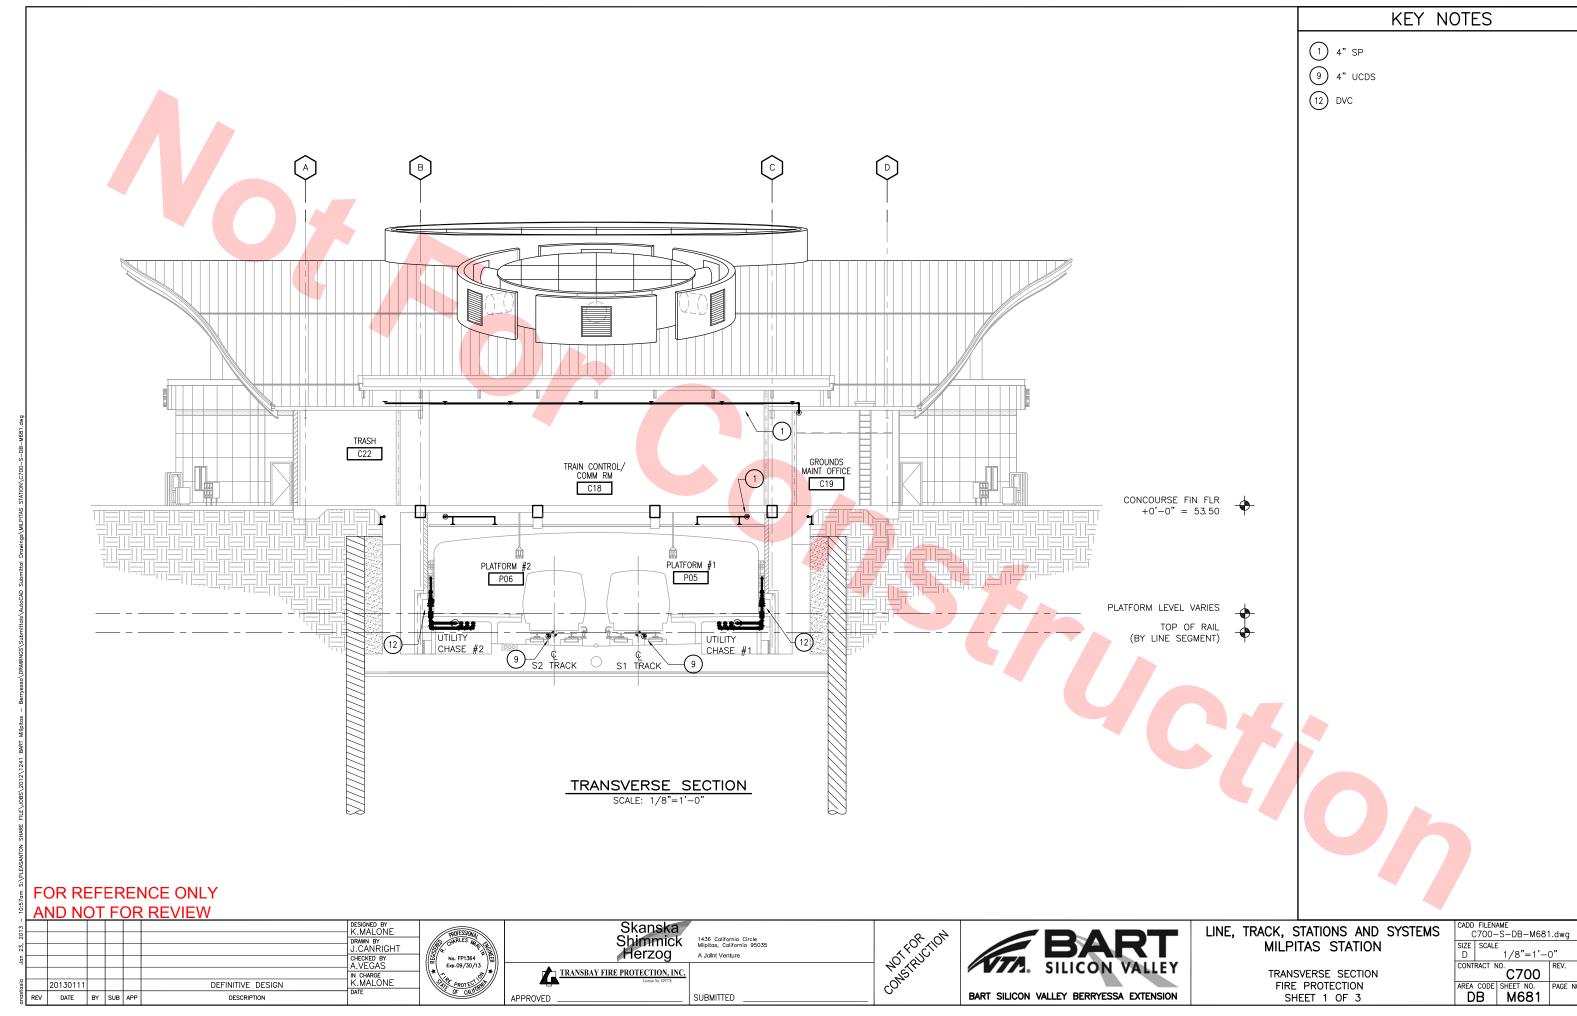
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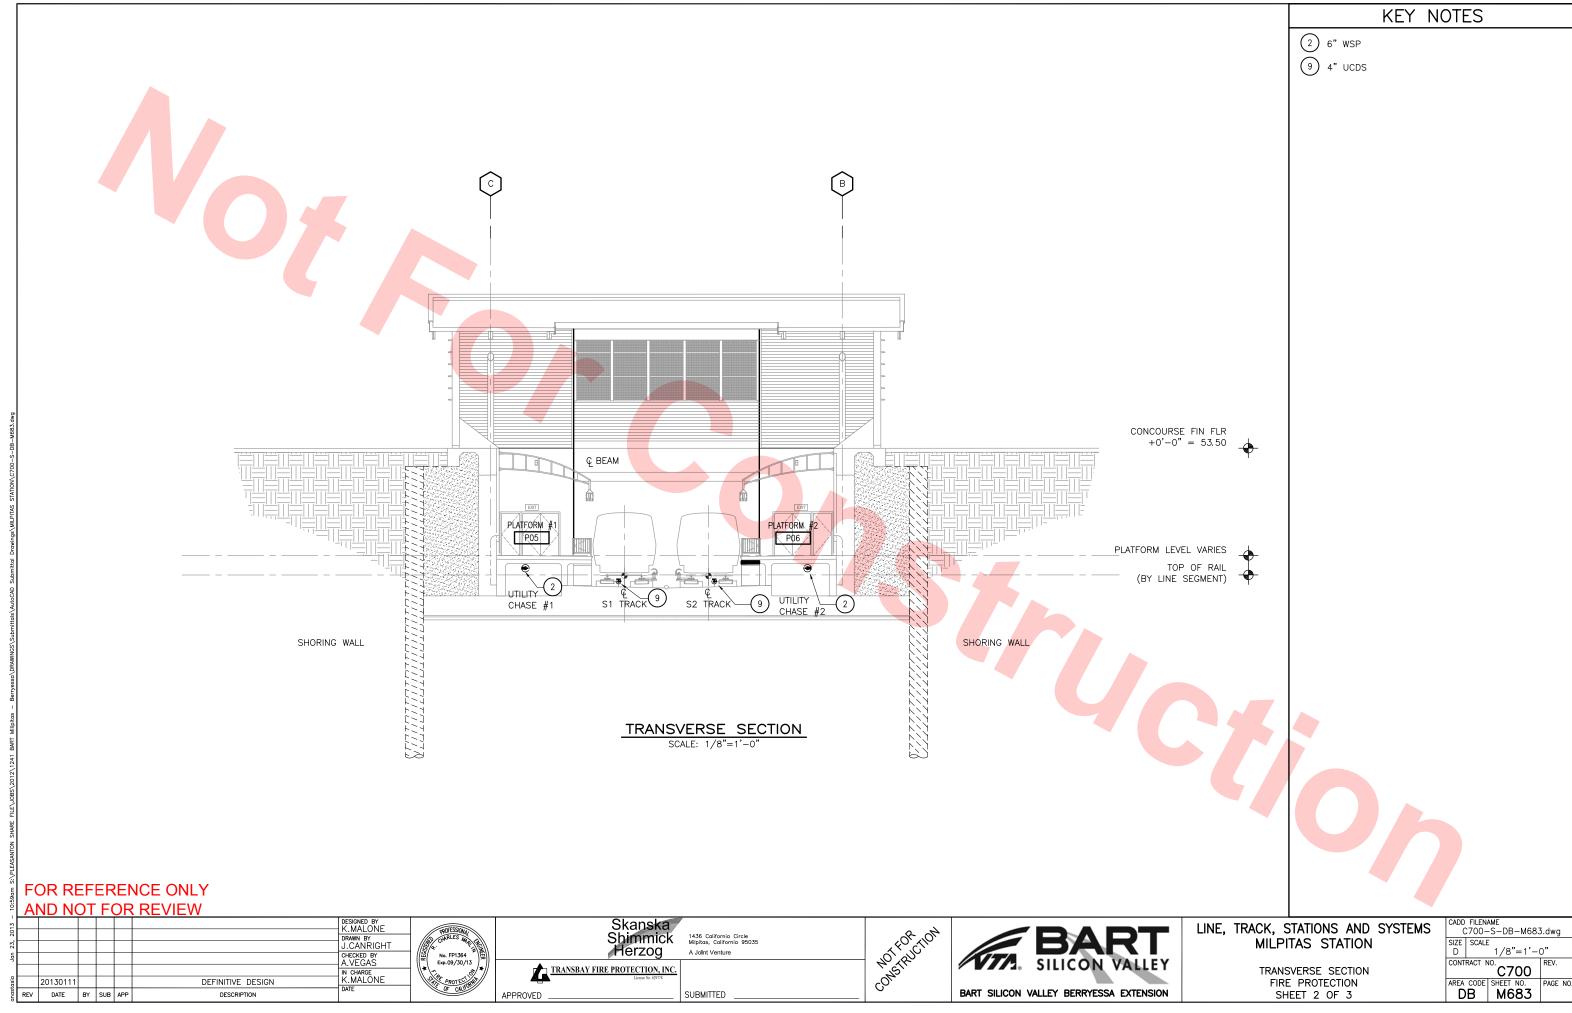










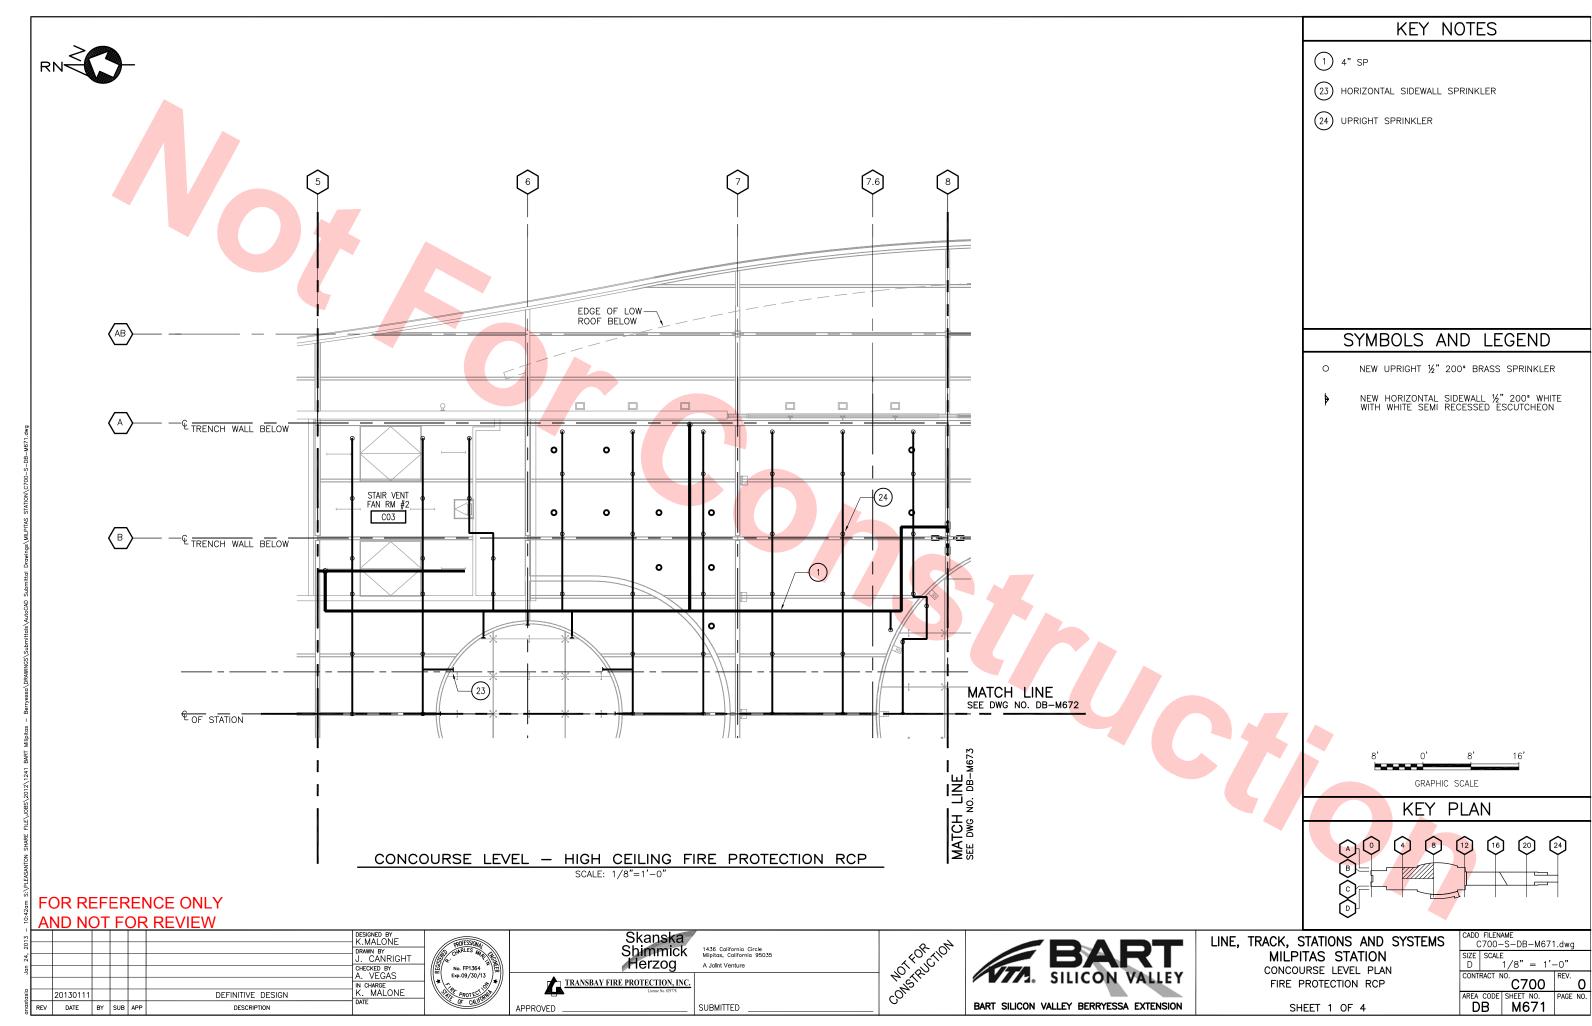


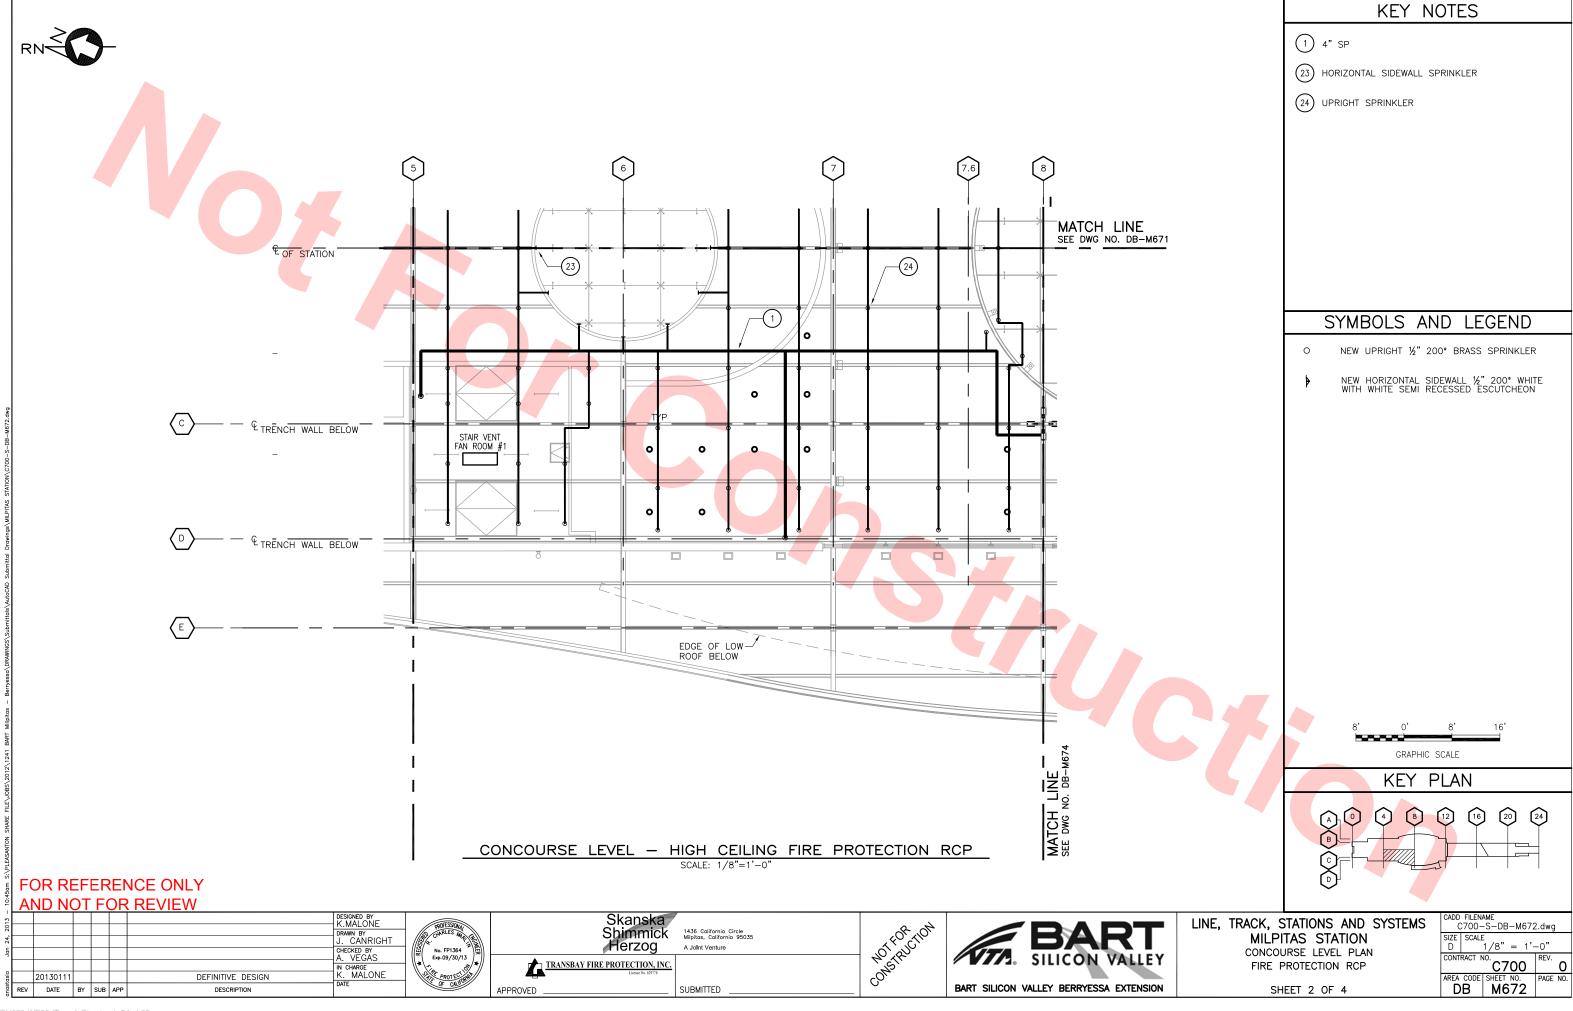


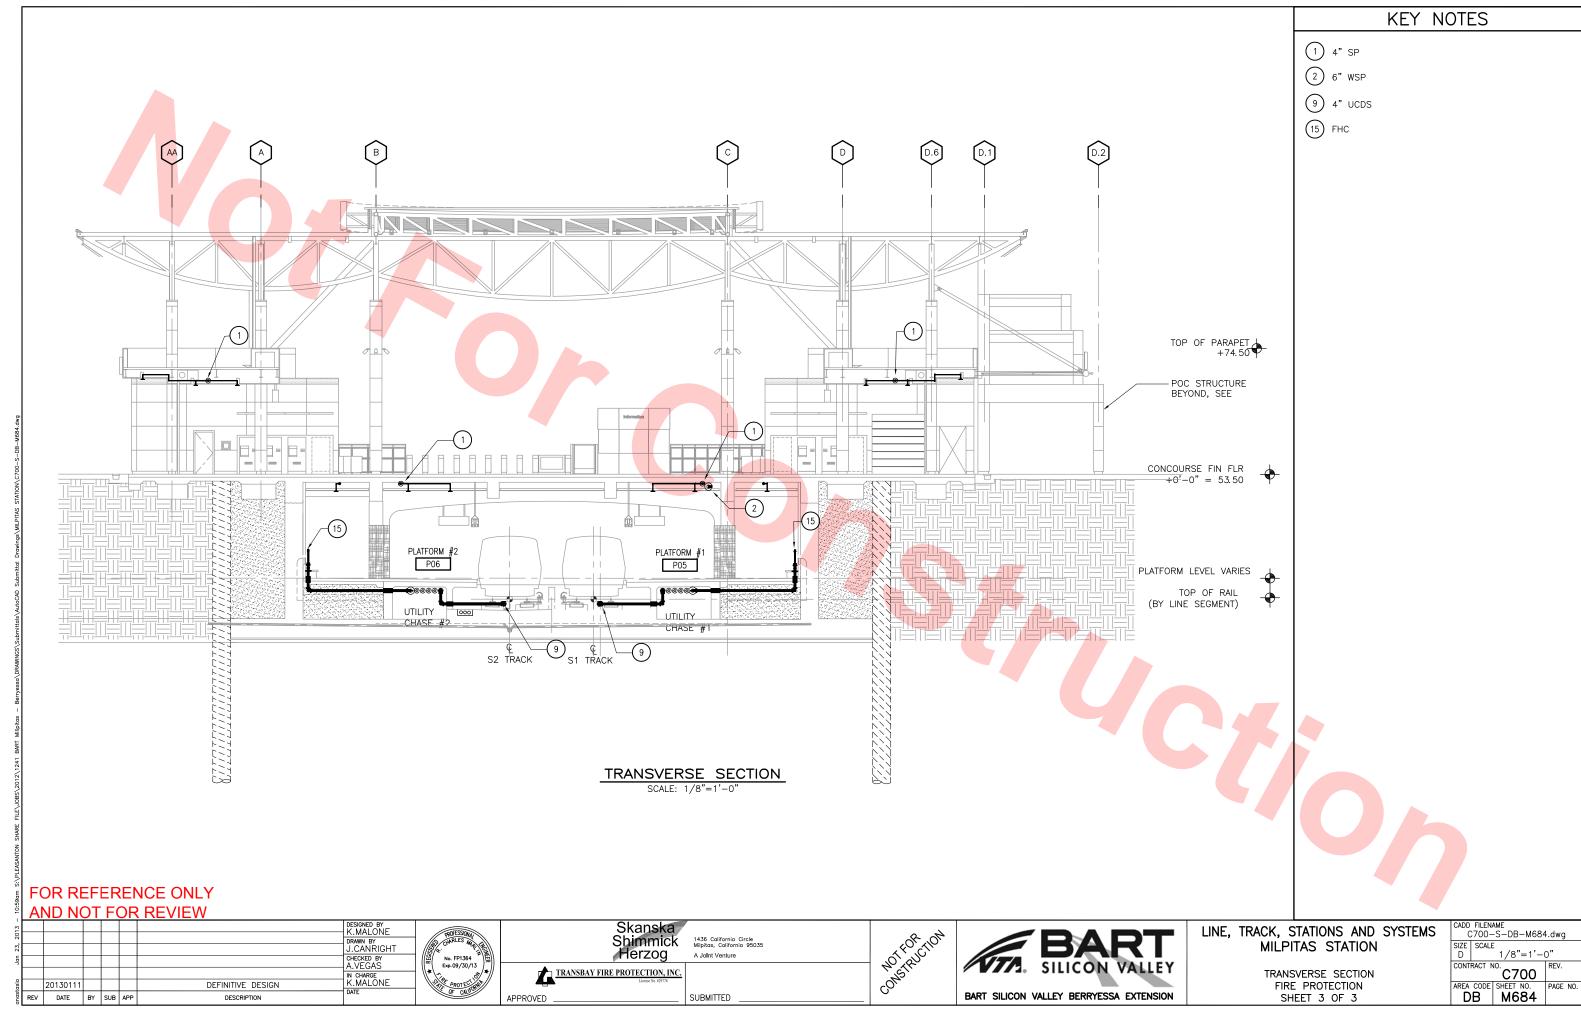


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KEY NOTES

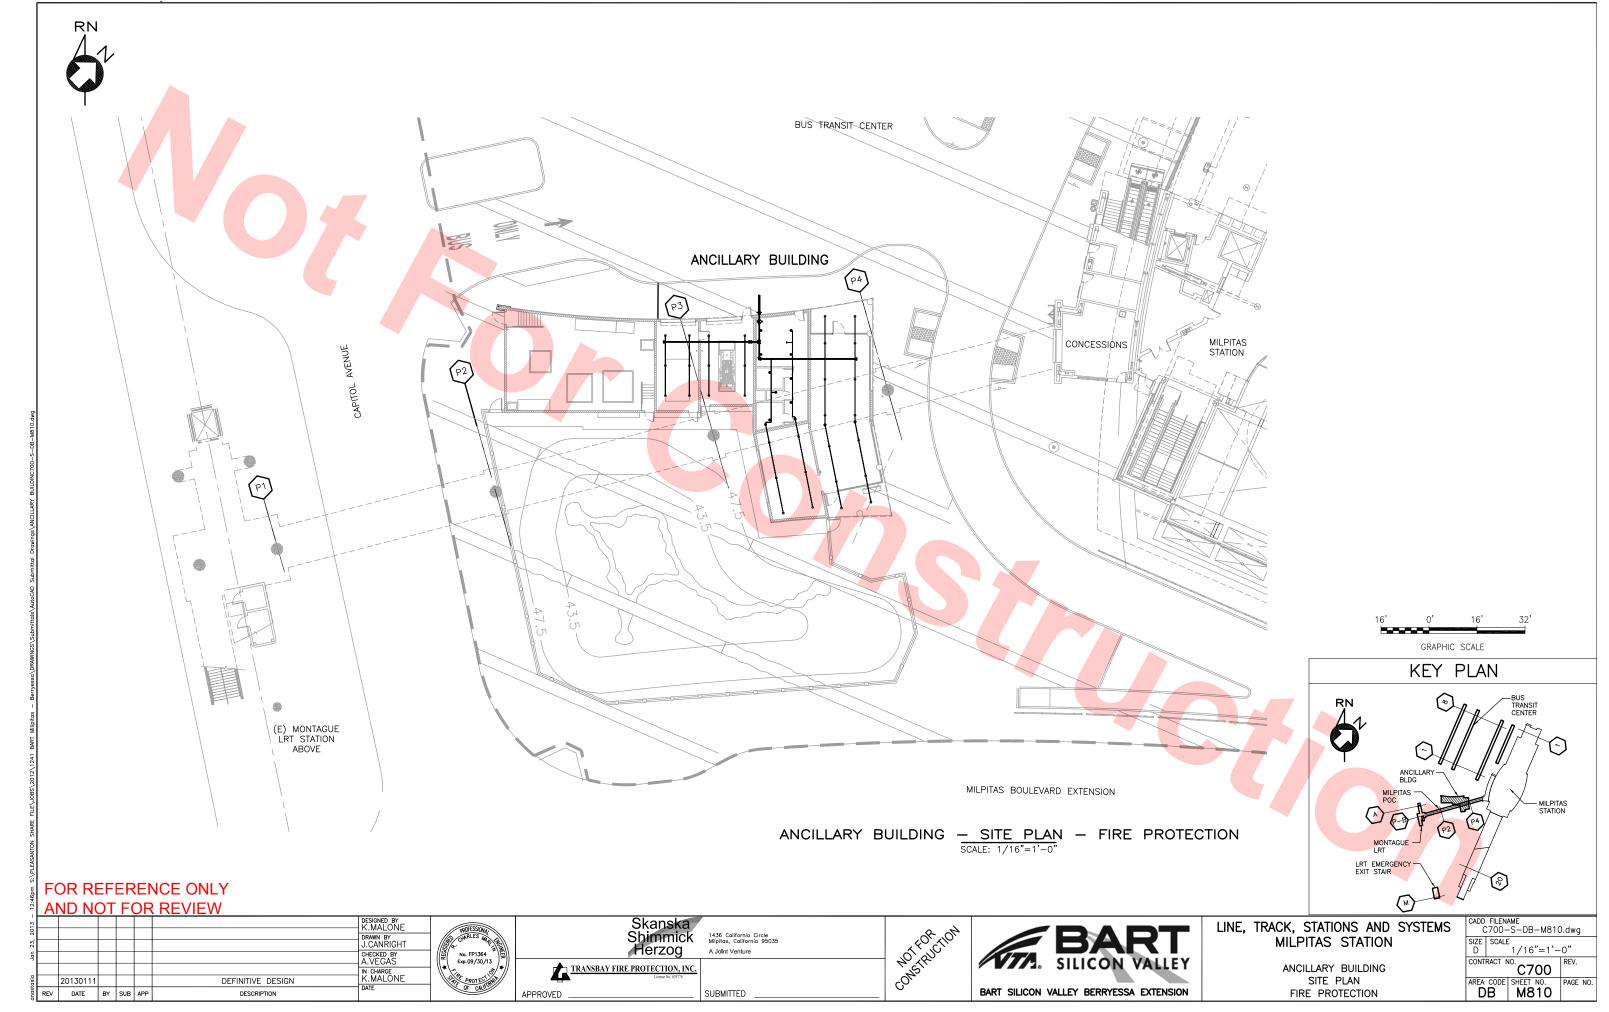1 4" SP

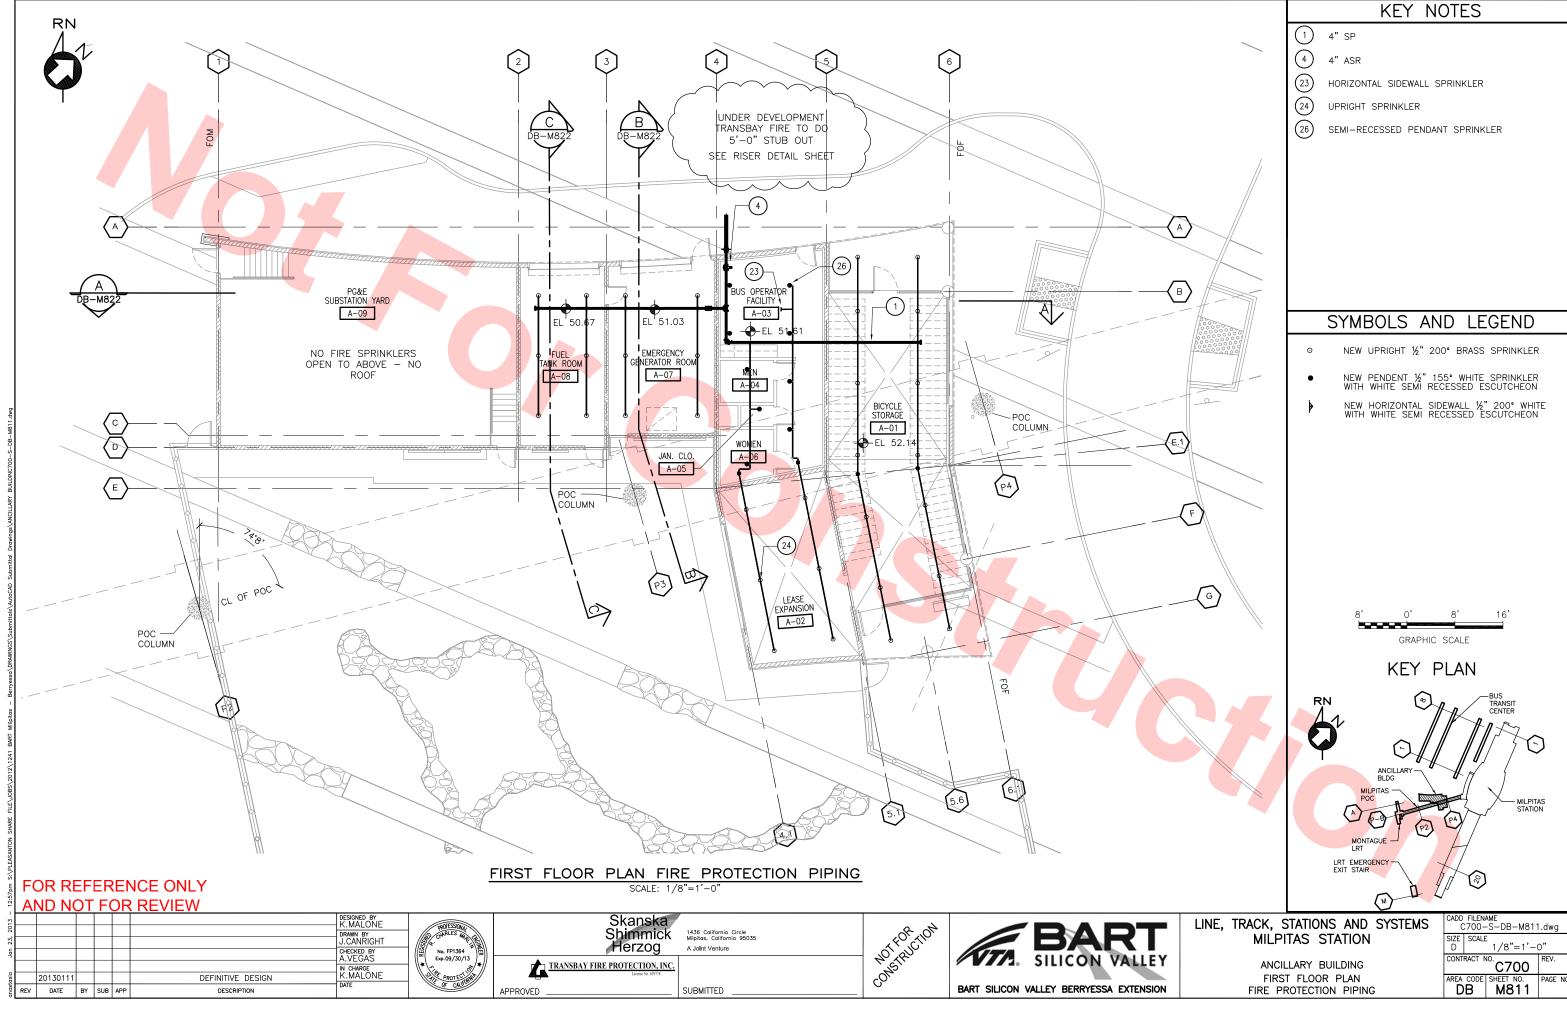(23) HORIZONTAL SIDEWALL SPRINKLER

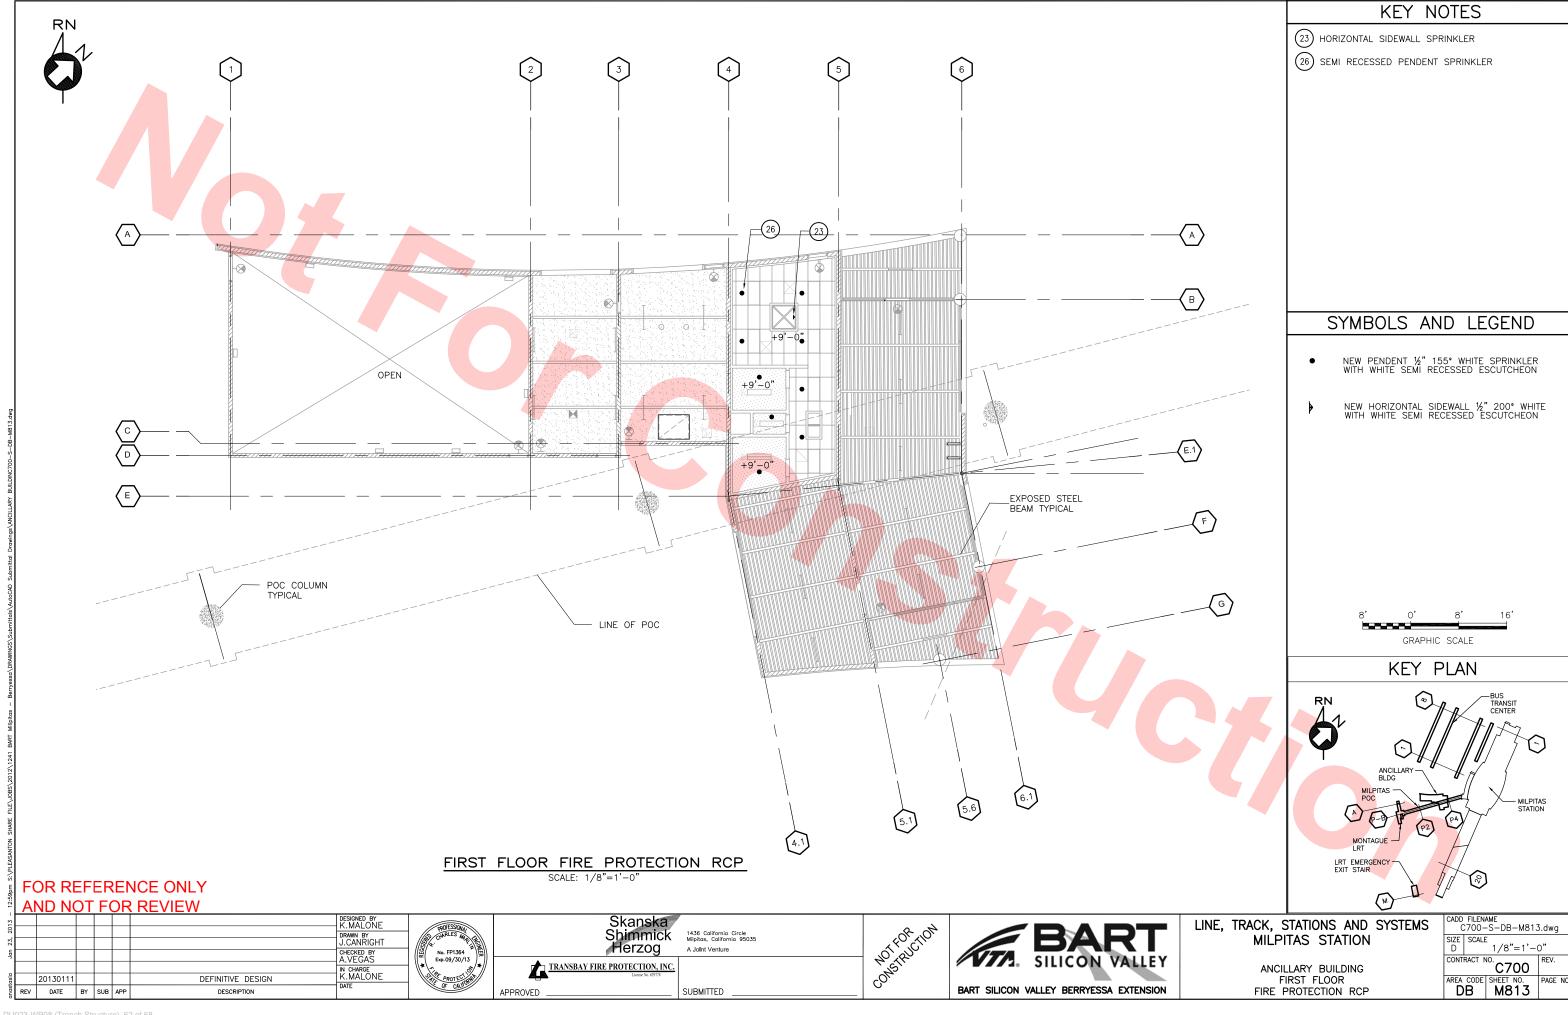24) UPRIGHT SPRINKLER

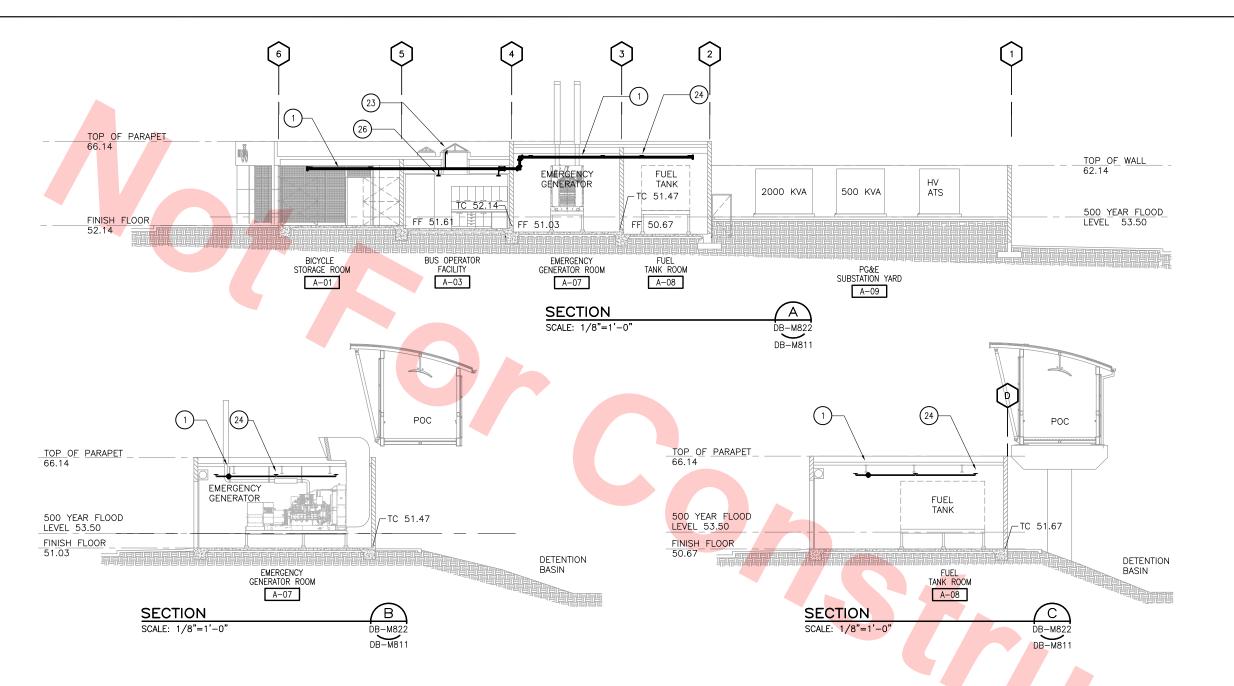(26) SEMI-RECESSED PENDENT SPRINKLER

FOR REFERENCE ONLY AND NOT FOR REVIEW

DESIGNED BY K.MALONE DRAWN BY J.CANRIGHT CHECKED BY A.VEGAS IN CHARGE K.MALONE DEFINITIVE DESIGN 20130111 REV DATE BY SUB APP DESCRIPTION

No. FP1364 Exp.09/30/13 APPROVED

Skanska Shimmick Herzog TRANSBAY FIRE PROTECTION, INC.

1436 California Circle Milpitas, California 95035 A Joint Venture SUBMITTED





LINE, TRACK, STATIONS AND SYSTEMS MILPITAS STATION

CADD FILENAME C700-S-DB-M822.dwg SIZE SCALE 1/8"=1'-0" . C700 AREA CODE DB SHEET NO.
M822

ANCILLARY BUILDING

