



SSH JV

Milpitas Station Fire Alarm Design Unit 023 – Work Package 06 Definitive Design

SVBX C700



Thursday, February 14, 2013

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Joseph G Feb 07, 2013						DESIGNED BY S. DEBNATH	<div><div>Skanska Shimmick Herzog</div><div>1436 California Circle Milpitas, California 95035 A Joint Venture</div></div>	<div><div><div><div>Lockwood, Andrews & Newnam, Inc.</div><div>2000 A BULLY SQUARE</div></div><div>T-Y-LIN INTERNATIONAL</div></div></div>	<div><div><div><div>VTA</div><div>BART SILICON VALLEY</div></div><div>BART SILICON VALLEY BERRYESSA EXTENSION</div></div></div>	LINE, TRACK, STATIONS, AND SYSTEMS	CADD FILENAME C700-S-DB-X001.DWG
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						CONTRACT NO. C700 REV.					
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GENERAL (MILPITAS STATION, ANCILLARY BUILDING, AND TRANSIT CENTER BUS SHELTER)

DB-X001 TITLE SHEETS
DB-X027 INDEX OF DRAWINGS

DB-X033 INDEX OF DRAWINGS

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PAGE NO.	DWG NO.	REV NO.	TITLE
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MILPITAS STATION – FIRE ALARM

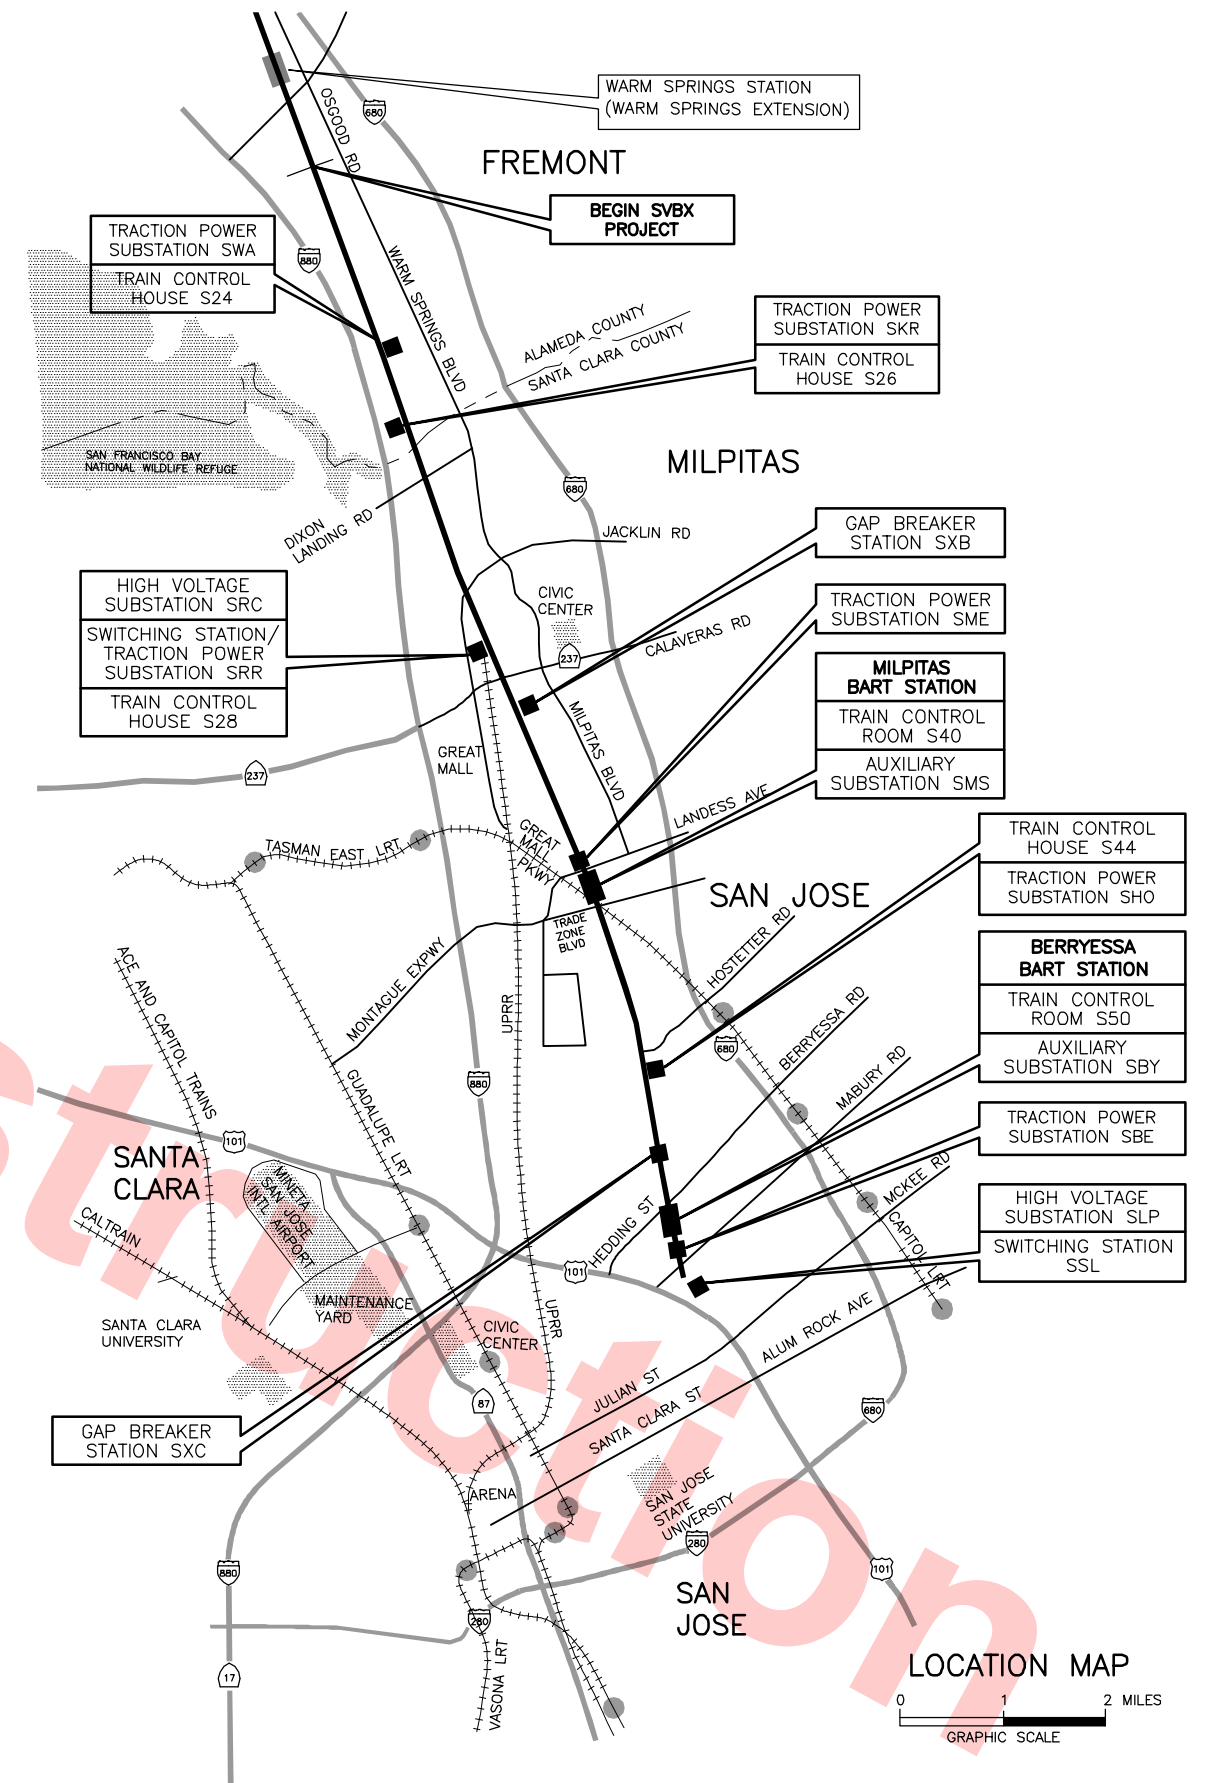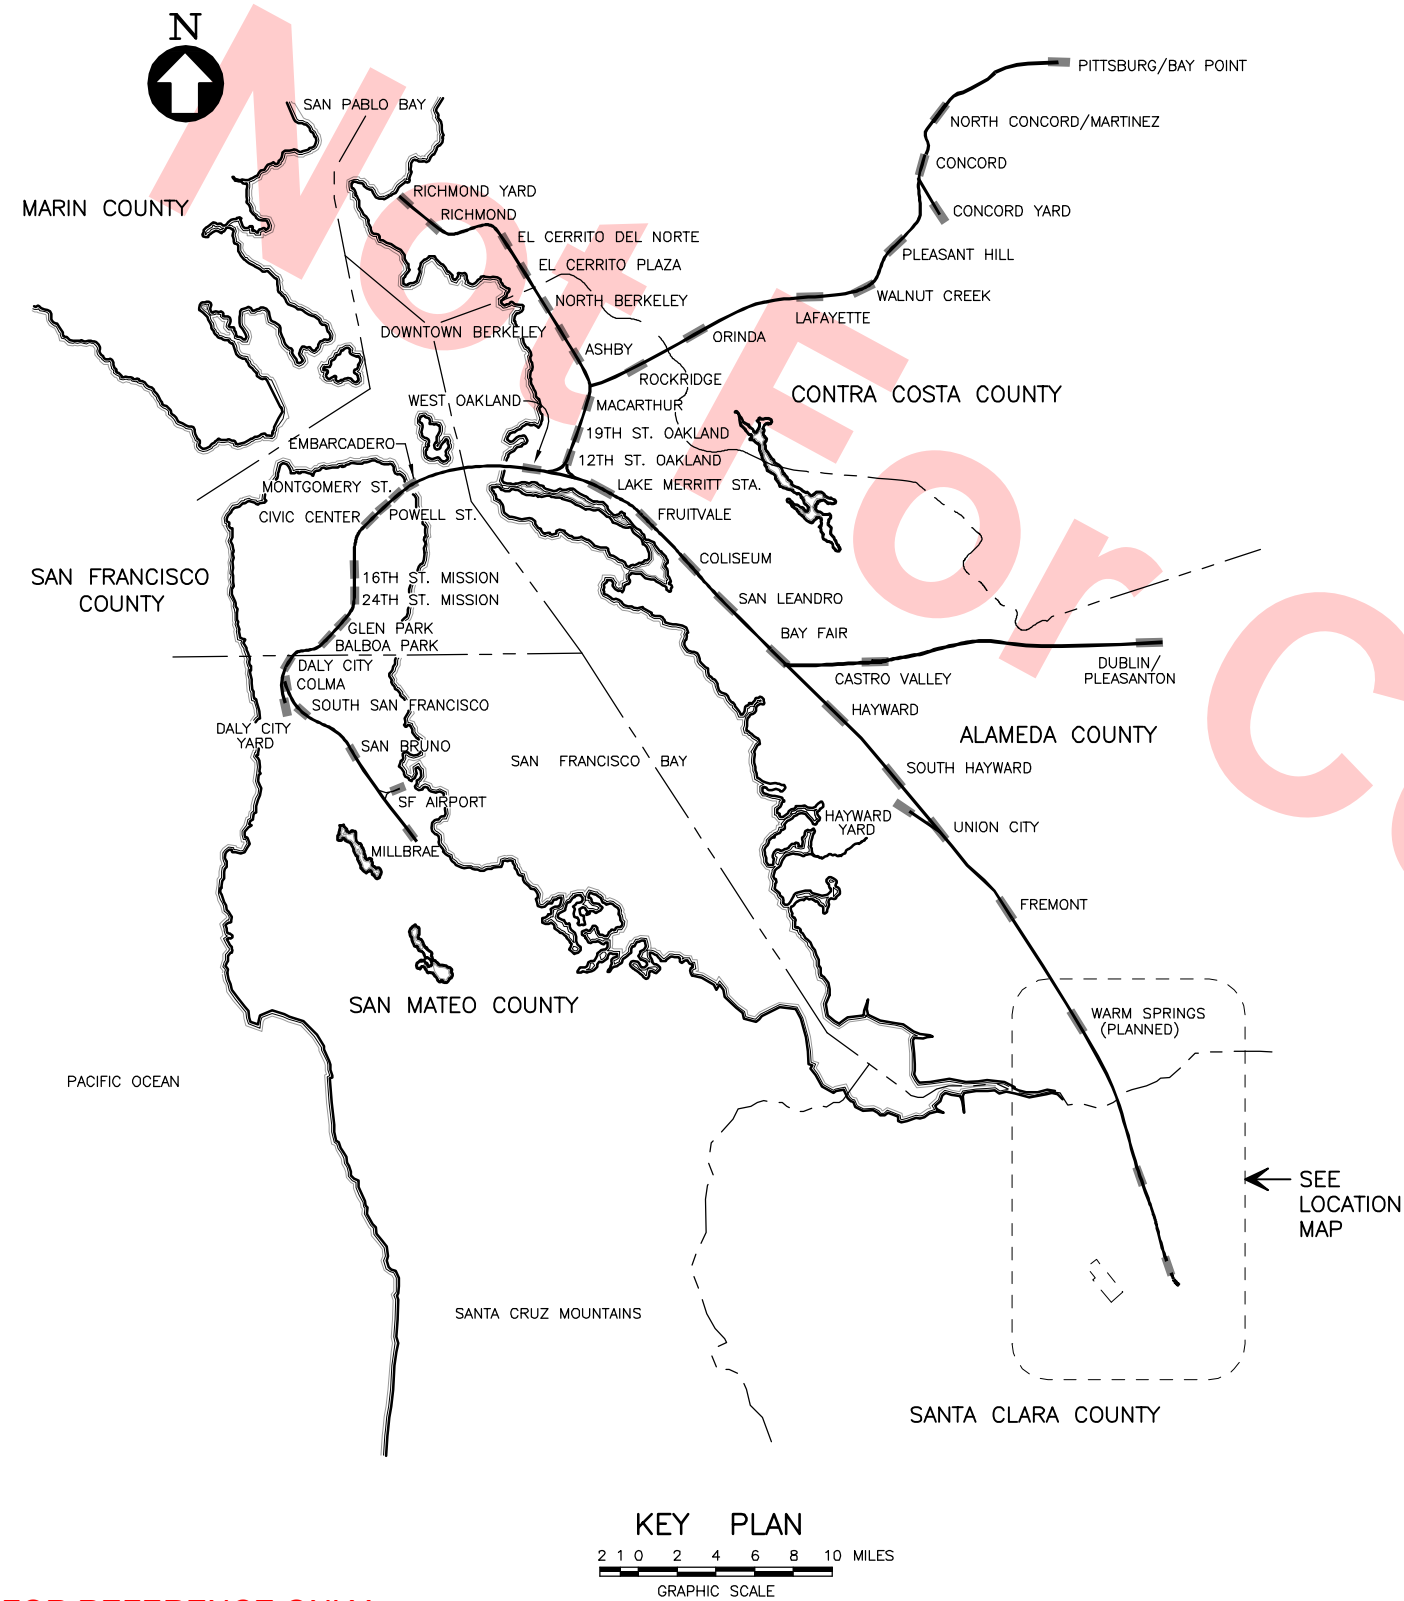COVER SHEET

DB–E700	FIRE ALARM COVER SHEET
DB–E701	FIRE ALARM EQUIPMENT LIST
DB–E702	FIRE ALARM MISCELLANEOUS DETAILS
DB–E703	FIRE ALARM SEQUENCE OF OPERATION
DB–E704	LEFT BLANKED INTENTIONALLY
DB–E705	LEFT BLANKED INTENTIONALLY
DB–E706	LEFT BLANKED INTENTIONALLY
DB–E707	LEFT BLANKED INTENTIONALLY
DB–E708	LEFT BLANKED INTENTIONALLY
DB–E709	LEFT BLANKED INTENTIONALLY

PLANS

DB–E710	KEY PLAN PLATFORM LEVEL FIRE ALARM SYSTEM
DB–E711	PLATFORM LEVEL PLAN FIRE ALARM SYSTEM SHEET 1 OF 6
DB–E712	PLATFORM LEVEL PLAN FIRE ALARM SYSTEM SHEET 2 OF 6
DB–E713	PLATFORM LEVEL PLAN FIRE ALARM SYSTEM SHEET 3 OF 6
DB–E714	PLATFORM LEVEL PLAN FIRE ALARM SYSTEM SHEET 4 OF 6
DB–E715	PLATFORM LEVEL PLAN FIRE ALARM SYSTEM SHEET 5 OF 6
DB–E716	PLATFORM LEVEL PLAN FIRE ALARM SYSTEM SHEET 6 OF 6
DB–E717	NOT USED
DB–E718	NOT USED
DB–E719	NOT USED
DB–E720	KEY PLAN CONCOURSE LEVEL FIRE ALARM SYSTEM
DB–E721	CONCOURSE LEVEL PLAN FIRE ALARM SYSTEM SHEET 1 OF 6
DB–E722	CONCOURSE LEVEL PLAN FIRE ALARM SYSTEM SHEET 2 OF 6
DB–E723	CONCOURSE LEVEL PLAN FIRE ALARM SYSTEM SHEET 3 OF 6

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
FIRE ALARM

DB–E724	CONCOURSE LEVEL PLAN FIRE ALARM SYSTEM SHEET 4 OF 6
DB–E725	CONCOURSE LEVEL PLAN FIRE ALARM SYSTEM SHEET 5 OF 6
DB–E726	CONCOURSE LEVEL PLAN FIRE ALARM SYSTEM SHEET 6 OF 6
DB–E727	ANCILLARY BUILDING FIRE ALARM SYSTEM
DB–E728	NOT USED
DB–E729	NOT USED
DB–E730	KEY PLAN LOWER ROOF AND MEZZANINE LEVEL FIRE ALARM SYSTEM
DB–E731	LOWER ROOF AND MEZZANINE LEVEL PLAN FIRE ALARM SYSTEM SHEET 1 OF 3
DB–E732	LOWER ROOF AND MEZZANINE LEVEL PLAN FIRE ALARM SYSTEM SHEET 2 OF 3
DB–E733	LOWER ROOF AND MEZZANINE LEVEL PLAN FIRE ALARM SYSTEM SHEET 3 OF 3
DB–E734	NOT USED
DB–E735	NOT USED
DB–E736	NOT USED
DB–E737	NOT USED
DB–E738	NOT USED
DB–E739	NOT USED
DB–E740	KEY PLAN ROOF LEVEL FIRE ALARM SYSTEM
DB–E741	ROOF LEVEL PLAN FIRE ALARM SYSTEM SHEET 1 OF 4
DB–E742	ROOF LEVEL PLAN FIRE ALARM SYSTEM SHEET 2 OF 4
DB–E743	ROOF LEVEL PLAN FIRE ALARM SYSTEM SHEET 3 OF 4
DB–E744	ROOF LEVEL PLAN FIRE ALARM SYSTEM SHEET 4 OF 4
DB–E745	NOT USED
DB–E746	NOT USED
DB–E747	NOT USED
DB–E748	NOT USED
DB–E749	NOT USED
DB–E750	FIRE ALARM CONTROL UNIT DETAILS OUTER & INNER DOOR
DB–E751	FIRE ALARM CONTROL UNIT DETAILS
DB–E752	FIRE ALARM POWER SUPPLY DETAILS STROBE CIRCUIT SCHEDULE
DB–E753	FIRE ALARM BATTERY AND VOLTAGE DROP CALCULATIONS
DB–E754	FIRE ALARM FIELD DEVICES WIRING DETAILS PART–1
DB–E755	FIRE ALARM FIELD DEVICES WIRING DETAILS PART–2
DB–E756	FIRE ALARM FIELD DEVICES WIRING DETAILS PART–3


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DB–E757	FIRE ALARM RISER DIAGRAM PART – 1
DB–E758	FIRE ALARM RISER DIAGRAM PART – 2
DB–E759	RESERVED FOR OTHER FIRE ALARM MISCELLANEOUS SHEETS
DB–E760 TO DB–E779 -----	RESERVED FOR OTHER FIRE ALARM MISCELLANEOUS SHEETS

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					DESIGNED BY S. DEBNATH	<div>Skanska Shimmick Herzog</div> <div>1436 California Circle Milpitas, California 95035 A Joint Venture</div>	<div>NOT FOR CONSTRUCTION</div>	<div> BART SILICON VALLEY BERRYESSA EXTENSION</div>	LINE, TRACK, STATIONS, AND SYSTEMS MILPITAS STATION		CADD FILENAME C700–S–DB–X033.dwg		
					DRAWN BY B. ITURALDE				SIZE D	SCALE NONE		CONTRACT NO. C700	
					CHECKED BY E. BALLADA						REV.		
					IN CHARGE R. BARLAAN						AREA CODE DB		
					DATE						SHEET NO. X033		PAGE NO.
REV	DATE	BY	SUB	APP	DEFINITIVE DESIGN	SUBMITTED	APPROVED	INDEX OF DRAWINGS		SHEET 7 OF 7			

Jan 31, 2013 -- 9:02am K:\VFS (Ops)\Engineering\California Projects\VTa-Bart\Milpitas Station S40\C700-S-DB-E700.dwg
SinghV

<div>MILPITAS STATION S40</div> <div>SILICON VALLEY BERRYESSA EXTENSION PROJECT</div> <div>555 E. CAPITOL AVE</div> <div>MILPITAS, CA 95035</div> <div>FIRE ALARM SYSTEM</div>										<div>FIRE ALARM GENERAL NOTES</div> <div>1. NO WORK ON THE FIRE ALARMS SYSTEM SHALL BEGIN WITHOUT APPROVED PLANS AND SIGNED PERMITS.</div> <div>2. INSTALLATION SHALL BE IN STRICT CONFORMANCE WITH THE CALIFORNIA ELECTRICAL CODE, NFPA 72; 2010 EDITION WITH CALIFORNIA AMENDMENTS, STATE CODE(S), AND/OR STATE FIRE MARSHAL.</div> <div>3. ANY DEVIATION FROM THE DESIGN AND LOCATION OF EQUIPMENT SHOWN MUST FIRST HAVE A WRITTEN APPROVAL FROM VTA/BART & SIEMENS INDUSTRY, INC. (SIEMENS). ANY DEVIATION FROM DESIGN MUST ALSO BE INDICATED ON SIEMENS SHOP DRAWINGS (BLUEPRINTS) AND RETURNED TO SIEMENS AT TIME OF JOB COMPLETION.</div> <div>4. INSTALLATION MATERIALS (I.E. CONDUIT, WIRE, FITTINGS, HANGERS, AND STANDARD BOXES) SHALL BE PROVIDED BY ELECTRICAL CONTRCATOR.</div> <div>5. WIRING SHALL BE PER PLAN WITH RESPECT TO CONDUCTOR SIZE, TYPE, QUANTITY AND COLOR CODE. CONDUCTORS SHALL BE PERMANENTLY MARKED FOR FUTURE IDENTIFICATION.</div> <div>6. CONDUIT KNOCKOUTS ARE PROVIDED ON ALL MANUFACTURERS PROVIDED BACK BOXES. DO <u>NOT</u> ENLARGE OR CHANGE LOCATION OF CONDUIT ENTRY WITHOUT PRIOR APPROVAL OF SIEMENS.</div> <div>7. CONDUIT RUNS SHALL NOT DEVIATE FROM FROM APPROVED SHOP DRAWINGS.</div> <div>8. CONDUCTOR TERMINATIONS SHALL BE BRADY OR EQUALLY LABELED.</div> <div>9. ALL FIRE ALARM CIRCUITS ARE CONTINUOUS FROM DEVICE TO DEVICE. NO SPLICES OR INTERIM CIRCUIT CONNECTIONS SHALL BE MADE UNLESS IN AN APPROVED JUNCTION BOX ON APPROVED TERMINAL BLOCKS.</div> <div>10. DETECTOR AND AUDIBLE/VISUAL CIRCUIT POLARITY SHALL BE OBSERVED.</div> <div>11. AUDIBLE/VISUAL CIRCUIT WIRING IS SUPERVISED. NO PARALLEL BRANCHING IS PERMISSIBLE.</div> <div>12. 120 VAC POWER SHALL NOT BE APPLIED TO FIRE ALARM PANEL WITHOUT DIRECT SUPERVISION OF A SIEMENS TECHNICIAN.</div> <div>13. STANDARD CONTROL PANEL, TERMINAL BOXES ETC. MOUNTING IS 6'-0" FROM FINISHED FLOOR TO TOP OF DEVICE UNLESS OTHERWISE NOTED.</div> <div>14. FIGURES ADJACENT TO ANY INITIATING DEVICE DESIGNATE FIRE LOOP AND ADDRESS NUMBER.</div> <div>15. FIGURES ADJACENT TO ANY AUDIBLE/VISUAL DEVICE DESIGNATE CIRCUIT AND ADDRESS NUMBER.</div> <div>16. WHERE DETECTORS ARE INSTALLED FOR SIGNAL INITIATION DURING CONSTRUCTION, THEY SHALL BE CLEANED AND VERIFIED TO BE OPERATING IN ACCORDANCE WITH THE LISTED SENSITIVITY, OR THEY SHALL BE REPLACED PRIOR TO THE FINAL COMMISSIONING OF THE SYSTEM PER NFPA 72-17.7.1.11.1, AT AN ADDITIONAL COST TO THE CONTRACTOR.</div> <div>17. WHERE DETECTORS ARE INSTALLED BUT NOT OPERATIONAL DURING CONSTRUCTION, THEY SHALL BE PROTECTED FROM CONSTRUCTION DEBRIS, DUST, DIRT, AND DAMAGE IN ACCORDANCE WITH MANUFACTURER'S RECOMMENDATIONS AND VERIFIED TO BE OPERATING IN ACCORDANCE WITH THE LISTED SENSITIVITY, OR THEY SHALL BE REPLACED PRIOR TO THE FINAL COMMISSIONING OF THE SYSTEM PER NFPA 72-17.7.1.11.2, AT AN ADDITIONAL COST TO THE CONTRACTOR.</div> <div>18. WHERE DETECTION IS NOT REQUIRED DURING CONSTRUCTION, DETECTORS SHALL NOT BE INSTALLED UNTIL ALL OTHER CONSTRUCTION TRADES HAVE COMPLETED CLEANUP PER NFPA 72-17.7.1.11.3.</div> <div>19. SMOKE DETECTORS THAT ARE USED EXCLUSIVELY FOR SMOKE DOOR RELEASE SERVICE SHALL BE LOCATED AND SPACED AS REQUIRED BY NFPA 72-17.7.5.6.</div> <div>20. DETECTORS ARE NOT TO BE LOCATED WITHIN 3'-0" OF ANY AIR SUPPLY DIFFUSER, IN ACCORDANCE WITH NFPA 72-A.17.7.4.1, AND SHALL NOT BE PLACED WHERE RETURN AIR MOVEMENT SHALL EXCEED THE MANUFACTURERS RECOMMENDATION AS TO AFFECT THE OPERATION OF THE SMOKE DETECTOR.</div> <div>21. PENETRATIONS OF RATED ASSEMBLIES REQUIRING OPENING PROTECTION SHALL USE AN APPROVED THROUGH PENETRATION FIRE STOP SYSTEM TO MAINTAIN THE FIRE RESISTANCE RATING OF THE ASSEMBLY PENETRATED CBC 713.</div> <div>22. CONNECT FIRE ALARM PANEL TO LIFE SAFETY BRANCH OF THE EMERGENCY CIRCUIT.</div> <div>23. ALL MANUAL PULL STATIONS SHALL BE INSTALLED SUCH THAT THE OPERABLE PART OF EACH PULL STATION SHALL BE NOT LESS THAN 42 IN. (1.1 m) AND NOT MORE THAN 48 IN. (1.37 m) ABOVE FLOOR LEVEL. NFPA 72-17.14.4.</div> <div>23. ALL AUDIBLE/VISUAL DEVICES SHALL BE MOUNTED SUCH THAT THE ENTIRE LENS IS NOT LESS THAN 80" AND NOT GREATER THAN 96" A.F.F. AS TO CONFORM TO NFPA 72-18.5.4.1 (SEE NFPA 72-18.4.8.1 FOR AUDIBLES ONLY).</div> <div>24. ALL 120 VAC POWER SOURCES SHALL BE ON DEDICATED CIRCUITS WITH A CIRCUIT BREAKER LOCK AND A LABEL IN ACCORDANCE WITH NFPA 72-10.5.5.3.</div> <div>25. ALL 24 VDC WIRE TO BE INSTALLED IN DEDICATED CONDUIT SEPARATE FROM 120 VAC WIRING.</div> <div>26. REVIEW SEQUENCE OF SYSTEM OPERATION ON INPUT/OUTPUT MATRIX.</div> <div>27. INSTALLING CONTRACTOR SHALL RETURN ONE SET OF ACCURATELY MARKED DRAWINGS FOR "AS BUILT" PURPOSES.</div> <div>28. THE SECONDARY POWER SUPPLY SHALL CONSIST OF STORAGE BATTERIES THAT SHALL HAVE SUFFICIENT CAPACITY TO OPERATE THE SYSTEM UNDER QUIESCENT LOAD (NONALARM CONDITION) FOR A MINIMUM OF 4 HOURS AND, AT THE END OF THAT PERIOD SHALL BE CAPABLE OF OPERATING ALL ALARM NOTIFICATION APPLIANCES FOR 15 MINUTES PER NFPA 72-10.5.6.3.1.</div>																																														
<div>FIRE ALARM SYSTEM SCOPE OF WORK</div> <div>1. SIEMENS INDUSTRY INC. SHALL SUPPLY DESIGN, PARTS AND PROGRAMMING NECESSARY FOR MILPITAS STATION (EXCLUDING POC AREAS) AND BART PORTION OF ANCILLARY BUILDING AS SHOWN ON THE DRAWINGS.</div> <div>2. POC AREAS AND VTA PORTION OF ANCILLARY BUILDING MUST BE SERVED BY EXISTING VTA FIRE ALARM SYSTEM. IT IS NOT UNDER SIEMENS SCOPE OF WORK TO PROVIDE PARTS AND FIRE ALARM SYSTEM DESIGN FOR THESE AREAS.</div> <div>2. INSTALLATION OF OUTLET BOXES, CONDUIT, AND, WIRING OF FIRE ALARM DEVICES BY ELECTRICAL CONTRACTOR.</div> <div>3. SIEMENS INDUSTRY INC. SHALL PROVIDE INSPECTION & TESTING FOR A COMPLETE AND OPERATIONAL FIRE ALARM SYSTEM.</div> <div>4. SIEMENS INDUSTRY INC. SHALL PROVIDE A FUNCTIONAL PRE-TEST OF THE FIRE ALARM SYSTEM PRIOR TO CALLING FOR THE FINAL TEST.</div> <div>5. UPON COMPLETION OF THE INSTALLATION AN OPERATIONAL ACCEPTANCE TEST OF THE SYSTEM SHALL BE MADE IN THE PRESENCE OF THE INSPECTOR OF RECORD AND/OR AUTHORITY HAVING JURISDICTION.</div> <div>6. AFTER COMPLETION OF THE OPERATIONAL ACCEPTANCE TEST A "RECORD OF COMPLETION" PER NFPA 72-10.18.2.1.1 SHALL BE PROVIDED TO THE INSPECTOR OF RECORD.</div>					<div>APPLICABLE CODES</div> <div>ADMINISTRATION: 2010 CALIFORNIA ADMINISTRATION CODE (CAC) PART 1, TITLE 24, CALIFORNIA CODE OF REGULATIONS (CCR)</div> <div>BUILDING: 2010 CALIFORNIA BUILDING CODE (CBC) PART 2, TITLE 24, CALIFORNIA CODE OF REGULATIONS (CCR)</div> <div>ELECTRICAL: 2010 CALIFORNIA ELECTRICAL CODE (CEC) PART 3, TITLE 24, CALIFORNIA CODE OF REGULATIONS (CCR)</div> <div>MECHANICAL: 2010 CALIFORNIA MECHANICAL CODE (CMC) PART 4, TITLE 24, CALIFORNIA CODE OF REGULATIONS (CCR)</div> <div>PLUMBING: 2010 CALIFORNIA PLUMBING CODE (CPC) PART 5, TITLE 24, CALIFORNIA CODE OF REGULATIONS (CCR)</div> <div>FIRE: 2010 CALIFORNIA FIRE CODE (CFC) PART 9, TITLE 24, CALIFORNIA CODE OF REGULATIONS (CCR)</div> <div>ADAAG: 2010 AMERICANS WITH DISABILITIES ACT ACCESSIBILITY GUIDELINES (ADAAG)</div>					<div>CONTRACTOR'S NOTES</div> <div>1. SHOWN IN THIS DRAWING SET IS SIEMENS ENGINEERED FIRE ALARM SYSTEM PER CONTRACTUAL DESIGN DRAWINGS AND SPECIFICATIONS.</div> <div>2. CONTRACTOR SHALL NOT DEVIATE BY NOT MORE THAN 5% FROM THE FINAL APPROVED SHOP DRAWINGS.</div> <div>3. WIRE RUNS HAVE BEEN ENGINEERED TO COMPLY WITH SPECIFIC VOLTAGE DROP REQUIREMENTS. ANY DEVIATION FROM SHOWN WIRE RUNS WHICH RESULTS IN NON-COMPLIANCE WITH VOLTAGE DROP REQUIREMENTS SHALL BE THE SOLE RESPONSIBILITY OF THE ELECTRICAL CONTRACTOR.</div> <div>4. IF DURING INSTALLATION, CONTRACTOR DEVIATES BY MORE THAN 5% FROM THE SHOP DRAWINGS, CONTRACTOR SHALL BE SOLELY RESPONSIBLE FOR ALL ADDITIONAL ENGINEERING COSTS THAT MAY ARISE TO ACCOMMODATE INCLUSION OF THESE DEVIATIONS ON RECORD DRAWINGS (AS-BUILTS).</div> <div>5. THESE SUBMITTED SHOP DRAWINGS ARE COMPLETE. SIEMENS SHALL NOT BEAR ANY ADDITIONAL COSTS OF RE-ENGINEERING RECORD DRAWINGS (AS-BUILTS).</div> <div>6. SIEMENS SHALL NOT BEAR ANY LIABILITY FOR ENGINEERED DESIGN IF MORE THAN 5% DEVIATION HAS OCCURRED DURING INSTALLATION.</div>					<div>NFPA STANDARDS</div> <div>NFPA NATIONAL FIRE PROTECTION ASSOCIATION</div> <div>NFPA 13 2010 STANDARD FOR THE INSTALLATION OF FIRE SPRINKLER SYSTEM</div> <div>NFPA 72 NATIONAL FIRE ALARM AND SIGNALING CODE</div>																																									
<div>FIRE ALARM SYSTEM DESCRIPTION</div> <div>1. FIRE ALARM SYSTEM IS INDIVIDUALLY ADDRESSABLE MANUAL FIRE ALARM SYSTEM WITH SUPPLEMENTARY AUTOMATIC FIRE ALARM DEVICES.</div> <div>2. INITIATING DEVICE CIRCUITS (IDC) IS CLASS B.</div> <div>3. NOTIFICATION ALARM CIRCUITS (NAC) IS CLASS A.</div> <div>4. SIGNALING LINE CIRCUITS (SLC) IS CLASS X.</div>					<div>FIRE ALARM MONITORING</div>																																																			
<table><tr><td></td><td></td><td></td><td></td><td></td><td></td><td>DESIGNED BY V. SINGH</td></tr><tr><td></td><td></td><td></td><td></td><td></td><td></td><td>DRAWN BY V. SINGH</td></tr><tr><td></td><td></td><td></td><td></td><td></td><td></td><td>CHECKED BY F. CASABONNE</td></tr><tr><td></td><td></td><td></td><td></td><td></td><td></td><td>IN CHARGE F. CASABONNE</td></tr><tr><td></td><td></td><td></td><td></td><td></td><td></td><td>DATE 20130125</td></tr><tr><td>REV</td><td>DATE</td><td>BY</td><td>SUB</td><td>APP</td><td></td><td>DESCRIPTION</td></tr></table>											DESIGNED BY V. SINGH							DRAWN BY V. SINGH							CHECKED BY F. CASABONNE							IN CHARGE F. CASABONNE							DATE 20130125	REV	DATE	BY	SUB	APP		DESCRIPTION	<div>Skanska Shimmick Herzog</div> <div>1436 California Circle Milpitas, California 95035 A Joint Venture</div> <div>SIEMENS Industry, Inc. Fire Safety Division</div> <div>SUBMITTED</div>		<div>NOT FOR CONSTRUCTION</div>		<div> BART SILICON VALLEY BERRYESSA EXTENSION</div>		<div>LINE, TRACK, STATIONS AND SYSTEMS MILPITAS STATION</div> <div>FIRE ALARM COVER SHEET</div>		<div>CADD FILENAME C700-S-DB-E700.dwg</div> <div>SIZE SCALE D NONE</div> <div>CONTRACT NO. C700 REV.</div> <div>AREA CODE SHEET NO. DB E700 PAGE NO.</div>	
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FIRE ALARM EQUIPMENT LIST							
CATEGORY	ITEM NO.	SYMBOL	QTY	MODEL NUMBER	DESCRIPTION	MANUFACTURER	DATA SHEET NUMBER CALIFORNIA STATE FIRE MARSHAL LISTING NUMBER
MAIN FACU LOC @ CONCOURSE LEVEL	1	FACU	1	CAB3-BB	LARGE SIZE (3 ROW) ENCLOSURE BACKBOX BLACK	SIEMENS	6327 7165-0067:0222
	2		1	CAB3-BD	LARGE (3 ROW) INNER & OUTER DOOR BLACK	SIEMENS	6327 7165-0067:0222
	3		2	OD-LP	OUTER DOOR CLEAR LENS PLATE	SIEMENS	6327 7165-0067:0222
	4		1	OD-BP	OUTER DOOR BLANK PLATE	SIEMENS	6327 7165-0067:0222
	5		2	ID-SP	INNER DOOR SINGLE MODULE BLANK PLATE (2 PER PACKAGE)	SIEMENS	6327 7165-0067:0222
	6		1	ID-FP	INNER DOOR FOUR MODULE BLANK PLATE	SIEMENS	6327 7165-0067:0222
	7		2	ID-MP	MOUNTING PLATE/BRACKET	SIEMENS	6327 ---
	8		1	BCM	BLANK PLATE FOR ID-MP (4 PLATES)	SIEMENS	6317 ---
	9		1	CC-5	CARD CAGE - 5 SLOTS	SIEMENS	6321 7165-0067:0222
	10		2	CCL	30" LONG 6 WIRE CABLE (P/N 599-634214)	SIEMENS	6317 ---
	11		2	BCL	40" LONG 60 PIN WIRE CABLE (P/N 555-133743)	SIEMENS	--- ---
	12	XLS-250-ZIC4A-EP	1	CC-5	CARD CAGE - 5 SLOTS	SIEMENS	6321 7165-0067:0222
	13		1	ZIC-4A	ZONE INDICATING CARD	SIEMENS	6315 7165-0067:0222
	14		1	DLC	DEVICE LOOP CARD	SIEMENS	6312 7165-0067:0222
	15		1	PMI	PERSON MACHINE INTERFACE	SIEMENS	6329 7165-0067:0222
	16		1	PSC-12	12A POWER SUPPLY	SIEMENS	6322 7165-0067:0222
	17		1	NIC-C	NETWORK INTERFACE CARD	SIEMENS	6338 7165-0067:0222
	18		1	DAC-NET	DIGITAL AUDIO CARD	SIEMENS	6334 6912-0067:0237
	19		1	ZAC-40	ZONE AMPLIFIER MODULE (40 WATTS)	SIEMENS	XXXX XXXXXXXXXX
	20		1	LPB	LIVE PAGE BOARD	SIEMENS	--- 6912-0067:0237
	21		1	LVM	LIVE VOICE MODULE	SIEMENS	6333 6912-0067:0237
	22		1	FMT	FIREMAN'S MASTER TELEPHONE	SIEMENS	6335 6912-0067:0237
	23		1	PSX-12	POWER SUPPLY EXTENDER	SIEMENS	6322 7165-0067:0222
	24		1	CP2341	SURGE SUPPRESSOR	SIEMENS	--- 7300-0067:0172
	25		1	CAB-BATT	BATTERY CABINET	SIEMENS	6322 7165-0067:0222
	26		2	PS-121000	100 AMP/HOUR BATTERY (12 VDC)	POWER SONIC	--- NOT APPLICABLE
	27		1	MDACT	MULTIPOINT DIGITAL ALARM COMMUNICATOR	SIEMENS	5074 7300-0067:0172
	28		1	XMI	FIREFINDER XLS-MXL INTERFACE CARD	SIEMENS	5074 7300-0067:0172
	29		1	MOM2-XMP	MOUNTING PLATE	SIEMENS	5074 7300-0067:0172
	30		1	MOM-2	NETWORK OPTION MODULE CARD CAGE	SIEMENS	5043 7300-0067:0172
	31						
	32	PRINTER	1	TSP-40A	THERMAL STRIP PRINTER	SIEMENS	5007 7300-0067:0172
	33		1	TSP-40-PP	TSP-40 PRINTER PAPER	SIEMENS	5007 ---
	34		1	TSP-XB	XLSTSP-40A BRACKETS	SIEMENS	5007 ---
	35		1	TSP-XC	XLSTSP-40A CABLES	SIEMENS	5007 ---
	36						
	37	FAA	1	SSD-C	SYSTEM STATUS DISPLAY WITH CONTROL (REMOTE ANN.)	SIEMENS	5043 7300-0067:0172
	38	NAC	4	PS-8	NAC EXTENDER POWER SUPPLY PANEL (RED)	COOPER WHEELLOCK	--- 7315-0785:0167
	39		4	PS-EXP	4 CLASS B or 2 CLASS A EXPANSION MODULE	SPACE AGE	--- NOT APPLICABLE
	40		8	PS-1270	7 AMP/HOUR BATTERY (12 VDC)	POWER SONIC	--- NOT APPLICABLE
	41						
	42						

FIRE ALARM EQUIPMENT LIST							
CATEGORY	ITEM NO.	SYMBOL	QTY	MODEL NUMBER	DESCRIPTION	MANUFACTURER	DATA SHEET NUMBER CALIFORNIA STATE FIRE MARSHAL LISTING NUMBER
FIRE ALARM FIELD DEVICES	43	②	X	HFP-11	INTELLIGENT PHOTOELECTRIC SMOKE DETECTOR	SIEMENS	6301 7272-0067:0203
	44		X	DB-11	DETECTOR BASE FOR HFP-11 DETECTOR	SIEMENS	6301 7300-0067:0134
	45	②RB	X	HFP-11	INTELLIGENT PHOTOELECTRIC SMOKE DETECTOR	SIEMENS	6301 7272-0067:0203
	46		X	DB-HR	DETECTOR RELAY BASE FOR HFP-11 DETECTOR	SIEMENS	6301 7300-0067:0134
	47	①	X	HFPT-11	INTELLIGENT THERMAL DETECTOR	SIEMENS	6302 7270-0067:0224
	48		X	DB-11	DETECTOR BASE FOR HFPT-11 DETECTOR	SIEMENS	6302 7300-0067:0134
	49	⑤ WP	X	HFP-11	INTELLIGENT FIRE DETECTOR	SIEMENS	6301 7272-0067:0203
	50		X	AD2-XHR	RELAY BASE FOR H SERIES DETECTOR	SIEMENS	6185 3240-0067:0245
	51		X	WP-2000	WEATHERPROOF BACKBOX	SIEMENS	--- NOT APPLICABLE
	52	RM	X	ST-50	SAMPLING TUBE FOR DUCTS 3' TO 5'	SIEMENS	6185 NOT APPLICABLE
	53		X	HTRI-R	INTELLIGENT INTERFACE MODULE W/RELAY	SIEMENS	6304 7165-0067:0222
	54		X	HTRI-D	INTELLIGENT INTERFACE MODULE DUAL INPUT	SIEMENS	6304 7165-0067:0222
	55	HTRI-S	X	HTRI-S	INTELLIGENT INTERFACE MODULE SINGLE INPUT	SIEMENS	6304 7165-0067:0222
	56	M	X	HTRI-M	INTELLIGENT INTERFACE MODULE SINGLE INPUT	SIEMENS	6304 7165-0067:0222
	57	P	X	HMS-D	INTELLIGENT MANUAL PULL STATION (DUAL ACTION)	SIEMENS	6306 7150-0067:0036
	58	P WP	X	MSM-K-WP	CONVENTIONAL WEATHERPRROF PULL STATION	SIEMENS	6184 7150-0067:0215
	59		X	MSM-BOX	SURFACE BACKBOX FOR MSM-SERIES PULL STSTION	SIEMENS	6184 NOT APPLICABLE
	60	DSM					
	61		X	DSM-12/24	DUAL SYNCHRONIZATION CONTROL MODULE	COOPER WHEELLOCK	--- 7300-0785:0132
	62						
	63	HxxCD					
	64						
	65		X	STW	MULTI CANDELA (15/30/75/110) STROBE (RED) WALL MOUNTED	COOPER WHEELLOCK	--- 7125-0785:0168
	66	H30cd WP	X	RSSWP-2475W-FR	WEATHERPROOF STROBE (RED) WALL MOUNTED	COOPER WHEELLOCK	--- 7300-0785:0154
	67		X	WFP	WEATHERPROOF BACKBOX (FLUSH MOUNT)	COOPER WHEELLOCK	--- NOT APPLICABLE
	68	H5E-CD --W	X	E50-24MCW-FR	MULTI CANDELA (15/30/75/110) SPEAKER/STROBE (RED) WALL MOUNTED	COOPER WHEELLOCK	--- 7300-0785:0165
	69						
	70	H70WP-CD WP --W					
	71						
	72		X	E170WP-2475W-FR	WEATHERPROOF SPEAKER/STROBE 30 CANDELA (RED) WALL MOUNTED	COOPER WHEELLOCK	--- 7300-0785:0146
	73	H70WP-CD WP --W	X	WFP	WEATHERPROOF BACKBOX (FLUSH MOUNT)	COOPER WHEELLOCK	--- NOT APPLICABLE
	74		X	IOB	WEATHERPROOF BACKBOX (FLUSH MOUNT)	COOPER WHEELLOCK	--- NOT APPLICABLE
	75	H5E-CD --W					
	76						
	77		X	E50-W	SPEAKER ONLY DEVICE (RED) WALL MOUNTED	COOPER WHEELLOCK	--- 7320-0785:0134
	78	H5E-CD --W					
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
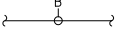
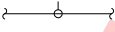









FIRE ALARM EQUIPMENT LIST							
CATEGORY	ITEM NO.	SYMBOL	QTY	MODEL NUMBER	DESCRIPTION	MANUFACTURER	DATA SHEET NUMBER CALIFORNIA STATE FIRE MARSHAL LISTING NUMBER
FIREFIGHTER'S OVERRIDE PANEL	85	FOP	1	RSE-L-GR	KIRKLAND ANNUNCIATOR 29.25"W X 24.25"W	KIRKLAND	--- 7120-1178:0100
	86		2	OCM-16	OUTPUT CONTROL MODULE	SIEMENS	6318 7165-0067:0222
	87		1	SIM-16	INPUT CONTROL MODULE	SIEMENS	6319 7165-0067:0222
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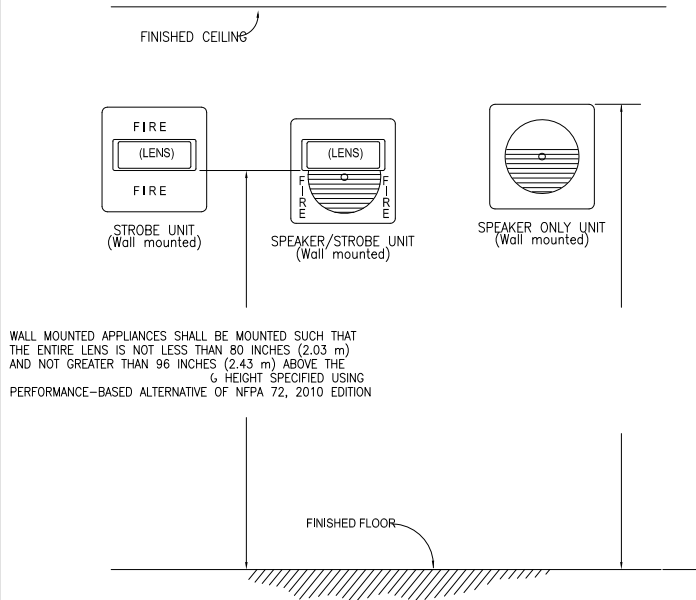
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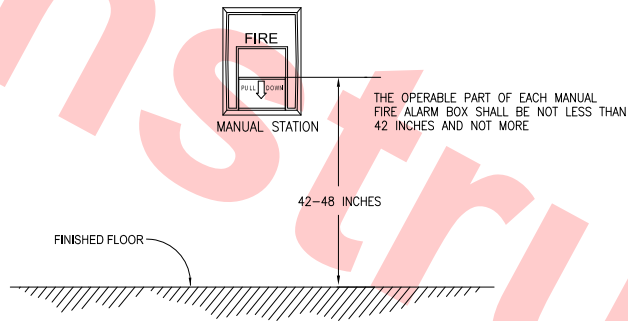
FOR REFERENCE ONLY
AND NOT FOR REVIEW

RECOMMENDED WIRING SCHEDULE		
SYMBOL	RECOMMENDED WIRE TYPE	USED ON
	2-CONDUCTOR, #16 AWG SOLID TWISTED CABLE Cable Part Number: F1TP16SRD-FPLR (CONDUIT)	ADDRESSABLE ALARM INITIATING DEVICES: - HFP-SERIES SMOKE DETECTORS - HTRI-SERIES INTERFACE MODULES - AD-SERIES DUCT DETECTORS - HMS-SERIES PULL STATION
	2-CONDUCTOR, #12 AWG SOLID or STRANDED (PER NEC) Cable Part Number: FA-1202C-1-1N-03 (CONDUIT)	NOTIFICATION APPLIANCE CIRCUIT: - STROBE CIRCUIT
	2-CONDUCTOR, #16 AWG SOLID TWISTED CABLE Cable Part Number: F1TP16SRD-FPLR (CONDUIT)	VOICE AUDIO CIRCUIT: - SPEAKER CIRCUIT
	2-CONDUCTOR, #12 AWG SOLID or STRANDED (PER NEC) Cable Part Number: FA-1202C-1-1N-03 (CONDUIT)	24 VDC POWER TO: - FIRE ALARM PANELS - DOOR HOLDERS - NURSE CALL DOME LIGHT
	2-CONDUCTOR, #16 AWG SOLID TWISTED CABLE Cable Part Number: F1TP16SRD-FPLR (CONDUIT)	TELEPHONE CIRCUIT: - FIREFIGHTER'S TELEPHONE JACK - FIREFIGHTER'S REMOTE TELEPHONE STATION
	2-CONDUCTOR, #16 AWG SOLID TWISTED CABLE Cable Part Number: F1TP16SRD-FPLR (CONDUIT)	MISCELLANEOUS FIELD DEVICES: - HTRI to MONITORED DEVICES - WATERFLOW SWITCH / TAMPER SWITCH
	2-CONDUCTOR, #16 AWG SOLID TWISTED CABLE Cable Part Number: F1TP16SRD-FPLR (CONDUIT)	"H-NET" XLS NETWORK WIRING: - MODULES that "SPEAK" H-NET: (SSD-C (ANNUNCIATOR))
	2-CONDUCTOR, #16 AWG SOLID TWISTED SHIELDED CABLE Cable Part Number: F1TSP16SRD-FPLR (CONDUIT)	"CAN BUS" - NETWORK WIRING: - MODULES that "SPEAK" CAN: - NIC-C, PSC-12 to (RPM, SCM-8, LCM-8, FCM-8, SIM-16 / OCM-16)
	2-CONDUCTOR, #16 AWG SOLID TWISTED CABLE Cable Part Number: F1TP16SRD-FPLR (CONDUIT)	VOICE AUDIO RISER: LOW LEVEL - DISTRIBUTED AMPLIFICATION (DAC-NET to DAC-NET)
	2-CONDUCTOR, #16 AWG SOLID TWISTED CABLE Cable Part Number: F1TP16SRD-FPLR (CONDUIT)	"X-NET" GLOBAL NETWORK WIRING: - MODULES that "SPEAK" X-NET: (NIC-C / NIM-1W / NCC-1F)
	2-CONDUCTOR, #12 AWG SOLID or STRANDED (PER NEC) Cable Part Number: FA-1202C-1-1N-03 (CONDUIT)	EXTENDER PANEL ACTIVATION: - SIEMENS PAD-3 EXTENDER PANEL
	2-CONDUCTOR, #12 AWG SOLID, THHN (GROUNDED WIRE)	120 VAC POWER WIRING TO: - F.A. CONTROL PANELS - WHEELLOCK PS-12/24-8 EXTENDER PANEL - POWER SUPPLY PANEL - FIRE ALARM PRINTERS
NOTES: 1. WIRING FOR NOTIFICATION APPLIANCE CIRCUIT IS CLASS A. 2. WIRING FOR SIGNAL LINE CIRCUIT IS CLASS X. 3. CONDUIT FILL < 40%, 3/4" CONDUIT. 4. LOCAL FIRE ALARM SYSTEM MONITORED BY A CENTRAL STATION. 5. SEE WIRING GUIDELINES FOR CABLE TYPE USE. 6. ALL WIRING SHALL BE IN A CONTINUOUS GRS CONDUIT SYSTEM. 7. ALL CONDUITS SHALL BE CONCEALED.		

MISCELLANEOUS DETAILS








TYPICAL ELEVATION DETAIL
OF AUDIBLE & VISUAL ALARM DEVICE

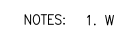

TYPICAL ELEVATION DETAIL
OF MANUAL PULL STATION

FIRE ALARM DESIGNATION

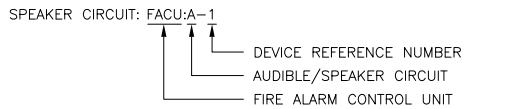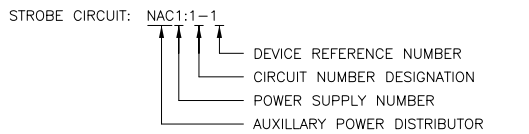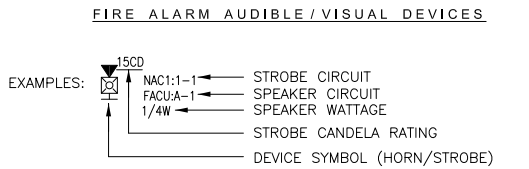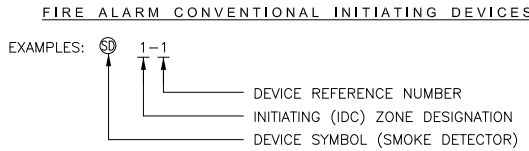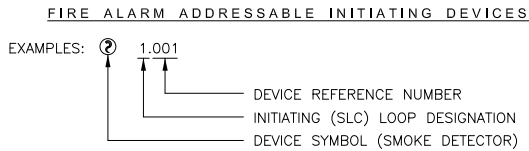

MISCELLANEOUS DETAILS

MANUFACTURER	PANEL DESCRIPTION	HEIGHT	WIDTH	DEPTH	WEIGHT	OSP NUMBER
Siemens	FACU CAB-3 (XLSV)	62-1/2"	26-1/8"	6-7/8"	175 Lbs.	0057-10
Siemens	CAB-BATT (100 A/H)	12-0"	26-1/8"	8-3/8"	135 Lbs.	0057-10
Wheelock	PS-8	16.7"	14.8"	5.5"	18 Lbs.	N/A
Kirkland	FAN CONTROL PANEL	30.0"	30.0"	5.0"	30 Lbs.	0139-10

DESIGNED BY V. SINGH	
DRAWN BY V. SINGH	
CHECKED BY F. CASABONNE	
IN CHARGE F. CASABONNE	
DATE 20130125	

REV	DATE	BY	SUB	APP	DESCRIPTION
20130125					DEFINITIVE DESIGN

Skanska Shimmick Herzog		1436 California Circle Milpitas, California 95035 A Joint Venture
SIEMENS Industry, Inc. Fire Safety Division		Lookwood, Andrews & Newnam, Inc. A LEOPOLD & WOLFF COMPANY
SUBMITTED		APPROVED

NOT FOR
CONSTRUCTION



LINE, TRACK, STATIONS AND SYSTEMS
MILPITAS STATION


FIRE ALARM
MISCELLANEOUS DETAILS

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SIZE D	SCALE NONE	
CONTRACT NO. C700	REV.	
AREA CODE DB	SHEET NO. E702	PAGE NO.

Jan 21, 2013 - 8 Singh						DESIGNED BY V. SINGH
						DRAWN BY V. SINGH
						CHECKED BY F. CASABONNE
						IN CHARGE F. CASABONNE
	20130125				DEFINITIVE DESIGN	DATE 20130125
REV	DATE	BY	SUB	APP	DESCRIPTION	

NOT FOR CONSTRUCTION	 BART SILICON VALLEY BART SILICON VALLEY BERRYESSA EXTENSION
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LINE, TRACK, STATIONS, AND SYSTEMS MILPITAS STATION FIRE ALARM SEQUENCE OF OPERATION	CADD FILENAME C700-S-DB-E703.dwg		
	SIZE D	SCALE NONE	
	CONTRACT NO. C700		REV.
	AREA CODE DB	SHEET NO. E703	PAGE NO.

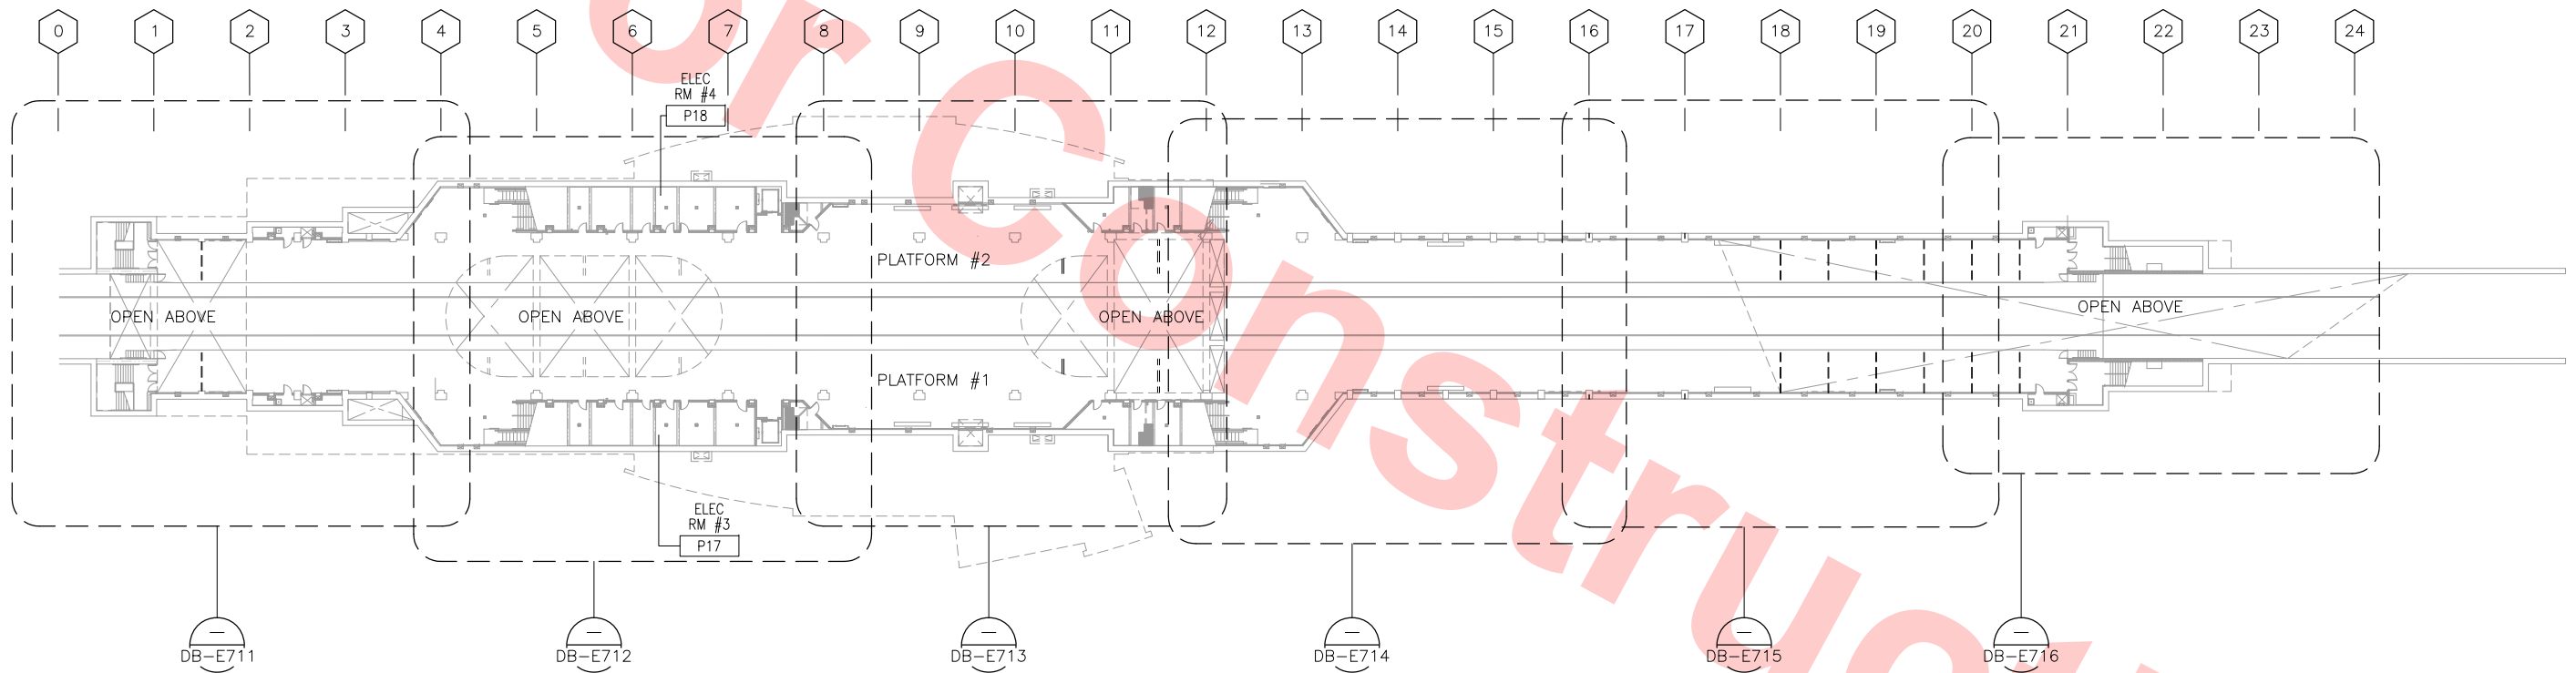

KEY PLAN — PLATFORM LEVEL — FIRE ALARM SYSTEM
SCALE: 1/32"=1'-0"



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Jan 23, 2013 - 6:06pm K:\FS\Engineering\California Projects\VA-Bart\Milpitas Station\S40\C700-S-DB-E710.dwg
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Jun. 23, 2013						DESIGNED BY V. SINGH
						DRAWN BY V. SINGH
						CHECKED BY F. CASABONNE
						IN CHARGE F. CASABONNE
						DATE 20130125
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		20130125				DEFINITIVE DESIGN


SIEMENS Industry, Inc. Fire Safety Division	SUBMITTED	APPROVED	NOT FOR CONSTRUCTION	 BART SILICON VALLEY BERRYESSA EXTENSION	LINE, TRACK, STATIONS AND SYSTEMS MILPITAS STATION KEY PLAN PLATFORM LEVEL FIRE ALARM SYSTEM	CADD FILENAME C700-S-DB-E710.dwg SIZE SCALE D 1/32"=1'-0" CONTRACT NO. C700 AREA CODE DB SHEET NO. E710 PAGE NO.

Skanska
Shimmick
Herzog

1436 California Circle
Milpitas, California 95035
A Joint Venture

Lookwood, Andrews
& Newnam, Inc.
A LEO A DALY COMPANY

T-Y-LIN INTERNATIONAL

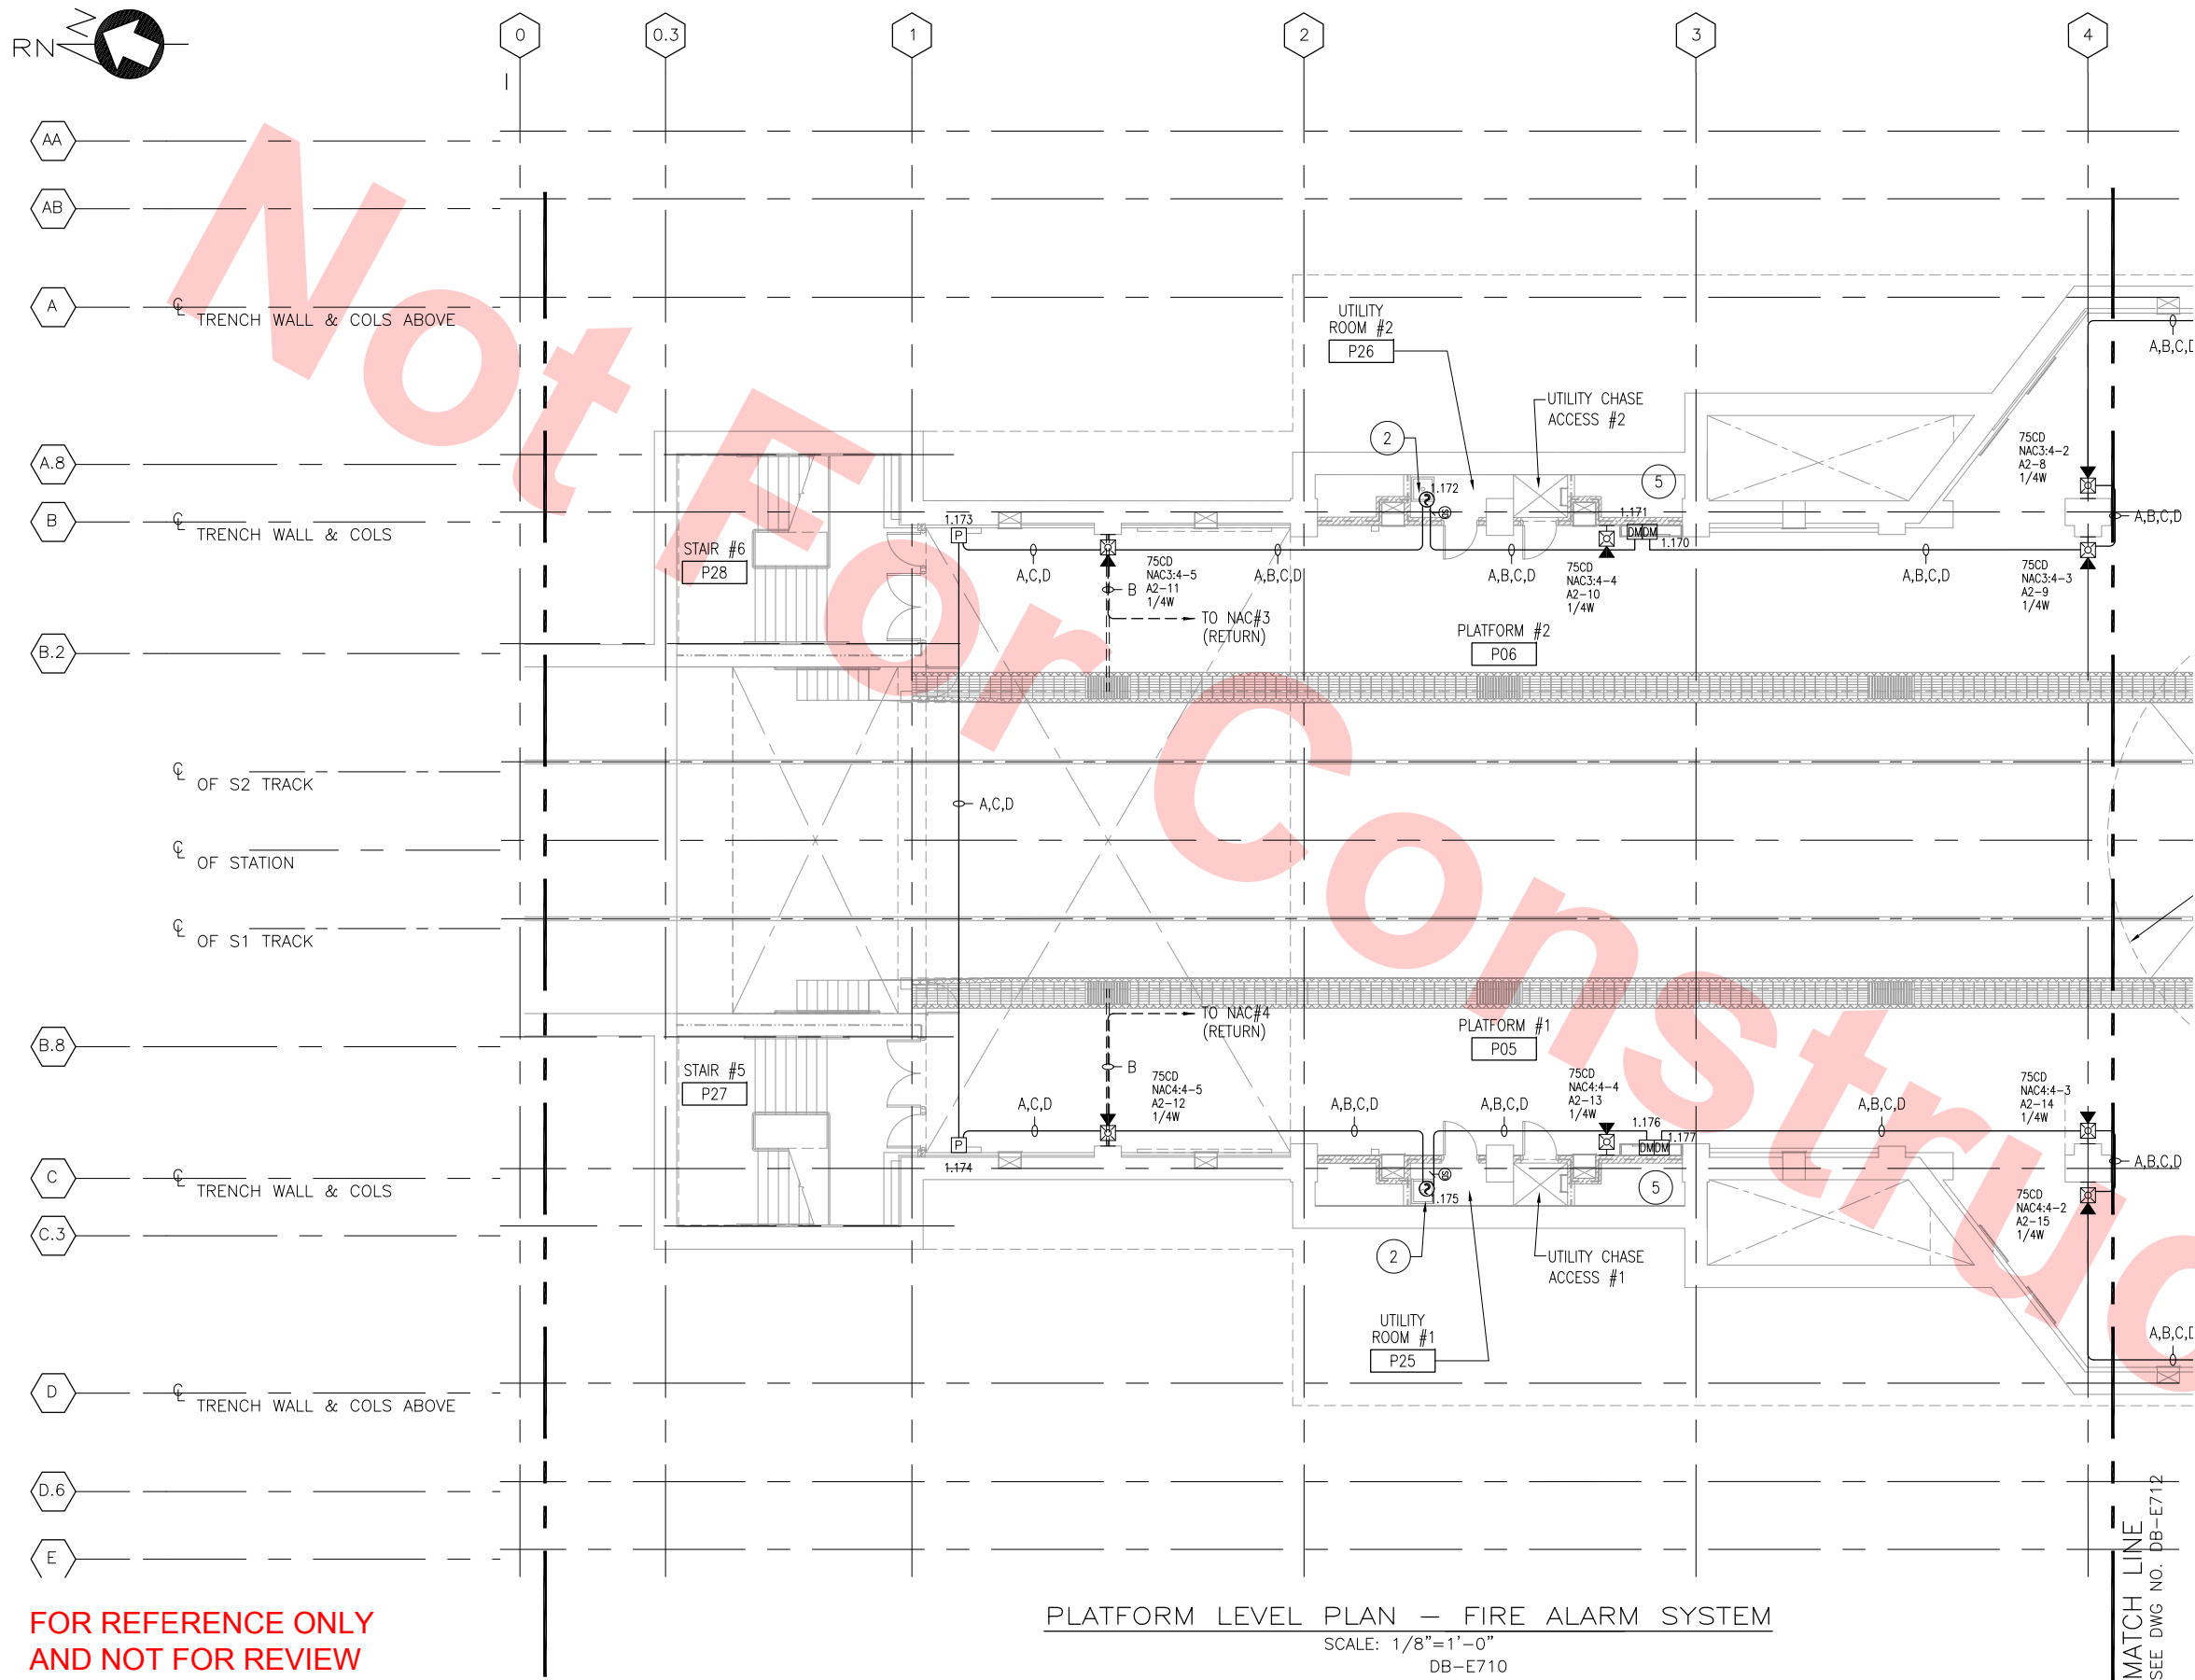

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AND NOT FOR REVIEW

PLATFORM LEVEL PLAN — FIRE ALARM SYSTEM
SCALE: 1/8"=1'-0"
DB-E710

NOTE

SHEET NOTES:


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GENERAL NOTES:

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KEY PLAN



Jan. 23, 2013						DESIGNED BY V. SINGH
						DRAWN BY V. SINGH
						CHECKED BY F. CASABONNE
						IN CHARGE F. CASABONNE
						DATE 20130125
SinghV	20130125				DEFINITIVE DESIGN	
REV	DATE	BY	SUB	APP	DESCRIPTION	

DESIGNED BY V. SINGH	
DRAWN BY V. SINGH	
CHECKED BY F. CASABONNE	
IN CHARGE F. CASABONNE	
DATE 20130125	

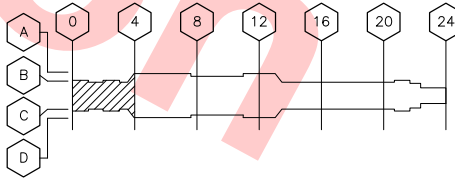SIEMENS Industry, Inc. Fire Safety Division	
SUBMITTED	

Skanska Shimmick Herzog	
1436 California Circle Milpitas, California 95035 A Joint Venture	
20130125	



Lookwood, Andrews & Newnam, Inc. A LEO A DALY COMPANY	
T-Y-LIN INTERNATIONAL	
APPROVED	

NOT FOR
CONSTRUCTION

BART SILICON VALLEY	
BART SILICON VALLEY BERRYESSA EXTENSION	

LINE, TRACK, STATIONS AND SYSTEMS MILPITAS STATION	
PLATFORM LEVEL PLAN FIRE ALARM SYSTEM SHEET 1 OF 6	

CADD FILENAME C700-S-DB-E711.dwg		
SIZE D	SCALE 1/8"=1'-0"	
CONTRACT NO. C700		REV.
AREA CODE DB	SHEET NO. E711	PAGE NO.

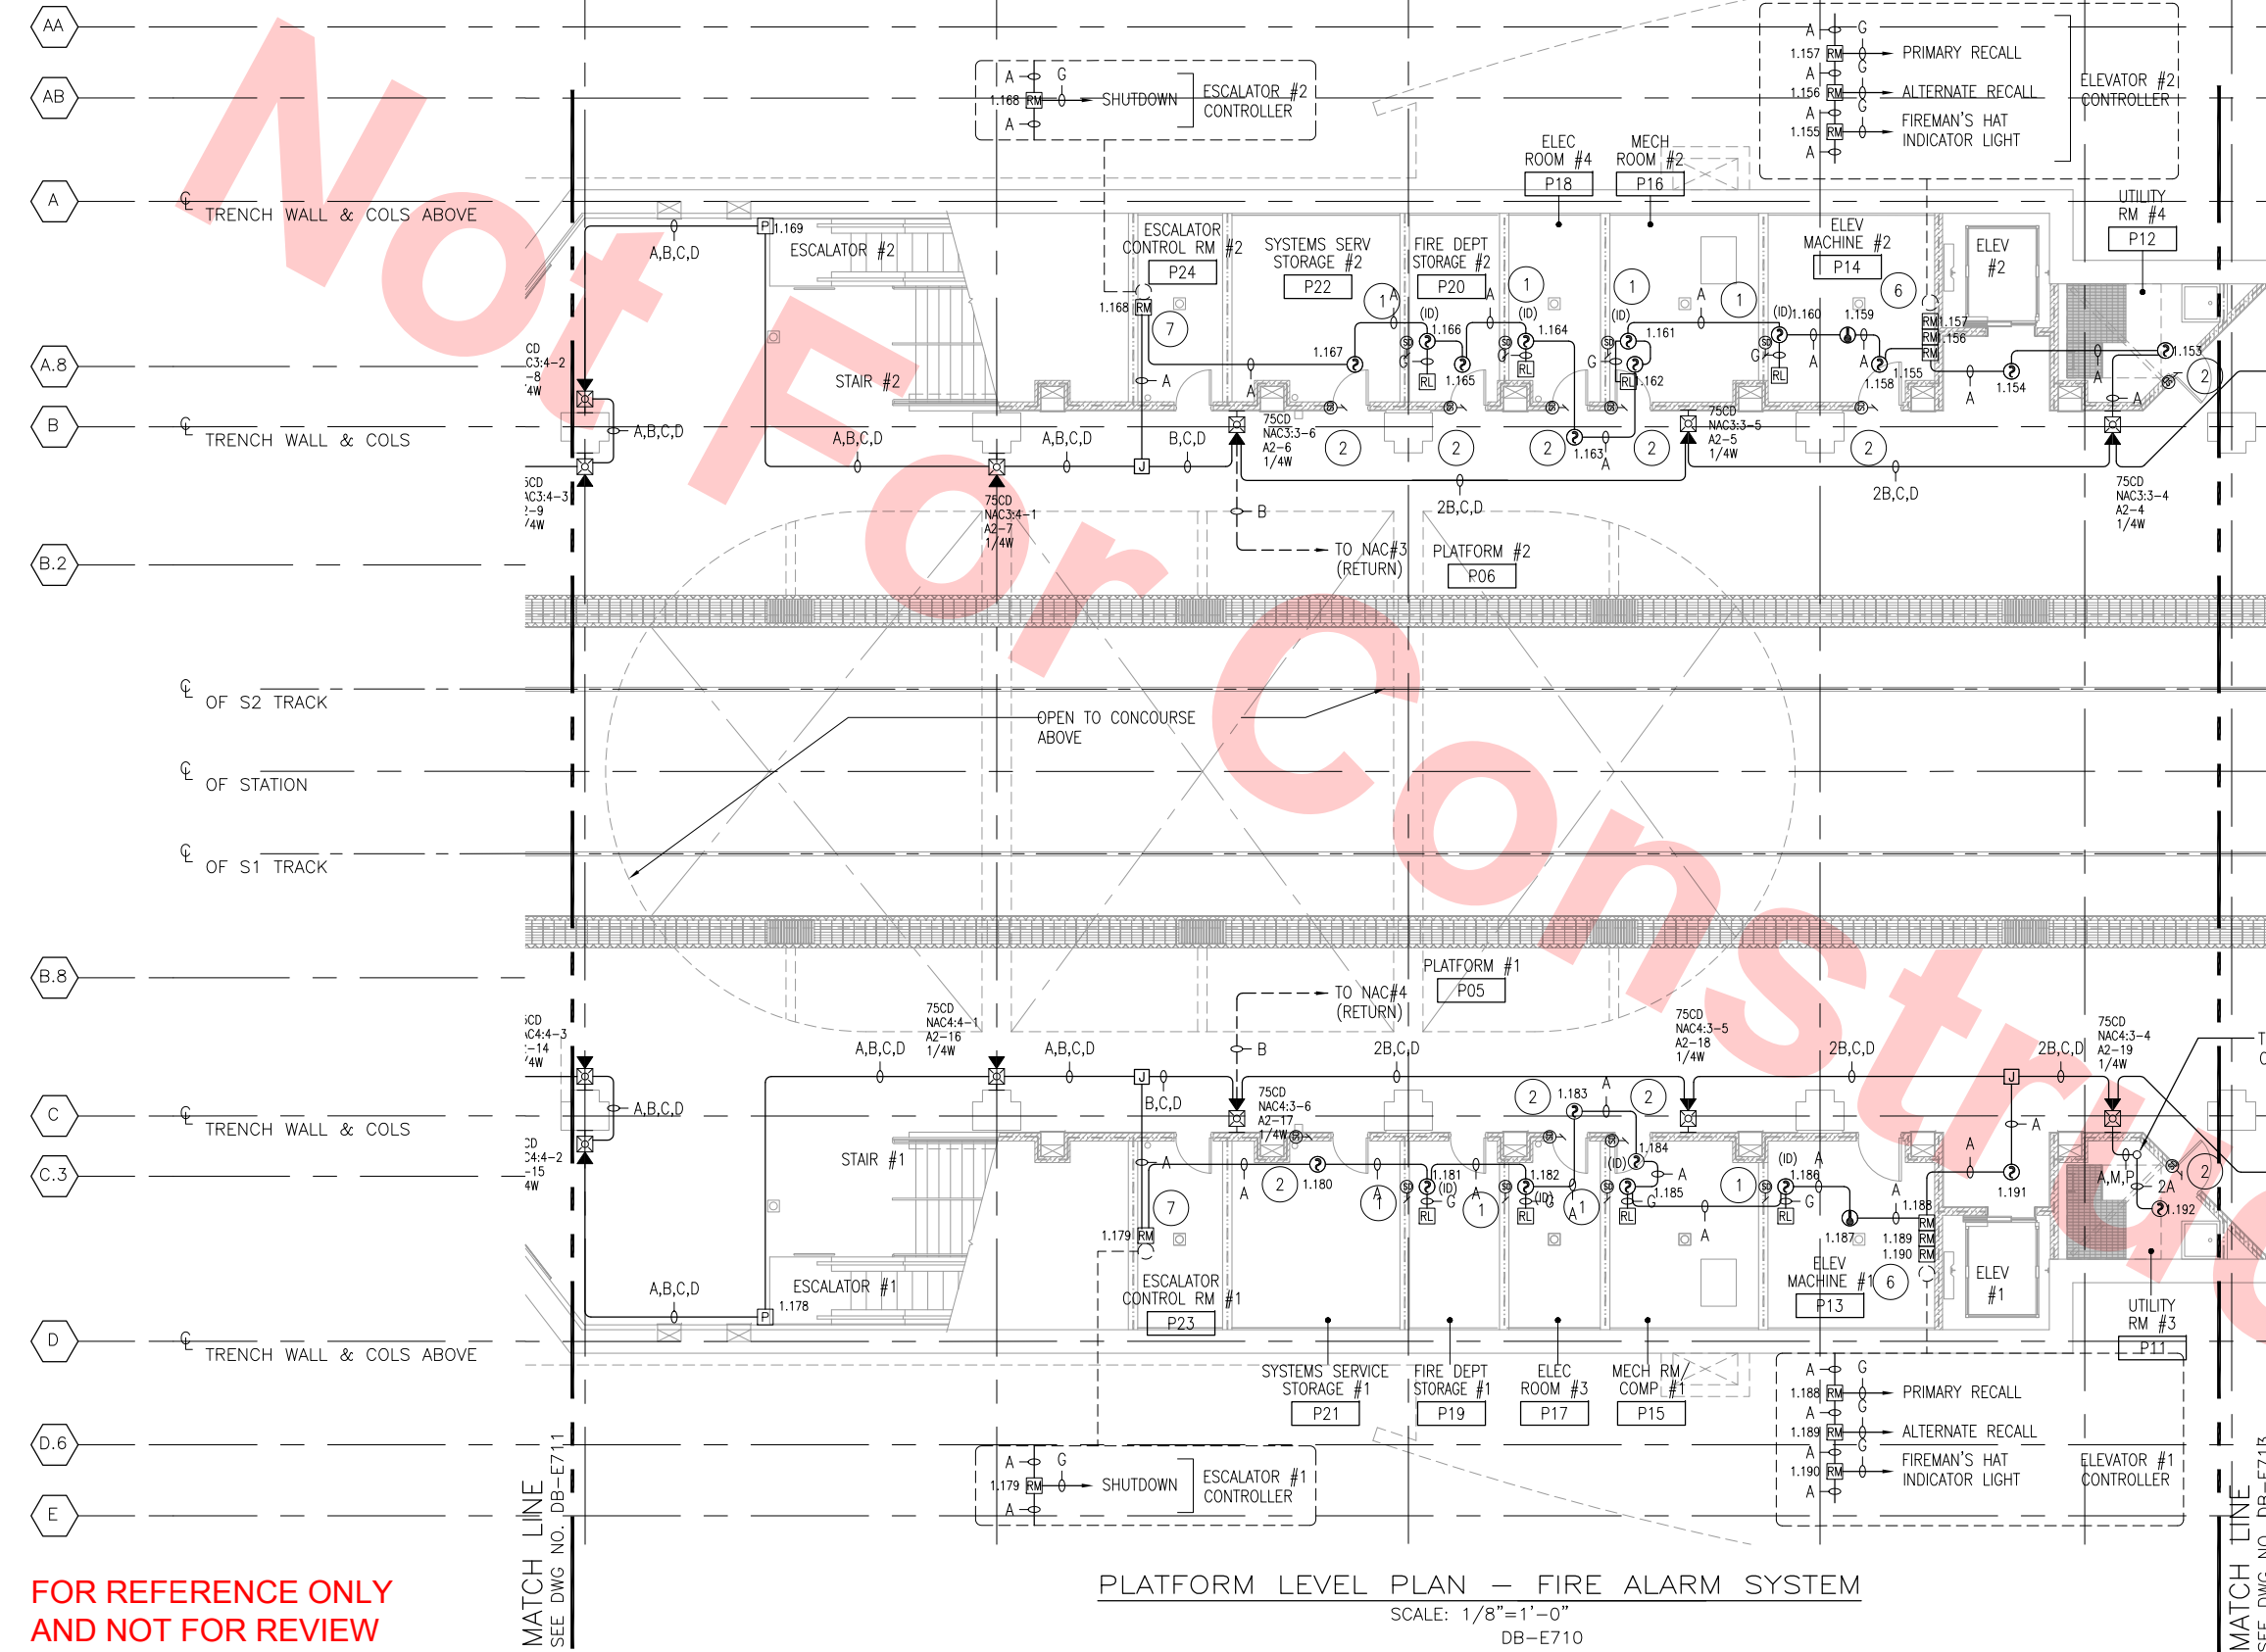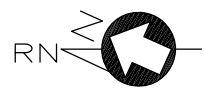

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PLATFORM LEVEL PLAN — FIRE ALARM SYSTEM
SCALE: 1/8"=1'-0"
DB-E710

NOTE

SHEET NOTES:


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KEY PLAN



Jan 24, 2013 10:14am K:\FS\Ops\Engineering\California Projects\Bart Milpitas Station S40\C700-S-DB-E712.dwg
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DESIGNED BY V. SINGH	
DRAWN BY V. SINGH	
CHECKED BY F. CASABONNE	
IN CHARGE F. CASABONNE	
DATE 20130125	
DEFINITIVE DESIGN	
REV	DATE BY SUB APP DESCRIPTION

Skanska Shimmick Herzog	1436 California Circle Milpitas, California 95035 A Joint Venture
SIEMENS Industry, Inc. Fire Safety Division	Lookwood, Andrews & Newnam, Inc. T-Y-LIN INTERNATIONAL
SUBMITTED	APPROVED


NOT FOR
CONSTRUCTION

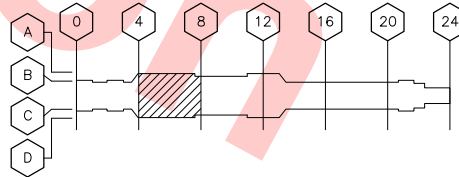

LINE, TRACK, STATIONS AND SYSTEMS
MILPITAS STATION

PLATFORM LEVEL PLAN
FIRE ALARM SYSTEM
SHEET 2 OF 6

CADD FILENAME C700-S-DB-E712.dwg	
SIZE SCALE D 1/8"=1'-0"	
CONTRACT NO. C700	REV.
AREA CODE DB	SHEET NO. E712
	PAGE NO.

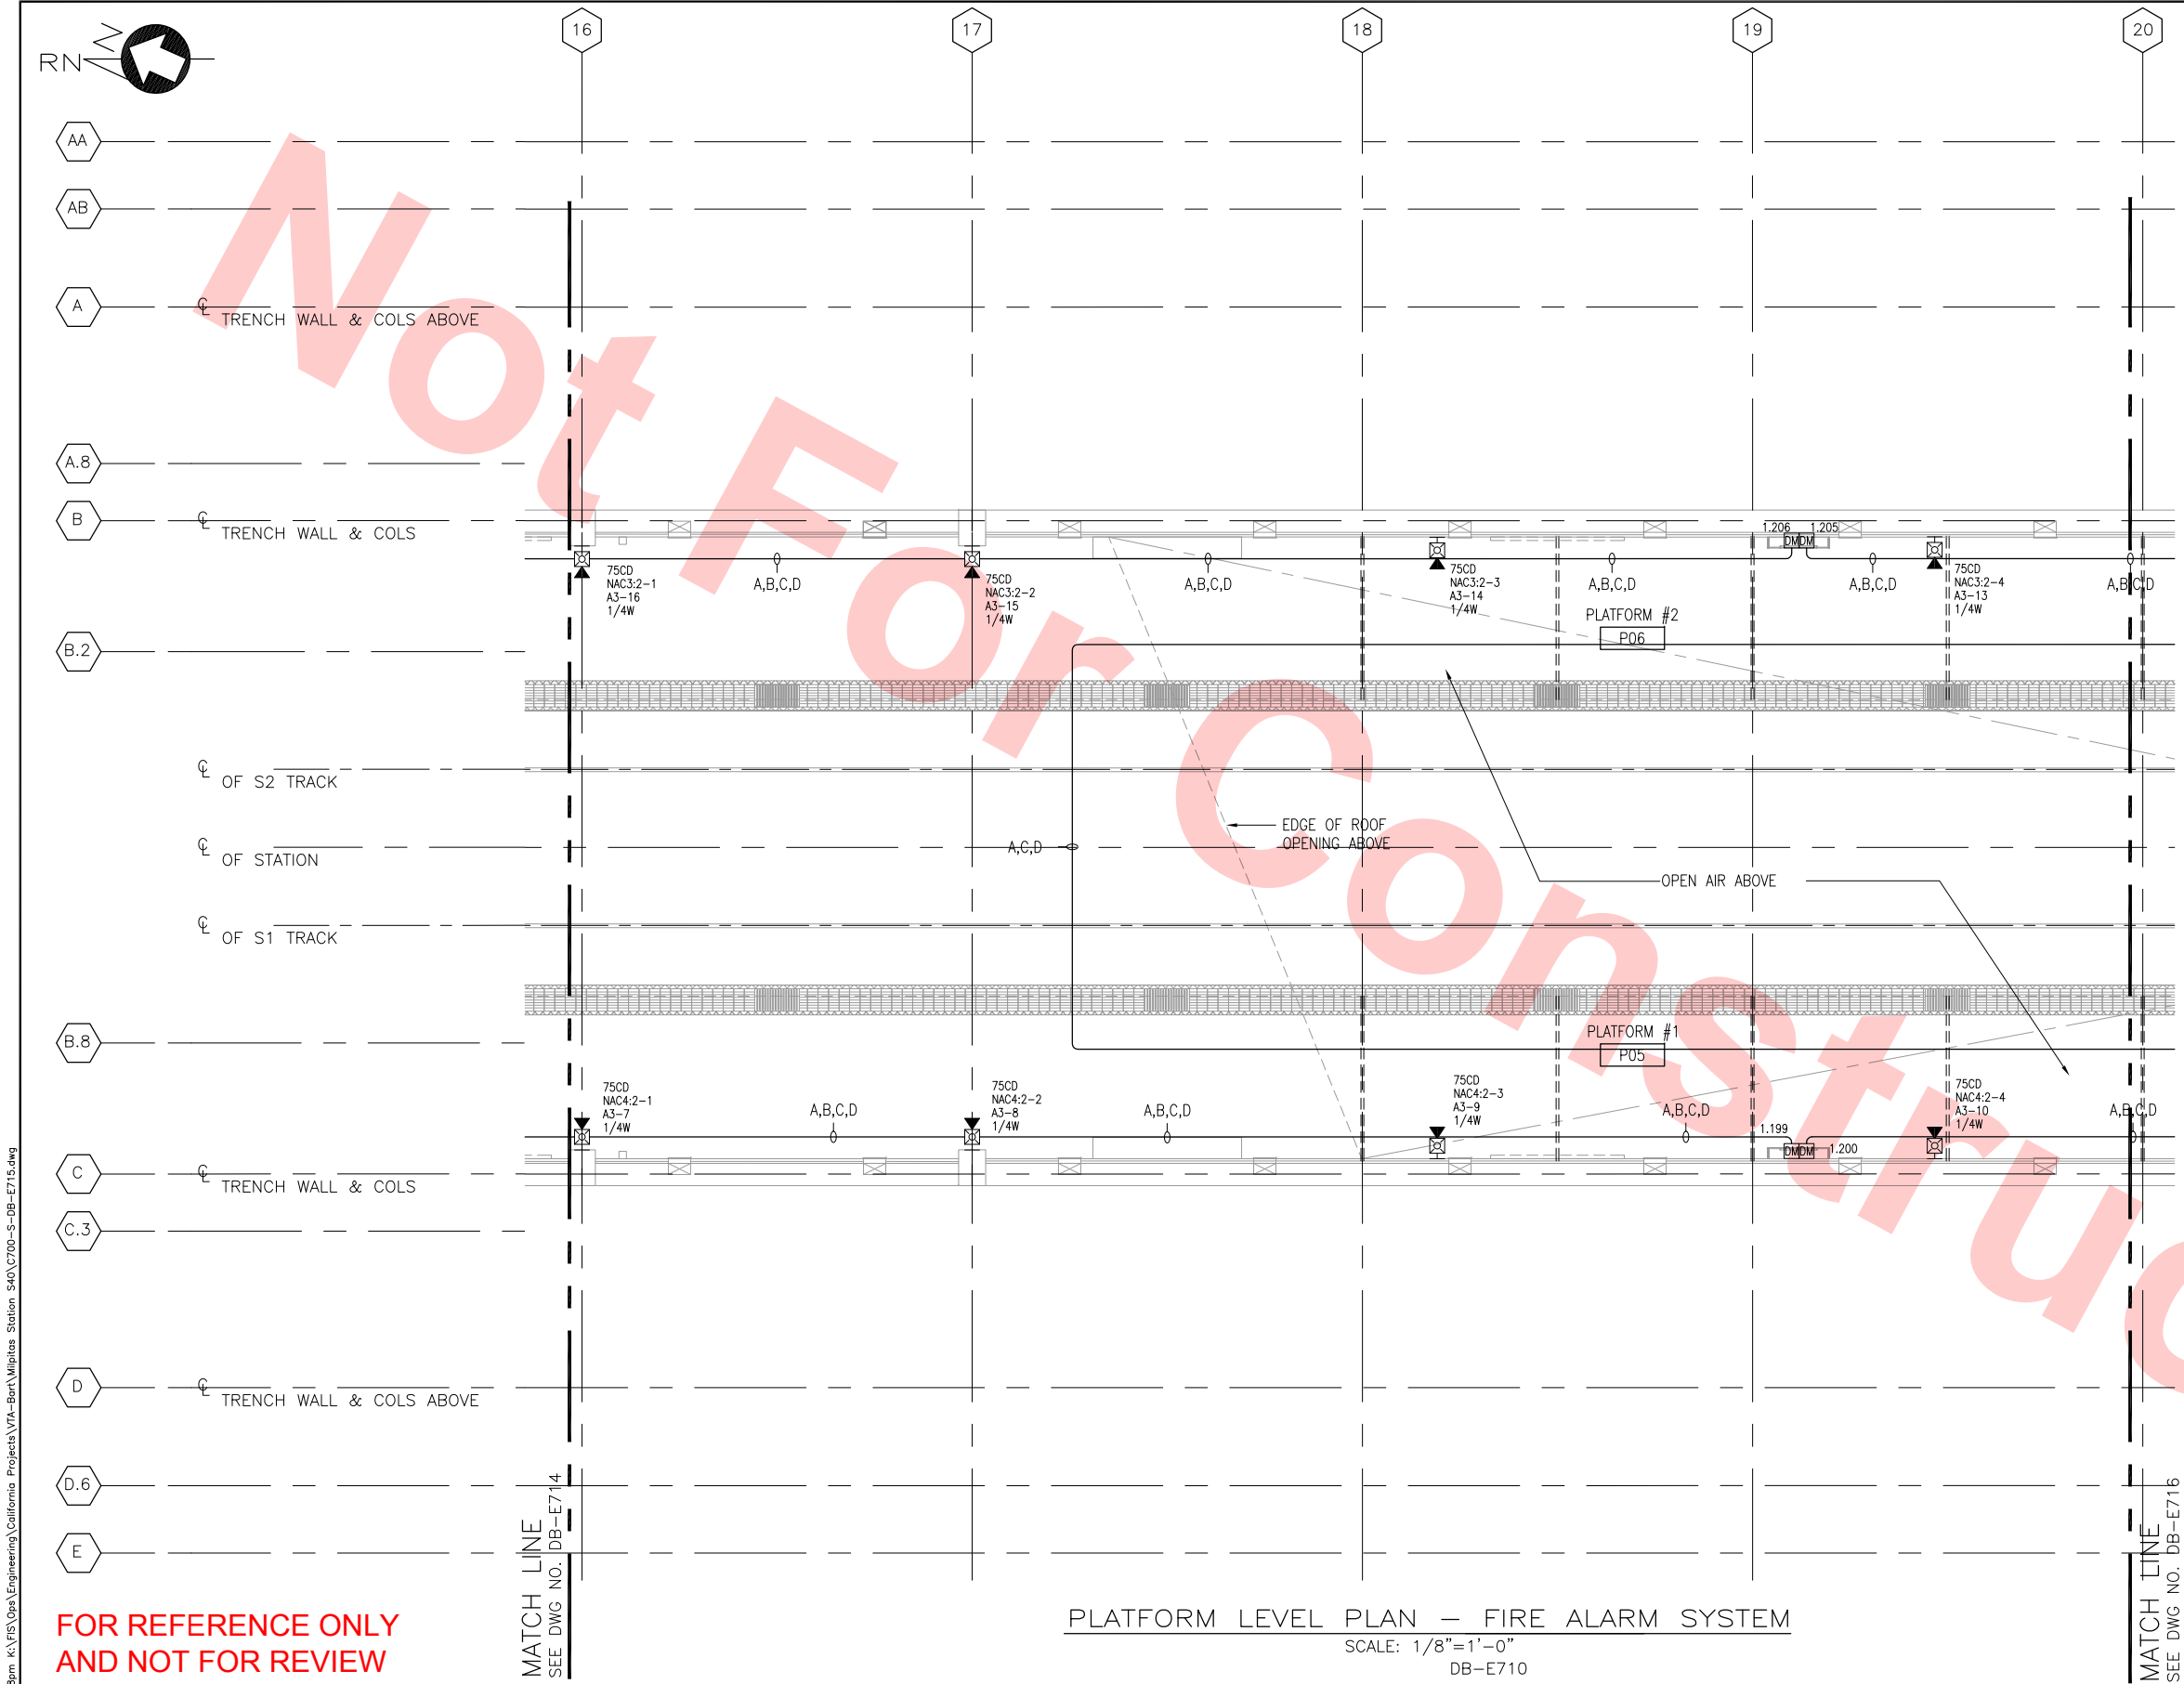

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PLATFORM LEVEL PLAN — FIRE ALARM SYSTEM
SCALE: 1/8"=1'-0"
DB-E710

NOTE


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 - 7 FIRE ALARM MODULE FOR ESCALATOR SHUTDOWN.

GENERAL NOTES:

1. CLASS A AND CLASS X CIRCUITS USING PHYSICAL CONDUCTORS (e.g METALLIC) SHALL BE INSTALLED SUCH THAT THE OUTGOING AND RETURN CONDUCTORS, EXISTING FROM AND RETURNING TO THE CONTROL UNIT RESPECTIVELY, ARE ROUTED SEPARATELY. THE RECOMMENDED MINIMUM SEPARATION TO PREVENT PHYSICAL DAMAGE IS 12 INCHES WHERE CABLE IS INSTALLED VERTICALLY AND 48 INCHES WHERE THE CABLE IS INSTALLED HORIZONTALLY.



KEY PLAN

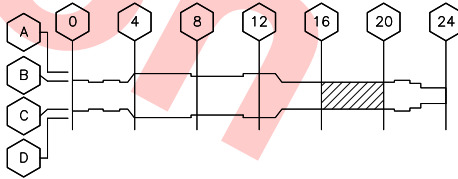

Jan 23, 2013 - 6:08pm K:\FS\Eng\California Projects\Bart\Bart-Milpitas Station S40\C700-S-DB-E715.dwg
Singh


Jun. 23, 2013						DESIGNED BY V. SINGH
						DRAWN BY V. SINGH
						CHECKED BY F. CASABONNE
						IN CHARGE F. CASABONNE
						DATE 20130125
SinghV	20130125				DEFINITIVE DESIGN	
REV	DATE	BY	SUB	APP	DESCRIPTION	

Skanska Shimmick Herzog <small>SAN FRANCISCO, CA 94104 20000 INDUSTRIAL BOULEVARD, SUITE 200 HAYWARD, CALIFORNIA 94541-2000 TEL (916) 785-0000 FAX (916) 785-2100 CALIFORNIA STATE CTS LICENSE NO. 705706 U.S. Certificate ID No. 324785-001</small>	1436 California Circle Milpitas, California 95035 A Joint Venture
SIEMENS Industry, Inc. Fire Safety Division	Lookwood, Andrews & Newnam, Inc. A LEOPOLD COMPANY
SUBMITTED	APPROVED

NOT FOR CONSTRUCTION

BART
VTA SILICON VALLEY
BART SILICON VALLEY BERRYESSA EXTENSION

LINE, TRACK, STATIONS AND SYSTEMS MILPITAS STATION	CADD FILENAME C700-S-DB-E715.dwg
PLATFORM LEVEL PLAN FIRE ALARM SYSTEM SHEET 5 OF 6	SIZE SCALE D 1/8"=1'-0"
	CONTRACT NO. C700
	AREA CODE DB
	SHEET NO. E715
	PAGE NO. 24

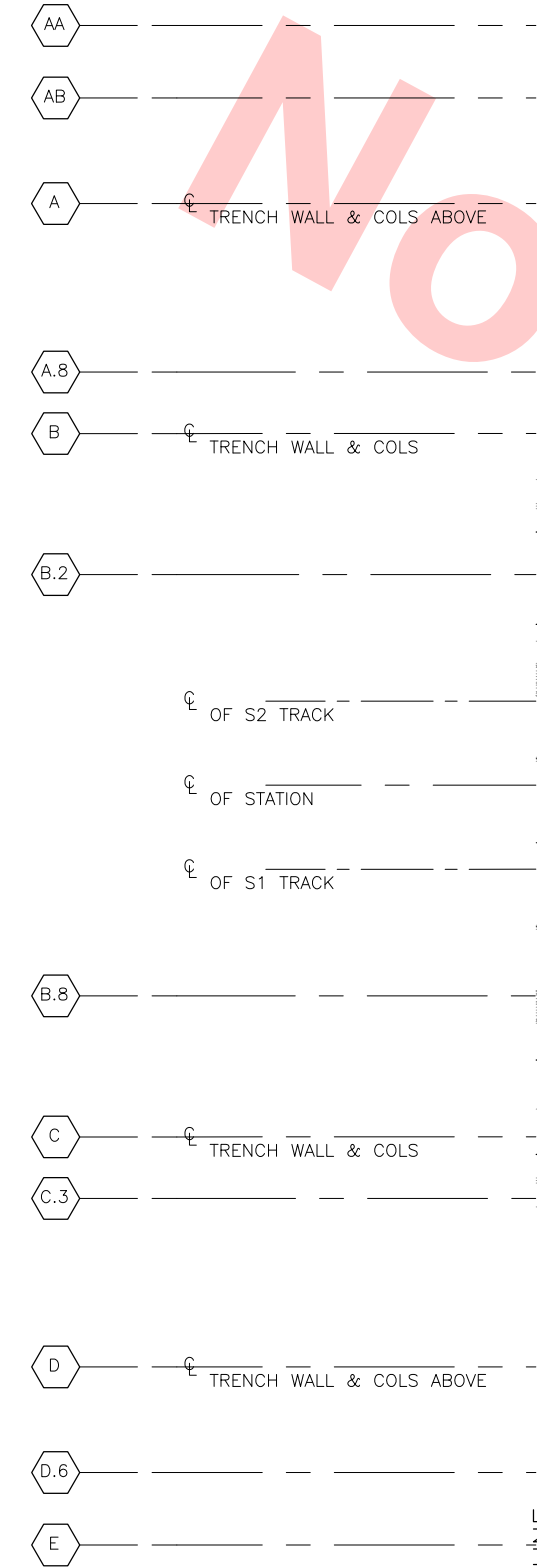

FOR REFERENCE ONLY
AND NOT FOR REVIEW

MATCH LINE
SEE DWG NO. DB-E715

PLATFORM LEVEL PLAN — FIRE ALARM SYSTEM
SCALE: 1/8"=1'-0"
DB-E710


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SHEET NOTES:


- 1 FIRE SMOKE DAMPER ACTUATION AS PER CBC 716.3.3.2.1
- 2 FIRE SMOKE DAMPER ACTUATION AS PER CBC 716.3.3.2.3
- 3 FIRE ALARM INTERFACE WITH SCADA SYSTEM.
- 4 FIRE ALARM INTERFACE WITH FM-200 FIRE SUPPRESSION SYSTEM. SMOKE DETECTION AND MECHANICAL CONTROL INSIDE TRAIN CONTROL/COMM ROOM PROVIDED BY FM-200 SYSTEM.
- 5 INTELLIGENT INTERFACE MODULE MONITORING SPRINKLER SYSTEM TAMPER SWITCHES AND WATERFOWL SWITCHES.
- 6 FIRE ALARM MODULES FOR ELEVATOR CONTROL. NO ELEVATOR SHUNT TRIP BECAUSE THERE ARE NO SPRINKLER'S INSIDE ELEVATOR MACHINE ROOM.
- 7 FIRE ALARM MODULE FOR ESCALATOR SHUTDOWN.

GENERAL NOTES:

1. CLASS A AND CLASS X CIRCUITS USING PHYSICAL CONDUCTORS (e.g METALLIC) SHALL BE INSTALLED SUCH THAT THE OUTGOING AND RETURN CONDUCTORS, EXISTING FROM AND RETURNING TO THE CONTROL UNIT RESPECTIVELY, ARE ROUTED SEPARATELY. THE RECOMMENDED MINIMUM SEPARATION TO PREVENT PHYSICAL DAMAGE IS 12 INCHES WHERE CABLE IS INSTALLED VERTICALLY AND 48 INCHES WHERE THE CABLE IS INSTALLED HORIZONTALLY.

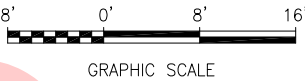

KEY PLAN

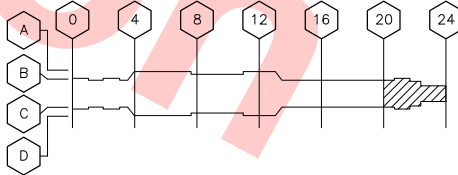

DESIGNED BY V. SINGH
DRAWN BY V. SINGH
CHECKED BY F. CASABONNE
IN CHARGE F. CASABONNE
DATE 20130125

REV	DATE	BY	SUB	APP	DESCRIPTION
20130125					DEFINITIVE DESIGN

Skanska Shimmick Herzog <small>SAN FRANCISCO 8649424 20027 INDUSTRIAL BOULEVARD, SUITE 200 HAYWARD, CALIFORNIA 94541-2001 TEL (916) 785-0000 FAX (916) 282-1100 CALIFORNIA STATE CTS LICENSE NO. 705706 U.S. Certificate ID No. 324795-001</small>	<small>1436 California Circle Milpitas, California 95035 A Joint Venture</small>
SIEMENS Industry, Inc. <small>Fire Safety Division</small>	Lookwood, Andrews & Newnam, Inc. <small>A LEO A DALY COMPANY</small>
SUBMITTED	APPROVED


NOT FOR
CONSTRUCTION



LINE, TRACK, STATIONS AND SYSTEMS
MILPITAS STATION


PLATFORM LEVEL PLAN
FIRE ALARM SYSTEM
SHEET 6 OF 6

CADD FILENAME C700-S-DB-E716.dwg		
SIZE D	SCALE 1/8"=1'-0"	
CONTRACT NO. C700		REV.
AREA CODE DB	SHEET NO. E716	PAGE NO.

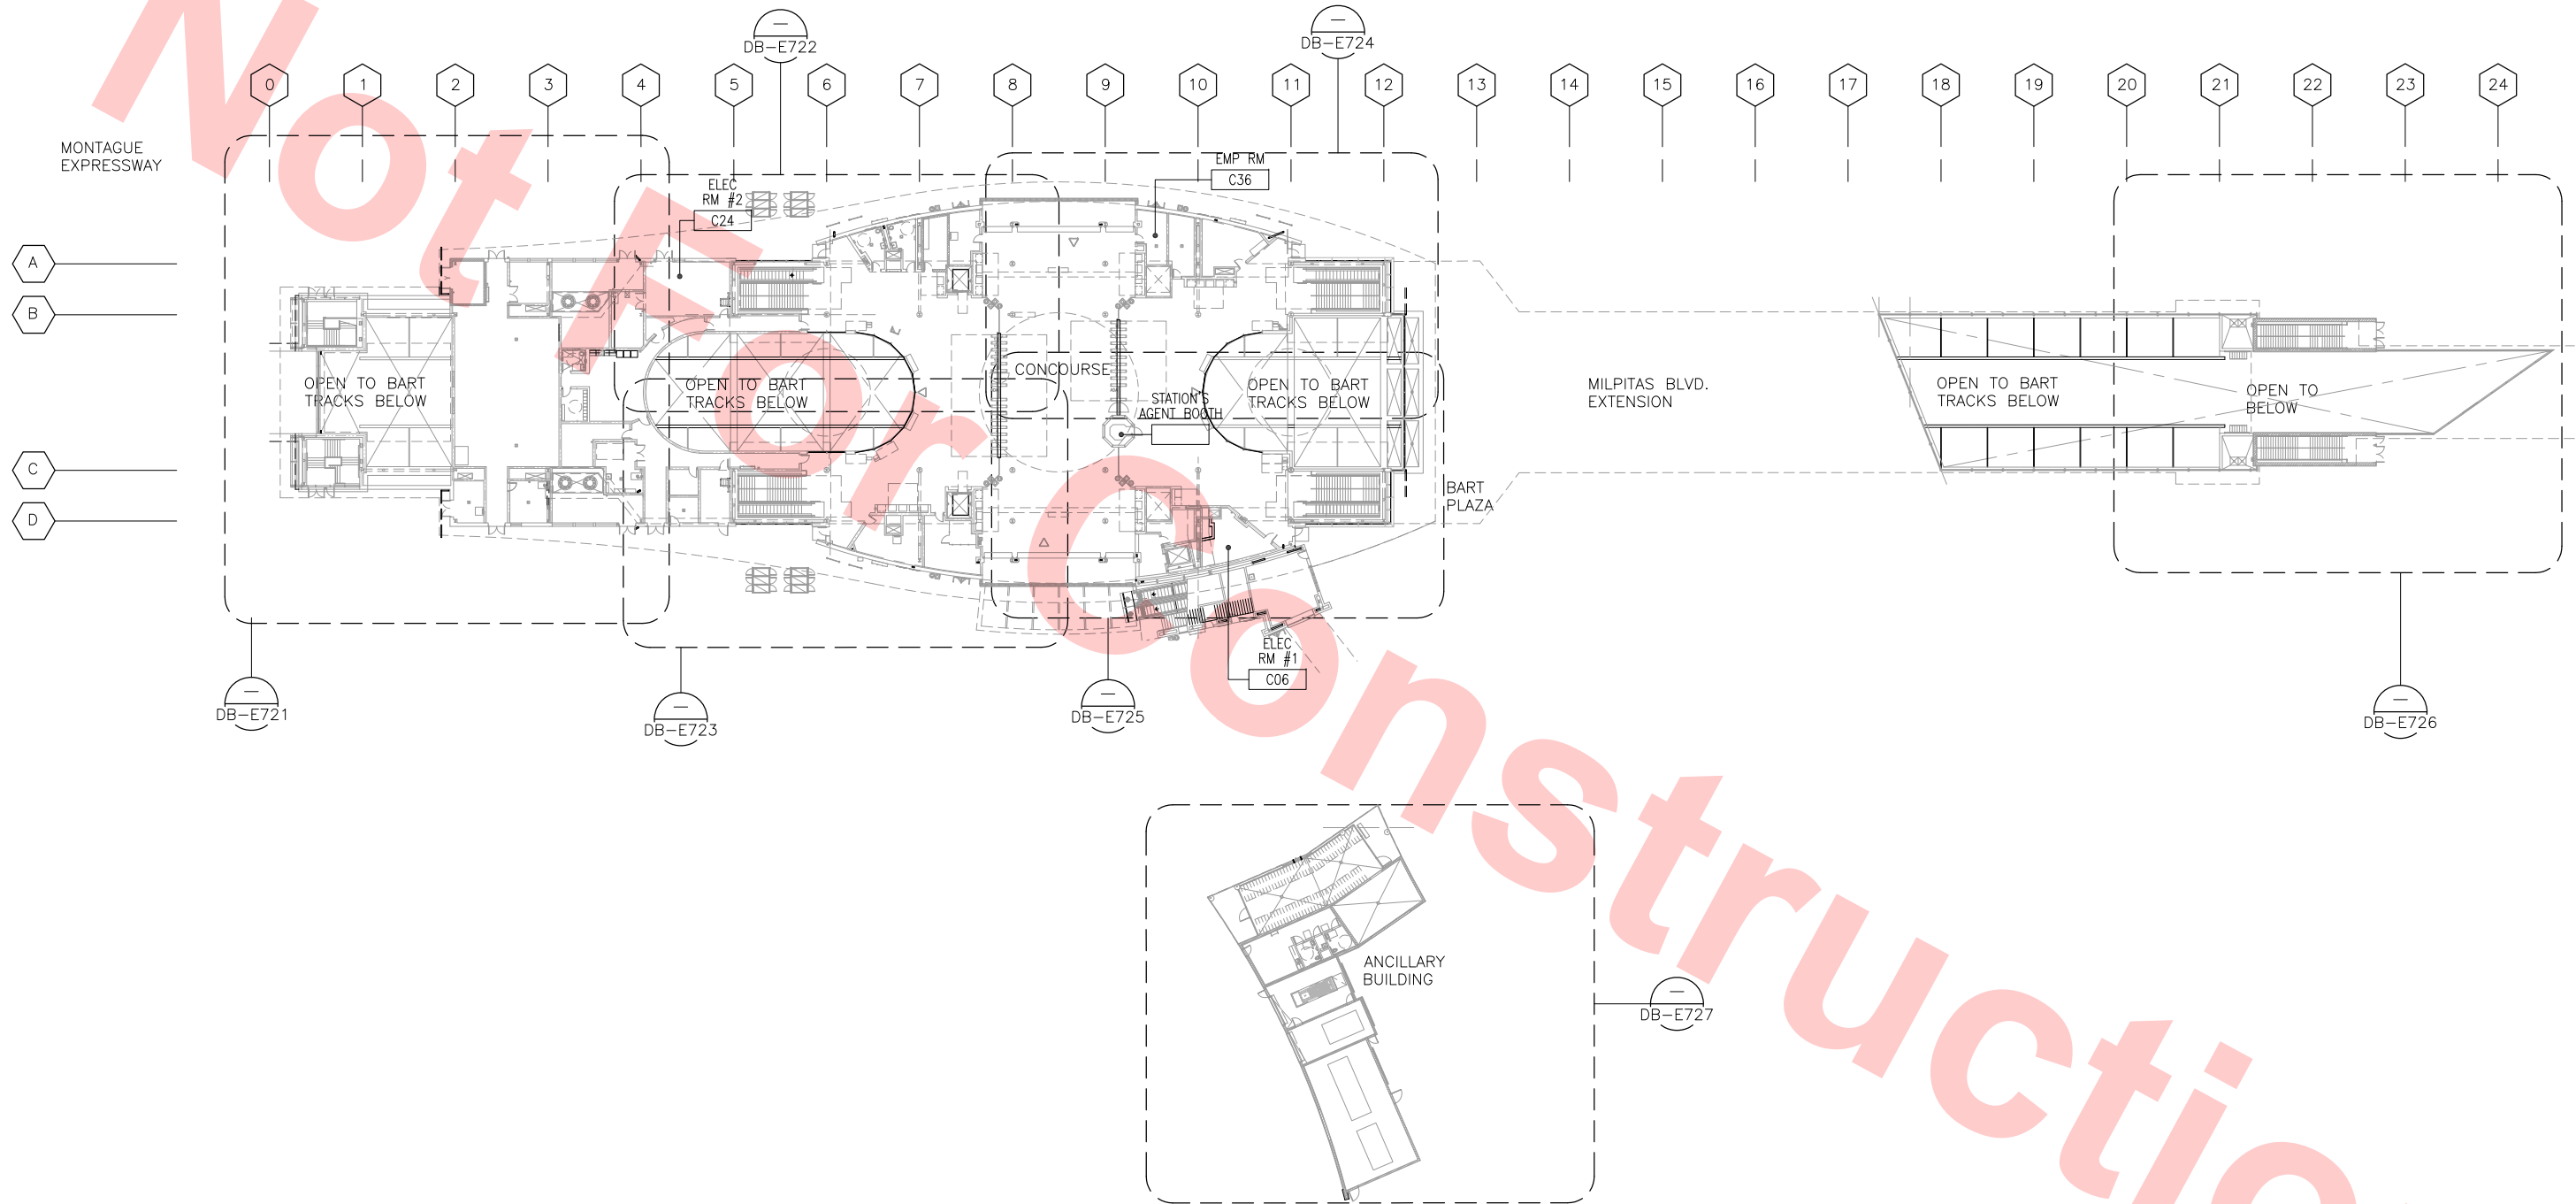

KEY PLAN — CONCOURSE LEVEL — FIRE ALARM SYSTEM
SCALE: 1/32"=1'-0"

FOR REFERENCE ONLY
AND NOT FOR REVIEW

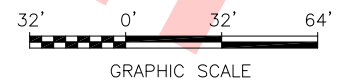

Jan 23, 2013 6:45pm K:\FS\Engineering\California Projects\VA-Bart\Milpitas Station\VA-Bart\Milpitas Station S40\C700-S-DB-E720.dwg
Singh

John 23, 2013 = Singh						DESIGNED BY V. SINGH
						DRAWN BY V. SINGH
						CHECKED BY F. CASABONNE
						IN CHARGE F. CASABONNE
						DATE 20130125
REV	DATE	BY	SUB	APP	DESCRIPTION	
	20130125				DEFINITIVE DESIGN	

Skanska Shimmick Herzog <small>SAN FRANCISCO 866-862-1234 20001 INDUSTRIAL BOULEVARD, SUITE 200 HAYWARD, CALIFORNIA 94541-2001 TEL (916) 785-5000 FAX (916) 785-2100 CALIFORNIA STATE C-15 LICENSE NO. 705706 U.S. Certificate ID No. 324795-001</small>	<small>1436 California Circle Milpitas, California 95035 A Joint Venture</small>
SIEMENS Industry, Inc. Fire Safety Division	Lookwood, Andrews & Newnam, Inc. A LEO A DALY COMPANY
SUBMITTED	APPROVED

NOT FOR
CONSTRUCTION



LINE, TRACK, STATIONS AND SYSTEMS MILPITAS STATION		
KEY PLAN CONCOURSE LEVEL FIRE ALARM SYSTEM		

CADD FILENAME C700-S-DB-E720.dwg		
SIZE	SCALE 1/32"=1'-0"	
CONTRACT NO.	C700	
AREA CODE	SHEET NO. DB E720	PAGE NO.



TRENCH WALL & COLS ABOVE

TRENCH WALL & COLS

OF S2 TRACK

OF STATION

OF S1 TRACK

TRENCH WALL & COLS

TRENCH WALL & COLS ABOVE

TRENCH WALL & COLS ABOVE

FOR REFERENCE ONLY
AND NOT FOR REVIEW

CONCOURSE LEVEL PLAN — FIRE ALARM SYSTEM

SCALE: 1/8"=1'-0"
DB-E720


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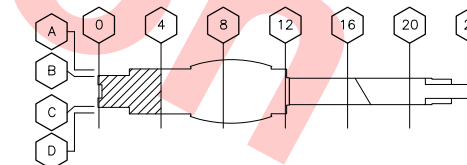
- 1 FIRE SMOKE DAMPER ACTUATION AS PER CBC 716.3.3.2.1
- 2 FIRE SMOKE DAMPER ACTUATION AS PER CBC 716.3.3.2.3
- 3 FIRE ALARM INTERFACE WITH SCADA SYSTEM.
- 4 FIRE ALARM INTERFACE WITH FM-200 FIRE SUPPRESSION SYSTEM. SMOKE DETECTION AND MECHANICAL CONTROL INSIDE TRAIN CONTROL/COMM ROOM PROVIDED BY FM-200 SYSTEM.
- 5 INTELLIGENT INTERFACE MODULE MONITORING SPRINKLER SYSTEM TAMPER SWITCHES AND WATERFLOW SWITCHES.
- 6 FIRE ALARM MODULES FOR ELEVATOR CONTROL. NO ELEVATOR SHUNT TRIP BECAUSE THERE ARE NO SPRINKLER'S INSIDE ELEVATOR MACHINE ROOM.

GENERAL NOTES:

1. CLASS A AND CLASS X CIRCUITS USING PHYSICAL CONDUCTORS (e.g METALLIC) SHALL BE INSTALLED SUCH THAT THE OUTGOING AND RETURN CONDUCTORS, EXISTING FROM AND RETURNING TO THE CONTROL UNIT RESPECTIVELY, ARE ROUTED SEPARATELY. THE RECOMMENDED MINIMUM SEPARATION TO PREVENT PHYSICAL DAMAGE IS 12 INCHES WHERE CABLE IS INSTALLED VERTICALLY AND 48 INCHES WHERE THE CABLE IS INSTALLED HORIZONTALLY.



KEY PLAN

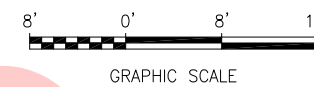

Jan 23, 2013 4:04pm K:\FS\Ops\Engineering\California Projects\Bart\Bart-VTA\Bart-VTA\Station S40\C700-S-DB-E721.dwg
Singh

DESIGNED BY V. SINGH	
DRAWN BY V. SINGH	
CHECKED BY F. CASABONNE	
IN CHARGE F. CASABONNE	
DATE 20130125	

REV	DATE	BY	SUB	APP	DESCRIPTION
20130125					DEFINITIVE DESIGN

Skanska Shimmick Herzog	1436 California Circle Milpitas, California 95035 A Joint Venture
SIEMENS Industry, Inc. Fire Safety Division	Lookwood, Andrews & Newnam, Inc. A LEO A DALY COMPANY
SUBMITTED	APPROVED


NOT FOR
CONSTRUCTION



LINE, TRACK, STATIONS AND SYSTEMS
MILPITAS STATION

CONCOURSE LEVEL PLAN
FIRE ALARM SYSTEM
SHEET 1 OF 6

CADD FILENAME C700-S-DB-E721.dwg	
SIZE SCALE D 1/8"=1'-0"	
CONTRACT NO. C700	REV.
AREA CODE DB	SHEET NO. E721
	PAGE NO.

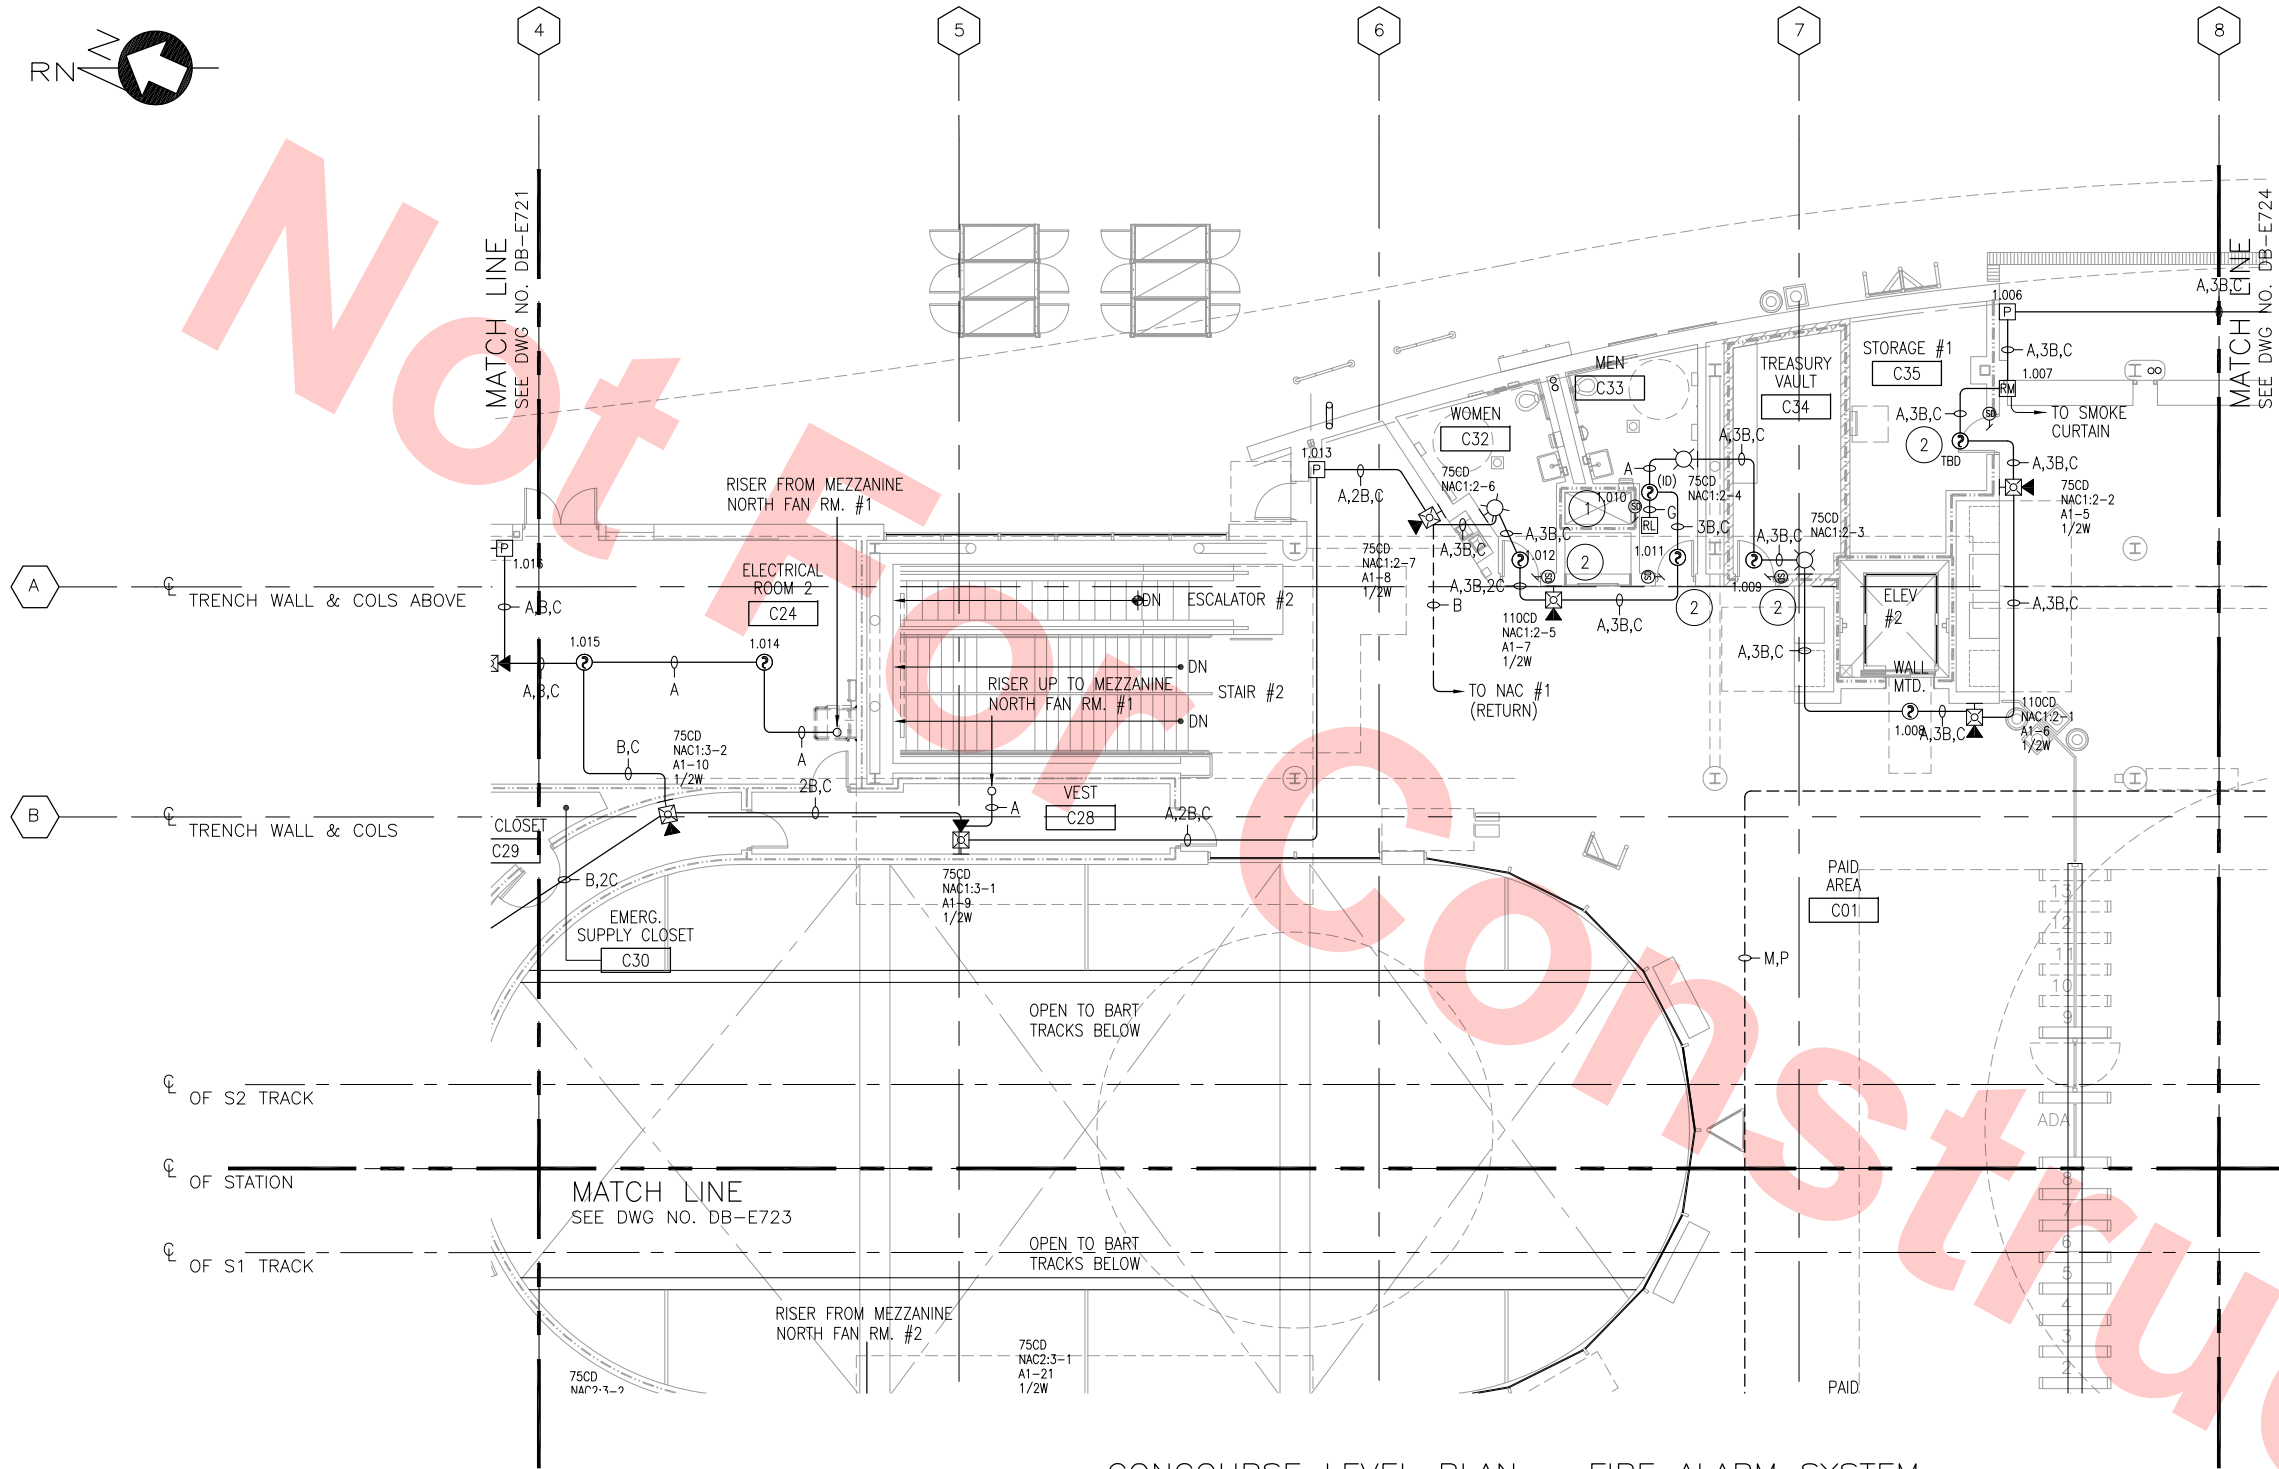

CONCOURSE LEVEL PLAN — FIRE ALARM SYSTEM
SCALE: 1/8"=1'-0"
DB-E720


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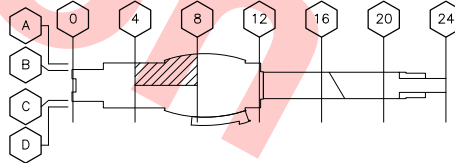
- 1 FIRE SMOKE DAMPER ACTUATION AS PER CBC 716.3.3.2.1
- 2 FIRE SMOKE DAMPER ACTUATION AS PER CBC 716.3.3.2.3
- 3 FIRE ALARM INTERFACE WITH SCADA SYSTEM.
- 4 FIRE ALARM INTERFACE WITH FM-200 FIRE SUPPRESSION SYSTEM. SMOKE DETECTION AND MECHANICAL CONTROL INSIDE TRAIN CONTROL/COMM ROOM PROVIDED BY FM-200 SYSTEM.
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KEY PLAN



FOR REFERENCE ONLY
AND NOT FOR REVIEW

Jan 23, 2013 - 4:06pm K:\FS\ps\Engineering\California Projects\BART\Bart\Wipiles Station S40\C700-S-DB-E722.dwg
Singh

DESIGNED BY V. SINGH
DRAWN BY V. SINGH
CHECKED BY F. CASABONNE
IN CHARGE F. CASABONNE
DATE 20130125

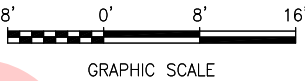REV	DATE	BY	SUB	APP	DESCRIPTION
20130125					DEFINITIVE DESIGN

Skanska Shimmick Herzog

1436 California Circle
Milpitas, California 95035
A Joint Venture

20077 Industrial Boulevard, Suite 200
Hayward, California 94541-2001
Tel: (510) 785-0000 Fax: (510) 252-1100
California State CTS License No. 705706
U.S. Certificate ID No. 324791-001

SIEMENS Industry, Inc.
Fire Safety Division

SUBMITTED

Lookwood, Andrews & Newnam, Inc.
A LEO A DALY COMPANY

T-Y-LIN INTERNATIONAL

APPROVED

NOT FOR CONSTRUCTION


BART SILICON VALLEY

BART SILICON VALLEY BERRYESSA EXTENSION

LINE, TRACK, STATIONS AND SYSTEMS
MILPITAS STATION

CONCOURSE LEVEL PLAN
FIRE ALARM SYSTEM
SHEET 2 OF 6

CADD FILENAME C700-S-DB-E722.dwg		
SIZE	SCALE 1/8"=1'-0"	
CONTRACT NO. C700		
AREA CODE DB	SHEET NO. E722	PAGE NO.

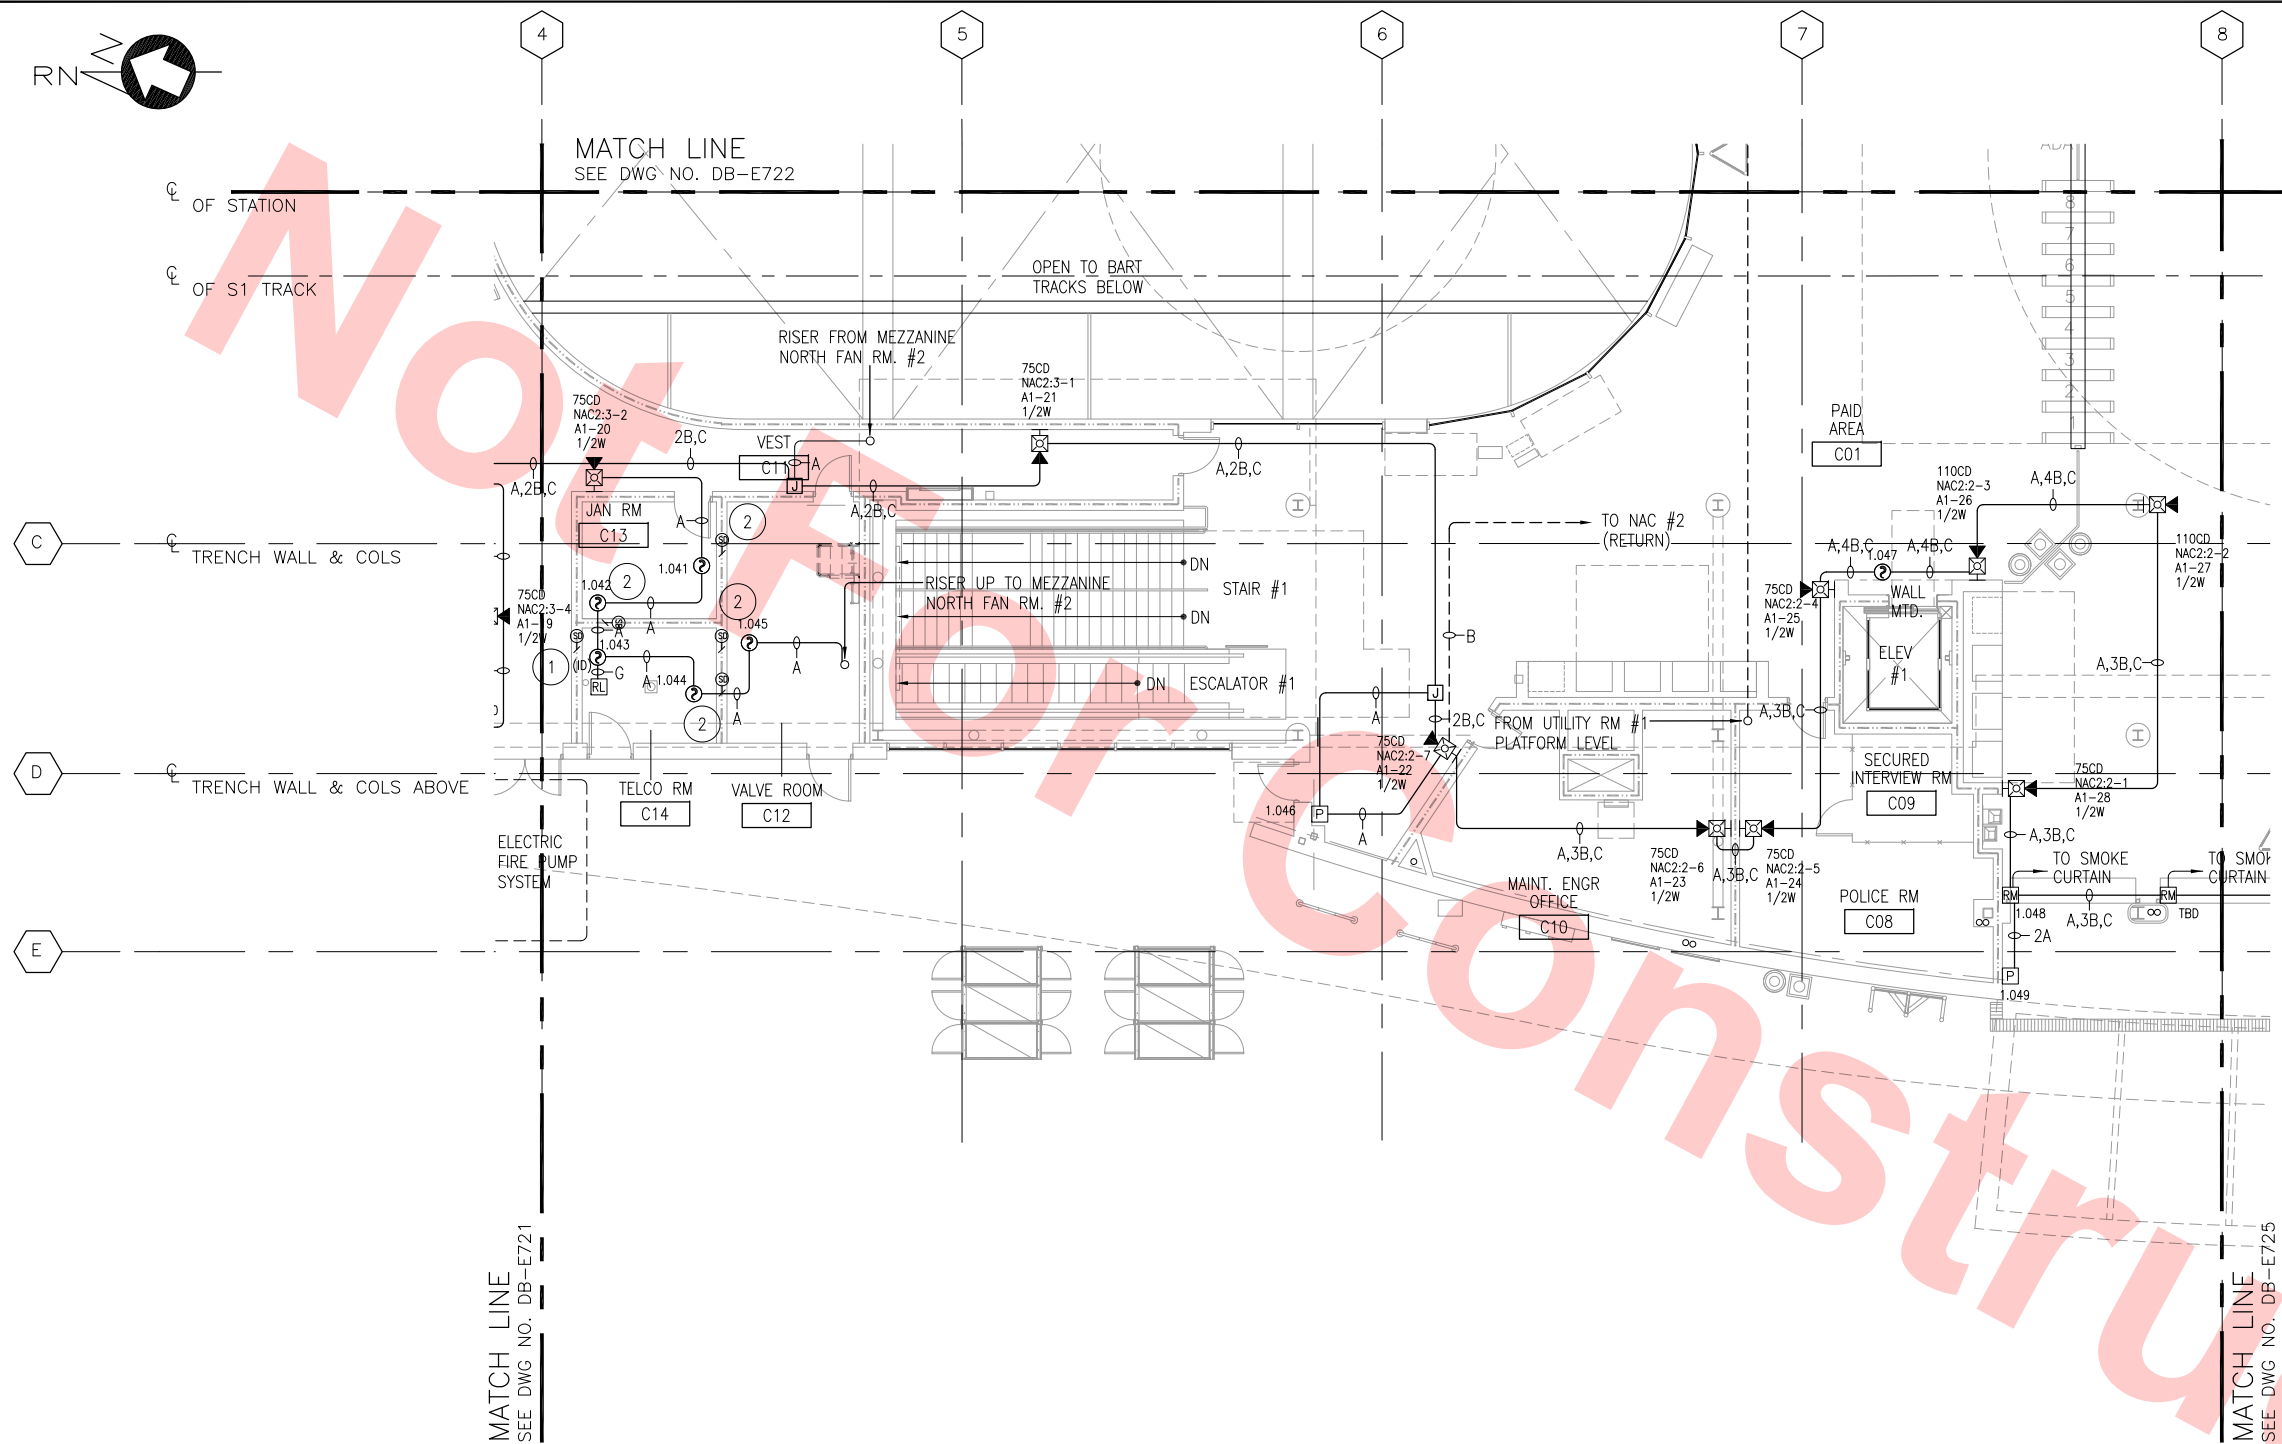

CONCOURSE LEVEL PLAN — FIRE ALARM SYSTEM
SCALE: 1/8"=1'-0"
DB-E720


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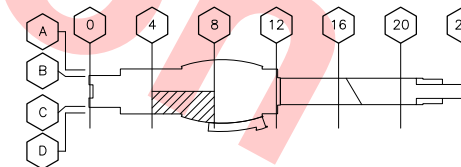
- 1 FIRE SMOKE DAMPER ACTUATION AS PER CBC 716.3.3.2.1
- 2 FIRE SMOKE DAMPER ACTUATION AS PER CBC 716.3.3.2.3
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GENERAL NOTES:

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KEY PLAN



FOR REFERENCE ONLY
AND NOT FOR REVIEW

Jan 23, 2013 4:12pm K:\FS\ps\Engineering\California Projects\VA-Bart-Berryessa Station S40\C700-S-DB-E723.dwg
Singh

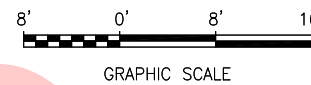REV	DATE	BY	SUB	APP	DESCRIPTION
20130125					DEFINITIVE DESIGN

DESIGNED BY V. SINGH	DATE 20130125
DRAWN BY V. SINGH	
CHECKED BY F. CASABONNE	
IN CHARGE F. CASABONNE	

Skanska Shimmick Herzog SAN FRANCISCO 8664824 2007 INDUSTRIAL BOULEVARD, SUITE 200 HAYWARD, CALIFORNIA 94542-0001 TEL (916) 785-0000 FAX (916) 282-1100 CALIFORNIA STATE C10 LICENSE NO. 705706 U.S. Certificate ID No. 324785-001	1436 California Circle Milpitas, California 95035 A Joint Venture Lookwood, Andrews & Newnam, Inc. A LEO A DALY COMPANY T-Y-LIN INTERNATIONAL
SIEMENS Industry, Inc. Fire Safety Division SUBMITTED	APPROVED


NOT FOR
CONSTRUCTION



LINE, TRACK, STATIONS AND SYSTEMS
MILPITAS STATION

CONCOURSE LEVEL PLAN
FIRE ALARM SYSTEM
SHEET 3 OF 6

CADD FILENAME C700-S-DB-E723.dwg	
SIZE SCALE D 1/8"=1'-0"	
CONTRACT NO. C700	REV.
AREA CODE DB	SHEET NO. E723
	PAGE NO.

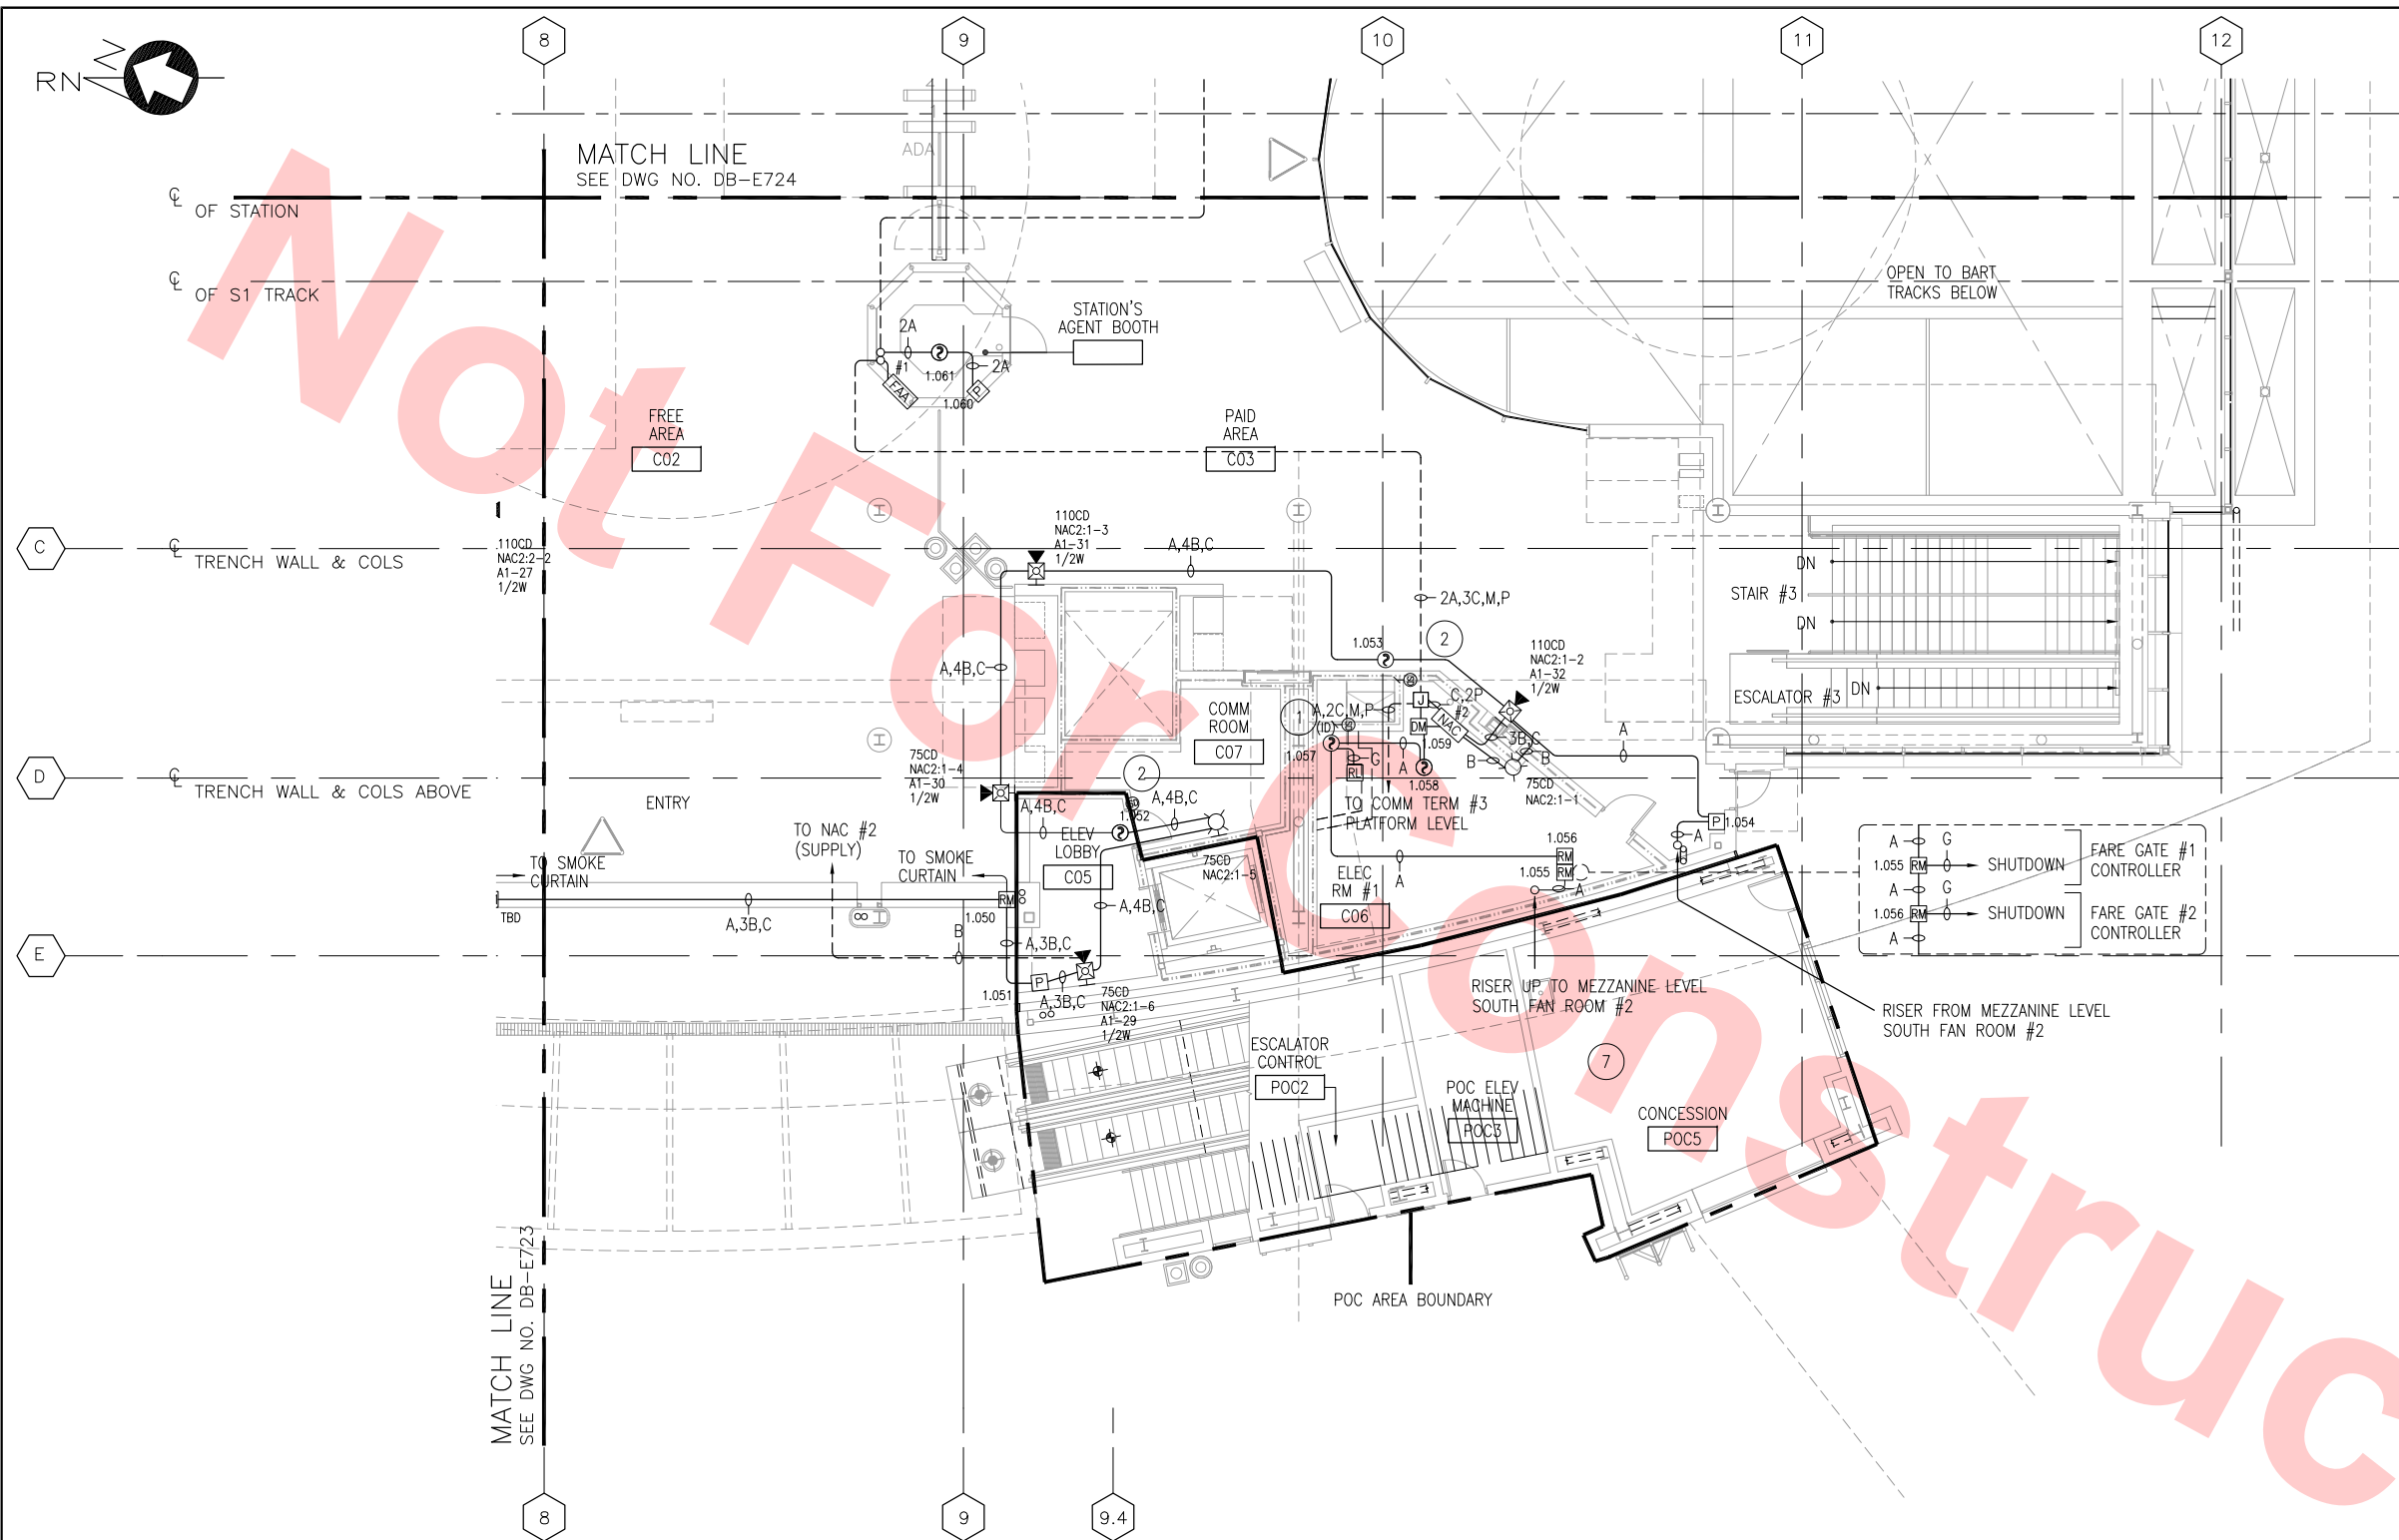


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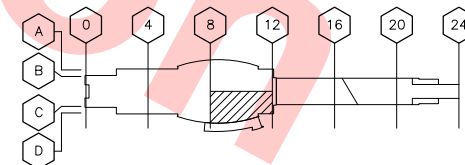
- 1 FIRE SMOKE DAMPER ACTUATION AS PER CBC 716.3.3.2.1
- 2 FIRE SMOKE DAMPER ACTUATION AS PER CBC 716.3.3.2.3
- 3 FIRE ALARM INTERFACE WITH SCADA SYSTEM.
- 4 FIRE ALARM INTERFACE WITH FM-200 FIRE SUPPRESSION SYSTEM. SMOKE DETECTION AND MECHANICAL CONTROL INSIDE TRAIN CONTROL/COMM ROOM PROVIDED BY FM-200 SYSTEM.
- 5 INTELLIGENT INTERFACE MODULE MONITORING SPRINKLER SYSTEM TAMPER SWITCHES AND WATERFOWL SWITCHES.
- 6 FIRE ALARM MODULES FOR ELEVATOR CONTROL. NO ELEVATOR SHUNT TRIP BECAUSE THERE ARE NO SPRINKLER'S INSIDE ELEVATOR MACHINE ROOM.
- 7 THIS AREA WILL BE SERVED BY THE EXISTING VTA FIRE ALARM SYSTEM. THIS INCLUDES THE ESCALATOR CONTROL, POC ELEVATOR CONTROL, DETECTION & NOTIFICATION.

GENERAL NOTES:

1. CLASS A AND CLASS X CIRCUITS USING PHYSICAL CONDUCTORS (e.g METALLIC) SHALL BE INSTALLED SUCH THAT THE OUTGOING AND RETURN CONDUCTORS, EXISTING FROM AND RETURNING TO THE CONTROL UNIT RESPECTIVELY, ARE ROUTED SEPARATELY. THE RECOMMENDED MINIMUM SEPARATION TO PREVENT PHYSICAL DAMAGE IS 12 INCHES WHERE CABLE IS INSTALLED VERTICALLY AND 48 INCHES WHERE THE CABLE IS INSTALLED HORIZONTALLY.



KEY PLAN

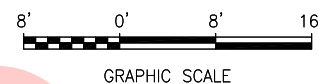

FOR REFERENCE ONLY
AND NOT FOR REVIEW

CONCOURSE LEVEL PLAN — FIRE ALARM SYSTEM
SCALE: 1/8"=1'-0"
DB-E720

Jan 23, 2013						DESIGNED BY V. SINGH
						DRAWN BY V. SINGH
						CHECKED BY F. CASABONNE
						IN CHARGE F. CASABONNE
	20130125				DEFINITIVE DESIGN	DATE 20130125
REV	DATE	BY	SUB	APP	DESCRIPTION	

Skanska Shimmick Herzog

1436 California Circle
Milpitas, California 95035
A Joint Venture

SIEMENS Industry, Inc.
Fire Safety Division

SAN FRANCISCO BRANCH
25021 Industrial Boulevard, Suite 500
Hayward, California 94545-1000
Phone: (415) 961-1000 Fax: (415) 961-1001
California State C-10 License No. 768796
U.S. Certificate # No. 324795-01

NOT FOR CONSTRUCTION

VTA BART SILICON VALLEY

BART SILICON VALLEY BERRYESSA EXTENSION

LINE, TRACK, STATIONS AND SYSTEMS
MILPITAS STATION

CONCOURSE LEVEL PLAN
FIRE ALARM SYSTEM
SHEET 5 OF 6

CADD FILENAME
C700-S-DB-E725.dwg


SIZE D SCALE 1/8"=1'-0"

CONTRACT NO. C700 REV.

AREA CODE DB SHEET NO. E725 PAGE NO.

Lookwood, Andrews & Newnam, Inc.
A LEO A DALY COMPANY


T-Y-LIN INTERNATIONAL

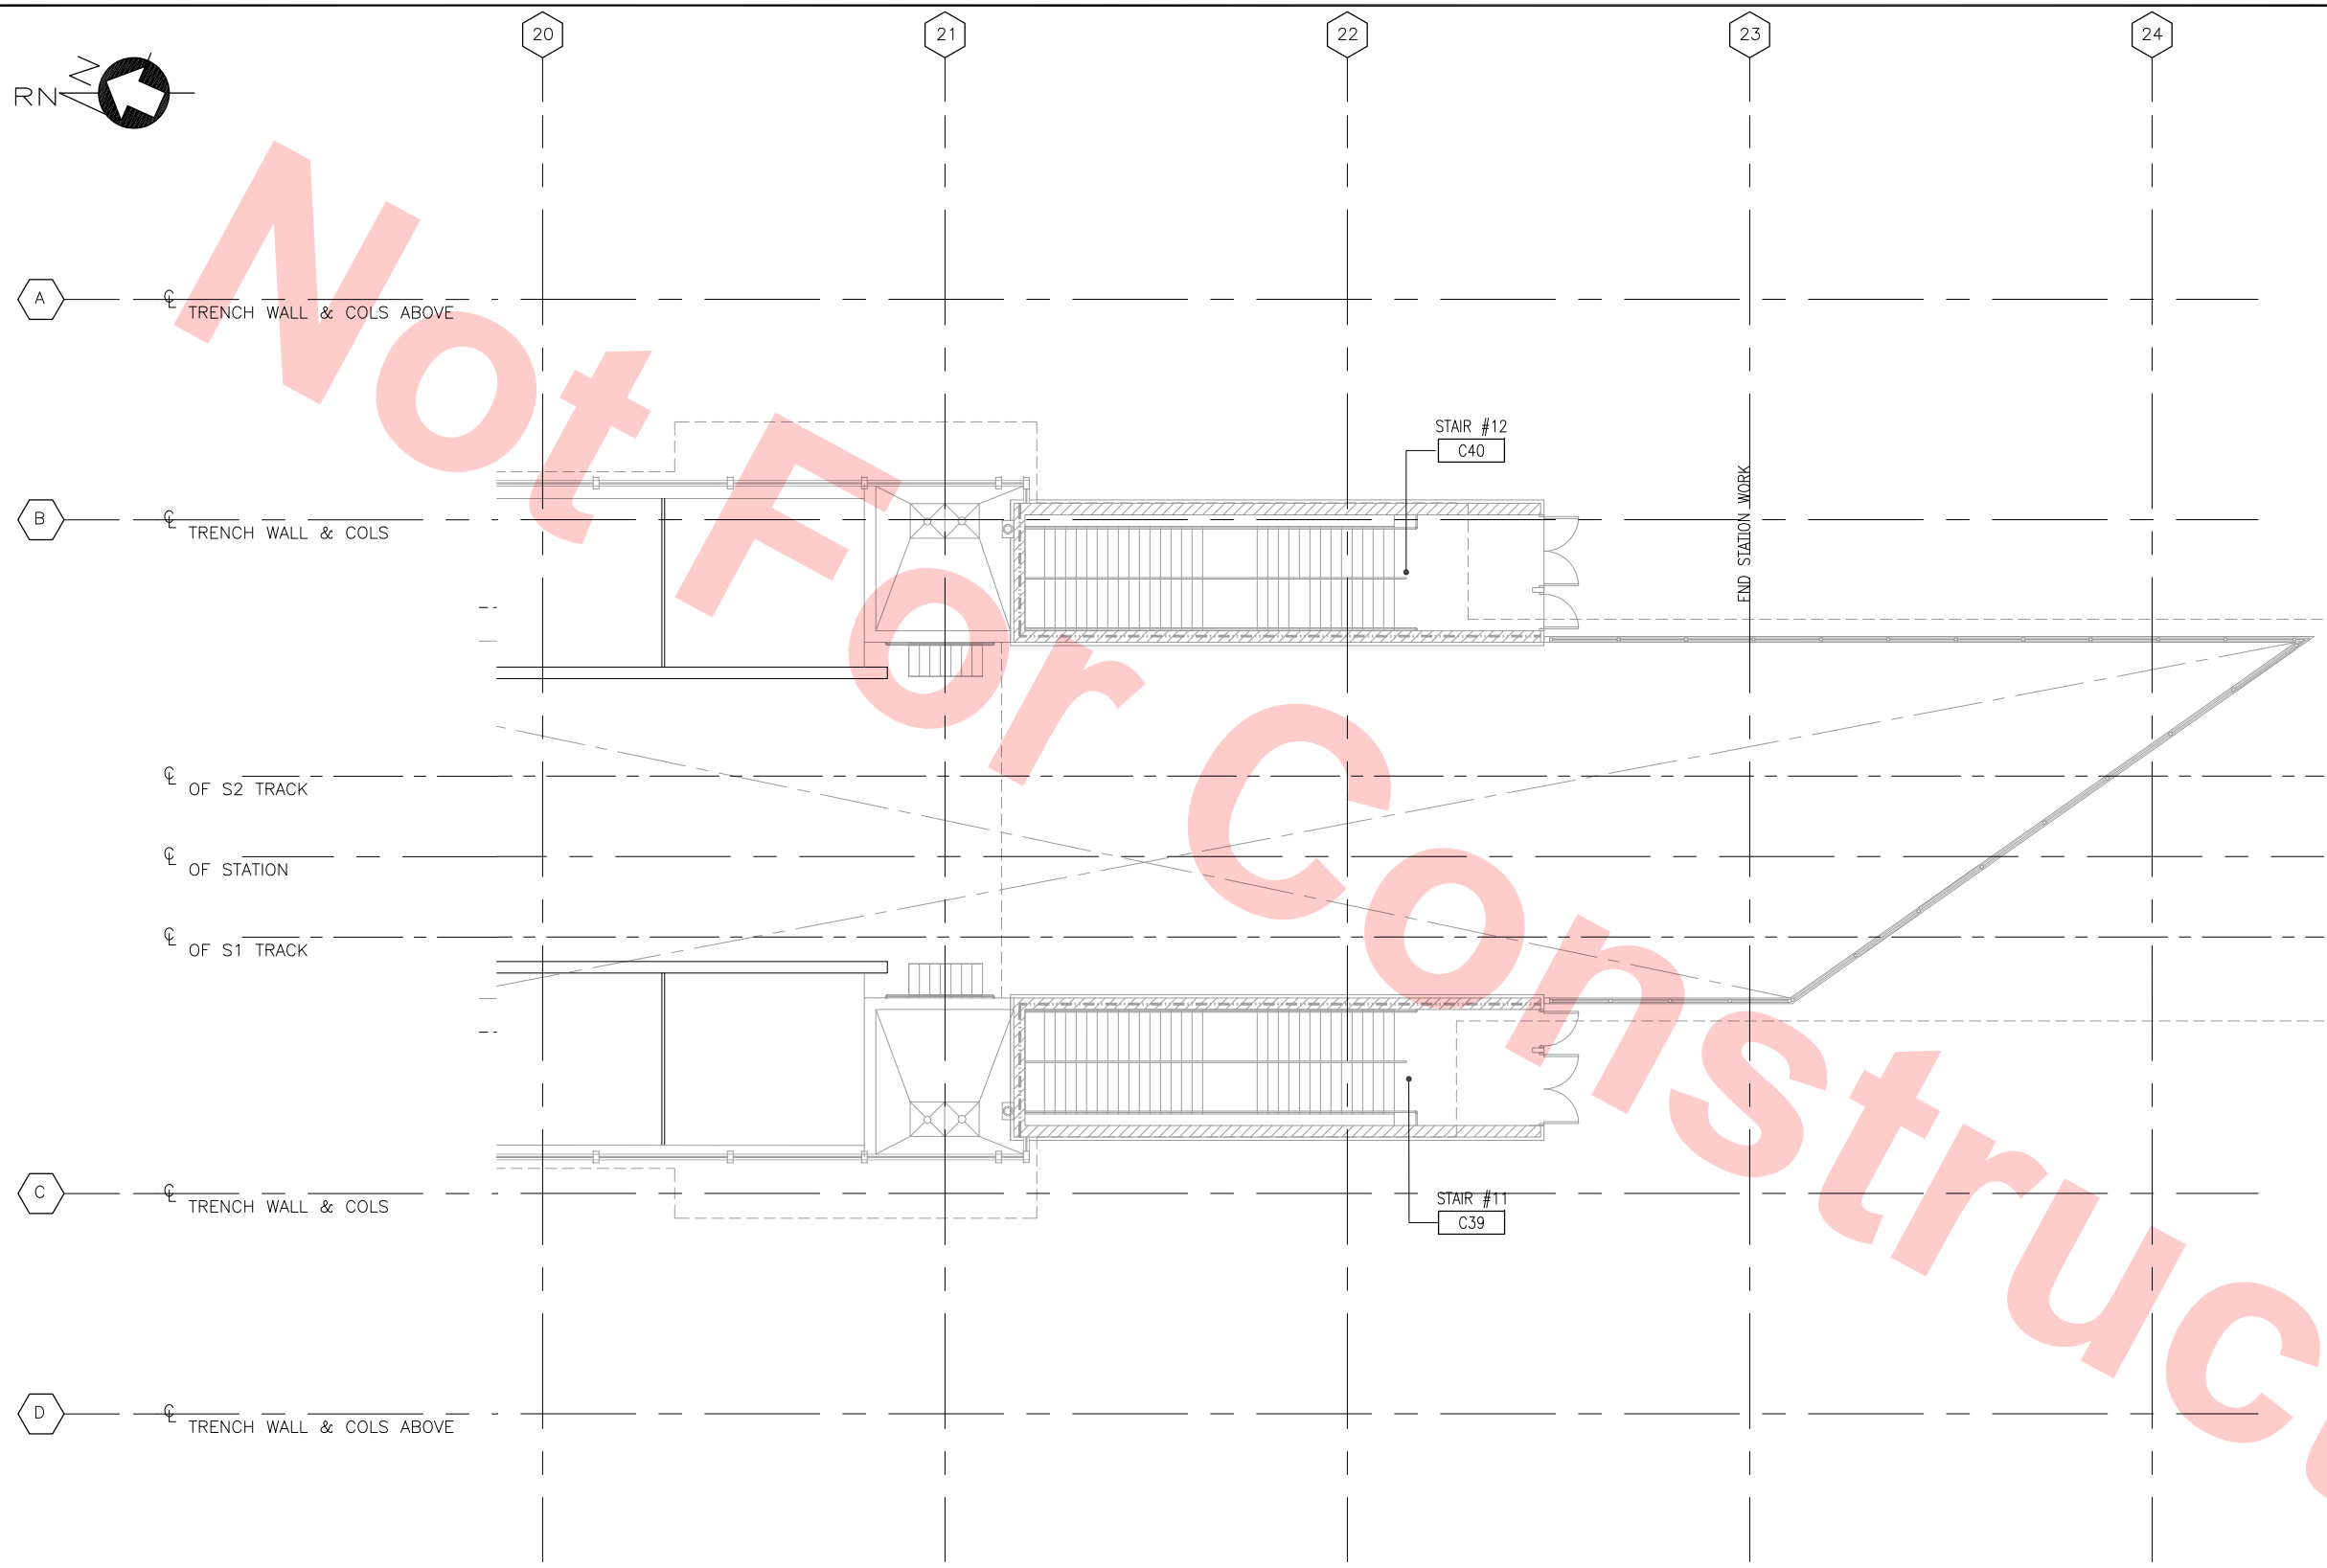


GENERAL NOTES:

1. NO FIRE ALARM SCOPE OF WORK ON THIS SHEET.

CONCOURSE LEVEL PLAN — FIRE ALARM SYSTEM
SCALE: 1/8"=1'-0"
DB-E720

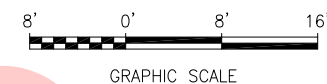


KEY PLAN

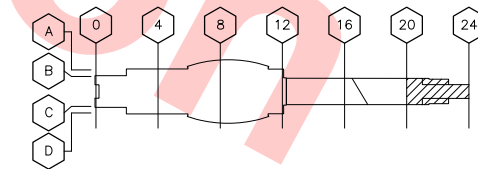[illegible]

Jan 31, 2013 - 10:55am K:\FS\Ops\Engineering\California Projects\VA-Bart\Milpitas Station S40\700-S-DB-E727.dwg
SingHV

DU023-WP08 (Trench Structure) 23 of 40

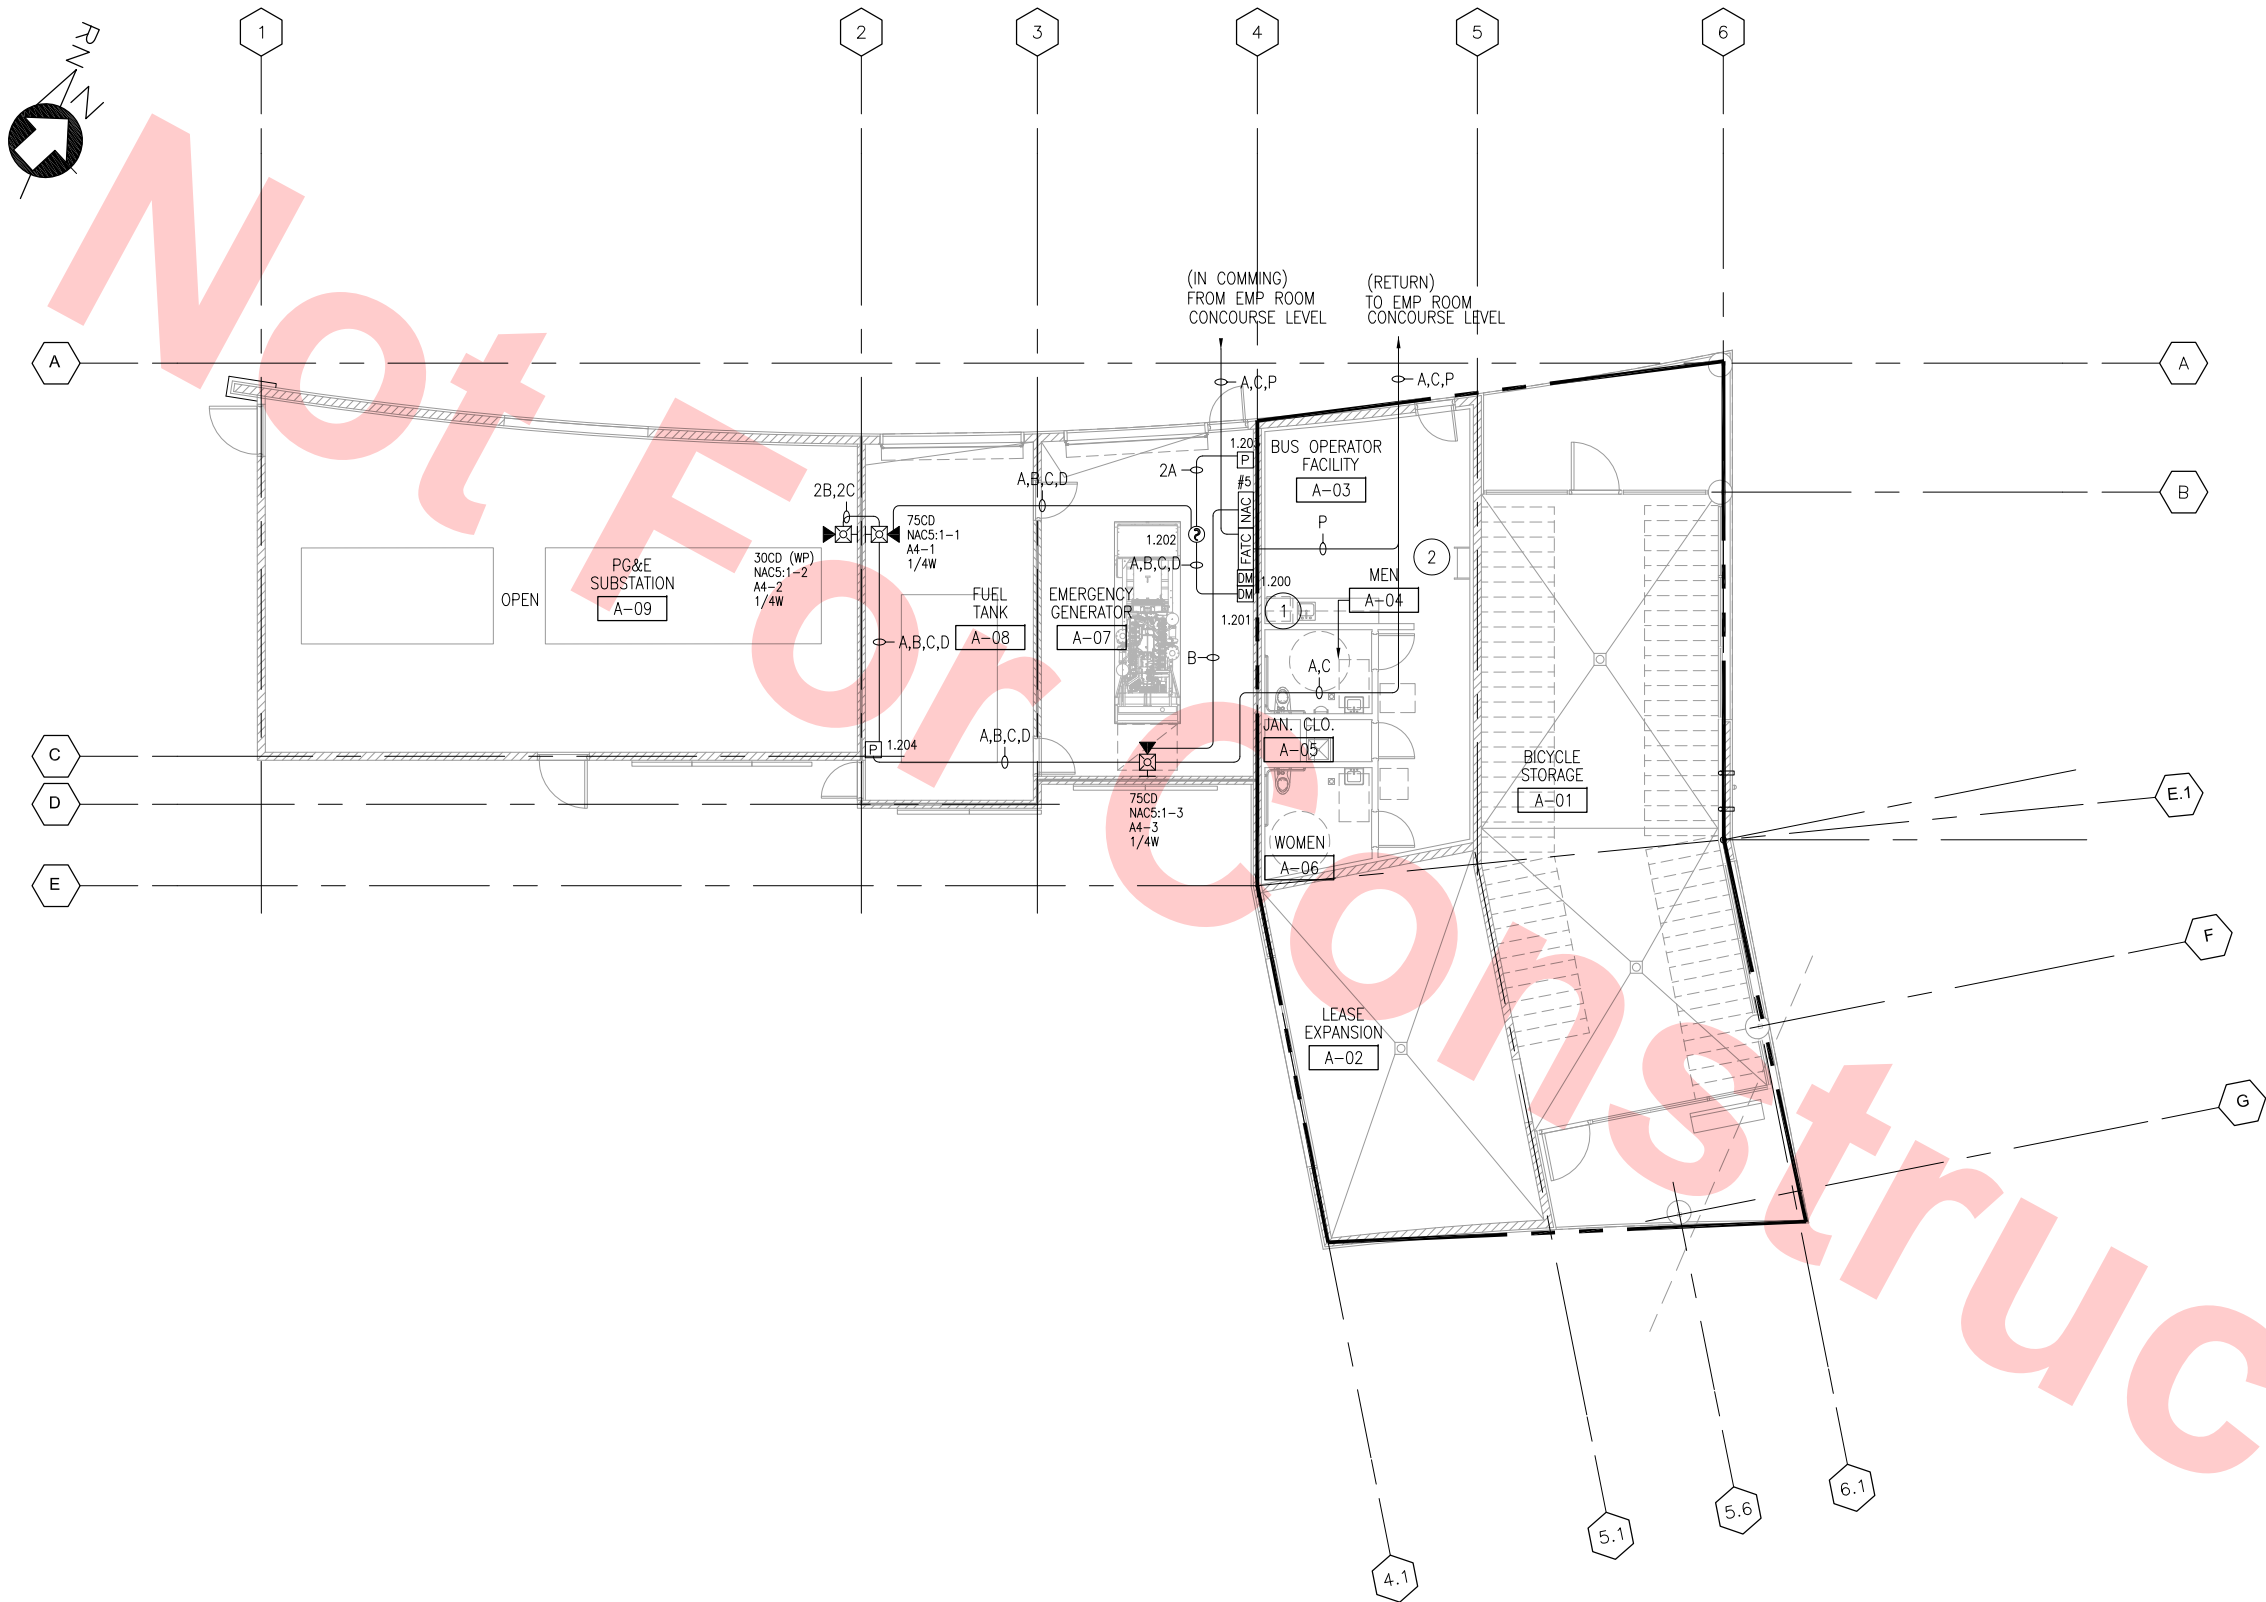

FOR REFERENCE ONLY
AND NOT FOR REVIEW

ANCILLARY BUILDING FLOOR PLAN — FIRE ALARM SYSTEM
SCALE: 1/8"=1'-0"
DB-E720


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SHEET NOTES:


- 1 FIRE ALARM MODULES FOR GENERATOR MONITORING.
- 2 THIS PORTION OF ANCILLARY BUILDING MUST BE SERVED BY EXISTING VTA FIRE ALARM SYSTEM.

GENERAL NOTES:

1. CLASS A AND CLASS X CIRCUITS USING PHYSICAL CONDUCTORS (e.g METALLIC) SHALL BE INSTALLED SUCH THAT THE OUTGOING AND RETURN CONDUCTORS, EXISTING FROM AND RETURNING TO THE CONTROL UNIT RESPECTIVELY, ARE ROUTED SEPARATELY. THE RECOMMENDED MINIMUM SEPARATION TO PREVENT PHYSICAL DAMAGE IS 12 INCHES WHERE CABLE IS INSTALLED VERTICALLY AND 48 INCHES WHERE THE CABLE IS INSTALLED HORIZONTALLY.

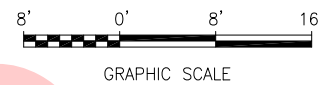

KEY PLAN

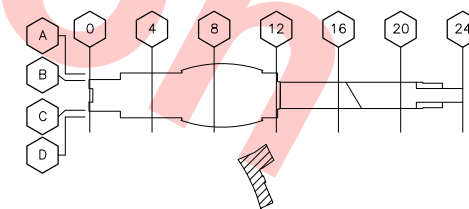

REV	DATE	BY	SUB	APP	DESCRIPTION
20130125					DEFINITIVE DESIGN

DESIGNED BY V. SINGH
DRAWN BY V. SINGH
CHECKED BY F. CASABONNE
IN CHARGE F. CASABONNE
DATE 20130125

Skanska Shimmick Herzog 1436 California Circle Milpitas, California 95035 A Joint Venture
SIEMENS Industry, Inc. Fire Safety Division
Lookwood, Andrews & Newnam, Inc. A LEOPOLD COMPANY
T-Y-LIN INTERNATIONAL


NOT FOR
CONSTRUCTION



LINE, TRACK, STATIONS AND SYSTEMS
MILPITAS STATION

ANCILLARY BUILDING
FIRE ALARM SYSTEM

CADD FILENAME C700-S-DB-E727.dwg		
SIZE D	SCALE 1/8"=1'-0"	
CONTRACT NO. C700		REV.
AREA CODE DB	SHEET NO. E727	PAGE N

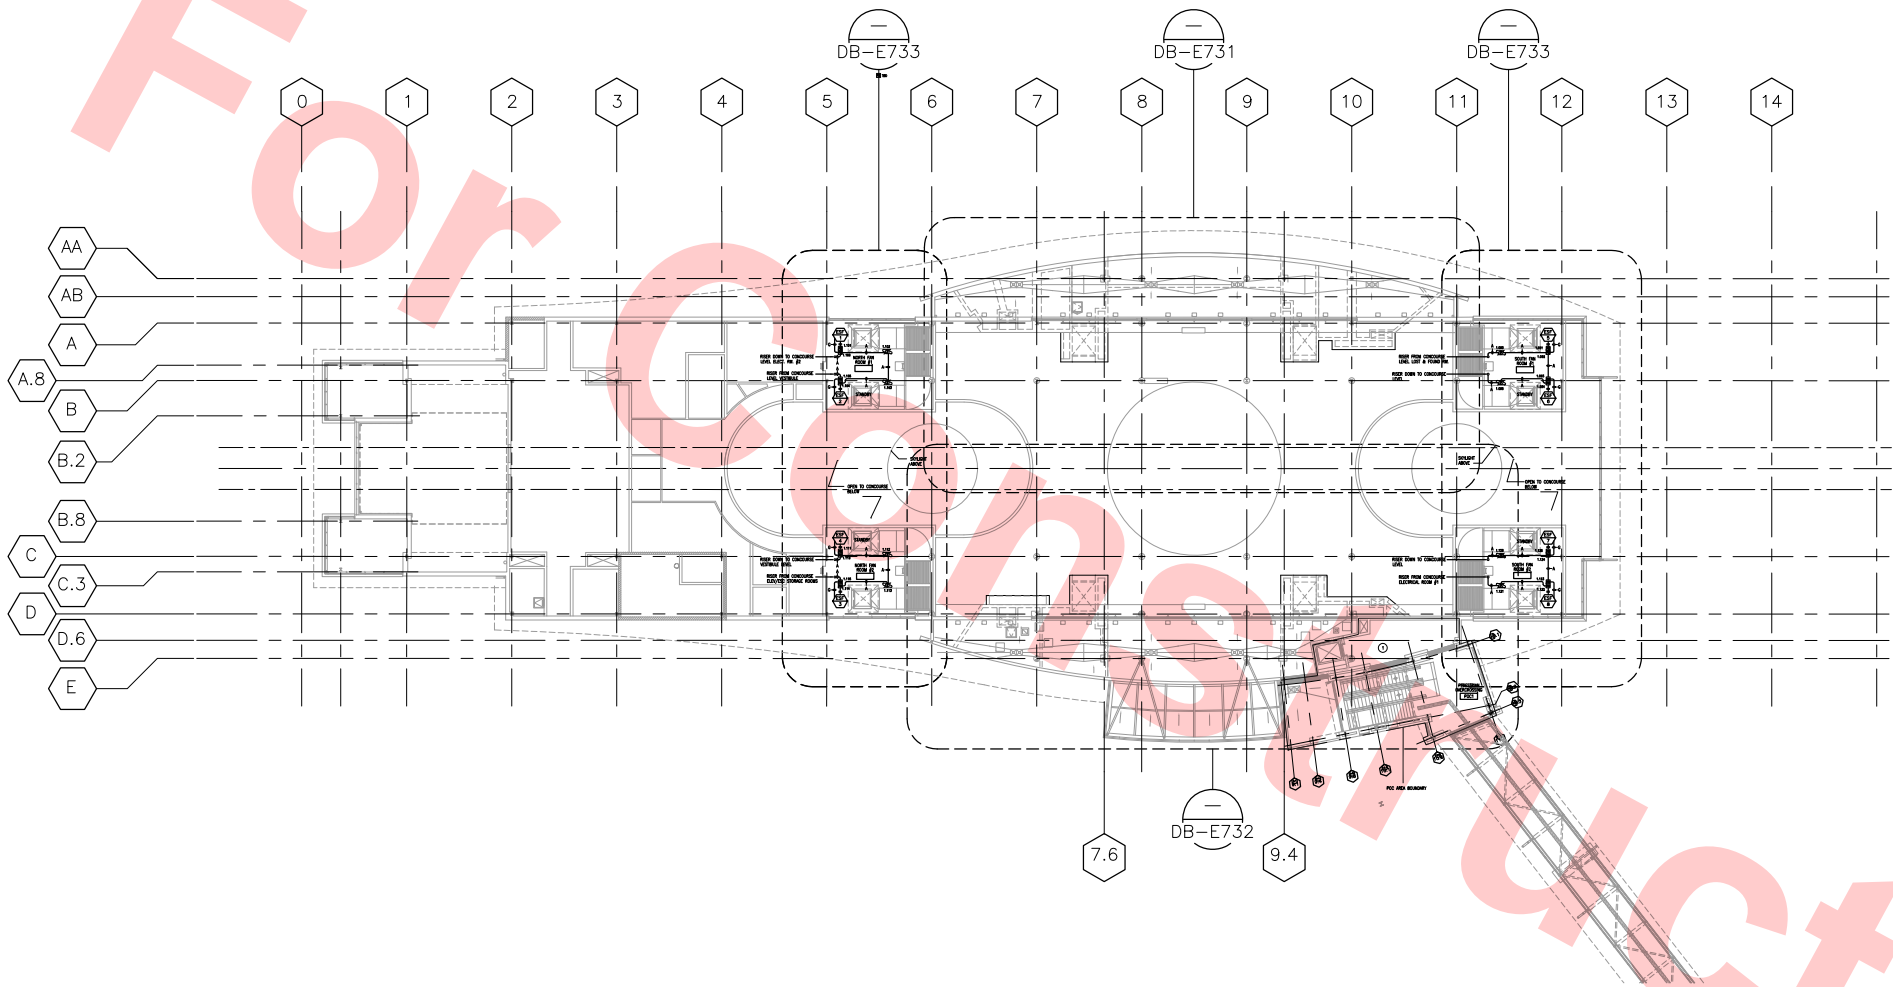


KEY PLAN LOWER ROOF AND MEZZANINE LEVEL — FIRE ALARM SYSTEM
SCALE: 1/32"=1'-0"




FOR REFERENCE ONLY
AND NOT FOR REVIEW

Singh V Jan 23, 2013							DESIGNED BY V. SINGH	<div>Skanska Shimmick Herzog</div> <div>1436 California Circle Milpitas, California 95035 A Joint Venture</div>	<div>NOT FOR CONSTRUCTION</div>	<div> BART SILICON VALLEY BERRYESSA EXTENSION</div>	LINE, TRACK, STATIONS AND SYSTEMS MILPITAS STATION				CADD FILENAME C700-S-DB-E730.dwg		
						DRAWN BY V. SINGH	SIZE D				SCALE 1/32"=1'-0"	CONTRACT NO. C700	REV.				
						CHECKED BY F. CASABONNE											
						IN CHARGE F. CASABONNE											
		20130125				DEFINITIVE DESIGN	DATE 20130125				SIEMENS Industry, Inc. Fire Safety Division				KEY PLAN LOWER ROOF AND MEZZANINE LEVEL FIRE ALARM SYSTEM		AREA CODE DB
REV	DATE	BY	SUB	APP	DESCRIPTION												

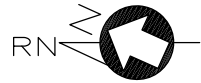

KEY NOTES

- GENERAL NOTES:
1. NO FIRE ALARM SCOPE OF WORK ON THIS SHEET.

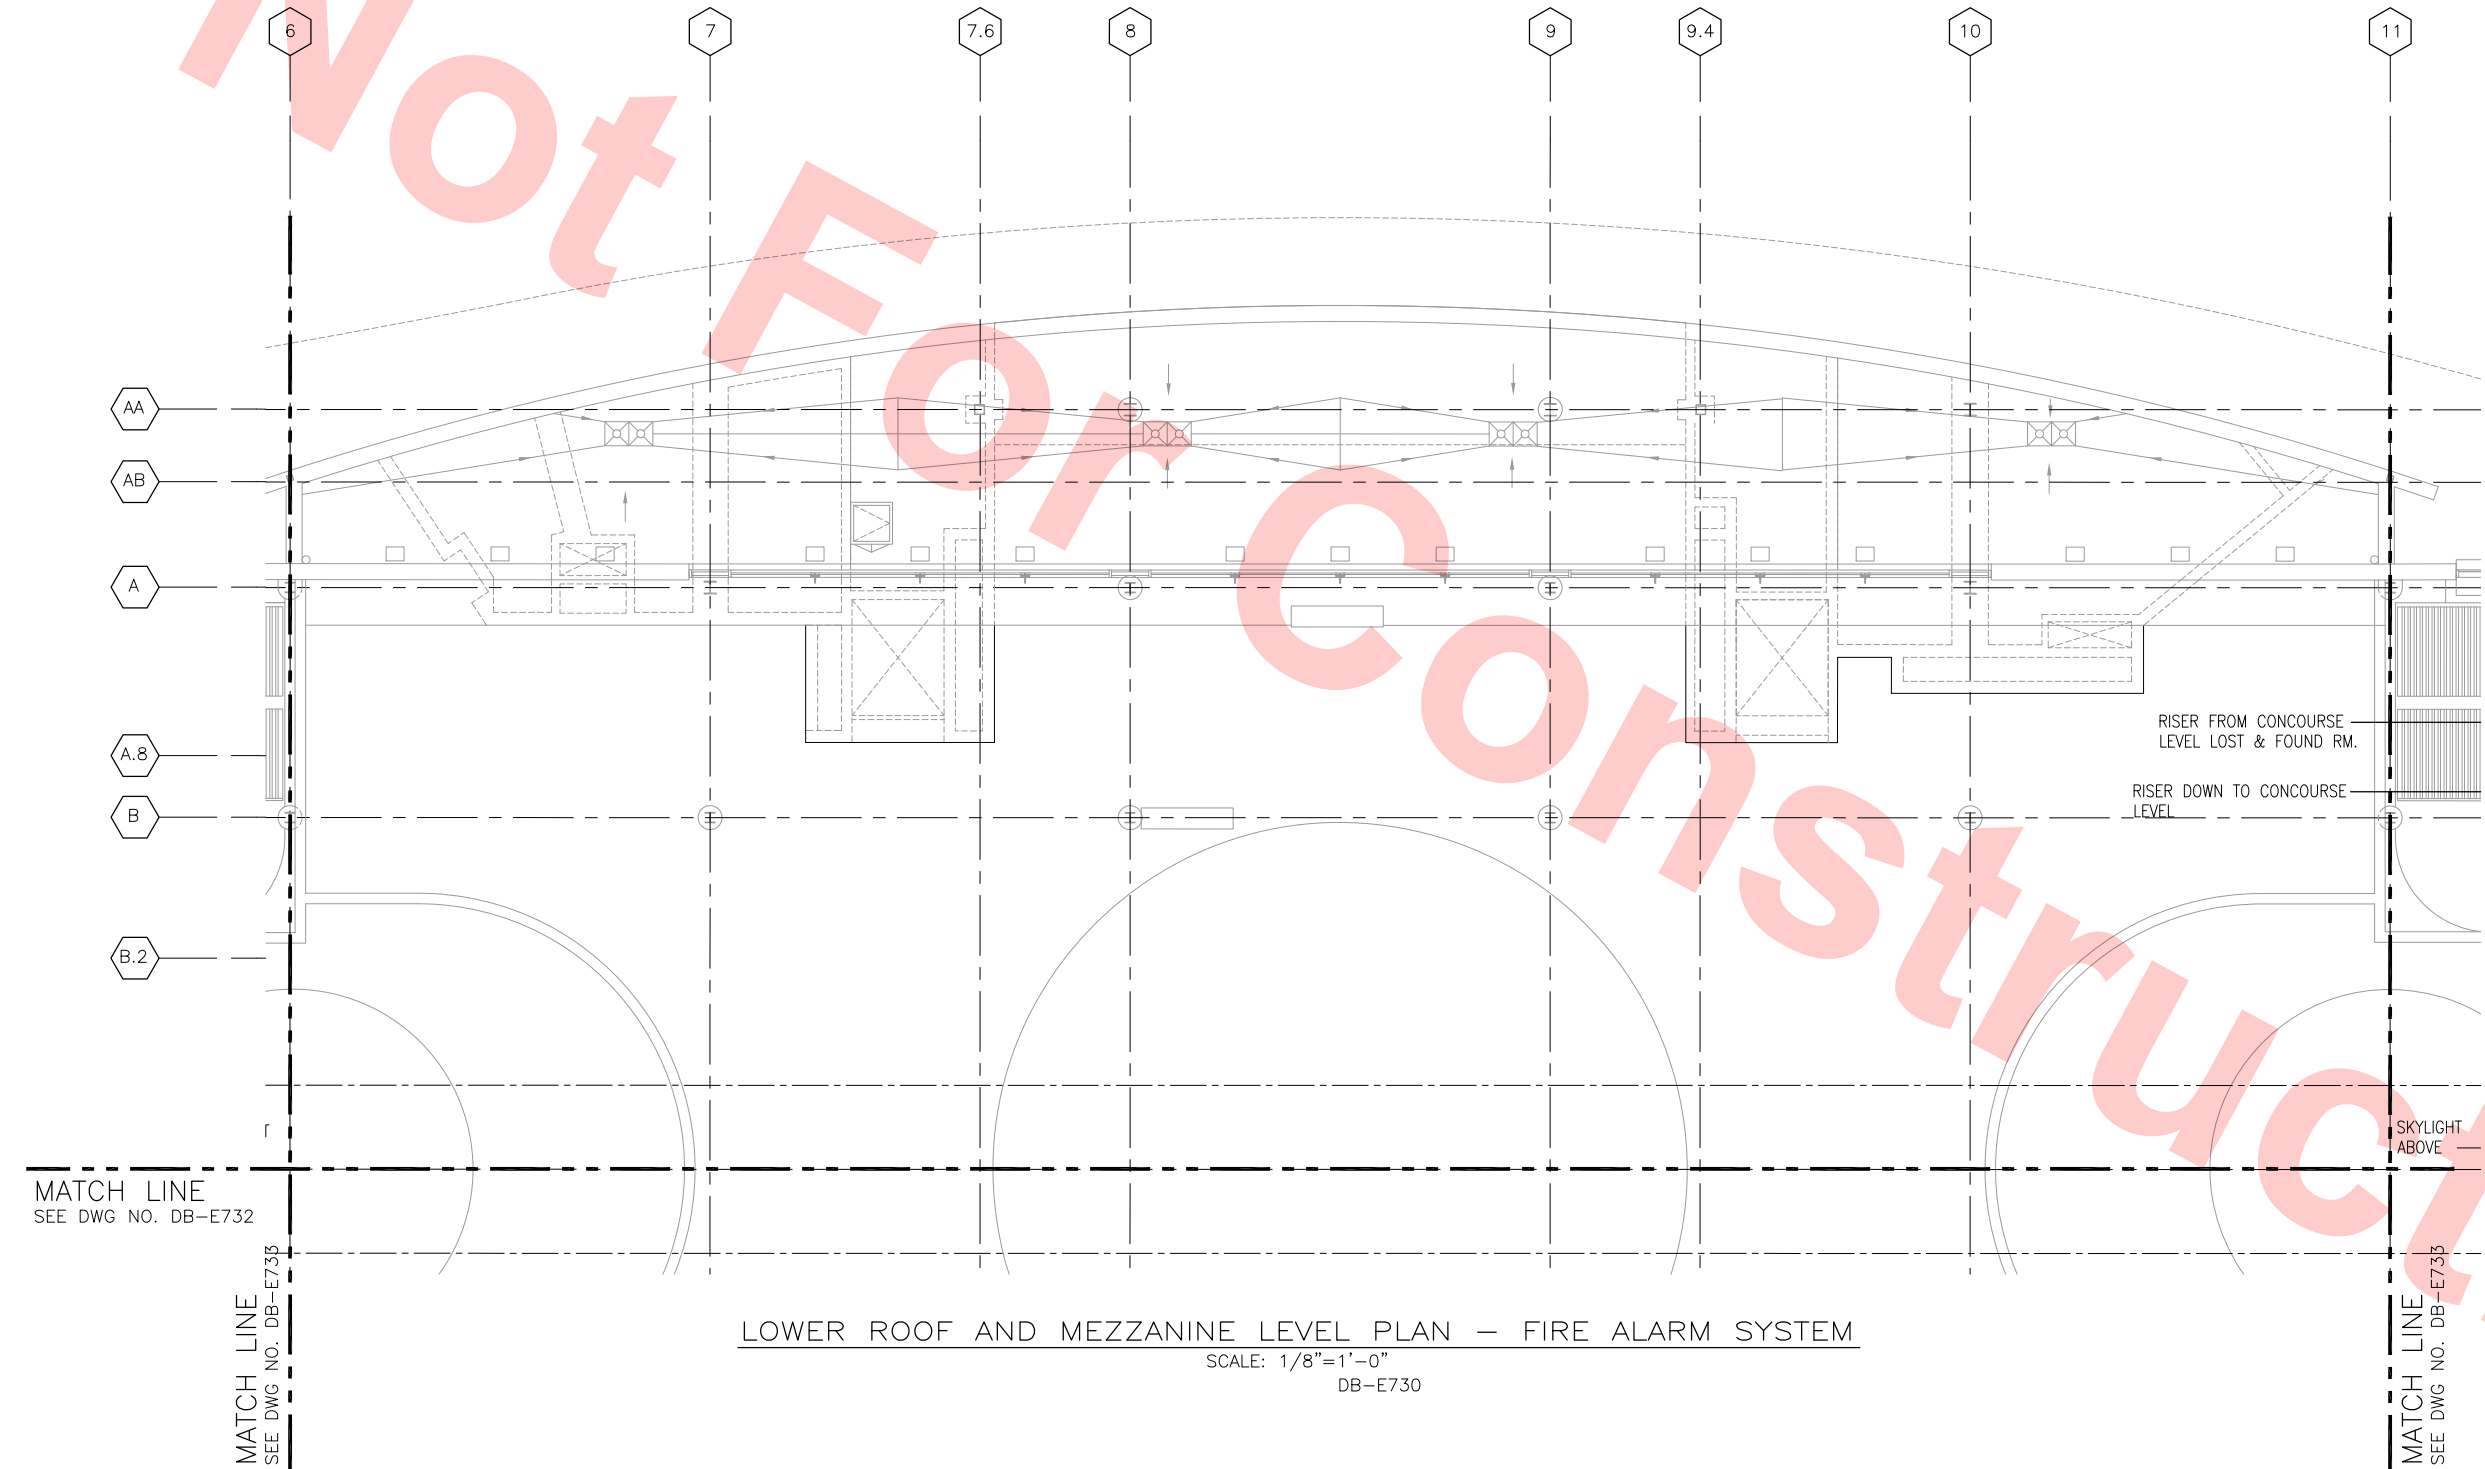


MATCH LINE
SEE DWG NO. DB-E732


MATCH LINE
SEE DWG NO. DB-E733

LOWER ROOF AND MEZZANINE LEVEL PLAN — FIRE ALARM SYSTEM
SCALE: 1/8"=1'-0"
DB-E730

FOR REFERENCE ONLY
AND NOT FOR REVIEW

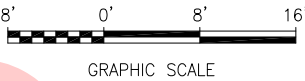

KEY PLAN

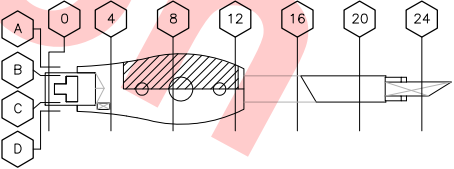

DESIGNED BY V. SINGH
DRAWN BY V. SINGH
CHECKED BY F. CASABONNE
IN CHARGE F. CASABONNE
DATE 20130125

20130125					DEFINITIVE SUBMITTAL
REV	DATE	BY	SUB	APP	DESCRIPTION

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Shimmick
Herzog**

1436 California Circle
Milpitas, California 95035
A Joint Venture

SIEMENS Industry, Inc.
Fire Safety Division

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Lookwood, Andrews
& Newnam, Inc.
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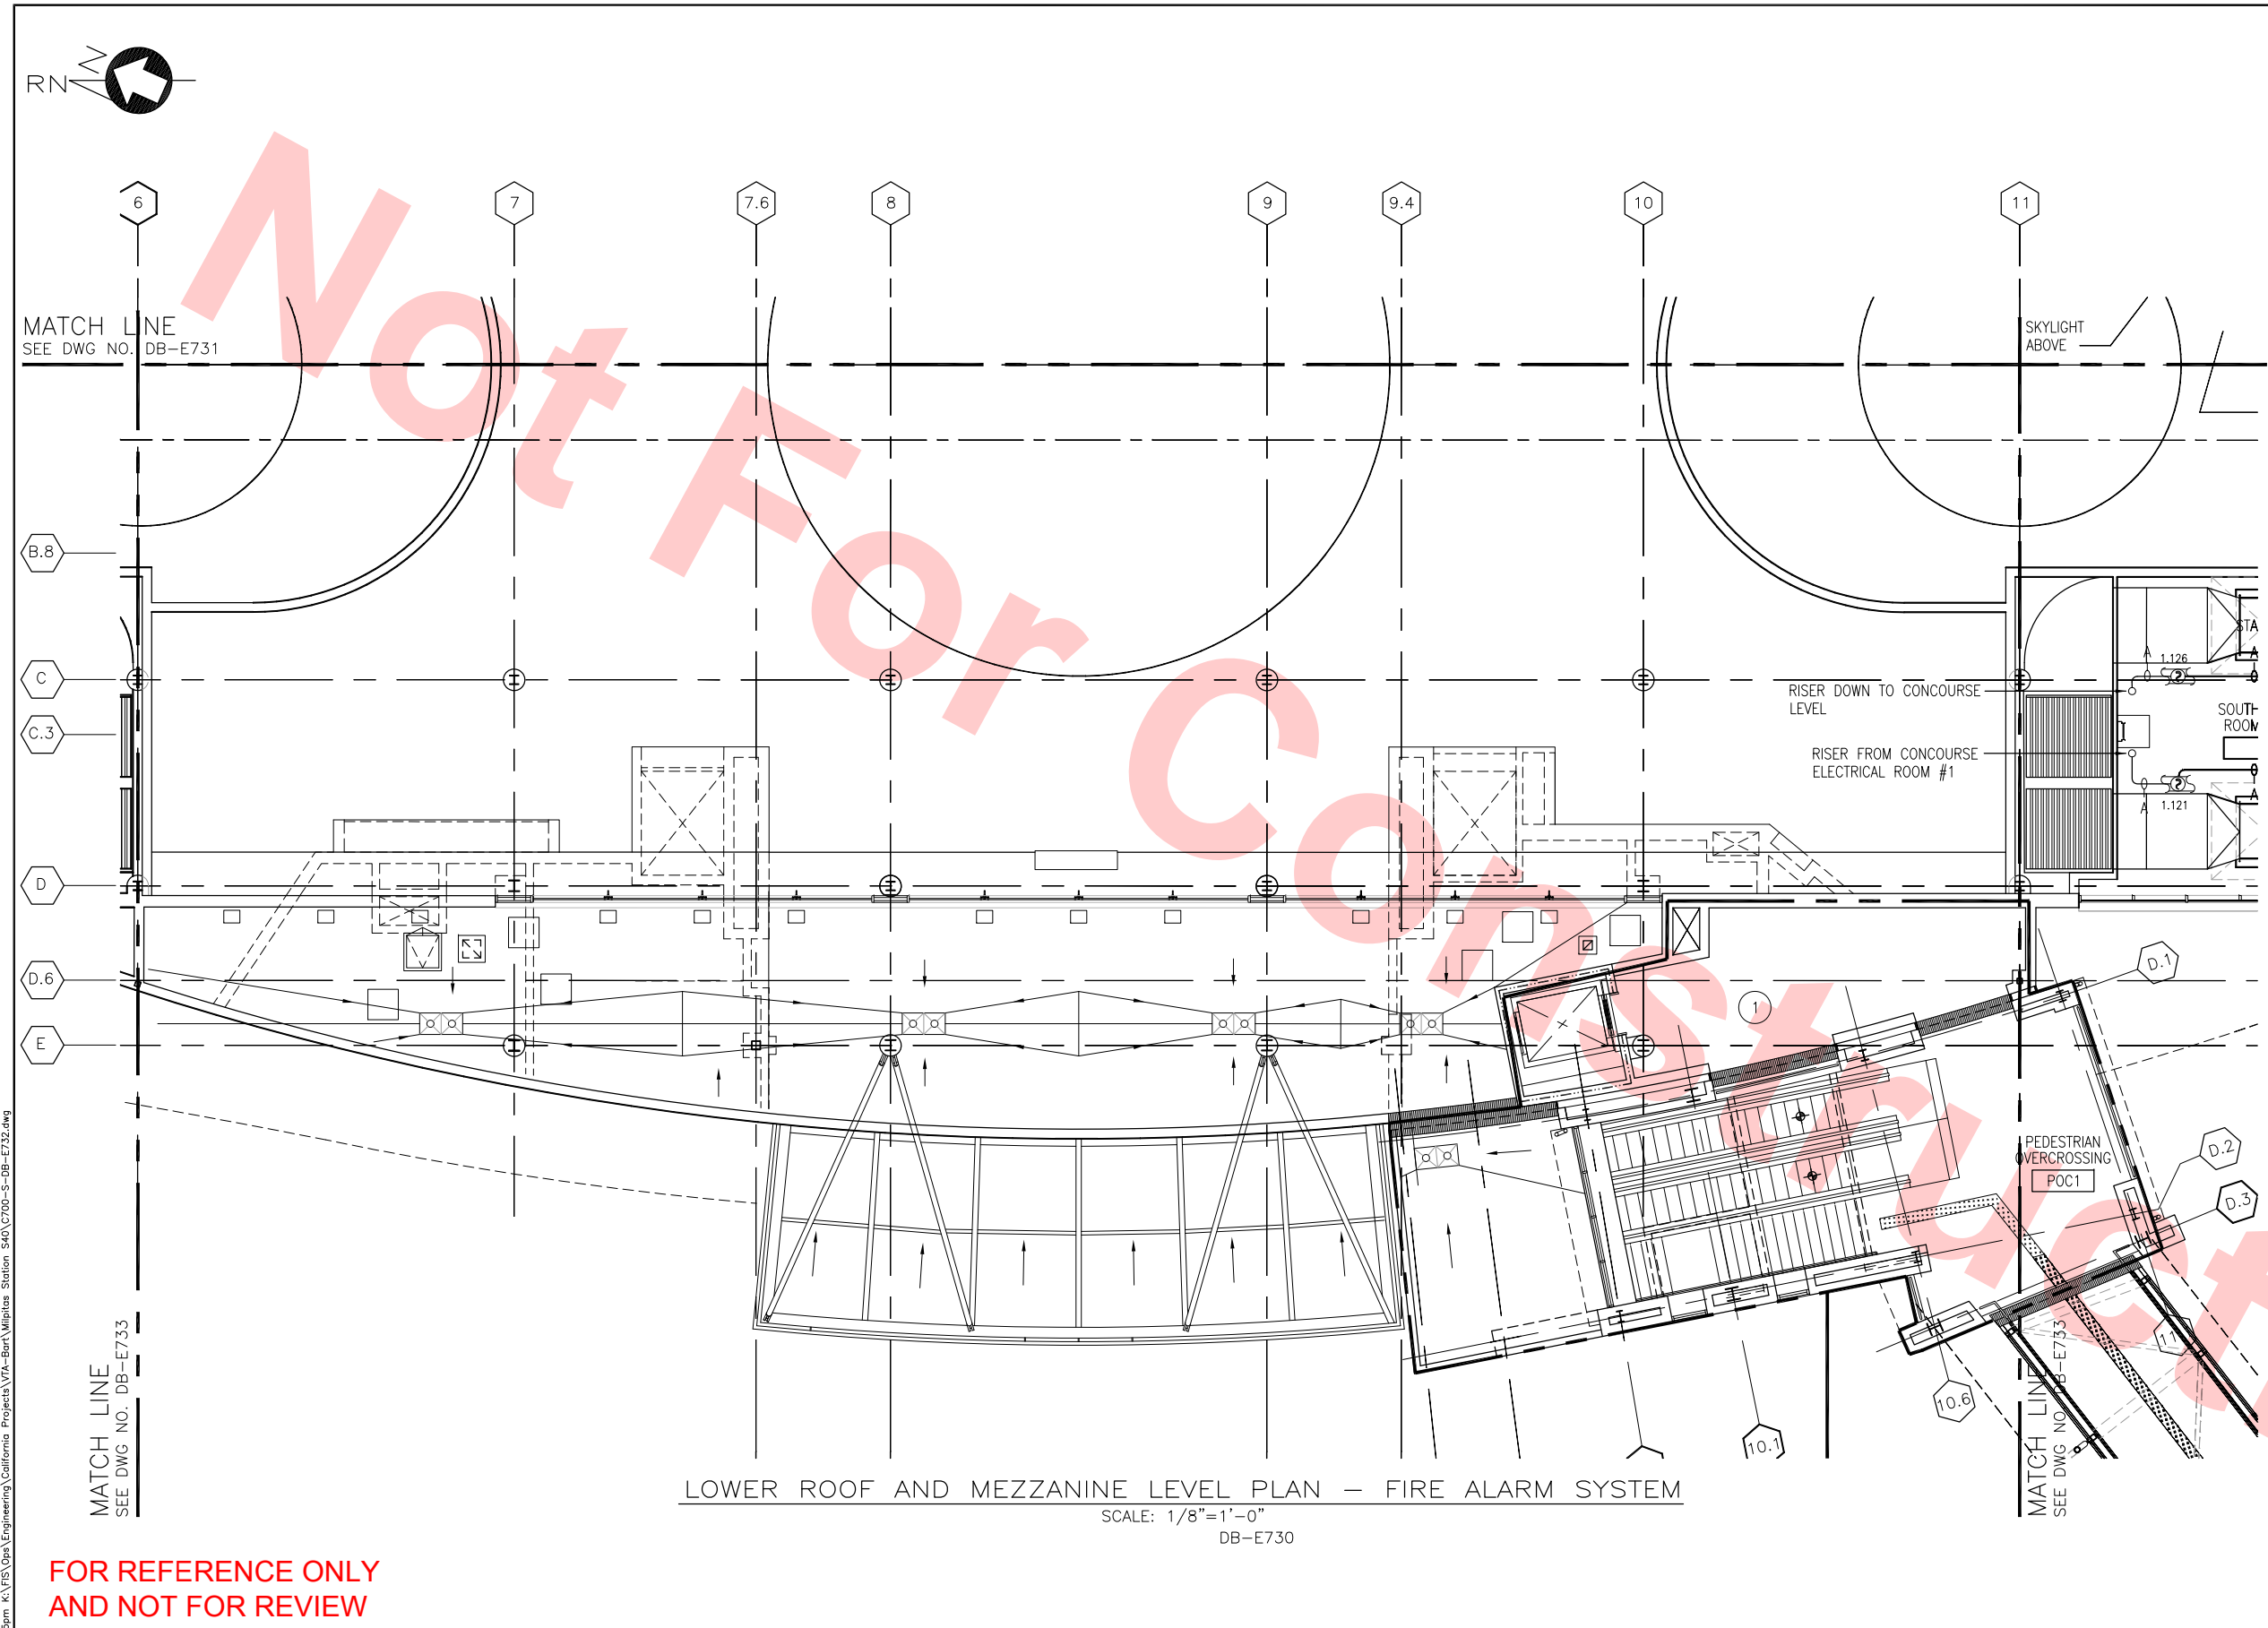
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CONSTRUCTION

BART SILICON VALLEY BERRYESSA EXTENSION

LINE, TRACK, STATIONS AND SYSTEMS
MILPITAS STATION

LOWER ROOF AND MEZZANINE LEVEL PLAN
FIRE ALARM SYSTEM
SHEET 1 OF 3

CADD FILENAME C700-S-DB-E731.dwg		
SIZE D	SCALE 1/8"=1'-0"	
CONTRACT NO. C700		REV.
AREA CODE DB	SHEET NO. E731	PAGE NO.



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DRAWN BY V. SINGH				
CHECKED BY F. CASABONNE				
IN CHARGE F. CASABONNE				
DATE 20130125				
20130125				DEFINITIVE DESIGN
REV	DATE	BY	SUB	APP

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**Skanska
Shimmick
Herzog**
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CALIFORNIA STATE C-15 LICENSE NO. 725706
U.S. Certificate ID No. 324785-001

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& Newnam, Inc.**
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**BART
VTA SILICON VALLEY**
BART SILICON VALLEY BERRYESSA EXTENSION


**LINE, TRACK, STATIONS AND SYSTEMS
MILPITAS STATION**

LOWER ROOF AND MEZZANINE LEVEL PLAN
FIRE ALARM SYSTEM
SHEET 2 OF 3


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AREA CODE DB	SHEET NO. E732	PAGE NO.

KEY NOTES



- SHEET NOTES:
- THIS AREA WILL BE SERVED BY THE EXISTING VTA FIRE ALARM SYSTEM. THIS INCLUDES THE ESCALATOR CONTROL, POC ELEVATOR CONTROL, DETECTION & NOTIFICATION.

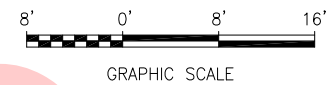

KEY PLAN

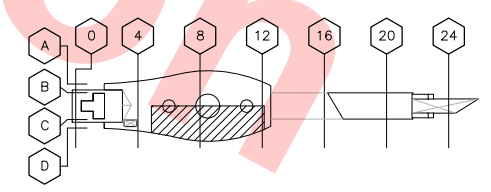

Jan 23, 2013 - 5:55pm K:\FS (ops)\Engineering\California Projects\VTA-Bart\Milpitas Station S40\C700-S-DB-E732.dwg
SinghV

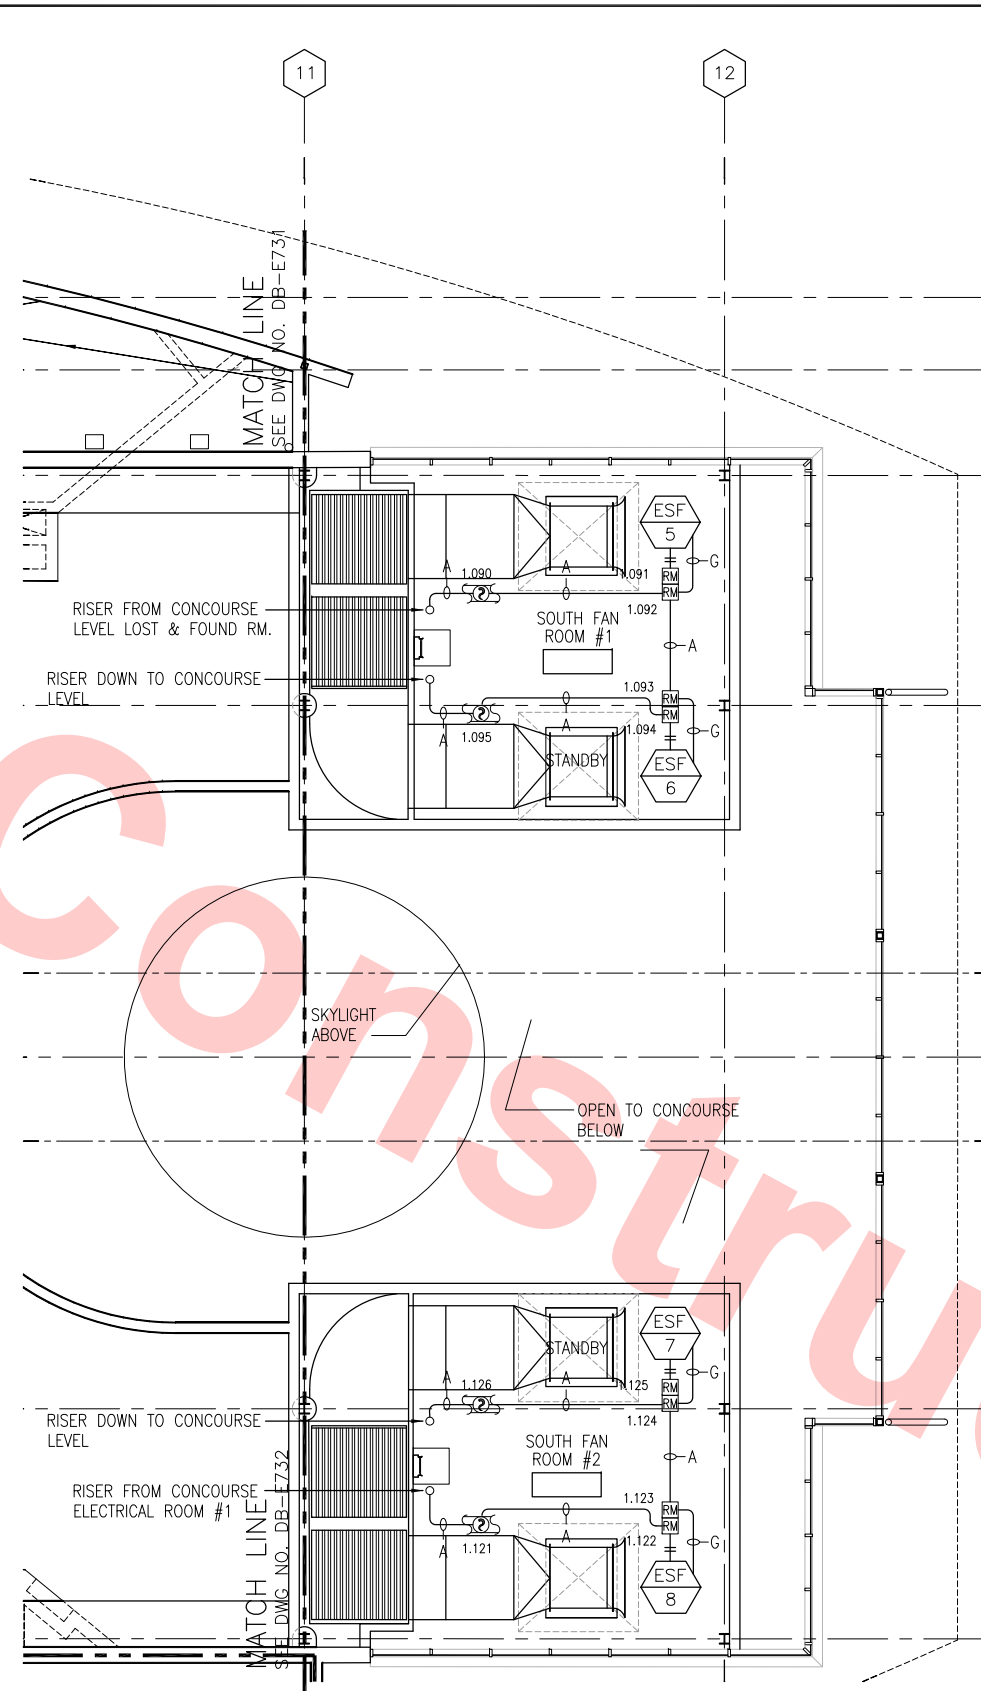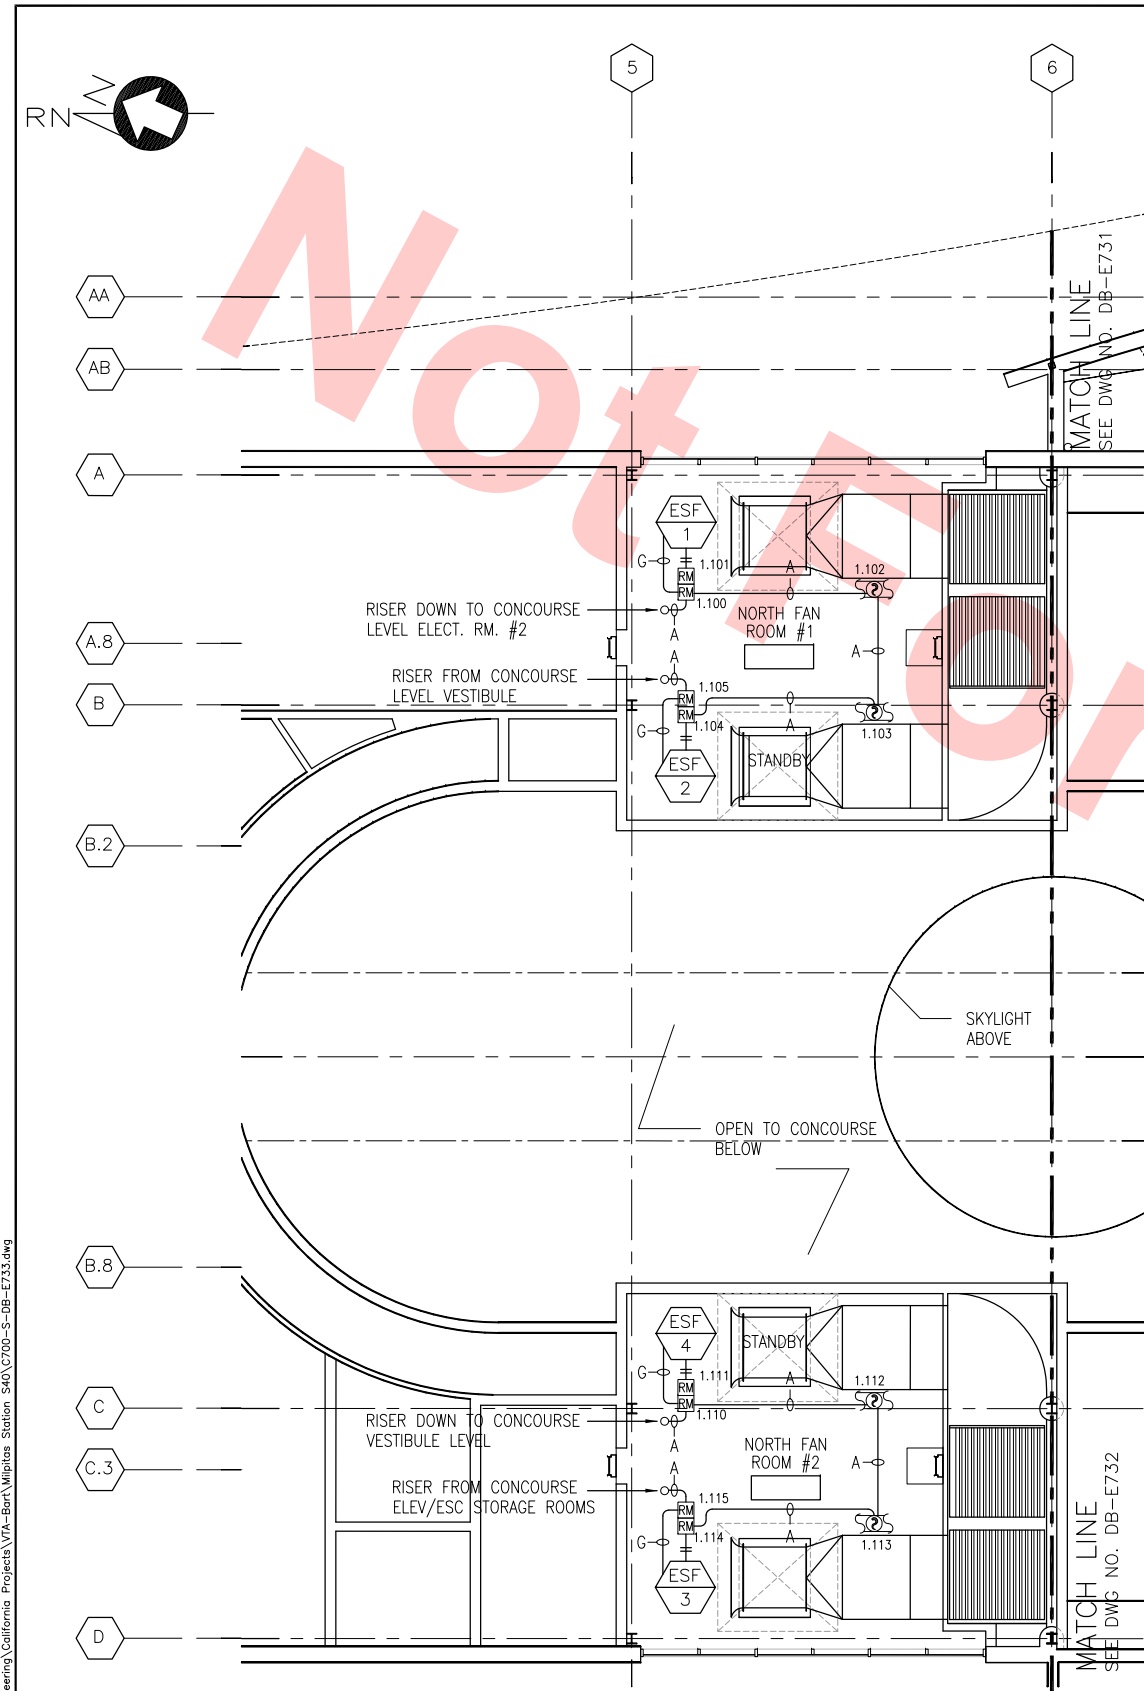

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IN CHARGE F. CASABONNE				
DATE 20130125				
REV	DATE	BY	SUB	APP
20130125				
DEFINITIVE DESIGN				
DESCRIPTION				

LOWER ROOF AND MEZZANINE LEVEL PLAN – FIRE ALARM SYSTEM
SCALE: 1/8"=1'-0"
DB-E730

**Skanska
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Herzog**
SAN FRANCISCO, CA 94104
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U.S. Certificate ID No. 324787-001

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**BART
SILICON VALLEY**
BART SILICON VALLEY BERRYESSA EXTENSION

LINE, TRACK, STATIONS AND SYSTEMS
MILPITAS STATION

LOWER ROOF AND MEZZANINE LEVEL PLAN
FIRE ALARM SYSTEM
SHEET 3 OF 3

NOTE



SHEET NOTES:

1 FIRE ALARM MODULES FOR MONITORING AND CONTROLLING STAIR PRESSURIZATION FANS.

GRAPHIC SCALE

KEY PLAN

Jan 23, 2013 - 5:56pm K:\VFS\pos\Engineering\California Projects\Bart\Bart-Milpitas Station S40\C700-S-DB-E733.dwg
Singh

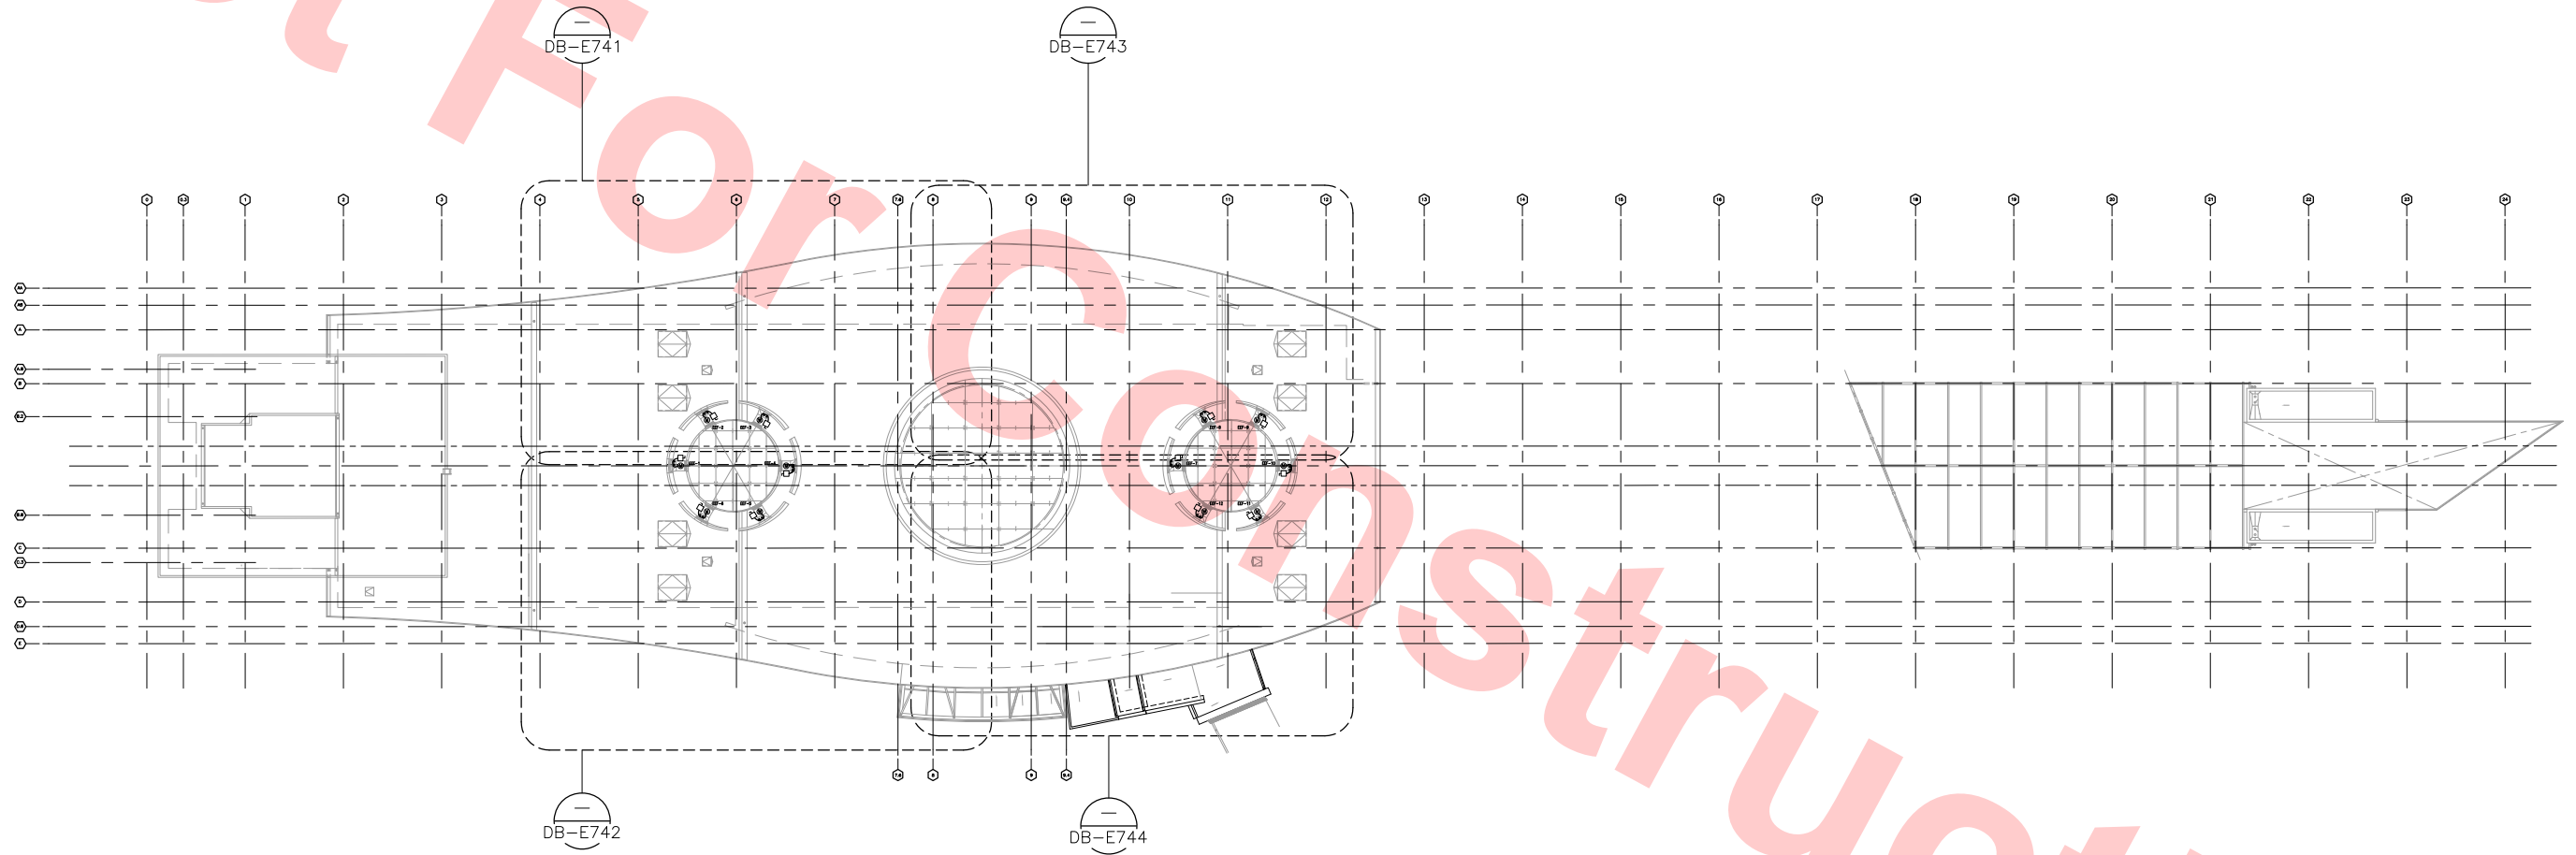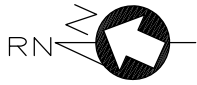

KEY PLAN ROOF LEVEL — FIRE ALARM SYSTEM
SCALE: 1/32"=1'-0"

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AND NOT FOR REVIEW



Jan 23, 2013 5:59pm K:\FS\Engineering\California Projects\Bart\Bart-Milpitas Station\40\C700-S-DB-E740.dwg
Singh

Jun 23, 2013 SinghV						DESIGNED BY V. SINGH
						DRAWN BY V. SINGH
						CHECKED BY F. CASABONNE
						IN CHARGE F. CASABONNE
						DATE 20130125
	REV	DATE	BY	SUB	APP	DEFINITIVE DESIGN
						DESCRIPTION

SIEMENS Industry, Inc.
Fire Safety Division
SUBMITTED

Skanska Shimmick Herzog
20000 Industrial Boulevard, Suite 200 Hayward, California 94542-2000 Tel: (510) 785-4000 Fax: (510) 785-2100 California State EIT License No. 705706 U.S. Certificate ID No. 324795-001
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BART SILICON VALLEY BERRYESSA EXTENSION

LINE, TRACK, STATIONS AND SYSTEMS MILPITAS STATION
KEY PLAN ROOF LEVEL FIRE ALARM SYSTEM


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SIZE D	SCALE 1/32"=1'-0"	
CONTRACT NO. C700		REV.
AREA CODE DB	SHEET NO. E740	PAGE NO.




KEY NOTES

SHEET NOTES:


- 1 NO FIRE ALARM SCOPE OF WORK ON THIS SHEET.

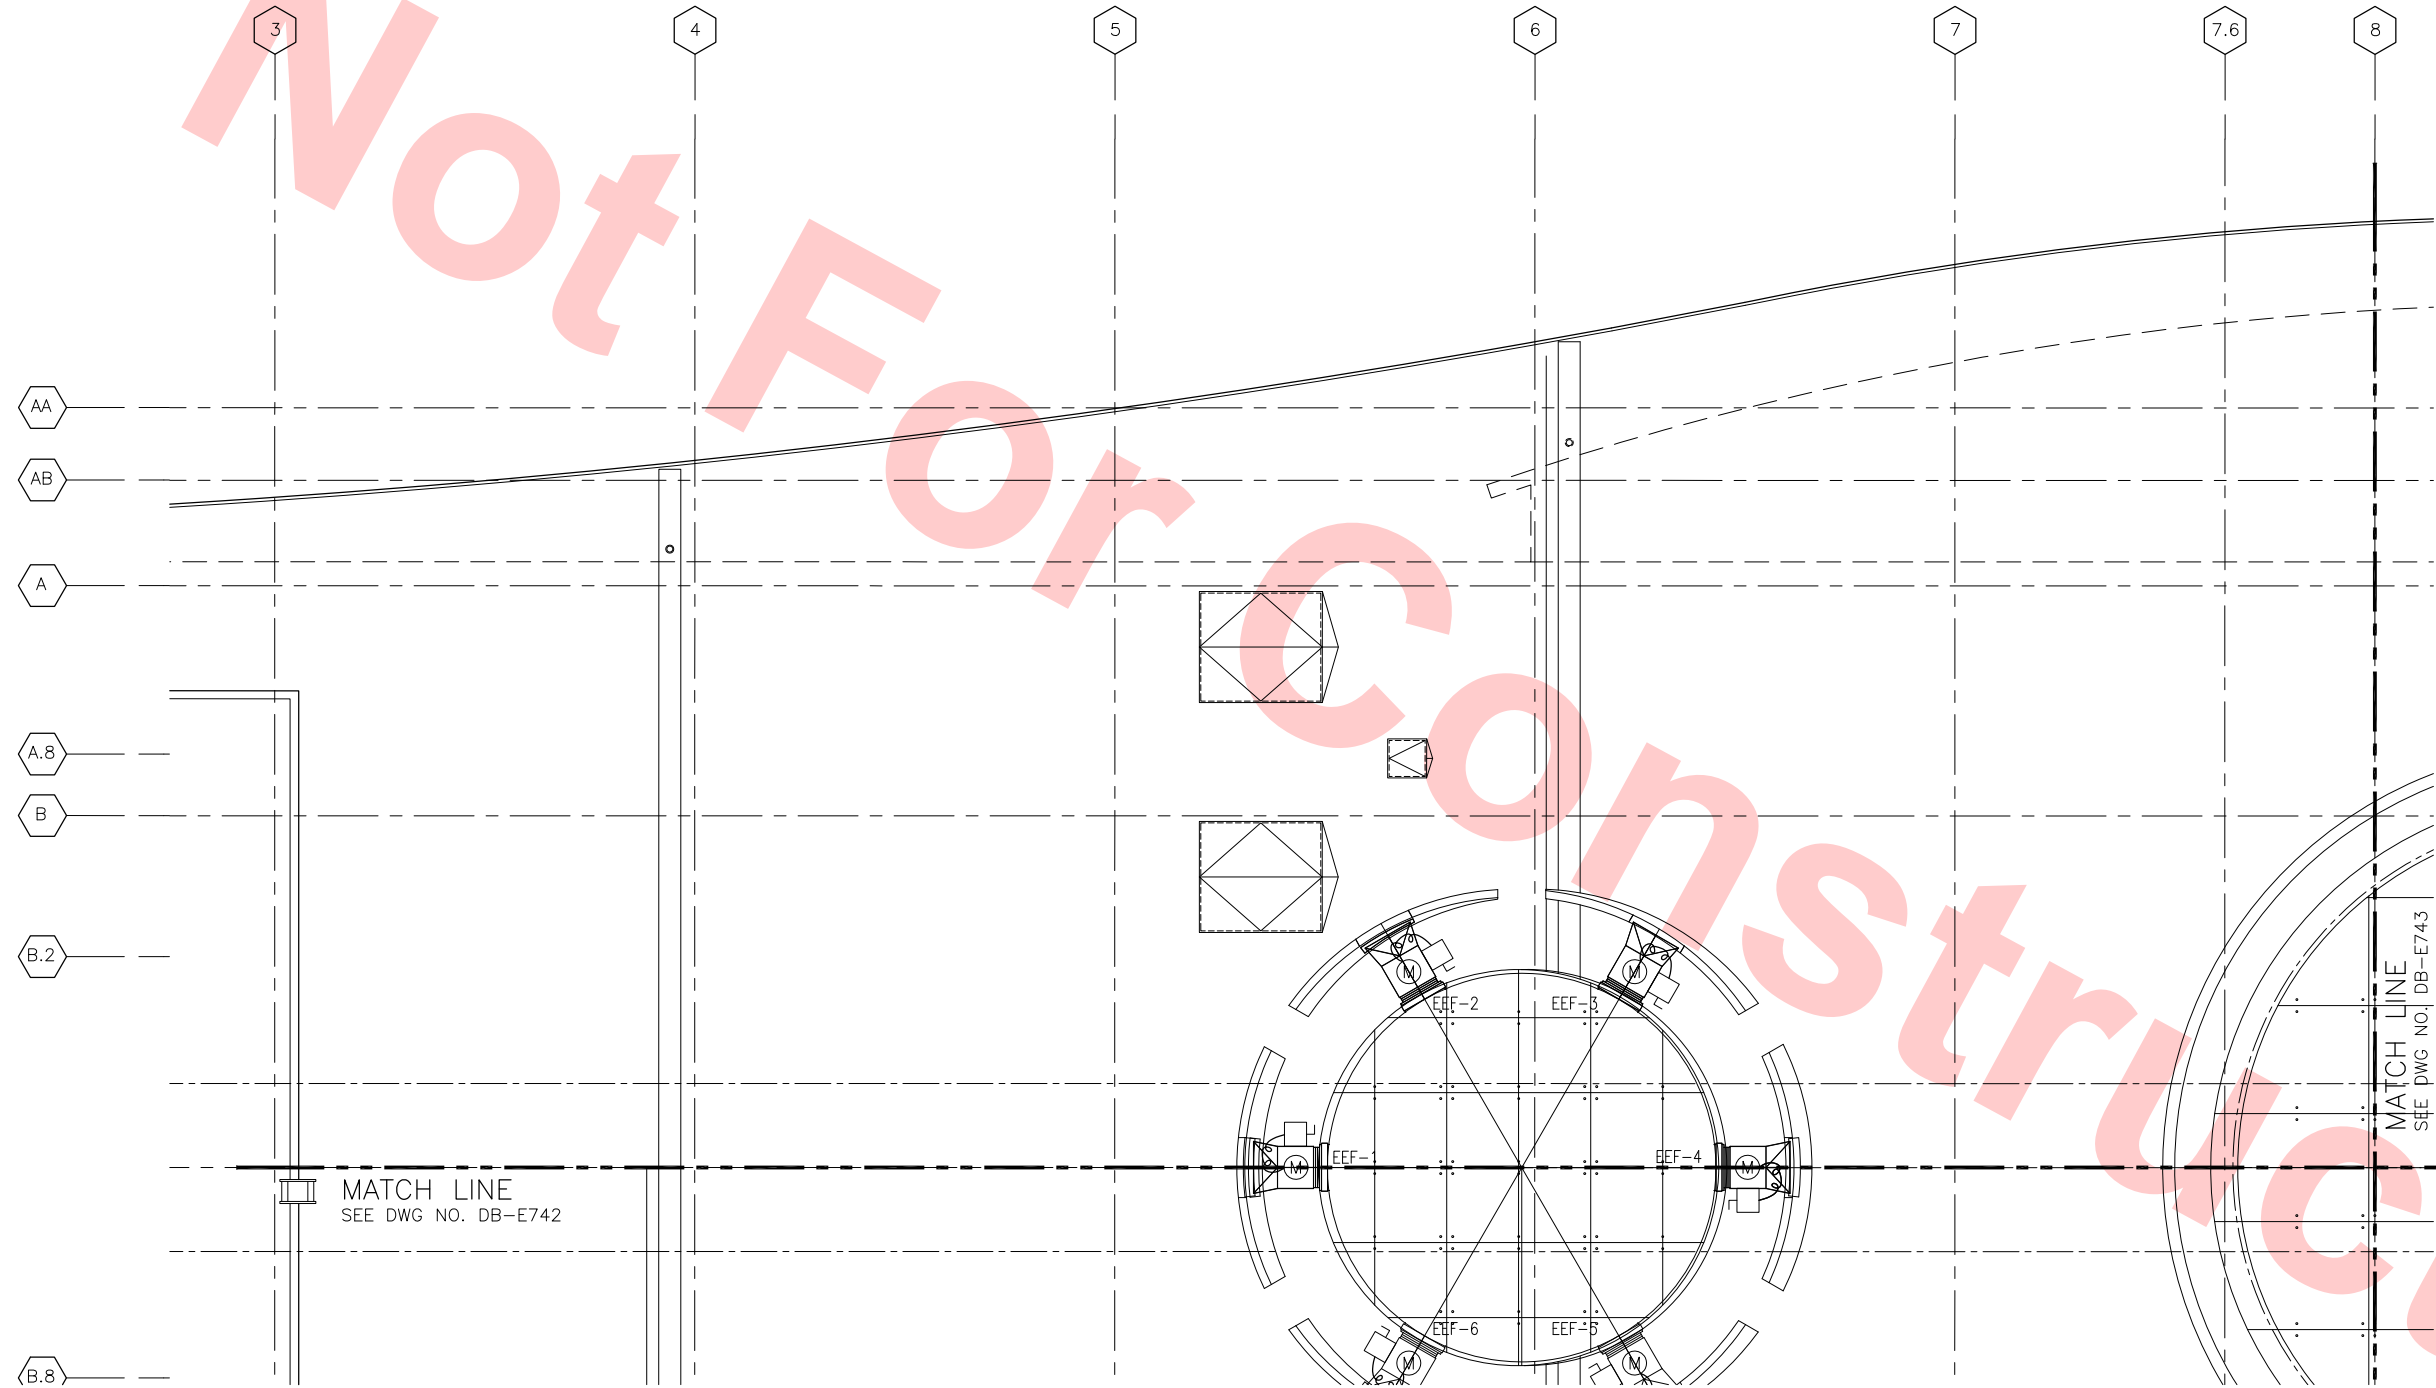

ROOF LEVEL PLAN — FIRE ALARM SYSTEM
SCALE: 1/8"=1'-0"
DB-E740

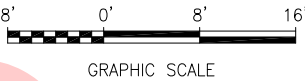

KEY ROOF PLAN

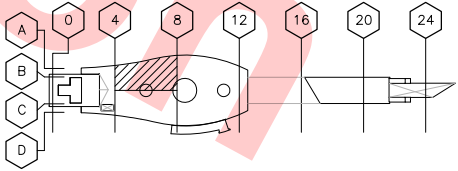

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AND NOT FOR REVIEW

Jan 23, 2013 6:00pm K:\FS (ps)\Engineering\California Projects\VA-Bart\Bart\Milpitas Station S40\C700-S-DB-E741.dwg
SingHV

DESIGNED BY V. SINGH
DRAWN BY V. SINGH
CHECKED BY F. CASABONNE
IN CHARGE F. CASABONNE
DATE 20120125

REV	DATE	BY	SUB	APP	DESCRIPTION
20130125					DEFINITIVE DESIGN

**Skanska
Shimmick
Herzog**
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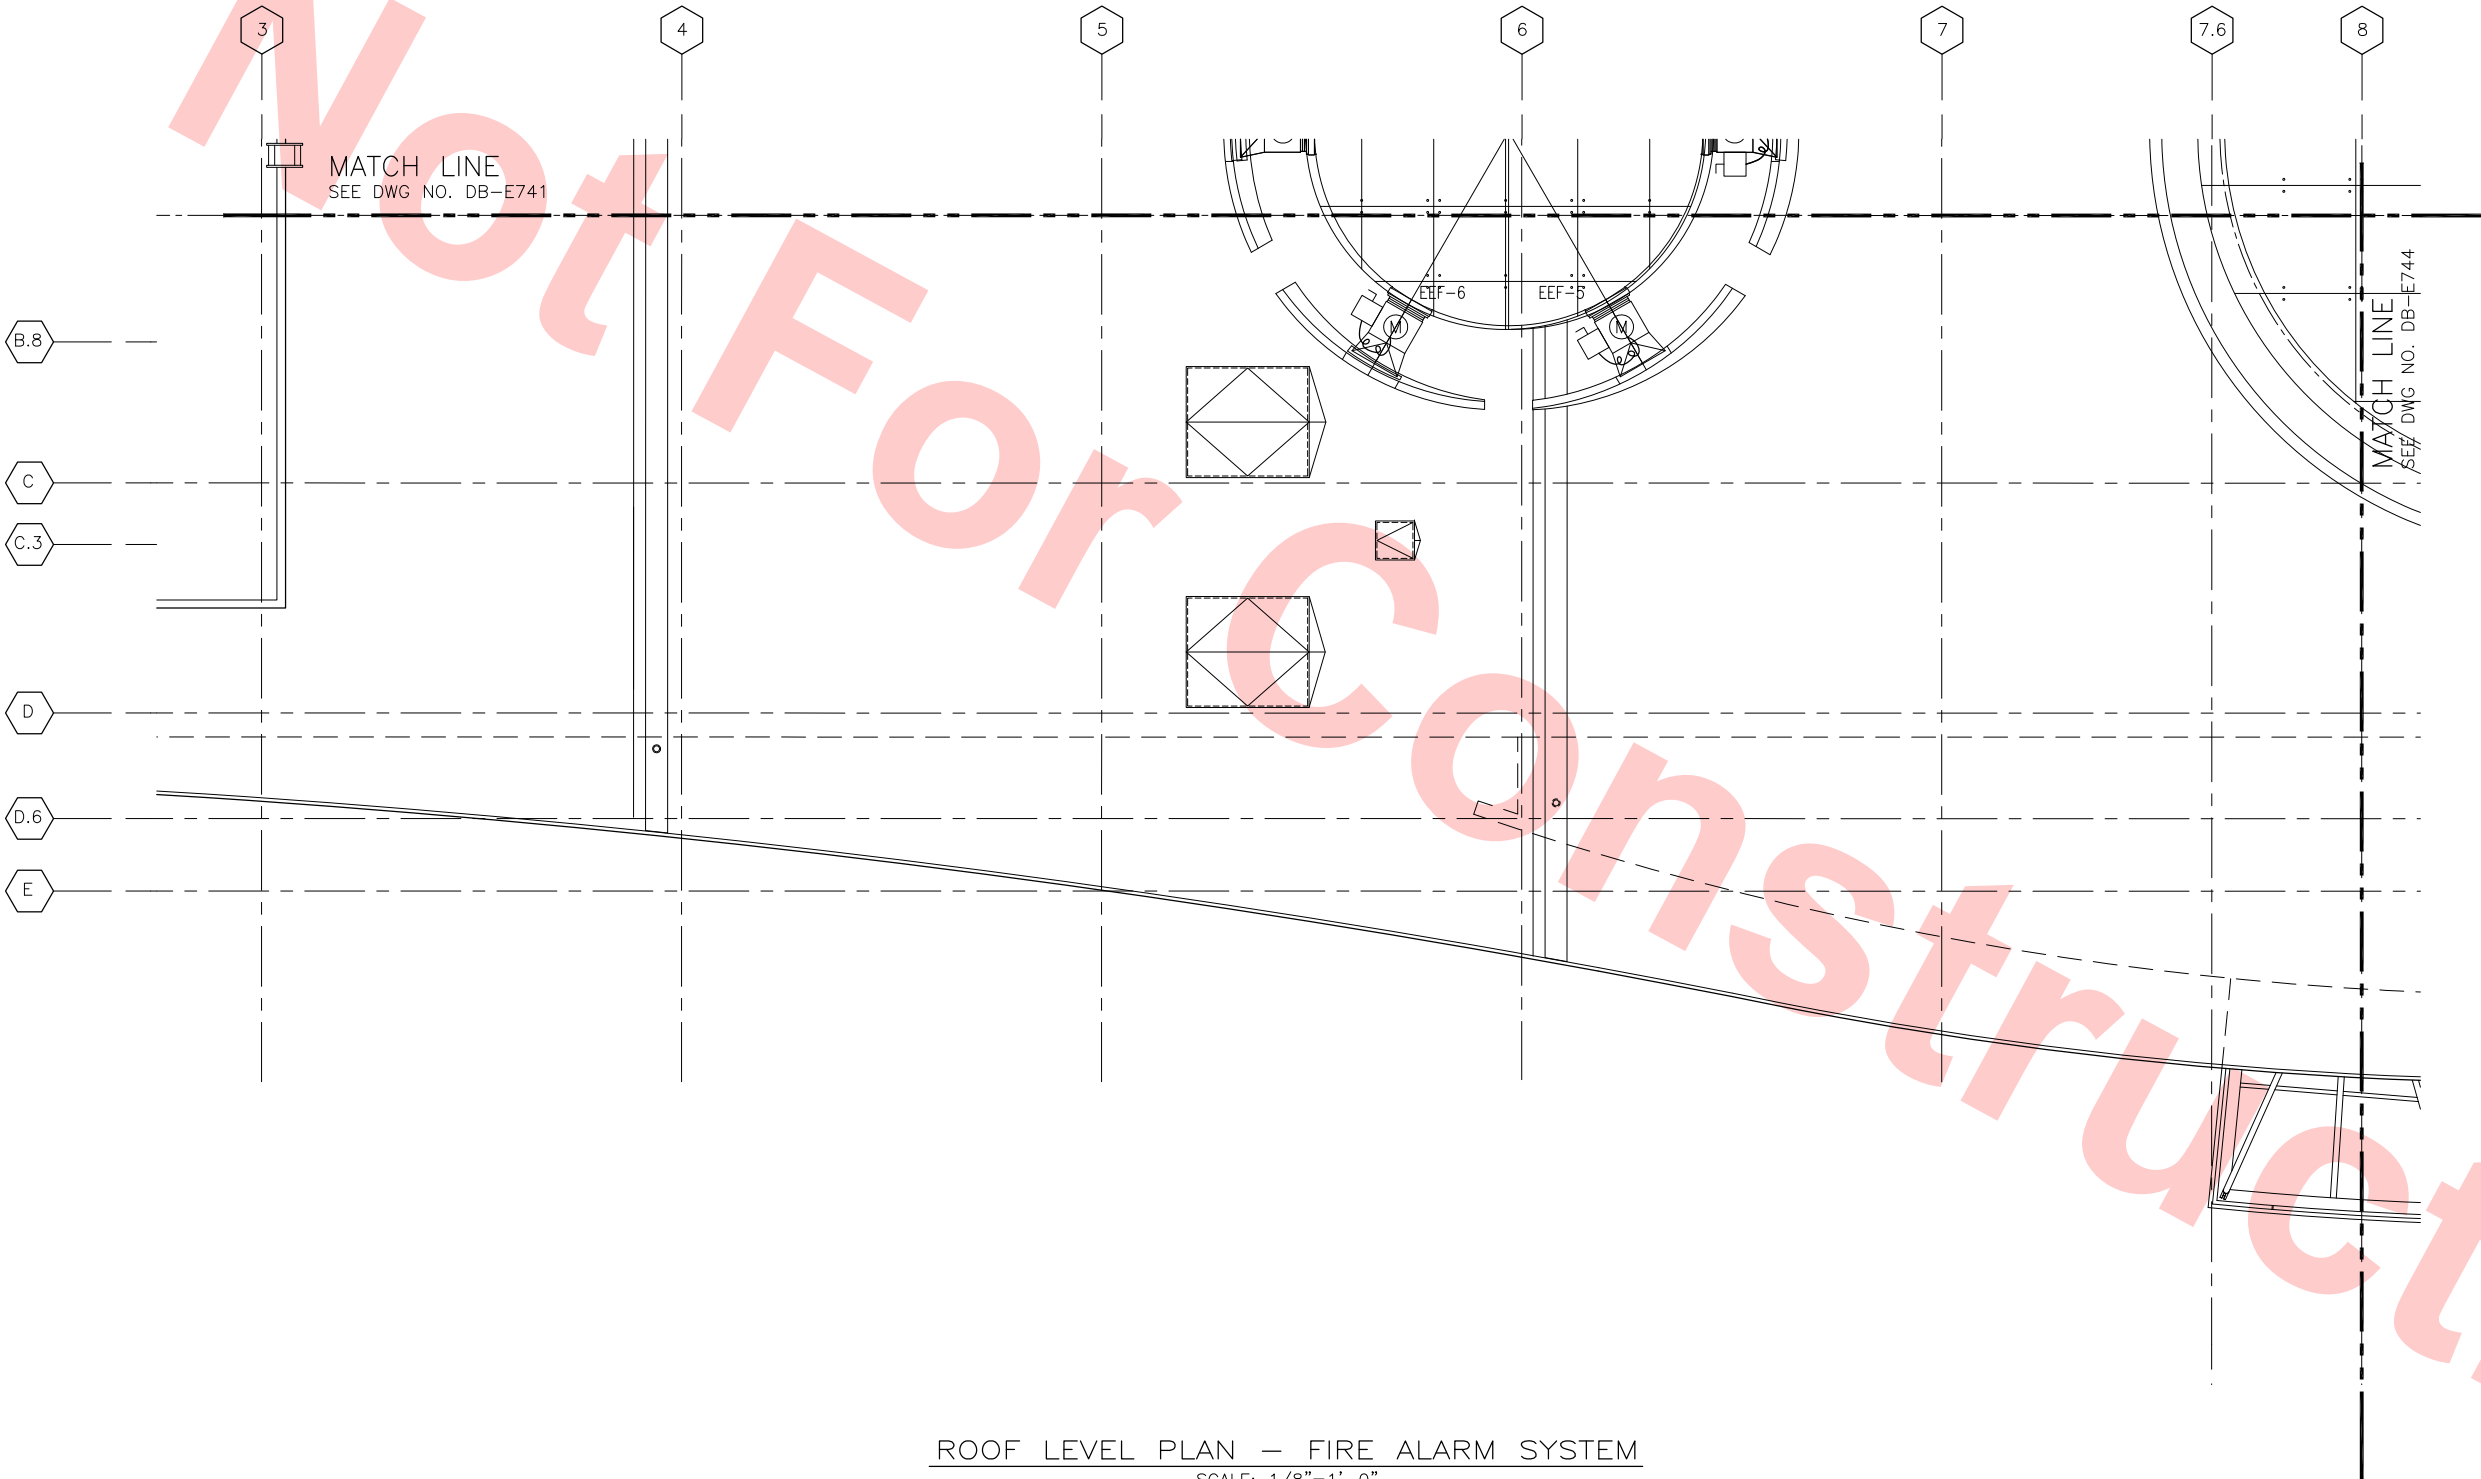
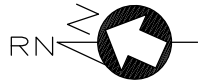
BART SILICON VALLEY BERRYESSA EXTENSION

LINE, TRACK, STATIONS AND SYSTEMS
MILPITAS STATION

ROOF LEVEL PLAN
FIRE ALARM SYSTEM
SHEET 1 OF 4

CADD FILENAME C700-S-DB-E741.dwg		
SIZE D	SCALE 1/8"=1'-0"	
CONTRACT NO. C700		REV.
AREA CODE DB	SHEET NO. E741	PAGE NO.

Jan 23, 2013 - 6:01pm K:\FS\Engineering\California Projects\VA-Bart\Milpitas Station S40\C700-S-DB-E742.dwg
SingHV



ROOF LEVEL PLAN — FIRE ALARM SYSTEM
SCALE: 1/8"=1'-0"
DB-E740


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AND NOT FOR REVIEW

KEY NOTES

- GENERAL NOTES:
1. NO FIRE ALARM SCOPE OF WORK ON THIS SHEET.



KEY ROOF PLAN

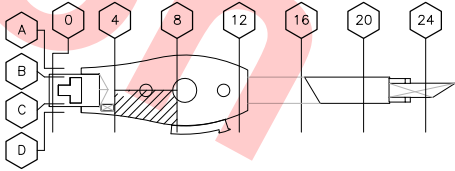

						DESIGNED BY V. SINGH
						DRAWN BY V. SINGH
						CHECKED BY F. CASABONNE
						IN CHARGE F. CASABONNE
						DATE 20130125
REV	DATE	BY	SUB	APP	DESCRIPTION	
	20130125				DEFINITIVE DESIGN	

Skanska Shimmick Herzog
SAN FRANCISCO 8664621
20027 INDUSTRIAL BOULEVARD, SUITE 200
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BART SILICON VALLEY
BART SILICON VALLEY BERRYESSA EXTENSION

LINE, TRACK, STATIONS AND SYSTEMS
MILPITAS STATION


ROOF LEVEL PLAN
FIRE ALARM SYSTEM
SHEET 2 OF 4

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CONTRACT NO.	C700	REV.
AREA CODE DB	SHEET NO. E742	PAGE NO.



KEY NOTES


- GENERAL NOTES:
1. NO FIRE ALARM SCOPE OF WORK ON THIS SHEET.

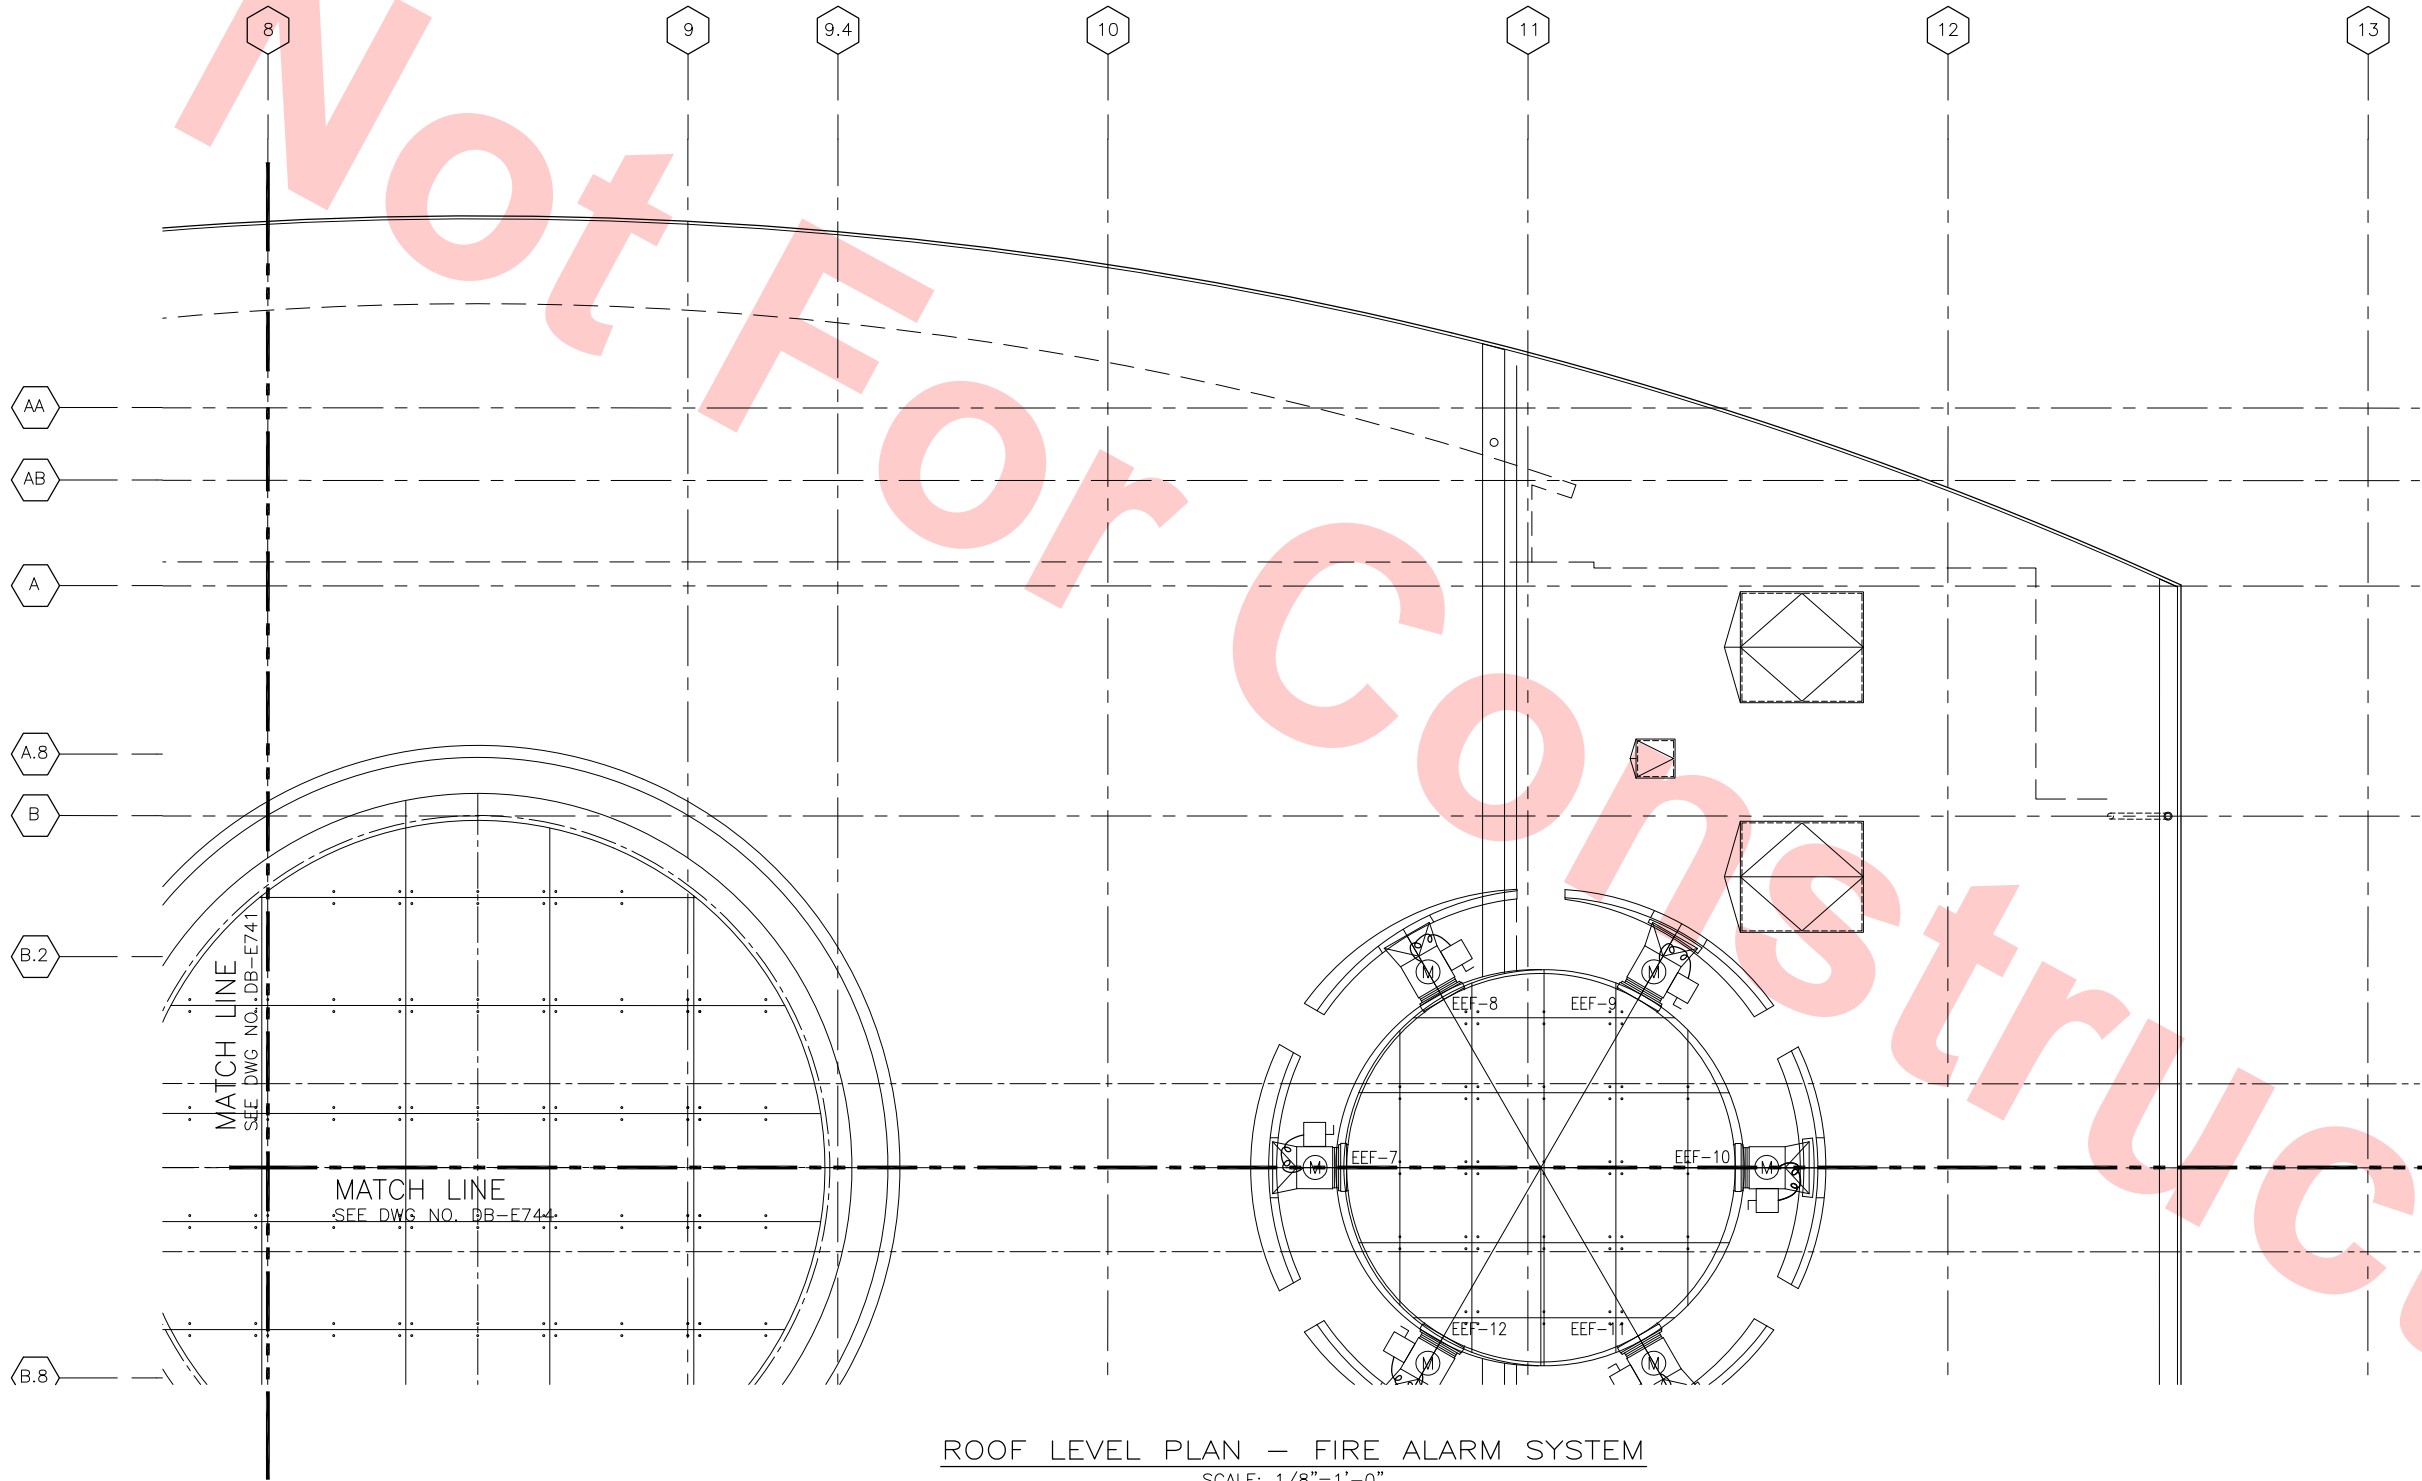

ROOF LEVEL PLAN — FIRE ALARM SYSTEM
SCALE: 1/8"=1'-0"
DB-E740

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AND NOT FOR REVIEW

KEY ROOF PLAN

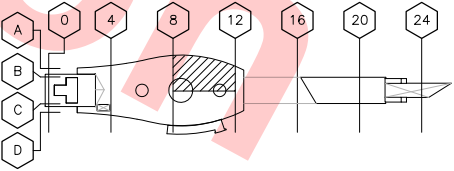

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Singh

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DRAWN BY V. SINGH	
CHECKED BY F. CASABONNE	
IN CHARGE F. CASABONNE	
DATE 20130125	

REV	DATE	BY	SUB	APP	DEFINITIVE DESIGN	DESCRIPTION
20130125						

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Milpitas, California 95035
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BART
SILICON VALLEY

BART SILICON VALLEY BERRYESSA EXTENSION

LINE, TRACK, STATIONS AND SYSTEMS MILPITAS STATION			CADD FILENAME C700-S-DB-E743.dwg
SIZE D	SCALE 1/8"=1'-0"	CONTRACT NO. C700	REV.
AREA CODE DB	SHEET NO. E743	PAGE NO.	



<p>Skanska Shimmick Herzog</p> <p><small>SAN FRANCISCO BRANCH</small> 5997 Potrero Avenue, Suite 101 Hayward, California 94541-2691 Tel: 415.764.6500 Fax: 415.763.2010 California State C-10 License No. 729786 U.S. Certificate # U.S. 324593581</p>	<p>1436 California Circle Milpitas, California 95035</p> <p>A Joint Venture</p>	<p>Lockwood, Andrews & Newman, Inc. A T-Y-LIN COMPANY</p>	<p>T-Y-LIN INTERNATIONAL</p>
<p>SIEMENS Industry, Inc. Fire Safety Division</p>	<p>LOCKWOOD, ANDREWS & NEWMAN, INC.</p>	<p>T-Y-LIN INTERNATIONAL</p>	<p>T-Y-LIN INTERNATIONAL</p>
<p>SUBMITTED _____</p>	<p>APPROVED _____</p>	<p>APPROVED _____</p>	<p>APPROVED _____</p>



BART SILICON VALLEY BERRYESSA EXTENSION

ROOF LEVEL PLAN
FIRE ALARM SYSTEM
SHEET 4 OF 4

Technical drawing of a mechanical part. The drawing includes a side view and a section view. Dimensions are indicated by circles with numbers: 0, 4, 8, 12, 16, 20, and 24. The part has a complex profile with a central hole and a hatched section. The drawing is labeled with letters A, B, C, and D on the left side.



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CONTRACT NO. C700		REV.
AREA CODE DB	SHEET NO. E744	PAGE NO.

Jan 24, 2013 - 10:47am K:\FS\Ops\Engineering\California Projects\VA-Bart\Milpitas Station S40\C700-S-DB-E751.dwg
Singh

2 DEDICATED PHONE LINES
PROVIDED BY THE OWNER

NOTE TO TECHNICIAN:
ZEUS VER. 4.0 MUST
BE USED IN THIS
CONFIGURATION

120 VAC, POWER
FROM FIRE & LIFE
SAFETY PANEL ----

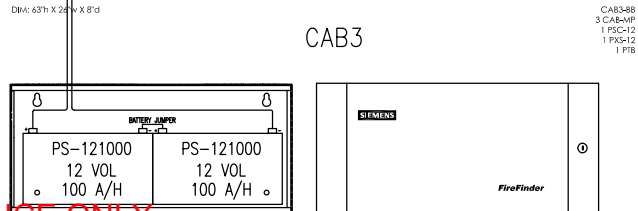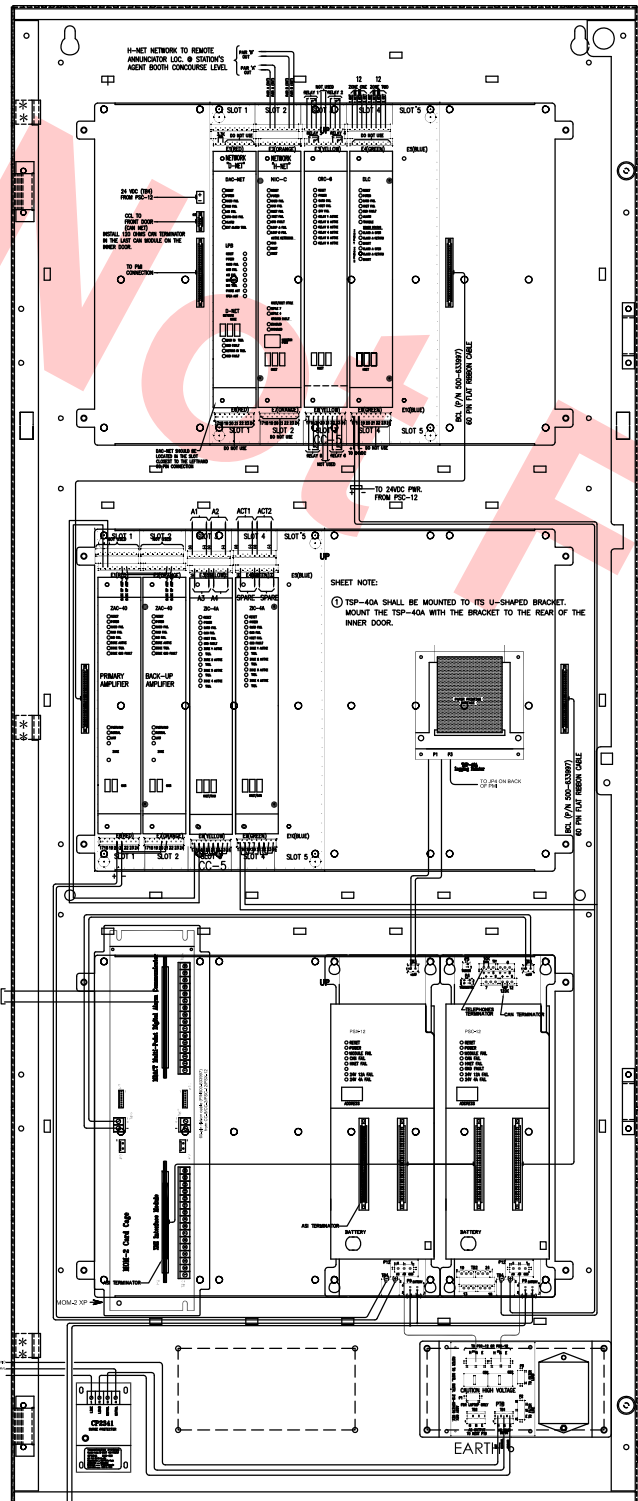

GENERAL NOTES:

1. ALL BATTERY CALCULATION ARE BASED ON A 4 HOUR BATTERY BACKUP PER NFPA 72: 10.5.10.3.2.1 & NFPA 110: CHAPTER 4.
2. THE STATION EMERGENCY GENERATOR IS LOCATED AT THE ANCILLARY BUILDING. THE EMERGENCY GENERATOR MEETS ALL THE REQUIREMENTS FOR LEVEL 1.
3. PLEASE REFER TO FLOOR PLANS FOR EACH SPEAKER WATTAGE TAPPING.

XLSV - SPEAKER CIRCUIT SCHEDULE

CIRCUIT DESIGNATION	CARD TYPE	CIRCUIT DESCRIPTION	CIRCUIT LOCATION	CIRCUIT WATTAGE	CIRCUIT ALARM CURRENT
A1	ZIC-4A	SPEAKER ONLY (CLASS A)	CONCOURSE LEVEL	16	0.848000
A2	ZIC-4A	SPEAKER ONLY (CLASS A)	PLATFORM LEVEL	5.5	0.291500
A3	ZIC-4A	SPEAKER ONLY (CLASS A)	PLATFORM LEVEL	5.5	0.291500
A4	ZIC-4A	SPEAKER ONLY (CLASS A)	ANCILLARY BUILDING	.75	0.039750
		TOTAL		27.7500	1.4708

XLSV - NAC ACTIVATION SCHEDULE

CIRCUIT DESIGNATION	CARD TYPE	CIRCUIT DESCRIPTION	CIRCUIT LOCATION
ACT1	ZIC-4A	POWER BOOSTER ACTIVATION	MILPITAS STATION
ACT2	ZIC-4A	POWER BOOSTER ACTIVATION	ANCILLARY BUILDING

XLSV - SIGNALING LINE CIRCUIT SCHEDULE

CIRCUIT DESIGNATION	ZONE NO.	CIRCUIT DESCRIPTION	LOOP DESCRIPTION	CIRCUIT LOCATION
DLC	ZONE #1	SLC CIRCUIT (CLASS A)	1	CONCOURSE LEVEL & ANCILLARY BUILDING
DLC	ZONE #2	SLC CIRCUIT (CLASS A)	1	PLATFORM LEVEL

XLSV #1 FIRE ALARM & VOICE CONTROL UNIT
LOCATED @ CONCOURSE LEVEL - EMP ROOM

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AND NOT FOR REVIEW

DESIGNED BY
V. SINGH
DRAWN BY
V. SINGH
CHECKED BY
F. CASABONNE
IN CHARGE
F. CASABONNE
DATE
20130125

Skanska
Shimmick
Herzog
1436 California Circle
Milpitas, California 95035
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T-Y-LIN INTERNATIONAL
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BART
SILICON VALLEY
BART SILICON VALLEY BERRYESSA EXTENSION

LINE, TRACK, STATIONS AND SYSTEMS
MILPITAS STATION

FIRE ALARM
CONTROL UNIT DETAILS

CADD FILENAME
C700-S-DB-E751.dwg
SIZE SCALE
D NONE
CONTRACT NO.
C700
REV.
AREA CODE SHEET NO. PAGE NO.
DB E751

Jan 23, 2013 - 6:09pm K:\VFS\Pos\Engineering\California Projects\VTA-Bart\Milpitas Station S40\C700-S-DB-E752.dwg
Singh

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						DRAWN BY V. SINGH
						CHECKED BY F. CASABONNE
						IN CHARGE F. CASABONNE
20130125						DATE 20130125
REV	DATE	BY	SUB	APP	DESCRIPTION	

STROBE CIRCUIT SCHEDULE				
SERVED LEVEL DESIGNATION	CIRCUIT DESIGNATION	POWER SUPPLY LOCATION	CIRCUIT DESCRIPTION	SERVED AREA LOCATION
MILPITAS STATION	NAC1:1	EMP ROOM	STROBE CIRCUIT	CONCOURSE LEVEL
	NAC1:2	EMP ROOM	STROBE CIRCUIT	CONCOURSE LEVEL
	NAC1:3	EMP ROOM	STROBE CIRCUIT	CONCOURSE LEVEL
	NAC1:4	EMP ROOM	STROBE CIRCUIT	CONCOURSE LEVEL
	NAC2:1	ELEC. ROOM #2	STROBE CIRCUIT	CONCOURSE LEVEL
	NAC2:2	ELEC. ROOM #2	STROBE CIRCUIT	CONCOURSE LEVEL
	NAC2:3	ELEC. ROOM #2	STROBE CIRCUIT	CONCOURSE LEVEL
	NAC2:4	ELEC. ROOM #2	STROBE CIRCUIT	CONCOURSE LEVEL
	NAC3:1	COMM ROOM #2	STROBE CIRCUIT	PLATFORM LEVEL
	NAC3:2	COMM ROOM #2	STROBE CIRCUIT	PLATFORM LEVEL
	NAC3:3	COMM ROOM #2	STROBE CIRCUIT	PLATFORM LEVEL
	NAC3:4	COMM ROOM #2	STROBE CIRCUIT	PLATFORM LEVEL
	NAC4:1	COMM ROOM #3	STROBE CIRCUIT	PLATFORM LEVEL
	NAC4:2	COMM ROOM #3	STROBE CIRCUIT	PLATFORM LEVEL
	NAC4:3	COMM ROOM #3	STROBE CIRCUIT	PLATFORM LEVEL
	NAC4:4	COMM ROOM #3	STROBE CIRCUIT	PLATFORM LEVEL

SIEMENS Industry, Inc. Fire Safety Division	SUBMITTED	APPROVED

NOT FOR CONSTRUCTION	BART SILICON VALLEY BERRYESSA EXTENSION

LINE, TRACK, STATIONS AND SYSTEMS MILPITAS STATION			CADD FILENAME C700-S-DB-E752.dwg		
FIRE ALARM POWER SUPPLY DETAILS STROBE CIRCUIT SCHEDULE			CONTRACT NO. C700		
			REV.		
			AREA CODE DB		
			SHEET NO. E752		
			PAGE NO.		

XLSV #1 BATTERY CALCULATION					
SUPERVISORY CURRENT					
DESCRIPTION	QTY	MODULE CURRENT	EOL CURRENT	DEVICE CURRENT	TOTAL ROW CURRENT
CRC-6 CONTROLLABLE RELAY CARD	1	0.051			0.051
20.5mA per Active Relay	6			0.02	0.12
DAC-NET DIGITAL AUDIO CARD NETWORK	1	0.23			0.23
FMT FIREFIGHTERS MASTER TELEPHONE	1	0.15			0.15
30mA per Active Handset	1			0.03	0.03
LPB LOCAL PAGE BOARD	1	0.1			0.1
LVM LIVE VOICE MODULE	1	0.025			0.025
NIC-C NETWORK INTERFACE CARD	1	0.12			0.12
OCM-16 OUTPUT CONTROL MODULE	1	0.014			0.014
10mA per Active LED	16			0.01	0.16
PMI PERSON MACHINE INTERFACE	1	0.23			0.23
PSC-12 PWR SUPPLY CHARGER MODULE	1	0.15			0.15
20mA per Active Relays	4			0.04	0.16
PSX-12 POWER SUPPLY EXTENDER	1	0.15			0.15
TSP-40A PRINTER	1	0.17			0.17
SCM-8 SWITCH CONTROL MODULE	1	0.014			0.014
1mA per LED (8 LED per Module)	8			0.008	0.064
SIM-16 SUPERVISED INPUT MODULE	1	0.02			0.02
1.2mA per Supervised Input	16		0.001		0.016
10mA per Active Relay	0			0.01	0
SSD/SSD-C SYSTEM STATUS DISPLAY	1	0.2			0.2
XMI MDACT INTERFACE	1	0.005			0.005
MDACT DIALER	1	0.38			0.38
ZAC-40 ZONE AMPLIFIER CARD 40 WATTS	2	0.15			0.3
# Speaker Circuits	4		0.001		0.004
ZIC-4A ZONE INDICATING CARD	2	0.089			0.178
TOTAL CURRENT					3.041
ALARM CURRENT					
DESCRIPTION	QTY	MODULE CURRENT	TOTAL CKT CURRENT LOAD		
DAC-NET DIGITAL AUDIO CARD NETWORK	1	0.23	0.23		
NIC-C NETWORK INTERFACE CARD	1	0.12	0.12		
PMI PERSON MACHINE INTERFACE	1	0.23	0.23		
PSC-12 POWER SUPPLY MODULE	1	0.23	0.23		
PSX-12 POWER SUPPLY EXTENDER	1	0.15	0.15		
TSP-40A PRINTER	1	0.17	0.17		
LPB LOCAL PAGE BOARD	1	0.1	0.1		
XMI MDACT INTERFACE	1	0.005	0.005		
MDACT DIALER	1	0.38	0.38		
LVM LIVE VOICE MODULE	1	0.025	0.025		
ZAC-40 ZONE AMPLIFIER CARD 40 WATTS	1	0.15	0.15		
ZIC-4A ZONE INDICATING CARD	2	0.077	0.154		
SCM-8 SWITCH CONTROL MODULE	1	0.014	0.014		
FMT FIREFIGHTERS MASTER TELEPHONE	1	0.18	0.18		
PSX-12 #1	1.5508	TOTAL SPEAKERS CURRENT (.053X27.75)			1.4708
		PS-8 POWER SUPPLY ACTIVATION ACT1			0.075
		PS-8 POWER SUPPLY ACTIVATION ACT2			0.005
					0
TOTAL ALARM CURRENT (AMPS)					3.6888
SUMMARY					
A = TOTAL SUPERVISORY CURRENT		SUPERVISORY TIME REQUIRED-----4 HR			
x SUPERVISORY TIME REQUIRED					
3.041	AMPS x 4 HR	ALARM TIME REQUIRED-----15 MINS. or .25 HR			
=	12.164 (AMP/HR)				
B = TOTAL ALARM CURRENT		BATTERY PROVIDED..... PS-121000 (2)			
x ALARM TIME REQUIRED					
3.6888	AMPS x 15 MINS.	BATTERY SIZE..... 100 (AMP/HR)			
=	0.922 (AMP/HR)				
TOTAL SYSTEM REQUIRED (A/H)		= 15.703 AMP/HOUR			
C = (A + B) x 1.2 (20% Safety Margin)		BATTERY RESERVE AFTER 4 HOURS SUPERVISORY & 5 MINUTES ALARM (AMP/HOUR)			
=	15.703 (AMP/HR)				
		= 84.297 AMP/HOUR			

PSC-12 POWER SUPPLY LOAD CALCULATION						
Card/Module	Quantity	Card/Module 24 VDC Current				
		Back Plane Current		Screw Terminal 24V Current		Total 24 VDC Current (Total 1 + Total 2)
		Per Card/Module	Total 1	Per Card/Module	Total 2	
CRC-6	1	10mA	0.133	0	0	0.133
	6	20.5mA per active relay				
DAC-NET	1	230mA	0.23	0	0	0.23
DLC	1	0	0	100mA	0.1	0.1
	252	0	0	1.8mA per device	0.4536	0.4536
FMT	1	0	0	150mA	0.15	0.15
LPB	1	50mA	0.05	0	0	0.05
LVM	1	0	0	25mA	0.025	0.025
NIC-C	1	120mA	0.12	0	0	0.12
PM	1	230mA	0.23	0	0	0.23
XM	1	0	0	5mA	0.005	0.005
MDACT	1	0	0	380mA	0.38	0.38
	1	0	0	14mA + 1mA per active LED	0.022	0.022
SCM-8	1	0	0	200mA	0.2	0.2
SSD/SSD-C	1	0	0			
ZIC-4A	1	166mA max	0.166	Total NAC device current	0	0
TOTAL			0.929			2.0986
			(Must not exceed 2 Amps)			(Must not exceed 5 Amps in Standby / 12 Amps in Alarm)


PSX-12 POWER SUPPLY LOAD CALCULATION				
Card/Module	Quantity	Card/Module 24 VDC Current		
		Screw Terminal 24V Current		Total 24 VDC Current (Total 1 + Total 2)
		Per Card/Module	Total 2	
DLC	1	100mA	0.1	0.1
	252	1.8mA per device	0.4536	0.4536
OCM-16	1	14mA + 1mA per active LED	0.03	0.03
	16			
SIM-16	1	10mA per active relay+ 1.2mA per supervised input	0.0292	0.0292
	16			
TSP-40A	1	170mA	0.7	0.7
	2	150mA	0.3	0.3
ZAC-40	40	53mA per watt	2.12	2.12
ZIC-4A	1	227mA max	0.166	0.166
TOTAL				3.8988
				(Must not exceed 12 Amps in Alarm)

NAC#1 Loc@CONCOURSE LEVEL EMP RM. NAC1 BATTERY CALCULATIONS					
SUPERVISORY CURRENT					
DESCRIPTION	QTY	DEVICE CURRENT	STAND BY	ALARM CURRENT	
NAC#1 Loc@CONCOURSE LEVEL EMP RM.	1		0.129	0.129	
			0	0	
TOTAL CURRENT					0.129
ALARM CURRENT					
CKT	DEVICE DESCRIPTION	QTY	DEVICE CURRENT RATING	TOTAL CKT CURRENT LOAD	
NAC1:1 1.054	STROBE ONLY 15CD (CM)	0	0.064	0	
	STROBE ONLY 30CD (CM)	0	0.098	0	
	STROBE ONLY 75CD (WM)	3	0.175	0.526	
	SPEAKER/STROBE 75CD (WM)	1	0.109	0.109	
	SPEAKER/STROBE 110CD (WM)	3	0.14	0.42	
NAC1:2	STROBE ONLY 15CD (CM)	0	0.064	0	
	STROBE ONLY 30CD (CM)	3	0.175	0.526	
	SPEAKER/STROBE 75CD (WM)	2	0.109	0.218	
	SPEAKER/STROBE 110CD (WM)	2	0.14	0.28	
NAC1:3 0.72	STROBE ONLY 15CD (CM)	0	0.064	0	
	STROBE ONLY 30CD (CM)	0	0.098	0	
	STROBE ONLY 75CD (WM)	1	0.175	0.175	
	SPEAKER/STROBE 75CD (WM)	5	0.109	0.546	
NAC1:4 0.809	STROBE ONLY 15CD (CM)	0	0.064	0	
	STROBE ONLY 30CD (CM)	0	0.098	0	
	STROBE ONLY 75CD (WM)	4	0.175	0.7	
	SPEAKER/STROBE 75CD (WM)	1	0.109	0.109	
TOTAL ALARM CURRENT (AMPS)					3.606
SUMMARY					
A = TOTAL SUPERVISORY CURRENT x SUPERVISORY TIME REQUIRED		SUPERVISORY TIME REQUIRED - 4 HR			
= 0.129 AMPS x 4 HR		ALARM TIME REQD 15 MINS. or .25 HR			
= 0.516 (AMP/HR)					
B = TOTAL ALARM CURRENT x ALARM TIME REQUIRED		BATTERY PROVIDED - PS-1270 (2)			
= 3.604 AMPS x 129 AMPS x .25 HR		BATT. SIZE 7.0 (AMP/HR)			
= 0.934 (AMP/HR)		TOTAL SYSTEM REQUIRED (A/H)			
C = (A + B) x 1.2 (20% Safety Margin)		= 1.740 AMP/HOUR			
= 1.740 (AMP/HR)		BATTERY RESERVE AFTER 4 HOURS SUPERVISORY & 15 MINUTES ALARM			
		= 5.260 AMP/HOUR			


NAC#3 Loc@PLATFORM LEVEL COMM RM.#2 NAC3 BATTERY CALCULATIONS					
SUPERVISORY CURRENT					
DESCRIPTION	QTY	DEVICE CURRENT	STAND BY	ALARM CURRENT	
NAC#3 Loc@PLATFORM LEVEL COMM RM.#2	1		0.129	0.129	
			0	0	
TOTAL CURRENT					0.129
ALARM CURRENT					
CKT	DEVICE DESCRIPTION	QTY	DEVICE CURRENT RATING	TOTAL CKT CURRENT LOAD	
NAC3:1 0.829	STROBE ONLY 15CD (CM)	0	0.064	0	
	STROBE ONLY 30CD (CM)	0	0.098	0	
	STROBE ONLY 75CD (WM)	1	0.175	0.175	
	SPEAKER/STROBE 75CD (WM)	6	0.109	0.654	
NAC3:2 0.545	STROBE ONLY 15CD (CM)	0	0.064	0	
	STROBE ONLY 30CD (CM)	0	0.098	0	
	SPEAKER/STROBE 75CD (WM)	5	0.109	0.545	
NAC3:3 0.654	STROBE ONLY 15CD (CM)	0	0.064	0	
	STROBE ONLY 30CD (CM)	0	0.098	0	
	SPEAKER/STROBE 75CD (WM)	6	0.109	0.654	
NAC3:4 0.545	STROBE ONLY 15CD (CM)	0	0.064	0	
	STROBE ONLY 30CD (CM)	0	0.098	0	
	SPEAKER/STROBE 75CD (WM)	5	0.109	0.545	
TOTAL ALARM CURRENT (AMPS)					2.573
SUMMARY					
A = TOTAL SUPERVISORY CURRENT x SUPERVISORY TIME REQUIRED		SUPERVISORY TIME REQUIRED - 4 HR			
= 0.129 AMPS x 4 HR		ALARM TIME REQD 15 MINS. or .25 HR			
= 0.516 (AMP/HR)					
B = TOTAL ALARM CURRENT x ALARM TIME REQUIRED		BATTERY PROVIDED - PS-1270 (2)			
= 2.573 AMPS x 129 AMPS x .25 HR		BATT. SIZE 7.0 (AMP/HR)			
= 0.676 (AMP/HR)		TOTAL SYSTEM REQUIRED (A/H)			
C = (A + B) x 1.2 (20% Safety Margin)		= 1.430 AMP/HOUR			
= 1.430 (AMP/HR)		BATTERY RESERVE AFTER 4 HOURS SUPERVISORY & 15 MINUTES ALARM			
		= 5.570 AMP/HOUR			

NAC#2 Loc@CONCOURSE LEVEL ELEC. RM.#2			NAC2		BATTERY CALCULATIONS	
SUPERVISORY CURRENT						
DESCRIPTION			QTY	DEVICE CURRENT	STAND BY	ALARM CURRENT
NAC#2 Loc@CONCOURSE LEVEL ELEC. RM.#2			1		0.129	0.129
					0	
					0	
TOTAL CURRENT					0.129	
ALARM CURRENT						
CKT	DEVICE DESCRIPTION	QTY	DEVICE CURRENT RATING	TOTAL CKT CURRENT LOAD		
NAC2:1 0.848	STROBE ONLY 15CD (CM)	0	0.064	0		
	STROBE ONLY 30CD (CM)	0	0.098	0		
	STROBE ONLY 75CD (WM)	2	0.175	0.35		
	SPEAKER/STROBE 75CD (WM)	2	0.109	0.218		
	SPEAKER/STROBE 110CD (WM)	2	0.14	0.28		
NAC2:2 0.97	STROBE ONLY 15CD (CM)	0	0.064	0		
	STROBE ONLY 30CD (CM)	0	0.098	0		
	SPEAKER/STROBE 110CD (WM)	2	0.14	0.28		
	WP SPEAKER/STROBE 30CD (WM)	5	0.138	0.69		
NAC2:3 0.786	STROBE ONLY 15CD (CM)	0	0.064	0		
	STROBE ONLY 30CD (CM)	0	0.098	0		
	STROBE ONLY 75CD (WM)	2	0.175	0.35		
	SPEAKER/STROBE 75CD (WM)	4	0.109	0.436		
NAC2:4 0.502	STROBE ONLY 15CD (CM)	0	0.064	0		
	STROBE ONLY 30CD (CM)	0	0.098	0		
	STROBE ONLY 75CD (WM)	1	0.175	0.175		
	SPEAKER/STROBE 75CD (WM)	3	0.109	0.327		
TOTAL ALARM CURRENT (AMPS)						3.106
SUMMARY						
A = TOTAL SUPERVISORY CURRENT x SUPERVISORY TIME REQUIRED = 0.129 AMPS x 4 HR = 0.516 (AMP/HR)			SUPERVISORY TIME REQUIRED - 4 HR ALARM TIME REQED 15 MINS. or 26 HR			
B = TOTAL ALARM CURRENT x ALARM TIME REQUIRED = 3.101 AMPS x 129 AMPS x 26 HR = 0.801 (AMP/HR)			BATTERY PROVIDED - PS-1270 (2) BATT. SIZE 7.0 (AMP/HR)			
C = (A + B) x 1.2(20% Safety Margin) = 1.591 (AMP/HR)			TOTAL SYSTEM REQUIRED (AH) = 1.590 AMP/HOUR			
			BATTERY RESERVE AFTER 4 HOURS SUPERVISORY & 15 MINUTES ALARM = 5.410 AMP/HOUR			


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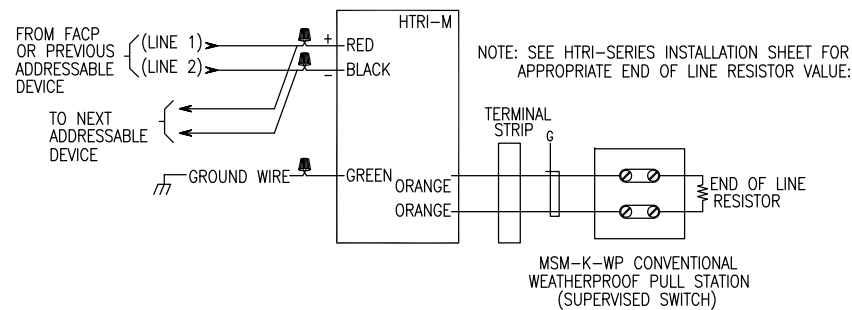
DB-11 DETECTOR BASE
HFPT-11 INTELLIGENT THERMAL DETECTOR or
HFP-11 INTELLIGENT PHOTOELECTRIC FIRE DETECTOR
with DB-11 DETECTOR BASE

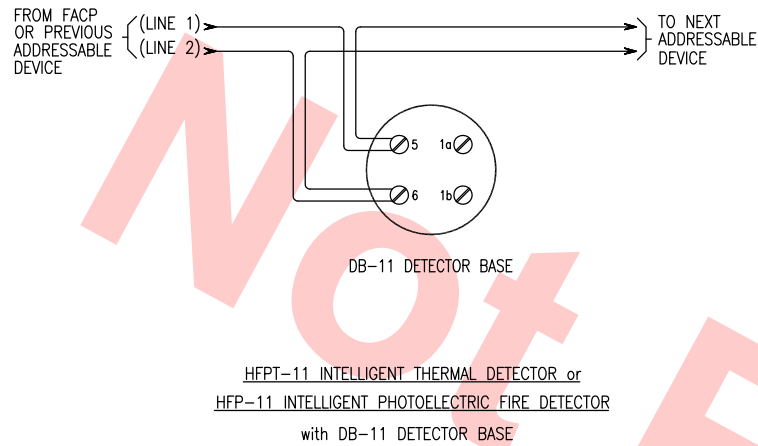


DB-HR RELAY BASE
HFPT-11 INTELLIGENT THERMAL DETECTOR or
HFP-11 INTELLIGENT PHOTOELECTRIC FIRE DETECTOR
with DB-HR DETECTOR BASE with RELAY

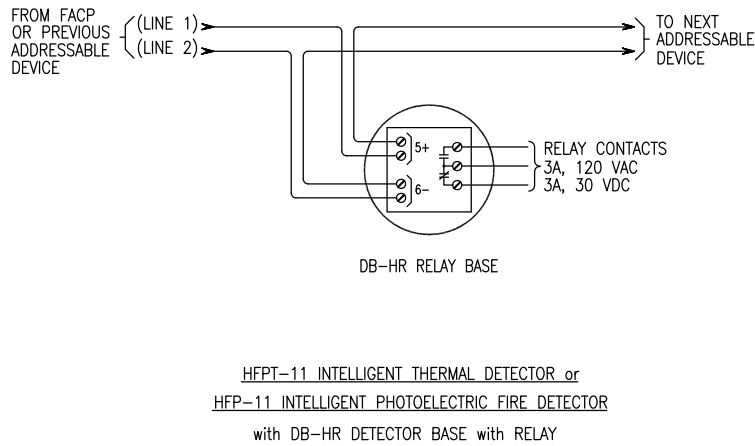


HMS-D MANUAL PULL STATION (DUAL ACTION)

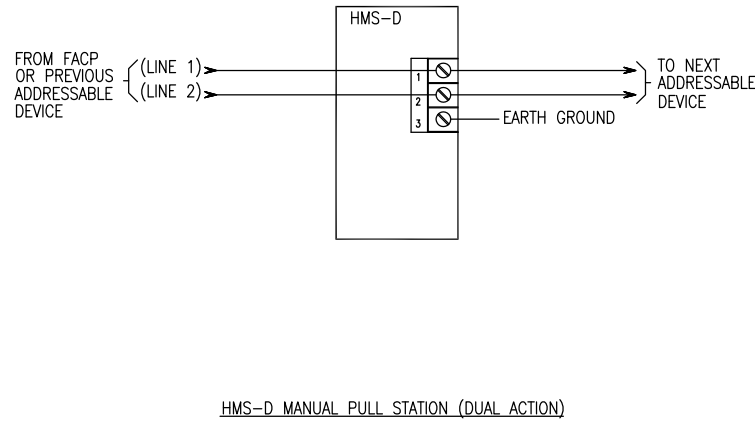


HTRI-M MINI-INTERFACE MODULE, SINGLE INPUT
for MONITORING MSM-K-WP CONVENTIONAL WEATHERPROOF PULL STATION

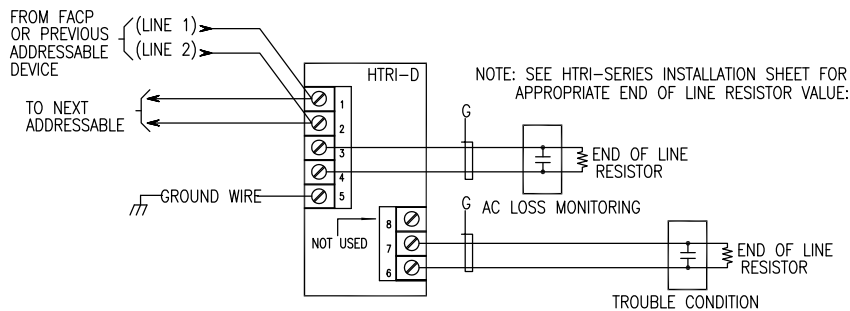

HTRI-D INTERFACE MODULE, DUAL INPUT
for PS8 BOOSTER POWER SUPPLY PANEL AC LOSS AND TROUBLE CONDITION
**FOR REFERENCE ONLY
AND NOT FOR REVIEW**

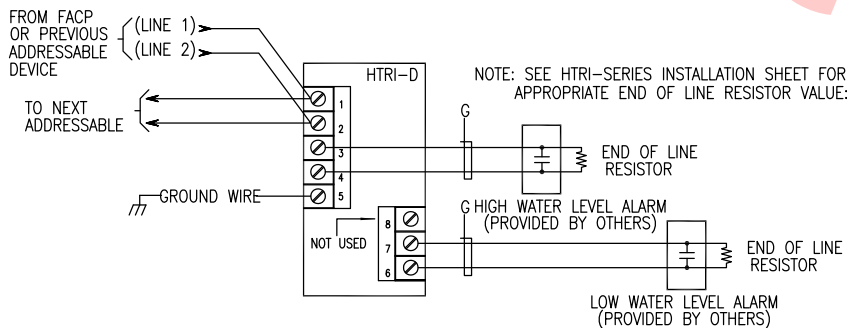

HTRI-D INTERFACE MODULE, DUAL INPUT
for FIRE PUMP WATER LEVEL SUPERVISION

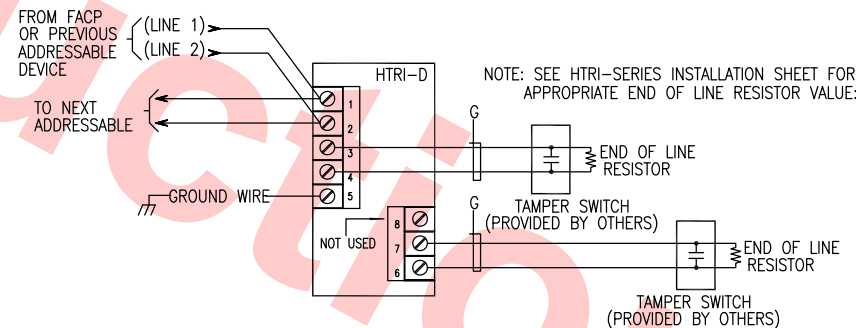

HTRI-D INTERFACE MODULE, DUAL INPUT
for FIRE PUMP TAMPER & WATERFLOW SWITCH SUPERVISION

e Jan. 23, 2013 - 1 SinghV							DESIGNED BY V. SINGH
							DRAWN BY V. SINGH
							CHECKED BY F. CASABONNE
							IN CHARGE F. CASABONNE
							DATE 20130125
	20130125					DEFINITIVE DESIGN	
	REV	DATE	BY	SUB	APP	DESCRIPTION	

SIEMENS Industry, Inc. Fire Safety Division	Skanska Shimmick Herzog SAN FRANCISCO 94102 20027 Industrial Boulevard, Suite 200 Milpitas, California 95035 A Joint Venture T48 (010) 785-0000 Fax (010) 285-0100 California State CTS License No. 725706 U.S. Certificate ID No. 324797-001	Lookwood, Andrews & Newnam, Inc. A LEO A DALY COMPANY	T-Y-LIN INTERNATIONAL
SUBMITTED	APPROVED		

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CONSTRUCTION




LINE, TRACK, STATIONS AND SYSTEMS
MILPITAS STATION
FIRE ALARM
FIELD DEVICES WIRING DETAILS
PART-1

CADD FILENAME		
C700-S-DB-E754.dwg		
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CONTRACT NO.		REV.
C700		
AREA CODE	SHEET NO.	PAGE NO.
DB	E754	

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WARNING: THE STROBE APPLIANCES MUST BE FIELD SET TO THE DESIRED CANDELA RATING BEFORE THEY ARE INSTALLED. REFER TO FIRE ALARM FLOOR PLAN FOR APPROPRIATE CANDELA SETTING.
THE SPEAKER APPLIANCES MUST BE FIELD SET TO THE DESIRED dBA SOUND OUTPUT LEVEL BEFORE THEY ARE INSTALLED. THIS IS DONE BY PROPERLY INSERTING JUMPER PLUG IN ACCORDANCE WITH THE INSTALLATION INSTRUCTION.

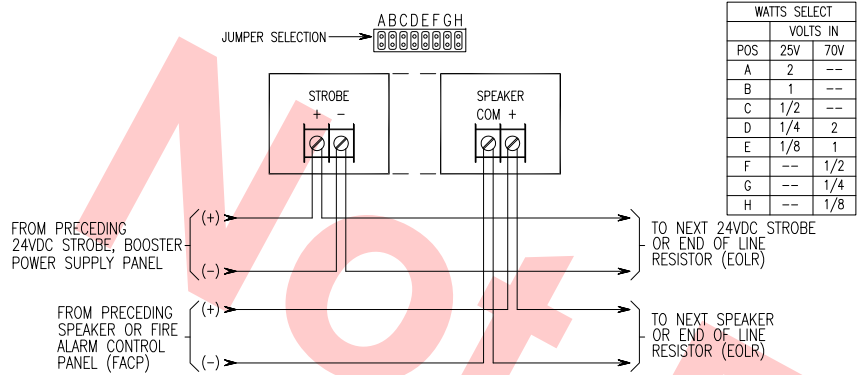


E50-24MCW-FR / E50-24MCWH-FR SPEAKER/STROBE (WALL MOUNTED)

(Multi-Candela Appliance 15 / 30 / 75 / 110cd),(High Candela Appliance 115/177)

NOTE: SET SPEAKER JUMPER PLUG TO 70 VOLTS AND TAP EACH SPEAKER TO 1/4 WATT, UNLESS OTHERWISE NOTED ON THE DRAWINGS. (SEE FLOOR PLAN FOR ADDITIONAL INFORMATION)

WARNING: THE STROBE APPLIANCES MUST BE FIELD SET TO THE DESIRED CANDELA RATING BEFORE THEY ARE INSTALLED. REFER TO FIRE ALARM FLOOR PLAN FOR APPROPRIATE CANDELA SETTING.
THE SPEAKER APPLIANCES MUST BE FIELD SET TO THE DESIRED dBA SOUND OUTPUT LEVEL BEFORE THEY ARE INSTALLED. THIS IS DONE BY PROPERLY INSERTING JUMPER PLUG IN ACCORDANCE WITH THE INSTALLATION INSTRUCTION.

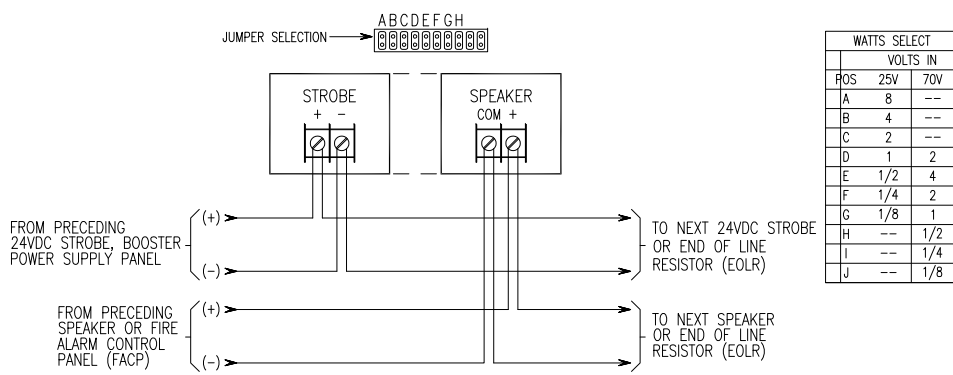


ET70WP-24185W WEATHERPROOF SPEAKER/STROBE (WALL MOUNTED)

(Strobe Candela Appliance 185cd, 90cd at -40°C)


NOTE: SET SPEAKER JUMPER PLUG TO 70 VOLTS AND TAP EACH SPEAKER TO 2 WATT, UNLESS OTHERWISE NOTED ON THE DRAWINGS. (SEE FLOOR PLAN FOR ADDITIONAL INFORMATION)

WARNING: THE STROBE APPLIANCES MUST BE FIELD SET TO THE DESIRED CANDELA RATING BEFORE THEY ARE INSTALLED. REFER TO FIRE ALARM FLOOR PLAN FOR APPROPRIATE CANDELA SETTING.

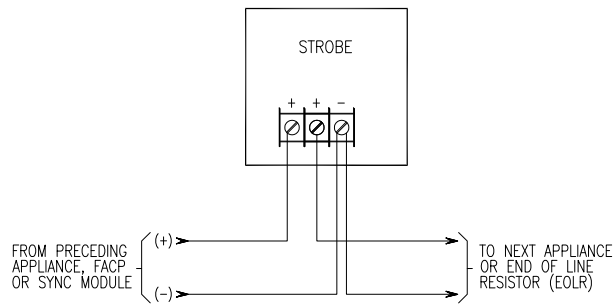


STW (WALL MOUNTED) & STWC (CEILING MOUNTED) STROBE

(Multi-Candela Appliance 15 / 1575 / 30 / 75 / 95 / 110 / 135 / 185cd)

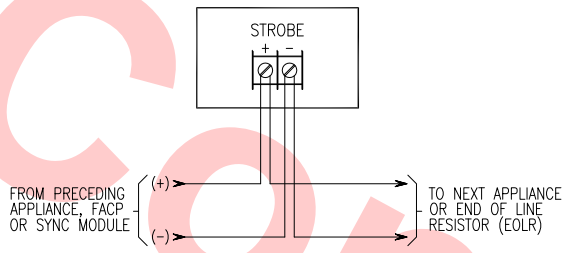

RSSWP-2475W-FW WEATHERPROOF STROBE (WALL MOUNTED)

(Multi-Candela Appliance 30/180cd, 180cd is on Axis only)

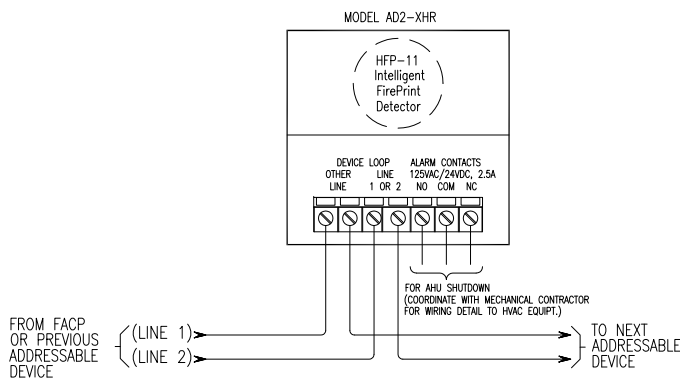


AD2-XHR DUCT DETECTOR HOUSING with RELAY for AHU/FSD CONTROL

with HFP-11 INTELLIGENT FirePrint SMOKE DETECTOR

NOTE: 1 THE AIR FLOW INSIDE THE DUCT MUST BE MORE THAT 100 FEET PER MINUTE FOR THE DUCT DETECTOR TO OPERATE PROPERLY.

THE INSTALLATION CONTRACTOR MUST PROVIDE PROPER SHIELDING OR OVERHUNG PROTECTION TO SIEMENS DUCT DETECTORS ON THE ROOF. IN ADDITION, AVOID INSTALLING THE DUCT DETECTORS WITH DIRECT HEAT OF THE SUN.

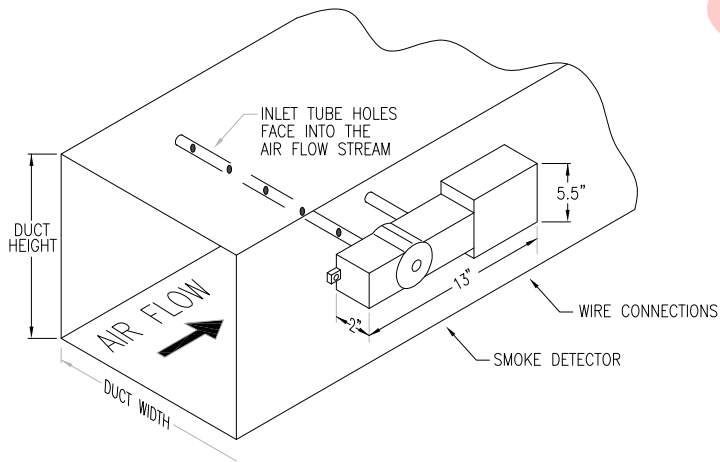

SMOKE DUCT DETECTOR HOUSING INSTALLATION

TYPICAL APPLICATION

THE SIEMENS DUCT SMOKE DETECTOR HOUSING MUST BE INSTALLED ON A FLAT, ACCESSIBLE DUCT AREA. TO AVOID STRATIFICATION EFFECTS, INSTALL THE DETECTOR HOUSING A MINIMUM OF SIX DUCT WIDTHS BEYOND ANY BENDS IN THE DUCT. BEFORE INSTALLING THE DUCT DETECTOR HOUSING, VERIFY THAT DUCT AIR VELOCITY IS WITHIN THE LIMITS OF THE SMOKE DETECTOR. ALSO VERIFY THAT DUCT RELATIVE HUMIDITY IS WITHIN 0-93%, NONCONDENSING. MOUNT ONLY ON THE TOP OR SIDES OF THE DUCT TO AVOID CONDENSATION ISSUES. A PAPER MOUNTING TEMPLATE IS PROVIDED WITH EACH DUCT DETECTOR.

INLET SAMPLE TUBE SELECTION TABLE	
HVAC DUCT WIDTH	SAMPLE TUBE MODEL
6" TO 12"	ST-10
1' TO 3'	ST-25
3' TO 5'	ST-50
5' TO 10'	ST-100

THE ST-100 IS SHIPPED IN TWO FIVE FOOT PIECES WITH A COUPLING FOR FIELD ASSEMBLY.

IMPORTANT: THIS DEVICE DRAWS AIR FROM THE DUCT THRU THE INLET SAMPLE TUBE AND EXHAUSTS IT BACK INTO THE DUCT THROUGH THE OUTLET TUBE. EACH INLET SAMPLE TUBE IS MANUFACTURED WITH A DIFFERENT NUMBER AND SIZE OF SAMPLING HOLES. THE SPECIFIC MODEL TUBE MUST BE USED FOR THE DUCT WIDTH. THESE TUBES CAN BE CUT TO LENGTH AND MUST SPAN AT LEAST 80% THE WIDTH OF THE DUCT. ALWAYS USE THE NEXT LONGEST STANDARD SIZE AND CUT DOWN TO THE EXACT REQUIREMENT. SAMPLING TUBES OVER 3.0' MUST BE SUPPORTED ON THE OPPOSITE SIDE OF THE DUCT. TO ENSURE THE CORRECT OPERATION, THE RED STOPPER (SUPPLIED) MUST BE INSERTED IN THE END OF THE AIR INPUT SAMPLING TUBE.

FOR REFERENCE ONLY
AND NOT FOR REVIEW

					DESIGNED BY V. SINGH
					DRAWN BY V. SINGH
					CHECKED BY F. CASABONNE
					IN CHARGE F. CASABONNE
					DATE 20130125
REV	DATE	BY	SUB	APP	DEFINITIVE DESIGN
					DESCRIPTION

SIEMENS Industry, Inc. Fire Safety Division		SUBMITTED	
APPROVED		APPROVED	

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CONSTRUCTION





LINE, TRACK, STATIONS AND SYSTEMS
MILPITAS STATION

FIRE ALARM
FIELD DEVICES WIRING DETAILS
PART-2

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CONTRACT NO. C700	REV.
AREA CODE DB	SHEET NO. E755
	PAGE NO.

Jan 24, 2013 3:48pm K:\VFS (ops)\Engineering\California Projects\VA-Bart\Bart\Milpitas Station\SA0\C700-S-DB-E756.dwg
SinghV




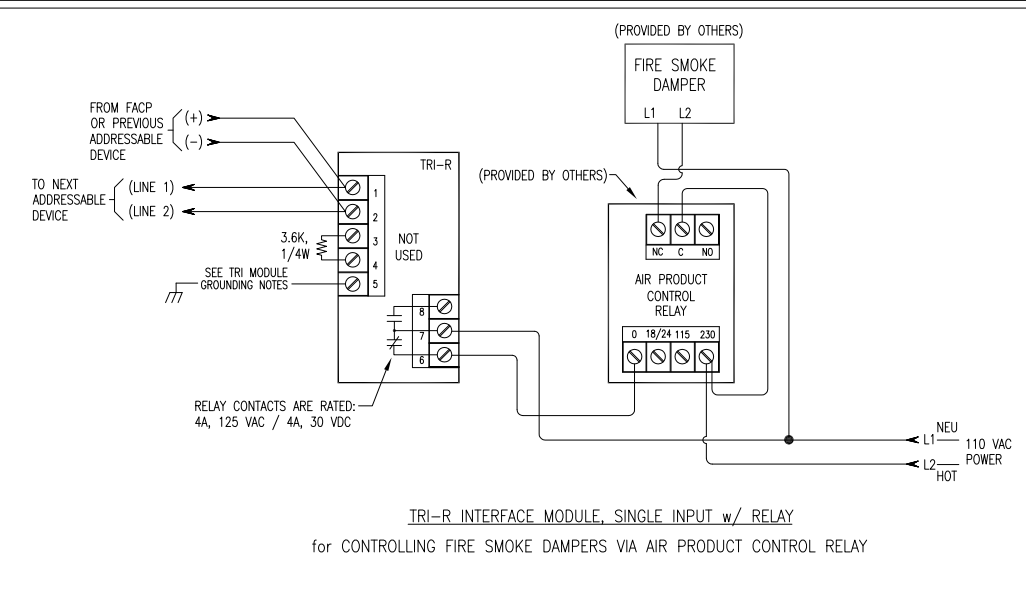
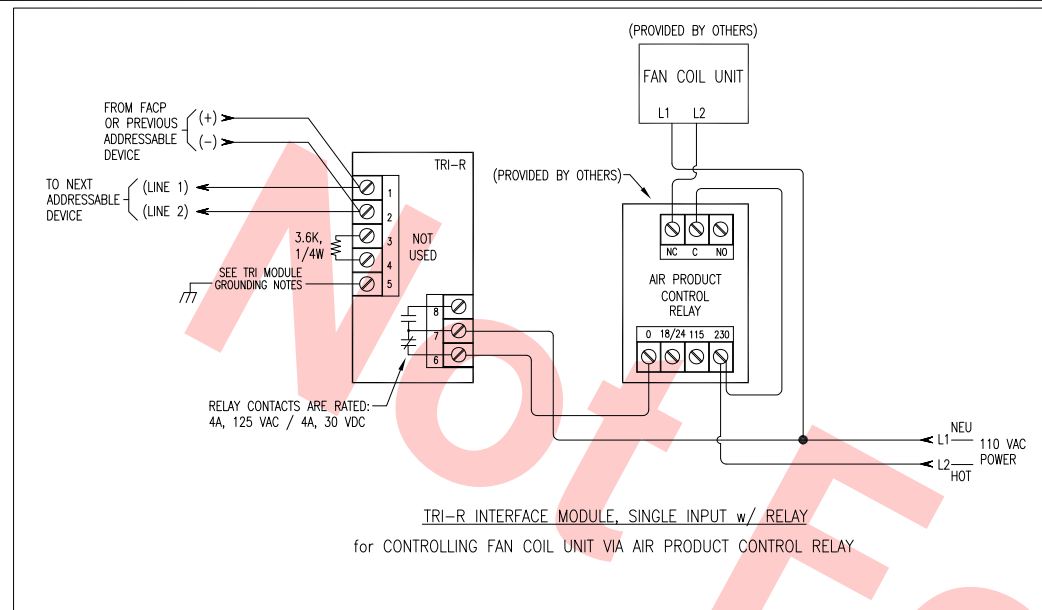


- HTRI-S/HTRI-R/HTRI-D GROUNDING NOTES
- CAUTION: GROUND SHIELD ONLY AT THE SPECIFIED LOCATION ON THE CONTROL PANEL.
 - IMPORTANT: TERMINAL 5 OF THE TRI-S/TRI-R/TRI-D MUST BE CONNECTED TO A KNOWN GOOD EARTH GROUND FOR PROPER OPERATION.
 - IF A GOOD LOCAL EARTH GROUND IS AVAILABLE:
 - TERMINAL 5 MUST BE CONNECTED TO EARTH GROUND.
 - USE WIRE NUTS TO PASS THE SHIELD WIRE THROUGH THE ELECTRICAL BOX WITH NO CONNECTION TO THE DEVICE TERMINAL BLOCK OR TO LOCAL GROUND.
 - USE SHIELDED WIRE TO CONNECT THE SWITCH WIRING.
 - TIE THE SWITCH WIRING SHIELD TO THE ALD WIRING SHIELD. DO NOT CONNECT SHIELD TO TERMINAL 5 OR THE LOCAL EARTH GROUND.
 - IF A GOOD LOCAL EARTH GROUND IS NOT AVAILABLE:

CONNECT SHIELD TO TERMINAL 5

IF ALD WIRING IS NOT SHIELDED, THE SWITCH WIRING MUST BE IN METAL RACEWAY.
- REFER TO INSTALLATION INSTRUCTIONS P/N 315-096242-2 FOR FURTHER DETAILS

TYPICAL HTRI MODULE GROUNDING DETAIL

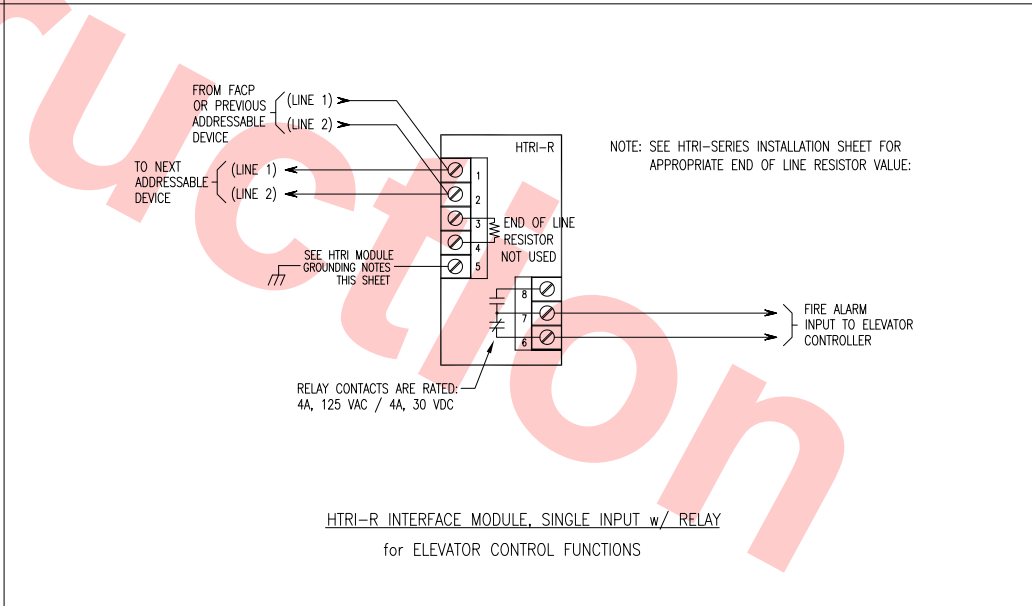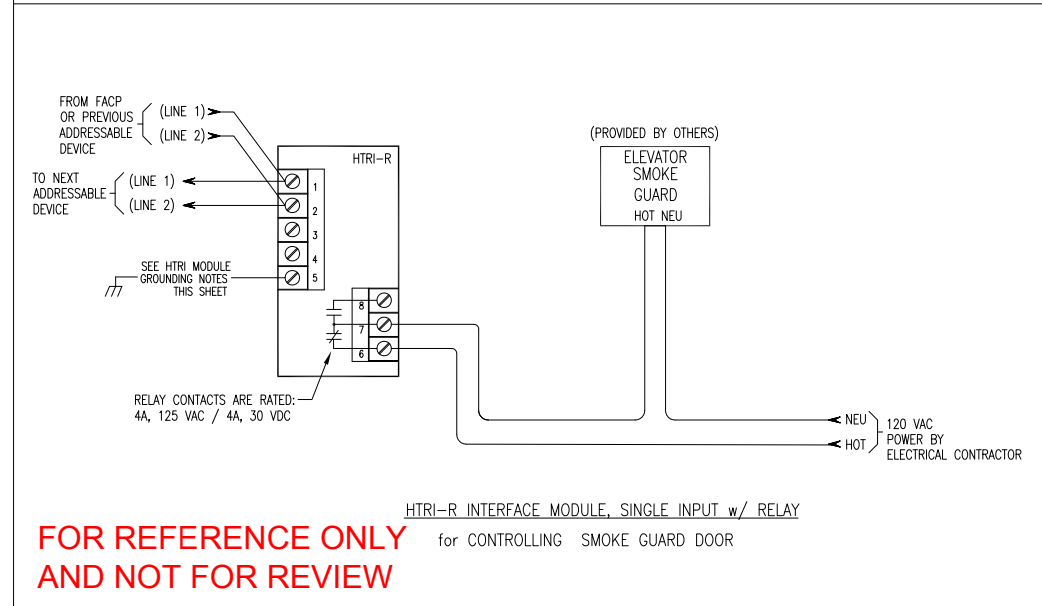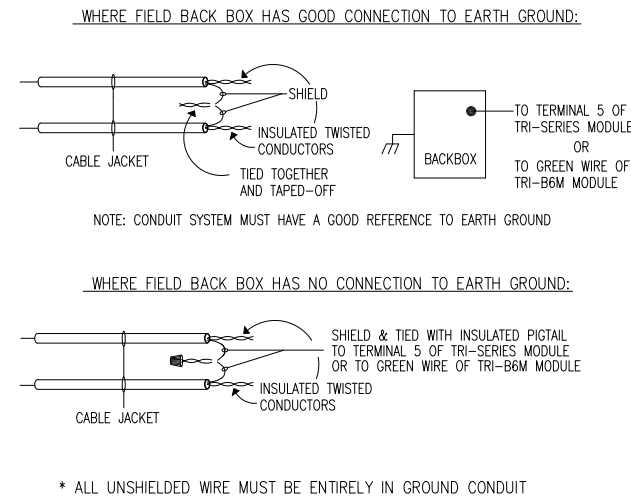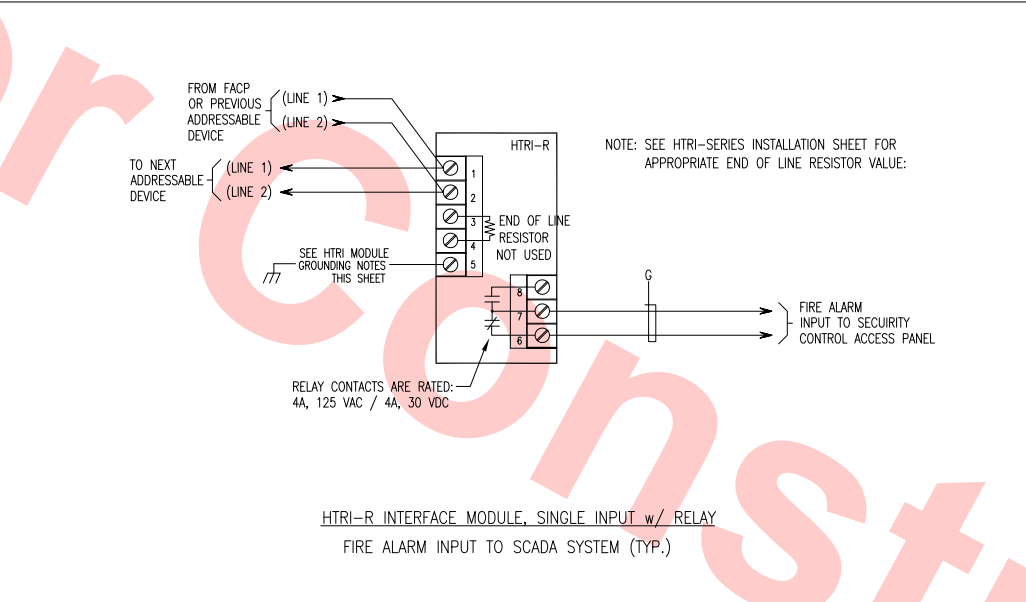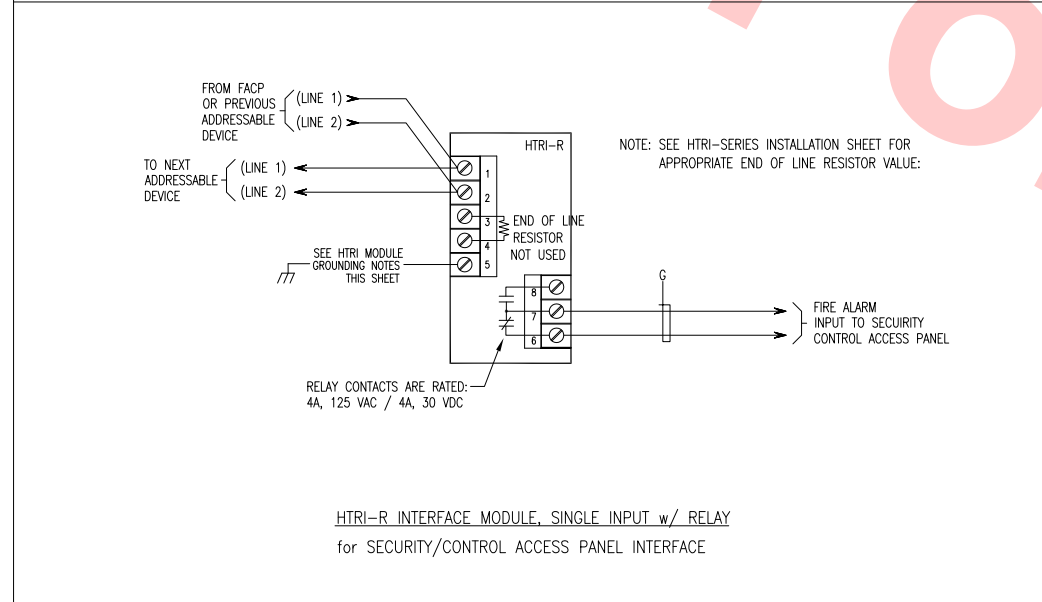

DESIGNED BY V. SINGH
DRAWN BY V. SINGH
CHECKED BY F. CASABONNE
IN CHARGE F. CASABONNE
DATE 20130125

REV	DATE	BY	SUB	APP	DESCRIPTION
20130125					DEFINITIVE DESIGN

Skanska Shimmick Herzog	1436 California Circle Milpitas, California 95035 A Joint Venture
SIEMENS Industry, Inc. Fire Safety Division	Lookwood, Andrews & Newnam, Inc. A LEO A DALY COMPANY
SUBMITTED	APPROVED

NOT FOR CONSTRUCTION

BART SILICON VALLEY

BART SILICON VALLEY BERRYESSA EXTENSION


LINE, TRACK, STATIONS AND SYSTEMS MILPITAS STATION			
FIRE ALARM FIELD DEVICES WIRING DETAILS PART-3			
CADD FILENAME C700-S-DB-E756.dwg	SIZE D	SCALE NONE	CONTRACT NO. C700
AREA CODE DB	SHEET NO. E756	REV.	PAGE NO.

ROOF LEVEL

MEZZANINE LEVEL

MEZZANINE LEVEL

CONCOURSE LEVEL

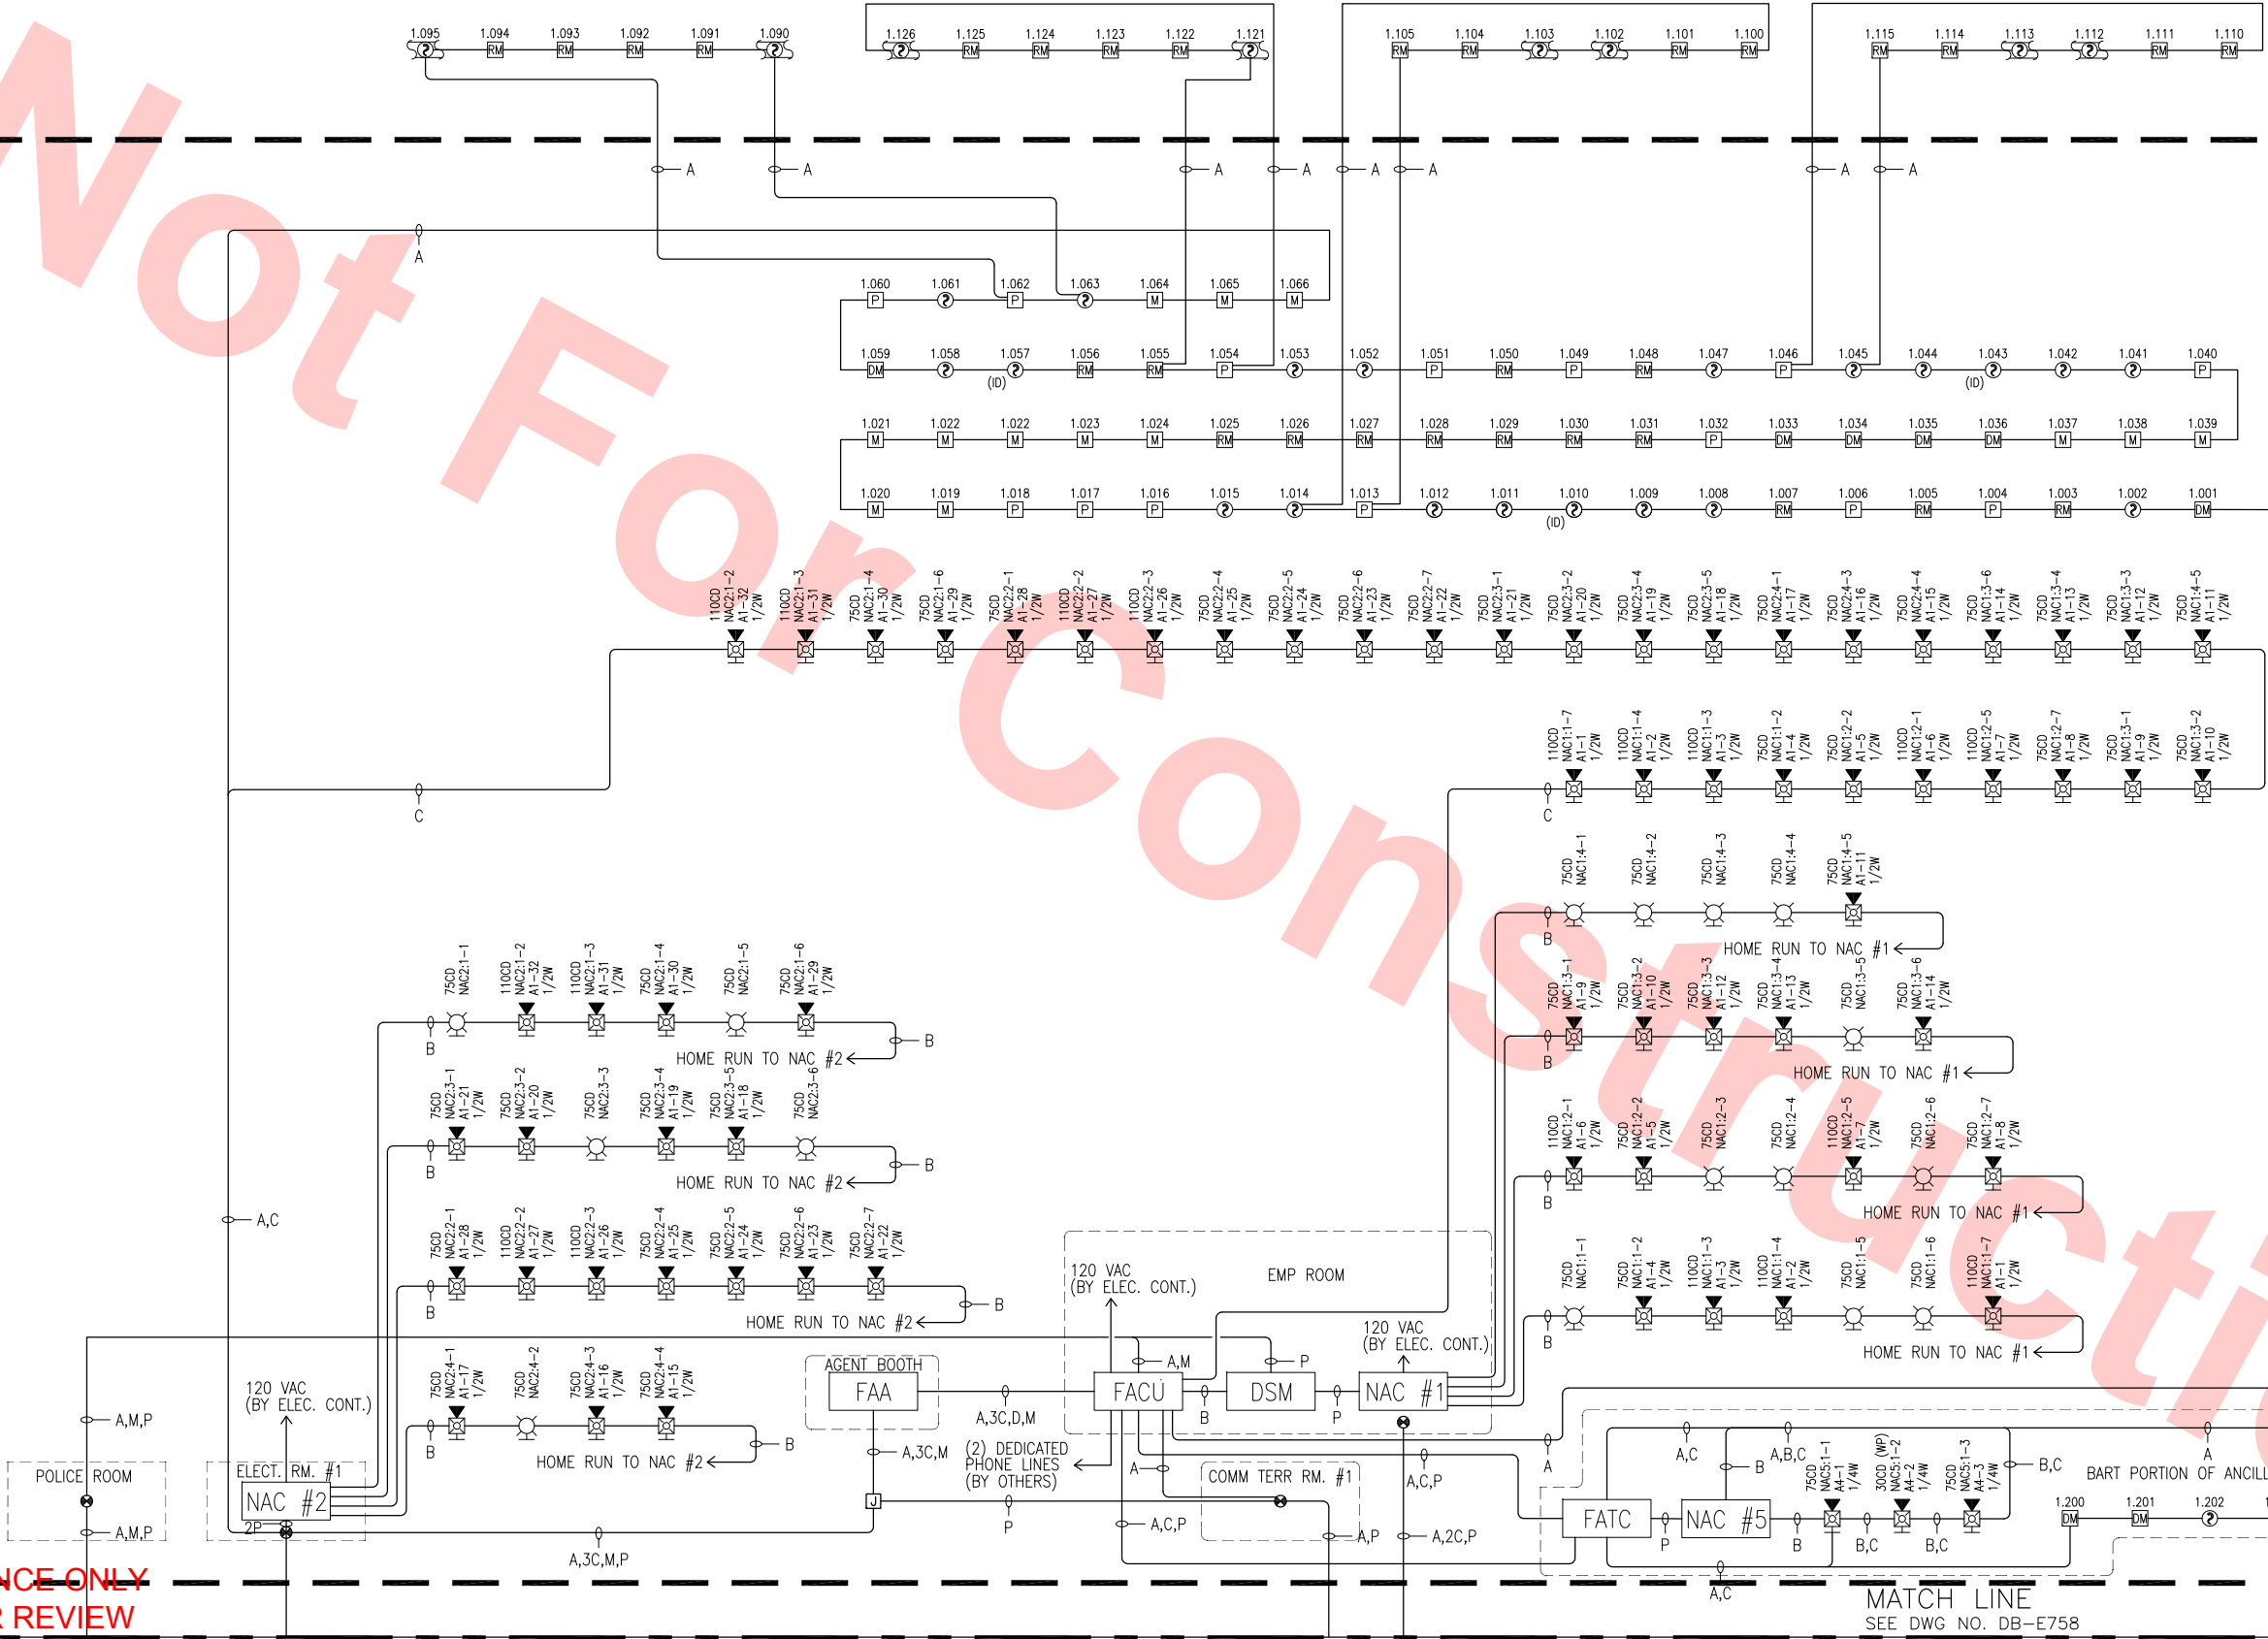

FOR REFERENCE ONLY
AND NOT FOR REVIEW

CONCOURSE LEVEL

MATCH LINE
SEE DWG NO. DB-E758

PLATFORM LEVEL

Jan 23, 2013 - 6:11pm K:\FS\Engineering\California Projects\BART\Bart-VTA\Milpitas Station S40\C700-S-DB-E757.dwg

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Fire Safety Division
SUBMITTED

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Shimmick
Herzog**

1436 California Circle
Milpitas, California 95035
A Joint Venture

**Lookwood, Andrews
& Newnam, Inc.**

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T-Y-LIN INTERNATIONAL

NOT FOR
CONSTRUCTION

**BART
SILICON VALLEY**

BART SILICON VALLEY BERRYESSA EXTENSION

LINE, TRACK, STATIONS AND SYSTEMS
MILPITAS STATION

FIRE ALARM
RISER DIAGRAM
PART-1

CADD FILENAME C700-S-DB-E757.dwg	
SIZE D	SCALE NONE
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