



SSH JV

Milpitas Station Design Unit 023 Readiness for Construction Systems

SVBX C700

Wednesday, July 10, 2013

HALF SIZE
COPY



TYLIN INTERNATIONAL
engineers | planners | scientists

WARM SPRINGS PROJECT					SILICON VALLEY BERRYESSA EXTENSION					CABINET DESIGNATION					CABINET DESIGNATION (CONT'D)					SPLICE BOX MANHOLE & PULLBOX DESIGNATION									
DESIGNATION		FACILITY			DESIGNATION		FACILITY			CABINETS 1 THROUGH 19 – TRAIN CONTROL					TRACTION POWER SUBSTATION/GAP BREAKER CABINET DESIGNATORS					PH 123									
WSX		WARM SPRINGS EXTENSION			PASSENGER STATIONS		S30 SOUTH CALAVERAS STATION (OPTIONAL) S40 MILPITAS STATION S50 BERRYESSA STATION			1 – AUTOMATIC TRAIN CONTROL TERMINATIONS 2–3 – TRACK CIRCUITS AND LOGIC 5 – TRAIN CONTROL SUPERVISORY & CONTROL (BASIC STATION ATO) 6–10 – TRACK CIRCUITS AND LOGIC 11–19 – INTERLOCKING					A01 – 34.5KV SWITCHGEAR CUBICLE NO. 1 A02 – 34.5KV SWITCHGEAR CUBICLE NO. 2 AUX01 – 34.5KV SWITCHGEAR AUXILIARY CUBICLE NO. 1 AUX02 – 34.5KV SWITCHGEAR AUXILIARY CUBICLE NO. 2 B01 – 1000V DC CIRCUIT BREAKER CUBICLE NO. 1 B02 – 1000V DC CIRCUIT BREAKER CUBICLE NO. 2 C02 – CONTROL & ANNUNCIATOR PANEL C03 – FIBER DISTRIBUTION PANEL D01 – 125V DC DISTRIBUTION PANEL D02 – BATTERY D03 – BATTERY CHARGER D05 – BATTERY DISCONNECT F01 – FIRE PROTECTION PANEL G01 – NEGATIVE GROUNDING DEVICE CABINET GTS – GROUND TEST STATION HC02 – HIGH VOLTAGE SUBSTATION CONTROL & ANNUNCIATOR PANEL					THE FIRST DIGIT OF THE 3–DIGIT NUMBER IS THE SAME NUMBER AS THE FIRST DIGIT OF THE NEAREST STATION ON THE INBOUND SIDE. THE LAST TWO DIGITS INCREASE SEQUENTIALLY, BEGINNING WITH "01". MANHOLES/PULLBOXES BRANCHING OFF A MAIN RUN HAVE THE SAME NUMBER AS THE MAIN MANHOLE/PULLBOX WITH A SUFFIX LETTER ADDED, BEGINNING WITH "A". PH – 34.5KV MANHOLES/PULLBOXES PP – DC POSITIVE MANHOLES/PULLBOXES PN – DC NEGATIVE MANHOLES/PULLBOXES PL – AUXILIARY POWER MANHOLES/PULLBOXES CC – COMMUNICATION MANHOLES/PULLBOXES TC – TRAIN CONTROL/COMMUNICATION MANHOLES/PULLBOXES									
S10		OPTIONAL IRVINGTON STATION			TRACKS		S1 WARM SPRINGS STATION TO BERRYESSA STATION S2 BERRYESSA STATION TO WARM SPRINGS STATION			CABINETS 20 THROUGH 29 – COMMUNICATIONS AND ATC					L01 – 208/120V AC DISTRIBUTION PANEL NO. 1 L02 – 208/120V AC DISTRIBUTION PANEL NO. 2 NB01 – NEGATIVE BUS ENCLOSURE P01 – 480V AC, 3Ø, SWITCHBOARD W/ATS S01 – 34.5KV DISCONNECT SWITCH NO. 1 TTC – TRANSFER TRIP CABINET X01 – RECTIFIER TRANSFORMER NO. 1 X02 – RECTIFIER TRANSFORMER NO. 2 X11 – AUXILIARY POWER TRANSFORMER X12 – ISOLATION POWER TRANSFORMER Y01 – YARD CONTROL BOARD Z01 – RECTIFIER NO. 1 Z02 – RECTIFIER NO. 2					CABLE TRAY & BUSWAY DESIGNATION									
S20		WARM SPRINGS STATION			HIGH VOLTAGE SUBSTATIONS (HVSS)		SRC RAILROAD COURT SLP LAS PLUMAS AVENUE			CABINETS/POWER PANELS 30 THROUGH 39 – POWER EQUIPMENT					CONDUIT DESIGNATIONS					34.5KV CABLE DESIGNATION									
SECTIONALIZING STATIONS		SWS WARM SPRINGS STATION			SECTIONALIZING STATIONS (SES)		SME MONTAGUE EXPWY.			30 – BATTERY 31 – BATTERY CHARGER 32 – INVERTER/STATIC BY–PASS 33H – POWER DISTRIBUTION SWITCHBOARD/PANEL 480V 34NA – LOW VOLTAGE PANEL BOARD – NON–ESSENTIAL 34EA – LOW VOLTAGE PANEL BOARD – ESSENTIAL 35 – SWITCH MACHINE POWER 36A – 480 VOLT DISTR PANEL (ESSENTIAL) 36B – 480 VOLT DISTR PANEL (NON–ESSENTIAL) 37A – 120 VOLT DISTR PANEL (ESSENTIAL, TC) 37B – 120 VOLT DISTR PANEL (ESSENTIAL, TC & C) 37C – 120 VOLT WAYSIDE SPSC DISTR PANEL (NON–ESSENTIAL) 37D – 120 VOLT COMM DISTR PANEL (NON–ESSENTIAL) 38 – 12V DC, 28V DC, 110V DC 38A – 28V DC					CONDUIT SYSTEM DESCRIPTION 1KXXX 34.5 KV SYSTEM 2KXXX 1000V DC SYSTEM 3KXXX 120–480V LIGHTING & AUX PWR 4KXXX TRAIN CONTROL SYSTEM 5KXXX COMMUNICATIONS 6KXXX CONTROL POWER, 48–125V DC 7KXXX FIRE ALARM CONTROL / ANNUNCIATION LESS THAN 48V 8KXXX 4.16KV POWER SYSTEM 9KXXX COMMERCIAL TELECOMMUNICATIONS					CONDUIT NUMBERING					S LC				
TRACTION POWER SUBSTATION		SFM FREMONT STATION SPP PASEO PADRE SBR BLACOW ROAD SWS WARM SPRINGS STATION			SWITCHING STATIONS (SWS)		SRR RAILROAD COURT SSL LAS PLUMAS AVENUE			CABINETS 40 THROUGH 49 – STATION COMMUNICATIONS/ PA/TRAIN DESTINATION					LA17/1 LA17/2 LA17/3–JB1 LA17/4 LA17/5–LA17A JB1/1 JB1/2					CABLE NUMBER CABLE DESTINATION CABLE ORIGINATION PH – 34.5 KV PP – DC POSITIVE PN – DC NEGATIVE PL – AUXILIARY POWER CC – COMMUNICATIONS TC – TRAIN CONTROL									
GAP BREAKER STATION		SXA AUTO MALL PKWY			TRACTION POWER SUBSTATIONS (TPSS)		SWA WARREN AVENUE SKR KATO ROAD SRR RAILROAD COURT SME MONTAGUE EXPWY. SHO HOSTETTER ROAD SBE BERRYESSA STATION			CABINETS 50 THROUGH 59 – AUX POWER/STATION LIGHTING/SIGN CONTROLS					LEGEND: LA17 /5–LA17A					INTERFACILITY FIBER CABLE DESIGNATION									
TRAIN CONTROL ROOMS/HOUSE		S06 PASEO PADRE TH S10 IRVINGTON STATION S20 WARM SPRINGS STATION			TRAIN CONTROL HOUSES (TCH)		S24 WARREN AVENUE S26 KATO ROAD S28 RAILROAD COURT S44 SOUTH OF HOSTETTER ROAD			CABINETS 60 THROUGH 69 – LOCAL CONTROL/TC VENTILATION/SUP CONTROL					WHERE: LA17 – UPSTREAM PANEL 5 – CONDUIT NUMBER FROM UPSTREAM PANEL LA17A – DOWNSTREAM PANEL (WHERE APPLICABLE)					1. ASSIGNMENT OF NUMBERS TO CONDUITS SHALL START FROM TOP TO BOTTOM ON THE LEFT SIDE OF THE PANEL AND INCREASING IN COUNTER–CLOCKWISE ROTATION.									
INTERLOCKING		S07 PASEO PADRE S15 AUTO MALL PKWY S21 WARM SPRINGS TAIL TRACKS			INTERLOCKINGS		S25 KATO ROAD S27 SOUTH OF ABEL STREET S29 SOUTH OF CALAVERAS BLVD S37 NORTH OF MILPITAS STATION S45 NORTH OF BERRYESSA STATION S55 SOUTH OF BERRYESSA STATION			CABINETS 70 THROUGH 79 – TRAIN CONTROL TEST & SIMULATION					NOTES:														
VENTILATION STRUCTURES		CPS CENTRAL PARK LES LAKE ELIZABETH			HI–RAIL ACCESS		MW54 CALAVERAS BLVD. MW55 MABURY ROAD			CABINETS 80 THROUGH 89 – (STATION COMPUTERS/LAN)																			
					PUMPING PLANTS (LIFT STATIONS)		SDL DIXON LANDING ROAD SPD GREAT MALL DRIVE STZ NEAR TRADE ZONE BLVD. SHR NEAR HOSTETTER ROAD SLA NEAR LUNDY AVE. & SIERRA ROAD			CABINETS 90 THROUGH 311 – COMM CARRIER/VIDEO REPEATERS/CARRIER PWR SUP																			
															</														

[illegible]

SCHEMATIC/BLOCK DIAGRAM SYMBOLS

LAYOUT SYMBOLS

SYMBOL	DESCRIPTION	SYMBOL	DESCRIPTION	SYMBOL	DESCRIPTION	SYMBOL	DESCRIPTION	SYMBOL	DESCRIPTION
	CIRCUIT BREAKER		INDICATING LAMP <u>LAMP COLOR:</u> A=AMBER B= BLUE G= GREEN R= RED W= WHITE		ARRESTER, GAS TUBE	TELEPHONE SYSTEM DEVICES		MISC SIGNAL SYSTEM DEVICES	
	TRANSFORMER		DISPLAY MONITOR		INTERCOM STATION WITH PUSH-TO-TALK		IPPBX SWITCHBOARD		BUZZER
	GROUND		TELEPHONE JACK		INSULATED COPPER CABLE		IPPBX TELEPHONE * W/IBM TYPE 2 JACK		BELL
	BASE OR REPEATER STATION		LED		FIBER OPTIC CABLE		HANDS FREE COURTESY TELEPHONE		PUSHBUTTON
	JUMPER		BATTERY		COAXIAL CABLE		EMERGENCY TELEPHONE		ANNUNCIATOR
	AMPLIFIER		SPST SWITCH		RADIATING COAXIAL CABLE		MASTER STATION INTERCOMM. TELEPHONE		DOOR OPENER
	RECTIFIER DIODE		SPDT SWITCH		UNSHIELDED TWISTED PAIR CABLE		STATION INTERCOMM. TELEPHONE		ALARM TRIP
	ZENER DIODE		JUNCTION OF CONDUCTORS CONNECTED		SHIELDED TWISTED PAIR CABLE		COURTESY TELEPHONE		DISCONNECT SWITCH
	RELAY COIL		JUNCTION OF CONDUCTORS NOT CONNECTED		SHIELDED CABLE		FIRE TELEPHONE		CONDUIT, EMBEDDED OR CONCEALED
	NORMALLY OPEN RELAY CONTACT		VARISTOR		50 OHM TERMINATION RESISTOR		HOTLINE TELEPHONE		CONDUIT EXPOSED
	NORMALLY CLOSED RELAY CONTACT		PUSH BUTTON		TALK-OUT		ECB - EMERGENCY CALL BOX		CONDUIT, TURNED UP
	FUSE		TELEPHONE SET <u>DESIGNATOR:</u> C=COURTESY E=EMERGENCY F=FIRE ECB=EM CALL BOX PX=PABX PY=PAY (PUBLIC)		TALK-IN		PUBLIC TELEPHONE * W/TDD		CONDUIT, TURNED DOWN
	MICROPHONE (TALK-THRU AT AGENT'S BOOTH)		ANTENNA		PARABOLIC ANTENNA		PUBLIC TELEPHONE (FUTURE)		CONDUIT, TERMINATED & CAPPED
	SPEAKER		DIGITAL MICROWAVE TERMINAL		RADIO WAVES		FLOOR OUTLET FOR TELEPHONE		"LB" CONDUIT BODY
	HEADSET OR HANDSET		COMBINER		HIGH STABILITY MASTER OSCILLATOR		ET - EMERGENCY TELEPHONE SHELF PABX - TELEPHONE SWITCH PCM - PULSE CODE MODULATOR		"T" CONDUIT BODY
	FOOTSWITCH		CROSSBAND COUPLER		POWER SPLITTER (50/50 RATIO)	VISUAL COMMUNICATION SYSTEM DEVICES			JUNCTION BOX
	CROSS-CONNECT		DIRECTIONAL COUPLER		BROADBAND DIRECTIONAL ANTENNA		CCTV CAMERA OUTLET		PULL BOX
	CABLE PAIR PROTECTOR						CCTV CAMERA WITH ENCLOSURE AND PTZ		TERMINAL CABINET
	CABLE SPLICE						PENDANT MOUNTED CCTV CAMERA WITH ENCLOSURE AND PTZ		DISTRIBUTED ANTENNA SYSTEM
	CABLE SPLICE WITH CONECTORS						CCTV CAMERA WITH ENCLOSURE		PX AND ET IN LOCKED BOX
	BI-DIRECTIONAL REPEATER/AMPLIFIER						PENDANT MOUNTED CCTV CAMERA WITH ENCLOSURE		RUNAWAY TRAIN ALARM AND FLASHING LIGHT
	JACKFIELD						NON-BFS CCTV CAMERA		AEI LOCATION
	MALE & FEMALE CONNECTORS OR PLUG & JACK						TRAIN DESTINATION SIGN UNIT		SPLICE/TERMINATION BOX
	WIRE TERMINATION						RGB VIDEO AMPLIFIER		WORK AREA OUTLET/SINGLE GANG DOUBLE OUTLET
							PROGRAMMABLE MESSAGE SIGN		WORK AREA OUTLET/SINGLE GANG SINGLE OUTLET
						SOUND SYSTEM DEVICES		TRAIN INFORMATION MONITORS (TIM)	
							AMPLIFIER		TIM FOR PATRON MOUNTED IN SPARE TVM CUBICLE OR IN CAVITY UNDER ESCALATOR
							MICROPHONE		TIM AT STATION AGENT'S BOOTH
							INTERIOR SPEAKER		ROUTER
							INTERIOR SPEAKER W/ VOLUME CONTROL		X-TERMINAL
							EXTERIOR SPEAKER	ACCESS CONTROL SYSTEM (ACS)	
							PENDANT MOUNTED SPEAKER		MAGNETIC CONTACT
							AMBIENT SOUND MONITOR		CARD READER
							CEILING MOUNTED SPEAKER		ELECTRIC LOCK
							PENDANT MOUNTED HORN SPEAKER		
							PA SPEAKER HORN		
							INTERCOM		

Santa Clara Valley Transportation Authority

NO EXCEPTIONS TAKEN (NET)

MAKE CORRECTIONS NOTED (MCN)

AMEND AND RESUBMIT (A/R)


Any action shown above is subject to the terms of the contract and does not relieve the Contractor of any of its obligations under the contract, including design and detailing.

Contract No.: DB11002F

By: _____ Date: _____

Jun 20, 2013 1:39pm C:\projects\mbox-astrolde\mbox34735\c700-5-DB-B002.DWG

DESIGNED BY	M. GOLUCKI
DRAWN BY	B. COOPER
CHECKED BY	B. MENDEZ LORA
IN CHARGE	B. MENDEZ LORA
DATE	20130710
REV	0
DATE	20130710
BY	
SUB	
APP	
DESCRIPTION	READINESS FOR CONSTRUCTION

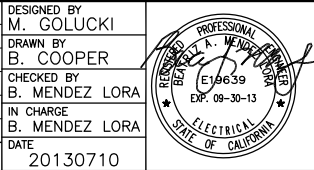

Skanska
Shimmick
Herzog

1436 California Circle
Milpitas, California 95035
A Joint Venture

LTK
LTK Engineering Services

Lockwood, Andrews
& Newnam, Inc.
A LEO A DALY COMPANY

T-Y-LIN INTERNATIONAL

APPROVED
Ray Holmuth



LINE, TRACK, STATIONS AND SYSTEMS
DESIGN UNIT 023
MILPITAS STATION
COMMUNICATIONS SYSTEMS
SYMBOLS

BART SILICON VALLEY BERRYESSA EXTENSION

CADD FILENAME
C700-S-DB-B002.dwg

SIZE
D NONE

CONTRACT NO.
C700


REV.
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AREA CODE
DB

SHEET NO.
B002

PAGE NO.
1020

STAIRWAY EXITS

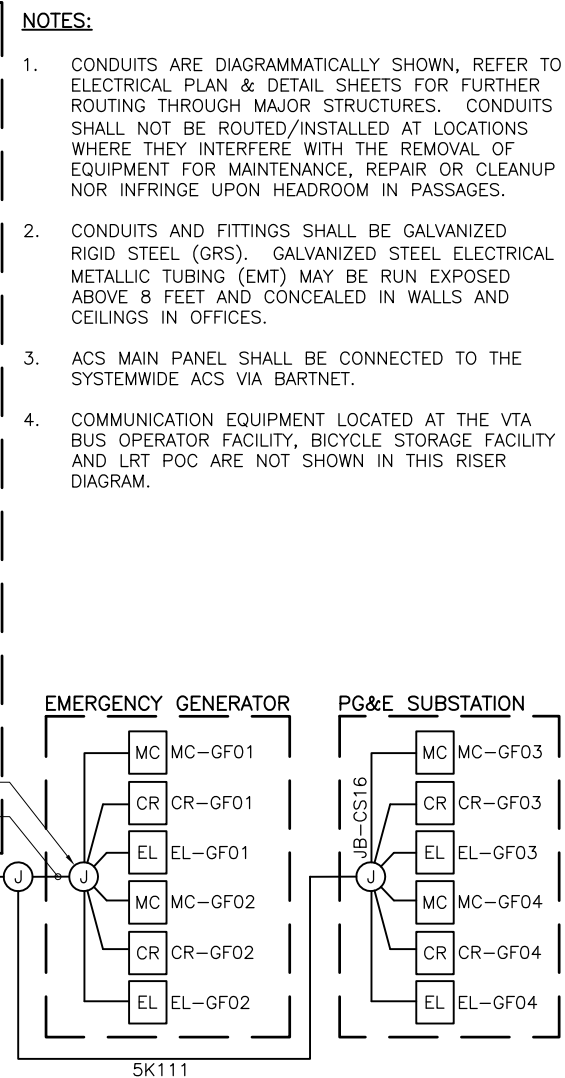

Santa Clara Valley Transportation Authority

_____**NO EXCEPTIONS TAKEN (NET)**_____

_____**MAKE CORRECTIONS NOTED (MCN)**_____

_____**AMEND AND RESUBMIT (A/R)**_____


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Contract No.: _____**DB11002F**_____

By: _____**Date:** _____

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- NOTES:
1. CONDUITS ARE DIAGRAMMATICALLY SHOWN. REFER TO ELECTRICAL PLAN AND DETAIL SHEETS FOR ROUTING DETAIL.
 2. 50 FEET OF COIL FOR EACH CABLE (FIBER AND COPPER) TO BE PROVIDED IN VTA COMM ROOM.



Santa Clara Valley Transportation Authority

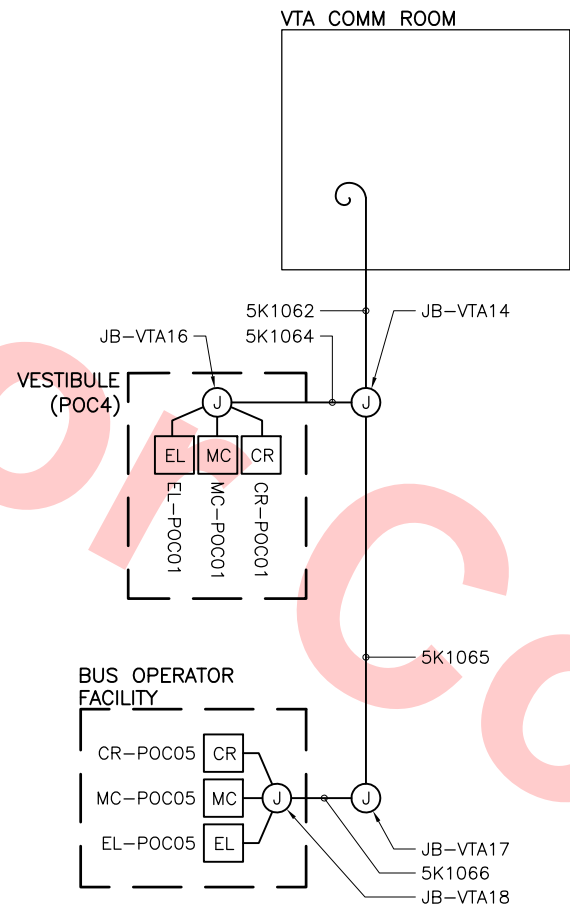NO EXCEPTIONS TAKEN (NET)

MAKE CORRECTIONS NOTED (MCN)


AMEND AND RESUBMIT (A/R)

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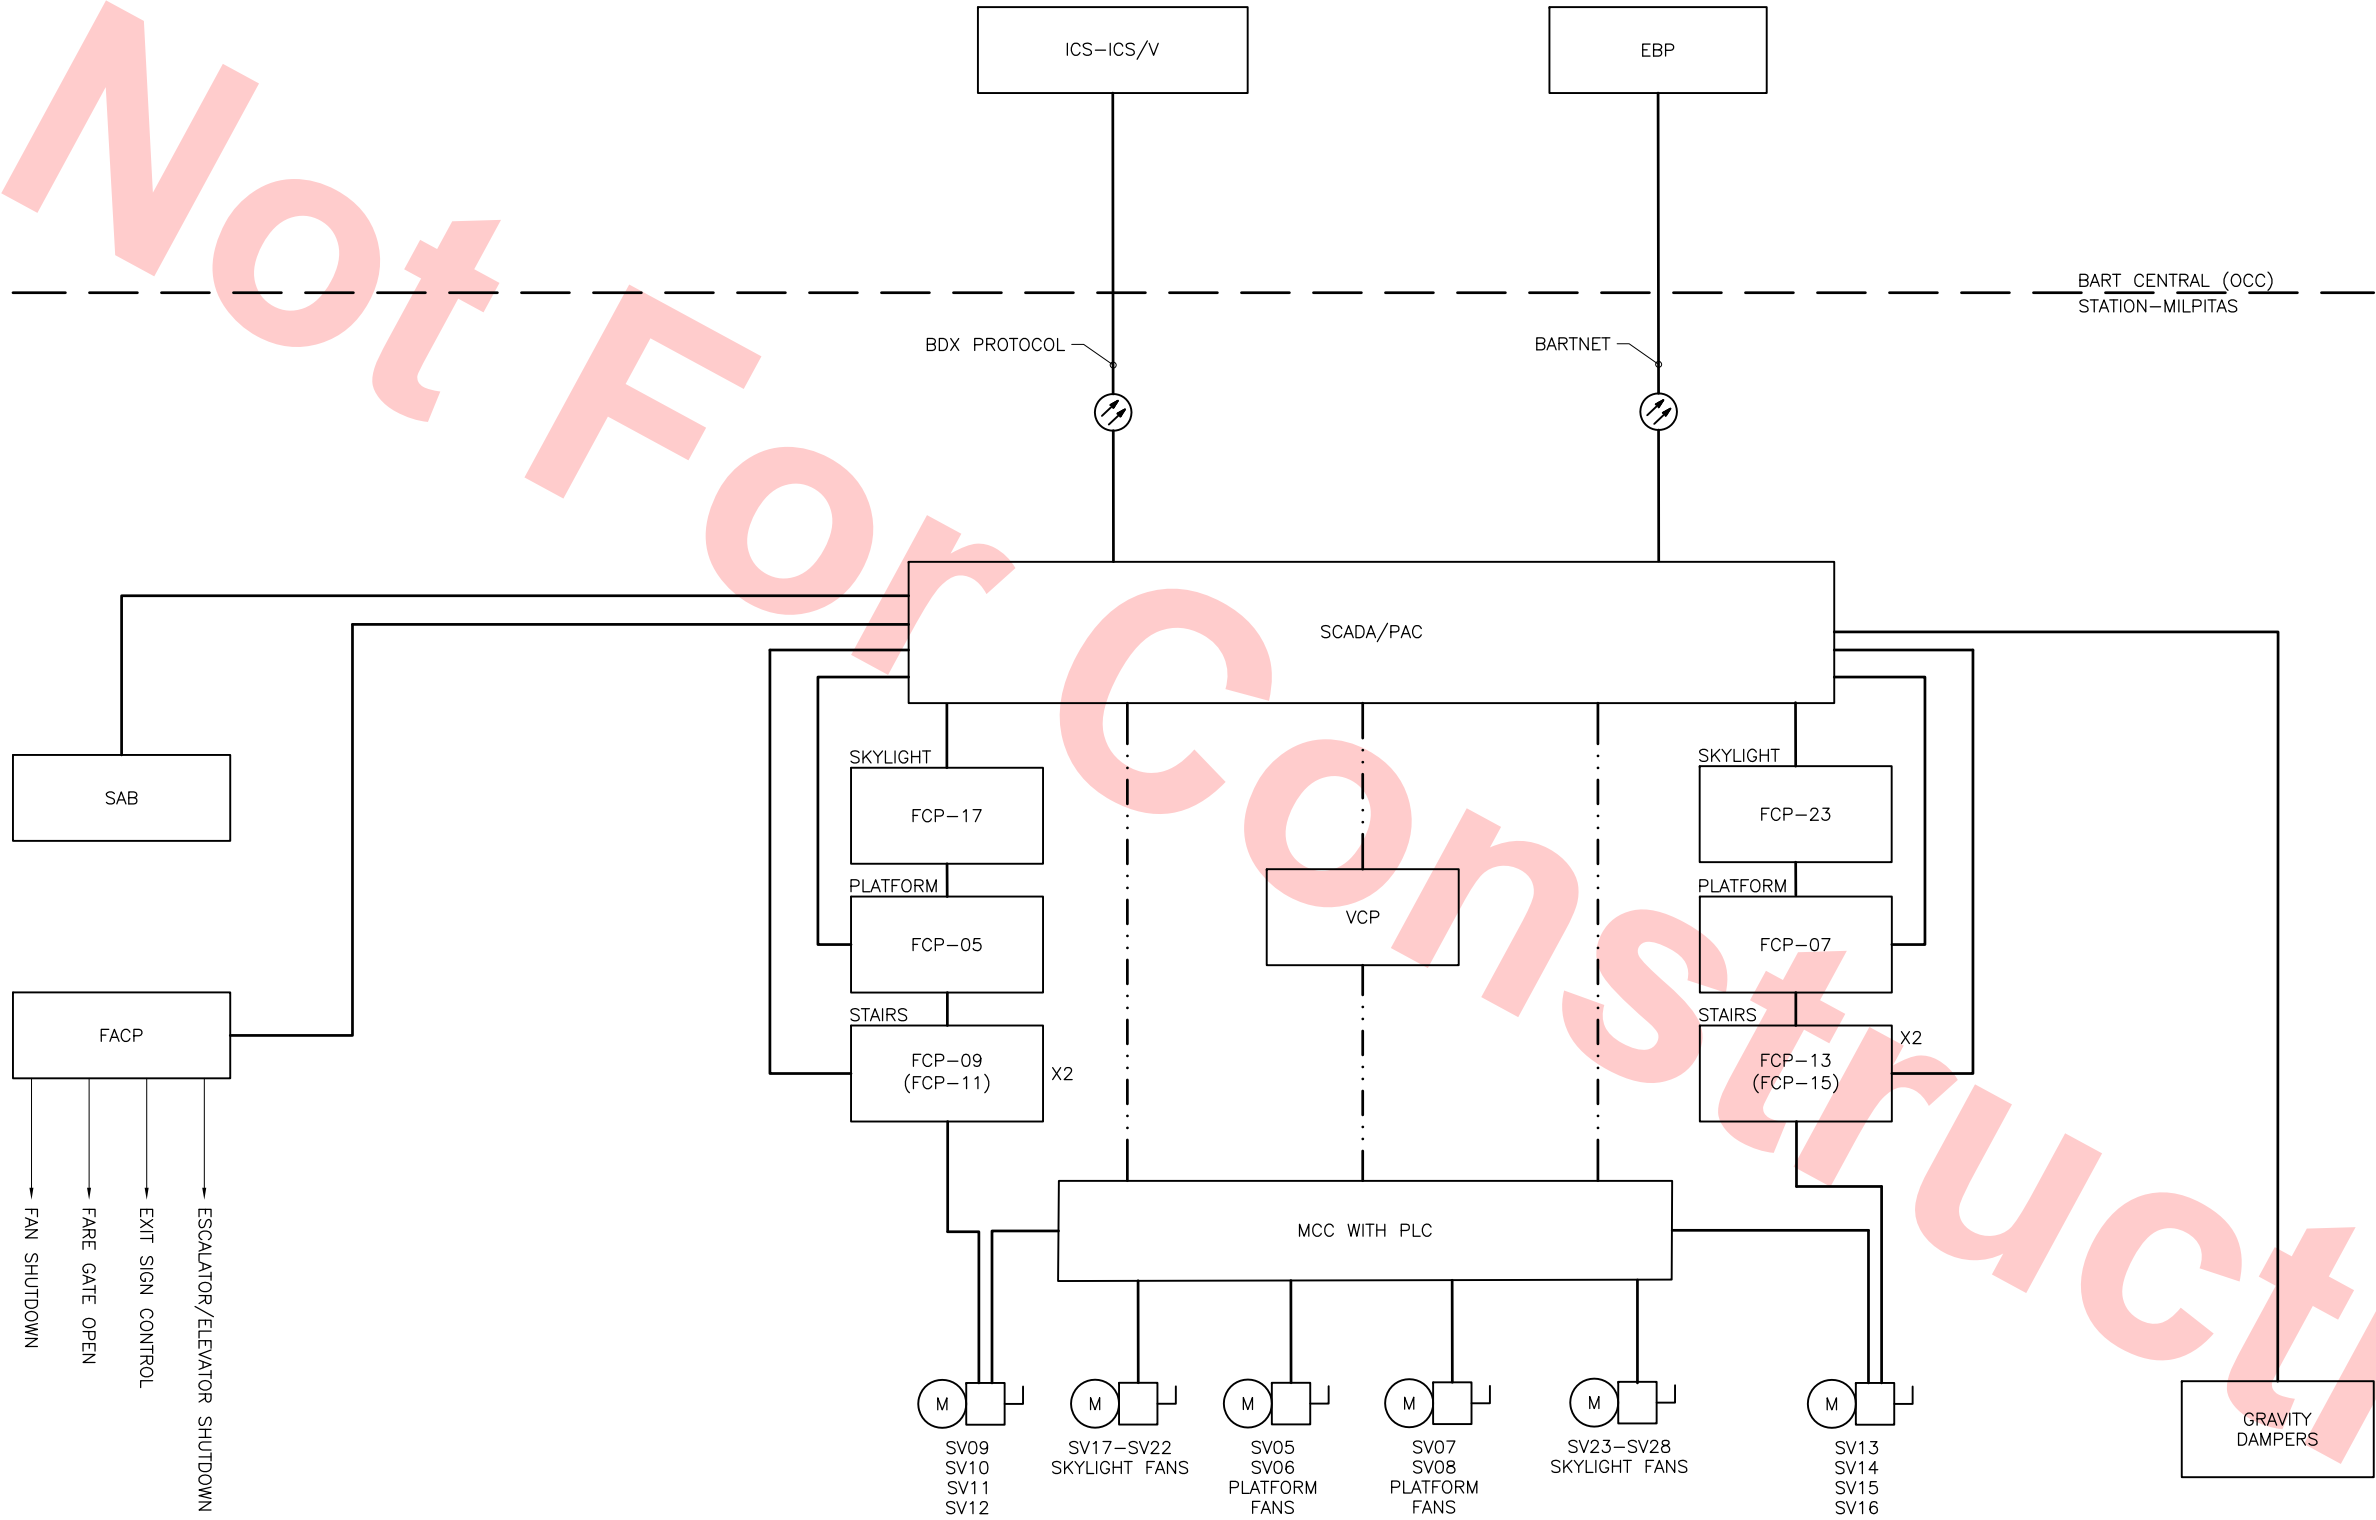
Contract No.: DB11002F

By: _____ Date: _____

						DESIGNED BY M. GOLUCKI		<div>Skanska Shimmick Herzog</div> <div>1436 California Circle Milpitas, California 95035 A Joint Venture</div>		 BART SILICON VALLEY BERRYESSA EXTENSION	<div>LINE, TRACK, STATIONS AND SYSTEMS DESIGN UNIT 023 MILPITAS STATION VTA ACCESS CONTROL SYSTEM RISER DIAGRAM</div>			CADD FILENAME C700-S-DB-H021.dwg		
						DRAWN BY A. SHRODE								SIZE D	SCALE NONE	
						CHECKED BY B. MENDEZ LORA								CONTRACT NO. C700		REV. 0
						IN CHARGE B. MENDEZ LORA								AREA CODE DB	SHEET NO. H021	PAGE NO. 1022
0	20130710				READINESS FOR CONSTRUCTION		LTK Engineering Services		Lookwood, Andrews & Newman, Inc. T-Y LIN INTERNATIONAL							
REV	DATE	BY	SUB	APP	DESCRIPTION	DATE 20130710	SUBMITTED		APPROVED							

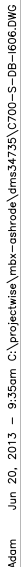

- NOTES:
1. EACH FAN STARTER HAS A LOCAL DISCONNECT SWITCH AND A STARTER LOCATED AT THE MOTOR CONTROL CENTER (MCC). EACH GROUPING OF FANS HAVE A LOCAL FAN CONTROL PANEL (FCP) WITH LOCAL/REMOTE SWITCHES (L/R), START/STOP PUSHBUTTONS AND STATUS INDICATING PILOT LIGHTS. THE FCP'S WILL MONITOR THE POSITION OF THE FAN'S LOCAL DISCONNECT SWITCH (WHETHER IN THE OPEN OR CLOSED POSITION), WHICH WILL ALSO BE MONITORED BACK AT BART CENTRAL THROUGH THE STATION PAC. UNDER NORMAL OPERATIONS, THE FAN LOCAL CONTROL PANEL L/R SWITCHES WILL BE IN THE REMOTE POSITION.
 2. SMOKE EVACUATION SYSTEM SHALL BE MONITORED FROM THE STATION SCADA/PAC. IN AN EVENT, A SIGNAL WILL BE TRANSMITTED FROM THE FACP TO THE SCADA/PAC TO BART CENTRAL. BART CENTRAL WILL INITIATE A SMOKE EVAC START SIGNAL THAT WILL BE TRANSMITTED BACK THROUGH THE STATION PAC TO THE PLC LOCATED AT THE MOTOR CONTROL CENTER (MCC). THE MCC PLC WILL BE PROGRAMMED TO START THE FAN EVACUATION SEQUENCE OF OPERATION – REFER TO MECHANICAL DRAWINGS AND SPECIFICATIONS FOR FURTHER START SEQUENCE.
 3. SHOULD A LOSS IN COMMUNICATION BETWEEN BART CENTRAL AND THE STATION BE LOST, THEN CONTROL OF THE SYSTEM WILL BE THROUGH THE STATION VENTILATION CONTROL PANEL (VCP).
 4. STATUS OF FAN OPERATION FROM THE MCC/PLC WILL BE TRANSMITTED BACK TO BART CENTRAL (INCLUDING ANY FAULTS).
 5. ROUTINE EXERCISING OF THE FANS MAY BE INITIATED LOCALLY AT THE STATION OR REMOTELY AT BART CENTRAL.
 6. ANY MAINTENANCE REQUIRED OF THE FANS, WILL BE LOCALLY AT THE STATION BY PLACING THE L/R SWITCH FOR THE FAN IN THE LOCAL POSITION AND OPENING THE DISCONNECT SWITCH. BART CENTRAL WILL BE ABLE TO MONITOR THE POSITIONS OF THE L/R AND THE DISCONNECT SWITCH AND BE AWARE OF THE FAN MOTOR "OUT OF SERVICE".



Santa Clara Valley Transportation Authority

NO EXCEPTIONS TAKEN (NET)
MAKE CORRECTIONS NOTED (MCN)
AMEND AND RESUBMIT (A/R)

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Contract No.: **DB11002F**

By: _____ Date: _____

Jun 20, 2013 9:35am C:\projects\msh\shrode\msh\34735\700-S-DB-1607.DWG

REV	DATE	BY	SUB	APP	DESCRIPTION
0	20130710				READINESS FOR CONSTRUCTION

DESIGNED BY B. MENDEZ LORA	
DRAWN BY A. SHRODE	
CHECKED BY M. GOLUCKI	
IN CHARGE B. MENDEZ LORA	
DATE 20130710	

Skanska Shimmick Herzog

1436 California Circle
Milpitas, California 95035
A Joint Venture

LTK Engineering Services

Lookwood, Andrews & Newnam, Inc.
A LEON A. BALLY COMPANY

T-Y LIN INTERNATIONAL

SUBMITTED _____ APPROVED _____

BART SILICON VALLEY

BART SILICON VALLEY BERRYESSA EXTENSION

LINE, TRACK, STATIONS AND SYSTEMS

DESIGN UNIT 023


MILPITAS STATION

EMERGENCY VENTILATION SYSTEM

LOGIC DIAGRAM

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SIZE D	SCALE NONE	
CONTRACT NO. C700		REV. 0
AREA CODE DB	SHEET NO. 1607	PAGE NO. 1024

- NOTES:
1. NOT ALL EQUIPMENT SHOWN INSIDE THE STATION AGENT'S BOOTH.
 2. SEE TECHNICAL SPECIFICATION 345011 FOR REQUIREMENTS TO SUPPORT CLIPPER HAND-HELD CARD READER.

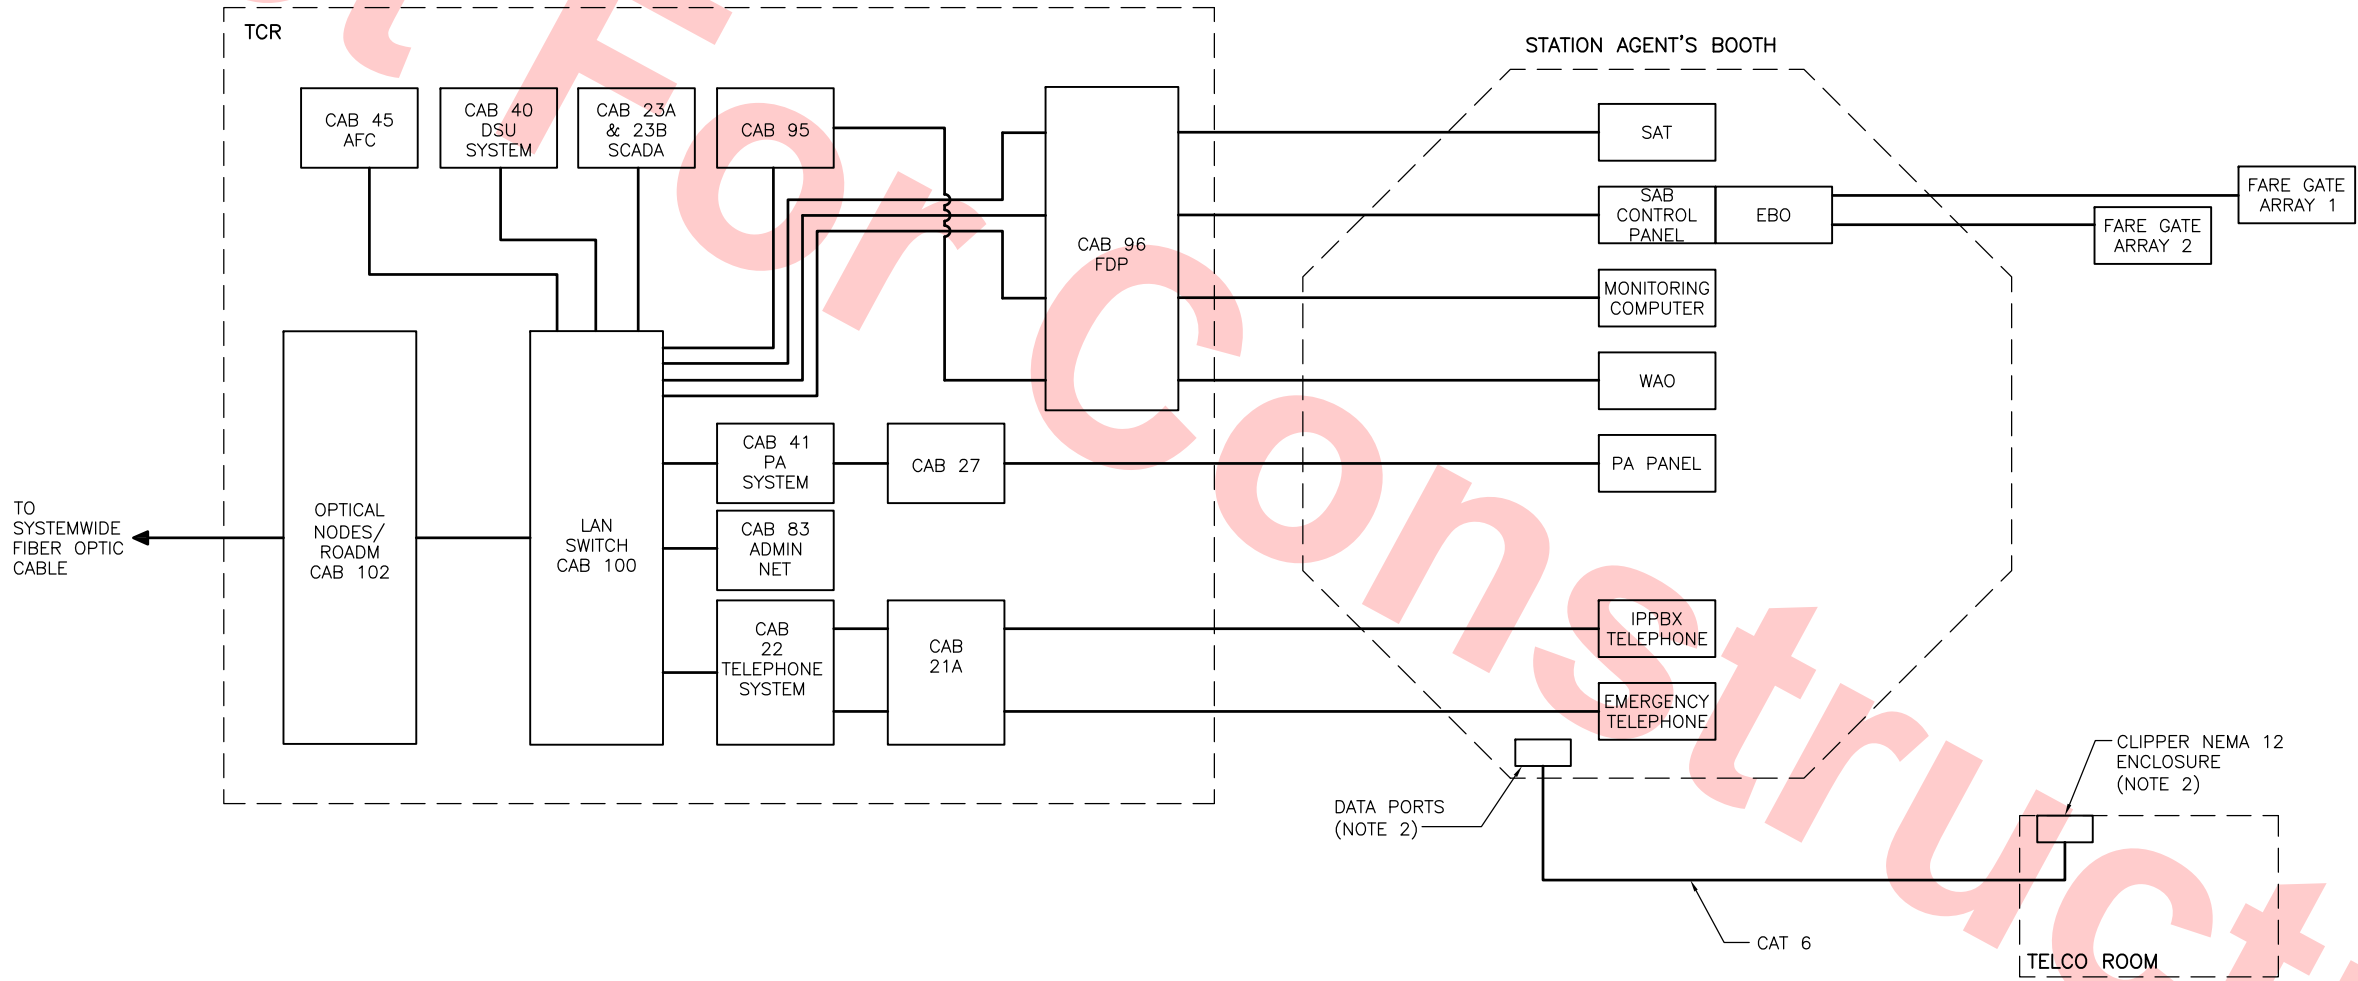

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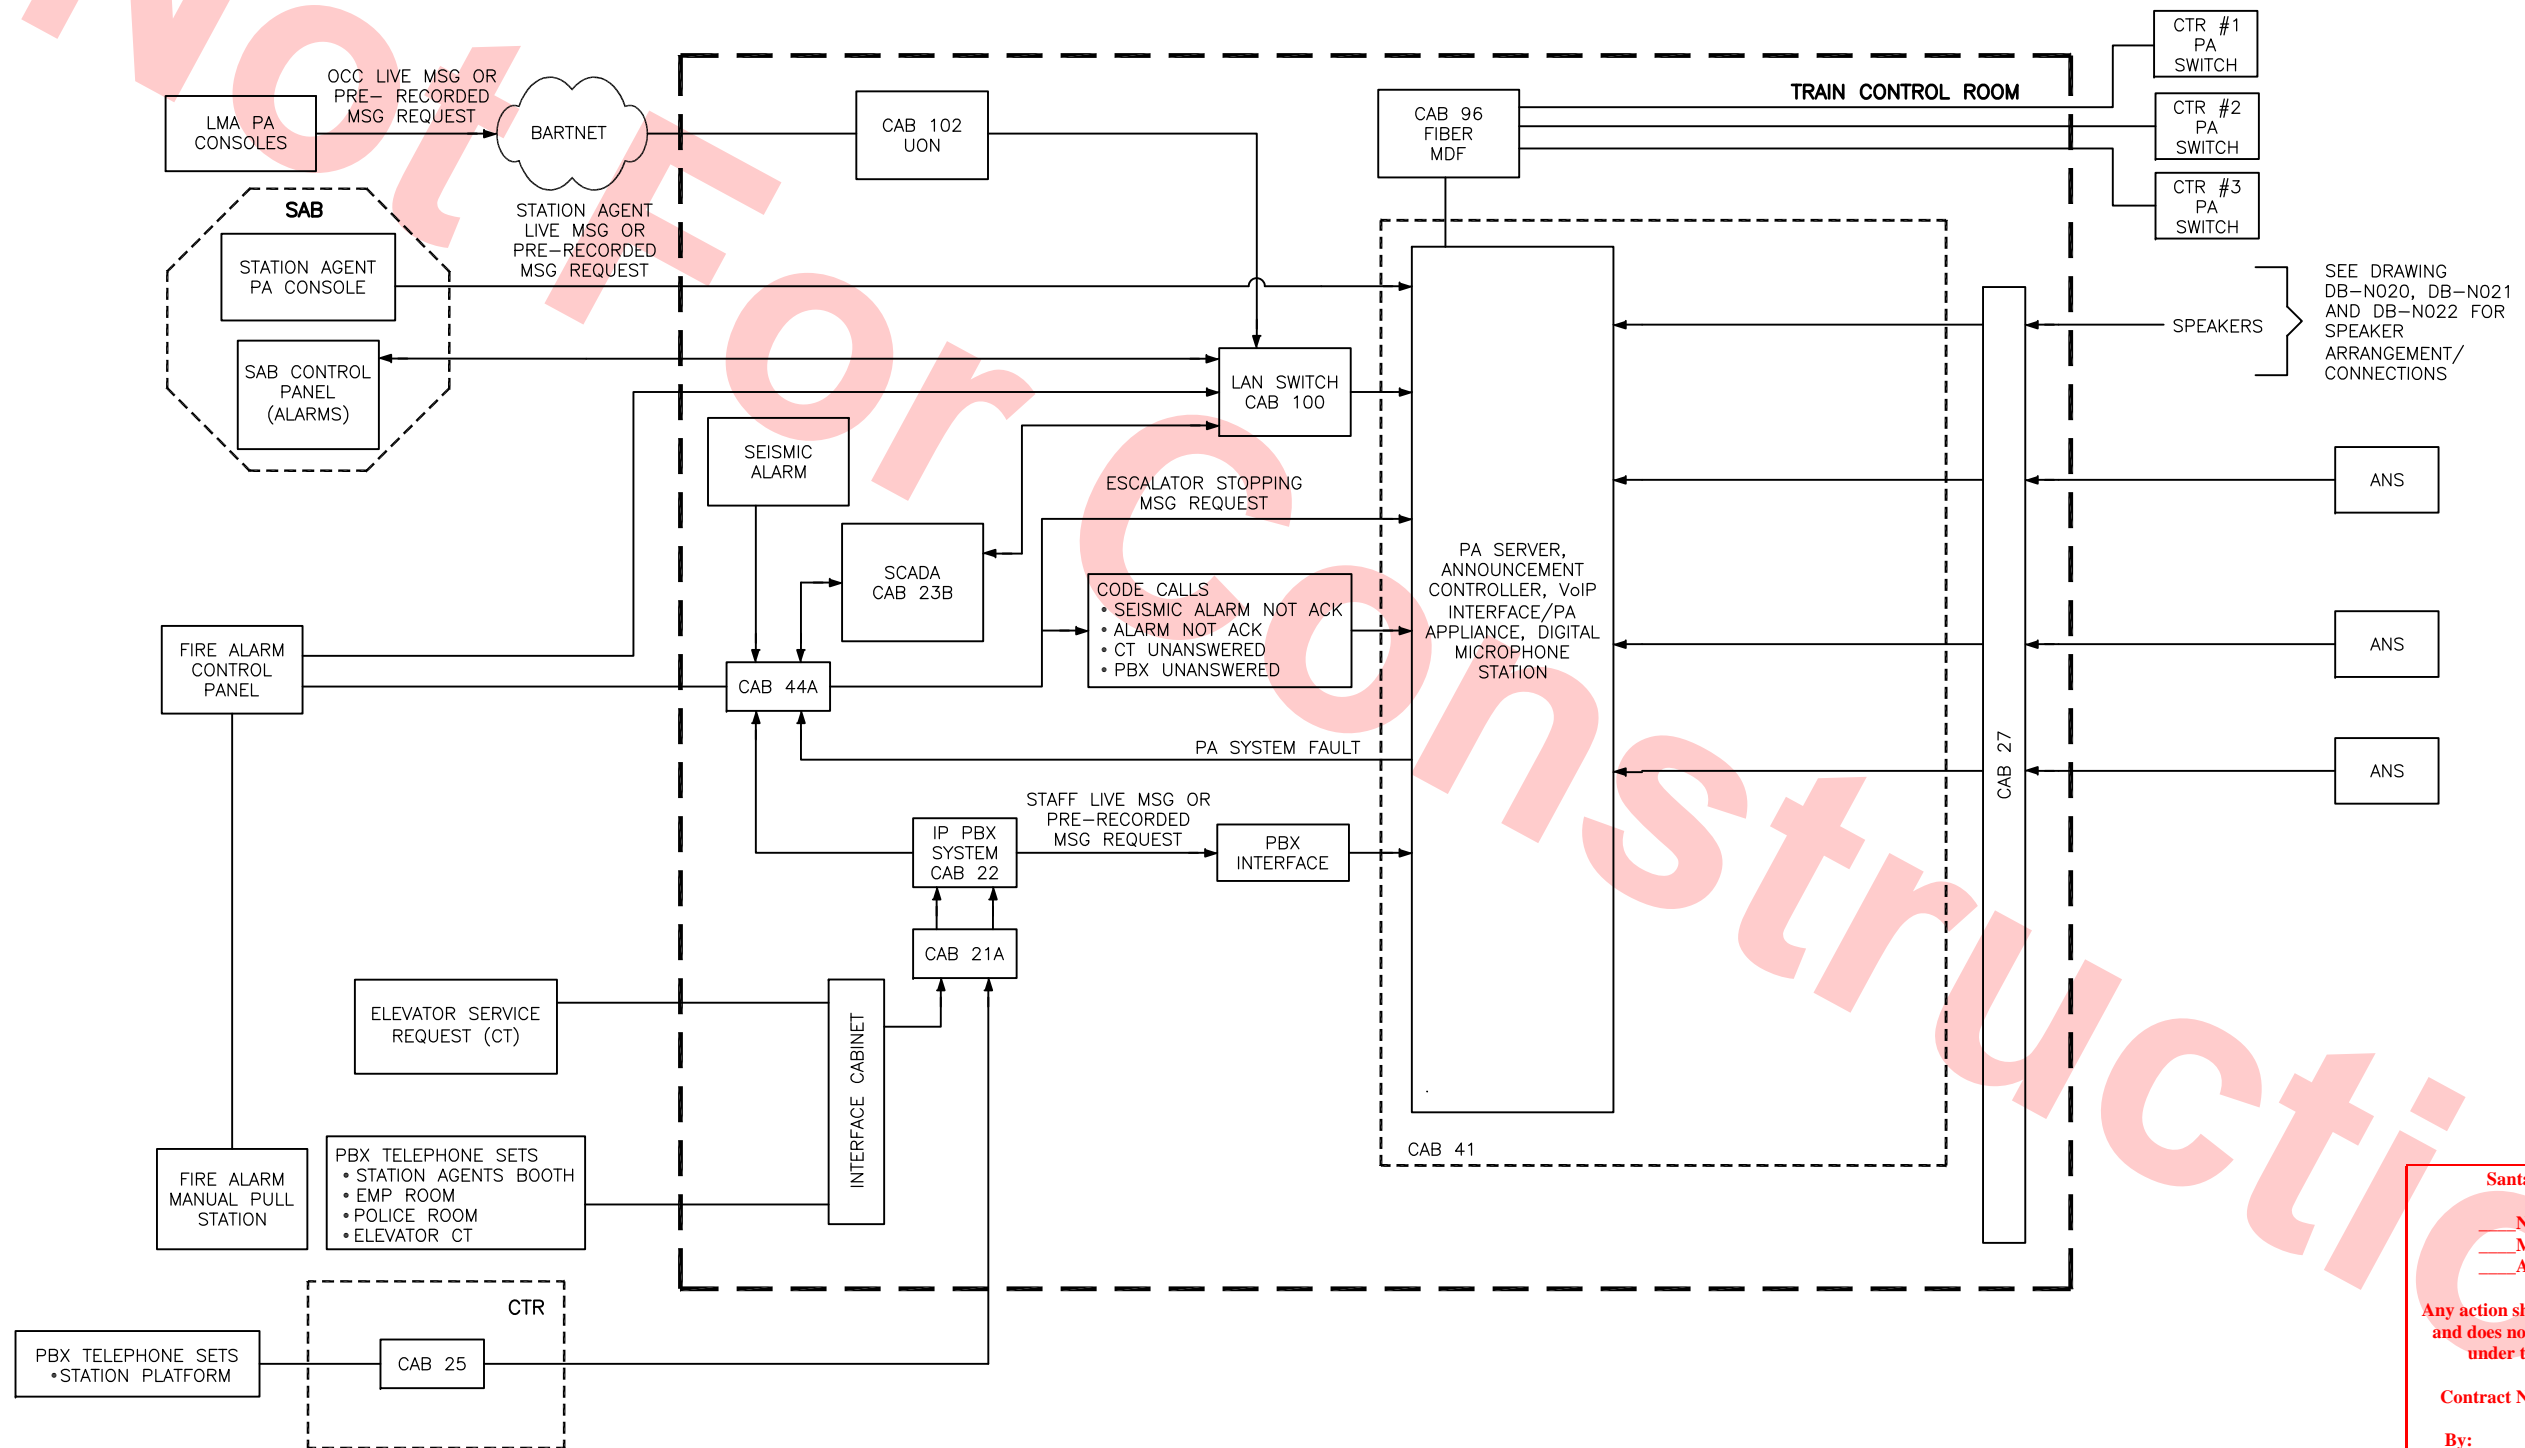
Contract No.: DB11002F

By: _____ Date: _____

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						DESIGNED BY M. GOLUCKI		Skanska Shimmick Herzog		1436 California Circle Milpitas, California 95035 A Joint Venture		 LTK Engineering Services		 T-Y-LIN INTERNATIONAL		 BART SILICON VALLEY BERRYESSA EXTENSION		LINE, TRACK, STATIONS AND SYSTEMS DESIGN UNIT 023 MILPITAS STATION STATION AGENT'S BOOTH BLOCK DIAGRAM				CADD FILENAME C700-S-DB-1622.dwg			
						DRAWN BY B. COOPER																SIZE D	SCALE NONE	CONTRACT NO. C700	REV. 0
						CHECKED BY B. MENDEZ LORA																			
						IN CHARGE B. MENDEZ LORA																			
0	20130710				READINESS FOR CONSTRUCTION	DATE 20130710																			
REV	DATE	BY	SUB	APP	DESCRIPTION		SUBMITTED		APPROVED										AREA CODE DB	SHEET NO. 1622	PAGE NO. 1025				

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SEE DRAWING
DB-N020, DB-N021
AND DB-N022 FOR
SPEAKER
ARRANGEMENT/
CONNECTIONS

Santa Clara Valley Transportation Authority

NO EXCEPTIONS TAKEN (NET)
MAKE CORRECTIONS NOTED (MCN)
AMEND AND RESUBMIT (A/R)


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REV	DATE	BY	SUB	APP	DESCRIPTION
0	20130710				READINESS FOR CONSTRUCTION

DESIGNED BY
M. GOLUCKI
DRAWN BY
B. COOPER
CHECKED BY
B. MENDEZ LORA
IN CHARGE
B. MENDEZ LORA
DATE
20130710



Skanska
Shimmick
Herzog


1436 California Circle
Milpitas, California 95035
A Joint Venture

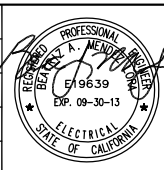LTK
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Lockwood, Andrews
& Newnam, Inc.
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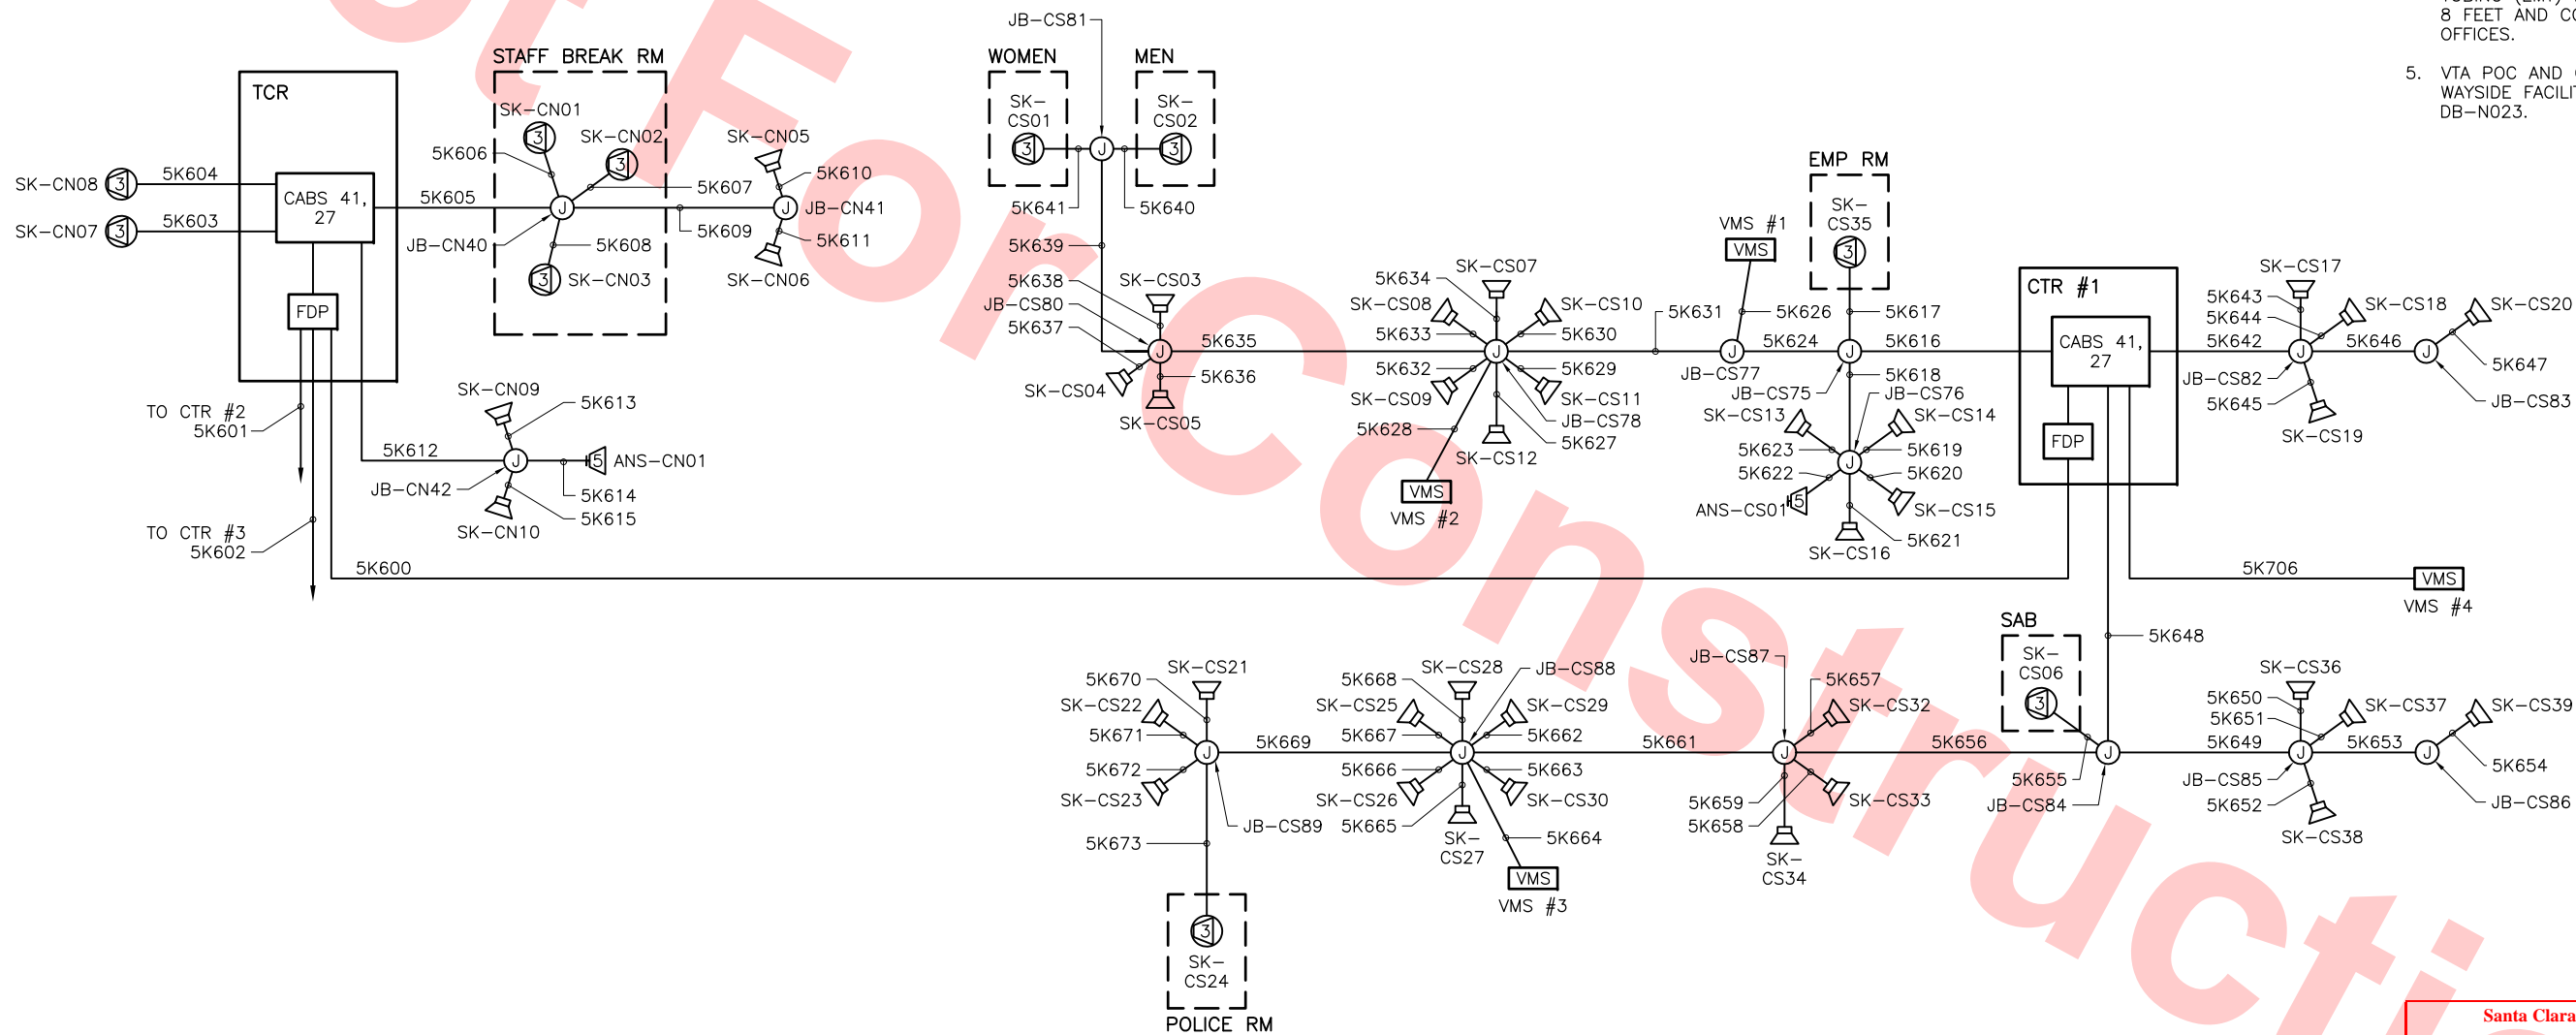
APPROVED
Ray Hollnuth



LINE, TRACK, STATIONS AND SYSTEMS
DESIGN UNIT 023
MILPITAS STATION
PUBLIC ADDRESS SYSTEM
STATION BLOCK DIAGRAM

CADD FILENAME C700-S-DB-N005.dwg	REV. 0
SIZE D	SCALE NONE
CONTRACT NO. C700	PAGE NO. 1026
AREA CODE DB	SHEET NO. N005

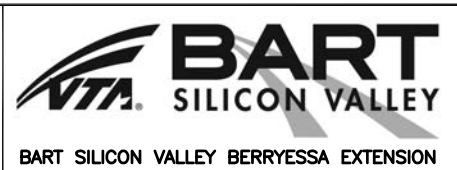- NOTES:**
1. SPEAKER TYPES WILL BE DETERMINED DURING FINAL DESIGN AND TESTING ANALYSIS.
 2. ALL CABLES FROM SPEAKERS TO THE PA SYSTEM EQUIPMENT IN THE TCR AND CTRS; AND ALL CABLES BETWEEN TCR AND CTRS, WILL BE FURNISHED, INSTALLED, TERMINATED, AND TESTED.
 3. CONDUITS ARE DIAGRAMMATICALLY SHOWN. REFER TO ELECTRICAL PLAN AND DETAIL SHEETS FOR ROUTING THROUGH STRUCTURES. CONDUITS WILL NOT BE ROUTED/INSTALLED AT LOCATIONS WHERE THEY INTERFERE WITH THE REMOVAL OF EQUIPMENT FOR MAINTENANCE, REPAIR,OR CLEANUP; NOR INFRINGE UPON HEADROOM IN PASSAGES.
 4. CONDUITS AND FITTINGS WILL BE GALVANIZED RIGID STEEL (GRS). GALVANIZED STEEL ELECTRICAL METALLIC TUBING (EMT) MAY BE RUN EXPOSED ABOVE 8 FEET AND CONCEALED IN WALLS AND CEILINGS IN OFFICES.
 5. VTA POC AND CAMPUS AREA DEVICES AND ROUTING TO WAYSIDE FACILITIES NOT SHOWN. SEE DRAWING DB-N023.



Santa Clara Valley Transportation Authority

NO EXCEPTIONS TAKEN (NET)
MAKE CORRECTIONS NOTED (MCN)
AMEND AND RESUBMIT (A/R)



Any action shown above is subject to the terms of the contract and does not relieve the Contractor of any of its obligations under the contract, including design and detailing.

Contract No.: DB11002F

By: _____ Date: _____

DESIGNED BY M. GOLUCKI					Skanska Shimmick Herzog		1436 California Circle Milpitas, California 95035 A Joint Venture		Lockwood, Andrews & Nowman, Inc. A LEO A DALY COMPANY		T-Y-LIN INTERNATIONAL		BART SILICON VALLEY		LINE, TRACK, STATIONS AND SYSTEMS DESIGN UNIT 023 MILPITAS STATION PUBLIC ADDRESS RISER DIAGRAM CONCOURSE LEVEL		CADD FILENAME C700-S-DB-N020.dwg	
DRAWN BY A. SHRODE					LTK Engineering Services		APPROVED Ray Hollenuth		BART SILICON VALLEY		BART SILICON VALLEY BERRYESSA EXTENSION		SIZE D NONE		CONTRACT NO. C700		REV. 0	
CHECKED BY B. MENDEZ LORA					IN CHARGE B. MENDEZ LORA		DATE 20130710		AREA CODE DB		SHEET NO. N020		PAGE NO. 1027					
DATE 20130710					SUBMITTED		APPROVED											
READINESS FOR CONSTRUCTION																		
DESCRIPTION																		

Jun 20, 2013 - 9:35am C:\projectwise\mbx-aashrode\lma34735\C700-S-DB-N020.DWG

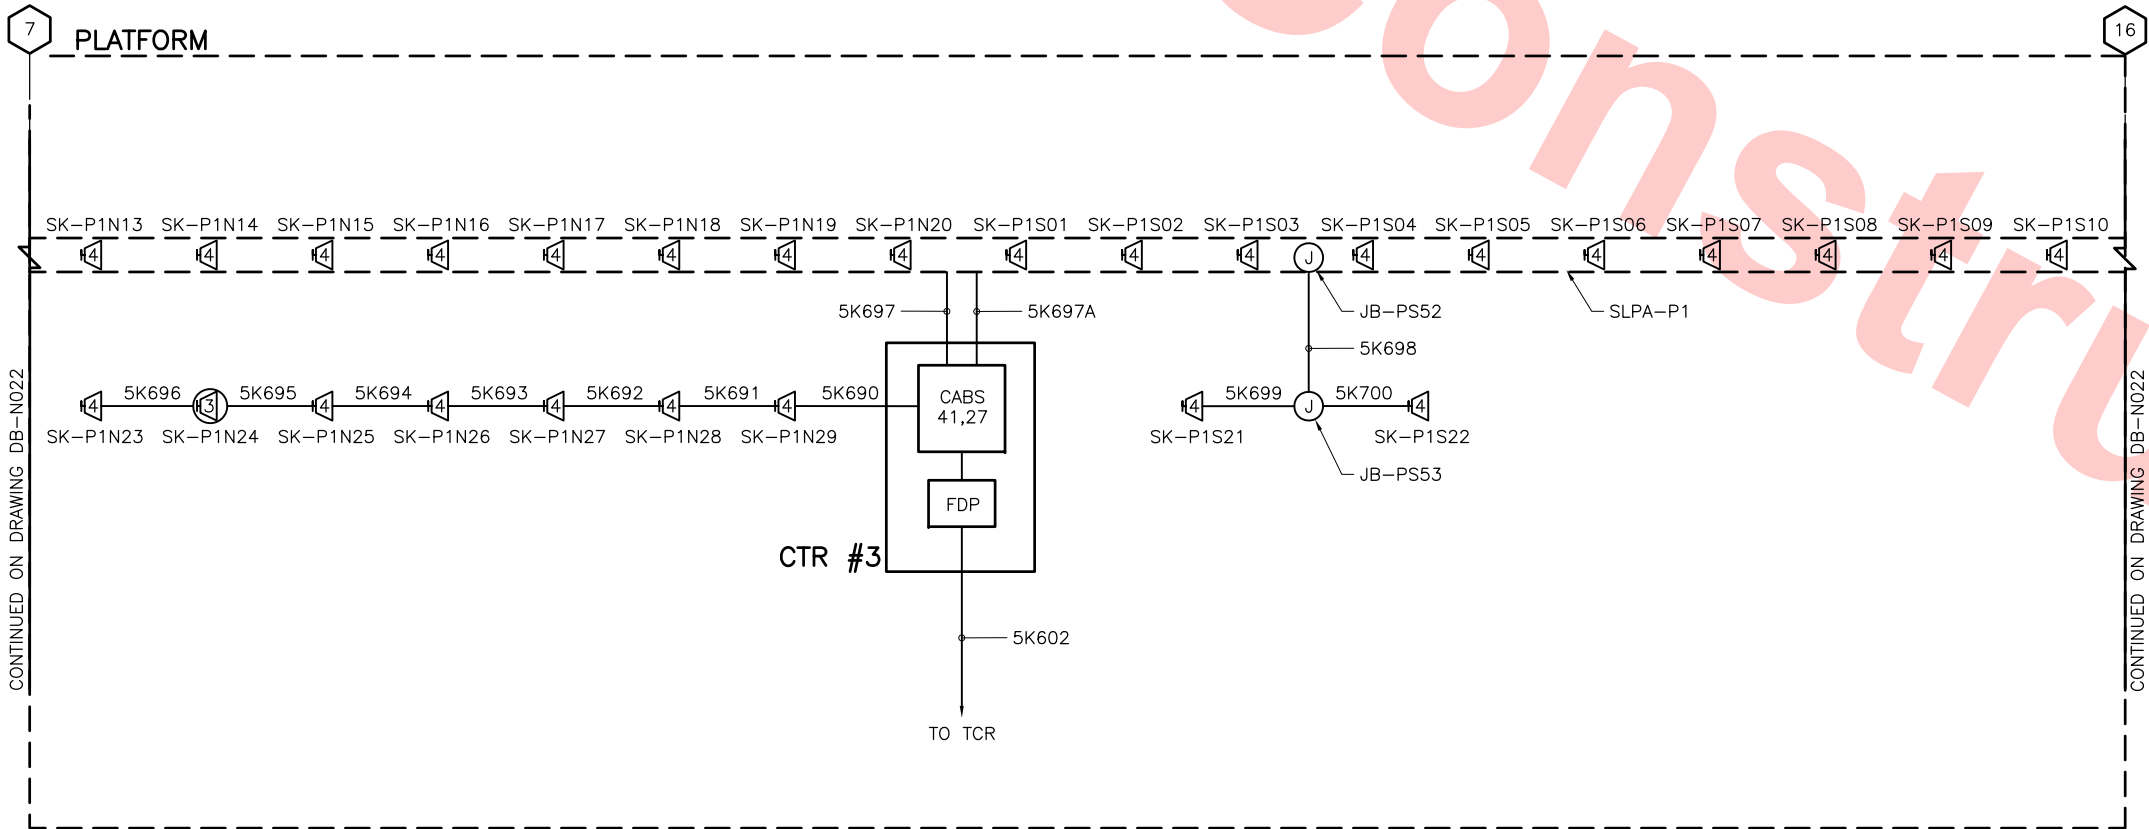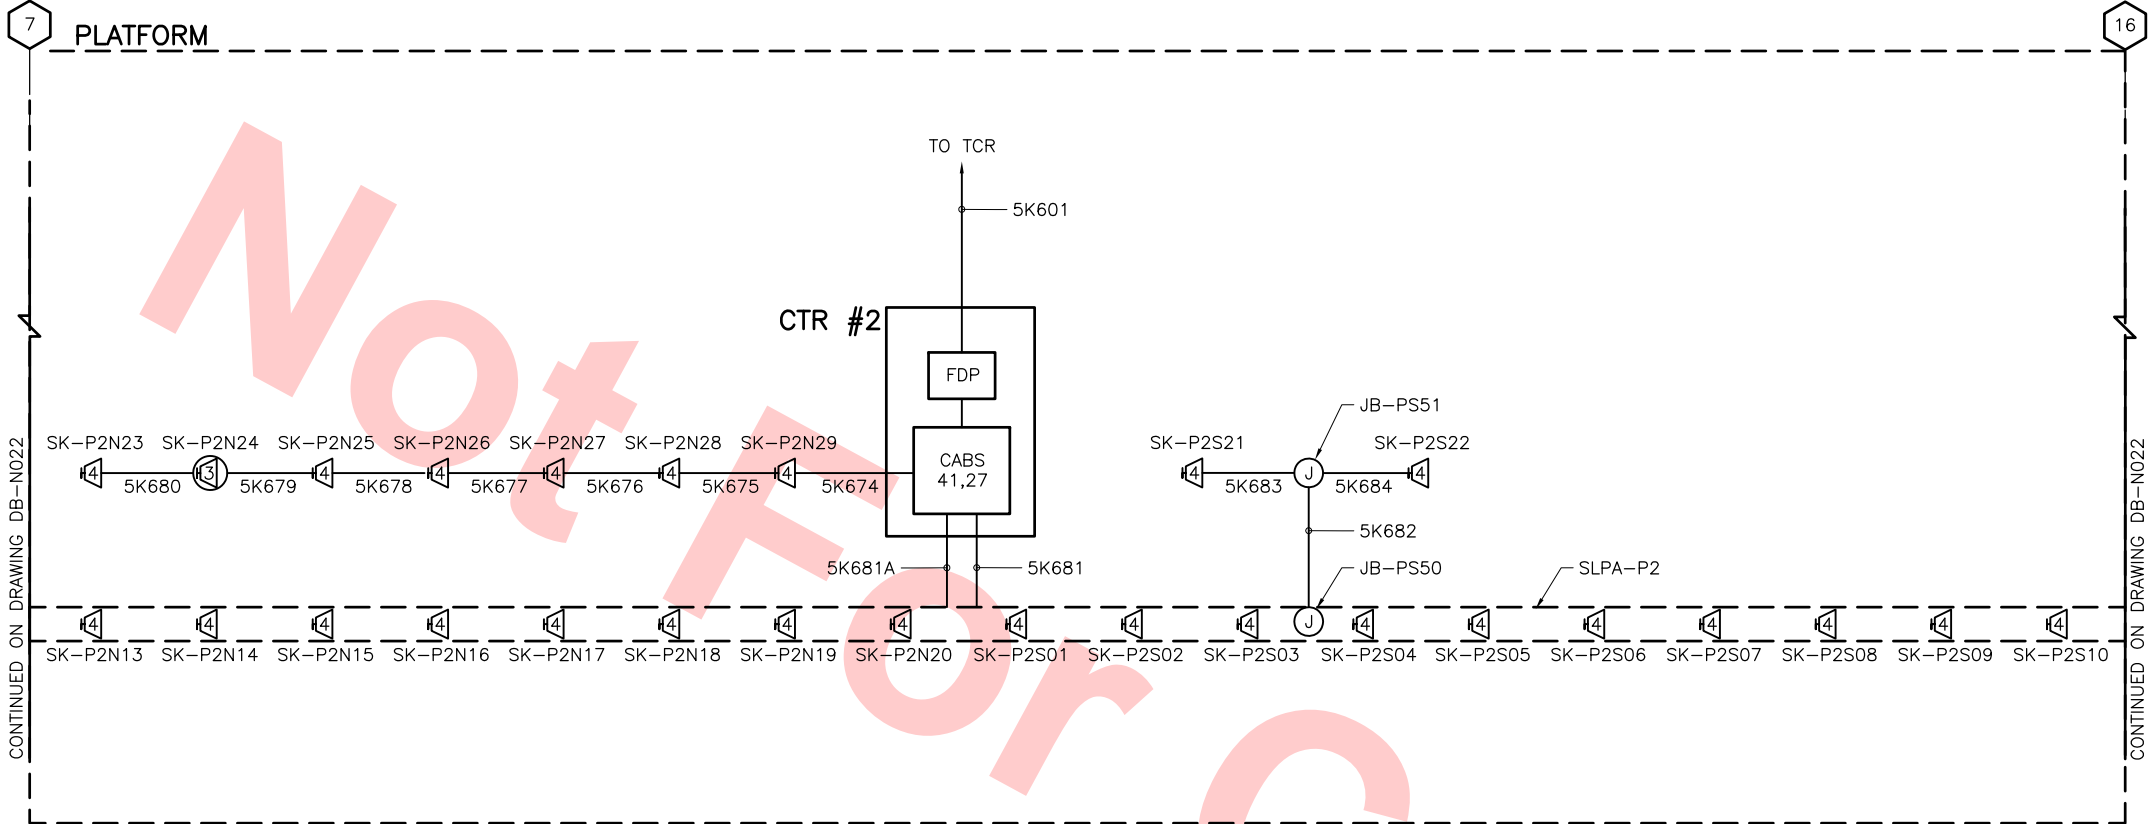

- NOTES:
1. SPEAKER TYPES WILL BE DETERMINED DURING FINAL DESIGN AND TESTING ANALYSIS.
 2. ALL CABLES FROM SPEAKERS TO THE PA SYSTEM EQUIPMENT IN THE TCR AND CTRS; AND ALL CABLES BETWEEN TCR AND CTRS, WILL BE FURNISHED, INSTALLED, TERMINATED, AND TESTED.
 3. CONDUITS ARE DIAGRAMMATICALLY SHOWN. REFER TO ELECTRICAL PLAN AND DETAIL SHEETS FOR ROUTING THROUGH STRUCTURES. CONDUITS WILL NOT BE ROUTED/INSTALLED AT LOCATIONS WHERE THEY INTERFERE WITH THE REMOVAL OF EQUIPMENT FOR MAINTENANCE, REPAIR,OR CLEANUP; NOR INFRINGE UPON HEADROOM IN PASSAGES.
 4. CONDUITS AND FITTINGS WILL BE GALVANIZED RIGID STEEL (GRS). GALVANIZED STEEL ELECTRICAL METALLIC TUBING (EMT) MAY BE RUN EXPOSED ABOVE 8 FEET AND CONCEALED IN WALLS AND CEILINGS IN OFFICES.
 5. VTA POC AND CAMPUS AREA DEVICES AND ROUTING TO WAYSIDE FACILITIES NOT SHOWN. SEE DRAWING DB-N023.

Santa Clara Valley Transportation Authority

NO EXCEPTIONS TAKEN (NET)
MAKE CORRECTIONS NOTED (MCN)
AMEND AND RESUBMIT (A/R)

Any action shown above is subject to the terms of the contract and does not relieve the Contractor of any of its obligations under the contract, including design and detailing.


Contract No.: DB11002F

By: _____ Date: _____


					DESIGNED BY M. GOLUCKI		Skanska Shimmick Herzog	1436 California Circle Milpitas, California 95035 A Joint Venture		Lockwood, Andrews & Nowman, Inc. A LEO A DALY COMPANY	T-Y-LIN INTERNATIONAL		LINE, TRACK, STATIONS AND SYSTEMS DESIGN UNIT 023 MILPITAS STATION PUBLIC ADDRESS RISER DIAGRAM PLATFORM LEVEL SHEET 1 OF 2	CADD FILENAME C700-S-DB-N021.dwg				
					DRAWN BY A. SHRODE									SIZE D	SCALE NONE	CONTRACT NO. C700	REV. 0	
					CHECKED BY B. MENDEZ LORA									AREA CODE DB	SHEET NO. N021	PAGE NO. 1028		
					IN CHARGE B. MENDEZ LORA													
0	20130710			READINESS FOR CONSTRUCTION	DATE 20130710	SUBMITTED			APPROVED									
REV	DATE	BY	SUB	APP	DESCRIPTION													

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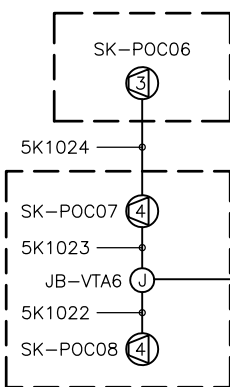
BUS TRANSIT CENTER

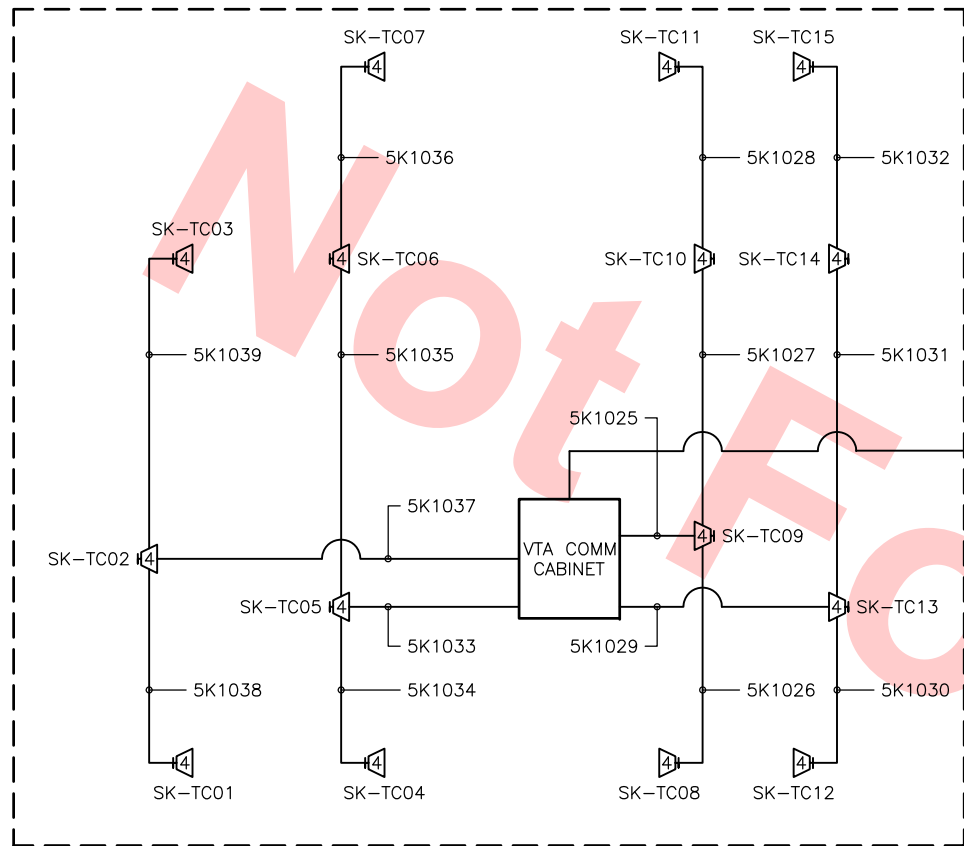


VTA COMM ROOM

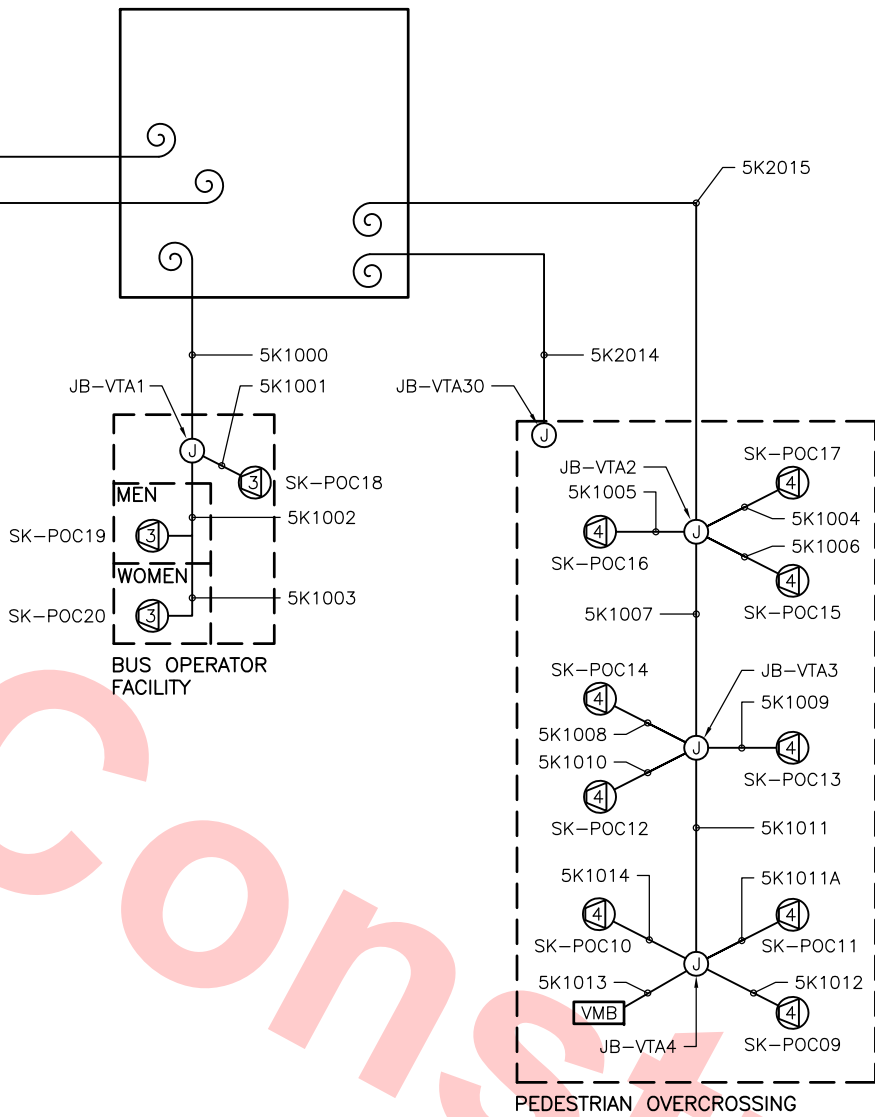

ELEVATOR



LRT LANDING

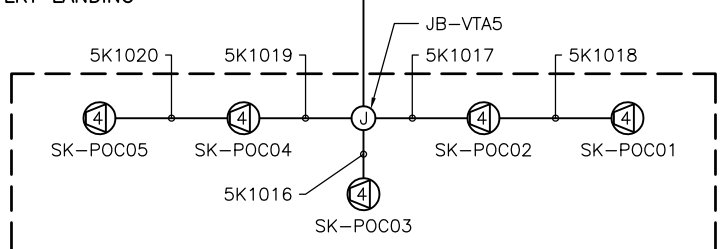

LRT PLATFORM EXTENSION

NOTES:

1. SPEAKER TYPES WILL BE DETERMINED DURING FINAL DESIGN AND TESTING ANALYSIS.
2. CONDUITS ARE DIAGRAMMATICALLY SHOWN. REFER TO ELECTRICAL SITE PLAN AND DETAIL SHEETS FOR ROUTING DETAILS.
3. 50 FEET OF COIL FOR EACH CABLE (FIBER AND COPPER) TO BE PROVIDED IN VTA COMM ROOM.
4. REFER TO VTA CONDUIT AND CABLE SCHEDULE DRAWING DB-B991 FOR REQUIREMENTS BETWEEN VTA COMM ROOM AND VTA COMM CABINET.
5. REFER TO VTA CONDUIT AND CABLE SCHEDULE DRAWING DB-B991 FOR REQUIREMENTS BETWEEN VTA COMM ROOM AND EXISTING VTA LRT COMM ROOM.

Santa Clara Valley Transportation Authority

- NO EXCEPTIONS TAKEN (NET)
- MAKE CORRECTIONS NOTED (MCN)
- AMEND AND RESUBMIT (A/R)


Any action shown above is subject to the terms of the contract and does not relieve the Contractor of any of its obligations under the contract, including design and detailing.

Contract No.: DB11002F

By: _____ Date: _____

Jun 20, 2013 - 9:36am C:\projects\mbox-astrod\mbox34735\C700-S-DB-N023.DWG

DESIGNED BY
M. GOLUCKI
DRAWN BY
A. SHRODE
CHECKED BY
B. MENDEZ LORA
IN CHARGE
B. MENDEZ LORA
DATE
20130710

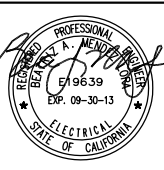

Skanska
Shimmick
Herzog
LTK
LTK Engineering Services
SUBMITTED


1436 California Circle
Milpitas, California 95035
A Joint Venture
Lockwood, Andrews
& Nowman, Inc.
T-Y-LIN INTERNATIONAL
APPROVED



LINE, TRACK, STATIONS AND SYSTEMS
DESIGN UNIT 023
MILPITAS STATION
VTA PUBLIC ADDRESS SYSTEM
RISER DIAGRAM

CADD FILENAME C700-S-DB-N023.dwg		
SIZE D	SCALE NONE	
CONTRACT NO. C700	REV. 0	
AREA CODE DB	SHEET NO. N023	PAGE NO. 1030

CONCOURSE

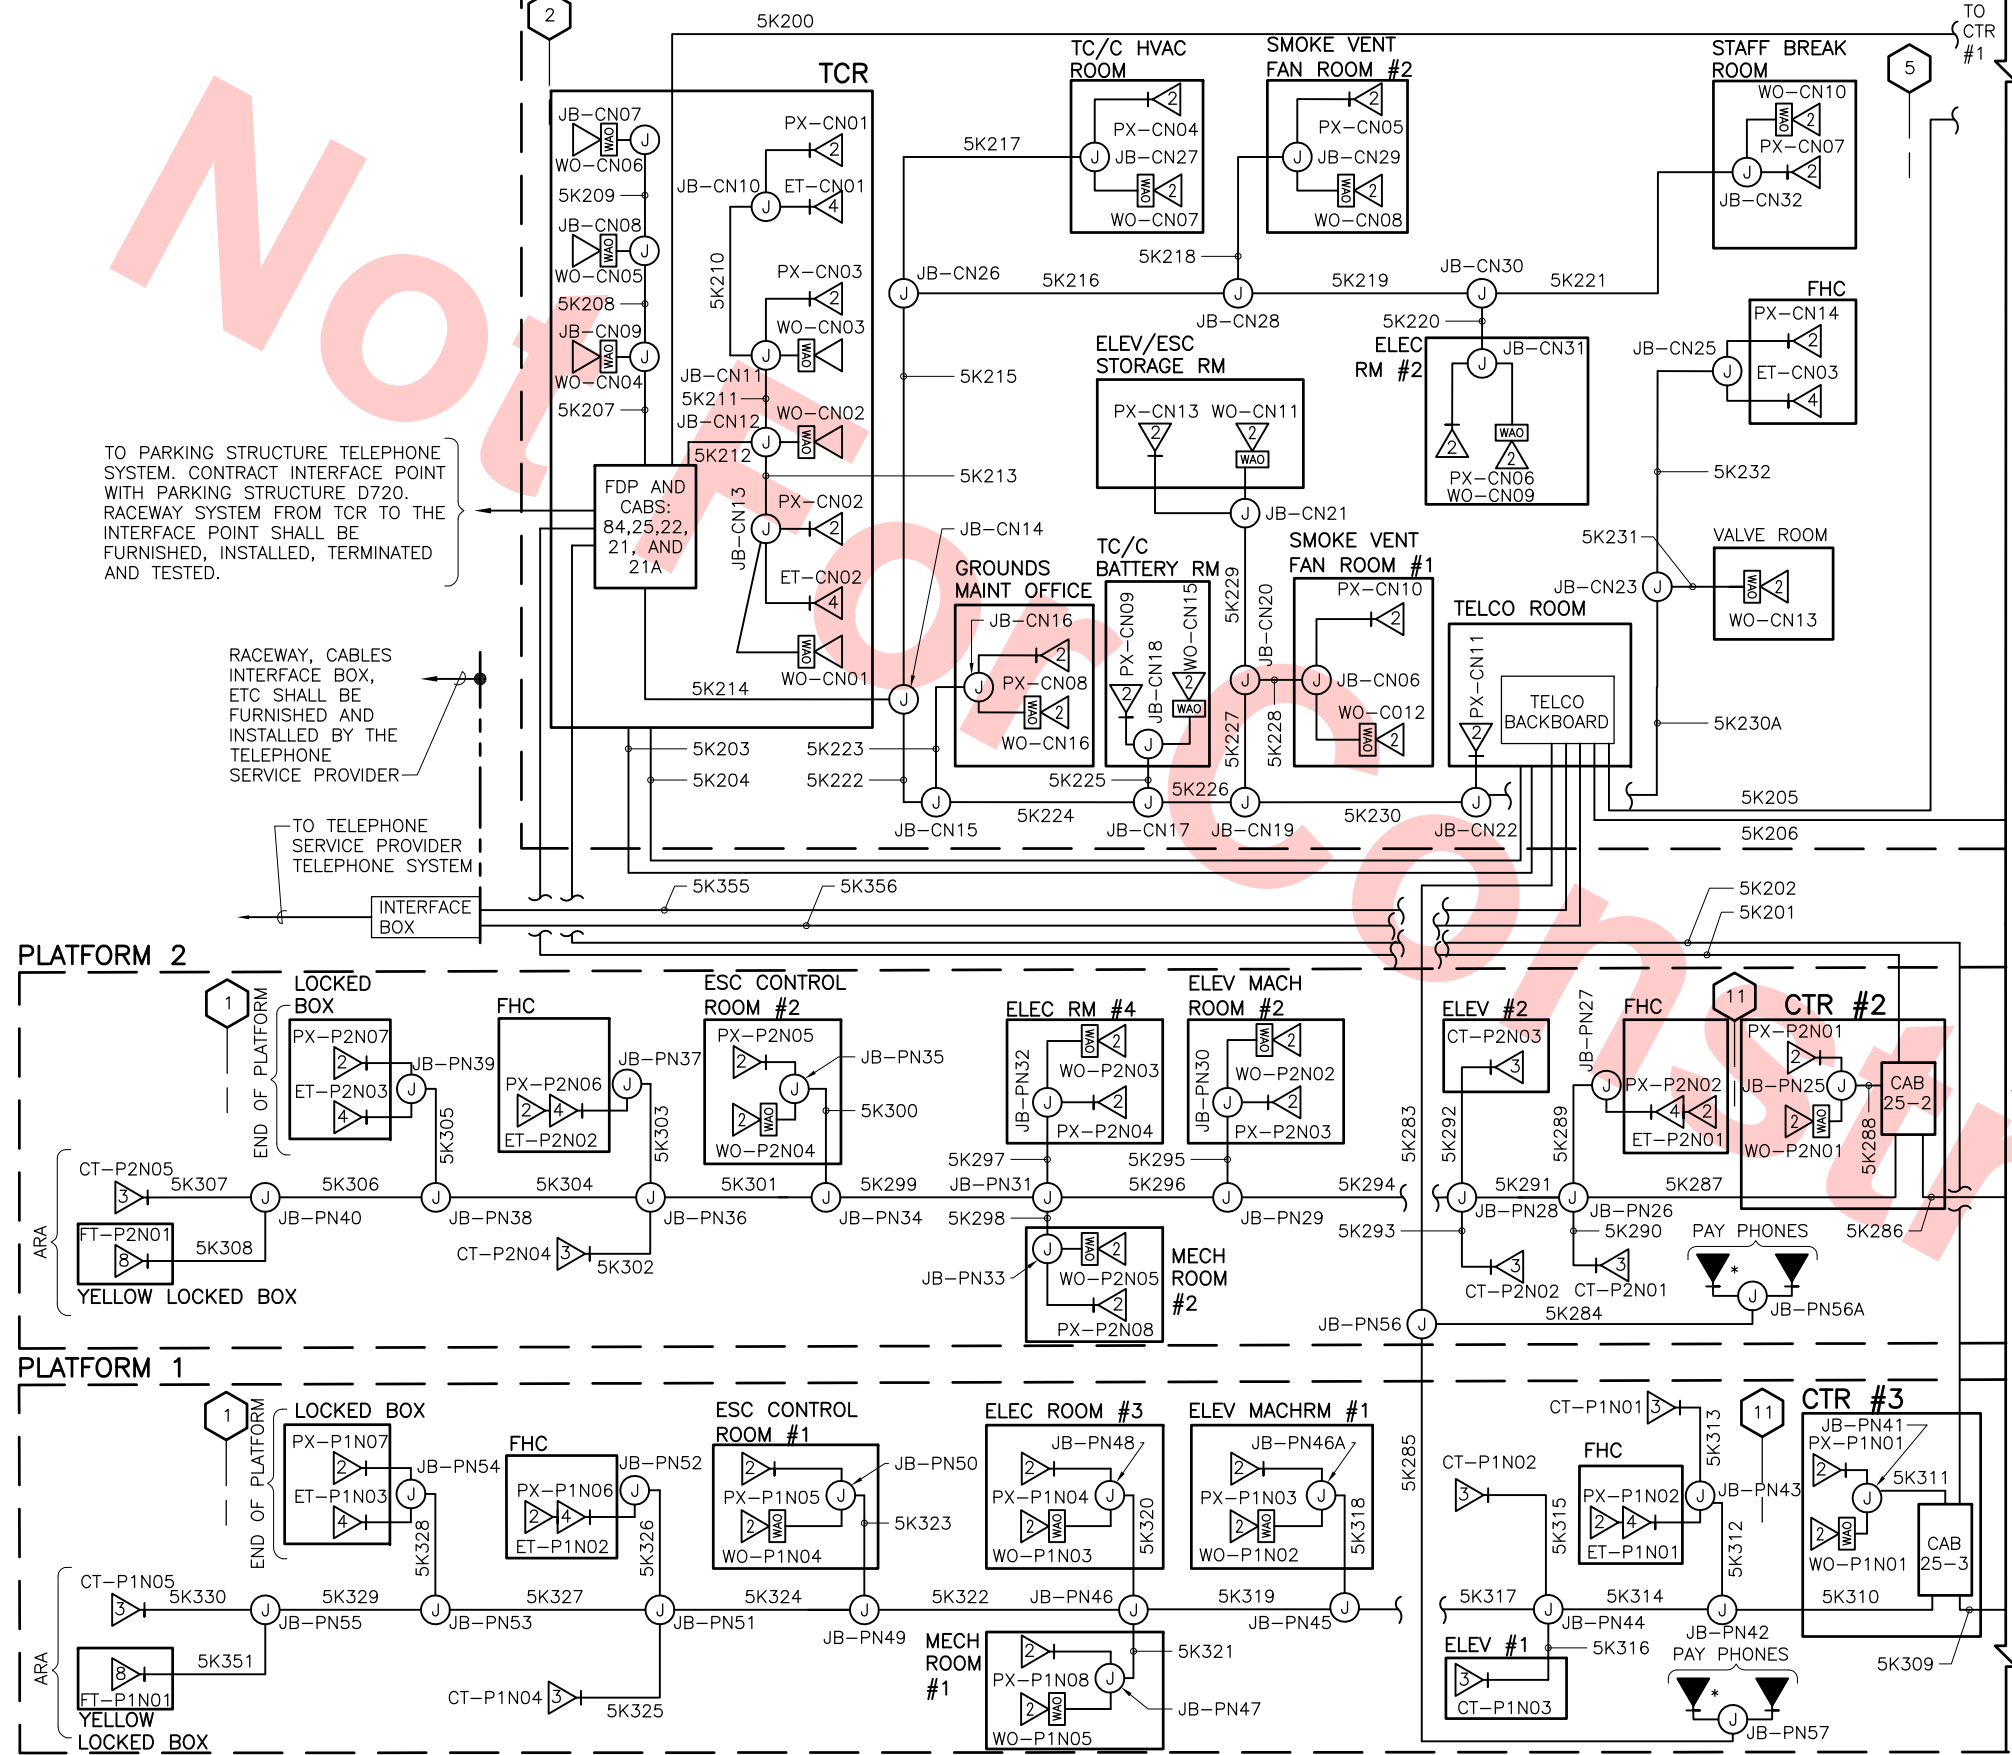

NOTES:

1. TELEPHONE TYPES SHALL BE DETERMINED DURING FINAL DESIGN AND TESTING ANALYSIS.
2. PUBLIC PAY PHONE OUTLETS SHALL BE FURNISHED AND INSTALLED BY TELEPHONE SERVICE PROVIDER.
3. ALL CABLES FROM TELEPHONE JACKS AND OUTLETS TO THE TELEPHONE TERMINATION CABINETS IN THE CTR AND TO THE TELEPHONE INTERFACE CABINET IN THE TCR SHALL BE FURNISHED, INSTALLED, TERMINATED AND TESTED.
4. ALL CABLES BETWEEN TELEPHONE TERMINATION CABINETS IN THE CTR AND THE MAIN DISTRIBUTION FRAME CABINET IN THE TCR SHALL BE FURNISHED, INSTALLED, TERMINATED AND TESTED.
5. TELEPHONE CABLES FROM THE TELCO ROOM TO THE TCR SHALL BE FURNISHED, INSTALLED, TERMINATED AND TESTED.
6. TELEPHONE CABLES FROM THE CROSS-CONNECT BLOCKS IN THE TELCO ROOM TO THE PUBLIC PAY PHONE STATIONS SHALL BE FURNISHED, INSTALLED, TERMINATED AND TESTED BY THE TELEPHONE SERVICE PROVIDER.
7. TELEPHONE CABLES FROM THE ENTRANCE TERMINALS IN THE TELCO ROOM TO THE TELEPHONE SERVICE PROVIDER INTERFACE BOX SHALL BE FURNISHED, INSTALLED, TERMINATED AND TESTED BY THE TELEPHONE SERVICE PROVIDER.
8. CONDUITS ARE DIAGRAMMATICALLY SHOWN. REFER TO ELECTRICAL PLAN & DETAIL SHEETS FOR FURTHER ROUTING THROUGH MAJOR STRUCTURES. CONDUITS SHALL NOT BE ROUTED/INSTALLED AT LOCATIONS WHERE THEY INTERFERE WITH THE REMOVAL OF EQUIPMENT FOR MAINTENANCE, REPAIR OR CLEANUP NOR INFRINGE UPON HEADROOM IN PASSAGES.
9. CONDUITS AND FITTINGS SHALL BE GALVANIZED RIGID STEEL (GRS). GALVANIZED STEEL ELECTRICAL METALLIC TUBING (EMT) MAY BE RUN EXPOSED ABOVE 8 FEET AND CONCEALED IN WALLS AND CEILINGS IN OFFICES.
10. COMMUNICATION EQUIPMENT LOCATED AT THE VTA BUS OPERATOR FACILITY, BICYCLE STORAGE FACILITY AND LRT POC ARE NOT SHOWN IN THIS RISER DIAGRAM. REFER TO SHEET DB-0022.

Santa Clara Valley Transportation Authority

— NO EXCEPTIONS TAKEN (NET)
 — MAKE CORRECTIONS NOTED (MCN)
 — AMEND AND RESUBMIT (A/R)

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Contract No.: DB11002F

By: _____ Date: _____

LEGEND:

- ET-P1S01 EMERGENCY TELEPHONE NO. 1 LOCATED AT PLATFORM 1 LEVEL SOUTH
 ET-P2N01 EMERGENCY TELEPHONE NO. 1 LOCATED AT PLATFORM 2 LEVEL NORTH
 CT-CS03 COURTESY TELEPHONE NO. 3 LOCATED AT CONCOURSE LEVEL SOUTH

DESIGNED BY
M. GOLUCKI
 DRAWN BY
B. COOPER
 CHECKED BY
B. MENDEZ LORA
 IN CHARGE
B. MENDEZ LORA
 DATE
20130710



Skanska
Shimmick
Herzog
 LTK Engineering Services
 SUBMITTED

1436 California Circle
 Milpitas, California 95035
 A Joint Venture

Lockwood, Andrews
& Nowman, Inc.
 T-Y-LIN INTERNATIONAL
 APPROVED

BART
SILICON VALLEY
 BART SILICON VALLEY BERRYESSA EXTENSION

LINE, TRACK, STATIONS AND SYSTEMS
 DESIGN UNIT 023
 MILPITAS STATION
 TELEPHONE SYSTEM
 RISER DIAGRAM
 SHEET 1 OF 2

CADD FILENAME
C700-S-DB-0020.dwg
 SIZE SCALE
D NONE
 CONTRACT NO. C700 REV. 0
 AREA CODE SHEET NO. DB 0020 PAGE NO. 1031



1. CAMERA TYPES WILL BE DETERMINED DURING FINAL DESIGN.
2. VTA POC AND CAMPUS AREA DEVICES AND ROUTING TO WAYSIDE FACILITIES NOT SHOWN.
3. CONDUITS ARE DIAGRAMMATICALLY SHOWN. REFER TO ELECTRICAL PLAN & DETAIL SHEETS FOR FURTHER ROUTING THROUGH MAJOR STRUCTURES.
4. POWER CABLEING AND ROUTING NOT SHOWN. SEE CABLE SCHEDULES.
5. CAMERAS SHALL BE CONNECTED DIRECTLY TO THE ASSOCIATED CCTV SWITCH W/O MEDIA CONVERTER AS THE INTERMEDIARY WHEREVER FEASIBLE.

NO EXCEPTIONS TAKEN (NET)
MAKE CORRECTIONS NOTED (MCN)
AMEND AND RESUBMIT (A/R)

Any action shown above is subject to the terms of the contract and does not relieve the Contractor of any of its obligations under the contract, including design and detailing.

Contract No.: **DB11002F**

By: _____ **Date:** _____

DESIGNED BY M. GOLUCKI
DRAWN BY B. COOPER
CHECKED BY B. MENDEZ LORA
IN CHARGE B. MENDEZ LORA
DATE 20130710




LINE, TRACK, STATIONS AND SYSTEMS
DESIGN UNIT 023
MILPITAS STATION
CCTV RISER DIAGRAM
CONCOURSE LEVEL


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SIZE D	SCALE NONE	
CONTRACT NO. C700		REV. 0
AREA CODE DB	SHEET NO. Q020	PAGE NO. 1034

- NOTES:
1. REFER TO DU-031 FOR VTA CAMERA TYPES (FIXED).
 2. 50 FEET OF COIL FOR EACH CABLE (FIBER AND COPPER) TO BE PROVIDED IN VTA COMM ROOM.
 3. CONDUITS ARE DIAGRAMMATICALLY SHOWN. REFER TO ELECTRICAL PLAN & DETAIL SHEETS FOR FURTHER ROUTING THROUGH MAJOR STRUCTURES.
 4. REFER TO VTA CONDUIT AND CABLE SCHEDULE DRAWING DB-B991 FOR REQUIREMENTS BETWEEN VTA COMM ROOM AND VTA COMM CABINET.
 5. REFER TO VTA CONDUIT AND CABLE SCHEDULE DRAWING DB-B991 FOR REQUIREMENTS BETWEEN VTA COMM ROOM AND EXISTING VTA LRT COMM ROOM.

BUS TRANSIT CENTER

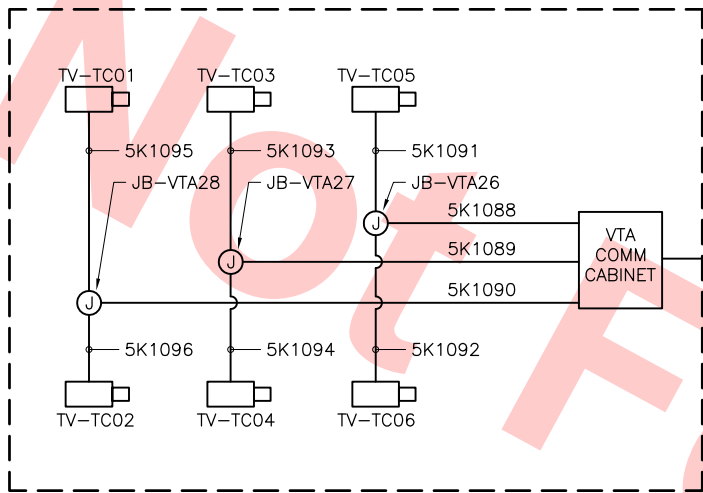


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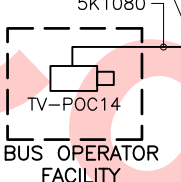
5K2016

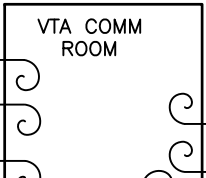5K2017




POC ECS & ELEV MACHINE ROOM

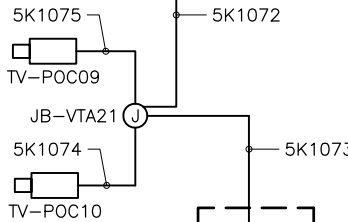JB-VTA22




BUS OPERATOR FACILITY

BIKE STORAGE AREA


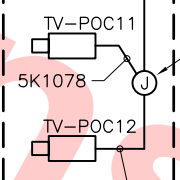


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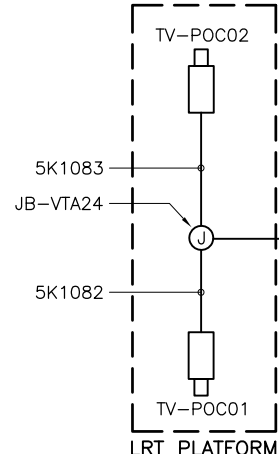


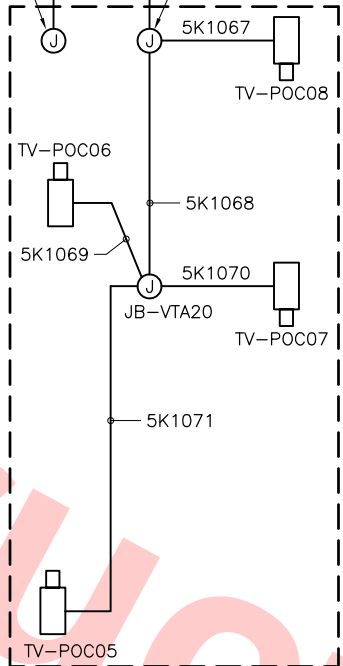PEDESTRIAN OVERCROSSING

NOTE 5

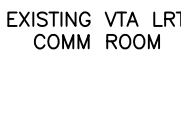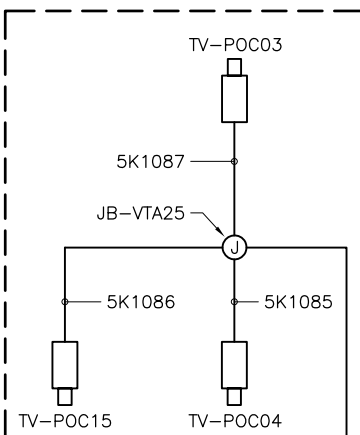

EXISTING VTA LRT COMM ROOM



LRT PLATFORM

Santa Clara Valley Transportation Authority

NO EXCEPTIONS TAKEN (NET)
MAKE CORRECTIONS NOTED (MCN)
AMEND AND RESUBMIT (A/R)

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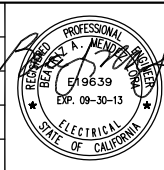
Contract No.: DB11002F

By: _____ Date: _____

Jun 20, 2013 9:36am C:\projects\mbx-astrod\lms34735\C700-S-DB-Q022.DWG

REV	DATE	BY	SUB	APP	DESCRIPTION
0	20130710				READINESS FOR CONSTRUCTION

DESIGNED BY
M. GOLUCKI
DRAWN BY
B. COOPER
CHECKED BY
B. MENDEZ LORA
IN CHARGE
B. MENDEZ LORA
DATE
20130710



Skanska
Shimmick
Herzog

LTK
LTK Engineering Services


SUBMITTED

1436 California Circle
Milpitas, California 95035
A Joint Venture

Lockwood, Andrews
& Nowman, Inc.
A LEO A DALY COMPANY





T-Y-LIN INTERNATIONAL

APPROVED

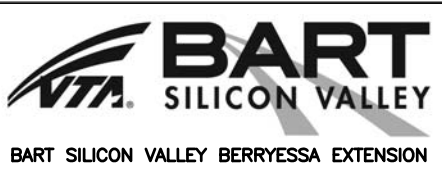

LINE, TRACK, STATIONS AND SYSTEMS
DESIGN UNIT 023
MILPITAS STATION
VTA CCTV RISER DIAGRAM

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CONTRACT NO. C700	SHEET NO. Q022	REV. 0
AREA CODE DB	PAGE NO. 1036	

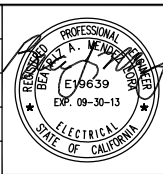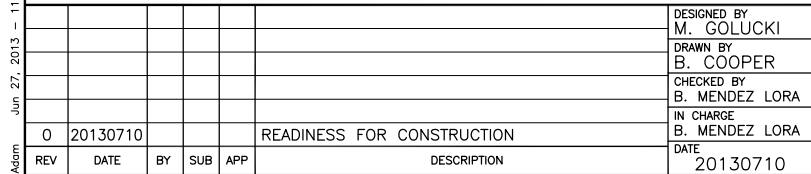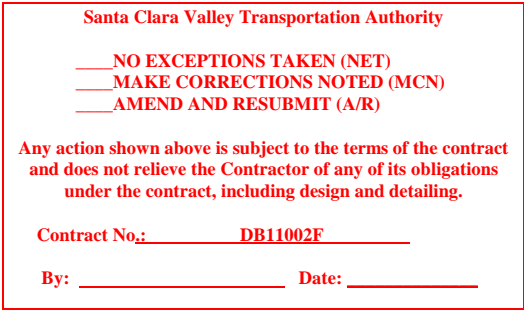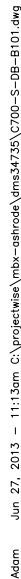

Skanska
Shimmick
Herzog

LTK
LTK Engineering Services

SUBMITTED *[Signature]*

1436 California Circle
Milpitas, California 95035

A Joint Venture

LAN **Lookwood, Andrews
& Newman, Inc.**
A LEO A DALY COMPANY



T-Y-LIN INTERNATIONAL

APPROVED *Ry. Apolunth*



LINE, TRACK, STATIONS AND SYSTEMS
DESIGN UNIT 023
MILPITAS STATION
COMMUNICATION EQUIPMENT LAYOUT
BOARDING PLATFORM LEVEL PLAN
SHEET 1 OF 6

CADD FILENAME C700-S-DB-B101.dwg		
SIZE D	SCALE 1/8"=1'-0"	
CONTRACT NO. C700		REV. 0
AREA CODE DB	SHEET NO. B101	PAGE NO. 1037

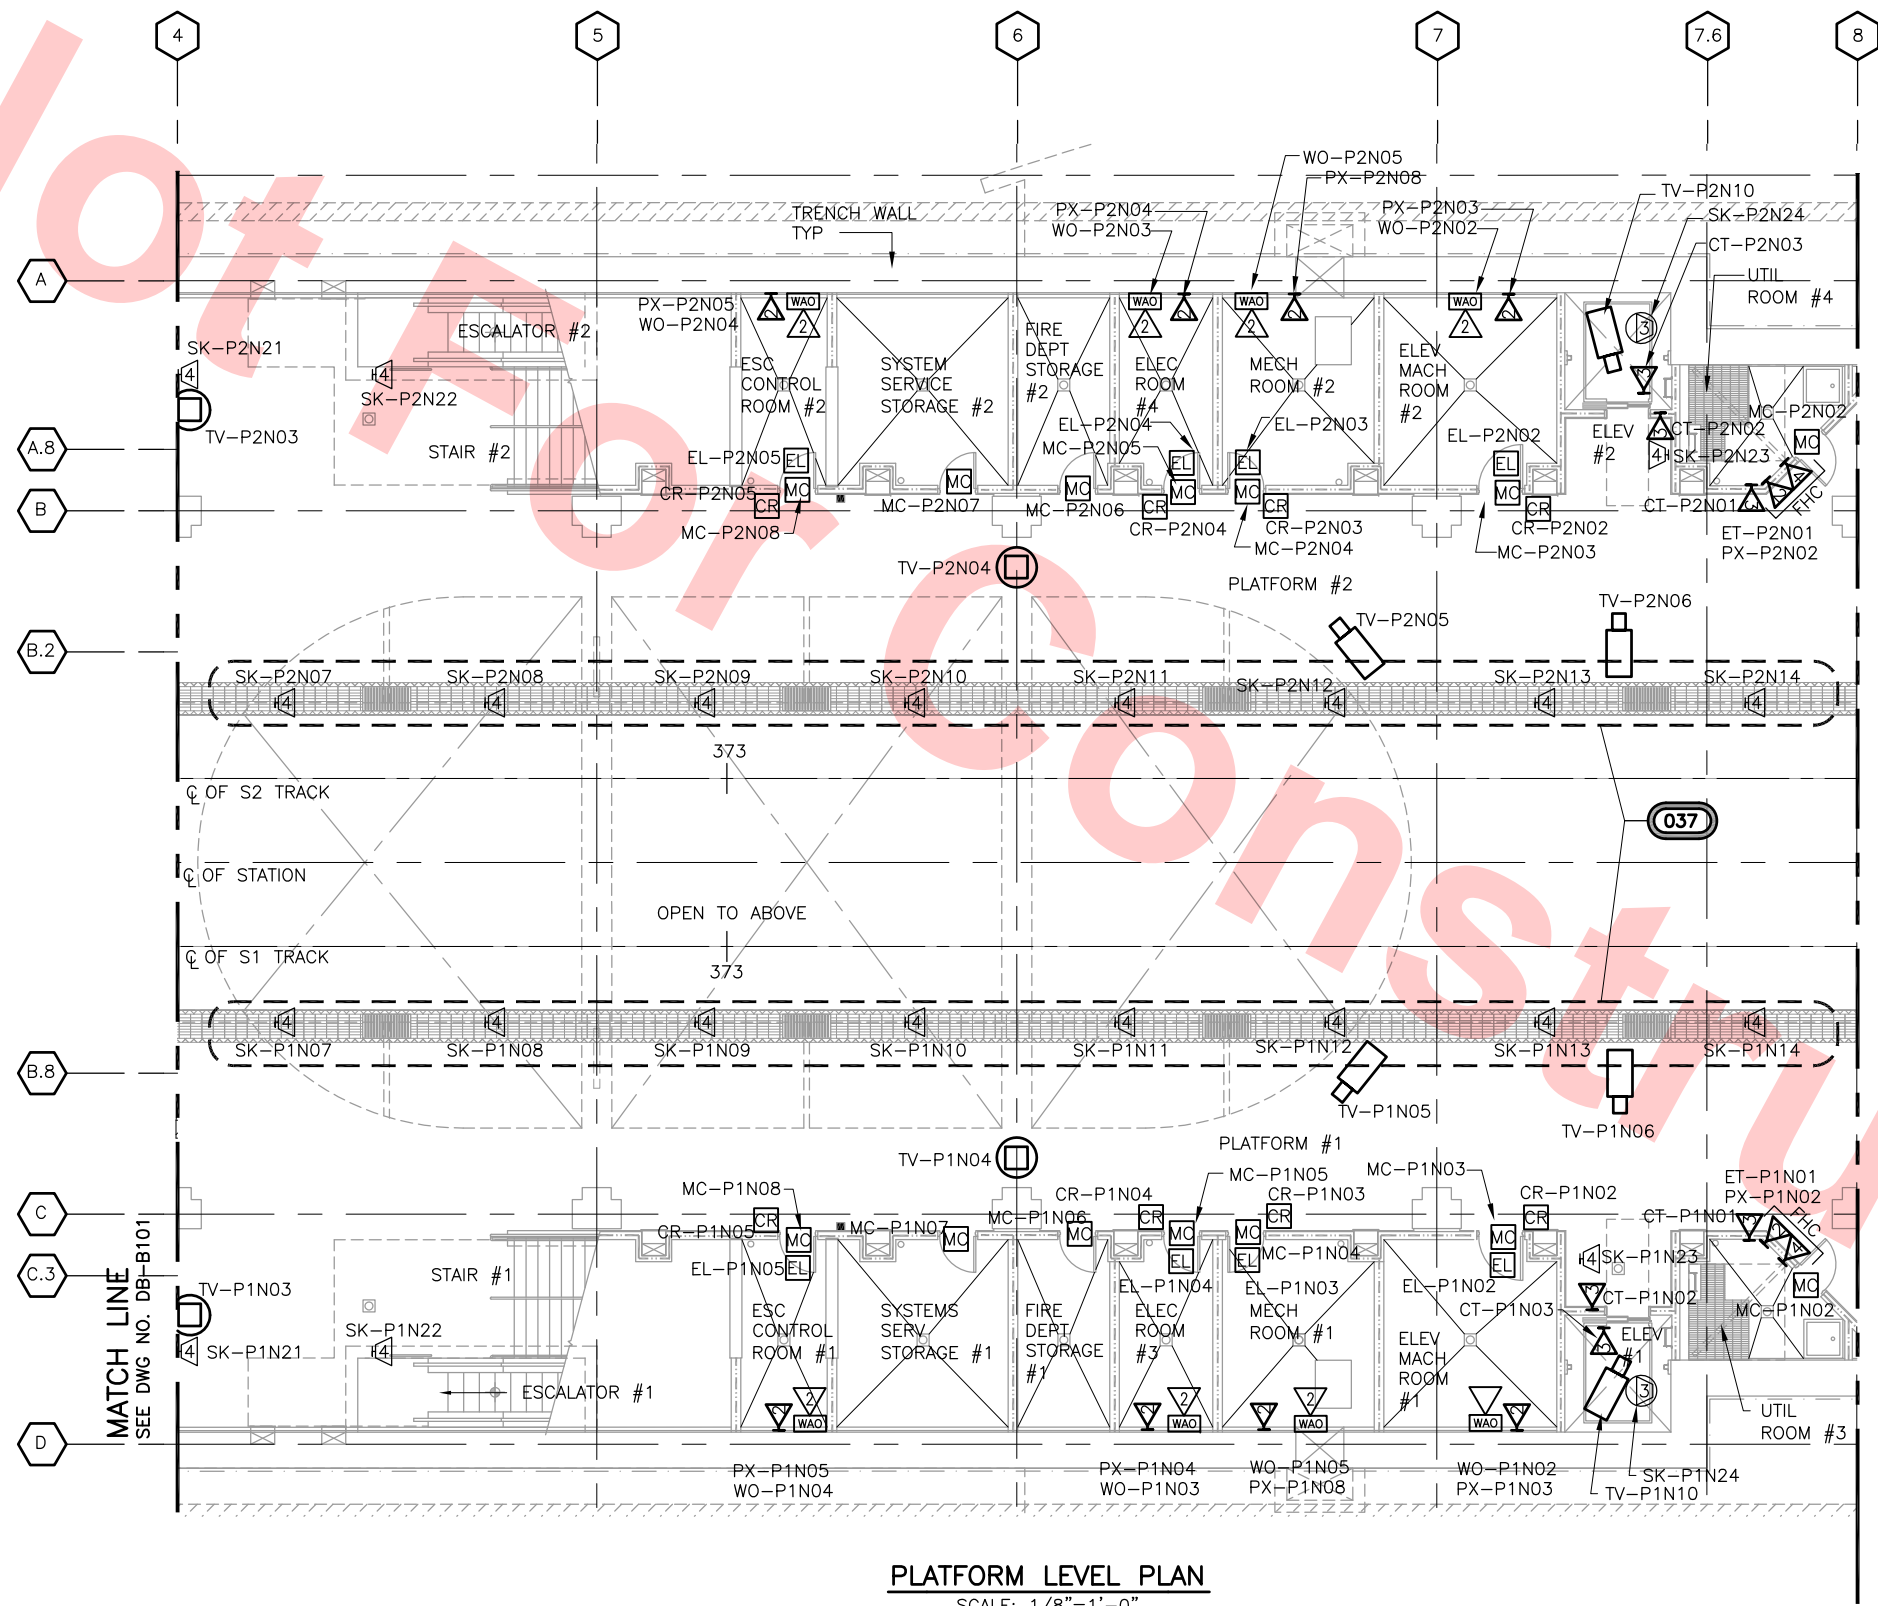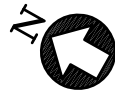

PLATFORM LEVEL PLAN
SCALE: 1/8"=1'-0"


Santa Clara Valley Transportation Authority

NO EXCEPTIONS TAKEN (NET)
MAKE CORRECTIONS NOTED (MCN)
AMEND AND RESUBMIT (A/R)

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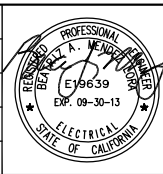
Contract No.: DB11002F

By: _____ Date: _____

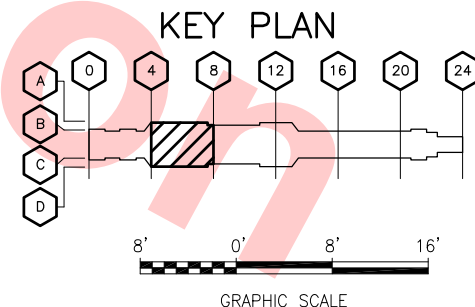

Jun 27, 2013 11:14am C:\projects\mbs-astroc\mbs34735\CT00-S-DB-B102.dwg

DESIGNED BY M. GOLUCKI	DATE 20130710	BY B. COOPER	APP B. MENDEZ LORA	DESCRIPTION READINESS FOR CONSTRUCTION
CHECKED BY B. MENDEZ LORA	DATE 20130710	IN CHARGE B. MENDEZ LORA		



Skanska
Shimmick
Herzog

LTK
LTK Engineering Services

1436 California Circle
Milpitas, California 95035
A Joint Venture

Lookwood, Andrews
& Newnam, Inc.
A LEO A DALY COMPANY

T-Y LIN INTERNATIONAL


BART
SILICON VALLEY


BART SILICON VALLEY BERRYESSA EXTENSION

LINE, TRACK, STATIONS AND SYSTEMS
DESIGN UNIT 023
MILPITAS STATION
COMMUNICATION EQUIPMENT LAYOUT
BOARDING PLATFORM LEVEL PLAN
SHEET 2 OF 6

CADD FILENAME C700-S-DB-B102.dwg	REV. 0
SIZE D	SCALE 1/8"=1'-0"
CONTRACT NO. C700	SHEET NO. B102
AREA CODE DB	PAGE NO. 1038

1. PENDANT MOUNT SPEAKERS NOT INSTALLED WITHIN SLPA AT 12' AFF.

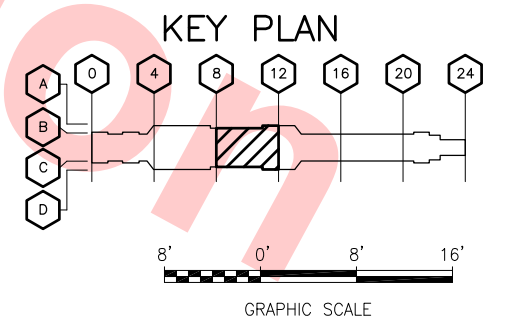


DESIGNED BY M. GOLUCKI		Skanska Shimmick Herzog	1436 California Circle Milpitas, California 95035 A Joint Venture			T-Y-LIN INTERNATIONAL A L&A B&N COMPANY		LINE, TRACK, STATIONS AND SYSTEMS DESIGN UNIT 023 MILPITAS STATION COMMUNICATION EQUIPMENT LAYOUT BOARDING PLATFORM LEVEL PLAN SHEET 3 OF 6	CADD FILENAME C700-S-DB-B103.dwg
DRAWN BY B. COOPER									
CHECKED BY B. MENDEZ LORA									
IN CHARGE B. MENDEZ LORA									
DATE 20130710									
0	20130710			READINESS FOR CONSTRUCTION					
REV	DATE	BY	SUB	APP	DESCRIPTION				



NOTE:

- PENDANT MOUNT SPEAKERS NOT INSTALLED WITHIN SLPA AT 12' AFF.

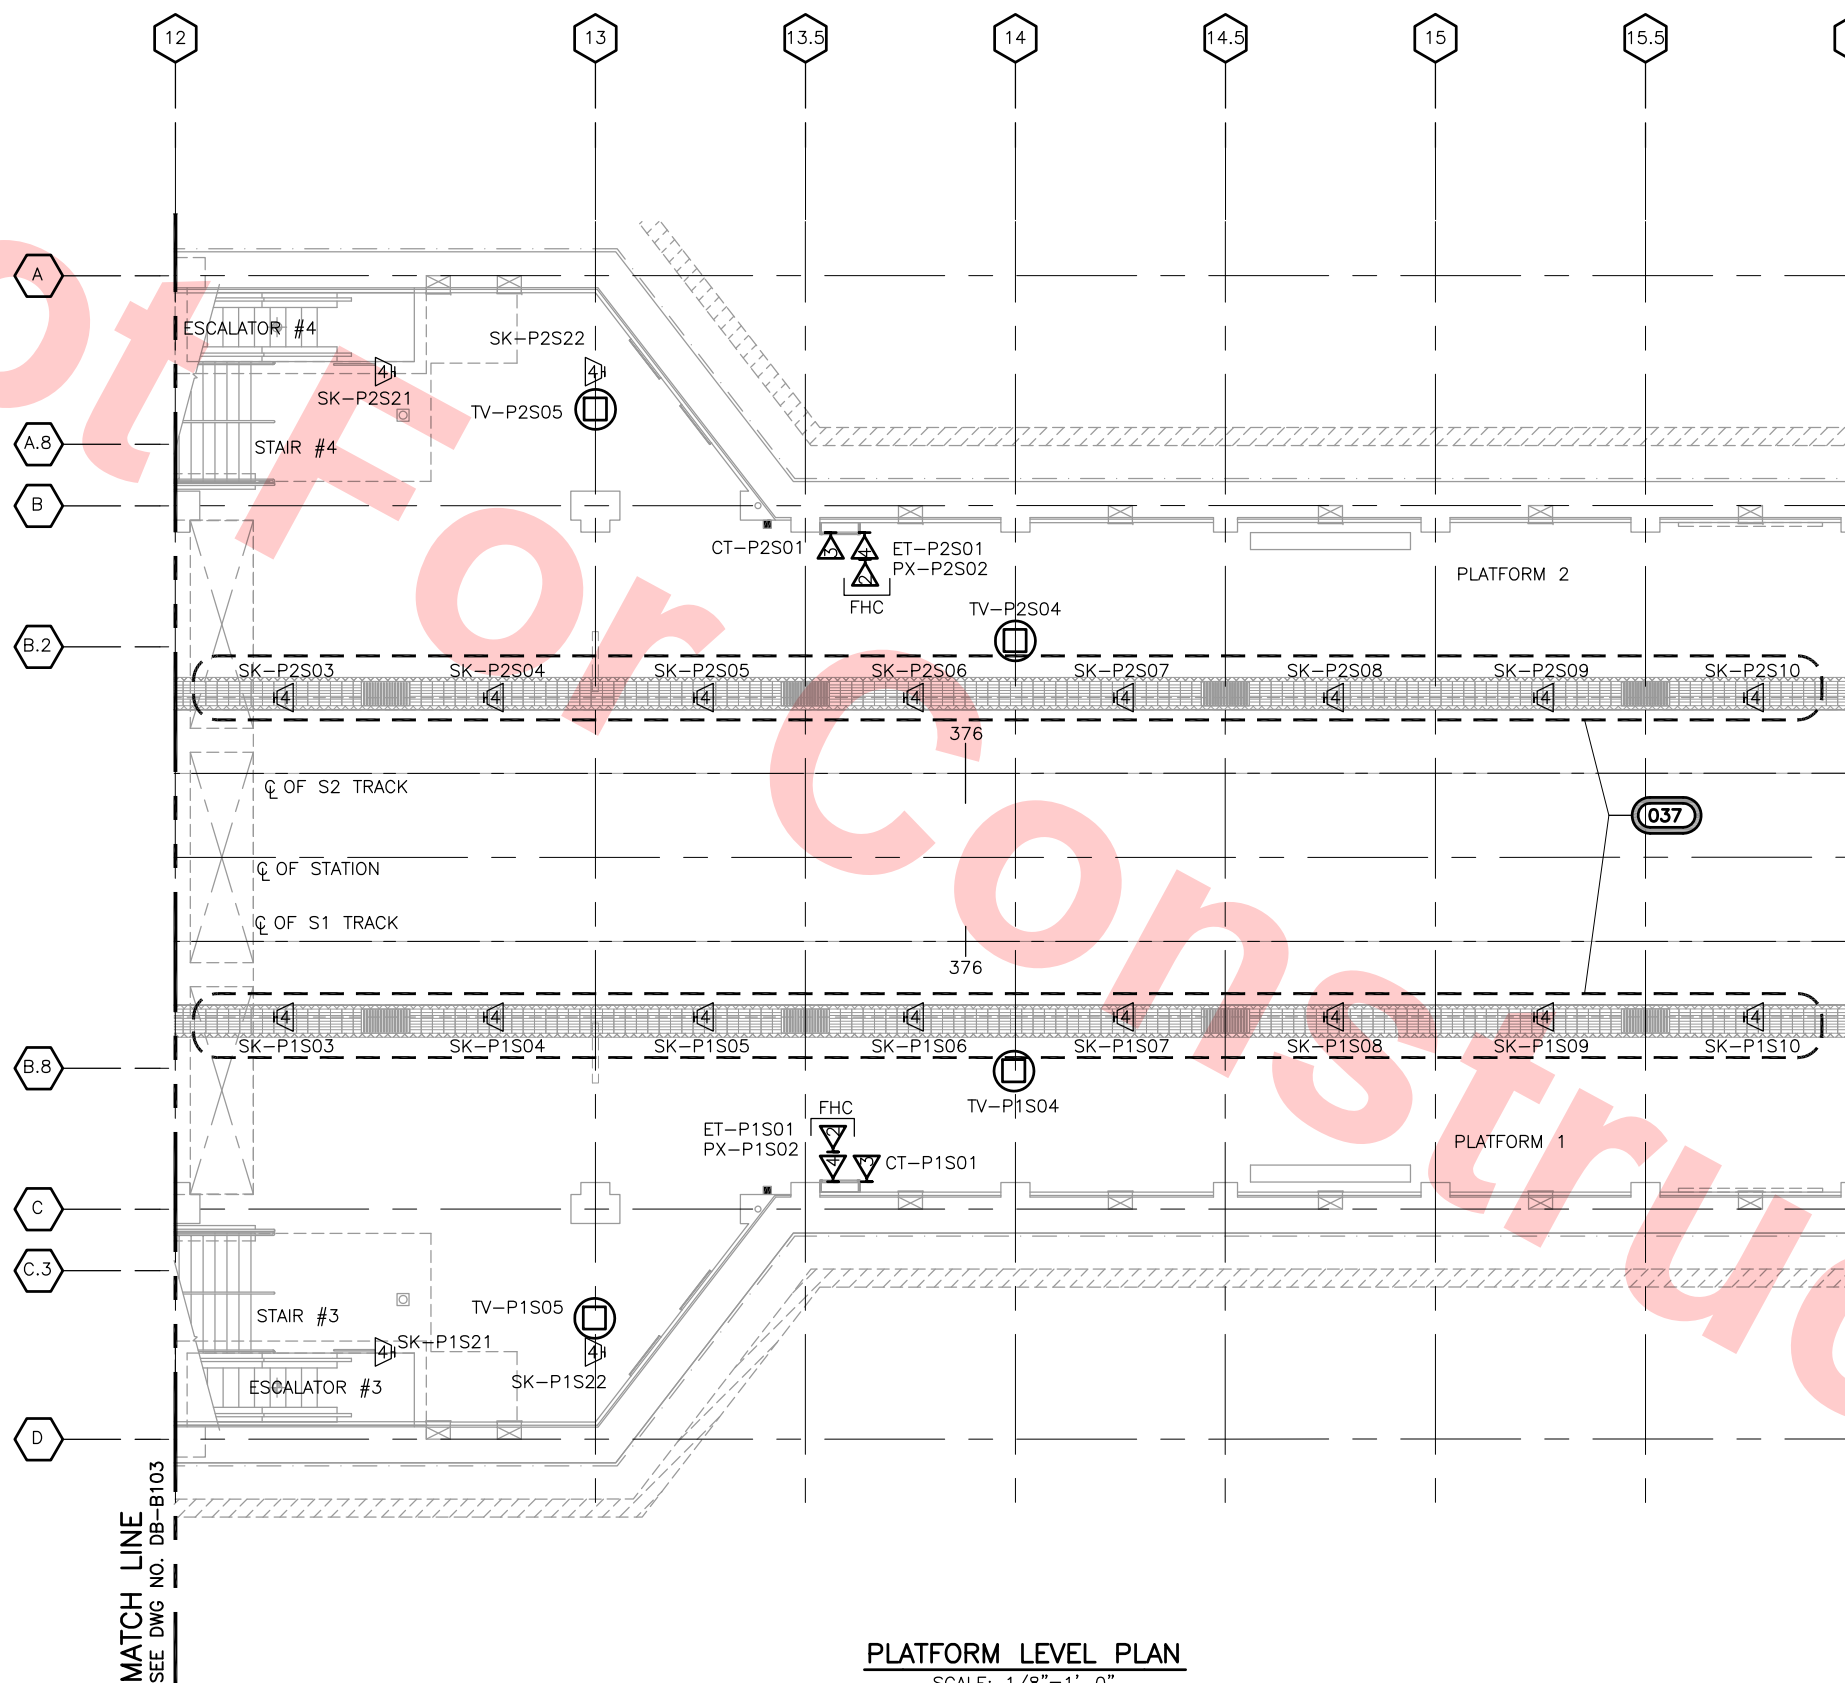

PLATFORM LEVEL PLAN
SCALE: 1/8"=1'-0"


Santa Clara Valley Transportation Authority

NO EXCEPTIONS TAKEN (NET)
MAKE CORRECTIONS NOTED (MCN)
AMEND AND RESUBMIT (A/R)

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Contract No.: DB11002F


By: _____ Date: _____

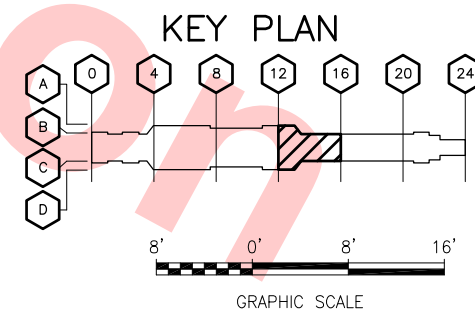

Jun 27, 2013 12:43pm C:\projects\mbox-astrow\mbox34735\CTD0-S-DB-B104.dwg

REV	DATE	BY	SUB	APP	DESCRIPTION
0	20130710				READINESS FOR CONSTRUCTION

DESIGNED BY
M. GOLUCKI
DRAWN BY
B. COOPER
CHECKED BY
B. MENDEZ LORA
IN CHARGE
B. MENDEZ LORA
DATE
20130710

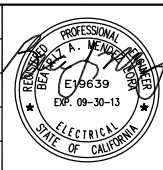

Skanska
Shimmick
Herzog

LTK
LTK Engineering Services

SUBMITTED

1436 California Circle
Milpitas, California 95035
A Joint Venture

Lookwood, Andrews
& Newnam, Inc.
A LEOP A DALY COMPANY



T-Y LIN INTERNATIONAL

APPROVED



LINE, TRACK, STATIONS AND SYSTEMS
DESIGN UNIT 023
MILPITAS STATION
COMMUNICATION EQUIPMENT LAYOUT
BOARDING PLATFORM LEVEL PLAN
SHEET 4 OF 6

CADD FILENAME C700-S-DB-B104.dwg	REV. 0
SIZE D	SCALE 1/8"=1'-0"
CONTRACT NO. C700	SHEET NO. B104
AREA CODE DB	PAGE NO. 1040

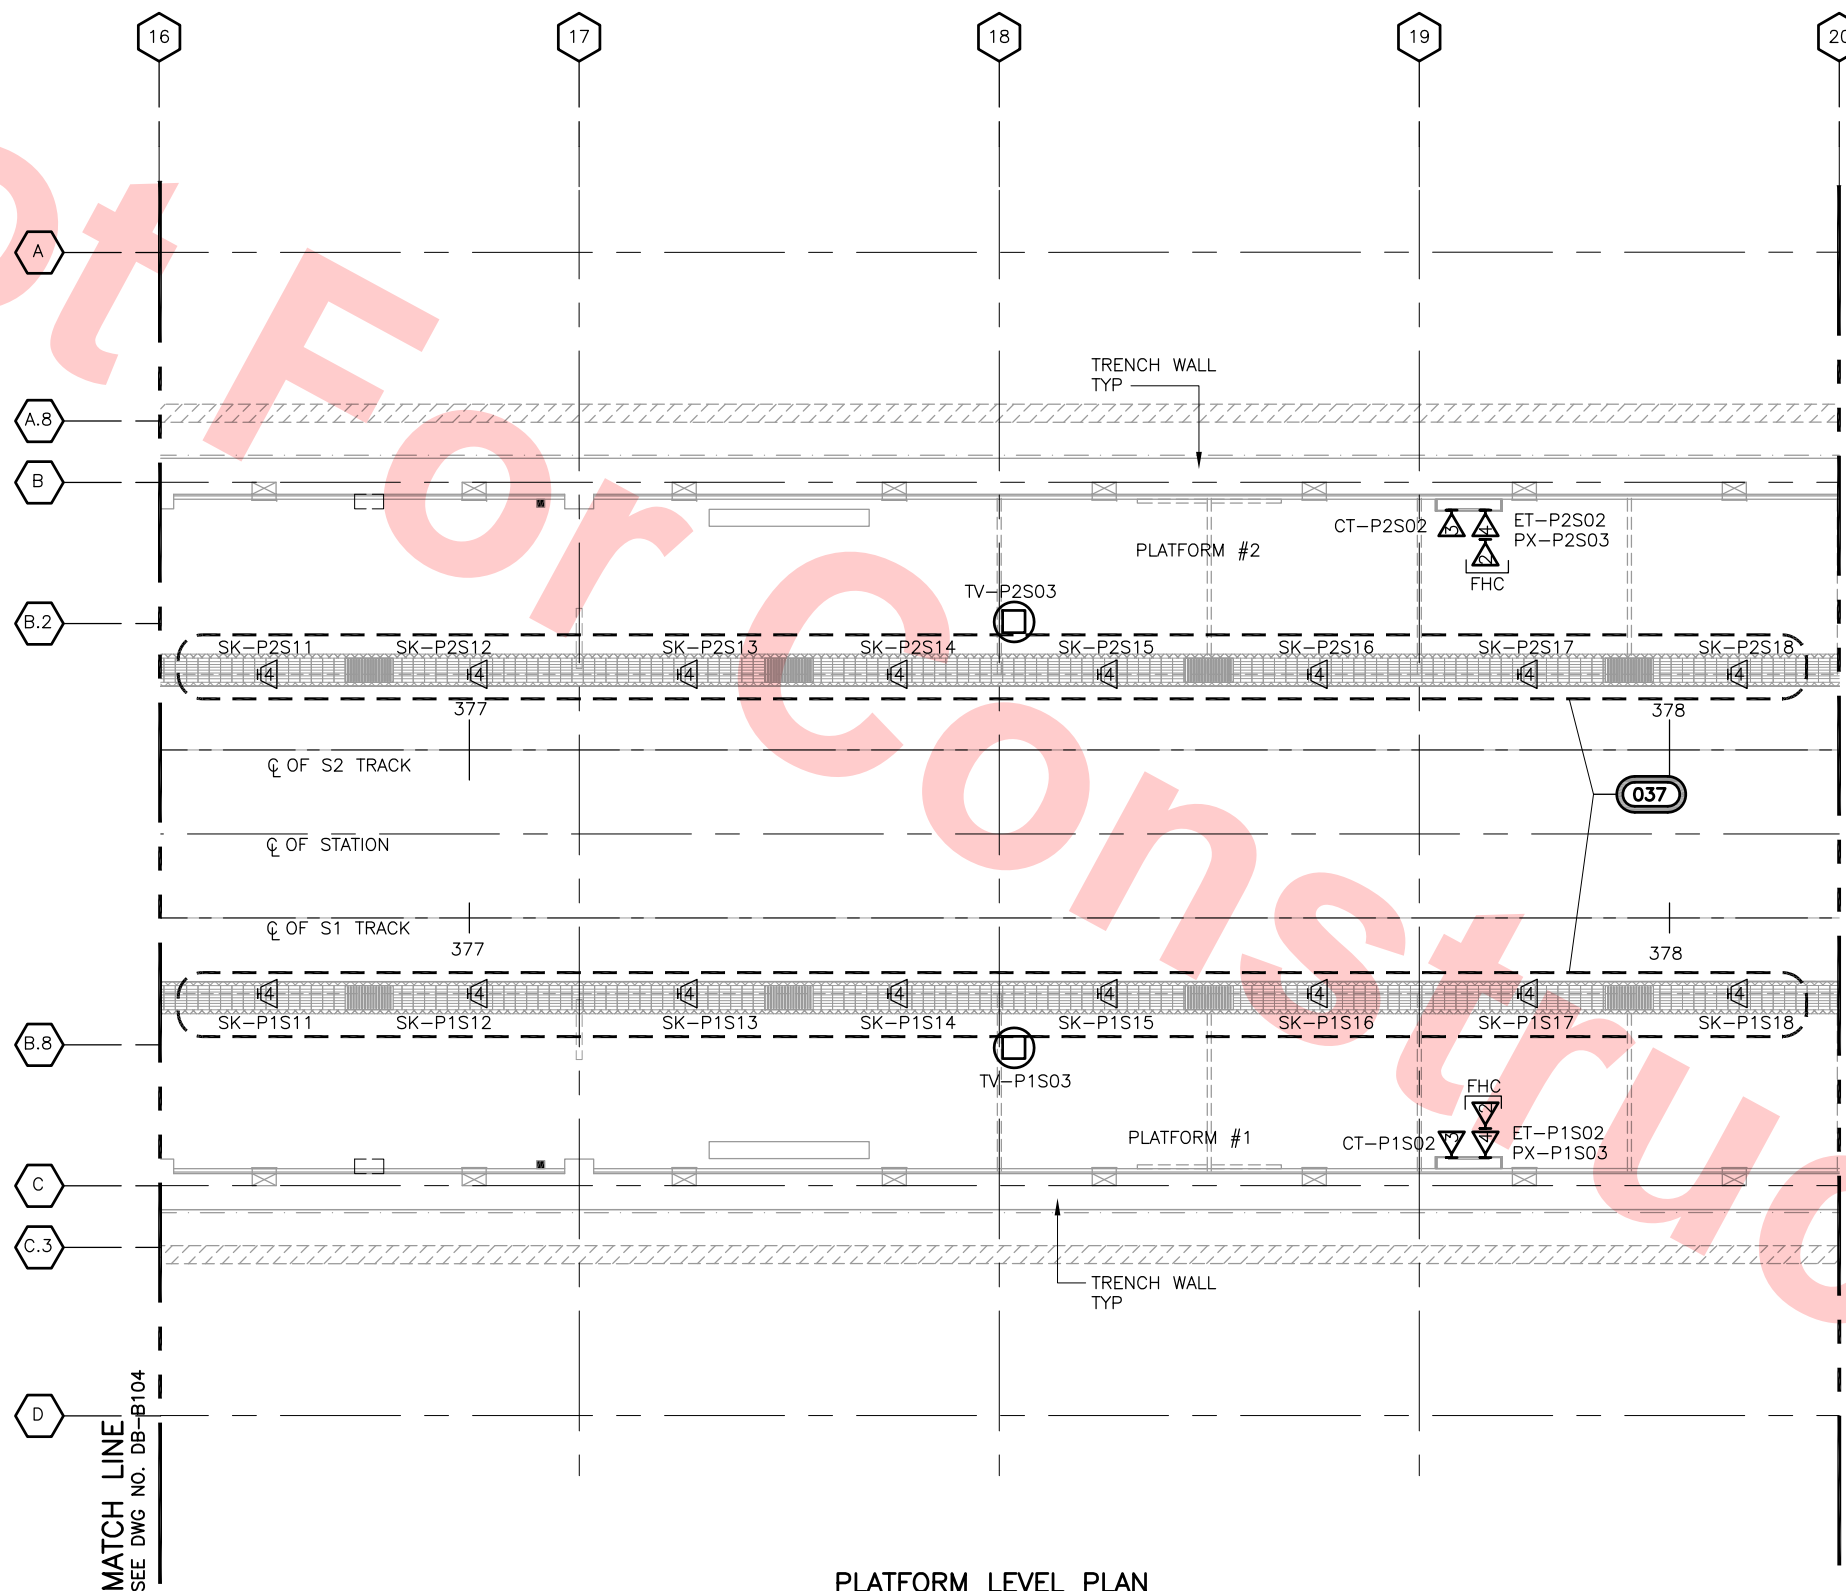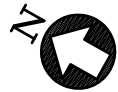


Santa Clara Valley Transportation Authority

NO EXCEPTIONS TAKEN (NET)
MAKE CORRECTIONS NOTED (MCN)
AMEND AND RESUBMIT (A/R)

Any action shown above is subject to the terms of the contract and does not relieve the Contractor of any of its obligations under the contract, including design and detailing.

Contract No.: DB11002F

By: _____ Date: _____

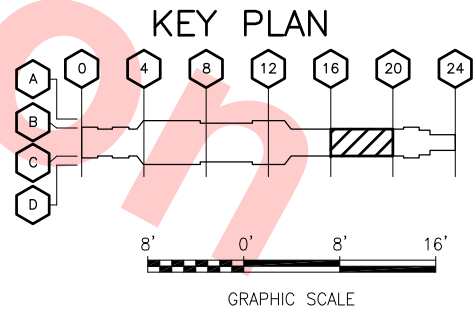


PLATFORM LEVEL PLAN
SCALE: 1/8"=1'-0"

Jun 27, 2013 11:42am C:\projects\mbs-astro\mbs34735\CTD0-S-DB-B105.dwg

REV	DATE	BY	SUB	APP	DESCRIPTION
0	20130710				READINESS FOR CONSTRUCTION

DESIGNED BY
M. GOLUCKI
DRAWN BY
B. COOPER
CHECKED BY
B. MENDEZ LORA
IN CHARGE
B. MENDEZ LORA
DATE
20130710

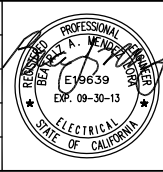

Skanska
Shimmick
Herzog

LTK
LTK Engineering Services
SUBMITTED


1436 California Circle
Milpitas, California 95035
A Joint Venture

**Lookwood, Andrews
& Newnam, Inc.**
A LEOP A DALY COMPANY
T-Y LIN INTERNATIONAL
APPROVED




LINE, TRACK, STATIONS AND SYSTEMS
DESIGN UNIT 023
MILPITAS STATION
COMMUNICATION EQUIPMENT LAYOUT
BOARDING PLATFORM LEVEL PLAN
SHEET 5 OF 6

CADD FILENAME C700-S-DB-B105.dwg	REV. 0
SIZE D	SCALE 1/8"=1'-0"
CONTRACT NO. C700	SHEET NO. B105
AREA CODE DB	PAGE NO. 1041

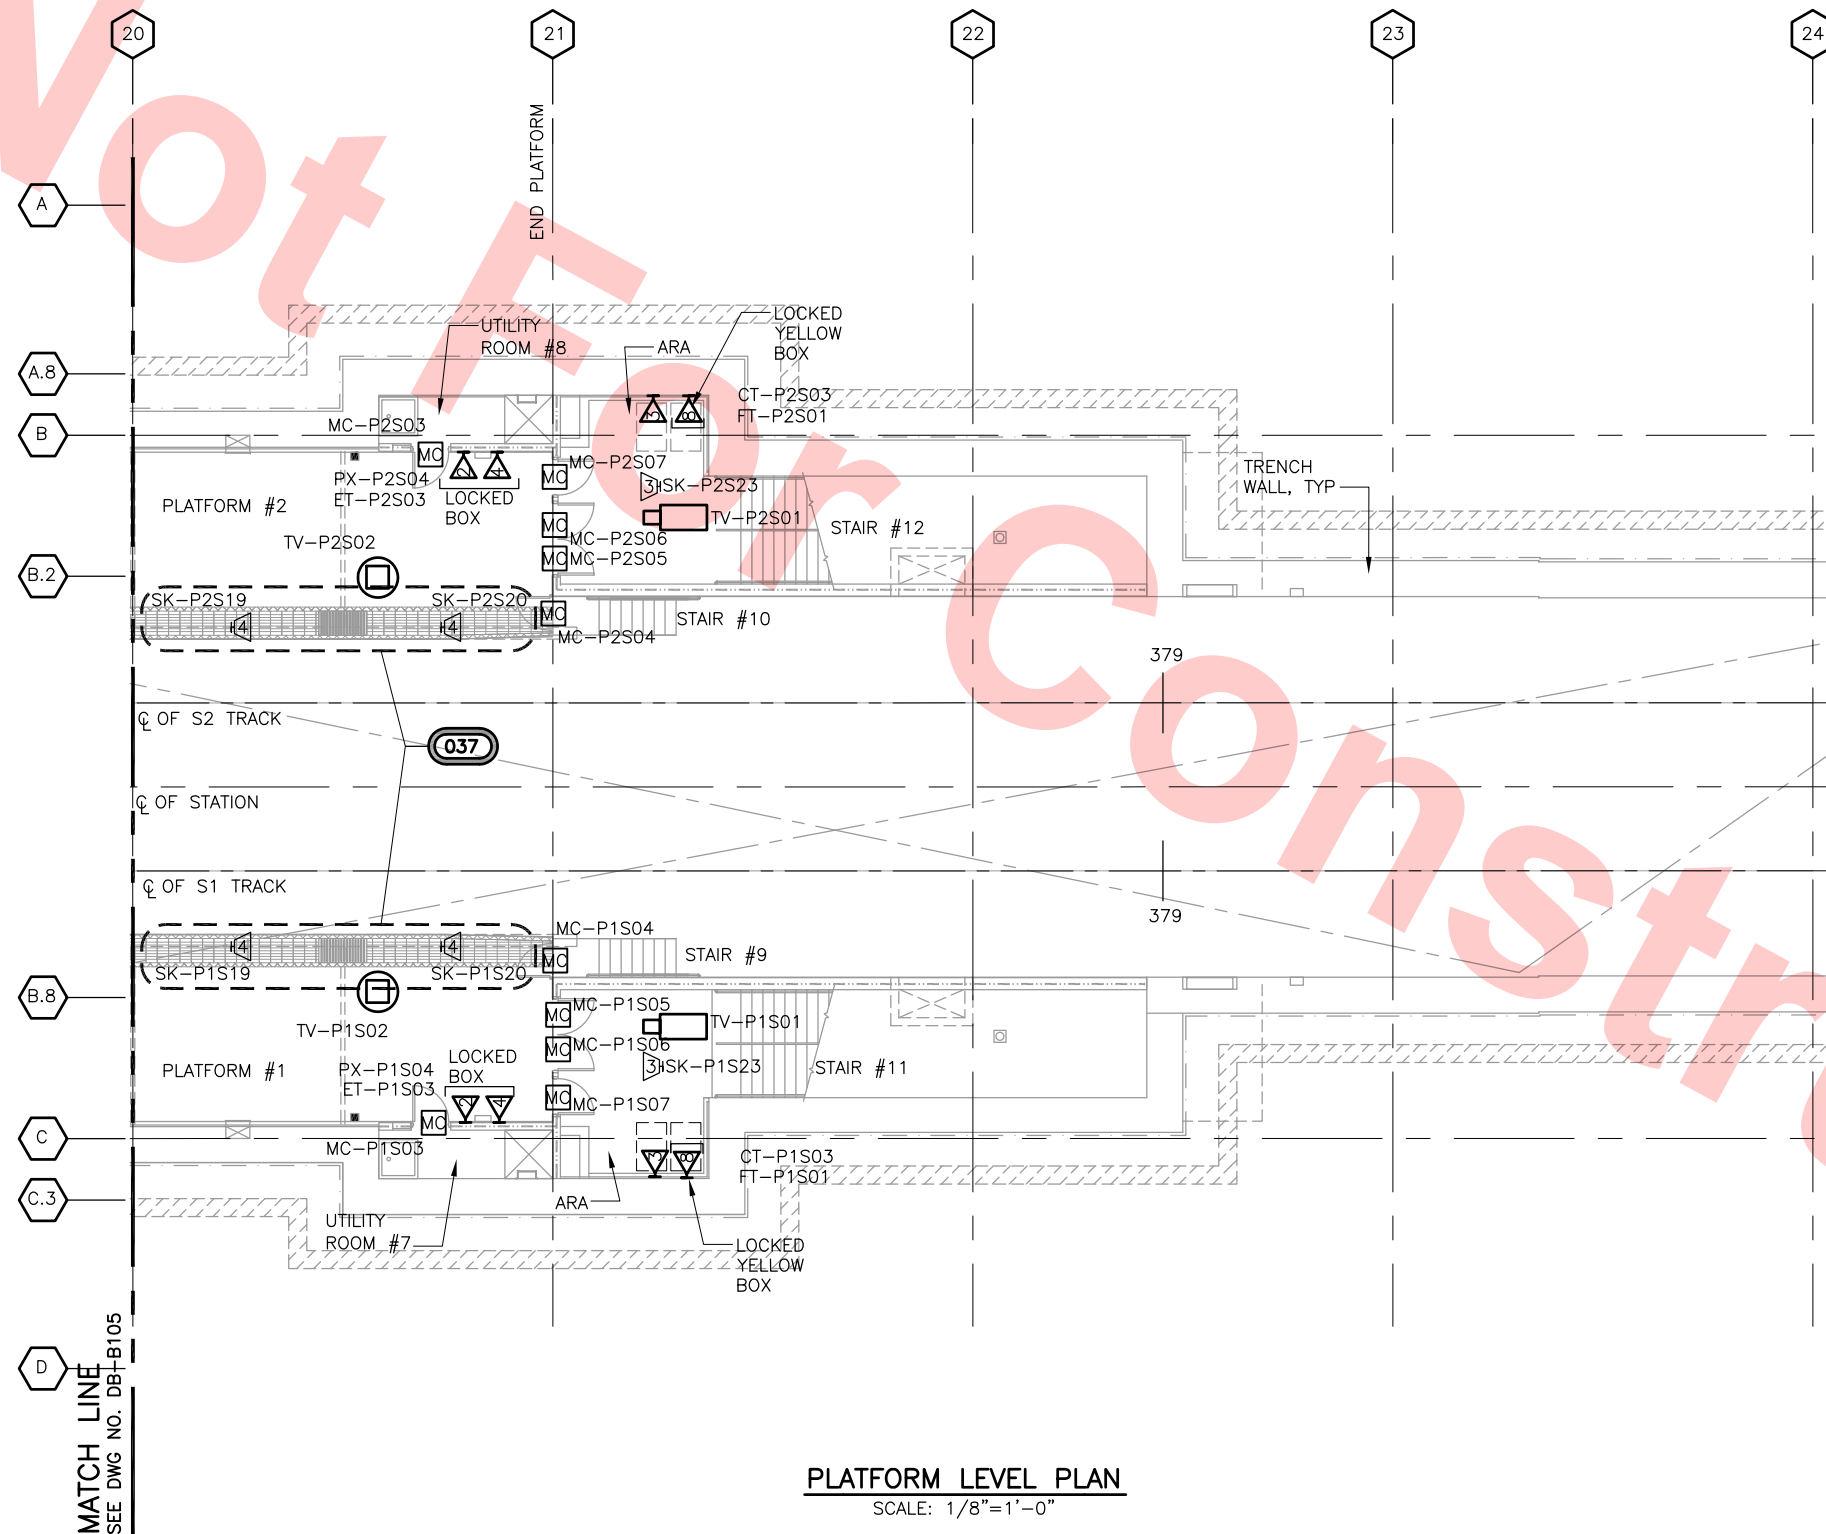


By: _____ **Date:** _____

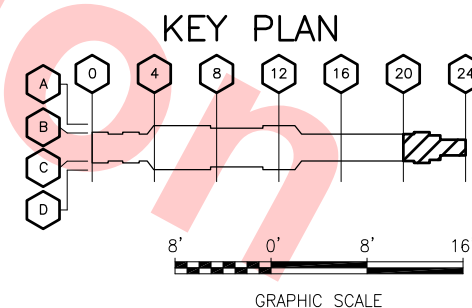

PLATFORM LEVEL PLAN
SCALE: 1/8"=1'-0"

Jun 27, 2013 - 11:00am 0						DESIGNED BY M. GOLUCKI
						DRAWN BY B. COOPER
						CHECKED BY B. MENDEZ LORA
						IN CHARGE B. MENDEZ LORA
						DATE 20130710
REV	DATE	BY	SUB	APP	DESCRIPTION	
0	20130710				READINESS FOR CONSTRUCTION	

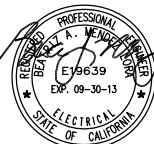

Skanska
Shimmick
Herzog

1436 California Circle
Milpitas, California 95035
A Joint Venture

LTK
LTK Engineering Services

LIN Lockwood, Andrews & Newnam, Inc.
A LEO A DALY COMPANY
T-Y-LIN INTERNATIONAL



APPROVED *R. A. Lin*


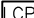





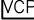

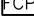



BART SILICON VALLEY BERRYESSA EXTENSION

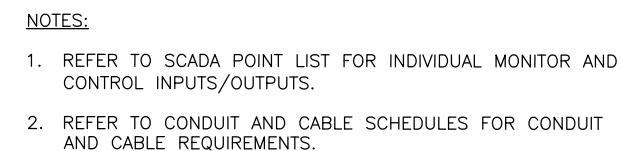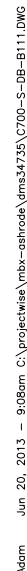LINE, TRACK, STATIONS AND SYSTEMS
DESIGN UNIT 023
MILPITAS STATION
COMMUNICATION EQUIPMENT LAYOUT
BOARDING PLATFORM LEVEL PLAN
SHEET 6 OF 6

CADD FILENAME C700-S-DB-B106.dwg		
SIZE D	SCALE 1/8"=1'-0"	
CONTRACT NO. C700		REV. 0
AREA CODE DB	SHEET NO. B106	PAGE NO. 1042




----->	HIDDEN/BURIED CONDUIT
—————>	EXPOSED CONDUIT
	COMMUNICATIONS INTERFACE CABINET
	LIGHTING CONTROL PANEL
	INPUT/OUTPUT TERMINAL BOARD/CABINET
	FARE COLLECTION INTERFACE JUNCTION BOX
	STATION AGENT BOOTH CONTROL PANEL
	CONTROL VALVE
	PASSENGER TRIP STATION
	VENTILATION CONTROL PANEL
	FIRE ALARM CONTROL PANEL
	FAN CONTROL PANEL
	DELUGE VALVE CABINET


☐ NO EXCEPTIONS TAKEN (NET)
☐ MAKE CORRECTIONS NOTED (MCN)
☐ AMEND AND RESUBMIT (A/R)

Any action shown above is subject to the terms of the contract and does not relieve the Contractor of any of its obligations under the contract, including design and detailing.

Contract No.: DB11002F

By: _____ **Date:** _____

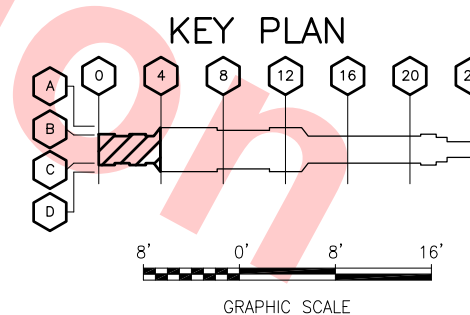

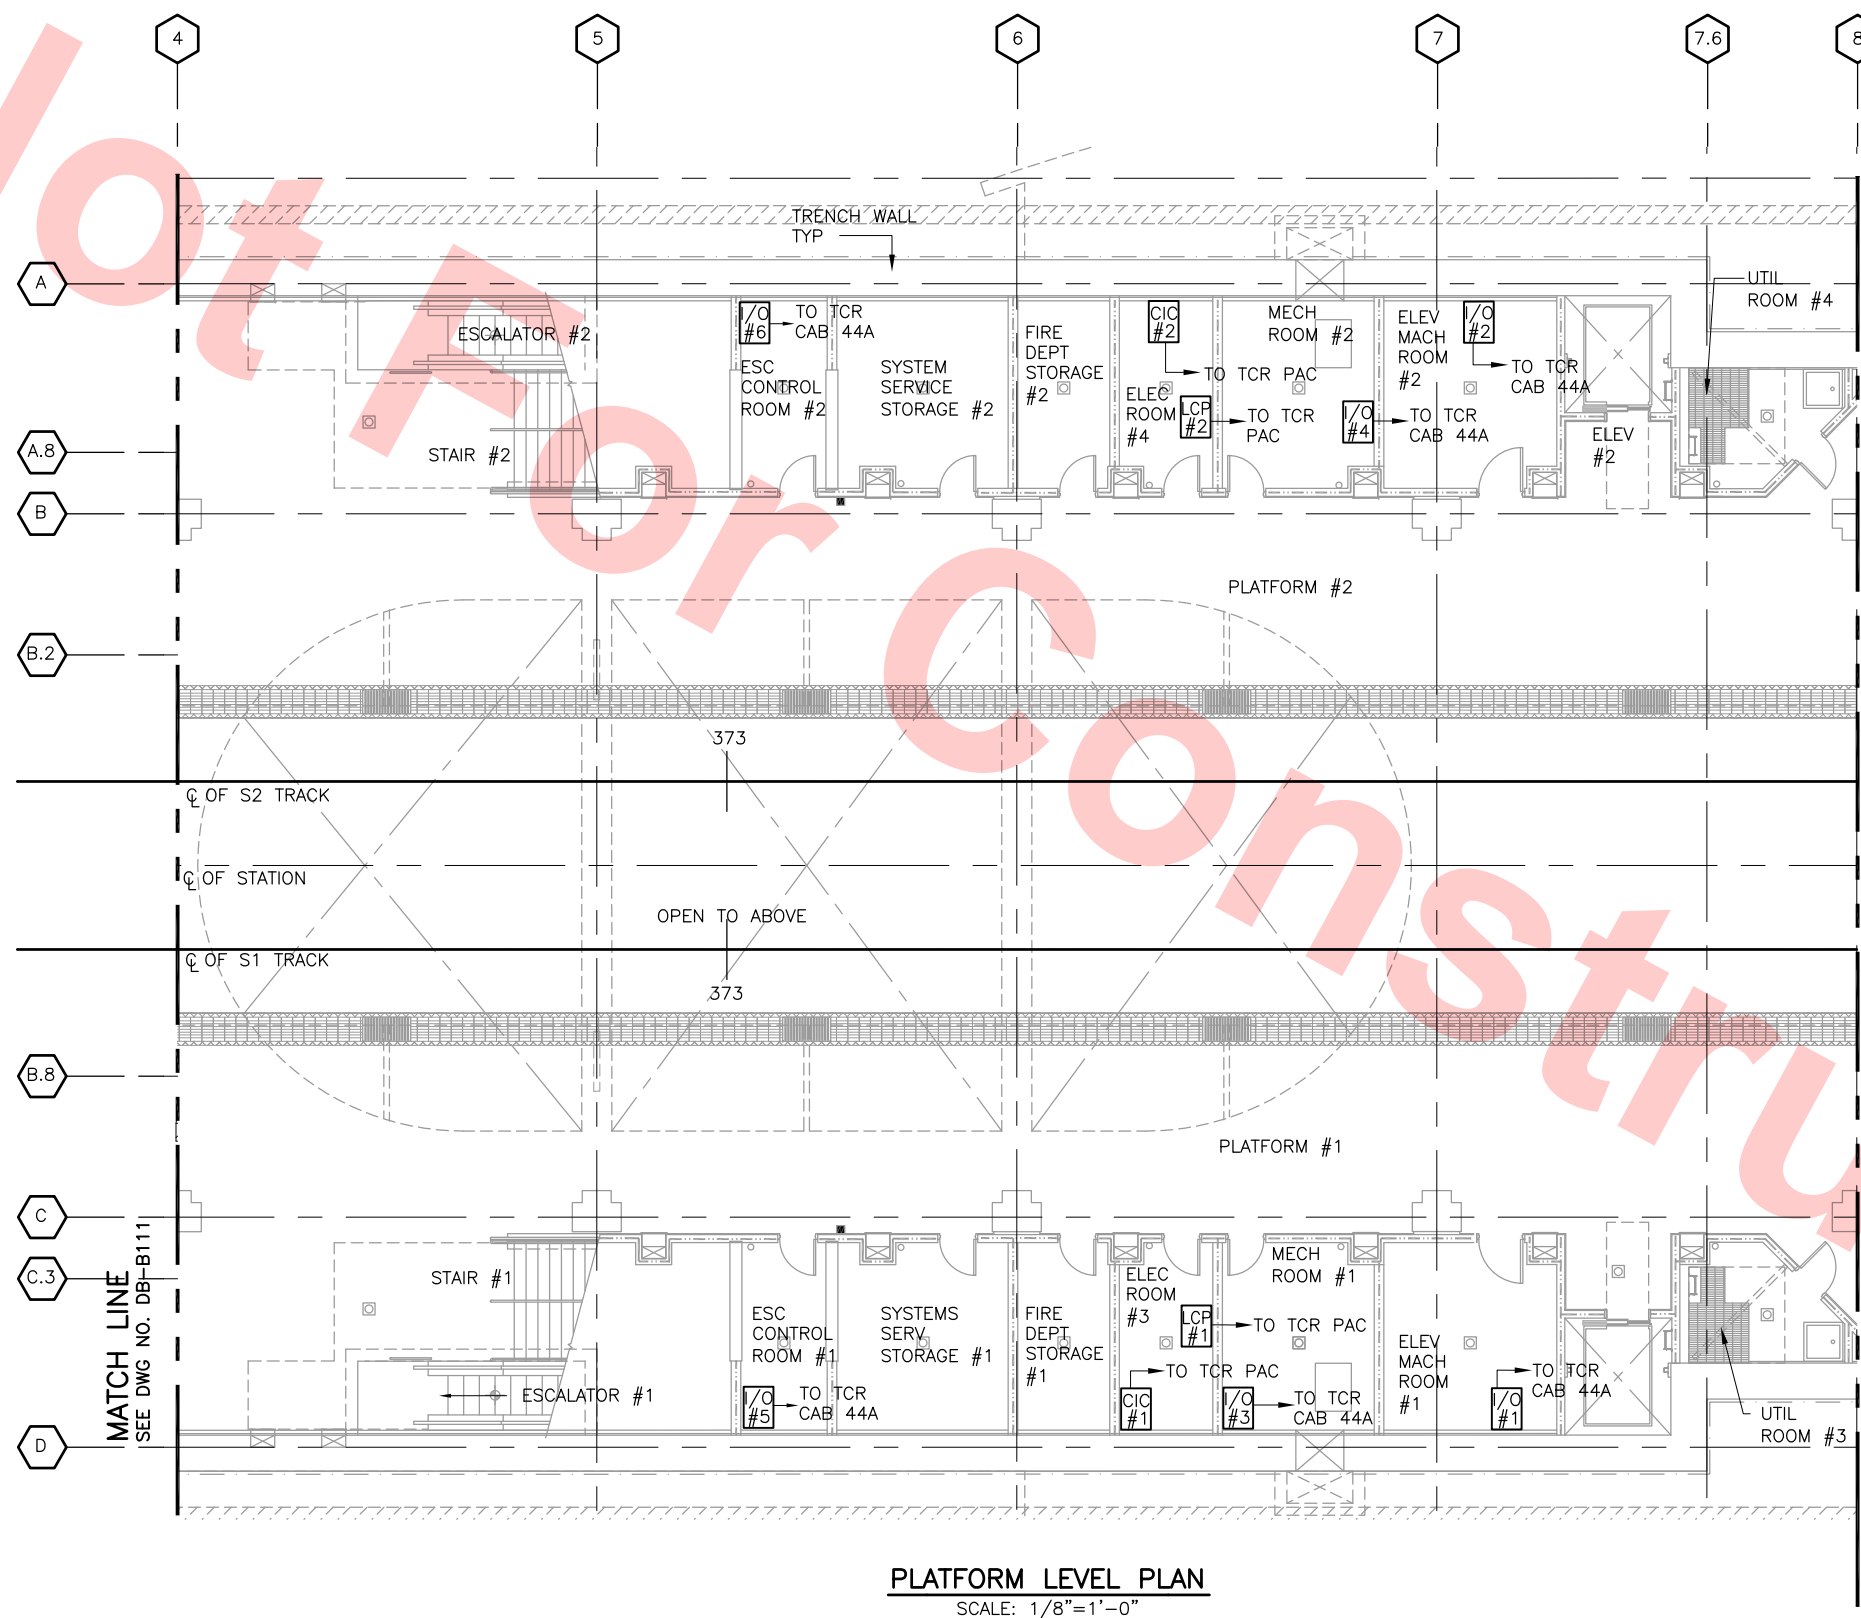

By: _____ **Date:** _____


8' 0' 8' 16'

GRAPHIC SCALE

SCALE: 1/8"=1'-0"

[illegible]

Jun 20, 2013 - 9:08am C:\projects\mbox-ashrode\lms34735\700-S-DB-B113.DWG

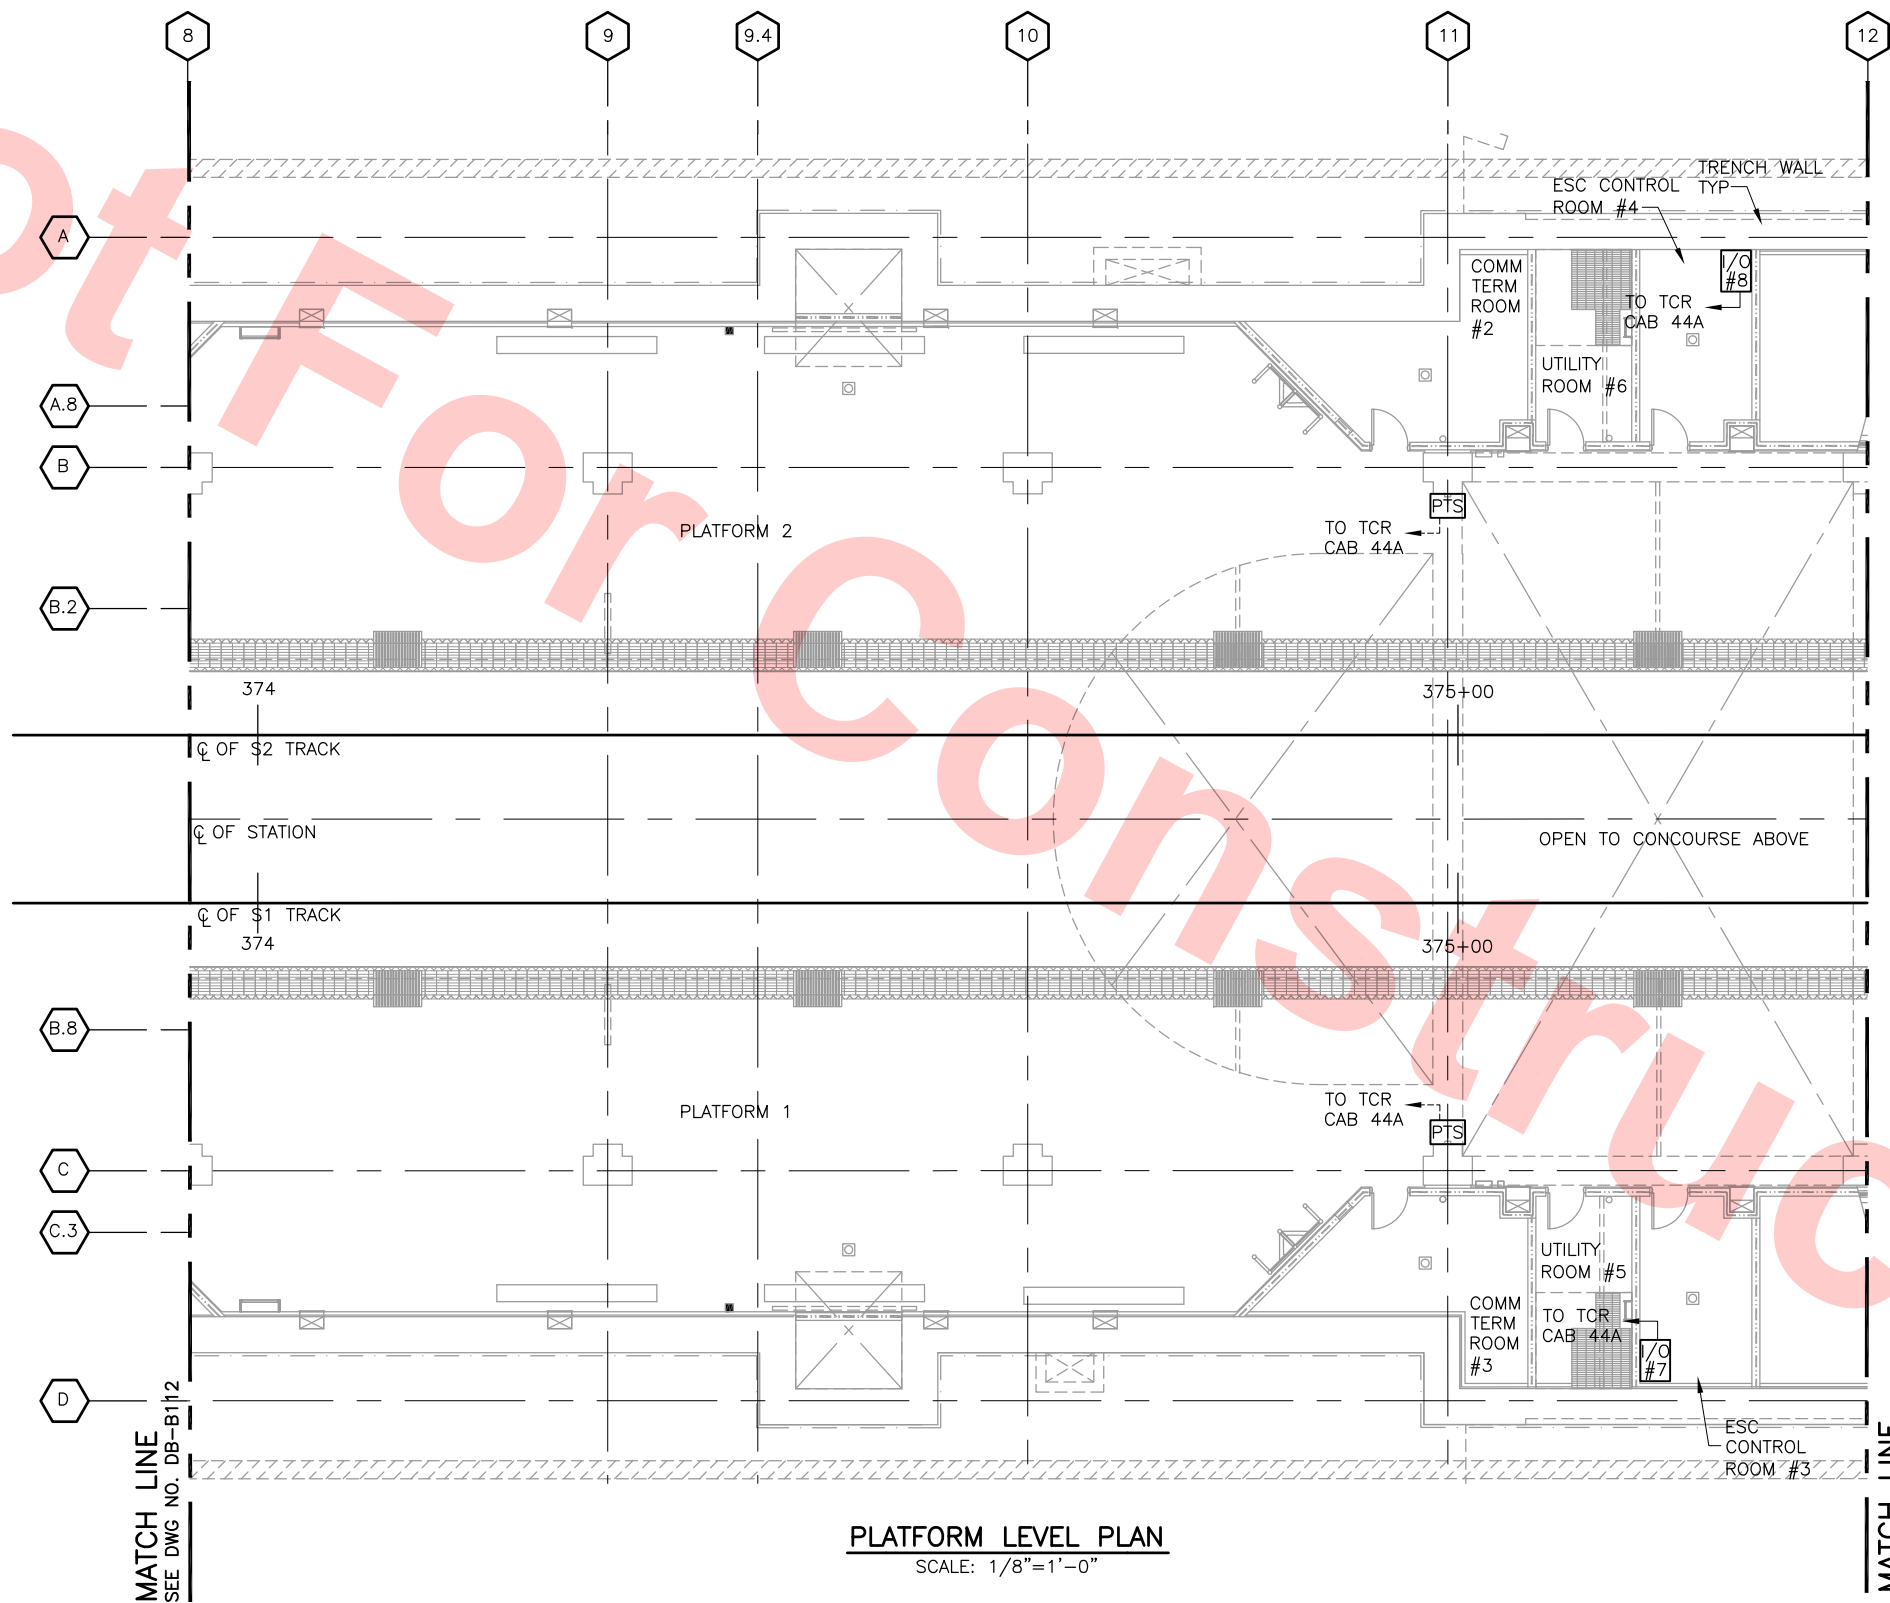

PLATFORM LEVEL PLAN
SCALE: 1/8"=1'-0"

NOTES:

1. REFER TO SCADA POINT LIST FOR INDIVIDUAL MONITOR AND CONTROL INPUTS/OUTPUTS.
2. REFER TO CONDUIT AND CABLE SCHEDULES FOR CONDUIT AND CABLE REQUIREMENTS.

LEGEND:

- HIDDEN/BURIED CONDUIT
- EXPOSED CONDUIT
- [CIC] COMMUNICATIONS INTERFACE CABINET
- [LCP] LIGHTING CONTROL PANEL
- [I/O] INPUT/OUTPUT TERMINAL BOARD/CABINET
- [FC] FARE COLLECTION INTERFACE JUNCTION BOX
- [SAB] STATION AGENT BOOTH CONTROL PANEL
- [CV] CONTROL VALVE
- [PTS] PASSENGER TRIP STATION
- [VCP] VENTILATION CONTROL PANEL
- [FACP] FIRE ALARM CONTROL PANEL
- [FCP] FAN CONTROL PANEL
- [DVC] DELUGE VALVE CABINET

Santa Clara Valley Transportation Authority


- NO EXCEPTIONS TAKEN (NET)
- MAKE CORRECTIONS NOTED (MCN)
- AMEND AND RESUBMIT (A/R)

Any action shown above is subject to the terms of the contract and does not relieve the Contractor of any of its obligations under the contract, including design and detailing.

Contract No.: DB11002F

By: Date:


KEY PLAN

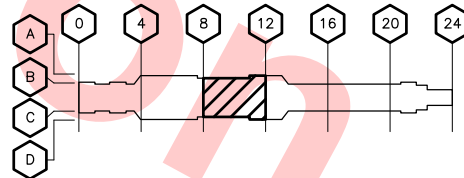

GRAPHIC SCALE

REV	DATE	BY	SUB	APP	DESCRIPTION
0	20130710				READINESS FOR CONSTRUCTION

DESIGNED BY
M. GOLUCKI
DRAWN BY
B. COOPER
CHECKED BY
B. MENDEZ LORA
IN CHARGE
B. MENDEZ LORA
DATE
20130710

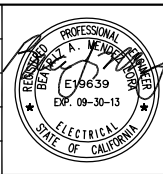


Skanska
Shimmick
Herzog
LTK
LTK Engineering Services
SUBMITTED

1436 California Circle
Milpitas, California 95035
A Joint Venture
**Lookwood, Andrews
& Newnam, Inc.**
T-Y-LIN INTERNATIONAL
APPROVED



LINE, TRACK, STATIONS AND SYSTEMS
DESIGN UNIT 023
MILPITAS STATION
SCADA INTEGRATION EQUIPMENT LAYOUT
BOARDING PLATFORM LEVEL PLAN
SHEET 3 OF 6

CADD FILENAME C700-S-DB-B113.dwg	REV. 0
SIZE D	SCALE 1/8"=1'-0"
CONTRACT NO. C700	SHEET NO. B113
AREA CODE DB	PAGE NO. 1045

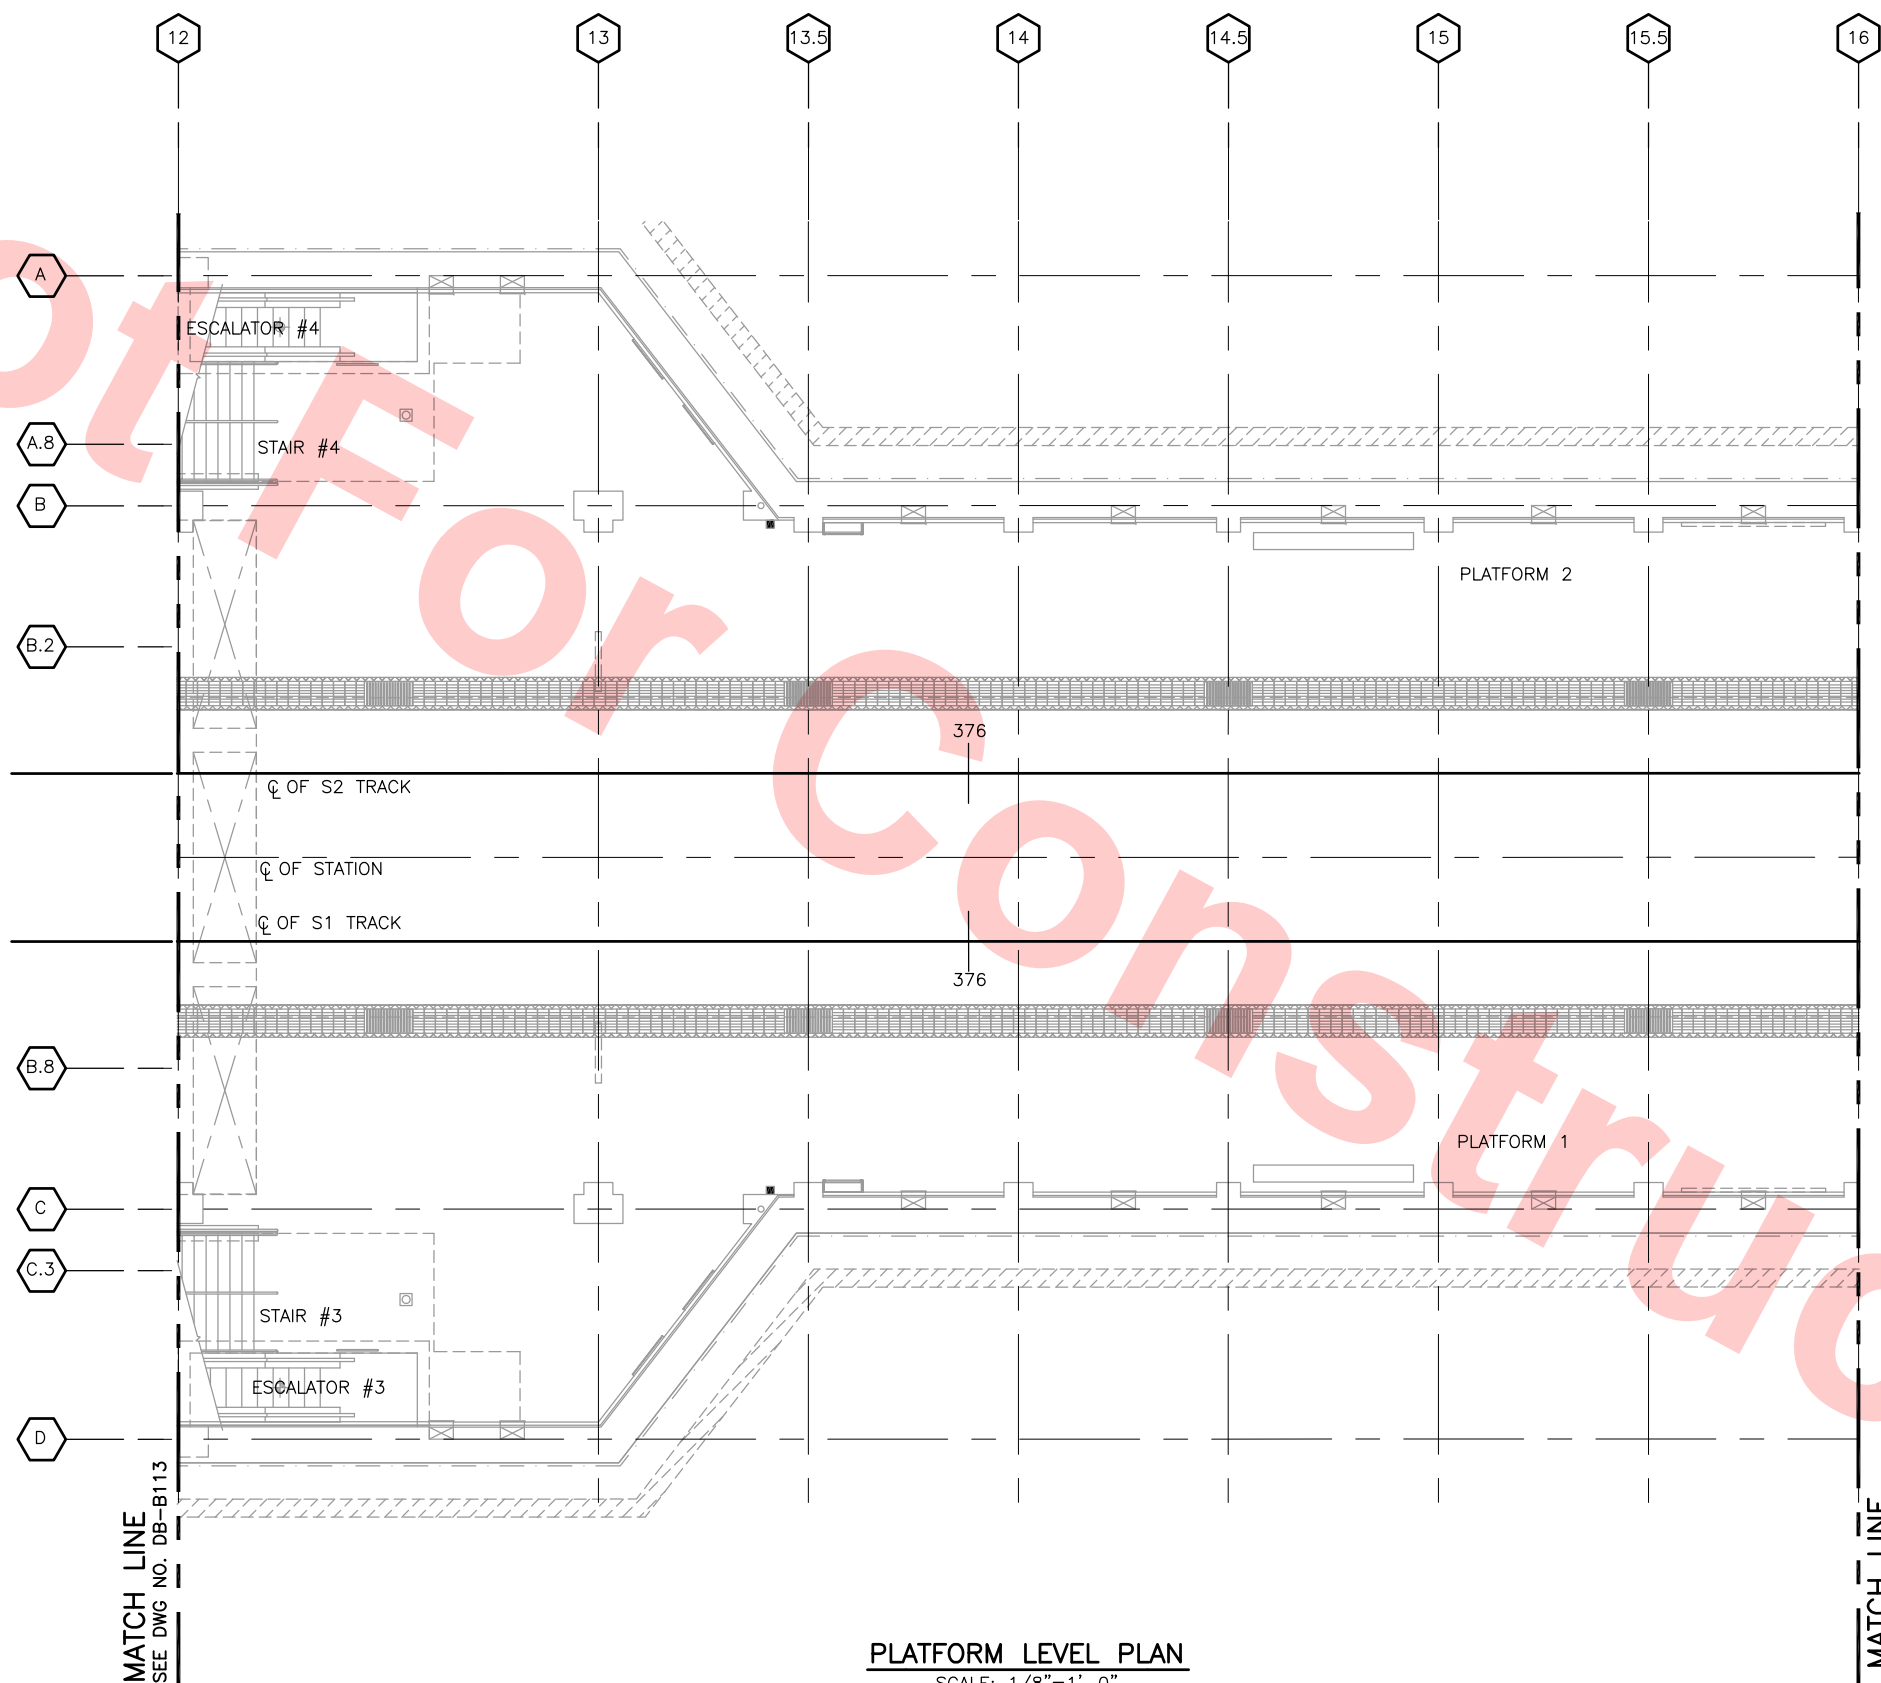

PLATFORM LEVEL PLAN
SCALE: 1/8"=1'-0"

NOTE:
THIS DRAWING IS SHOWN FOR STATION CONTINUATION.
THERE ARE NO SYSTEMS/COMMUNICATION INTERFACES
AT THIS LOCATION.


Santa Clara Valley Transportation Authority

- NO EXCEPTIONS TAKEN (NET)
- MAKE CORRECTIONS NOTED (MCN)
- AMEND AND RESUBMIT (A/R)

Any action shown above is subject to the terms of the contract
and does not relieve the Contractor of any of its obligations
under the contract, including design and detailing.

Contract No.: DB11002F


By: _____ Date: _____

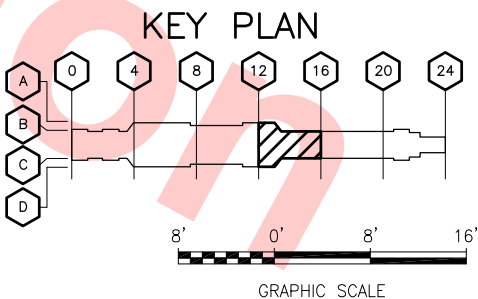

Jun 20, 2013 9:08am C:\projects\mbs-ashrode\lms34735\700-S-DB-B114.dwg

REV	DATE	BY	SUB	APP	DESCRIPTION
0	20130710				READINESS FOR CONSTRUCTION

DESIGNED BY
M. GOLUCKI
DRAWN BY
B. COOPER
CHECKED BY
B. MENDEZ LORA
IN CHARGE
B. MENDEZ LORA
DATE
20130710

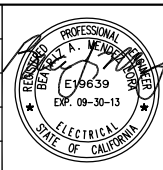

Skanska
Shimmick
Herzog

1436 California Circle
Milpitas, California 95035
A Joint Venture

LTK
LTK Engineering Services

SUBMITTED

**Lookwood, Andrews
& Newnam, Inc.**
A LEO A DALY COMPANY

T-Y LIN INTERNATIONAL

APPROVED

BART
SILICON VALLEY

BART SILICON VALLEY BERRYESSA EXTENSION


LINE, TRACK, STATIONS AND SYSTEMS
DESIGN UNIT 023
MILPITAS STATION
SCADA INTEGRATION EQUIPMENT LAYOUT
BOARDING PLATFORM LEVEL PLAN
SHEET 4 OF 6

CADD FILENAME
C700-S-DB-B114.dwg

SIZE SCALE
D 1/8"=1'-0"

CONTRACT NO. C700 REV. 0

AREA CODE DB SHEET NO. B114 PAGE NO. 1046

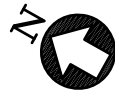

- NOTES:
1. REFER TO SCADA POINT LIST FOR INDIVIDUAL MONITOR AND CONTROL INPUTS/OUTPUTS.
 2. REFER TO CONDUIT AND CABLE SCHEDULES FOR CONDUIT AND CABLE REQUIREMENTS.

LEGEND:

- HIDDEN/BURIED CONDUIT
- EXPOSED CONDUIT
- CIC COMMUNICATIONS INTERFACE CABINET
- LCP LIGHTING CONTROL PANEL
- I/O INPUT/OUTPUT TERMINAL BOARD/CABINET
- FC FARE COLLECTION INTERFACE JUNCTION BOX
- SAB STATION AGENT BOOTH CONTROL PANEL
- CV CONTROL VALVE
- PTS PASSENGER TRIP STATION
- VCF VENTILATION CONTROL PANEL
- FACP FIRE ALARM CONTROL PANEL
- FCP FAN CONTROL PANEL
- DVC DELUGE VALVE CABINET

Santa Clara Valley Transportation Authority


- NO EXCEPTIONS TAKEN (NET)
- MAKE CORRECTIONS NOTED (MCN)
- AMEND AND RESUBMIT (A/R)

Any action shown above is subject to the terms of the contract and does not relieve the Contractor of any of its obligations under the contract, including design and detailing.

Contract No.: DB11002F

By: Date:

KEY PLAN

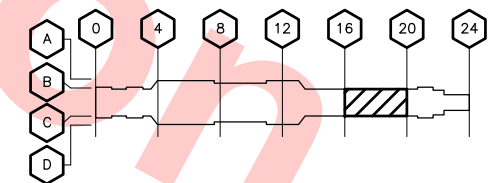

GRAPHIC SCALE

PLATFORM LEVEL PLAN

SCALE: 1/8"=1'-0"


MATCH LINE
SEE DWG NO. DB-B114

MATCH LINE
SEE DWG NO. DB-B116

Jun 20, 2013 9:08am C:\projects\mbox\ashrode\lms34735\700-S-DB-B115.DWG

REV	DATE	BY	SUB	APP	DESCRIPTION
0	20130710				READINESS FOR CONSTRUCTION

DESIGNED BY
M. GOLUCKI
DRAWN BY
B. COOPER
CHECKED BY
B. MENDEZ LORA
IN CHARGE
B. MENDEZ LORA
DATE
20130710

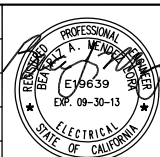

Skanska
Shimmick
Herzog
LTK
LTK Engineering Services
SUBMITTED

1436 California Circle
Milpitas, California 95035
A Joint Venture


**Lookwood, Andrews
& Newnam, Inc.**
A LEQ A BALLY COMPANY
T-Y-LIN INTERNATIONAL
APPROVED



BART SILICON VALLEY BERRYESSA EXTENSION

LINE, TRACK, STATIONS AND SYSTEMS
DESIGN UNIT 023
MILPITAS STATION
SCADA INTEGRATION EQUIPMENT LAYOUT
BOARDING PLATFORM LEVEL PLAN
SHEET 5 OF 6

CADD FILENAME C700-S-DB-B115.dwg	REV. 0
SIZE D	SCALE 1/8"=1'-0"
CONTRACT NO. C700	PAGE NO. 1047
AREA CODE DB	SHEET NO. B115

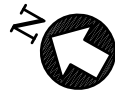

NOTES:

1. REFER TO SCADA POINT LIST FOR INDIVIDUAL MONITOR AND CONTROL INPUTS/OUTPUTS.
2. REFER TO CONDUIT AND CABLE SCHEDULES FOR CONDUIT AND CABLE REQUIREMENTS.

LEGEND:

	HIDDEN/BURIED CONDUIT
	EXPOSED CONDUIT
	COMMUNICATIONS INTERFACE CABINET
	LIGHTING CONTROL PANEL
	INPUT/OUTPUT TERMINAL BOARD/CABINET
	FARE COLLECTION INTERFACE JUNCTION BOX
	STATION AGENT BOOTH CONTROL PANEL
	CONTROL VALVE
	PASSENGER TRIP STATION
	VENTILATION CONTROL PANEL
	FIRE ALARM CONTROL PANEL
	FAN CONTROL PANEL
	DELUGE VALVE CABINET


Santa Clara Valley Transportation Authority

- NO EXCEPTIONS TAKEN (NET)
- MAKE CORRECTIONS NOTED (MCN)
- AMEND AND RESUBMIT (A/R)


Any action shown above is subject to the terms of the contract and does not relieve the Contractor of any of its obligations under the contract, including design and detailing.

Contract No.: DB11002F

By: _____ Date: _____

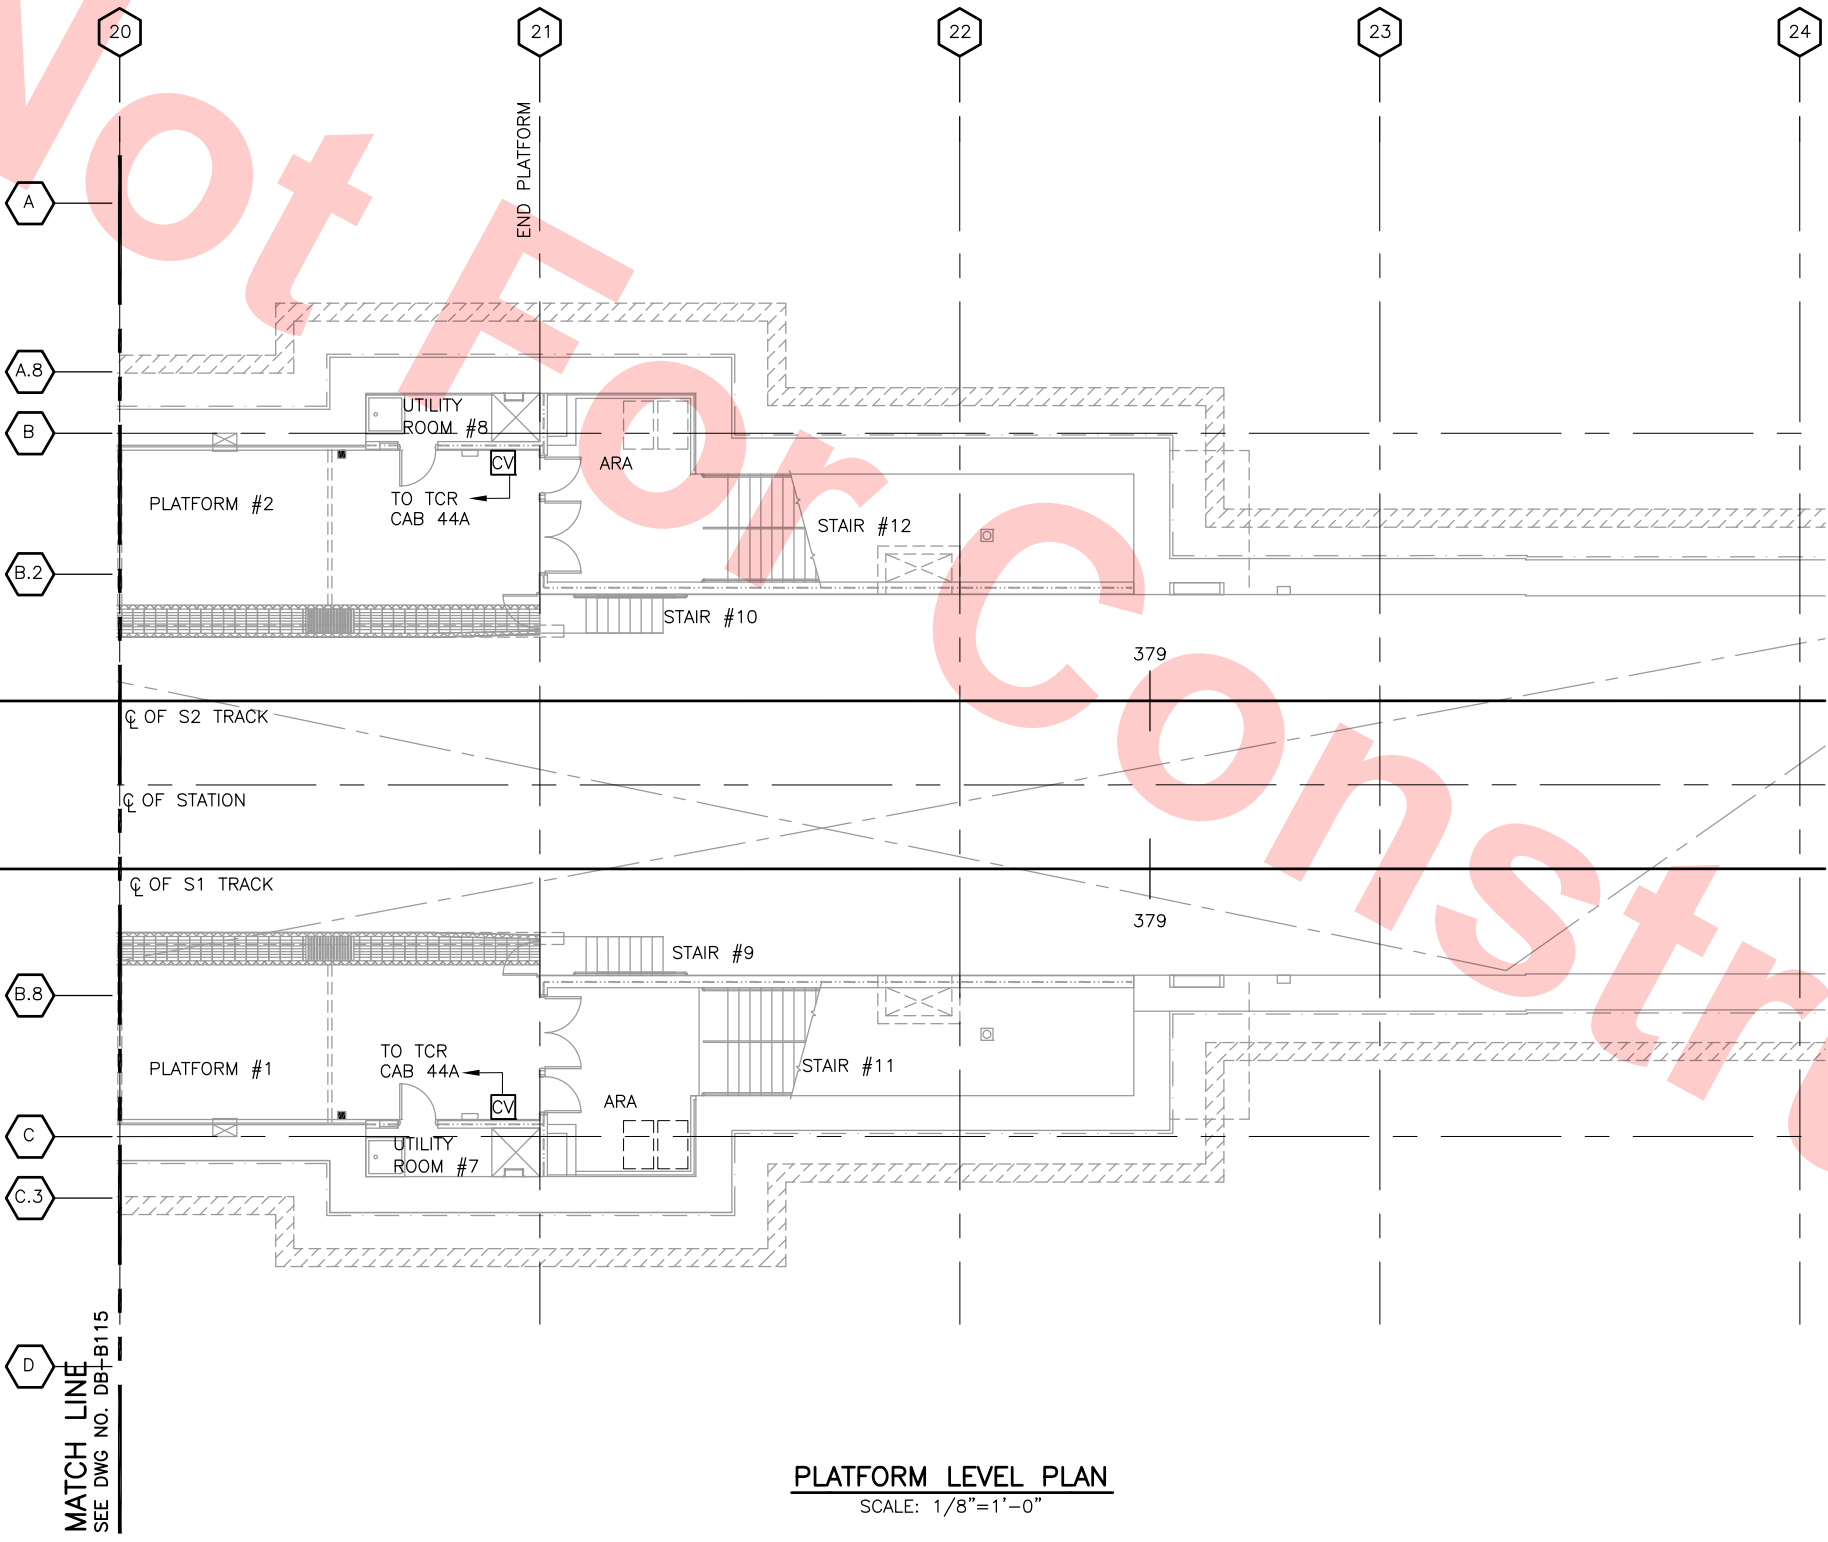


PLATFORM LEVEL PLAN
SCALE: 1/8"=1'-0"

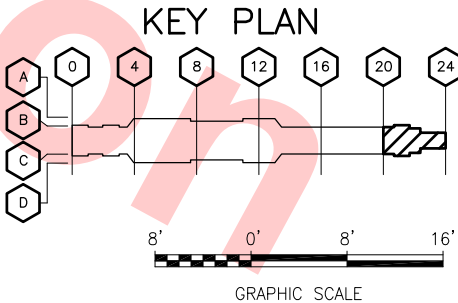

Jun 26, 2013 1:13pm C:\projects\mbox-ashrode\lms34735\700-S-DB-B116.dwg

DESIGNED BY M. GOLUCKI	
DRAWN BY B. COOPER	
CHECKED BY B. MENDEZ LORA	
IN CHARGE B. MENDEZ LORA	
DATE 20130710	

0	20130710				READINESS FOR CONSTRUCTION
REV	DATE	BY	SUB	APP	DESCRIPTION

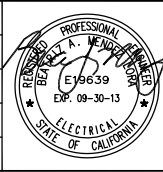

Skanska
Shimmick
Herzog

1436 California Circle
Milpitas, California 95035
A Joint Venture

LTK
LTK Engineering Services

SUBMITTED *[Signature]*

**Lookwood, Andrews
& Newnam, Inc.**
A LEOP A BALLY COMPANY

T-Y LIN INTERNATIONAL


APPROVED *[Signature]*

BART
SILICON VALLEY

BART SILICON VALLEY BERRYESSA EXTENSION

LINE, TRACK, STATIONS AND SYSTEMS
DESIGN UNIT 023
MILPITAS STATION
SCADA INTEGRATION EQUIPMENT LAYOUT
BOARDING PLATFORM LEVEL PLAN
SHEET 6 OF 6

CADD FILENAME C700-S-DB-B116.dwg		
SIZE	SCALE	
D	1/8"=1'-0"	
CONTRACT NO. C700		REV. 0
AREA CODE DB	SHEET NO. B116	PAGE NO. 1048

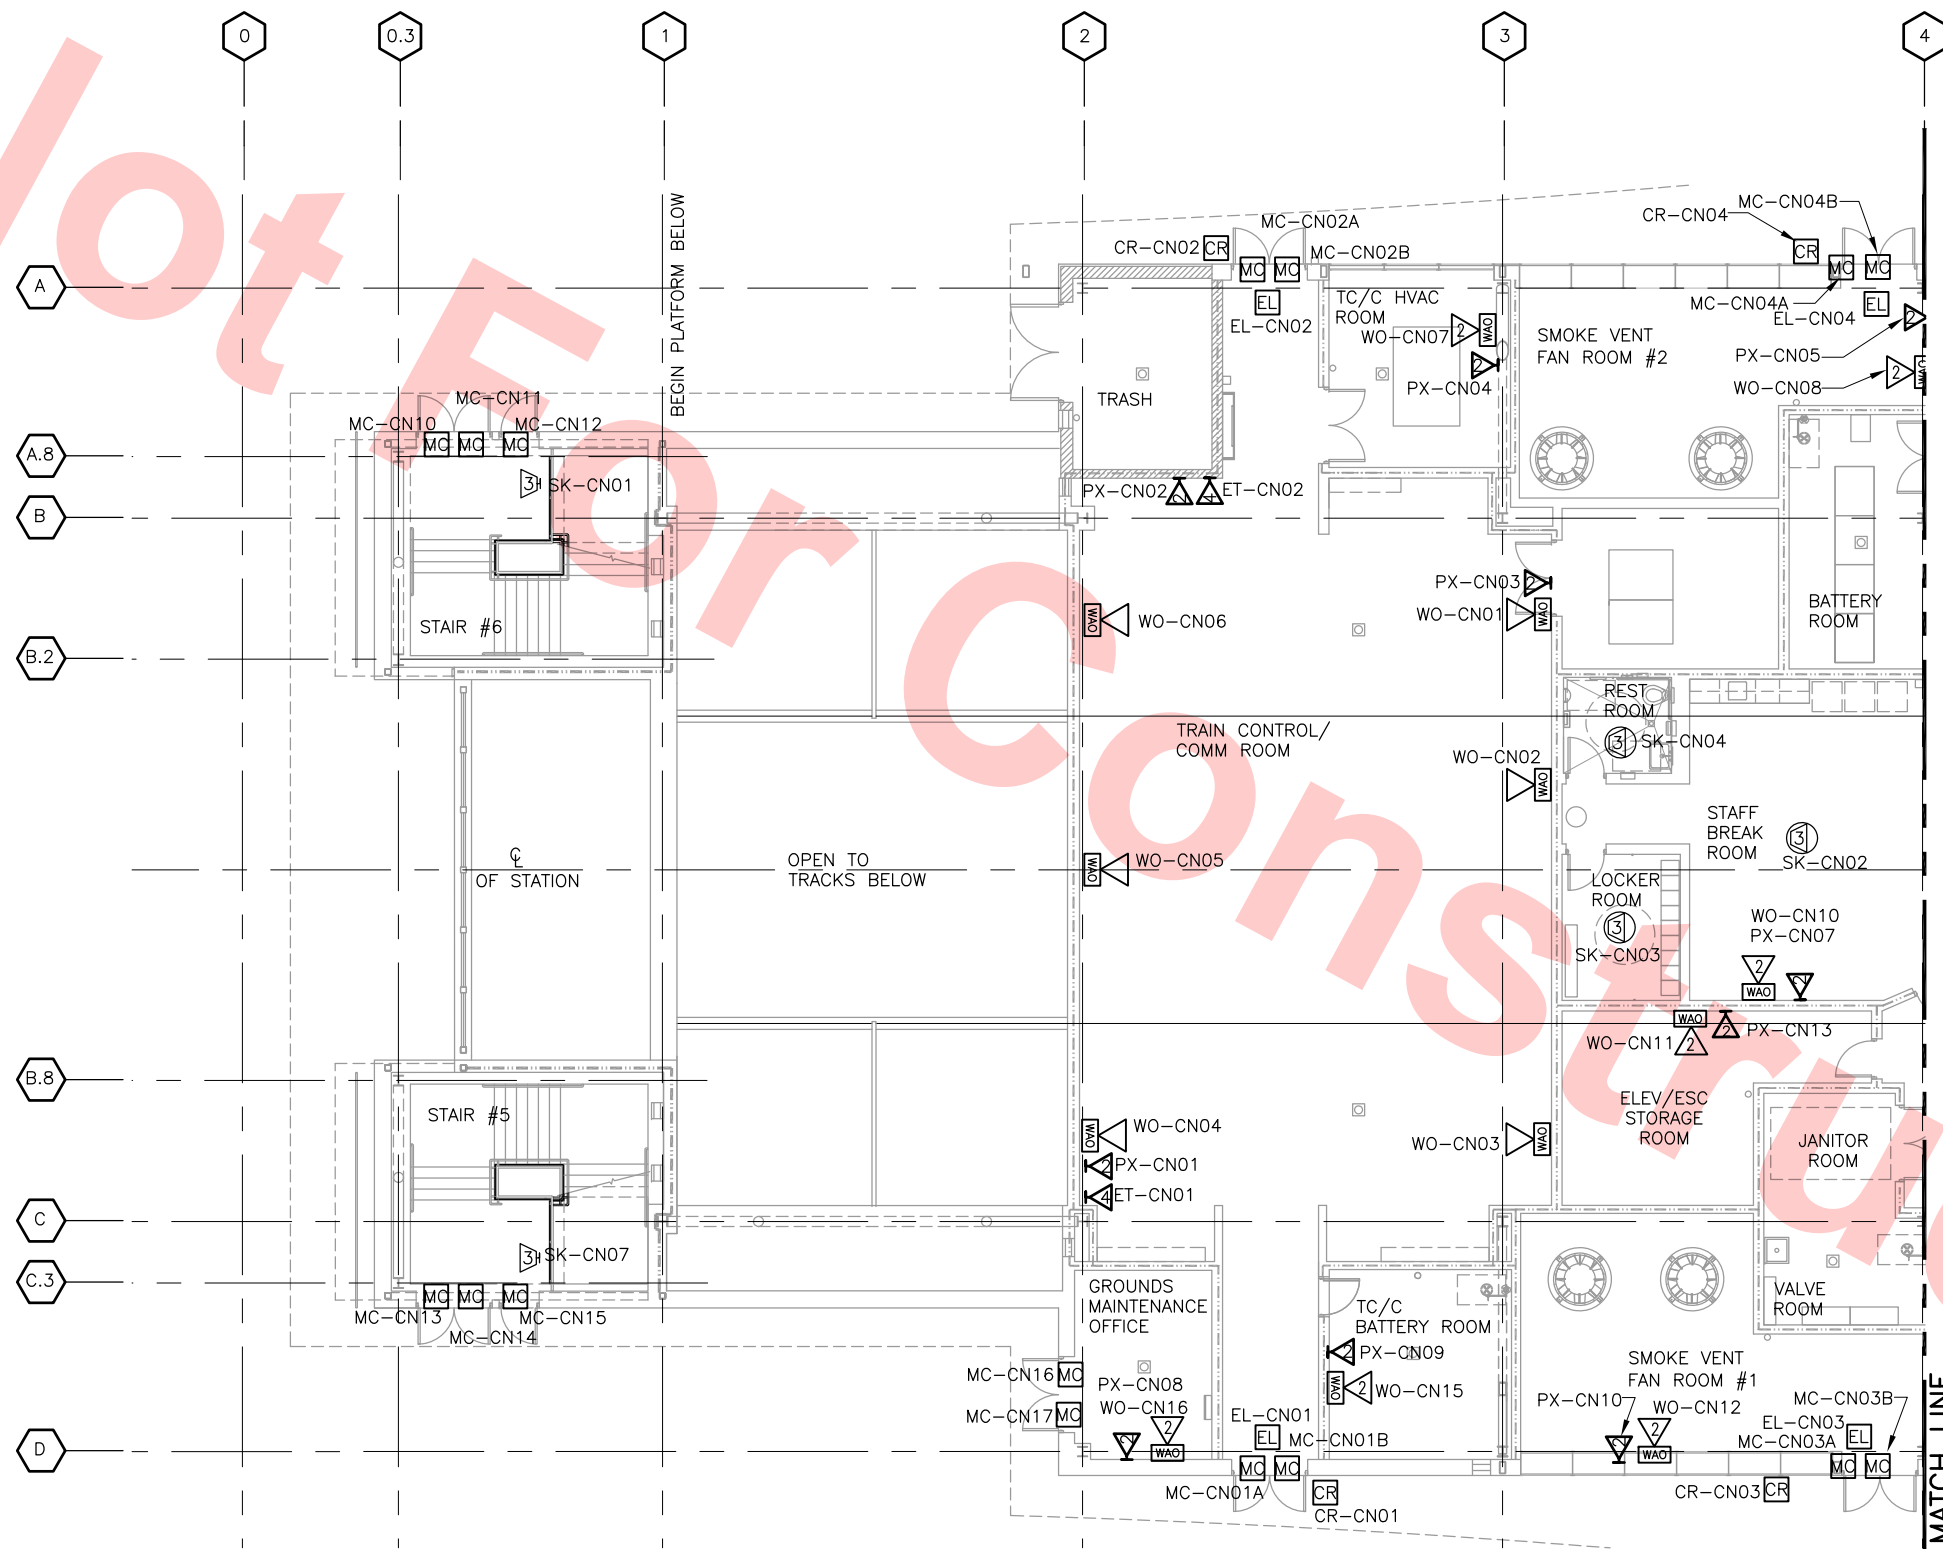


Santa Clara Valley Transportation Authority


____ **NO EXCEPTIONS TAKEN (NET)**
____ **MAKE CORRECTIONS NOTED (MCN)**
____ **AMEND AND RESUBMIT (A/R)**

Any action shown above is subject to the terms of the contract and does not relieve the Contractor of any of its obligations under the contract, including design and detailing.

Contract No.: _____ **DB11002F** _____

By: _____ Date: _____

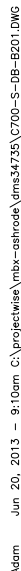


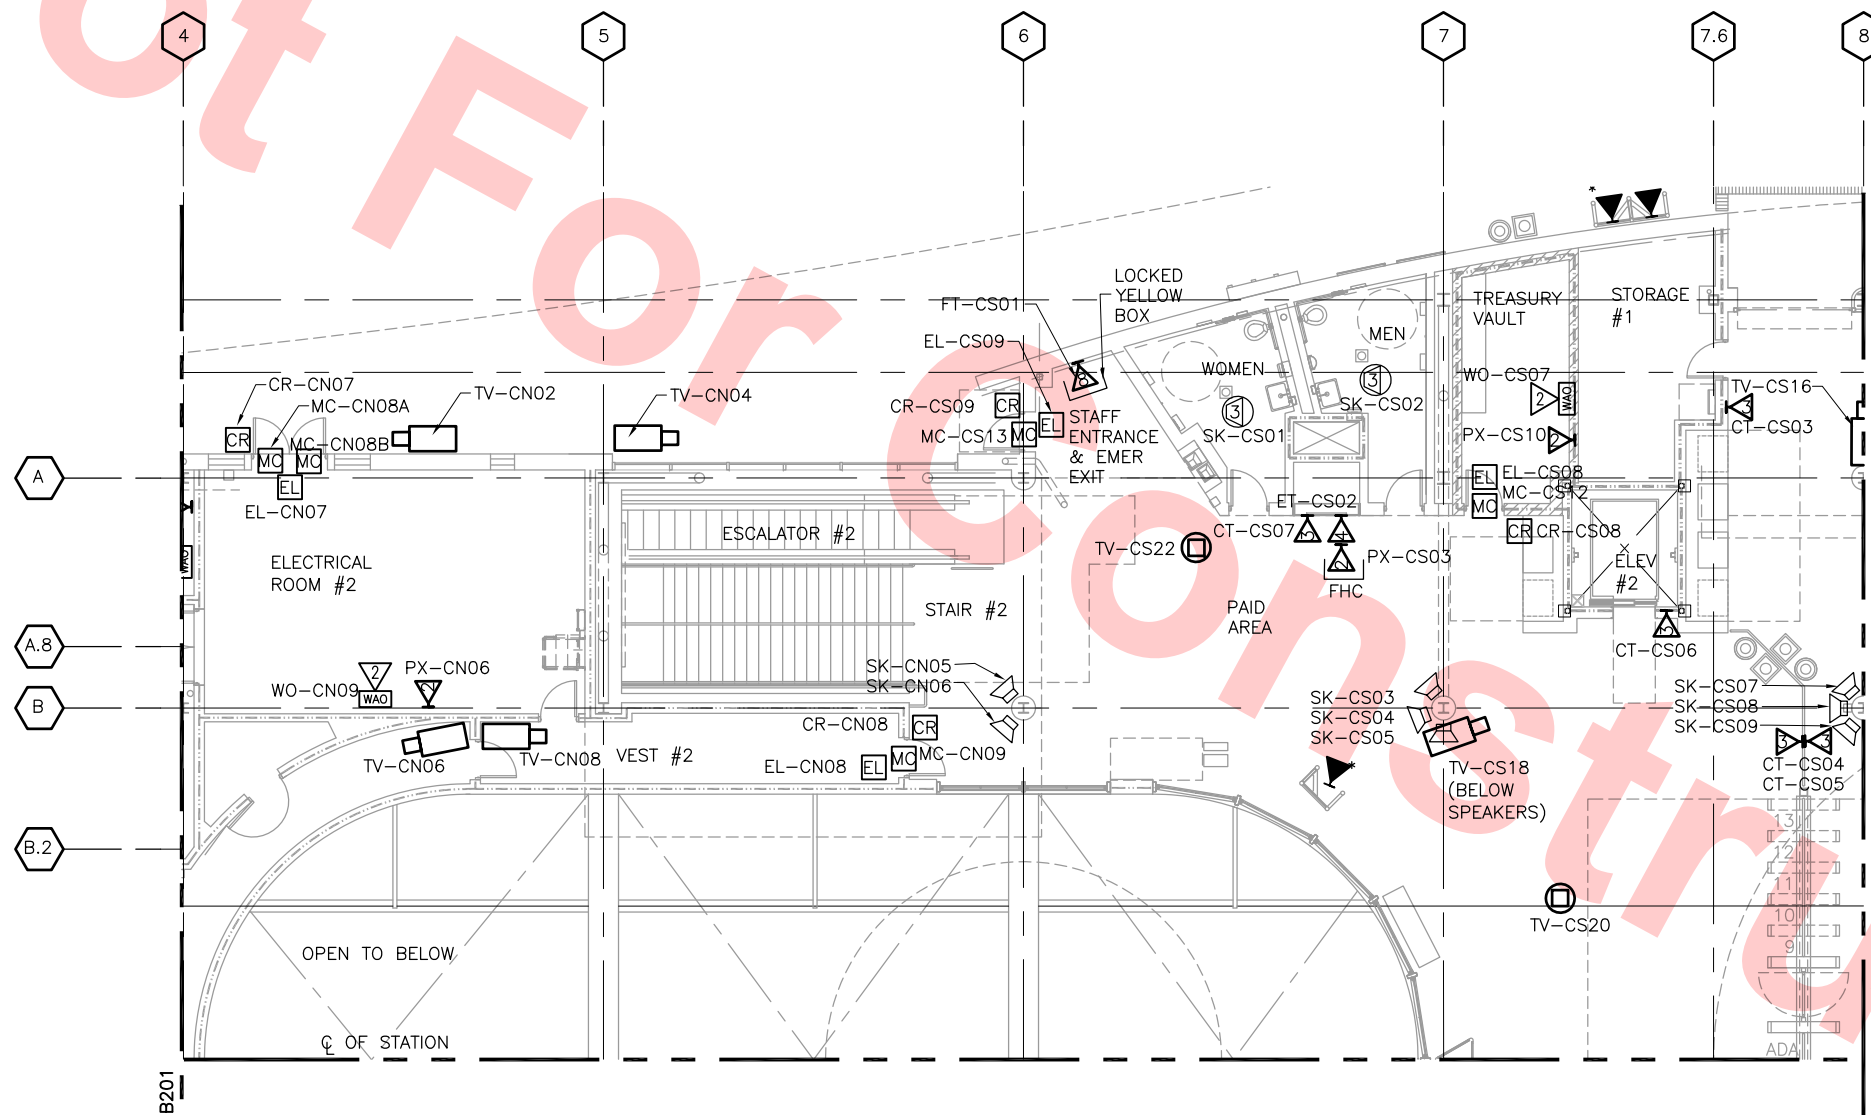

By: _____ **Date:** _____

GRAPHIC SCALE

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SIZE D	SCALE 1/8"=1'-0"	
CONTRACT NO. C700		REV.
AREA CODE DB	SHEET NO. B202	PAGE NO. 105

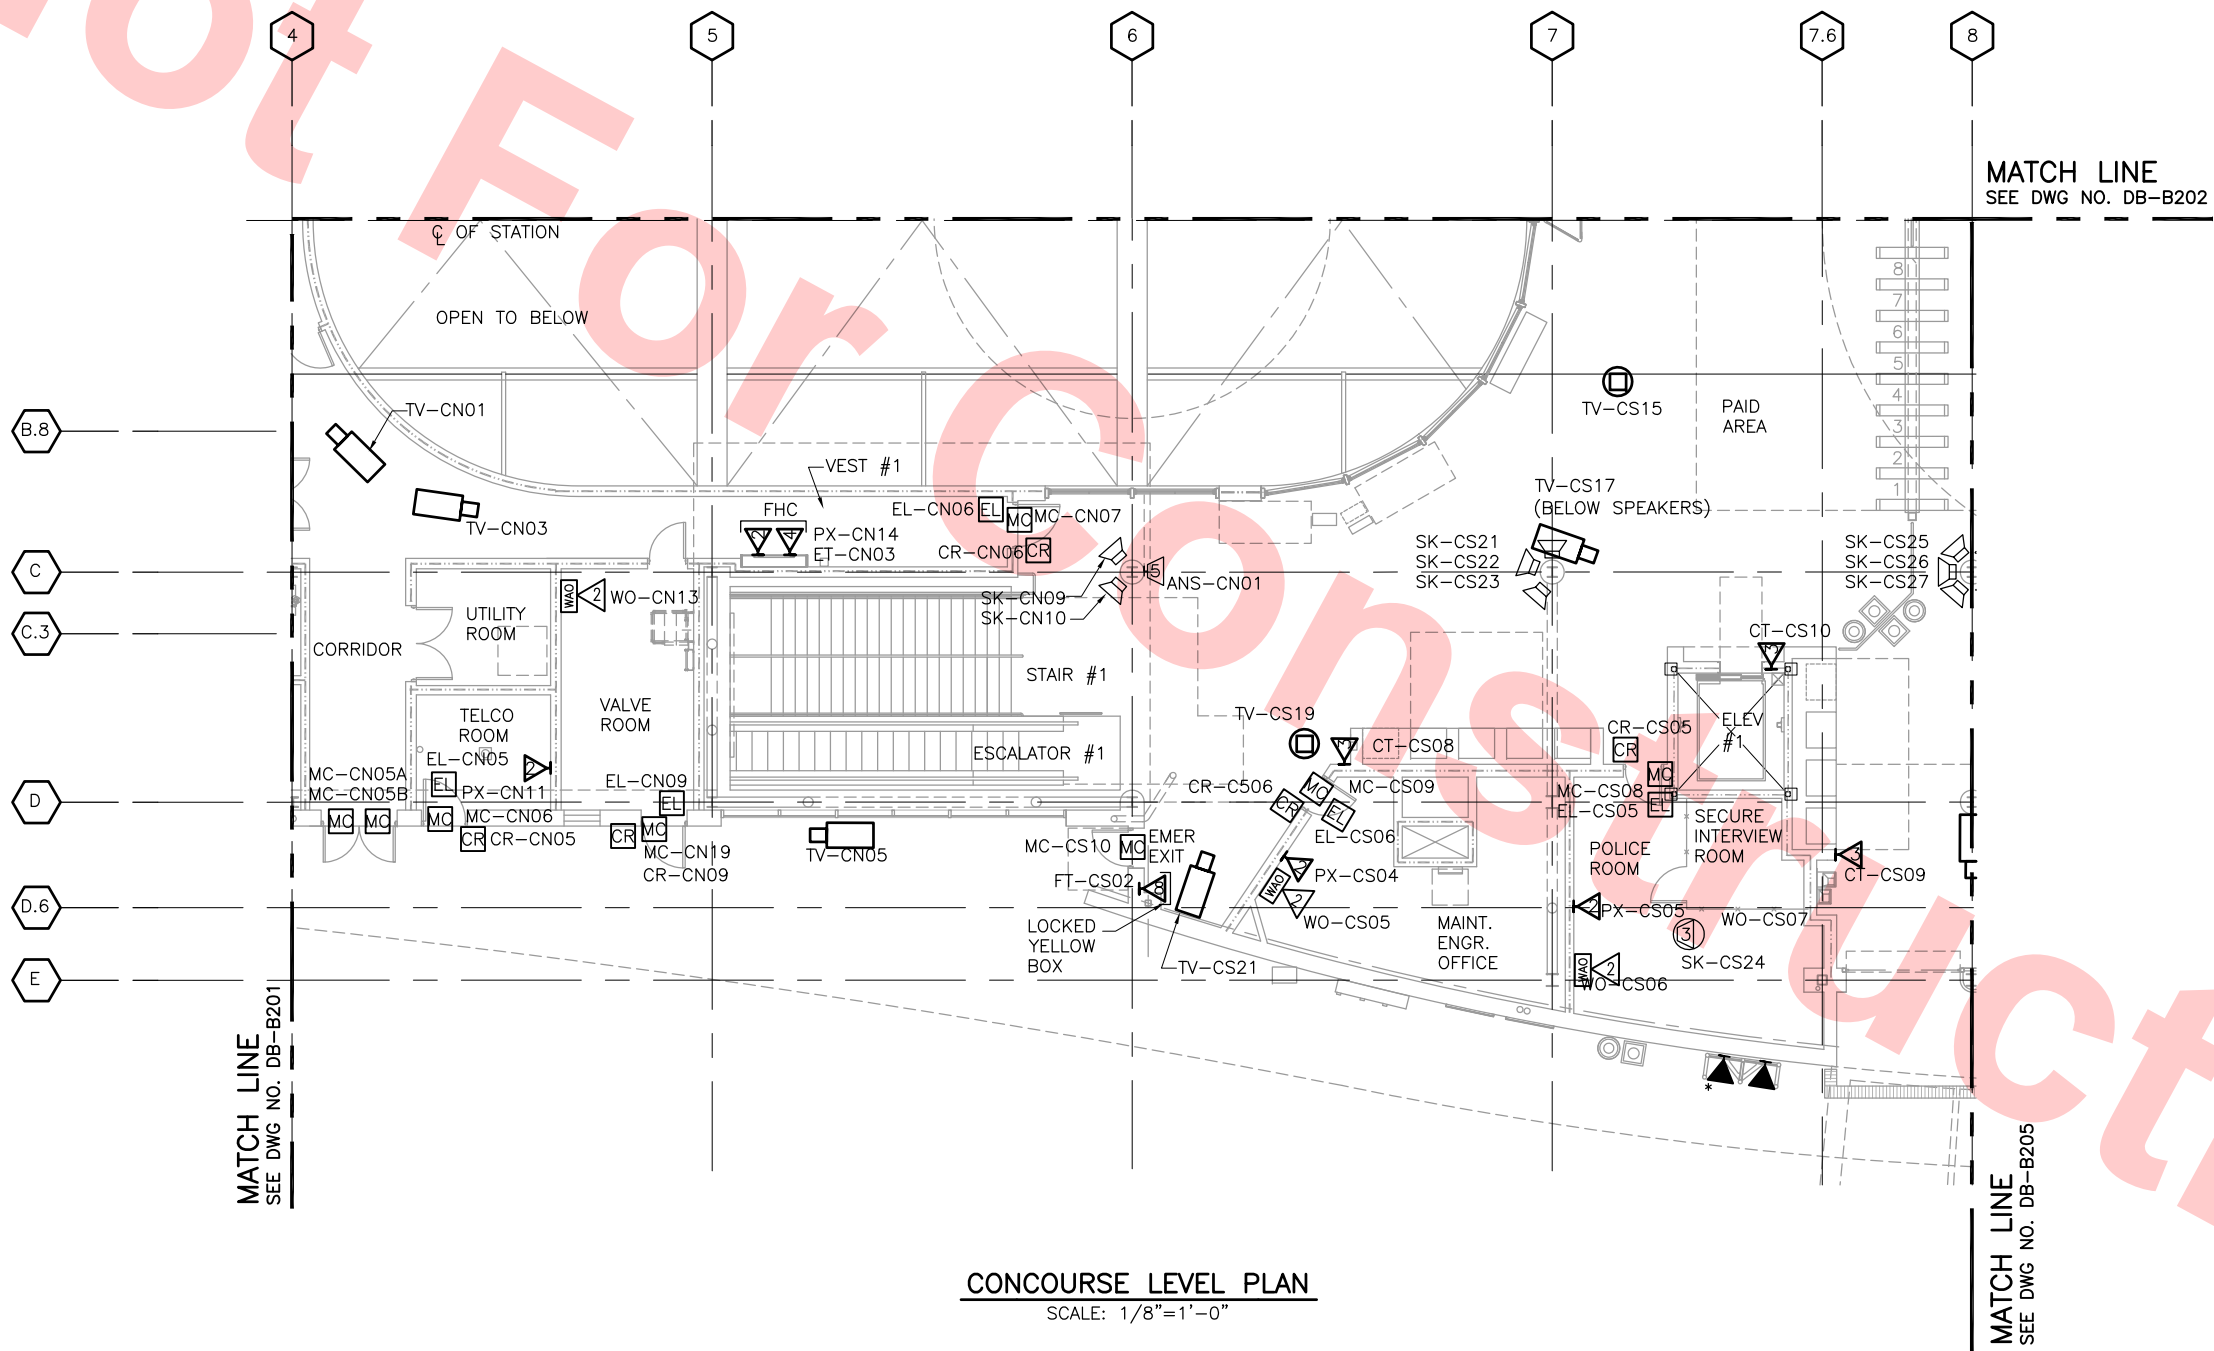

Santa Clara Valley Transportation Authority


NO EXCEPTIONS TAKEN (NET)
MAKE CORRECTIONS NOTED (MCN)
AMEND AND RESUBMIT (A/R)

Any action shown above is subject to the terms of the contract and does not relieve the Contractor of any of its obligations under the contract, including design and detailing.

Contract No.: DB11002F

By: _____ Date: _____

CONCOURSE LEVEL PLAN
SCALE: 1/8"=1'-0"

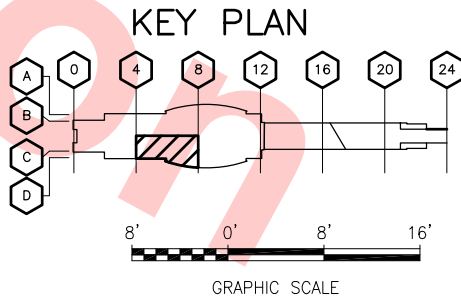

Jun 20, 2013 - 9:12am C:\projects\mbs\ashrode\lms\34735\700-S-DB-B203.DWG

REV	DATE	BY	SUB	APP	DESCRIPTION
0	20130710				READINESS FOR CONSTRUCTION

DESIGNED BY M. GOLUCKI	
DRAWN BY B. COOPER	
CHECKED BY B. MENDEZ LORA	
IN CHARGE B. MENDEZ LORA	
DATE 20130710	

Skanska
Shimmick
Herzog

1436 California Circle
Milpitas, California 95035
A Joint Venture

LTK
LTK Engineering Services

SUBMITTED *[Signature]*

**Lookwood, Andrews
& Newnam, Inc.**
A LEOP A BALLY COMPANY

T-Y LIN INTERNATIONAL


APPROVED *[Signature]*

BART
SILICON VALLEY

BART SILICON VALLEY BERRYESSA EXTENSION


LINE, TRACK, STATIONS AND SYSTEMS
DESIGN UNIT 023
MILPITAS STATION
COMMUNICATION EQUIPMENT LAYOUT
CONCOURSE LEVEL PLAN
SHEET 3 OF 6

CADD FILENAME C700-S-DB-B203.dwg	REV. 0
SIZE SCALE D 1/8"=1'-0"	
CONTRACT NO. C700	
AREA CODE DB	SHEET NO. B203
PAGE NO. 1051	

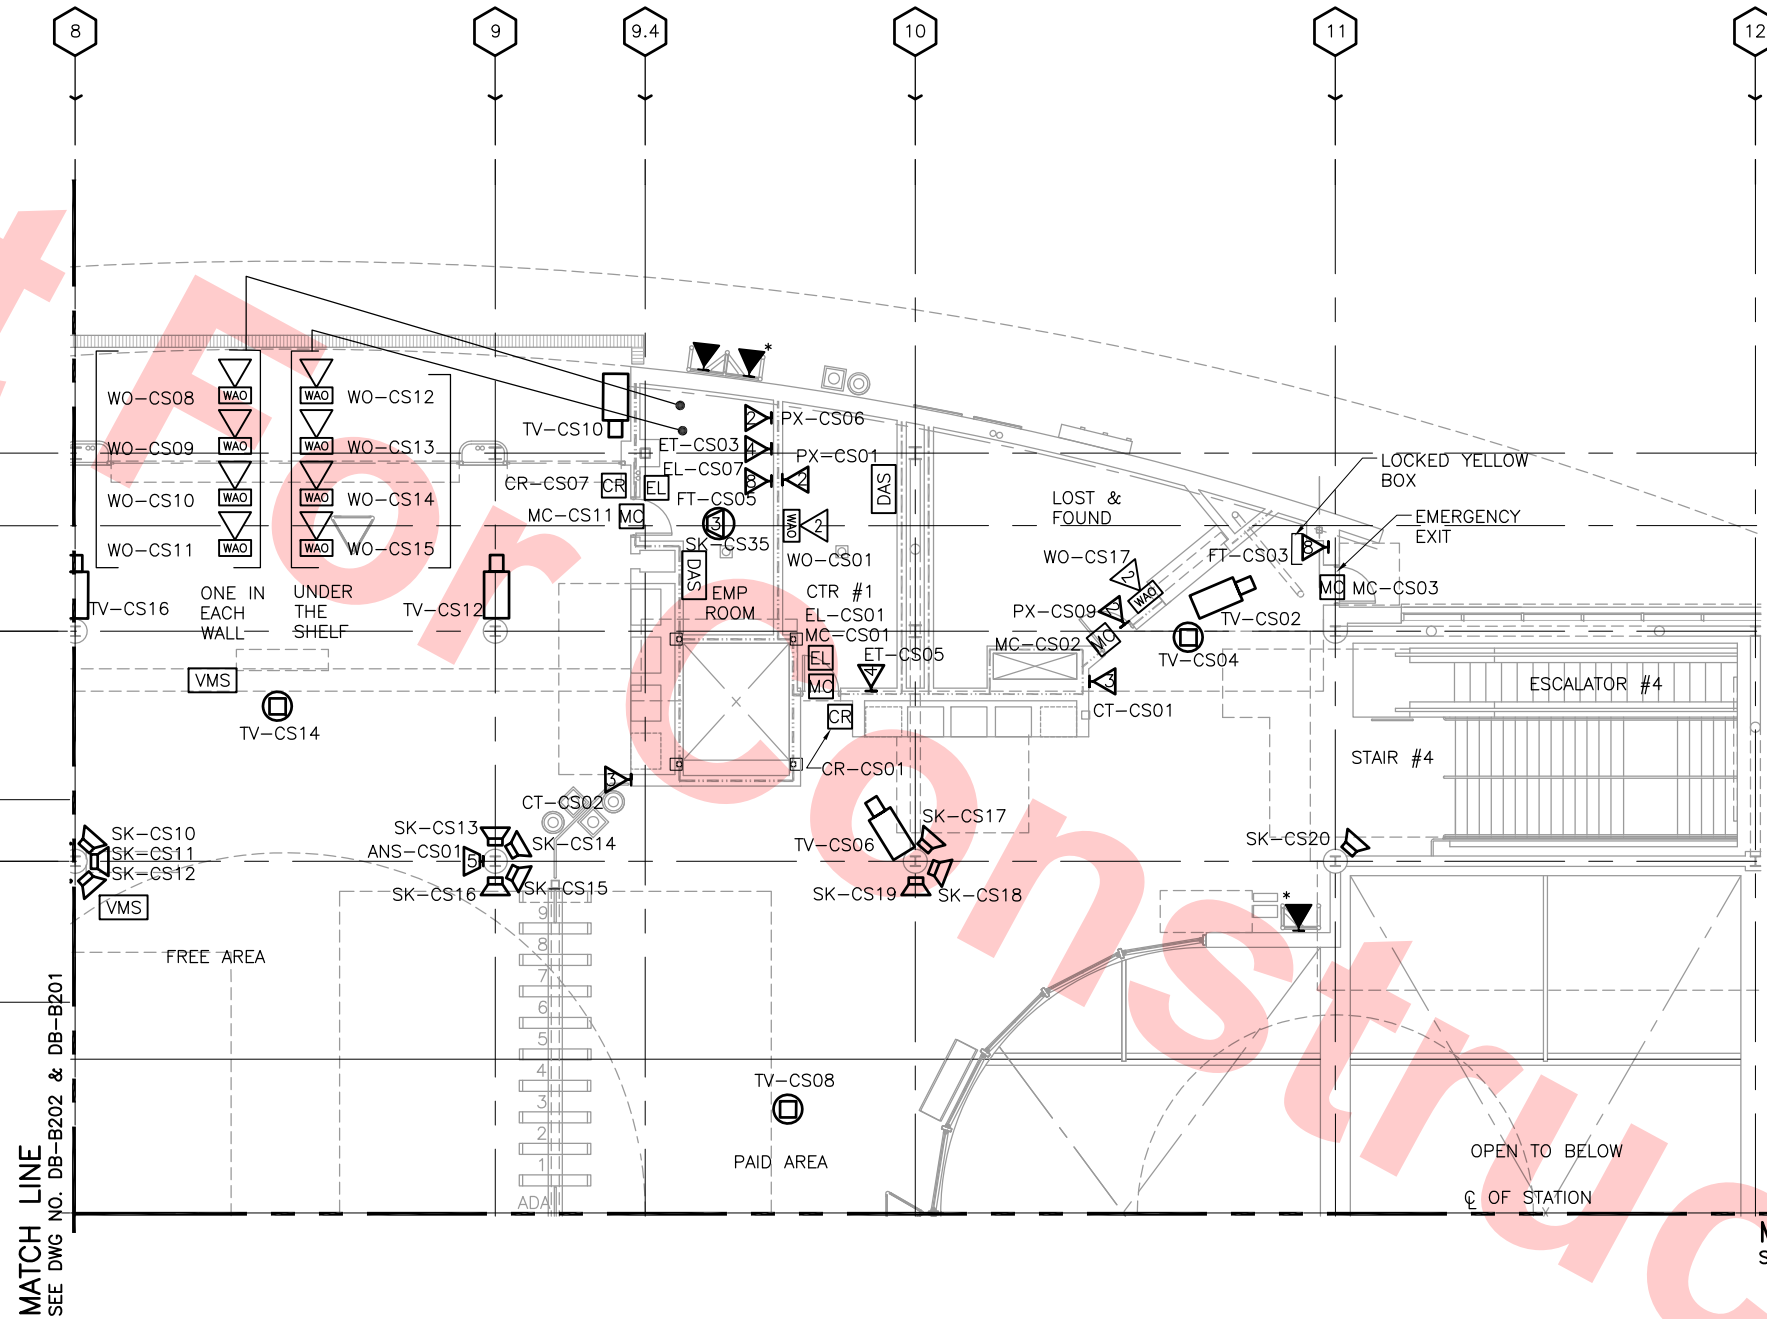


By: _____ **Date:** _____

SCALE: $1/8"=1'-0"$

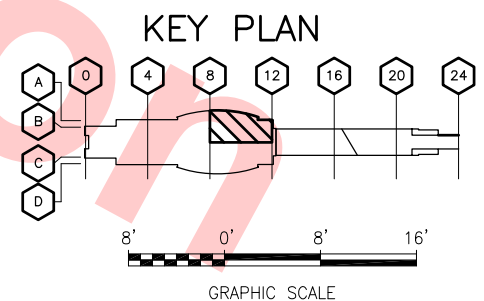

Jun 20, 2013 - 9:00am						DESIGNED BY M. GOLUCKI
						DRAWN BY B. COOPER
						CHECKED BY B. MENDEZ LORA
						IN CHARGE B. MENDEZ LORA
	0	20130710			READINESS FOR CONSTRUCTION	DATE 20130710
REV	DATE	BY	SUB	APP	DESCRIPTION	

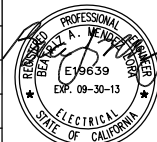

Skanska
Shimmick
Herzog

1436 California Circle
Milpitas, California 95035
A Joint Venture




T-Y-LIN INTERNATIONAL





BART SILICON VALLEY BERRYESSA EXTENSION



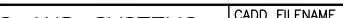
SHEET 4 OF 6



CADD FILENAME C700-S-DB-B204.dwg		
SIZE D	SCALE 1/8"=1'-0"	
CONTRACT NO. C700		REV. 0
AREA CODE DB	SHEET NO. B204	PAGE NO. 1052

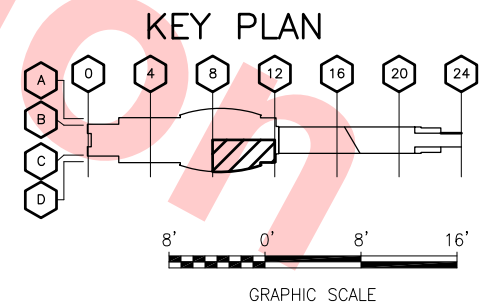

CONCOURSE LEVEL PLAN
SCALE: 1/8"=1'-0"

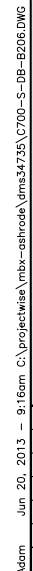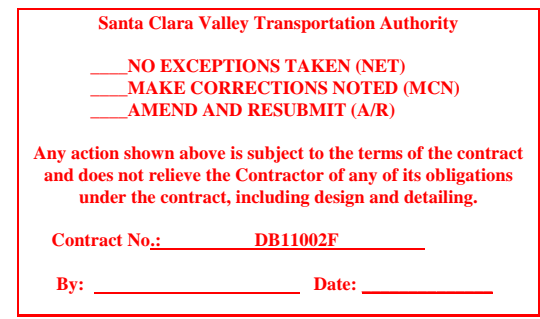

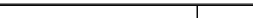Jun 20, 2013 Adam							DESIGNED BY M. GOLUCKI		Skanska Shimmick Herzog	1436 California Circle Milpitas, California 95035 A Joint Venture			LINE, TRACK, STATIONS AND SYSTEMS DESIGN UNIT 023 MILPITAS STATION COMMUNICATION EQUIPMENT LAYOUT CONCOURSE LEVEL PLAN SHEET 6 OF 6	CADD FILENAME C700-S-DB-B206.dwg			
						DRAWN BY B. COOPER	CHECKED BY B. MENDEZ LORA							SIZE D	SCALE 1/8"=1'-0"	CONTRACT NO. C700	REV. 0
	0	20130710				READINESS FOR CONSTRUCTION	IN CHARGE B. MENDEZ LORA							AREA CODE DB	SHEET NO. B206	PAGE NO. 1054	
	REV	DATE	BY	SUB	APP	DESCRIPTION	DATE										

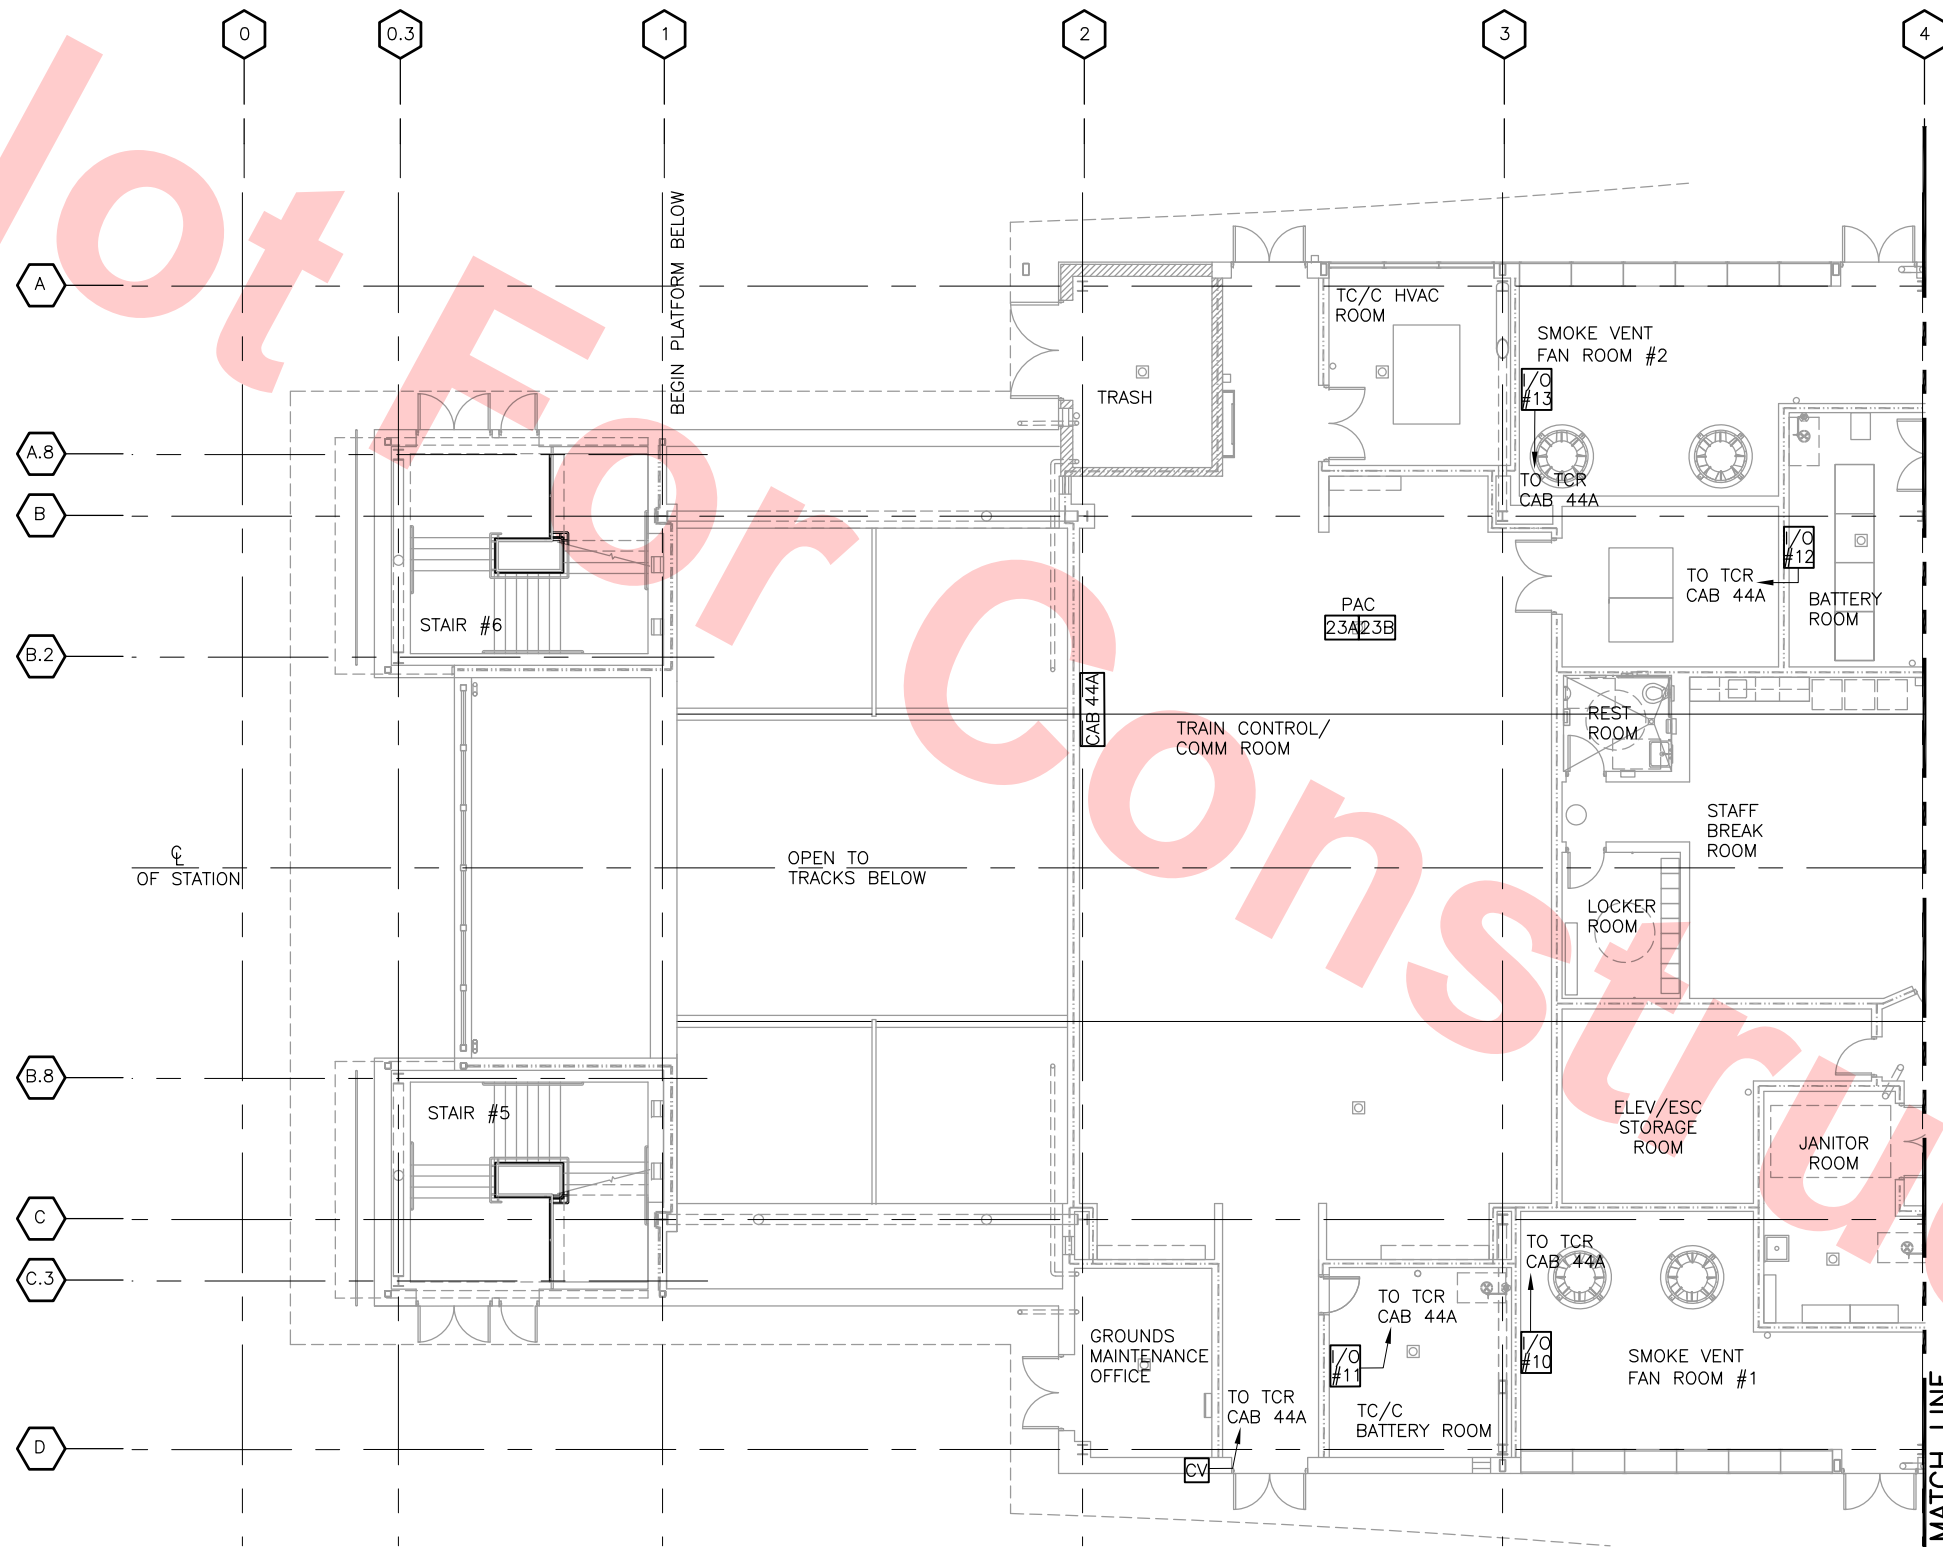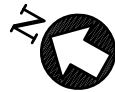

CONCOURSE LEVEL PLAN
SCALE: 1/8"=1'-0"

NOTES:

1. REFER TO SCADA POINT LIST FOR INDIVIDUAL MONITOR AND CONTROL INPUTS/OUTPUTS.
2. REFER TO CONDUIT AND CABLE SCHEDULES FOR CONDUIT AND CABLE REQUIREMENTS.

LEGEND:

- HIDDEN/BURIED CONDUIT
- EXPOSED CONDUIT
- CIC COMMUNICATIONS INTERFACE CABINET
- LCP LIGHTING CONTROL PANEL
- I/O INPUT/OUTPUT TERMINAL BOARD/CABINET
- FC FARE COLLECTION INTERFACE JUNCTION BOX
- SAB STATION AGENT BOOTH CONTROL PANEL
- CV CONTROL VALVE
- PTS PASSENGER TRIP STATION
- VCP VENTILATION CONTROL PANEL
- FACP FIRE ALARM CONTROL PANEL
- FCP FAN CONTROL PANEL
- DVC DELUGE VALVE CABINET

Santa Clara Valley Transportation Authority


- NO EXCEPTIONS TAKEN (NET)
- MAKE CORRECTIONS NOTED (MCN)
- AMEND AND RESUBMIT (A/R)

Any action shown above is subject to the terms of the contract and does not relieve the Contractor of any of its obligations under the contract, including design and detailing.

Contract No.: DB11002F

By: _____ Date: _____

KEY PLAN

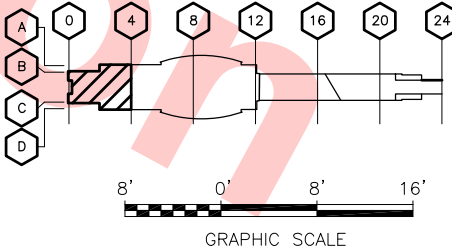

Jun 20, 2013 9:17am C:\projects\mbox-ashrode\lms34735\700-S-DB-B211.dwg

REV	DATE	BY	SUB	APP	DESCRIPTION
0	20130710				READINESS FOR CONSTRUCTION

DESIGNED BY M. GOLUCKI	
DRAWN BY B. COOPER	
CHECKED BY B. MENDEZ LORA	
IN CHARGE B. MENDEZ LORA	
DATE 20130710	

Skanska
Shimmick
Herzog

1436 California Circle
Milpitas, California 95035
A Joint Venture

LTK
LTK Engineering Services

SUBMITTED

**Lookwood, Andrews
& Newman, Inc.**
A LEO A DALY COMPANY

T-Y LIN INTERNATIONAL


APPROVED

BART
SILICON VALLEY

BART SILICON VALLEY BERRYESSA EXTENSION

LINE, TRACK, STATIONS AND SYSTEMS
DESIGN UNIT 023
MILPITAS STATION
SCADA INTEGRATION EQUIPMENT LAYOUT
CONCOURSE LEVEL PLAN
SHEET 1 OF 6

CADD FILENAME C700-S-DB-B211.dwg	REV. 0
SIZE SCALE D 1/8"=1'-0"	
CONTRACT NO. C700	
AREA CODE DB	SHEET NO. B211
	PAGE NO. 1055

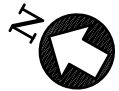

NOTES:

1. REFER TO SCADA POINT LIST FOR INDIVIDUAL MONITOR AND CONTROL INPUTS/OUTPUTS.
2. REFER TO CONDUIT AND CABLE SCHEDULES FOR CONDUIT AND CABLE REQUIREMENTS.

LEGEND:

	HIDDEN/BURIED CONDUIT
	EXPOSED CONDUIT
	COMMUNICATIONS INTERFACE CABINET
	LIGHTING CONTROL PANEL
	INPUT/OUTPUT TERMINAL BOARD/CABINET
	FARE COLLECTION INTERFACE JUNCTION BOX
	STATION AGENT BOOTH CONTROL PANEL
	CONTROL VALVE
	PASSENGER TRIP STATION
	VENTILATION CONTROL PANEL
	FIRE ALARM CONTROL PANEL
	FAN CONTROL PANEL
	DELUGE VALVE CABINET
	STATION AGENT TERMINAL


Santa Clara Valley Transportation Authority

- NO EXCEPTIONS TAKEN (NET)
- MAKE CORRECTIONS NOTED (MCN)
- AMEND AND RESUBMIT (A/R)

Any action shown above is subject to the terms of the contract and does not relieve the Contractor of any of its obligations under the contract, including design and detailing.

Contract No.: DB11002F

By: _____ Date: _____

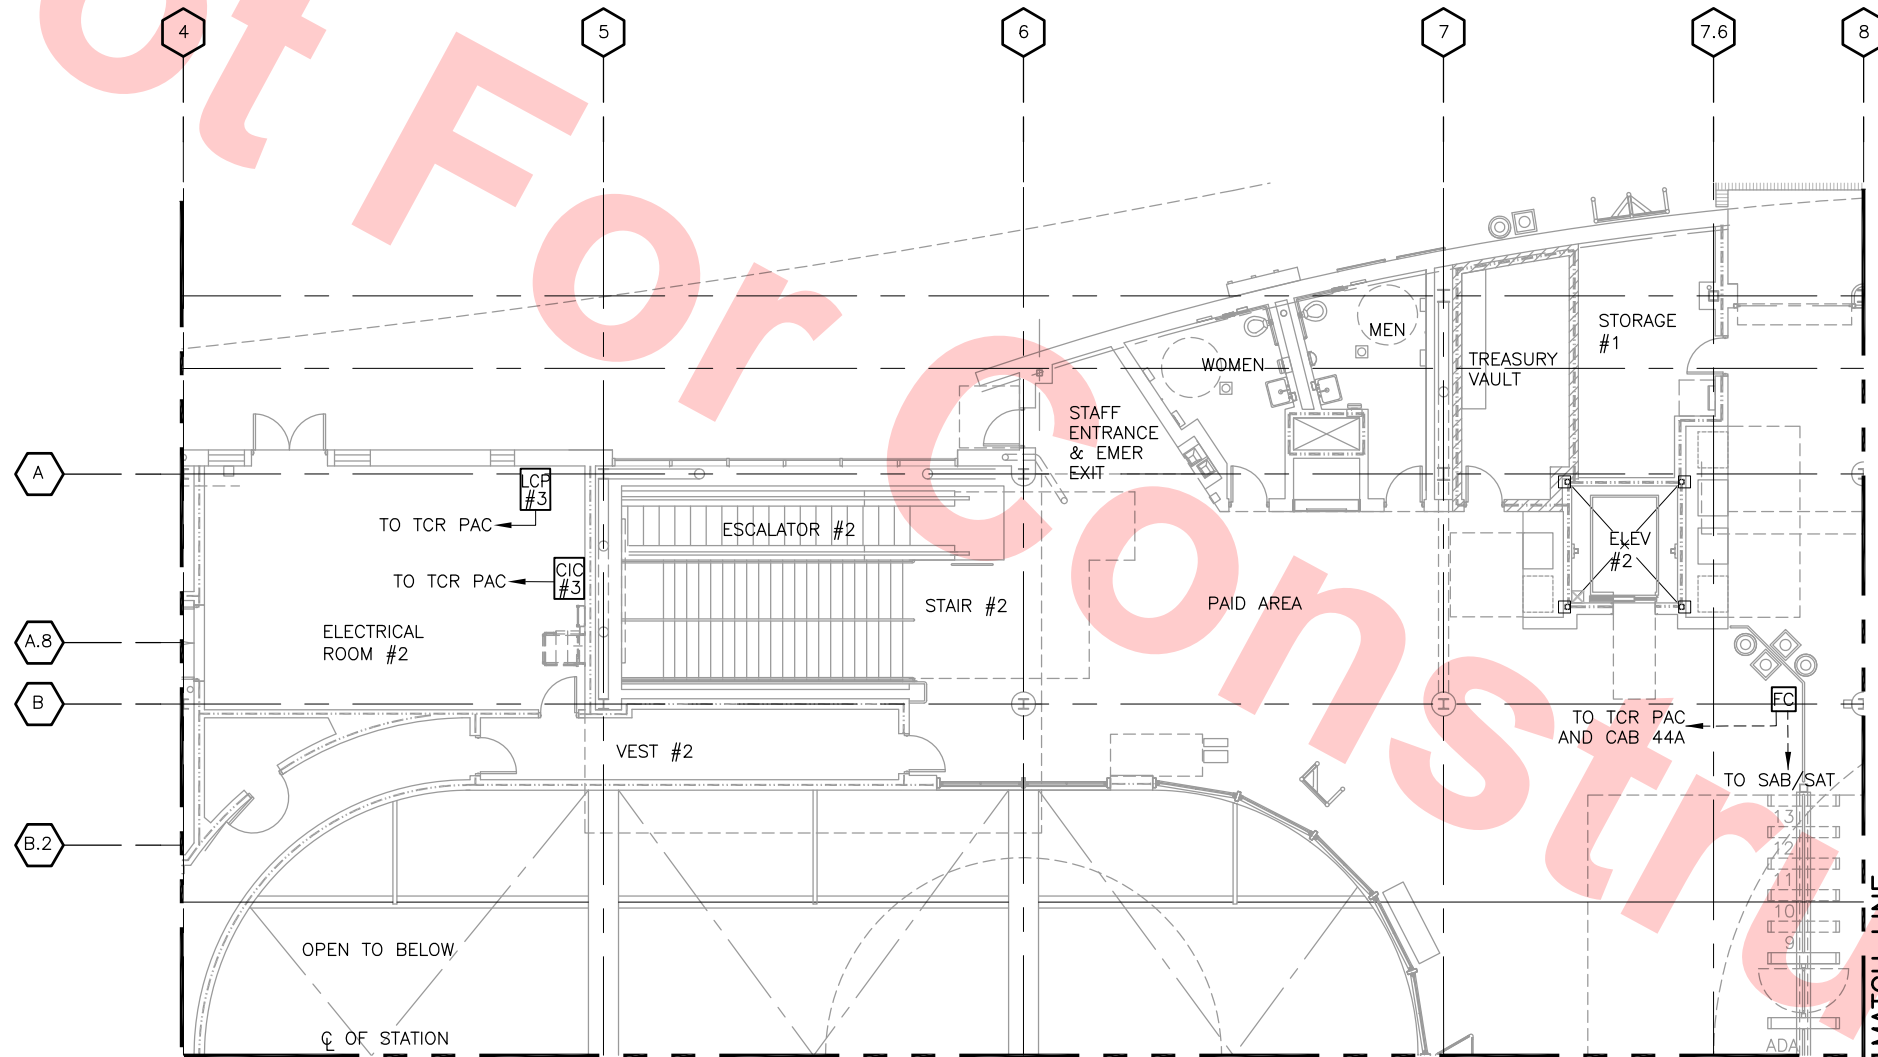


MATCH LINE
SEE DWG NO. DB-B211

MATCH LINE
SEE DWG NO. DB-B214

MATCH LINE
SEE DWG NO. DB-B213

CONCOURSE LEVEL PLAN
SCALE: 1/8"=1'-0"



KEY PLAN

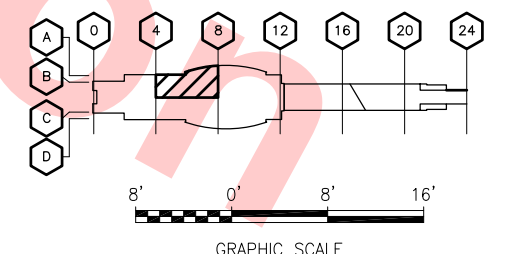

Jun 20, 2013

1

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CONCOURSE LEVEL PLAN
SCALE: 1/8"=1'-0"

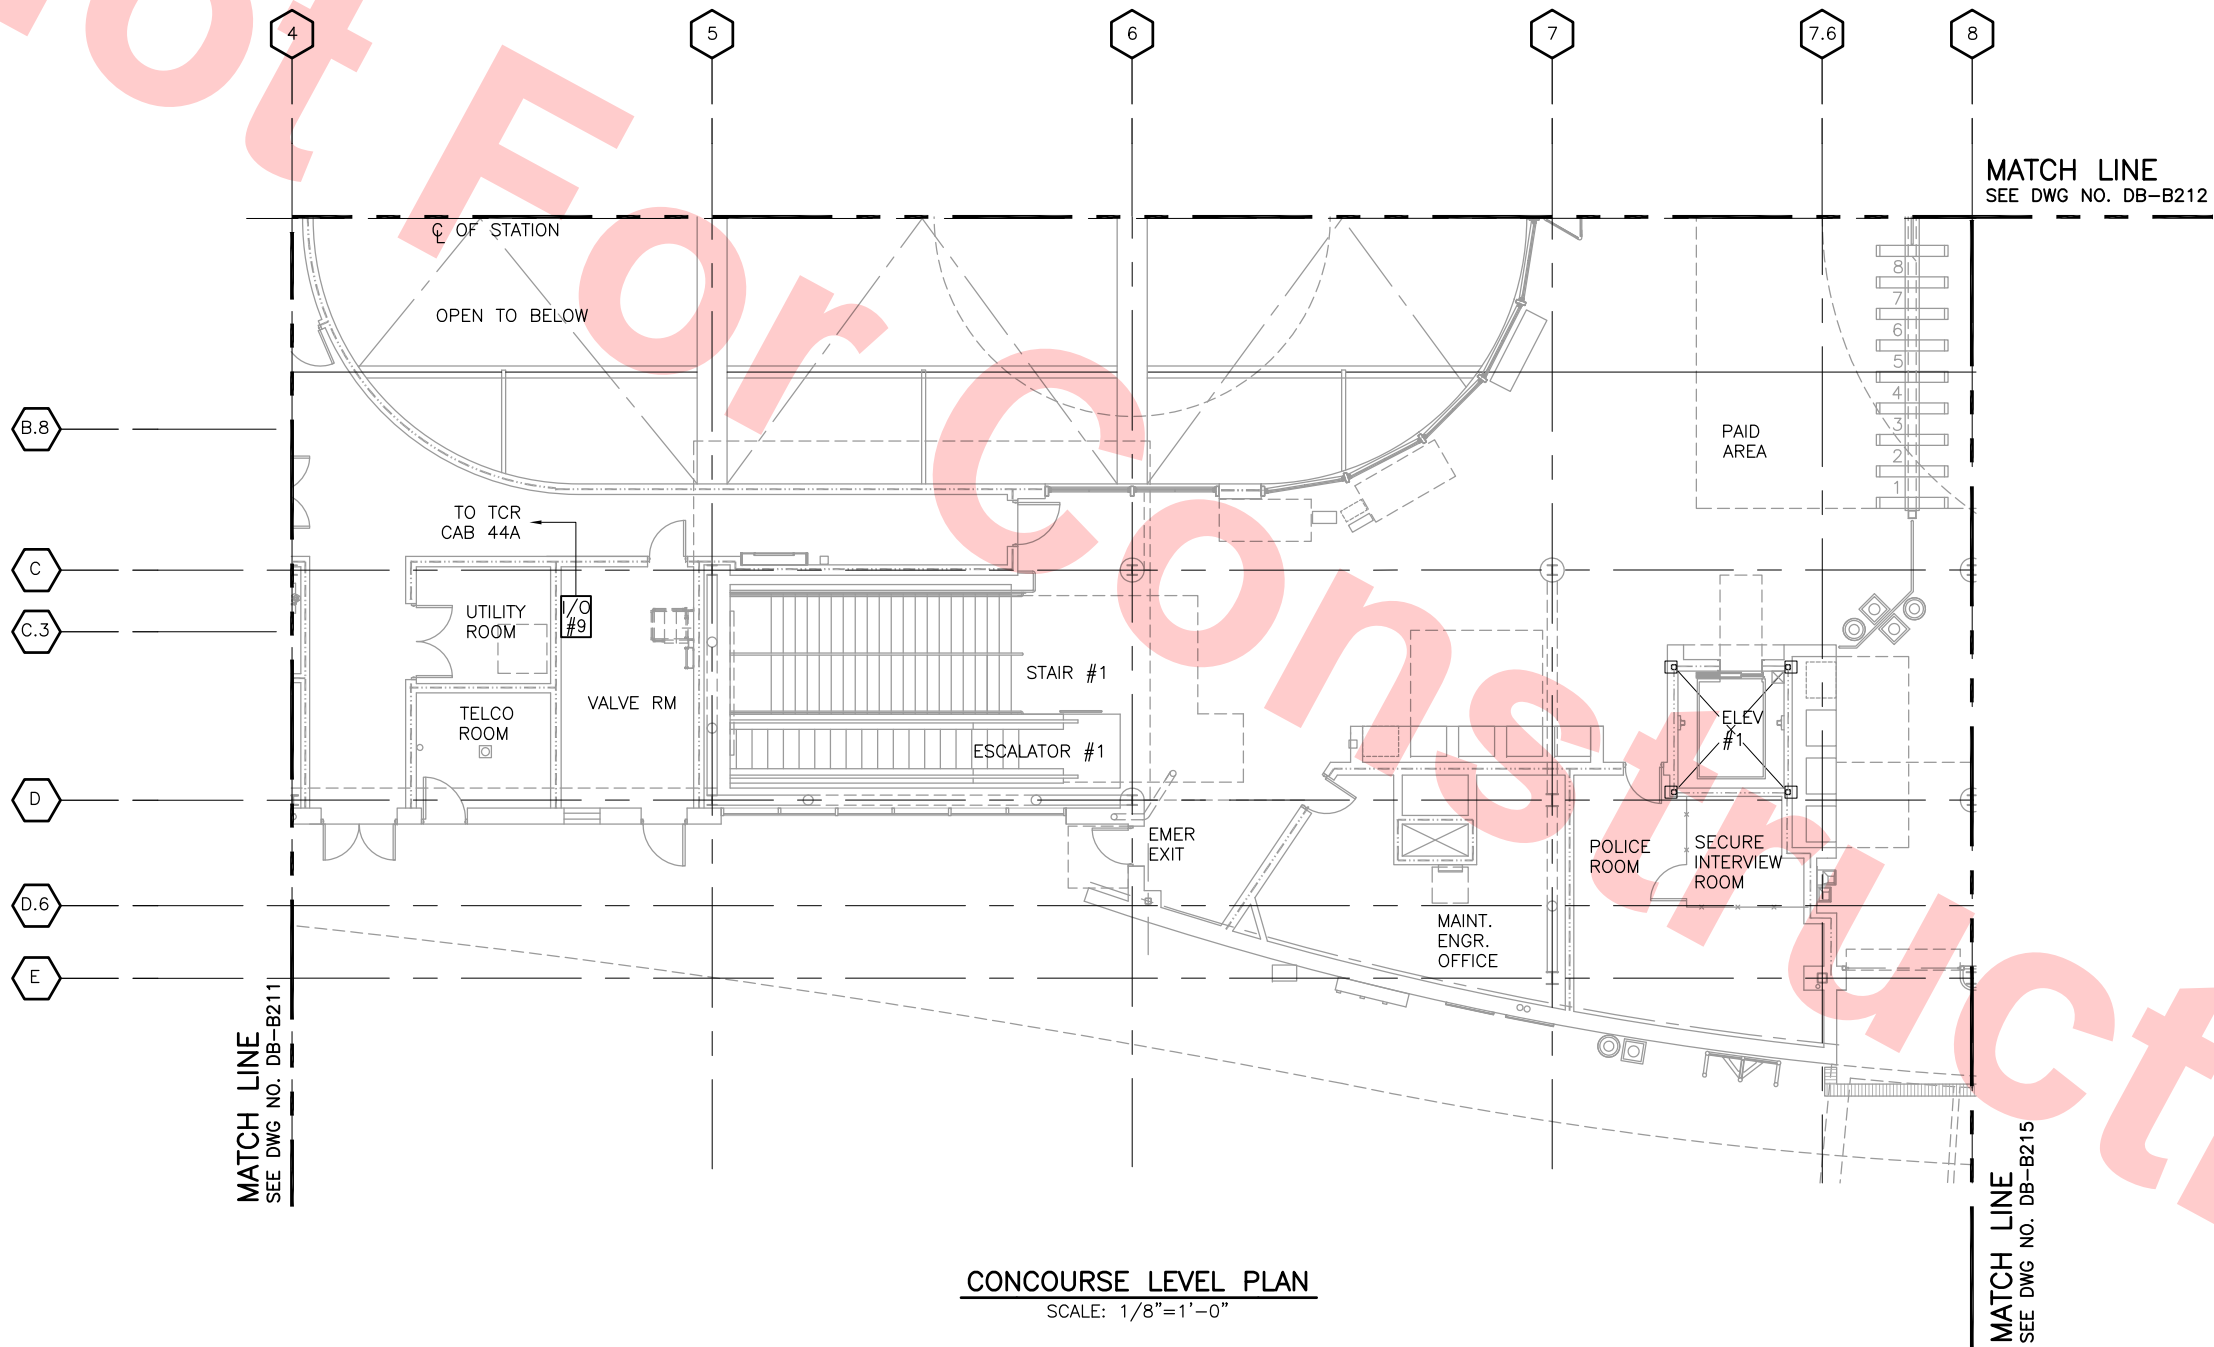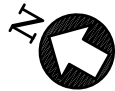
Santa Clara Valley Transportation Authority

NO EXCEPTIONS TAKEN (NET)
MAKE CORRECTIONS NOTED (MCN)
AMEND AND RESUBMIT (A/R)

Any action shown above is subject to the terms of the contract and does not relieve the Contractor of any of its obligations under the contract, including design and detailing.


Contract No.: DB11002F

By: _____ Date: _____

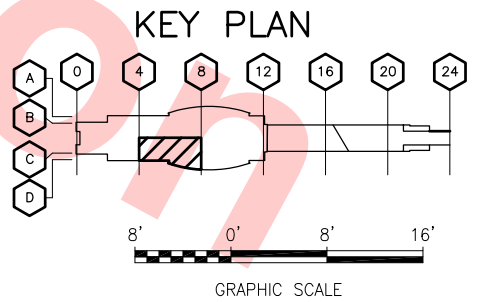

Jun 20, 2013 9:20am C:\projects\mbs-ashrode\lms34735\700-S-DB-B213.dwg

REV	DATE	BY	SUB	APP	DESCRIPTION
0	20130710				READINESS FOR CONSTRUCTION

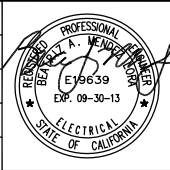

DESIGNED BY
M. GOLUCKI
DRAWN BY
B. COOPER
CHECKED BY
B. MENDEZ LORA
IN CHARGE
B. MENDEZ LORA
DATE
20130710

Skanska
Shimmick
Herzog

1436 California Circle
Milpitas, California 95035
A Joint Venture


LTK Engineering Services
SUBMITTED

Lookwood, Andrews
& Newnam, Inc.
A LEO A DALY COMPANY
T-Y LIN INTERNATIONAL
APPROVED



LINE, TRACK, STATIONS AND SYSTEMS
DESIGN UNIT 023
MILPITAS STATION
SCADA INTEGRATION EQUIPMENT LAYOUT
CONCOURSE LEVEL PLAN
SHEET 3 OF 6

CADD FILENAME C700-S-DB-B213.dwg	REV. 0
SIZE D	SCALE 1/8"=1'-0"
CONTRACT NO. C700	PAGE NO. 1057
AREA CODE DB	SHEET NO. B213

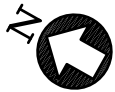

NOTES:

1. REFER TO SCADA POINT LIST FOR INDIVIDUAL MONITOR AND CONTROL INPUTS/OUTPUTS.
2. REFER TO CONDUIT AND CABLE SCHEDULES FOR CONDUIT AND CABLE REQUIREMENTS.

LEGEND:

- HIDDEN/BURIED CONDUIT
- EXPOSED CONDUIT
- [CIC] COMMUNICATIONS INTERFACE CABINET
- [LCP] LIGHTING CONTROL PANEL
- [I/O] INPUT/OUTPUT TERMINAL BOARD/CABINET
- [FC] FARE COLLECTION INTERFACE JUNCTION BOX
- [SAB] STATION AGENT BOOTH CONTROL PANEL
- [CV] CONTROL VALVE
- [PTS] PASSENGER TRIP STATION
- [VCP] VENTILATION CONTROL PANEL
- [FACP] FIRE ALARM CONTROL PANEL
- [FCP] FAN CONTROL PANEL
- [DVC] DELUGE VALVE CABINET
- [SAT] STATION AGENT TERMINAL

Santa Clara Valley Transportation Authority

- ___ NO EXCEPTIONS TAKEN (NET)
- ___ MAKE CORRECTIONS NOTED (MCN)
- ___ AMEND AND RESUBMIT (A/R)

Any action shown above is subject to the terms of the contract and does not relieve the Contractor of any of its obligations under the contract, including design and detailing.

Contract No.: DB11002F

By: _____ Date: _____


MATCH LINE
SEE DWG NO. DB-B212 & DB-B211

MATCH LINE
SEE DWG NO. DB-B215

CONCOURSE LEVEL PLAN

SCALE: 1/8"=1'-0"

KEY PLAN

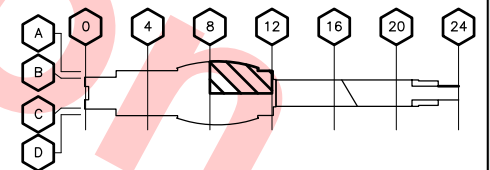


GRAPHIC SCALE

Jun 20, 2013 9:21am C:\projects\mbox-ashrode\lms34735\700-S-DB-B214.dwg

REV	DATE	BY	SUB	APP	DESCRIPTION
0	20130710				READINESS FOR CONSTRUCTION

DESIGNED BY
M. GOLUCKI
DRAWN BY
B. COOPER
CHECKED BY
B. MENDEZ LORA
IN CHARGE
B. MENDEZ LORA
DATE
20130710

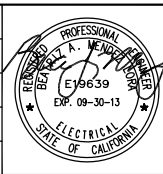


Skanska
Shimmick
Herzog
LTK
LTK Engineering Services
SUBMITTED

1436 California Circle
Milpitas, California 95035
A Joint Venture
**Lookwood, Andrews
& Newnam, Inc.**
T-Y LIN INTERNATIONAL
APPROVED

BART
SILICON VALLEY
BART SILICON VALLEY BERRYESSA EXTENSION

LINE, TRACK, STATIONS AND SYSTEMS
DESIGN UNIT 023
MILPITAS STATION
SCADA INTEGRATION EQUIPMENT LAYOUT
CONCOURSE LEVEL PLAN
SHEET 4 OF 6

CADD FILENAME C700-S-DB-B214.dwg	REV. 0
SIZE SCALE D 1/8"=1'-0"	
CONTRACT NO. C700	
AREA CODE DB	SHEET NO. B214
	PAGE NO. 1058

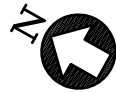

NOTES:

1. REFER TO SCADA POINT LIST FOR INDIVIDUAL MONITOR AND CONTROL INPUTS/OUTPUTS.
2. REFER TO CONDUIT AND CABLE SCHEDULES FOR CONDUIT AND CABLE REQUIREMENTS.

LEGEND:

	HIDDEN/BURIED CONDUIT
	EXPOSED CONDUIT
	COMMUNICATIONS INTERFACE CABINET
	LIGHTING CONTROL PANEL
	INPUT/OUTPUT TERMINAL BOARD/CABINET
	FARE COLLECTION INTERFACE JUNCTION BOX
	STATION AGENT BOOTH CONTROL PANEL
	CONTROL VALVE
	PASSENGER TRIP STATION
	VENTILATION CONTROL PANEL
	FIRE ALARM CONTROL PANEL
	FAN CONTROL PANEL
	DELUGE VALVE CABINET
	STATION AGENT TERMINAL


Santa Clara Valley Transportation Authority

- NO EXCEPTIONS TAKEN (NET)
- MAKE CORRECTIONS NOTED (MCN)
- AMEND AND RESUBMIT (A/R)


Any action shown above is subject to the terms of the contract and does not relieve the Contractor of any of its obligations under the contract, including design and detailing.

Contract No.: DB11002F

By: _____ Date: _____

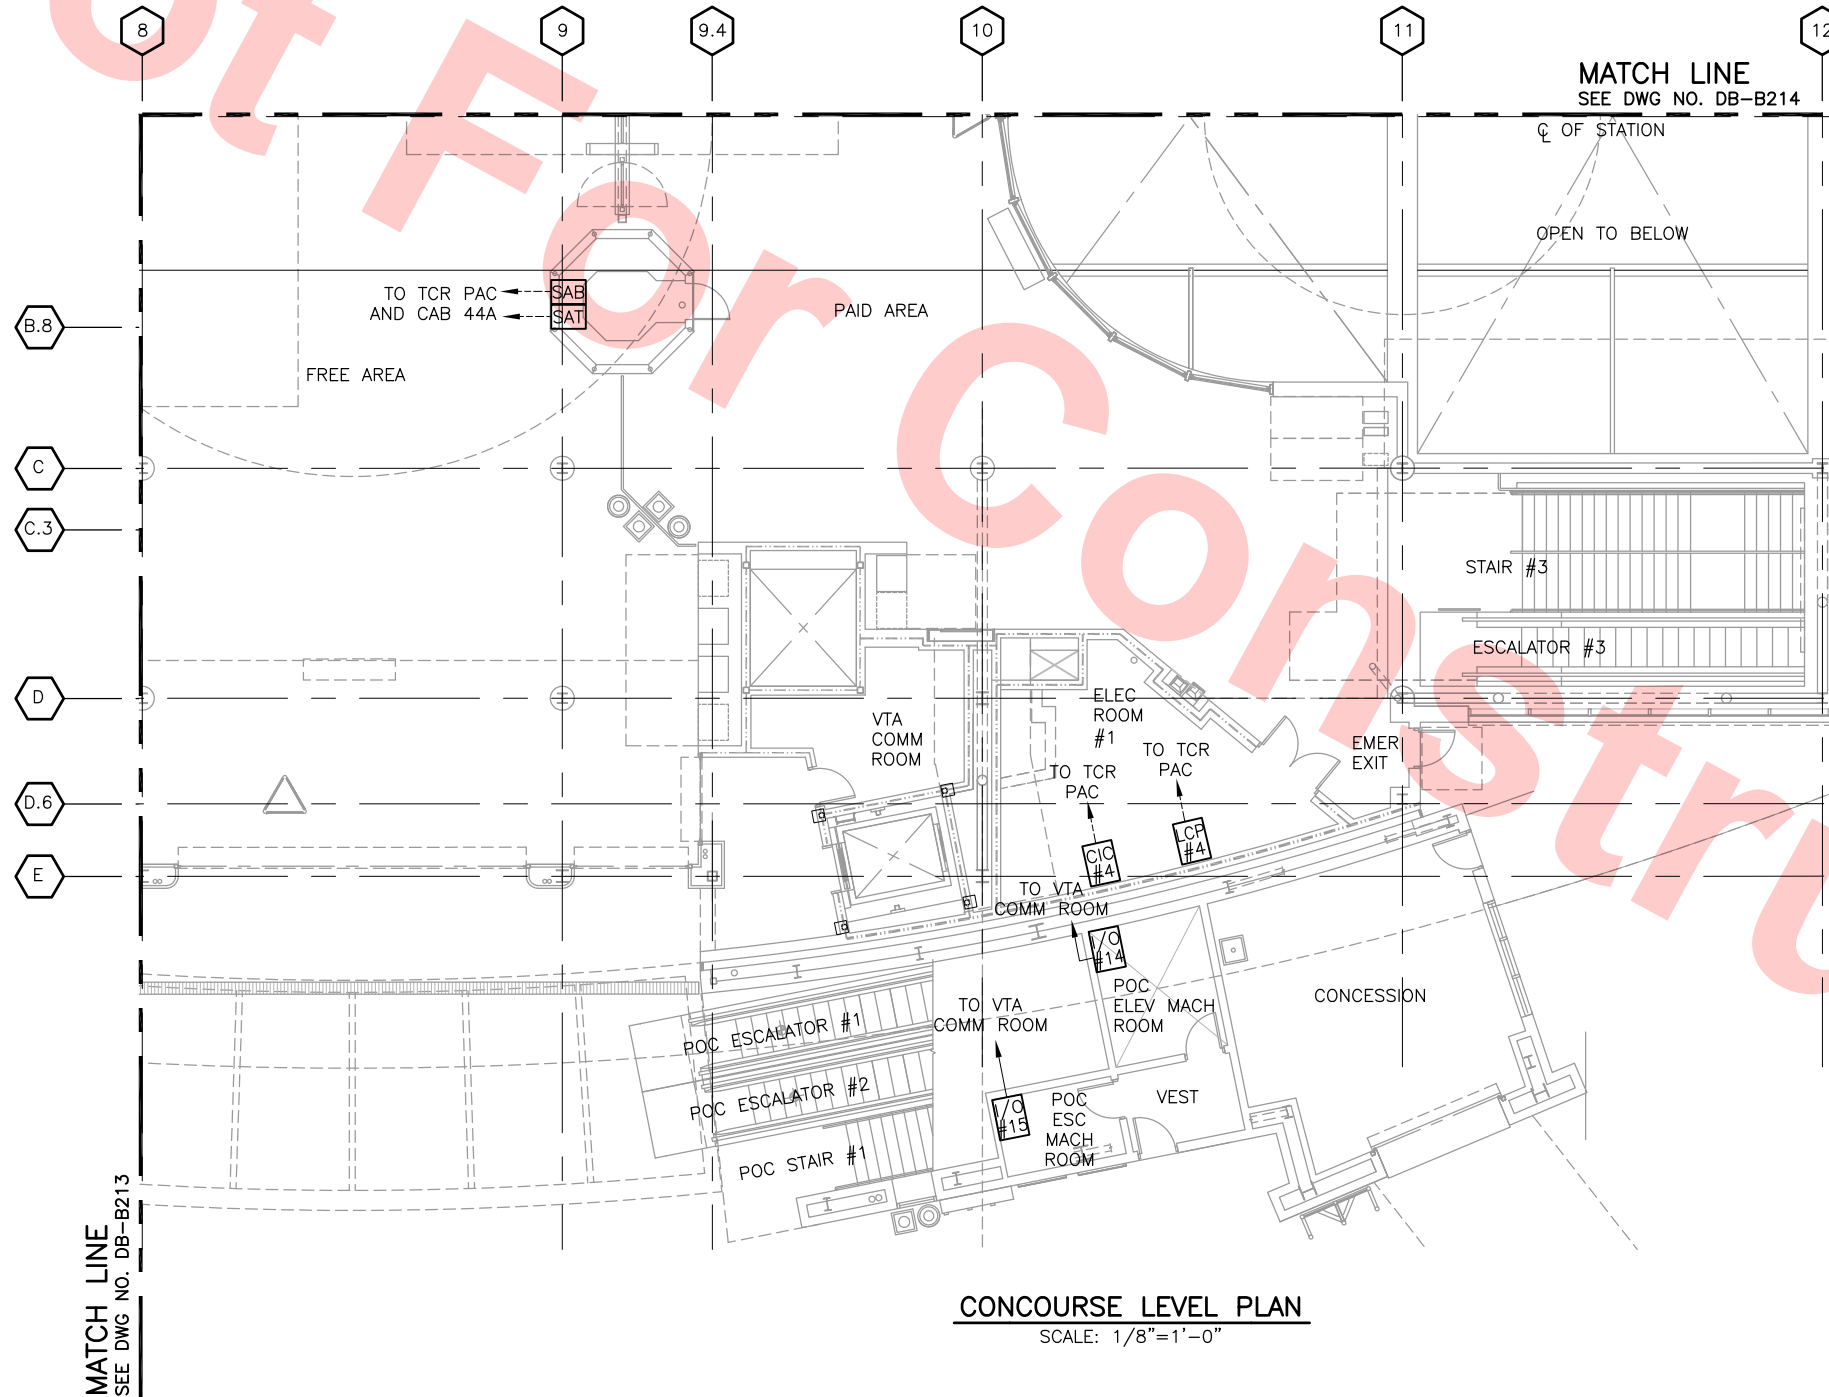


CONCOURSE LEVEL PLAN
SCALE: 1/8"=1'-0"

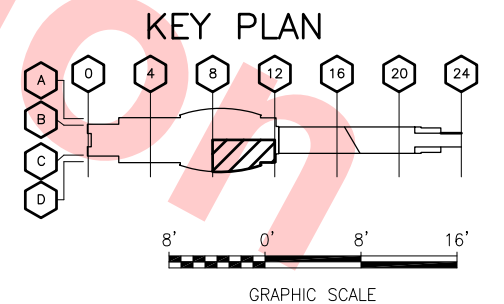

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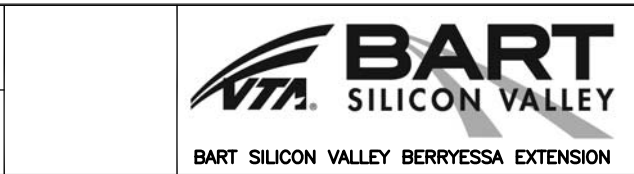
REV	DATE	BY	SUB	APP	DESCRIPTION
0	20130710				READINESS FOR CONSTRUCTION

DESIGNED BY
M. GOLUCKI
DRAWN BY
B. COOPER
CHECKED BY
B. MENDEZ LORA
IN CHARGE
B. MENDEZ LORA
DATE
20130710

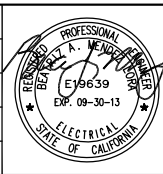


Skanska
Shimmick
Herzog
LTK
LTK Engineering Services
SUBMITTED

1436 California Circle
Milpitas, California 95035
A Joint Venture
Lookwood, Andrews & Newnam, Inc.
T-Y-LIN INTERNATIONAL
APPROVED




LINE, TRACK, STATIONS AND SYSTEMS
DESIGN UNIT 023
MILPITAS STATION
SCADA INTEGRATION EQUIPMENT LAYOUT
CONCOURSE LEVEL PLAN
SHEET 5 OF 6

CADD FILENAME C700-S-DB-B215.dwg	REV. 0
SIZE SCALE D 1/8"=1'-0"	CONTRACT NO. C700
AREA CODE DB	SHEET NO. B215
PAGE NO. 1059	

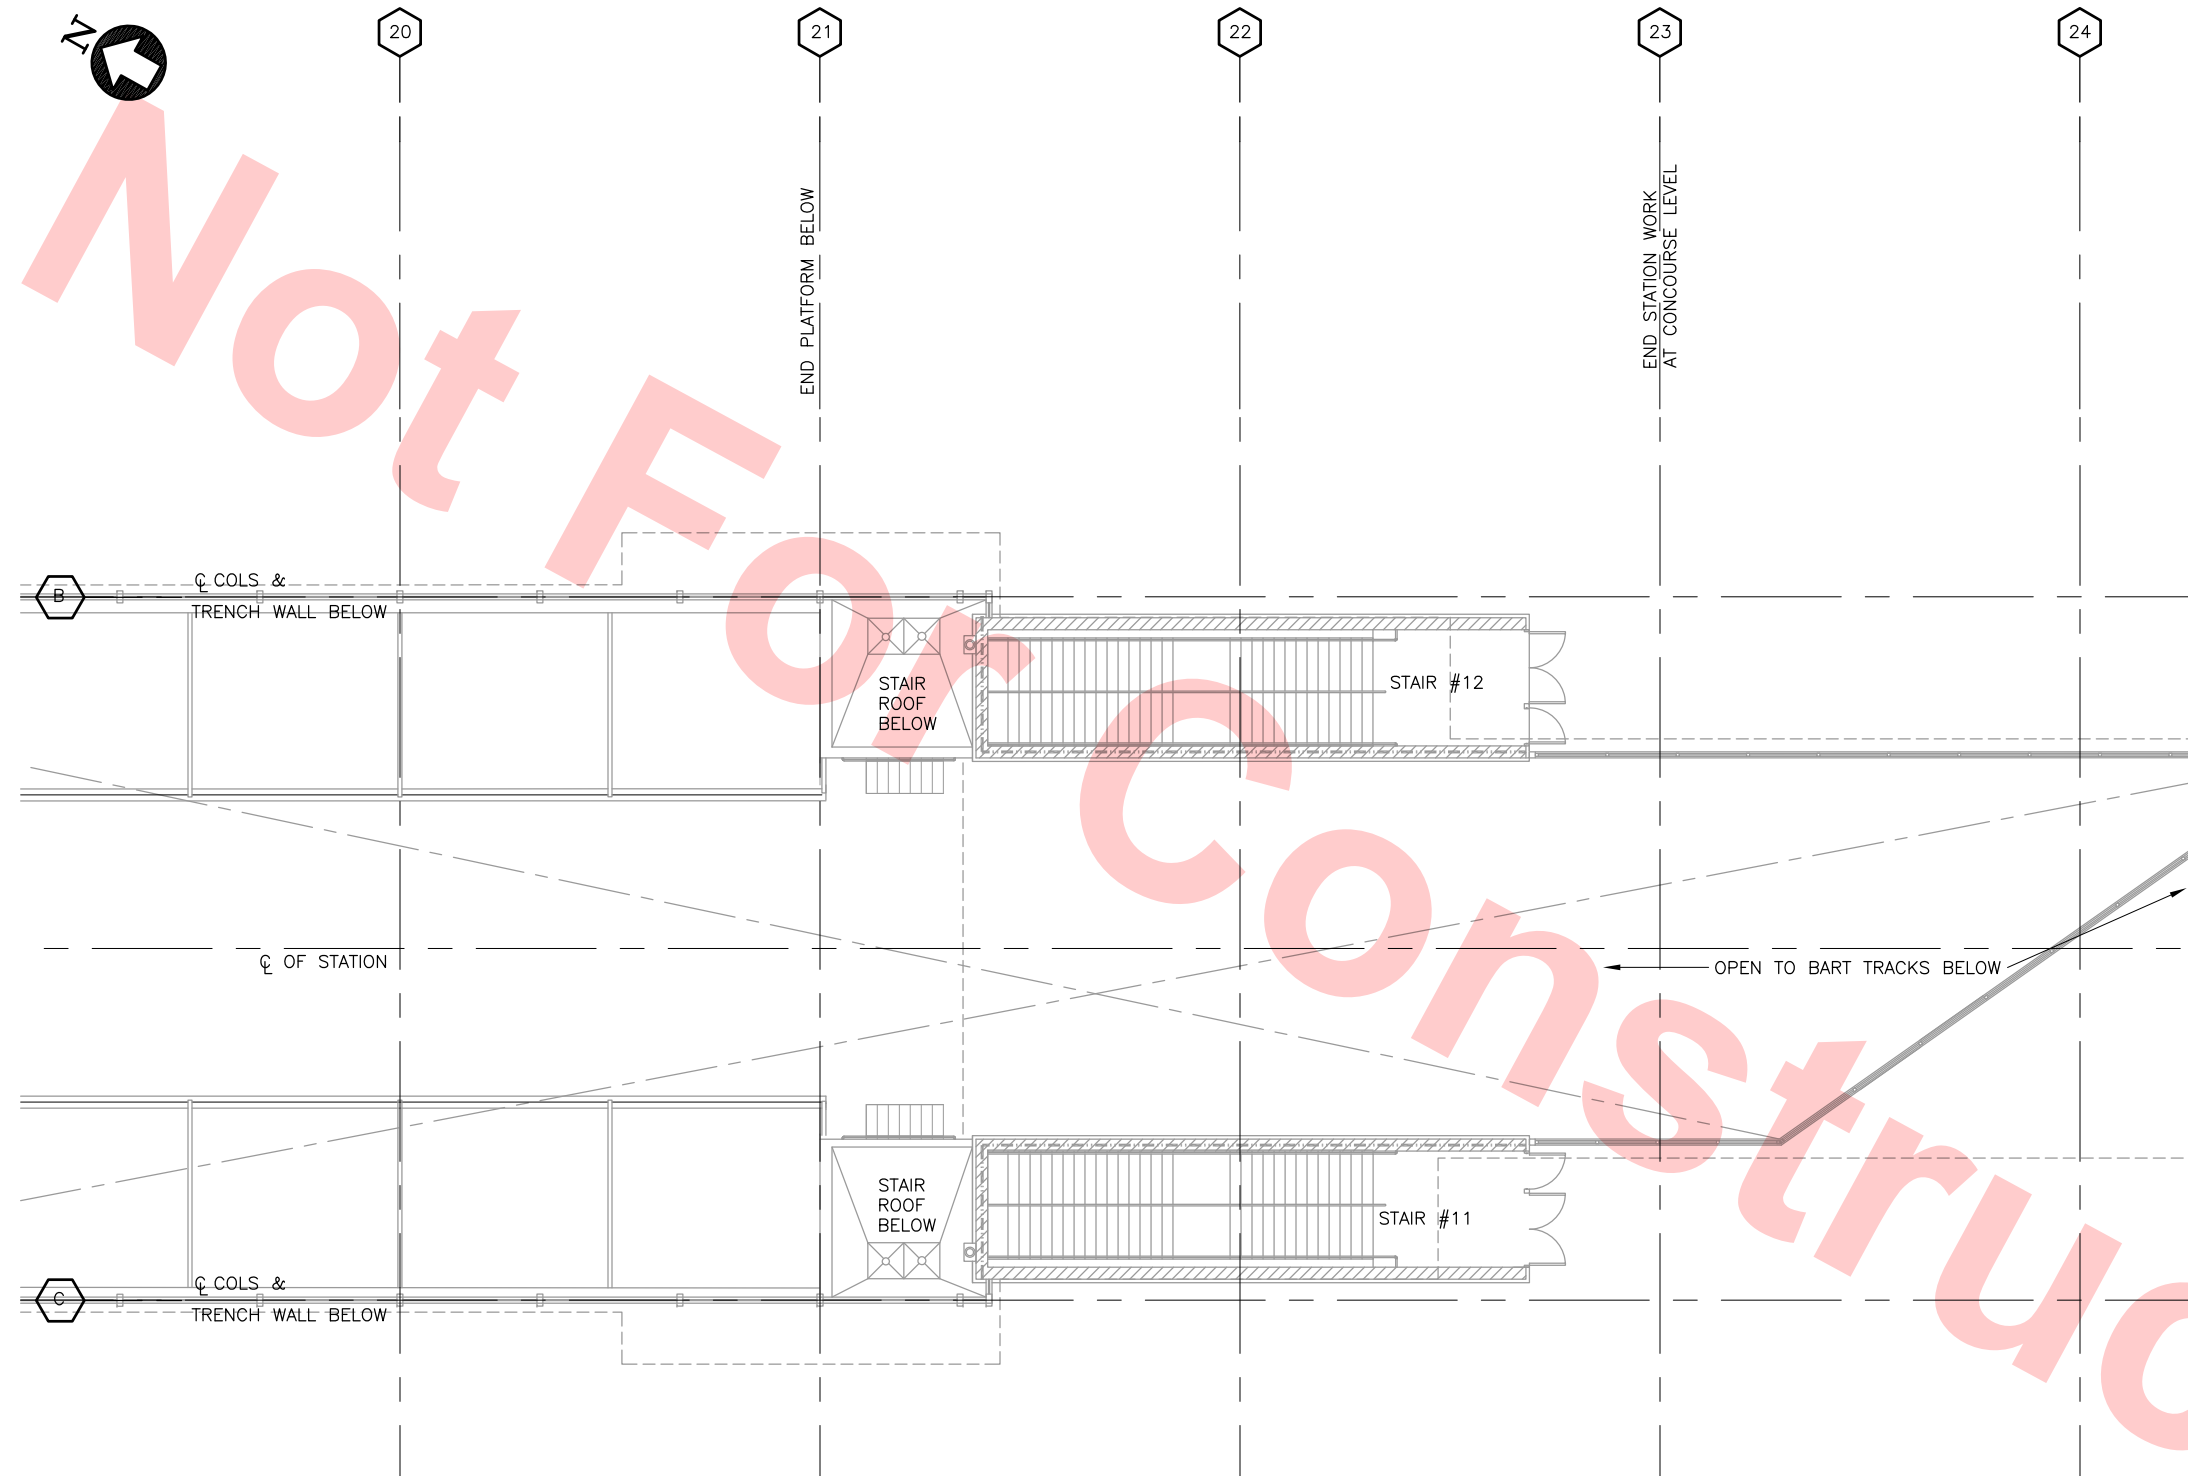


1. THIS DRAWING IS SHOWN FOR STATION CONTINUATION. THERE ARE NO SYSTEMS/COMMUNICATION INTERFACES AT THIS LOCATION

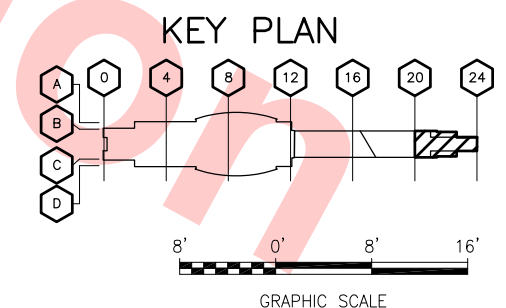


By: _____ **Date:** _____



CONCOURSE LEVEL PLAN
SCALE: 1/8"=1'-0"

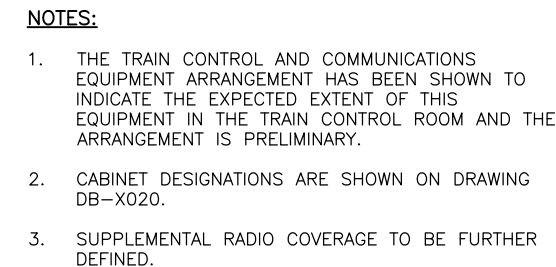[illegible]



 DAS DISTRIBUTED ANTENNA SYSTEM
 FUTURE CABINET
 MINIMUM DIMENSION

___ NO EXCEPTIONS TAKEN (NET)
___ MAKE CORRECTIONS NOTED (MCN)
___ AMEND AND RESUBMIT (A/R)

Any action shown above is subject to the terms of the contract and does not relieve the Contractor of any of its obligations under the contract, including design and detailing.

Contract No.: **DB11002F**

By: _____ **Date:** _____



Jun 20, 2013 - 9:54am

Not For Construction

COMMUNICATION CABLE TRAY
SIGNAL CABLE TRAY
POWER CABLE TRAY

14'-3 5/8"

6'-4"

1'-10"

10"

6'-4"

6'-4"

7'-4 1/2"

7'-4 1/2"

7'-4 1/2"

6'-0" MIN

4 1/2" SILL (TYP)

4'-0" MIN

2'-0"

SIGNAL CABINETS
POWER CABINETS
COMMUNICATION CABINETS

COMMUNICATION CABLE TRAY
POWER CABLE TRAY

Santa Clara Valley Transportation Authority
— NO EXCEPTIONS TAKEN (NET)
— MAKE CORRECTIONS NOTED (MCN)
— AMEND AND RESUBMIT (A/R)
Any action shown above is subject to the terms of the contract and does not relieve the Contractor of any of its obligations under the contract, including design and detailing.
Contract No.: DB11002F
By: _____ Date: _____

SECTION A
SCALE: 1/2" = 1'-0" DB-1057

1' 0' 1' 2' 3' 4'
GRAPHIC SCALE


Santa Clara Valley Transportation Authority




____ **NO EXCEPTIONS TAKEN (NET)**
____ **MAKE CORRECTIONS NOTED (MCN)**
____ **AMEND AND RESUBMIT (A/R)**

Any action shown above is subject to the terms of the contract and does not relieve the Contractor of any of its obligations under the contract, including design and detailing.

Contract No.: _____ **DB11002F** _____

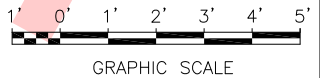




By: _____ Date: _____



					DESIGNED BY M. GOLUCKI DRAWN BY B. COOPER CHECKED BY B. MENDEZ LORA IN CHARGE B. MENDEZ LORA DATE 20130710				Skanska Shimmick Herzog 1436 California Circle Milpitas, California 95035 A Joint Venture 				LINE, TRACK, STATIONS AND SYSTEMS DESIGN UNIT 023 MILPITAS STATION TRAIN CONTROL ROOM S40 EQUIPMENT ELEVATIONS		CADD FILENAME C700-S-DB-I057.d SIZE SCALE D 1/2" = 1'-0" CONTRACT NO. C700 AREA CODE DB SHEET NO. I057	
0	20130710				READINESS FOR CONSTRUCTION											
REV	DATE	BY	SUB	APP	DESCRIPTION				APPROVED		T-Y LIN INTERNATIONAL					




By: _____ **Date:** _____

						DESIGNED BY M. GOLUCKI		Skanska Shimmick Herzog	1436 California Circle Milpitas, California 95035 A Joint Venture		LINE, TRACK, STATIONS AND SYSTEMS DESIGN UNIT 023 MILPITAS STATION EQUIPMENT ARRANGEMENT STATION AGENT'S BOOTH	CADD FILENAME C700-S-DB-I640.dwg				
					DRAWN BY B. COOPER	SIZE D						SCALE NOT TO SCALE	CONTRACT NO.	C700	REV.	0
					CHECKED BY B. MENDEZ LORA	IN CHARGE B. MENDEZ LORA										
					DATE 20130710											
	0	20130710				READINESS FOR CONSTRUCTION						AREA CODE DB	SHEET NO. 1640	PAGE NO. 1065		
REV	DATE	BY	SUB	APP	DESCRIPTION			SUBMITTED	APPROVED							



NOTES:

1. COMMUNICATION DEVICES LABELED "POC" TO BE ROUTED TO VTA COMMUNICATIONS ROOM.
2. DEVICES LABELED "GF" (GROUND FLOOR) TO BE ROUTED TO CTR #1.
3. REFER TO RISER DIAGRAMS AND CONDUIT SCHEDULES FOR ROUTING DETAILS AND REQUIREMENTS.

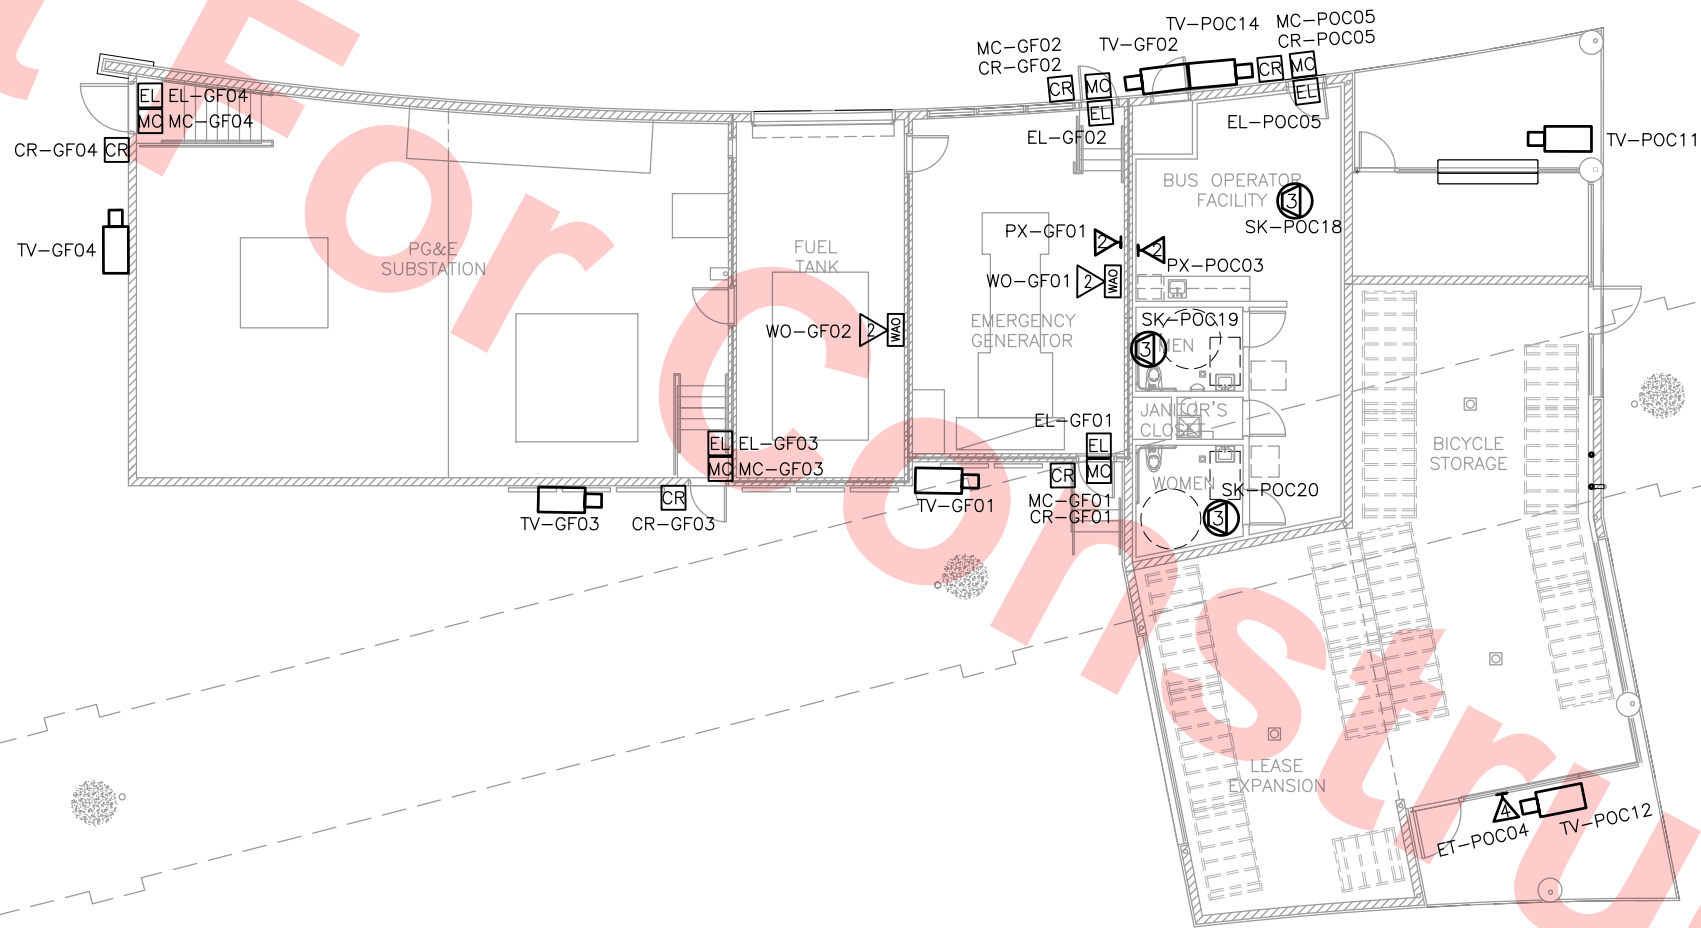

Santa Clara Valley Transportation Authority

NO EXCEPTIONS TAKEN (NET)
MAKE CORRECTIONS NOTED (MCN)
AMEND AND RESUBMIT (A/R)

Any action shown above is subject to the terms of the contract
and does not relieve the Contractor of any of its obligations
under the contract, including design and detailing.

Contract No.: DB11002F


By: _____ Date: _____

ANCILLARY BUILDING PLAN
SCALE: 1/8"=1'-0"



REV	DATE	BY	SUB	APP	DESCRIPTION
0	20130710				READINESS FOR CONSTRUCTION

DESIGNED BY
M. GOLUCKI
DRAWN BY
B. COOPER
CHECKED BY
B. MENDEZ LORA
IN CHARGE
B. MENDEZ LORA
DATE
20130710

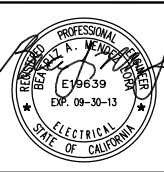


Skanska
Shimmick
Herzog
LTK
LTK Engineering Services
SUBMITTED

1436 California Circle
Milpitas, California 95035
A Joint Venture
**Lockwood, Andrews
& Newnam, Inc.**
A LEA A BALLY COMPANY
T-Y-LIN INTERNATIONAL
APPROVED



LINE, TRACK, STATIONS AND SYSTEMS DESIGN UNIT 023 MILPITAS STATION ANCILLARY BUILDING COMMUNICATIONS EQUIPMENT LAYOUT				CADD FILENAME C700-S-DB-B811.dwg
SIZE	SCALE	CONTRACT NO.	REV.	PAGE NO.
D	1/8"=1'-0"	C700	0	1066
AREA CODE	SHEET NO.	DB	B811	

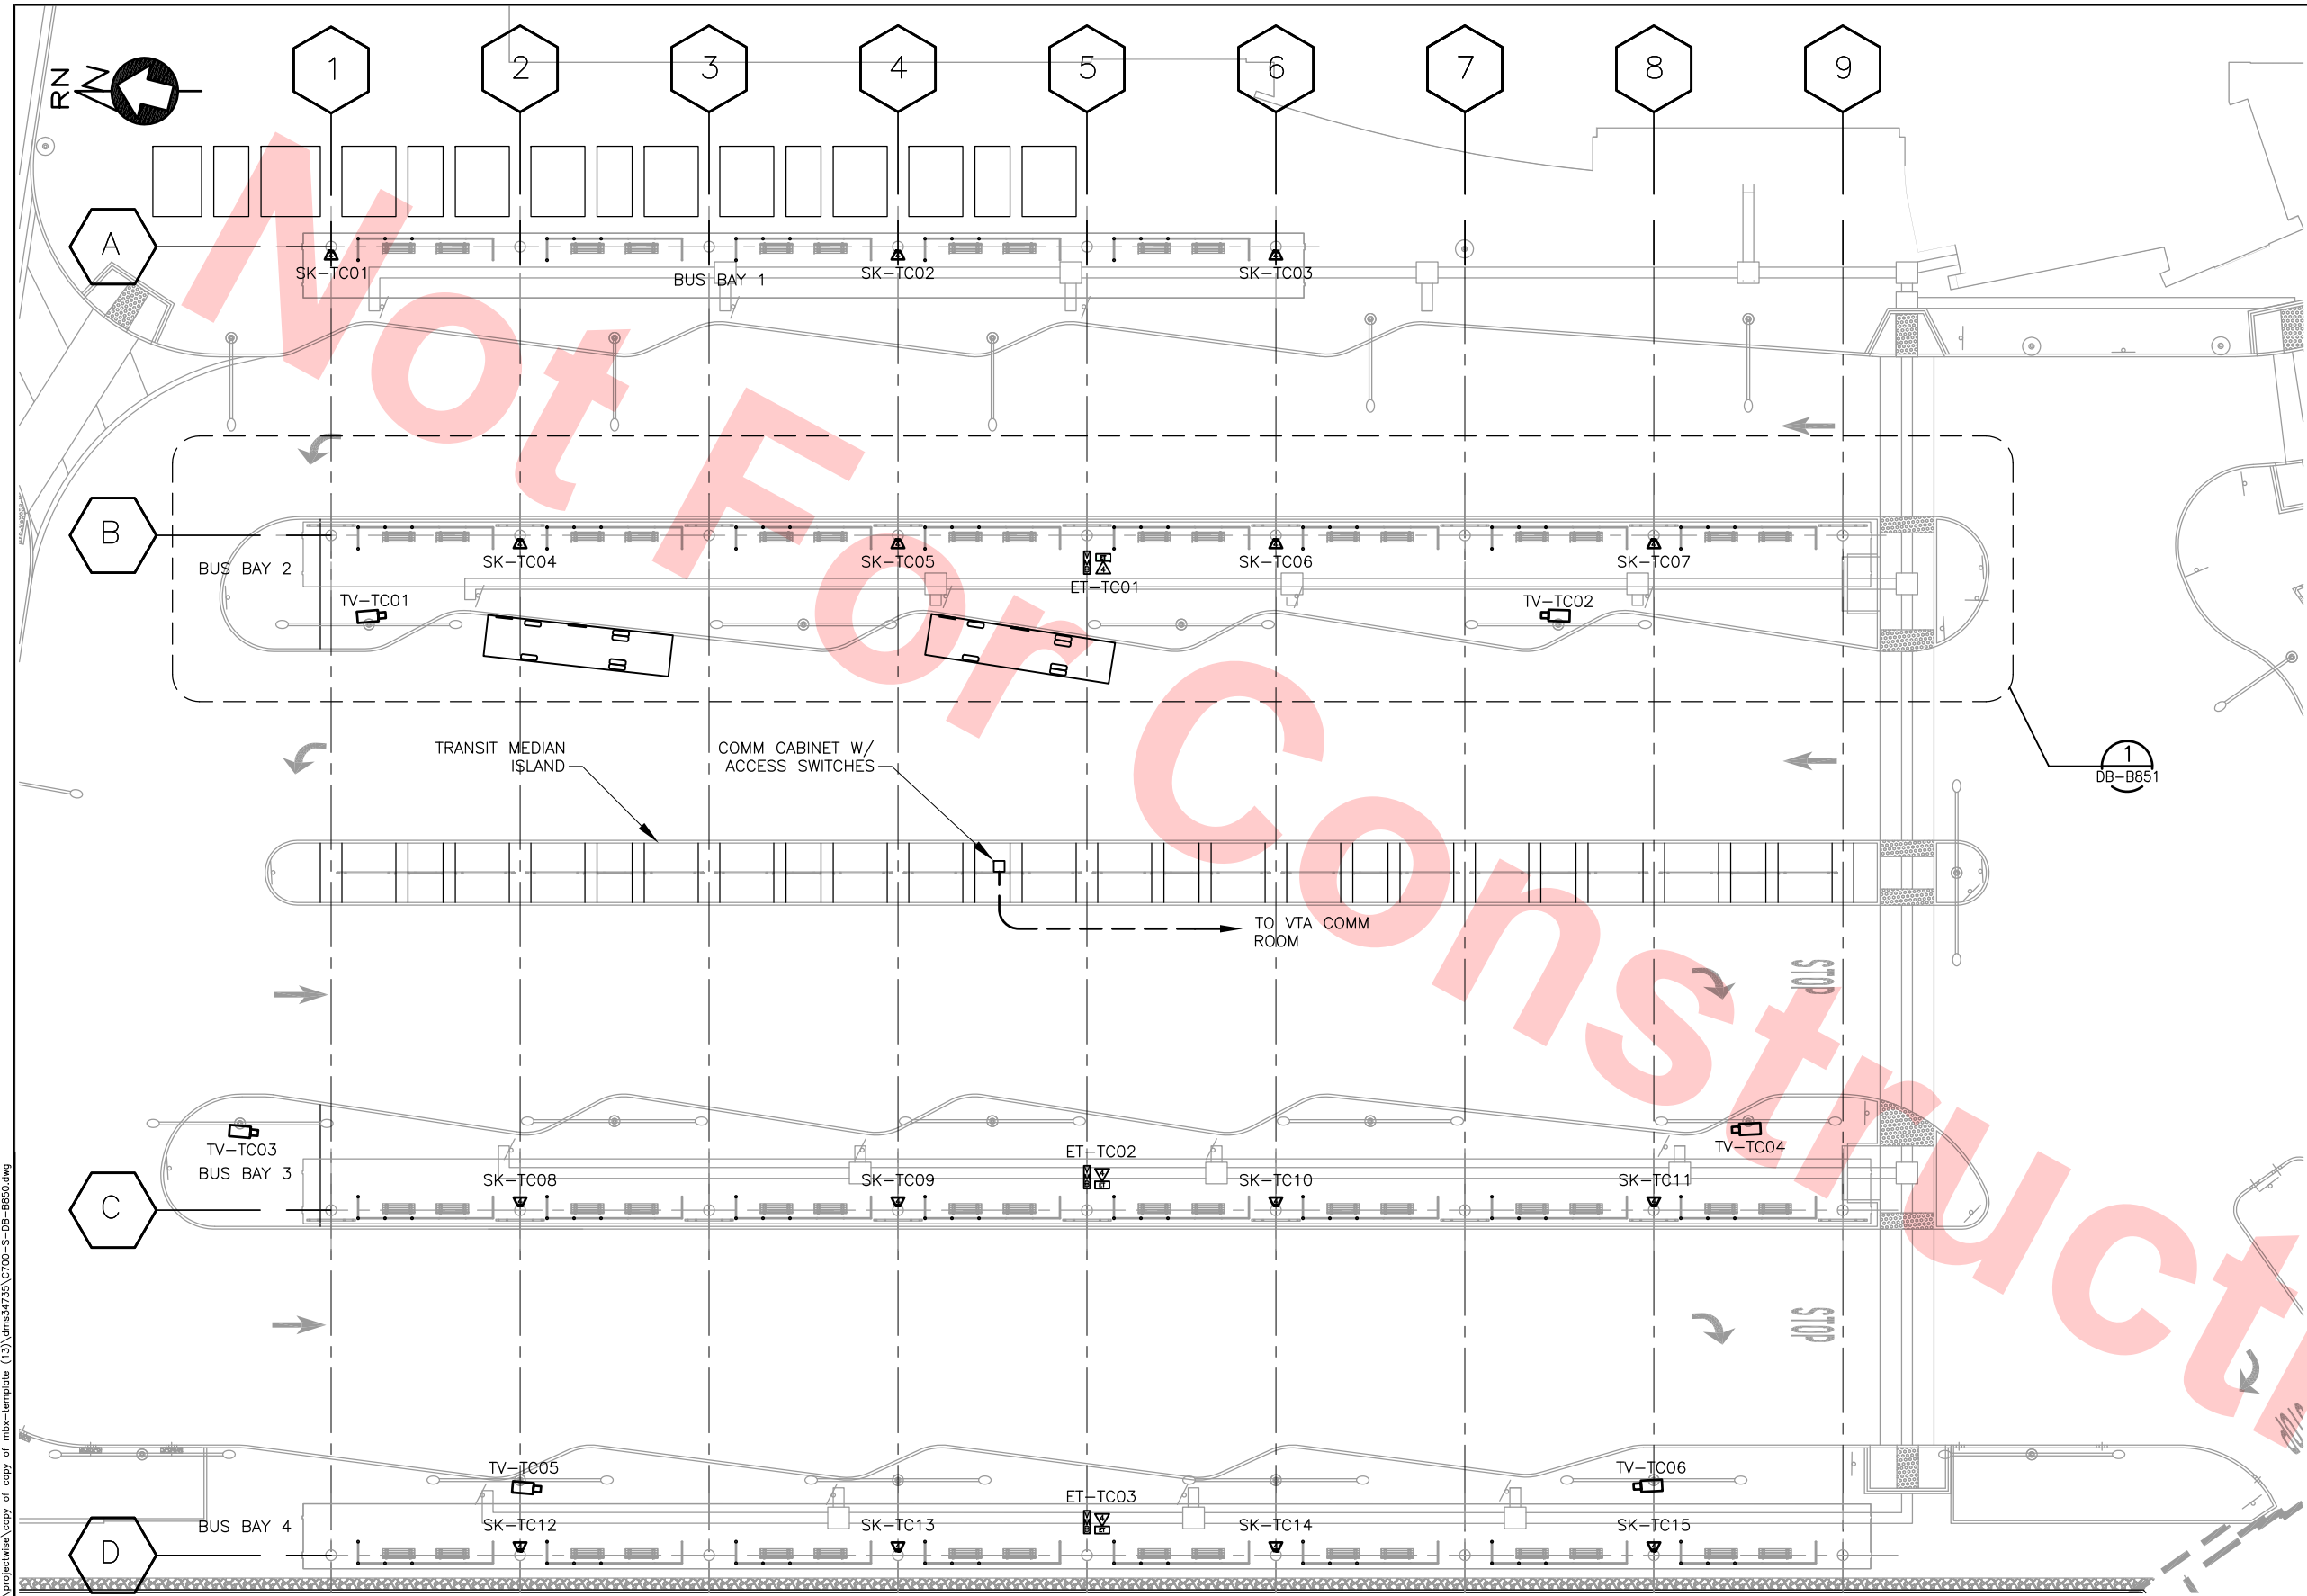

- NOTES:**
- 1. PROTECT COMMUNICATION CASE ON TRANSIT MEDIAN WITH BOLLARDS.
 - 2. COMMUNICATION CASE CONDUIT TO BE ROUTED TO VTA COMM ROOM.
 - 3. ALL CONDUITS SHALL BE RUN CONCEALED BELOW SLAB AND INSTALLED IN STRUCTURAL STEEL POLES ON BUS SHELTER STRUCTURAL STEEL TO INDIVIDUAL DEVICES.
 - 4. REFER TO RISER DIAGRAMS AND CONDUIT SCHEDULES FOR ROUTING DETAILS AND REQUIREMENTS.

Santa Clara Valley Transportation Authority

— NO EXCEPTIONS TAKEN (NET)
— MAKE CORRECTIONS NOTED (MCN)
— AMEND AND RESUBMIT (A/R)

Any action shown above is subject to the terms of the contract and does not relieve the Contractor of any of its obligations under the contract, including design and detailing.


Contract No.: DB11002F

By: _____ Date: _____

COMMUNICATIONS SITE PLAN
SCALE: 1/16"=1'-0"



DESIGNED BY M. GOLUCKI				
DRAWN BY A. SHRODE				
CHECKED BY B. MENDEZ LORA				
IN CHARGE B. MENDEZ LORA				
DATE 20130710				
0	20130710			READINESS FOR CONSTRUCTION
REV	DATE	BY	SUB	APP

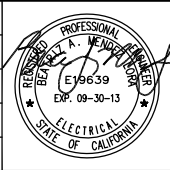

Skanska Shimmick Herzog

1436 California Circle
Milpitas, California 95035
A Joint Venture

LTK Engineering Services

SUBMITTED

Lookwood, Andrews & Newnam, Inc.

APPROVED


T-Y LIN INTERNATIONAL



LINE, TRACK, STATIONS AND SYSTEMS
DESIGN UNIT 023
MILPITAS STATION
TRANSIT CENTER BUS SHELTER
COMMUNICATIONS SITE PLAN

CADD FILENAME C700-S-DB-B850.dwg			
SIZE	SCALE		
D	1/16"=1'-0"		
CONTRACT NO.	C700	REV.	0
AREA CODE	DB	SHEET NO.	B850
		PAGE NO.	1068

NOTE:
1. REFER TO RISER DIAGRAMS AND CONDUIT SCHEDULES FOR ROUTING DETAILS AND REQUIREMENTS.

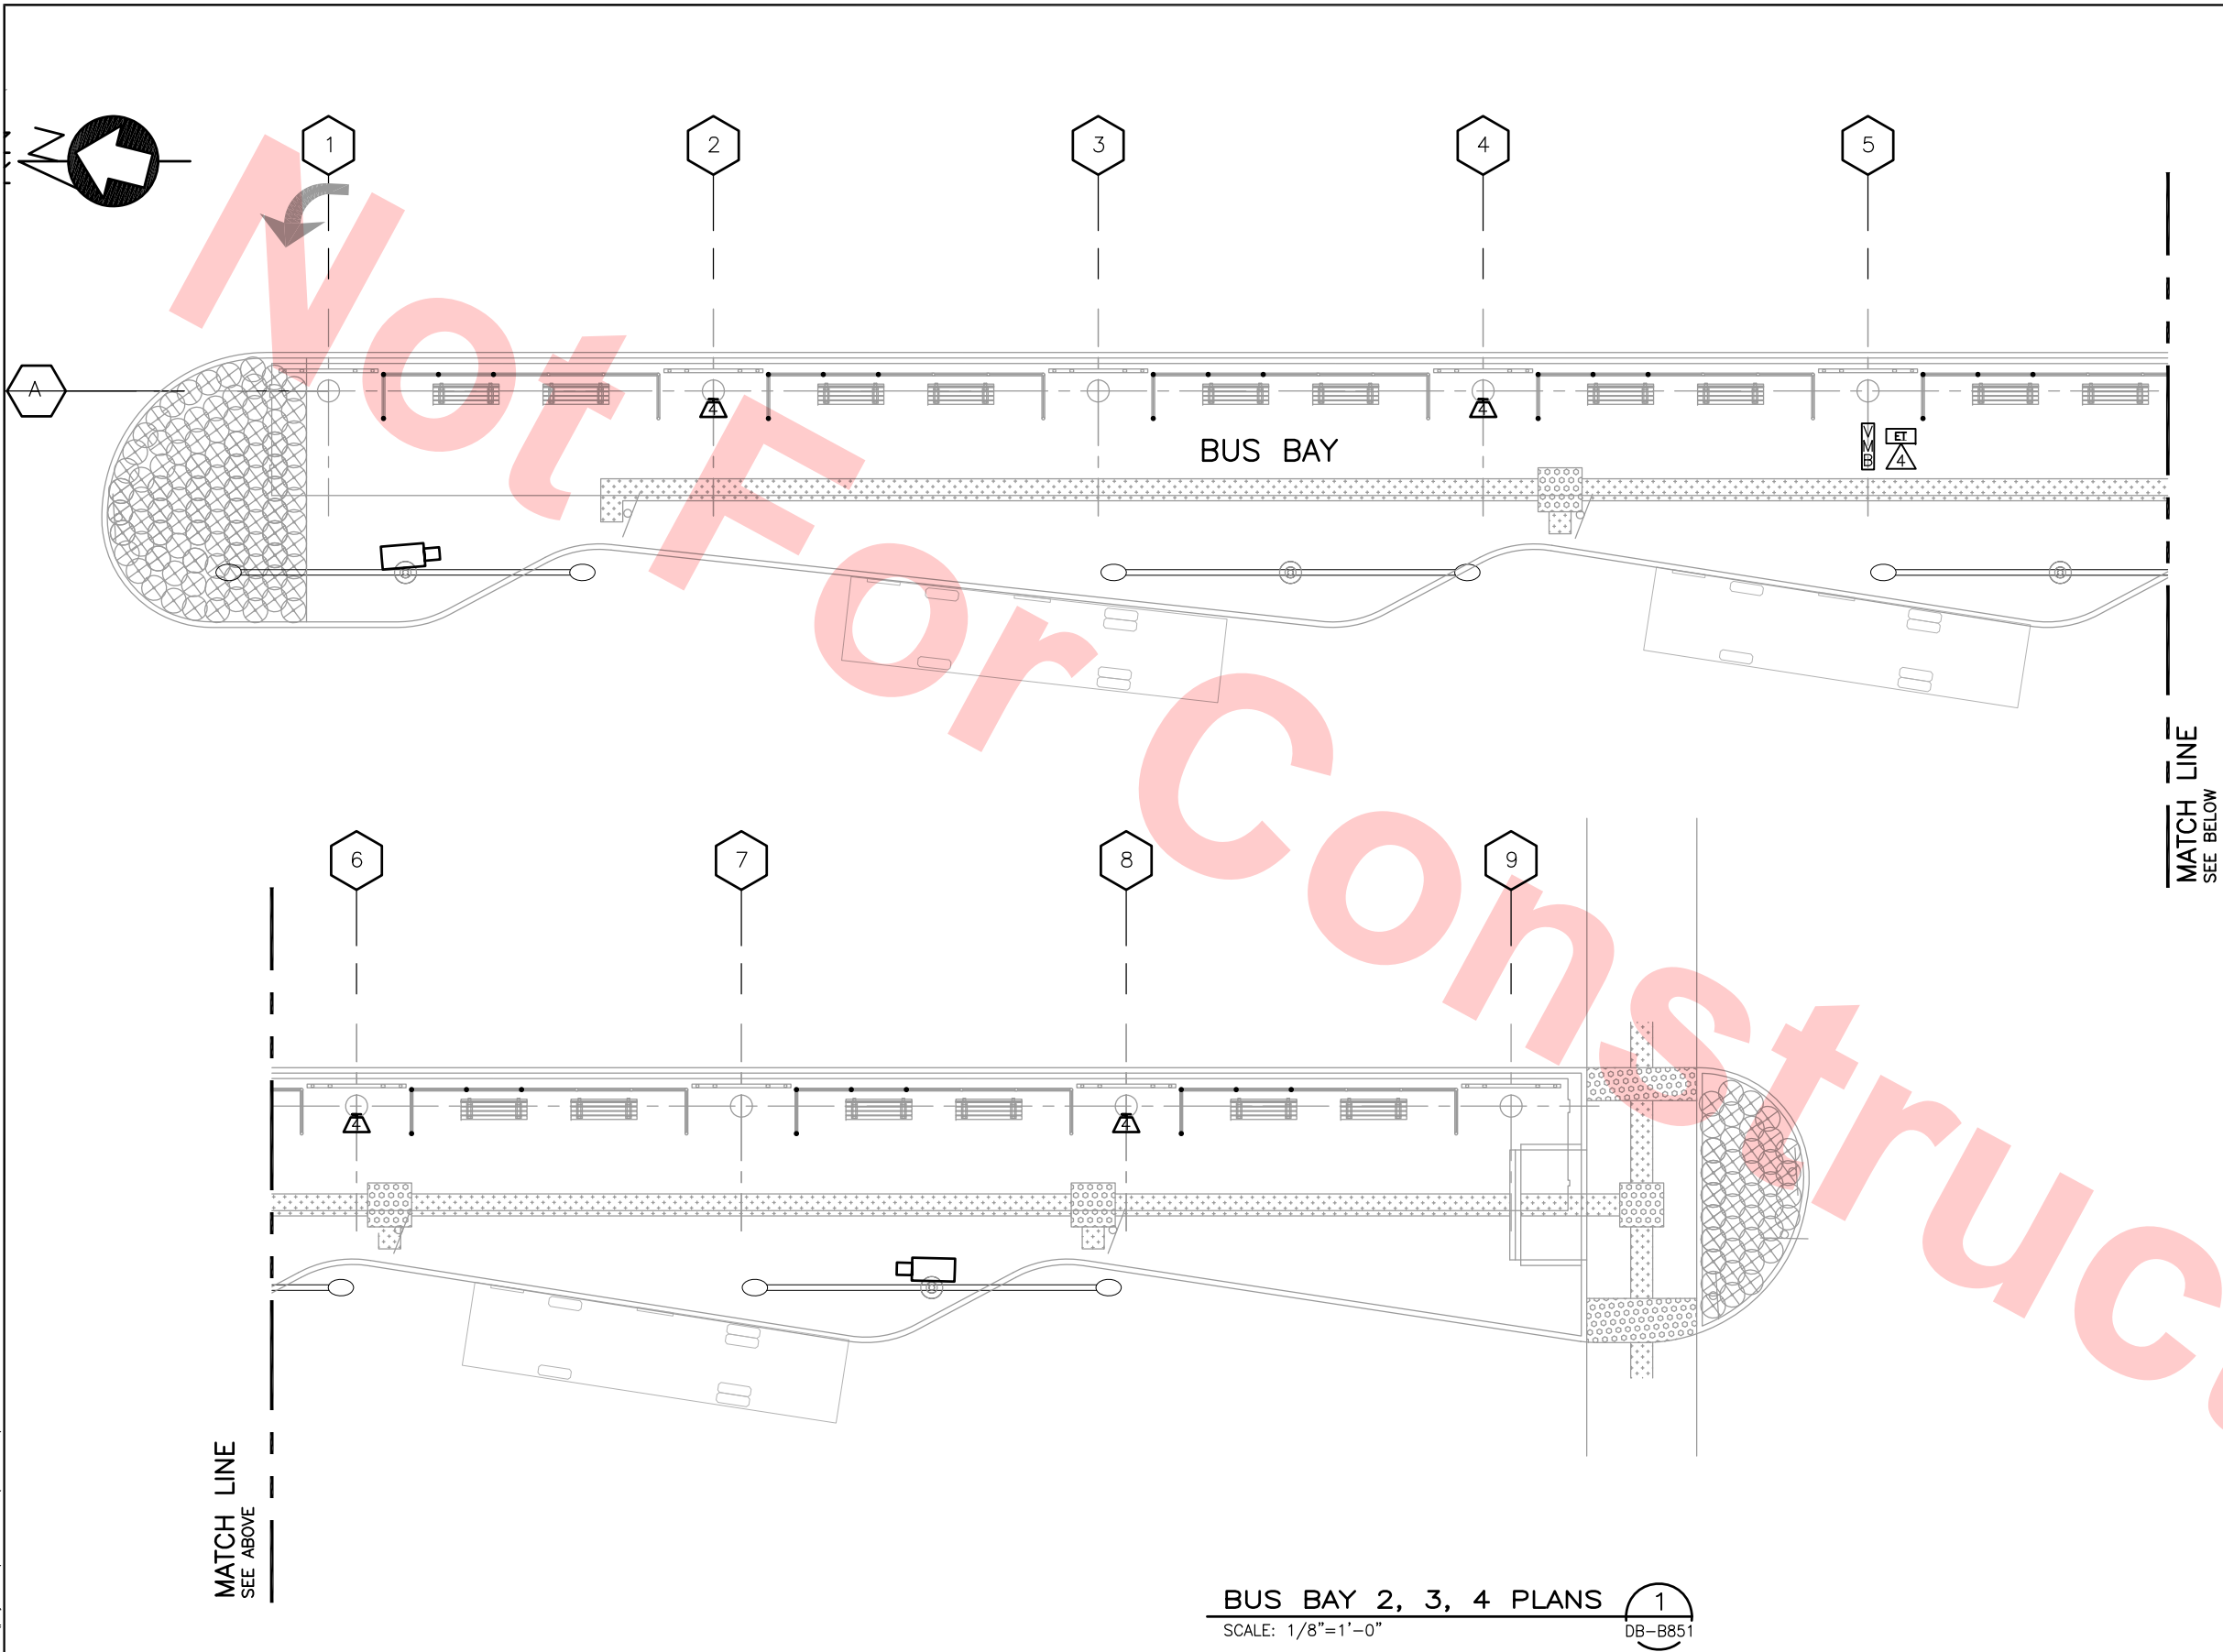

Santa Clara Valley Transportation Authority

___NO EXCEPTIONS TAKEN (NET)
___MAKE CORRECTIONS NOTED (MCN)
___AMEND AND RESUBMIT (A/R)

Any action shown above is subject to the terms of the contract and does not relieve the Contractor of any of its obligations under the contract, including design and detailing.

Contract No.: DB11002F

By: _____ Date: _____


BUS BAY 2, 3, 4 PLANS 1
SCALE: 1/8"=1'-0" DB-B851



Jun 20, 2013 9:25am C:\projects\mbox-astrode\mbox34735\C700-S-DB-B851.DWG

REV	DATE	BY	SUB	APP	DESCRIPTION
0	20130710				READINESS FOR CONSTRUCTION

DESIGNED BY
M. GOLUCKI
DRAWN BY
A. SHRODE
CHECKED BY
B. MENDEZ LORA
IN CHARGE
B. MENDEZ LORA
DATE
20130710

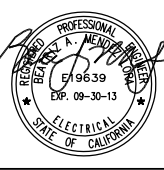

Skanska
Shimmick
Herzog

LTK
LTK Engineering Services

1436 California Circle
Milpitas, California 95035
A Joint Venture

Lockwood, Andrews
& Nowman, Inc.
A LEO A DALY COMPANY

T-Y-LIN INTERNATIONAL

SUBMITTED

APPROVED



BART
SILICON VALLEY

BART SILICON VALLEY BERRYESSA EXTENSION

LINE, TRACK, STATIONS AND SYSTEMS
DESIGN UNIT 023
MILPITAS STATION
TRANSIT CENTER BUS SHELTER
COMMUNICATIONS BUS BAY PLAN DETAIL

LINE, TRACK, STATIONS AND SYSTEMS
DESIGN UNIT 023
MILPITAS STATION
TRANSIT CENTER BUS SHELTER
COMMUNICATIONS BUS BAY PLAN DETAIL

1. SPEAKERS LOCATED ON COLUMNS #1, #4, AND #6 AT BUS BAY #1.
2. SPEAKERS LOCATED ON COLUMNS #2, #4, #6, AND #8 AT BUS BAYS #2, #3, AND #4.
3. CCTVS LOCATED ON LIGHT POLES AT COLUMNS #2, AND #8 AT BUS BAYS #2, #3, AND #4.
4. VMBS LOCATED ON COLUMN #5 AT BUS BAYS #2, #3, AND #4.
5. EMERGENCY TELEPHONES LOCATED ON COLUMN #5 AT BUS BAYS #2, #3, AND #4.
6. MOUNTING DETAILS TO BE COORDINATED WITH BUS TRANSIT FINISHER.
7. ANY CONDUITS INSTALLED EXPOSED ON STRUCTURAL STEEL SHALL BE PAINTED TO MATCH STRUCTURAL STEEL.

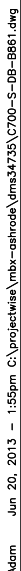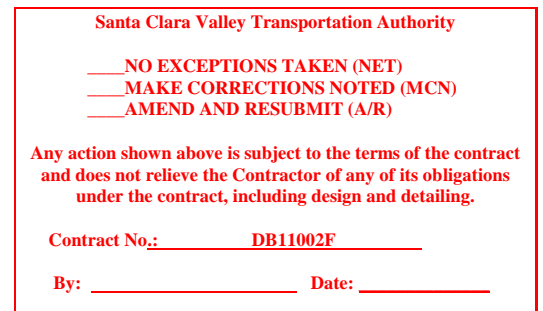

020130710

020130710

020130710

020130710

020130710

020130710

DESIGNED BY
M. GOLUCKI

DRAWN BY
A. SHRODE

CHECKED BY
B. MENDEZ LORA

IN CHARGE
B. MENDEZ LORA

DATE
20130710

PROFESSIONAL
ENGINEER
MILPITAS, CALIFORNIA
519639
EXP. 09-30-13
STATE OF CALIFORNIA

Skanska
Shimmick
Herzog

1436 California Circle
Milpitas, California 95035
A Joint Venture

LTK
LTK Engineering Services

SUBMITTED

Lookwood, Andrews
& Nowman, Inc.
ELECTRICAL

APPROVED

T-Y-LIN INTERNATIONAL

VTA

BART
SILICON VALLEY

BART SILICON VALLEY BERRYESSA EXTENSION

LINE, TRACK, STATIONS AND SYSTEMS
DESIGN UNIT 023
MILPITAS STATION
TRANSIT CENTER BUS SHELTER
COMMUNICATIONS ELEVATION

CADD FILENAME
C700-S-DB-B861.dwg

SIZE D SCALE
AS NOTED

CONTRACT NO. C700
REV. 0

AREA CODE DB
SHEET NO. B861
PAGE NO. 1070

Jun 26, 2013 - 5:47pm C:\projects\wms\mbx-ashrode\lms34735\c700-s-db-b881.dwg

CONDUIT		FOR	FROM	TO	CABLE	
ID	SIZE				SIZE	REMARKS
5K037	1"	ACCESS CONTROL	JB-CS10	SPNL-CS01	7-2/C#18	MAGNETIC CONTACT
					2-4/C#22	REX
					2-4/C#18	ELECTRICAL LOCK
					2-6/C#18TS	CARD READER
5K038	1"	ACCESS CONTROL	JB-CS11	SPNL-CS01	4-2/C#18	MAGNETIC CONTACT
					3-4/C#22	REX
					3-4/C#18	ELECTRICAL LOCK
					3-6/C#18TS	CARD READER
5K039	3/4"	ACCESS CONTROL	JB-C07	JB-CS10	1-2/C#18	MAGNETIC CONTACT
					1-4/C#22	REX
					1-4/C#18	ELECTRICAL LOCK
					1-6/C#18TS	CARD READER
5K040	3/4"	ACCESS CONTROL	JB-C08	JB-CS11	1-2/C#18	MAGNETIC CONTACT
					1-4/C#22	REX
					1-4/C#18	ELECTRICAL LOCK
					1-6/C#18TS	CARD READER
5K041	3/4"	ACCESS CONTROL	JB-CS12	JB-CS11	1-2/C#18	MAGNETIC CONTACT
					1-4/C#22	REX
					1-4/C#18	ELECTRICAL LOCK
					1-6/C#18TS	CARD READER
5K042	3/4"	ACCESS CONTROL	JB-CS13	JB-CS11	2-2/C#18	MAGNETIC CONTACT
					1-4/C#22	REX
					1-4/C#18	ELECTRICAL LOCK
					1-6/C#18TS	CARD READER
5K043	3/4"	ACCESS CONTROL	MC-CS10	JB-CS13	1-2/C#18	MAGNETIC CONTACT
					1-4/C#22	REX
					1-4/C#18	ELECTRICAL LOCK
					1-6/C#18TS	CARD READER
5K044	3/4"	ACCESS CONTROL	JB-C10	JB-CS13	1-2/C#18	MAGNETIC CONTACT
					1-4/C#22	REX
					1-4/C#18	ELECTRICAL LOCK
					1-6/C#18TS	CARD READER
5K045	3/4"	ACCESS CONTROL	JB-P10	SPNL-P2N01	1-2/C#18	MAGNETIC CONTACT
					1-4/C#22	REX
					1-4/C#18	ELECTRICAL LOCK
					1-6/C#18TS	CARD READER
5K046	1 1/2"	ACCESS CONTROL	JB-PN01	SPNL-P2N01	19-2/C#18	MAGNETIC CONTACT
					5-4/C#22	REX
					5-4/C#18	ELECTRICAL LOCK
					5-6/C#18TS	CARD READER
5K047	1"	ACCESS CONTROL	JB-PN02	JB-PN01	7-2/C#18	MAGNETIC CONTACT
					1-4/C#22	REX
					1-4/C#18	ELECTRICAL LOCK
					1-6/C#18TS	CARD READER
5K048	3/4"	ACCESS CONTROL	MC-P2S01	JB-PN02	1-2/C#18	MAGNETIC CONTACT
					6-2/C#18	MAGNETIC CONTACT
					1-4/C#22	REX
					1-4/C#18	ELECTRICAL LOCK
5K049	3/4"	ACCESS CONTROL	JB-PS01	JB-PN02	1-6/C#18TS	CARD READER
					1-2/C#18	MAGNETIC CONTACT
					1-4/C#22	REX
					1-4/C#18	ELECTRICAL LOCK
5K050	3/4"	ACCESS CONTROL	JB-P08	JB-PS01	1-2/C#18	MAGNETIC CONTACT
					1-4/C#22	REX
					1-4/C#18	ELECTRICAL LOCK
					1-6/C#18TS	CARD READER
5K051	3/4"	ACCESS CONTROL	JB-PS02	JB-PS01	5-2/C#18	MAGNETIC CONTACT
5K052	3/4"	ACCESS CONTROL	MC-P2S03	JB-PS02	1-2/C#18	MAGNETIC CONTACT
5K053	3/4"	ACCESS CONTROL	MC-P2S07	JB-PS02	1-2/C#18	MAGNETIC CONTACT
5K054	3/4"	ACCESS CONTROL	MC-P2S06	JB-PS02	1-2/C#18	MAGNETIC CONTACT
5K055	3/4"	ACCESS CONTROL	MC-P2S05	JB-PS02	1-2/C#18	MAGNETIC CONTACT
5K056	3/4"	ACCESS CONTROL	MC-P2S04	JB-PS02	1-2/C#18	MAGNETIC CONTACT

CONDUIT		FOR	FROM	TO	CABLE	
ID	SIZE				SIZE	REMARKS
5K057	1 1/4"	ACCESS CONTROL	JB-PN03	JB-PN01	12-2/C#18	MAGNETIC CONTACT
					4-4/C#22	REX
					4-4/C#18	ELECTRICAL LOCK
					4-6/C#18TS	CARD READER
5K058	3/4"	ACCESS CONTROL	MC-P2N02	JB-PN03	1-2/C#18	MAGNETIC CONTACT
5K059	1 1/4"	ACCESS CONTROL	JB-PN04	JB-PN03	11-2/C#18	MAGNETIC CONTACT
					4-4/C#22	REX
					4-4/C#18	ELECTRICAL LOCK
					4-6/C#18TS	CARD READER
5K060	3/4"	ACCESS CONTROL	JB-P14	JB-PN04	1-2/C#18	MAGNETIC CONTACT
					1-4/C#22	REX
					1-4/C#18	ELECTRICAL LOCK
					1-6/C#18TS	CARD READER
5K061	1 1/4"	ACCESS CONTROL	JB-PN05	JB-PN04	10-2/C#18	MAGNETIC CONTACT
					3-4/C#22	REX
					3-4/C#18	ELECTRICAL LOCK
					3-6/C#18TS	CARD READER
5K062	3/4"	ACCESS CONTROL	JB-P16	JB-PN05	1-2/C#18	MAGNETIC CONTACT
					1-4/C#22	REX
					1-4/C#18	ELECTRICAL LOCK
					1-6/C#18TS	CARD READER
5K063	1"	ACCESS CONTROL	JB-PN06	JB-PN05	9-2/C#18	MAGNETIC CONTACT
					2-4/C#22	REX
					2-4/C#18	ELECTRICAL LOCK
					2-6/C#18TS	CARD READER
5K064	3/4"	ACCESS CONTROL	JB-P18	JB-PN06	1-2/C#18	MAGNETIC CONTACT
					1-4/C#22	REX
					1-4/C#18	ELECTRICAL LOCK
					1-6/C#18TS	CARD READER
5K065	1"	ACCESS CONTROL	JB-PN07	JB-PN06	8-2/C#18	MAGNETIC CONTACT
					1-4/C#22	REX
					1-4/C#18	ELECTRICAL LOCK
					1-6/C#18TS	CARD READER
5K066	3/4"	ACCESS CONTROL	MC-P2N06	JB-PN07	1-2/C#18	MAGNETIC CONTACT
					7-2/C#18	MAGNETIC CONTACT
					1-4/C#22	REX
					1-4/C#18	ELECTRICAL LOCK
5K067	3/4"	ACCESS CONTROL	JB-PN08	JB-PN07	1-6/C#18TS	CARD READER
					1-2/C#18	MAGNETIC CONTACT
					1-4/C#22	REX
					1-4/C#18	ELECTRICAL LOCK
5K068	3/4"	ACCESS CONTROL	MC-P2N07	JB-PN08	1-6/C#18TS	CARD READER
					1-2/C#18	MAGNETIC CONTACT
					6-2/C#18	MAGNETIC CONTACT
					1-4/C#22	REX
5K069	3/4"	ACCESS CONTROL	JB-PN09	JB-PN08	1-4/C#18	ELECTRICAL LOCK
					1-6/C#18TS	CARD READER
					1-2/C#18	MAGNETIC CONTACT
					1-4/C#22	REX
5K070	3/4"	ACCESS CONTROL	JB-P24	JB-PN09	1-4/C#18	ELECTRICAL LOCK
					1-6/C#18TS	CARD READER
					1-2/C#18	MAGNETIC CONTACT
					1-4/C#22	REX
5K071	3/4"	ACCESS CONTROL	JB-PN10	JB-PN09	5-2/C#18	MAGNETIC CONTACT

Santa Clara Valley Transportation Authority

NO EXCEPTIONS TAKEN (NET)
MAKE CORRECTIONS NOTED (MCN)
AMEND AND RESUBMIT (A/R)

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Contract No.: DB11002F

By: _____ Date: _____

DESIGNED BY
M. GOLUCKI

DRAWN BY
A. SHRODE

CHECKED BY
B. MENDEZ LORA

IN CHARGE
B. MENDEZ LORA

DATE
20130710

PROFESSIONAL
ENGINEER
E 19639
EXP. 09-30-13
STATE OF CALIFORNIA

Skanska
Shimmick
Herzog

1436 California Circle
Milpitas, California 95035
A Joint Venture

LTK
LTK Engineering Services

SUBMITTED

Lookwood, Andrews
& Newnam, Inc.
A LEOPALDY COMPANY

APPROVED

T-Y LIN INTERNATIONAL

BART
SILICON VALLEY

BART SILICON VALLEY BERRYESSA EXTENSION

LINE, TRACK, STATIONS AND SYSTEMS
DESIGN UNIT 023
MILPITAS STATION
COMMUNICATION SYSTEMS
CONDUIT AND CABLE SCHEDULE
SHEET 2 OF 9

CADD FILENAME
C700-S-DB-B881.dwg

SIZE SCALE
D NONE

CONTRACT NO.
C700

REV.
0

AREA CODE
DB

SHEET NO.
B881

PAGE NO.
1072

Jun 26, 2013 - 6:53pm C:\projects\msh-ashrode\lms34735\c700-S-DB-B882.dwg

CONDUIT		FOR	FROM	TO	CABLE	
ID	SIZE				SIZE	REMARKS
5K072	3/4"	ACCESS CONTROL	MC-P2N09	JB-PN10	1-2/C#18	MAGNETIC CONTACT
5K073	3/4"	ACCESS CONTROL	MC-P2N10	JB-PN11	1-2/C#18	MAGNETIC CONTACT
5K074	3/4"	ACCESS CONTROL	MC-P2N11	JB-PN11	1-2/C#18	MAGNETIC CONTACT
5K075	3/4"	ACCESS CONTROL	MC-P2N12	JB-PN11	1-2/C#18	MAGNETIC CONTACT
5K076	3/4"	ACCESS CONTROL	MC-P2N13	JB-PN11	1-2/C#18	MAGNETIC CONTACT
5K077	3/4"	ACCESS CONTROL	JB-P09	SPNL-P1N01	1-2/C#18	MAGNETIC CONTACT
					1-4/C#22	REX
					1-4/C#18	ELECTRICAL LOCK
					1-6/C#18TS	CARD READER
5K078	1 1/2"	ACCESS CONTROL	JB-PN12	SPNL-P1N01	19-2/C#18	MAGNETIC CONTACT
					5-4/C#22	REX
					5-4/C#18	ELECTRICAL LOCK
					5-6/C#18TS	CARD READER
5K079	1"	ACCESS CONTROL	JB-PS03	JB-PN12	7-2/C#18	MAGNETIC CONTACT
					1-4/C#22	REX
					1-4/C#18	ELECTRICAL LOCK
					1-6/C#18TS	CARD READER
5K080	3/4"	ACCESS CONTROL	MC-P1S01	JB-PS03	1-2/C#18	MAGNETIC CONTACT
5K081	3/4"	ACCESS CONTROL	JB-PS04	JB-PS03	6-2/C#18	MAGNETIC CONTACT
					1-4/C#22	REX
					1-4/C#18	ELECTRICAL LOCK
					1-6/C#18TS	CARD READER
5K082	3/4"	ACCESS CONTROL	JB-P07	JB-PS04	1-2/C#18	MAGNETIC CONTACT
					1-4/C#22	REX
					1-4/C#18	ELECTRICAL LOCK
					1-6/C#18TS	CARD READER
5K083	3/4"	ACCESS CONTROL	JB-PS05	JB-PS04	5-2/C#18	MAGNETIC CONTACT
5K084	3/4"	ACCESS CONTROL	MC-P1S03	JB-PS05	1-2/C#18	MAGNETIC CONTACT
5K085	3/4"	ACCESS CONTROL	MC-P1S04	JB-PS05	1-2/C#18	MAGNETIC CONTACT
5K086	3/4"	ACCESS CONTROL	MC-P1S05	JB-PS05	1-2/C#18	MAGNETIC CONTACT
5K087	3/4"	ACCESS CONTROL	MC-P1S06	JB-PS05	1-2/C#18	MAGNETIC CONTACT
5K088	3/4"	ACCESS CONTROL	MC-P1S07	JB-PS05	1-2/C#18	MAGNETIC CONTACT
5K089	1 1/4"	ACCESS CONTROL	JB-PN13	JB-PN12	12-2/C#18	MAGNETIC CONTACT
					4-4/C#22	REX
					4-4/C#18	ELECTRICAL LOCK
					4-6/C#18TS	CARD READER
5K090	3/4"	ACCESS CONTROL	MC-P1N02	JB-PN13	1-2/C#18	MAGNETIC CONTACT
5K091	1 1/4"	ACCESS CONTROL	JB-PN14	JB-PN13	11-2/C#18	MAGNETIC CONTACT
					4-4/C#22	REX
					4-4/C#18	ELECTRICAL LOCK
					4-6/C#18TS	CARD READER
5K092	3/4"	ACCESS CONTROL	JB-P13	JB-PN14	1-2/C#18	MAGNETIC CONTACT
					1-4/C#22	REX
					1-4/C#18	ELECTRICAL LOCK
					1-6/C#18TS	CARD READER
5K093	1 1/4"	ACCESS CONTROL	JB-PN15	JB-PN14	10-2/C#18	MAGNETIC CONTACT
					3-4/C#22	REX
					3-4/C#18	ELECTRICAL LOCK
					3-6/C#18TS	CARD READER
5K094	3/4"	ACCESS CONTROL	JB-P15	JB-PN15	1-2/C#18	MAGNETIC CONTACT
					1-4/C#22	REX
					1-4/C#18	ELECTRICAL LOCK
					1-6/C#18TS	CARD READER

CONDUIT		FOR	FROM	TO	CABLE	
ID	SIZE				SIZE	REMARKS
5K095	1"	ACCESS CONTROL	JB-PN16	JB-PN15	9-2/C#18	MAGNETIC CONTACT
					2-4/C#22	REX
					2-4/C#18	ELECTRICAL LOCK
					2-6/C#18TS	CARD READER
5K096	3/4"	ACCESS CONTROL	JB-P17	JB-PN16	1-2/C#18	MAGNETIC CONTACT
					1-4/C#22	REX
					1-4/C#18	ELECTRICAL LOCK
					1-6/C#18TS	CARD READER
5K097	1"	ACCESS CONTROL	JB-PN17	JB-PN16	8-2/C#18	MAGNETIC CONTACT
					1-4/C#22	REX
					1-4/C#18	ELECTRICAL LOCK
					1-6/C#18TS	CARD READER
5K098	3/4"	ACCESS CONTROL	MC-P1N06	JB-PN17	1-2/C#18	MAGNETIC CONTACT
5K099	3/4"	ACCESS CONTROL	JB-PN18	JB-PN17	7-2/C#18	MAGNETIC CONTACT
					1-4/C#22	REX
					1-4/C#18	ELECTRICAL LOCK
					1-6/C#18TS	CARD READER
5K100	3/4"	ACCESS CONTROL	MC-P1N07	JB-PN18	1-2/C#18	MAGNETIC CONTACT
5K101	3/4"	ACCESS CONTROL	JB-PN19	JB-PN18	6-2/C#18	MAGNETIC CONTACT
					1-4/C#22	REX
					1-4/C#18	ELECTRICAL LOCK
					1-6/C#18TS	CARD READER
5K102	3/4"	ACCESS CONTROL	JB-P23	JB-PN19	1-2/C#18	MAGNETIC CONTACT
					1-4/C#22	REX
					1-4/C#18	ELECTRICAL LOCK
					1-6/C#18TS	CARD READER
5K103	3/4"	ACCESS CONTROL	MC-P1N09	JB-PN20	1-2/C#18	MAGNETIC CONTACT
5K104	3/4"	ACCESS CONTROL	MC-P1N10	JB-PN21	1-2/C#18	MAGNETIC CONTACT
5K105	3/4"	ACCESS CONTROL	MC-P1N11	JB-PN21	1-2/C#18	MAGNETIC CONTACT
5K106	3/4"	ACCESS CONTROL	MC-P1N12	JB-PN21	1-2/C#18	MAGNETIC CONTACT
5K107	3/4"	ACCESS CONTROL	MC-P1N13	JB-PN21	1-2/C#18	MAGNETIC CONTACT
5K108	3/4"	ACCESS CONTROL	JB-PN21	JB-PN20	4-2/C#18	MAGNETIC CONTACT
5K109	3/4"	ACCESS CONTROL	JB-PN11	JB-PN10	4-2/C#18	MAGNETIC CONTACT
5K110	3/4"	ACCESS CONTROL	JB-PN20	JB-PN19	5-2/C#18	MAGNETIC CONTACT
5K111	3/4"	ACCESS CONTROL	JB-CS16	JB-CS15	2-2/C#18	MAGNETIC CONTACT
					2-4/C#22	REX
					2-4/C#18	ELECTRICAL LOCK
					2-6/C#18TS	CARD READER
5K112	3/4"	ACCESS CONTROL	JB-CS14	JB-CS15	2-2/C#18	MAGNETIC CONTACT
					2-4/C#22	REX
					2-4/C#18	ELECTRICAL LOCK
					2-6/C#18TS	CARD READER
5K113	3/4"	ACCESS CONTROL	JB-C12	JB-CN03	1-2/C#18	MAGNETIC LOCK
					1-4/C#22	REX
					1-4/C#18	ELECTRIC LOCK
					1-6/C#18TS	CARD READER
5K114						

Santa Clara Valley Transportation Authority

NO EXCEPTIONS TAKEN (NET)

MAKE CORRECTIONS NOTED (MCN)

AMEND AND RESUBMIT (A/R)

Any action shown above is subject to the terms of the contract and does not relieve the Contractor of any of its obligations under the contract, including design and detailing.

Contract No.: DB11002F

By: _____ Date: _____

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Santa Clara Valley Transportation Authority

____ NO EXCEPTIONS TAKEN (NET)
____ MAKE CORRECTIONS NOTED (MCN)
____ AMEND AND RESUBMIT (A/R)

Any action shown above is subject to the terms of the contract
and does not relieve the Contractor of any of its obligations
under the contract, including design and detailing.

Contract No.: _____ DB11002F

By: _____ Date: _____

Jun 26, 2013

0

20130710

READINESS FOR CONSTRUCTION

REV

DATE

BY

SUB

APP

DESCRIPTION

DESIGNED BY
M. GOLUCKI

DRAWN BY
A. SHRODE

CHECKED BY
B. MENDEZ LORA

IN CHARGE
B. MENDEZ LORA

DATE
20130710

REGISTERED PROFESSIONAL
ELECTRICAL ENGINEER
BEAR 000

Jun 26, 2013 - 5:47pm C:\projects\wms\msh-estrate\lms\34735\700-S-DB-B884.dwg

CONDUIT		FOR	FROM	TO	CABLE	
ID	SIZE				SIZE	REMARKS
5K287	2 1/2"	TELEPHONE/NETWORK	JB-PN26	CAB 25-2	1-6PR#19 23-CAT6	FT PX, CT, ET & WAO
5K288	3/4"	TELEPHONE/NETWORK	JB-PN25	CAB 25-2	3-CAT6	PX & WAO
5K289	3/4"	TELEPHONE	JB-PN27	JB-PN26	2-CAT6	PX & ET
5K290	3/4"	TELEPHONE	CT-P2N01	JB-PN26	1-CAT6	CT
5K291	2 1/2"	TELEPHONE/NETWORK	JB-PN28	JB-PN26	1-6PR#19 20-CAT6	FT PX, CT, ET & WAO
5K292	3/4"	TELEPHONE	CT-P2N03	JB-PN28	1-CAT6	CT
5K293	3/4"	TELEPHONE	CT-P2N02	JB-PN28	1-CAT6	CT
5K294	2"	TELEPHONE/NETWORK	JB-PN29	JB-PN28	1-6PR#19 18-CAT6	FT PX, CT, ET & WAO
5K295	3/4"	TELEPHONE/NETWORK	JB-PN30	JB-PN29	3-CAT6	PX & WAO
5K296	2"	TELEPHONE/NETWORK	JB-PN31	JB-PN29	1-6PR#19 15-CAT6	FT PX, CT, ET & WAO
5K297	3/4"	TELEPHONE/NETWORK	JB-PN32	JB-PN31	3-CAT6	PX & WAO
5K298	3/4"	TELEPHONE/NETWORK	JB-PN33	JB-PN31	3-CAT6	PX & WAO
5K299	1 1/2"	TELEPHONE/NETWORK	JB-PN34	JB-PN31	1-6PR#19 9-CAT6	FT PX, CT, ET & WAO
5K300	3/4"	TELEPHONE/NETWORK	JB-PN35	JB-PN34	3-CAT6	PX & WAO
5K301	1 1/4"	TELEPHONE	JB-PN36	JB-PN34	1-6PR#19 6-CAT6	FT PX, CT & ET
5K302	3/4"	TELEPHONE	CT-P2N04	JB-PN36	1-CAT6	CT
5K303	3/4"	TELEPHONE	JB-PN37	JB-PN36	2-CAT6	PX & ET
5K304	1 1/4"	TELEPHONE	JB-PN38	JB-PN36	1-6PR#19 3-CAT6	FT PX, CT & ET
5K305	3/4"	TELEPHONE	JB-PN39	JB-PN38	2-CAT6	PX & ET
5K306	1"	TELEPHONE	JB-PN40	JB-PN38	1-6PR#19 1-CAT6	FT CT
5K307	3/4"	TELEPHONE	CT-P2N05	JB-PN40	1-CAT6	CT
5K308	1"	TELEPHONE	FT-P2N01	JB-PN40	1-6PR#19	FT
5K309	2"	TELEPHONE/NETWORK	JB-PS16	CAB 25-3	2-6PR#19 14-CAT6	FT PX, CT, ET & WAO
5K310	2 1/2"	TELEPHONE/NETWORK	JB-PN42	CAB 25-3	1-6PR#19 23-CAT6	FT PX, CT, ET & WAO
5K311	3/4"	TELEPHONE/NETWORK	JB-PN41	CAB 25-3	3-CAT6	PX & WAO
5K312	3/4"	TELEPHONE	JB-PN43	JB-PN42	3-CAT6	PX, ET & CT
5K313	3/4"	TELEPHONE	CT-P1N01	JB-PN43	1-CAT6	CT
5K314	2 1/2"	TELEPHONE/NETWORK	JB-PN44	JB-PN42	1-6PR#19 20-CAT6	FT PX, CT, ET & WAO
5K315	3/4"	TELEPHONE	CT-P1N02	JB-PN44	1-CAT6	CT
5K316	3/4"	TELEPHONE	CT-P1N03	JB-PN44	1-CAT6	CT
5K317	2"	TELEPHONE/NETWORK	JB-PN45	JB-PN44	1-6PR#19 18-CAT6	FT PX, CT, ET & WAO
5K318	3/4"	TELEPHONE/NETWORK	JB-PN46A	JB-PN45	3-CAT6	PX & WAO
5K319	2"	TELEPHONE/NETWORK	JB-PN46	JB-PN45	1-6PR#19 15-CAT6	FT PX, CT, ET & WAO
5K320	3/4"	TELEPHONE/NETWORK	JB-PN48	JB-PN46	3-CAT6	PX & WAO
5K321	3/4"	TELEPHONE/NETWORK	JB-PN47	JB-PN46	3-CAT6	PX & WAO
5K322	1 1/2"	TELEPHONE/NETWORK	JB-PN49	JB-PN46	1-6PR#19 9-CAT6	FT PX, CT, ET & WAO
5K323	3/4"	TELEPHONE/NETWORK	JB-PN50	JB-PN49	3-CAT6	PX & WAO
5K324	1 1/4"	TELEPHONE	JB-PN51	JB-PN49	1-6PR#19 6-CAT6	FT PX, CT & ET
5K325	3/4"	TELEPHONE	CT-P1N04	JB-PN51	1-CAT6	CT
5K326	3/4"	TELEPHONE	JB-PN52	JB-PN51	2-CAT6	PX & ET

CONDUIT		FOR	FROM	TO	CABLE	
ID	SIZE				SIZE	REMARKS
5K327	1 1/4"	TELEPHONE	JB-PN53	JB-PN51	1-6PR#19 3-CAT6	FT PX, CT & ET
5K328	3/4"	TELEPHONE	JB-PN54	JB-PN53	2-CAT6	PX & ET
5K329	1"	TELEPHONE	JB-PN55	JB-PN53	1-6PR#19 1-CAT6	FT CT
5K330	3/4"	TELEPHONE	CT-P1N05	JB-PN55	1-CAT6	CT
5K331	1"	TELEPHONE	FT-P1N01	JB-PN55	1-6PR#19	FT
5K332	1"	TELEPHONE	JB-PS07	JB-PS06	1-6PR#19 2-CAT6	FT PX & ET
5K333	2"	TELEPHONE/NETWORK	JB-PS08	JB-PS06	1-6PR#19 12-CAT6	FT PX, CT, ET & WAO
5K334	3/4"	TELEPHONE/NETWORK	JB-PS09	JB-PS08	3-CAT6	PX & WAO
5K335	1 1/2"	TELEPHONE	JB-PS10	JB-PS08	1-6PR#19 9-CAT6	FT PX, CT & ET
5K336	3/4"	TELEPHONE	JB-PS11A	JB-PS10	3-CAT6	PX, CT & ET
5K337	3/4"	TELEPHONE	CT-P2S01	JB-PS11A	1-CAT6	CT
5K338	1 1/4"	TELEPHONE	JB-PS11	JB-PS10	1-6PR#19 6-CAT6	FT PX, CT & ET
5K339	3/4"	TELEPHONE	JB-PS12	JB-PS11	3-CAT6	PX, CT & ET
5K340	3/4"	TELEPHONE	CT-P2S02	JB-PS12	1-CAT6	CT
5K341	1 1/4"	TELEPHONE	JB-PS13	JB-PS11	1-6PR#19 3-CAT6	FT PX, CT & ET
5K342	3/4"	TELEPHONE	JB-PS14	JB-PS13	2-CAT6	PX & ET
5K342A	1"	TELEPHONE	JB-PS15	JB-PS13	1-6PR#19 1-CAT6	FT CT
5K343	1"	TELEPHONE	JB-PS17	JB-PS16	1-6PR#19 2-CAT6	FT PX & ET
5K344	2"	TELEPHONE/NETWORK	JB-PS18	JB-PS16	1-6PR#19 12-CAT6	FT PX, CT, ET & WAO
5K345	3/4"	TELEPHONE/NETWORK	JB-PS19	JB-PS18	3-CAT6	PX & WAO
5K346	1 1/2"	TELEPHONE	JB-PS20	JB-PS18	1-6PR#19 9-CAT6	FT PX, CT & ET
5K347	3/4"	TELEPHONE	JB-PS21	JB-PS20	3-CAT6	PX, CT & ET
5K348	3/4"	TELEPHONE	CT-P1S01	JB-PS21	1-CAT6	CT
5K349	1 1/4"	TELEPHONE	JB-PS22	JB-PS20	1-6PR#19 6-CAT6	FT PX, CT & ET
5K350	3/4"	TELEPHONE	JB-PS23	JB-PS22	3-CAT6	PX, CT & ET
5K351	3/4"	TELEPHONE	CT-P1S02	JB-PS23	1-CAT6	CT
5K352	1 1/4"	TELEPHONE	JB-PS24	JB-PS22	1-6PR#19 3-CAT6	FT PX, CT & ET
5K353	3/4"	TELEPHONE	JB-PS25	JB-PS24	2-CAT6	PX & ET
5K354	1"	TELEPHONE	JB-PS26	JB-PS24	1-6PR#19 1-CAT6	FT CT
5K355	2"	PSTN	TELCO INTERFACE JB	TELCO ROOM	-	EMPTY WITH PULL STRING
5K356	2"	PSTN	TELCO INTERFACE JB	TELCO ROOM	-	EMPTY WITH PULL STRING

Santa Clara Valley Transportation Authority

NO EXCEPTIONS TAKEN (NET)

MAKE CORRECTIONS NOTED (MCN)

AMEND AND RESUBMIT (A/R)

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Contract No.: DB11002F

By: _____ Date: _____

DESIGNED BY
M. GOLUCKI

DRAWN BY
A. SHRODE

CHECKED BY
B. MENDEZ LORA

IN CHARGE
B. MENDEZ LORA

DATE
20130710

PROFESSIONAL
ENGINEER
E19639
EXP. 09-30-13
STATE OF CALIFORNIA

Skanska
Shimmick
Herzog

1436 California Circle
Milpitas, California 95035
A Joint Venture

LTK
LTK Engineering Services

SUBMITTED

Lookwood, Andrews
& Newnam, Inc.
A LEO A DALY COMPANY

APPROVED

T-Y LIN INTERNATIONAL

BART
SILICON VALLEY

BART SILICON VALLEY BERRYESSA EXTENSION

LINE, TRACK, STATIONS AND SYSTEMS
DESIGN UNIT 023
MILPITAS STATION
COMMUNICATION SYSTEMS
CONDUIT AND CABLE SCHEDULE
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NONE

CONTRACT NO.
C700

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SHEET NO.
B884

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CONDUIT		FOR	FROM	TO	CABLE	
ID	SIZE				SIZE	REMARKS
5K400	2"	CCTV	CTR#1	TCR	6-MMFO	
5K401	2"	CCTV	CTR#2	TCR	6-MMFO	
5K402	2"	CCTV	CTR#3	TCR	6-MMFO	
5K403	3/4"	CCTV	JB-CN30	CAB 95	1-CAT6	
5K404	3/4"	CCTV	TV-CN05	JB-CN30	1-CAT6	
5K405	1"	CCTV	JB-CN31	CAB 95	4-CAT6	
5K406	3/4"	CCTV	TV-CN06	JB-CN31	1-CAT6	
5K407	3/4"	CCTV	TV-CN08	JB-CN31	1-CAT6	
5K408	3/4"	CCTV	TV-CN01	JB-CN31	1-CAT6	
5K409	3/4"	CCTV	TV-CN03	JB-CN31	1-CAT6	
5K410	3/4"	CCTV	JB-CN32	CAB 95	2-CAT6	
5K411	3/4"	CCTV	TV-CN02	JB-CN32	1-CAT6	
5K412	3/4"	CCTV	JB-CN33	JB-CN32	1-CAT6	
5K413	3/4"	CCTV	TV-CN04	JB-CN33	1-CAT6	
5K414	1"	CCTV	JB-CS55	CTR#1	3-CAT6	
					2-2/C#18	
5K415	3/4"	CCTV	TV-CS20	JB-CS55	1-CAT6	
					1-2/C#18	
5K416	3/4"	CCTV	TV-CS18	JB-CS55	1-CAT6	
5K417	3/4"	CCTV	TV-CS22	JB-CS55	1-CAT6	
					1-2/C#18	
5K418	1"	CCTV	JB-CS56	CTR#1	4-CAT6	
					1-2/C#18	
5K419	3/4"	CCTV	TV-CS10	JB-CS56	1-CAT6	
5K420	3/4"	CCTV	JB-CS57	JB-CS56	3-CAT6	
					1-2/C#18	
5K421	3/4"	CCTV	TV-CS12	JB-CS57	1-CAT6	
5K422	3/4"	CCTV	JB-CS58	JB-CS57	2-CAT6	
					1-2/C#18	
5K423	3/4"	CCTV	TV-CS14	JB-CS58	1-CAT6	
					1-2/C#18	
5K424	3/4"	CCTV	TV-CS16	JB-CS58	1-CAT6	
5K425	1"	CCTV	JB-CS59	CTR#1	4-CAT6	
5K426	3/4"	CCTV	TV-GF01	JB-CS59	1-CAT6	
5K427	3/4"	CCTV	TV-GF02	JB-CS59	1-CAT6	
5K428	1 1/4"	CCTV	JB-CS68	CTR#1	4-CAT6	
					2-2/C#18	
5K429	3/4"	CCTV	TV-CS15	JB-CS68	1-CAT6	
					1-2/C#18	
5K430	3/4"	CCTV	TV-CS17	JB-CS68	1-CAT6	
5K431	3/4"	CCTV	JB-CS69	JB-CS68	2-CAT6	
					1-2/C#18	
5K432	3/4"	CCTV	TV-CS19	JB-CS69	1-CAT6	
					1-2/C#18	
5K433	3/4"	CCTV	TV-CS21	JB-CS69	1-CAT6	
5K434	2"	CCTV	JB-CS60	CTR#1	10-CAT6	
					4-2/C#18	
5K435	3/4"	CCTV	JB-CS61	JB-CS60	2-CAT6	
					1-2/C#18	
5K436	3/4"	CCTV	TV-CS02	JB-CS61	1-CAT6	
5K437	3/4"	CCTV	TV-CS04	JB-CS61	1-CAT6	
					1-2/C#18	
5K438	3/4"	CCTV	TV-CS06	JB-CS60	1-CAT6	
5K439	3/4"	CCTV	TV-CS08	JB-CS60	1-CAT6	
					1-2/C#18	

CONDUIT		FOR	FROM	TO	CABLE	
ID	SIZE				SIZE	REMARKS
5K440	1 1/4"	CCTV	JB-CS62	JB-CS60	6-CAT6	
					2-2/C#18	
5K440A	3/4"	CCTV	TV-CS07	JB-CS62	1-CAT6	
5K441	1 1/4"	CCTV	JB-CS63	JB-CS62	5-CAT6	
					2-2/C#18	
5K442	3/4"	CCTV	JB-CS67	JB-CS63	2-CAT6	
					1-2/C#18	
5K443						
5K444						
5K445	3/4"	CCTV	TV-CS03	JB-CS67	1-CAT6	
					1-2/C#18	
5K446	3/4"	CCTV	TV-CS01	JB-CS67	1-CAT6	
5K447	1"	CCTV	JB-CS64	JB-CS63	3-CAT6	
					1-2/C#18	
5K447A	3/4"	CCTV	TV-CS09	JB-CS64	1-CAT6	
5K448	3/4"	CCTV	JB-CS65	JB-CS64	2-CAT6	
					1-2/C#18	
5K449	3/4"	CCTV	TV-CS11	JB-CS65	1-CAT6	
					1-2/C#18	
5K450	3/4"	CCTV	TV-CS13	JB-CS65	1-CAT6	
5K451	1 1/2"	CCTV	JB-PN60	CTR#2	8-CAT6	
					5-2/C#18	
5K452	3/4"	CCTV	TV-P2N09	JB-PN60	1-CAT6	
5K453	3/4"	CCTV	TV-P2N08	JB-PN60	1-CAT6	
					1-2/C#18	
5K454	1 1/4"	CCTV	JB-PN61	JB-PN60	6-CAT6	
					4-2/C#18	
5K455	3/4"	CCTV	TV-P2N07	JB-PN61	1-CAT6	
					1-2/C#18	
5K456	1 1/4"	CCTV	JB-PN62	JB-PN61	5-CAT6	
					3-2/C#18	
5K457	3/4"	CCTV	TV-P2N06	JB-PN62	1-CAT6	
5K458	3/4"	CCTV	TV-P2N05	JB-PN62	1-CAT6	
5K459	3/4"	CCTV	TV-P2N04	JB-PN62	1-CAT6	
					1-2/C#18	
5K460	3/4"	CCTV	TV-P2N10	JB-PN62	1-CAT6	
5K461	3/4"	CCTV	JB-PN63	JB-PN62	1-CAT6	
					2-2/C#18	
5K462	3/4"	CCTV	TV-P2N03	JB-PN63	1-CAT6	
					1-2/C#18	
5K463	3/4"	CCTV	TV-PN64	JB-PN63	1-2/C#18	
5K463A	3/4"	CCTV	JB-PN64	ESC RM #2	2-CAT6	MEDIA CONVERTER
5K463B	1"	CCTV	ESC RM #2	CTR #2	6-MMFO	MEDIA CONVERTER

Santa Clara Valley Transportation Authority

NO EXCEPTIONS TAKEN (NET)

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Contract No.: DB11002F

By: _____ Date: _____

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CONDUIT		FOR	FROM	TO	CABLE	
ID	SIZE				SIZE	REMARKS
5K600	2"	PUBLIC ADDRESS	CTR #1	TCR	6-MMF	
5K601	2"	PUBLIC ADDRESS	CTR #2	TCR	6-MMF	
5K602	2"	PUBLIC ADDRESS	CTR #3	TCR	6-MMF	
5K603	3/4"	PUBLIC ADDRESS	SK-CN07	TCR	1-2/C#18	SPEAKER
5K604	3/4"	PUBLIC ADDRESS	SK-CN08	TCR	1-2/C#18	SPEAKER
5K605	1"	PUBLIC ADDRESS	JB-CN40	TCR	5-2/C#18	SPEAKERS
5K606	3/4"	PUBLIC ADDRESS	SK-CN01	JB-CN40	1-2/C#18	SPEAKER
5K607	3/4"	PUBLIC ADDRESS	SK-CN02	JB-CN40	1-2/C#18	SPEAKER
5K608	3/4"	PUBLIC ADDRESS	SK-CN03	JB-CN40	1-2/C#18	SPEAKER
5K609	3/4"	PUBLIC ADDRESS	JB-CN41	JB-CN40	2-2/C#18	SPEAKERS
5K610	3/4"	PUBLIC ADDRESS	SK-CN05	JB-CN41	1-2/C#18	SPEAKER
5K611	3/4"	PUBLIC ADDRESS	SK-CN06	JB-CN41	1-2/C#18	SPEAKER
5K612	3/4"	PUBLIC ADDRESS	JB-CN42	TCR	3-2/C#18	SPEAKERS & AMBIENT NOISE SENSOR
5K613	3/4"	PUBLIC ADDRESS	SK-CN09	JB-CN42	1-2/C#18	SPEAKER
5K614	3/4"	PUBLIC ADDRESS	ANS-CN01	JB-CN42	1-2/C#18	AMBIENT NOISE SENSOR
5K615	3/4"	PUBLIC ADDRESS	SK-CN10	JB-CN42	1-2/C#18	SPEAKER
5K616	2"	PUBLIC ADDRESS	JB-CS75	CTR #1	17-2/C#18	SPEAKERS & AMBIENT NOISE SENSOR
					2-CAT6	VMS
5K617	3/4"	PUBLIC ADDRESS	SK-CS35	JB-CS75	1-2/C#18	SPEAKER
5K618	1"	PUBLIC ADDRESS	JB-CS76	JB-CS75	5-2/C#18	SPEAKERS & AMBIENT NOISE SENSOR
5K619	3/4"	PUBLIC ADDRESS	SK-CS14	JB-CS76	1-2/C#18	SPEAKER
5K620	3/4"	PUBLIC ADDRESS	SK-CS15	JB-CS76	1-2/C#18	SPEAKER
5K621	3/4"	PUBLIC ADDRESS	SK-CS16	JB-CS76	1-2/C#18	SPEAKER
5K622	3/4"	PUBLIC ADDRESS	ANS-CS01	JB-CS76	1-2/C#18	AMBIENT NOISE SENSOR
5K623	3/4"	PUBLIC ADDRESS	SK-CS13	JB-CS76	1-2/C#18	SPEAKER
5K624	1 1/2"	PUBLIC ADDRESS	JB-CS77	JB-CS75	11-2/C#18	SPEAKERS
					2-CAT6	VMS
5K625						
5K626	3/4"	PUBLIC ADDRESS	VMS #1	JB-CS77	1-CAT6	VMS
5K627	3/4"	PUBLIC ADDRESS	SK-CS12	JB-CS78	1-2/C#18	SPEAKER
5K628	3/4"	PUBLIC ADDRESS	VMS #2	JB-CS78	1-CAT6	VMS
5K629	3/4"	PUBLIC ADDRESS	SK-CS11	JB-CS78	1-2/C#18	SPEAKER
5K630	3/4"	PUBLIC ADDRESS	SK-CS10	JB-CS78	1-2/C#18	SPEAKER
5K631	1 1/2"	PUBLIC ADDRESS	JB-CS78	JB-CS77	11-2/C#18	SPEAKERS
					1-CAT6	VMS
5K632	3/4"	PUBLIC ADDRESS	SK-CS09	JB-CS78	1-2/C#18	SPEAKER
5K633	3/4"	PUBLIC ADDRESS	SK-CS08	JB-CS78	1-2/C#18	SPEAKER
5K634	3/4"	PUBLIC ADDRESS	SK-CS07	JB-CS78	1-2/C#18	SPEAKER
5K635	1"	PUBLIC ADDRESS	JB-CS80	JB-CS79	5-2/C#18	SPEAKERS
5K636	3/4"	PUBLIC ADDRESS	SK-CS05	JB-CS80	1-2/C#18	SPEAKER
5K637	3/4"	PUBLIC ADDRESS	SK-CS04	JB-CS80	1-2/C#18	SPEAKER
5K638	3/4"	PUBLIC ADDRESS	SK-CS03	JB-CS80	1-2/C#18	SPEAKER
5K639	3/4"	PUBLIC ADDRESS	JB-CS81	JB-CS80	2-2/C#18	SPEAKER
5K640	3/4"	PUBLIC ADDRESS	SK-CS02	JB-CS81	1-2/C#18	SPEAKER
5K641	3/4"	PUBLIC ADDRESS	SK-CS01	JB-CS81	1-2/C#18	SPEAKER
5K642	1"	PUBLIC ADDRESS	JB-CS82	CTR #1	4-2/C#18	SPEAKERS
5K643	3/4"	PUBLIC ADDRESS	SK-CS17	JB-CS82	1-2/C#18	SPEAKER
5K644	3/4"	PUBLIC ADDRESS	SK-CS18	JB-CS82	1-2/C#18	SPEAKER
5K645	3/4"	PUBLIC ADDRESS	SK-CS19	JB-CS82	1-2/C#18	SPEAKER
5K646	3/4"	PUBLIC ADDRESS	JB-CS83	JB-CS82	1-2/C#18	SPEAKER
5K647	3/4"	PUBLIC ADDRESS	SK-CS20	JB-CS83	1-2/C#18	SPEAKER
5K648	2"	PUBLIC ADDRESS	JB-CS84	CTR #1	18-2/C#18	SPEAKERS
					1-CAT6	VMS
5K649	1"	PUBLIC ADDRESS	JB-CS85	JB-CS84	4-2/C#18	SPEAKERS

CONDUIT		FOR	FROM	TO	CABLE	
ID	SIZE				SIZE	REMARKS
5K650	3/4"	PUBLIC ADDRESS	SK-CS36	JB-CS85	1-2/C#18	SPEAKER
5K651	3/4"	PUBLIC ADDRESS	SK-CS37	JB-CS85	1-2/C#18	SPEAKER
5K652	3/4"	PUBLIC ADDRESS	SK-CS38	JB-CS85	1-2/C#18	SPEAKER
5K653	3/4"	PUBLIC ADDRESS	JB-CS86	JB-CS85	1-2/C#18	SPEAKER
5K654	3/4"	PUBLIC ADDRESS	SK-CS39	JB-CS86	1-2/C#18	SPEAKER
5K655	3/4"	PUBLIC ADDRESS	SK-CS06	JB-CS84	1-2/C#18	SPEAKER
5K656	2"	PUBLIC ADDRESS	JB-CS87	JB-CS84	13-2/C#18	SPEAKERS
					1-CAT6	VMS
5K657	3/4"	PUBLIC ADDRESS	SK-CS32	JB-CS87	1-2/C#18	SPEAKER
5K658	3/4"	PUBLIC ADDRESS	SK-CS33	JB-CS87	1-2/C#18	SPEAKER
5K659	3/4"	PUBLIC ADDRESS	SK-CS34	JB-CS87	1-2/C#18	SPEAKER
5K660						
5K661	1 1/2"	PUBLIC ADDRESS	JB-CS88	JB-CS87	10-2/C#18	SPEAKERS
					1-CAT6	VMS
5K662	3/4"	PUBLIC ADDRESS	SK-CS29	JB-CS88	1-2/C#18	SPEAKER
5K663	3/4"	PUBLIC ADDRESS	SK-CS30	JB-CS88	1-2/C#18	SPEAKER
5K664	3/4"	PUBLIC ADDRESS	VMS #3	JB-CS88	1-CAT6	VMS
5K665	3/4"	PUBLIC ADDRESS	SK-CS27	JB-CS88	1-2/C#18	SPEAKER
5K666	3/4"	PUBLIC ADDRESS	SK-CS26	JB-CS88	1-2/C#18	SPEAKER
5K667	3/4"	PUBLIC ADDRESS	SK-CS25	JB-CS88	1-2/C#18	SPEAKER
5K668	3/4"	PUBLIC ADDRESS	SK-CS28	JB-CS88	1-2/C#18	SPEAKER
5K669	1"	PUBLIC ADDRESS	JB-CS89	JB-CS88	4-2/C#18	SPEAKERS
5K670	3/4"	PUBLIC ADDRESS	SK-CS21	JB-CS89	1-2/C#18	SPEAKER
5K671	3/4"	PUBLIC ADDRESS	SK-CS22	JB-CS89	1-2/C#18	SPEAKER
5K672	3/4"	PUBLIC ADDRESS	SK-CS23	JB-CS89	1-2/C#18	SPEAKER
5K673	3/4"	PUBLIC ADDRESS	SK-CS24	JB-CS89	1-2/C#18	SPEAKER
5K674	1 1/4"	PUBLIC ADDRESS	SK-P2N29	CTR #2	2-2/C#18	SPEAKERS
5K675	1 1/4"	PUBLIC ADDRESS	SK-P2N28	SK-P2N29	2-2/C#18	SPEAKERS
5K676	1"	PUBLIC ADDRESS	SK-P2N27	SK-P2N28	2-2/C#18	SPEAKERS
5K677	1"	PUBLIC ADDRESS	SK-P2N26	SK-P2N27	2-2/C#18	SPEAKERS
5K678	3/4"	PUBLIC ADDRESS	SK-P2N25	SK-P2N26	2-2/C#18	SPEAKERS
5K679	3/4"	PUBLIC ADDRESS	SK-P2N24	SK-P2N25	2-2/C#18	SPEAKERS
5K680	3/4"	PUBLIC ADDRESS	SK-P2N23	SK-P2N24	1-2/C#18	SPEAKERS
5K681	2 1/2"	PUBLIC ADDRESS	SLPA-P2	CTR #2	2-2/C#18	SPEAKERS
5K681A	2 1/2"	PUBLIC ADDRESS	SLPA-P2	CTR #2	2-2/C#18	SPEAKERS
5K682	3/4"	PUBLIC ADDRESS	JB-PS51	JB-PS50	4-2/C#18	SPEAKERS
5K683	3/4"	PUBLIC ADDRESS	SK-P2S21	JB-PS51	2-2/C#18	SPEAKERS
5K684	3/4"	PUBLIC ADDRESS	SK-P2S22	JB-PS51	2-2/C#18	SPEAKERS
5K685	3/4"	PUBLIC ADDRESS	SK-P2S23	JB-PS54	1-2/C#18	SPEAKERS
5K686	3/4"	PUBLIC ADDRESS	JB-PN81	JB-PN80	4-2/C#18	SPEAKERS
5K687	3/4"	PUBLIC ADDRESS	SK-P2N22	JB-PN81	2-2/C#18	SPEAKERS
5K688	3/4"	PUBLIC ADDRESS	SK-P2N21	JB-PN81	2-2/C#18	SPEAKERS
5K689	3/4"	PUBLIC ADDRESS	SK-P2N30	JB-PN82	1-2/C#18	SPEAKERS
5K690	1 1/4"	PUBLIC ADDRESS	SK-P1N29	CTR #3	2-2/C#18	SPEAKERS
5K691	1 1/4"	PUBLIC ADDRESS	SK-P1N28	SK-P1N29	2-2/C#18	SPEAKERS
5K692	1"	PUBLIC ADDRESS	SK-P1N27	SK-P1N28	2-2/C#18	SPEAKERS
5K693	1"	PUBLIC ADDRESS	SK-P1N26	SK-P1N27	2-2/C#18	SPEAKERS

Santa Clara Valley Transportation Authority

NO EXCEPTIONS TAKEN (NET)

MAKE CORRECTIONS NOTED (MCN)

AMEND AND RESUBMIT (A/R)

Any action shown above is subject to the terms of the contract and does not relieve the Contractor of any of its obligations under the contract, including design and detailing.

Contract No.: DBJ1002F

By: _____ Date: _____

DESIGNED BY
M. GOLUCKI

DRAWN BY
A. SHRODE

CHECKED BY
B. MENDEZ LORA

IN CHARGE
B. MENDEZ LORA

DATE
20130710

REVISIONS

0	20130710				READINESS FOR CONSTRUCTION
REV	DATE	BY	SUB	APP	DESCRIPTION

PROFESSIONAL SEAL

REGISTERED ELECTRICAL ENGINEER

STATE OF CALIFORNIA

EXP. 09-30-13

Skanska Shimmick Herzog

1436 California Circle
Milpitas, California 95035
A Joint Venture

LTK

LTK Engineering Services

SUBMITTED

Lookwood, Andrews & Newnam, Inc.

A LEO A DALY COMPANY

T-Y LIN INTERNATIONAL

APPROVED

BART SILICON VALLEY BERRYESSA EXTENSION

LINE, TRACK, STATIONS AND SYSTEMS

DESIGN UNIT 023

MILPITAS STATION

COMMUNICATION SYSTEMS

CONDUIT AND CABLE SCHEDULE

SHEET 8 OF 9

CADD FILENAME
C700-S-DB-B887.dwg

SIZE | SCALE
D NONE

CONTRACT NO.
C700

REV.
0

AREA CODE
DB

SHEET NO.
B887


PAGE NO.
1078

1. REFER TO RISER DIAGRAMS AND CONDUIT SCHEDULES FOR ROUTING DETAILS AND REQUIREMENTS.



The map shows the Milpitas Station area. A north arrow is in the top left corner. A red shaded area indicates the project area. The map includes the following labels: RN, ANCILLARY BLDG, MILPITAS POC, MONTAGUE LRT, BUS TRANSIT SHELTER, and MILPITAS STATION. The map also shows a line with points A, P2, and P4, and a line with points P2 and P4.

Jun 21, 2013 - 9:00am 0						DESIGNED BY M. GOLUCKI
						DRAWN BY B. COOPER
						CHECKED BY B. MENDEZ LORA
						IN CHARGE B. MENDEZ LORA
	0	20130710			READINESS FOR CONSTRUCTION	DATE 20130710
REV	DATE	BY	SUB	APP	DESCRIPTION	

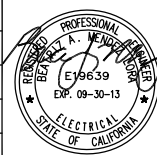

Skanska
Shimmick
Herzog

1436 California Circle
Milpitas, California 95035
A Joint Venture

LTK
LTK Engineering Services

LAN Lockwood, Andrew
& Newnam, Inc.
A LEO A DALY COMPANY

T-Y-LIN INTERNATIONAL




BART SILICON VALLEY BERRYESSA EXTENSION

LINE, TRACK, STATIONS AND SYSTEMS
DESIGN UNIT 023
MILPITAS STATION
POC
COMMUNICATIONS EQUIPMENT LAYOUT
GROUND LEVEL PLAN

CADD FILENAME C700-S-DB-B911.dwg		
SIZE D	SCALE 1/8"=1'-0"	
CONTRACT NO. C700		REV. 0
AREA CODE DB	SHEET NO. B911	PAGE NO. 1080



NOTE:
1. REFER TO RISER DIAGRAMS AND CONDUIT SCHEDULES FOR ROUTING DETAILS AND REQUIREMENTS.

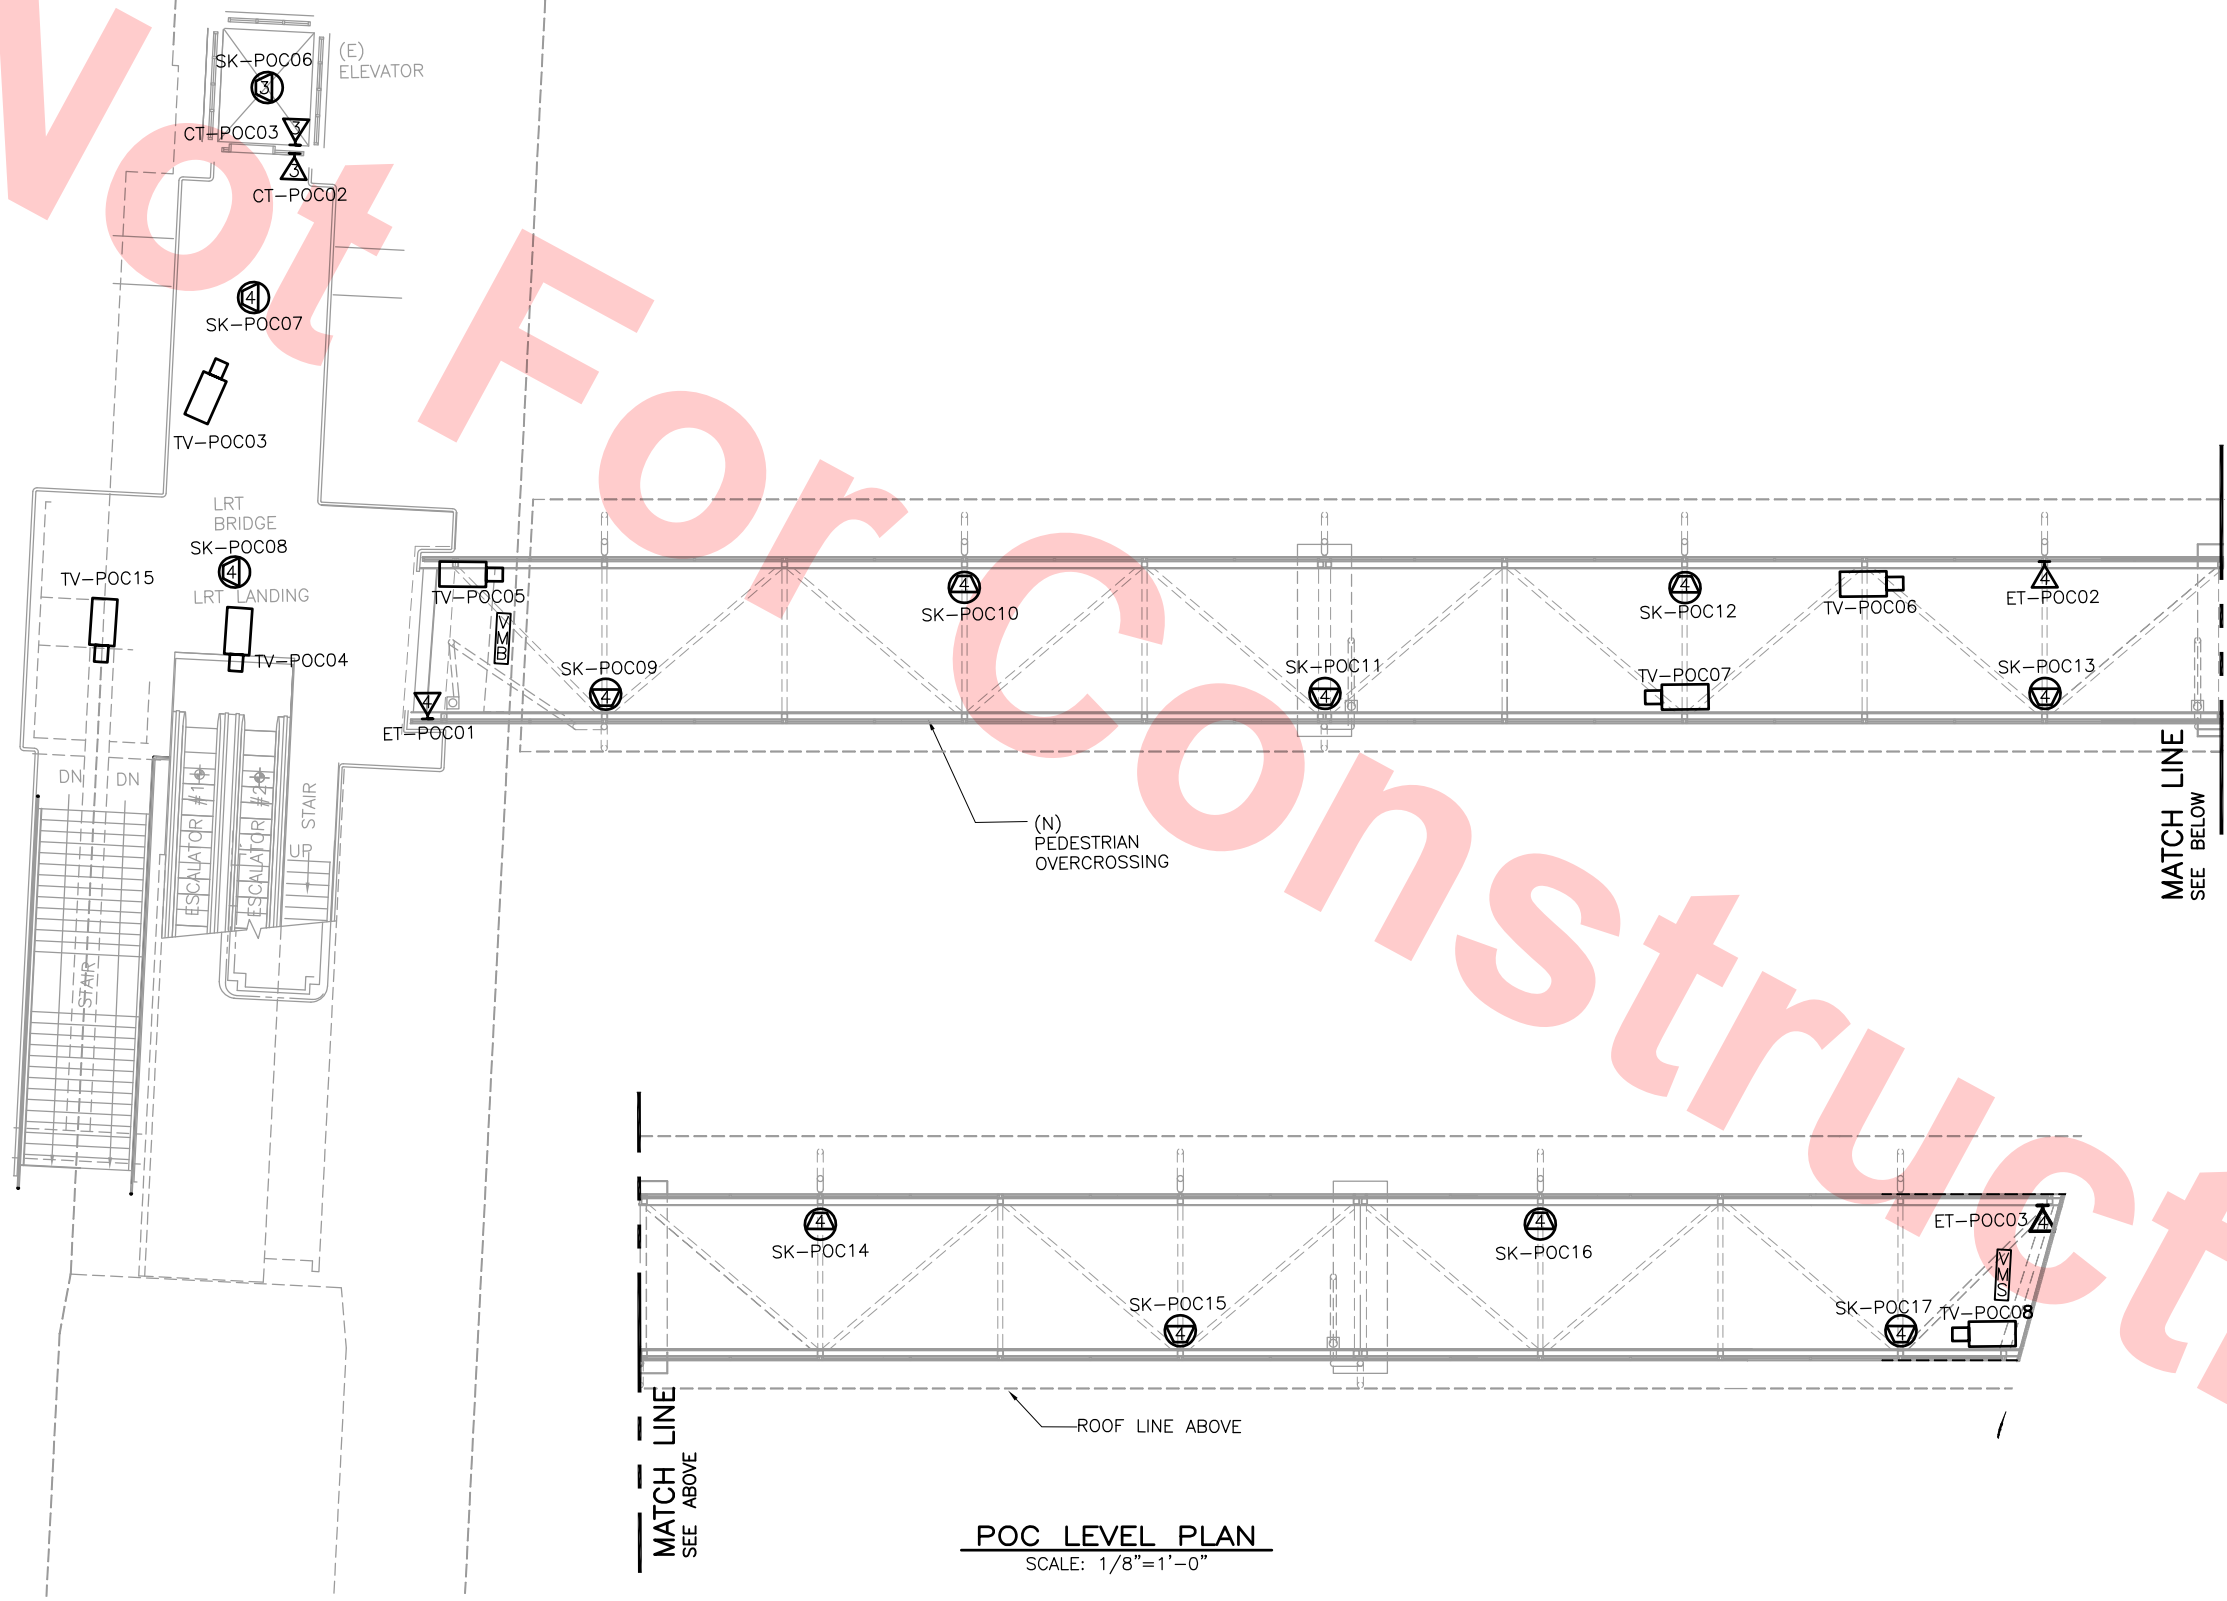


Santa Clara Valley Transportation Authority

NO EXCEPTIONS TAKEN (NET)
MAKE CORRECTIONS NOTED (MCN)
AMEND AND RESUBMIT (A/R)


Any action shown above is subject to the terms of the contract and does not relieve the Contractor of any of its obligations under the contract, including design and detailing.

Contract No.: DB11002F

By: _____ Date: _____

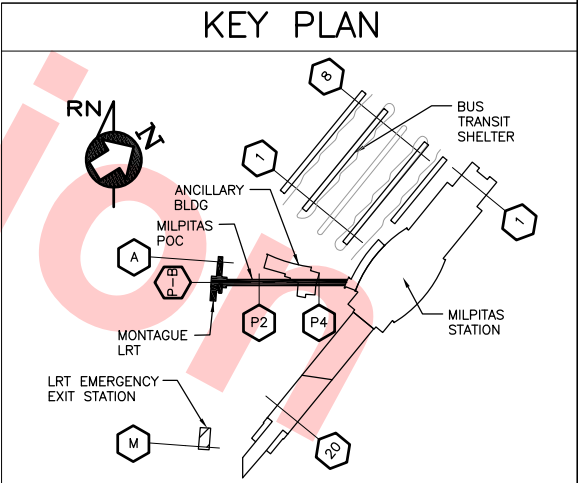

DESIGNED BY M. GOLUCKI	0	20130710	BY	SUB	APP	READINESS FOR CONSTRUCTION
DRAWN BY B. COOPER	REV	DATE	BY	SUB	APP	DESCRIPTION
CHECKED BY B. MENDEZ LORA						
IN CHARGE B. MENDEZ LORA						
DATE 20130710						

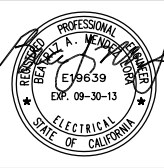

Skanska
Shimmick
Herzog

1436 California Circle
Milpitas, California 95035
A Joint Venture

LTK
LTK Engineering Services

SUBMITTED

Lookwood, Andrews & Nowman, Inc.
A JOINT VENTURE

T-Y LIN INTERNATIONAL


APPROVED

BART
SILICON VALLEY

BART SILICON VALLEY BERRYESSA EXTENSION

LINE, TRACK, STATIONS AND SYSTEMS
DESIGN UNIT 023
MILPITAS STATION
POC
COMMUNICATIONS EQUIPMENT LAYOUT
BRIDGE LEVEL PLAN

CADD FILENAME C700-S-DB-B912.dwg	REV. 0
SIZE SCALE D 1/8"=1'-0"	
CONTRACT NO. C700	
AREA CODE DB	SHEET NO. B912
	PAGE NO. 1081

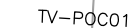

MATCH LINE
SEE ABOVE

-POC ROOF

POC ROOF

SCALE: 1/8"=1'-0"

By: _____ **Date:** _____


1. REFER TO RISER DIAGRAMS AND CONDUIT SCHEDULES FOR ROUTING DETAILS AND REQUIREMENTS.

MATCH 1
SEE BELOW



GRAPHIC SCALE

DESIGNED BY	M. GOLUCKI
DRAWN BY	B. COOPER
CHECKED BY	B. MENDEZ LORA
IN CHARGE	B. MENDEZ LORA
DATE	20130710

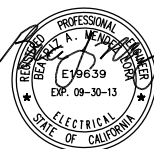

LTK
LTK Engineering Services

LAN Lockwood, Andrew
& Newnam, Inc.
A LEO A DALY COMPANY

APPROVED K. Volkmuth



LINE, TRACK, STATIONS AND SYSTEMS
DESIGN UNIT 023
MILPITAS STATION
POC
COMMUNICATIONS EQUIPMENT LAYOUT
LRT PLATFORM LEVEL PLAN

CADD FILENAME C700-S-DB-B913.dwg		
SIZE D	SCALE 1/8"=1'-0"	
CONTRACT NO. C700		REV. 0
AREA CODE DB	SHEET NO. B913	PAGE NO. 1082

CONDUIT		FOR	FROM	TO	CABLE	
ID	SIZE				SIZE	REMARKS
5K1000	2"	PUBLIC ADDRESS	JB-VTA1	VTA COMM RM	3-2/C#18	SPEAKERS
5K1001	3/4"	PUBLIC ADDRESS	SK-POC18	JB-VTA1	1-2/C#18	SPEAKERS
5K1002	3/4"	PUBLIC ADDRESS	SK-POC19	JB-VTA1	2-2/C#18	SPEAKERS
5K1003	3/4"	PUBLIC ADDRESS	SK-POC20	SK-POC19	1-2/C#18	SPEAKERS
5K1004	3/4"	PUBLIC ADDRESS	SK-POC17	JB-VTA2	2-2/C#18	SPEAKERS
5K1005	3/4"	PUBLIC ADDRESS	SK-POC16	JB-VTA2	2-2/C#18	SPEAKERS
5K1006	3/4"	PUBLIC ADDRESS	SK-POC15	JB-VTA2	2-2/C#18	SPEAKERS
5K1007	3/4"	PUBLIC ADDRESS	JB-VTA3	JB-VTA2	2-2/C#18	SPEAKERS
					1-CAT6	VMB
5K1008	3/4"	PUBLIC ADDRESS	SK-POC14	JB-VTA3	2-2/C#18	SPEAKERS
5K1009	3/4"	PUBLIC ADDRESS	SK-POC13	JB-VTA3	2-2/C#18	SPEAKERS
5K1010	3/4"	PUBLIC ADDRESS	SK-POC12	JB-VTA3	2-2/C#18	SPEAKERS
5K1011	3/4"	PUBLIC ADDRESS	JB-VTA4	JB-VTA3	2-2/C#18	SPEAKERS
					1-CAT6	VMB
5K1011A	3/4"	PUBLIC ADDRESS	SK-POC11	JB-VTA4	2-2/C#18	SPEAKERS
5K1012	3/4"	PUBLIC ADDRESS	SK-POC09	JB-VTA4	1-1/C#18	SPEAKERS
5K1013	3/4"	PUBLIC ADDRESS	VMB	JB-VTA4	1-CAT6	VMB
5K1014	3/4"	PUBLIC ADDRESS	SK-POC10	JB-VTA4	2-2/C#18	SPEAKERS
5K1015	1"	PUBLIC ADDRESS	JB-VTA5	LRT COMM RM	5-2/C#18	SPEAKERS
5K1016	3/4"	PUBLIC ADDRESS	SK-POC03	JB-VTA5	1-2/C#18	SPEAKERS
5K1017	3/4"	PUBLIC ADDRESS	SK-POC02	JB-VTA5	2-2/C#18	SPEAKERS
5K1018	3/4"	PUBLIC ADDRESS	SK-POC01	SK-POC02	1-2/C#18	SPEAKERS
5K1019	3/4"	PUBLIC ADDRESS	SK-POC04	JB-VTA5	2-2/C#18	SPEAKERS
5K1020	3/4"	PUBLIC ADDRESS	SK-POC05	SK-POC04	1-2/C#18	SPEAKERS
5K1021	3/4"	PUBLIC ADDRESS	JB-VTA6	LRT COMM RM	3-2/C#18	SPEAKERS
5K1022	3/4"	PUBLIC ADDRESS	SK-POC08	JB-VTA6	1-2/C#18	SPEAKERS
5K1023	3/4"	PUBLIC ADDRESS	SK-POC07	JB-VTA6	2-2/C#18	SPEAKERS
5K1024	3/4"	PUBLIC ADDRESS	SK-POC06	SK-POC07	1-2/C#18	SPEAKERS
5K1025	3/4"	PUBLIC ADDRESS	SK-TC09	VTA COMM CAB	3-2/C#18	SPEAKERS
5K1026	3/4"	PUBLIC ADDRESS	SK-TC08	SK-TC09	1-2/C#18	SPEAKERS
5K1027	3/4"	PUBLIC ADDRESS	SK-TC10	SK-TC09	2-2/C#18	SPEAKERS
5K1028	3/4"	PUBLIC ADDRESS	SK-TC11	SK-TC10	1-2/C#18	SPEAKERS
5K1029	3/4"	PUBLIC ADDRESS	SK-TC13	VTA COMM CAB	3-2/C#18	SPEAKERS
5K1030	3/4"	PUBLIC ADDRESS	SK-TC12	SK-TC13	1-2/C#18	SPEAKERS
5K1031	3/4"	PUBLIC ADDRESS	SK-TC14	SK-TC13	2-2/C#18	SPEAKERS
5K1032	3/4"	PUBLIC ADDRESS	SK-TC15	SK-TC14	1-2/C#18	SPEAKERS
5K1033	3/4"	PUBLIC ADDRESS	SK-TC05	VTA COMM CAB	3-2/C#18	SPEAKERS
5K1034	3/4"	PUBLIC ADDRESS	SK-TC04	SK-TC05	1-2/C#18	SPEAKERS
5K1035	3/4"	PUBLIC ADDRESS	SK-TC06	SK-TC05	2-2/C#18	SPEAKERS
5K1036	3/4"	PUBLIC ADDRESS	SK-TC07	SK-TC06	1-2/C#18	SPEAKERS
5K1037	3/4"	PUBLIC ADDRESS	SK-TC02	VTA COMM CAB	2-2/C#18	SPEAKERS
5K1038	3/4"	PUBLIC ADDRESS	SK-TC01	SK-TC02	2-2/C#18	SPEAKERS
5K1039	3/4"	PUBLIC ADDRESS	SK-TC03	SK-TC02	1-2/C#18	SPEAKERS
5K1040	3/4"	TELEPHONE	PX-POC03	JB-VTA7	1-6PR#24	BUS OPERATOR PHONE
5K1041	3/4"	TELEPHONE	ET-POC04	JB-VTA7	1-6PR#24	BIKE STORAGE AREA ET
5K1042	3/4"	TELEPHONE	JB-VTA8	JB-VTA7	3-6PR#24	ET PHONES
5K1043	3/4"	TELEPHONE	ET-POC03	JB-VTA8	1-6PR#24	ET POC
5K1044	3/4"	TELEPHONE	JB-VTA9	JB-VTA8	2-6PR#24	ET PHONES
5K1045	3/4"	TELEPHONE	ET-POC02	JB-VTA9	1-6PR#24	ET POC
5K1046	3/4"	TELEPHONE	ET-POC01	JB-VTA9	1-6PR#24	ET POC
5K1047	3/4"	TELEPHONE	JB-VTA10	LRT COMM RM	4-6PR#24	COURTESY PHONES
5K1048	3/4"	TELEPHONE	CT-POC03	JB-VTA10	1-6PR#24	CT
5K1049	3/4"	TELEPHONE	CT-POC01	JB-VTA10	1-6PR#24	CT
5K1050	3/4"	TELEPHONE	CT-POC02	JB-VTA10	1-6PR#24	CT
5K1051	3/4"	TELEPHONE	CT-POC04	JB-VTA10	1-6PR#24	CT
5K1052	3/4"	TELEPHONE	ET-TC01	VTA COMM CAB	1-6PR#24	ET

CONDUIT		FOR	FROM	TO	CABLE	
ID	SIZE				SIZE	REMARKS
5K1053	3/4"	TELEPHONE	JB-VTA13	VTA COMM CAB	2-6PR#24	ET
5K1054	3/4"	TELEPHONE	ET-TC02	JB-VTA13	1-6PR#24	ET
5K1055	3/4"	TELEPHONE	ET-TC03	JB-VTA13	1-6PR#24	ET
5K1056	1"	TELEPHONE & NETWORK	JB-VTA12	VTA COMM RM	2-6PR#24	PHONES & WAO
					4-CAT6	
5K1057	3/4"	TELEPHONE	PX-POC02	JB-VTA12	1-6PR#24	VTA PHONE
5K1058	3/4"	NETWORK	WO-POC02	JB-VTA12	2-CAT6	VTA WAO
5K1059	3/4"	TELEPHONE & NETWORK	JB-VTA11	JB-VTA12	1-6PR#24	PHONES & WAO
					2-CAT6	
5K1060	3/4"	TELEPHONE	PX-POC01	JB-VTA11	1-6PR#24	VTA PHONE
5K1061	3/4"	NETWORK	WO-POC01	JB-VTA11	2-CAT6	VTA WAO
					2-4/C#22	REX
5K1062	1"	ACCESS CONTROL	JB-VTA14	VTA COMM RM	2-2/C#18	MAGNETIC CONTACT
					2-4/C#18	ELECTRIC LOCK
					2-6/C#18	CARD READER
5K1063						
					1-4/C#22	REX
5K1064	3/4"	ACCESS CONTROL	JB-VTA16	JB-VTA14	1-2/C#18	MAGNETIC CONTACT
					1-4/C#18	ELECTRIC LOCK
					1-6/C#18	CARD READER
					1-4/C#22	REX
5K1065	3/4"	ACCESS CONTROL	JB-VTA17	JB-VTA14	1-2/C#18	MAGNETIC CONTACT
					1-4/C#18	ELECTRIC LOCK
					1-6/C#18	CARD READER
					1-4/C#22	REX
5K1066	3/4"	ACCESS CONTROL	JB-VTA18	JB-VTA17	1-2/C#18	MAGNETIC CONTACT
					1-4/C#18	ELECTRIC LOCK
					1-6/C#18	CARD READER
5K1067	3/4"	CCTV	TV-POC08	JB-VTA19	1-CAT6	
					1-2/C#18	
5K1068	1 1/4"	CCTV	JB-VTA20	JB-VTA19	3-CAT6	
					3-2/C#18	
5K1069	3/4"	CCTV	TV-POC06	JB-VTA20	1-CAT6	
					1-2/C#18	
5K1070	3/4"	CCTV	TV-POC07	JB-VTA20	1-CAT6	
					1-2/C#18	
5K1071	3/4"	CCTV	TV-POC05	JB-VTA20	1-CAT6	
					1-2/C#18	
5K1072	1 1/4"	CCTV	JB-VTA21	VTA COMM RM	3-CAT6	
					3-2/C#18	
5K1073	3/4"	CCTV	TV-POC13	JB-VTA21	1-CAT6	
					1-2/C#18	

Santa Clara Valley Transportation Authority


☐ NO EXCEPTIONS TAKEN (NET)
☐ MAKE CORRECTIONS NOTED (MCN)
☐ AMEND AND RESUBMIT (A/R)

Any action shown above is subject to the terms of the contract and does not relieve the Contractor of any of its obligations under the contract, including design and detailing.

Contract No.: DB11002F

By: _____ **Date:** _____

						DESIGNED BY M. GOLUCKI
						DRAWN BY A. SHRODE
						CHECKED BY B. MENDEZ LORA
						IN CHARGE B. MENDEZ LORA
0	20130710				READINESS FOR CONSTRUCTION	DATE 20130710
REV	DATE	BY	SUB	APP	DESCRIPTION	

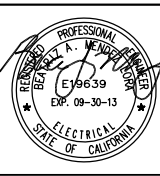

Skanska
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Herzog

LTK
LTK Engineering Services

SUBMITTED *[Signature]*

Skanska
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1436 California Circle
Milpitas, California 95035
A Joint Venture



T-Y-LIN INTERNATIONAL
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LINE, TRACK, STATIONS AND SYSTEMS
DESIGN UNIT 023
MILPITAS STATION
VTA COMMUNICATION SYSTEMS
CONDUIT AND CABLE SCHEDULE
SHEET 1 OF 2

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