

THESE DRAWINGS/DOCUMENTS HEREIN ATTACHED ARE THE PROPERTY OF BERGELECTRIC CORPORATION ANY REUSE OR REPRODUCTION OF THESE DOCUMENTS WITHOUT WRITTEN PERMISSION OF BERGELECTRIC CORPORATION IS STRICTLY FORBIDDEN. ALL RIGHTS RESERVED.

J.RAMIREZ

DESIGN SUPERVISOR:

INSTALL SUPERVISOR: Scott Adams Tel Data Systems Bergelectric Corporation 650 Opper Street Escondido, CA 92029

05-30-12 RECORD DRAWINGS

SHEET TITLE:


TELECOM FLOOR PLAN LEVEL 1 OVERALL

KEY PLAN

SCALE: 1/16"=1'0"

T3.1

RECORD DRAWING

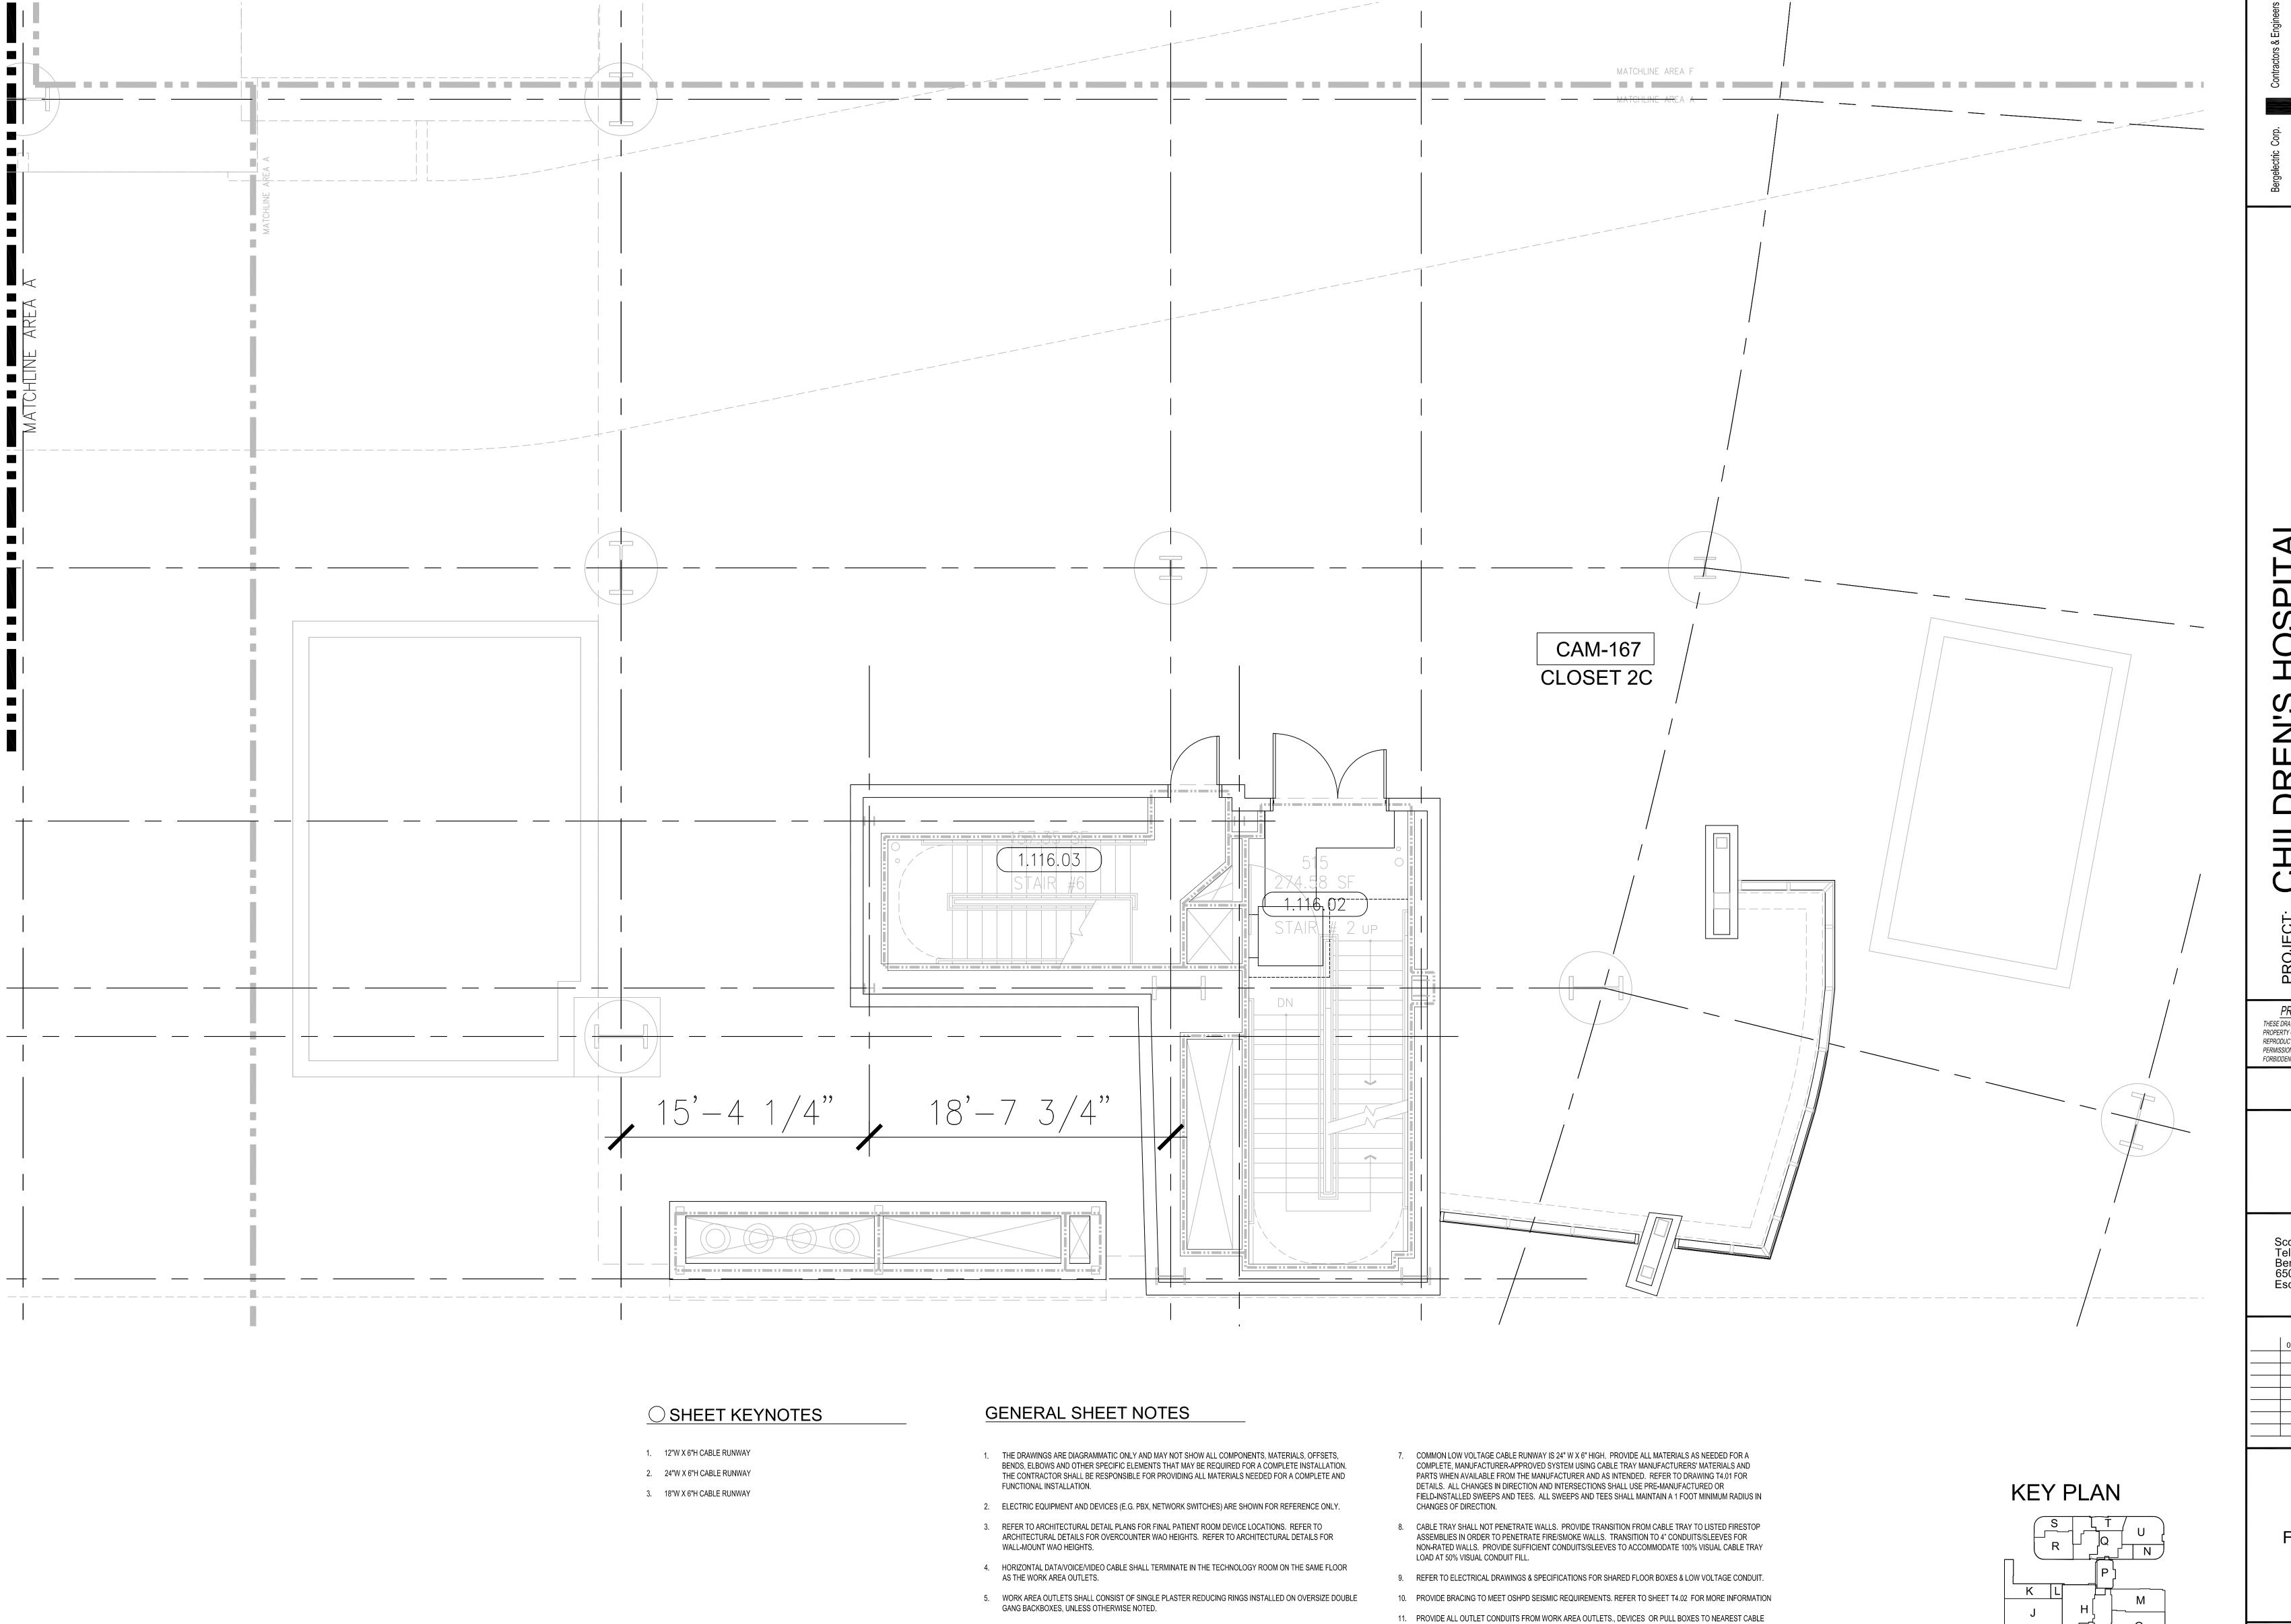

6. TV COAX CABLES SHALL BE COILED IN THE RESPECTIVE TECHNOLOGY ROOMS WITH A 20' SERVICE LOOP PRIOR

12. INSTALL CABLE TRAY @ 6" ABOVE CEILING.

TO TERMINATIONS. COILS SHALL BE SECURED TO THE AUDIOVISUAL WALL FIELD FOR AV CONTRACTOR.

ergelectric Corp.

Contractors & Engineers

10-#85046

(760) 746-1003

LDREN'S HOSPITAL ORANGE COUNTY - TOWER

PROPRIETARY STATEMINESE DRAWINGS/DOCUMENTS HEREIN ATTACK

THESE DRAWINGS/DOCUMENTS HEREIN ATTACHED ARE THE PROPERTY OF BERGELECTRIC CORPORATION ANY REUSE OR REPRODUCTION OF THESE DOCUMENTS WITHOUT WRITTEN PERMISSION OF BERGELECTRIC CORPORATION IS STRICTLY FORBIDDEN. ALL RIGHTS RESERVED.

DRAWN BY:
J.RAMIREZ

DESIGN SUPERVISOR:

INSTALL SUPERVISOR:
Scott Adams
Tel Data Systems
Bergelectric Corporation
650 Opper Street
Escondido, CA 92029

REVISION:

05-30-12 RECORD DRAWINGS


SHEET TITLE:

TELECOM FLOOR PLAN LEVEL 1 AREA-A

> SCALE: 1/4"=1'0"

DRAWING NO. :


T3.1A RECORD DRAWING

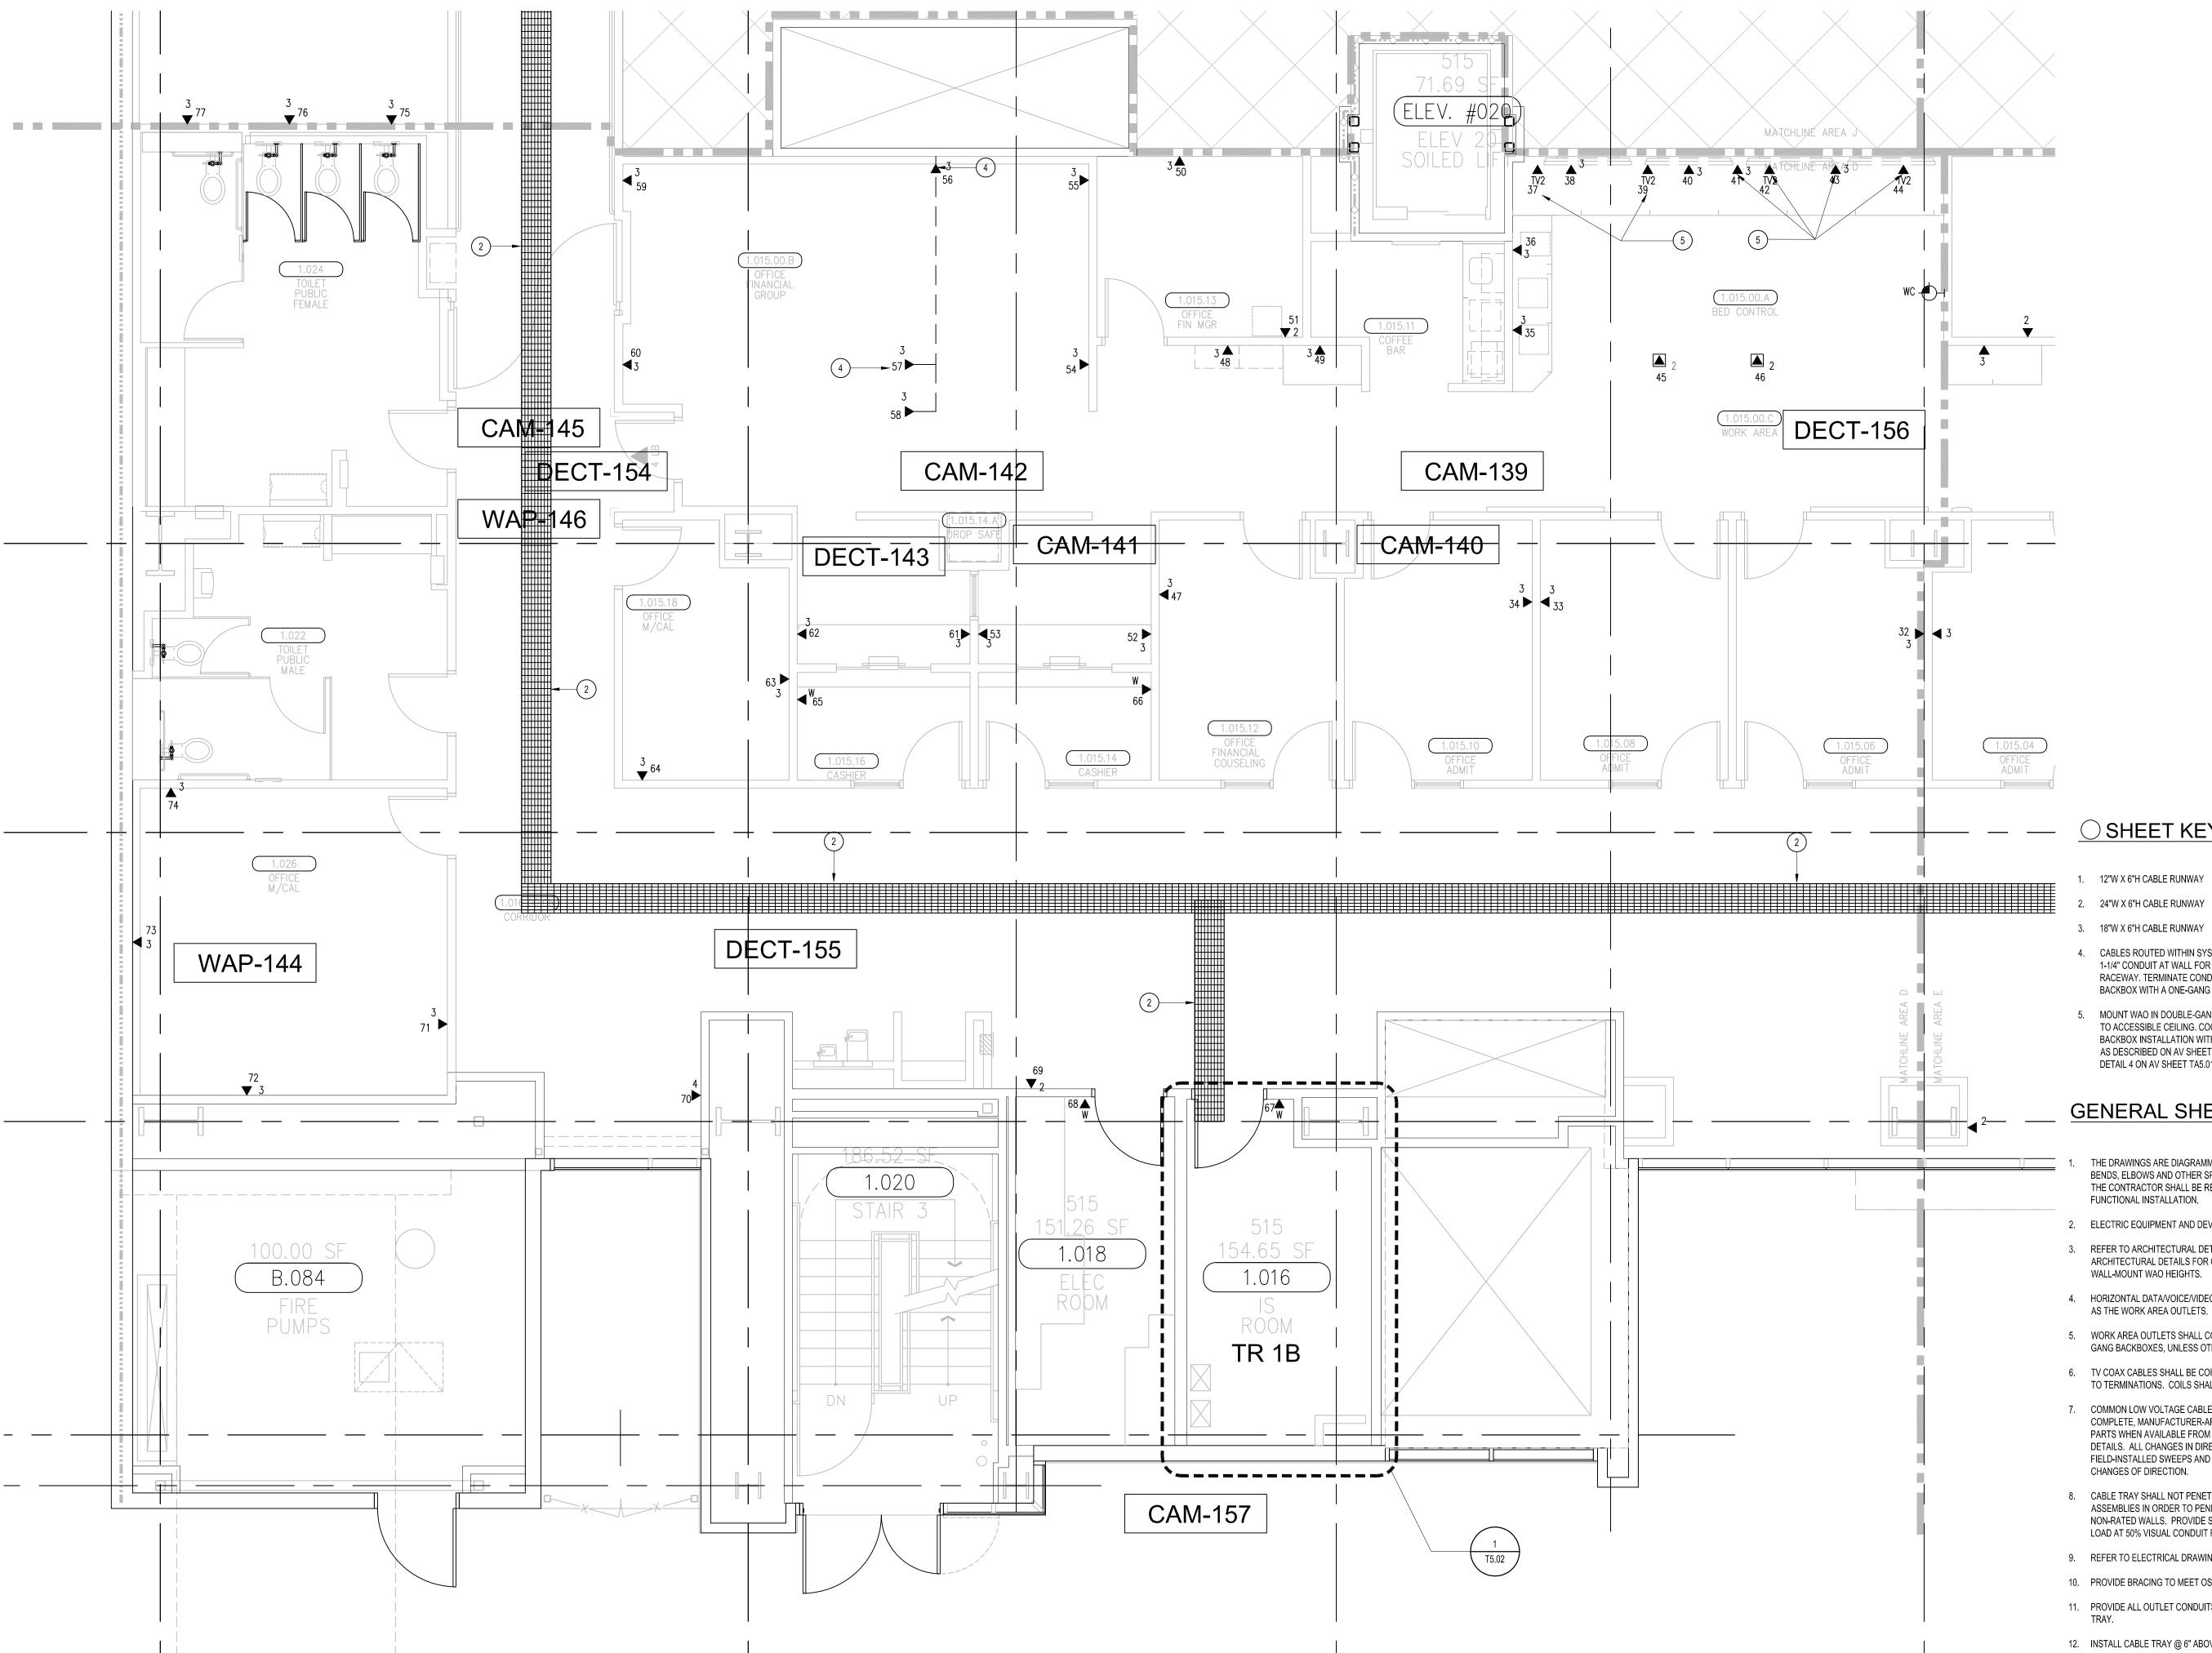

- 1. 12"W X 6"H CABLE RUNWAY
- 2. 24"W X 6"H CABLE RUNWAY
- 3. 18"W X 6"H CABLE RUNWAY
- 4. CABLES ROUTED WITHIN SYSTEMS FURNITURE. PROVIDE 1-1/4" CONDUIT AT WALL FOR ROUTING INTO FURNITURE RACEWAY. TERMINATE CONDUIT ONTO A TWO-GANG BACKBOX WITH A ONE-GANG REDUCER RING.
- 5. MOUNT WAO IN DOUBLE-GANG BACKBOX; STUB ONE (1) 1" EMT TO ACCESSIBLE CEILING. COORDINATE CABLING AND BACKBOX INSTALLATION WITH AUDIOVISUAL REQUIREMENTS AS DESCRIBED ON AV SHEET TA3.0C. COORDINATE WITH DETAIL 4 ON AV SHEET TA5.01 FOR MOUNTING HEIGHT.

GENERAL SHEET NOTES

- THE DRAWINGS ARE DIAGRAMMATIC ONLY AND MAY NOT SHOW ALL COMPONENTS, MATERIALS, OFFSETS, BENDS, ELBOWS AND OTHER SPECIFIC ELEMENTS THAT MAY BE REQUIRED FOR A COMPLETE INSTALLATION. THE CONTRACTOR SHALL BE RESPONSIBLE FOR PROVIDING ALL MATERIALS NEEDED FOR A COMPLETE AND FUNCTIONAL INSTALLATION.
- 2. ELECTRIC EQUIPMENT AND DEVICES (E.G. PBX, NETWORK SWITCHES) ARE SHOWN FOR REFERENCE ONLY. 3. REFER TO ARCHITECTURAL DETAIL PLANS FOR FINAL PATIENT ROOM DEVICE LOCATIONS. REFER TO ARCHITECTURAL DETAILS FOR OVERCOUNTER WAO HEIGHTS. REFER TO ARCHITECTURAL DETAILS FOR
- 4. HORIZONTAL DATA/VOICE/VIDEO CABLE SHALL TERMINATE IN THE TECHNOLOGY ROOM ON THE SAME FLOOR AS THE WORK AREA OUTLETS.
- 5. WORK AREA OUTLETS SHALL CONSIST OF SINGLE PLASTER REDUCING RINGS INSTALLED ON OVERSIZE DOUBLE GANG BACKBOXES, UNLESS OTHERWISE NOTED.
- 6. TV COAX CABLES SHALL BE COILED IN THE RESPECTIVE TECHNOLOGY ROOMS WITH A 20' SERVICE LOOP PRIOR TO TERMINATIONS. COILS SHALL BE SECURED TO THE AUDIOVISUAL WALL FIELD FOR AV CONTRACTOR.
- 7. COMMON LOW VOLTAGE CABLE RUNWAY IS 24" W X 6" HIGH. PROVIDE ALL MATERIALS AS NEEDED FOR A COMPLETE, MANUFACTURER-APPROVED SYSTEM USING CABLE TRAY MANUFACTURERS' MATERIALS AND PARTS WHEN AVAILABLE FROM THE MANUFACTURER AND AS INTENDED. REFER TO DRAWING T4.01 FOR DETAILS. ALL CHANGES IN DIRECTION AND INTERSECTIONS SHALL USE PRE-MANUFACTURED OR FIELD-INSTALLED SWEEPS AND TEES. ALL SWEEPS AND TEES SHALL MAINTAIN A 1 FOOT MINIMUM RADIUS IN
- CABLE TRAY SHALL NOT PENETRATE WALLS. PROVIDE TRANSITION FROM CABLE TRAY TO LISTED FIRESTOP ASSEMBLIES IN ORDER TO PENETRATE FIRE/SMOKE WALLS. TRANSITION TO 4" CONDUITS/SLEEVES FOR NON-RATED WALLS. PROVIDE SUFFICIENT CONDUITS/SLEEVES TO ACCOMMODATE 100% VISUAL CABLE TRAY LOAD AT 50% VISUAL CONDUIT FILL.
- 9. REFER TO ELECTRICAL DRAWINGS & SPECIFICATIONS FOR SHARED FLOOR BOXES & LOW VOLTAGE CONDUIT.
- 10. PROVIDE BRACING TO MEET OSHPD SEISMIC REQUIREMENTS. REFER TO SHEET T4.02 FOR MORE INFORMATION
- 11. PROVIDE ALL OUTLET CONDUITS FROM WORK AREA OUTLETS., DEVICES OR PULL BOXES TO NEAREST CABLE
- 12. INSTALL CABLE TRAY @ 6" ABOVE CEILING.

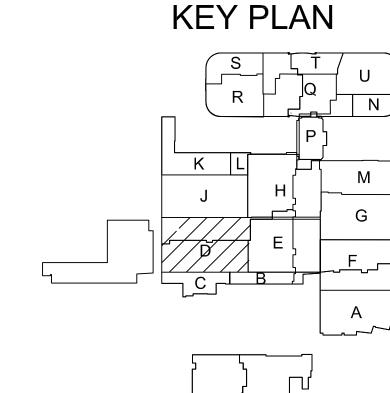

TELECOM FLOOR PLAN LEVEL 1 AREA-D

> SCALE: 1/4"=1'0"

T3.1D RECORD DRAWING

T3 LEVEL 1 - TELECOM PLAN - AREA D

REN'S RANGE lain Street 92868-3874

PROPRIETARY STATEMENT THESE DRAWINGS/DOCUMENTS HEREIN ATTACHED ARE THE PROPERTY OF BERGELECTRIC CORPORATION ANY REUSE OR REPRODUCTION OF THESE DOCUMENTS WITHOUT WRITTEN

FORBIDDEN. ALL RIGHTS RESERVED. DRAWN BY: J.RAMIREZ

PERMISSION OF BERGELECTRIC CORPORATION IS STRICTLY

DESIGN SUPERVISOR:

INSTALL SUPERVISOR: Scott Adams Tel Data Systems


05-30-12 RECORD DRAWINGS

Bergelectric Corporation 650 Opper Street

Escondido, CA 92029

SHEET TITLE:

DRAWING NO.:

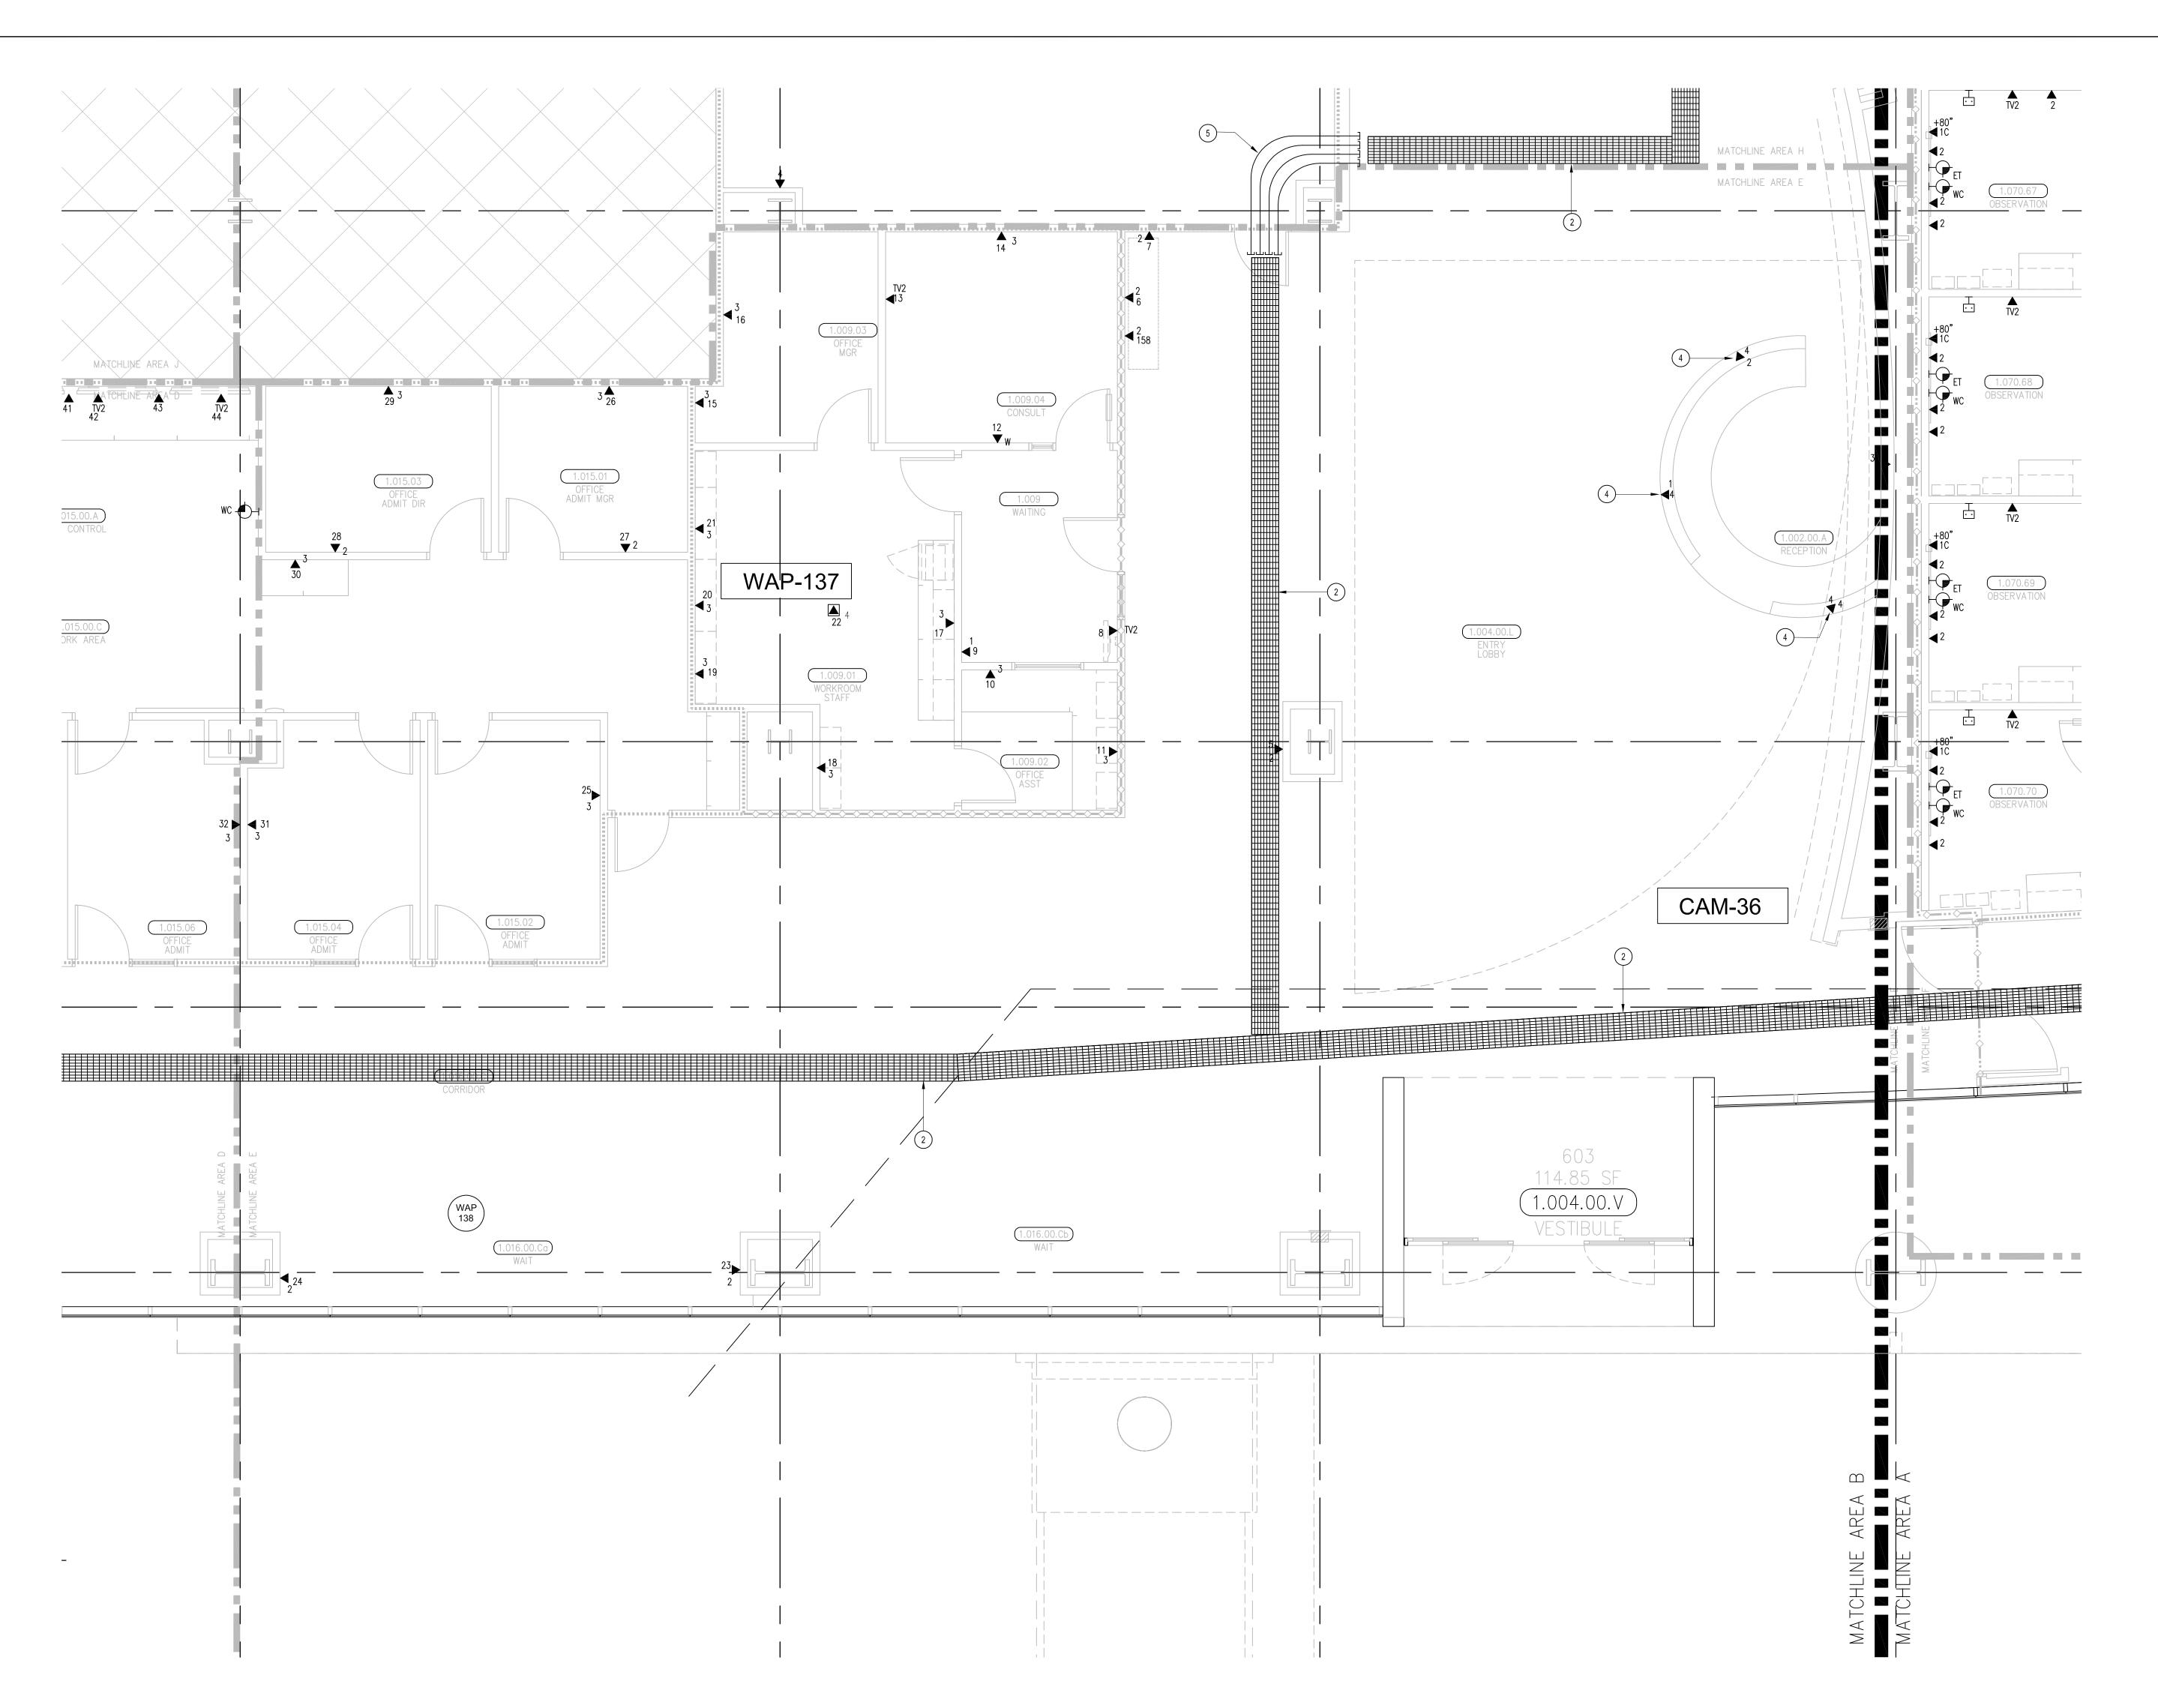

- 1. 12"W X 6"H CABLE RUNWAY
- 2. 24"W X 6"H CABLE RUNWAY


3. 18"W X 6"H CABLE RUNWAY

- 4. CABLES ROUTED WITHIN CASEWORK/MILLWORK. PROVIDE
- 1-1/4" CONDUIT AT WALL FOR ROUTING INTO CASEWORK/MILLWORK RACEWAY. TERMINATE CONDUIT ONTO A TWO-GANG BACKBOX WITH A ONE-GANG REDUCER RING.
- 5. PROVIDE TWELVE (12) 4" CONDUITS WITH A MINIMUM OF (6) EMPTY CONDUITS UPON COMPLETION.

GENERAL SHEET NOTES

WALL-MOUNT WAO HEIGHTS.

- 1. THE DRAWINGS ARE DIAGRAMMATIC ONLY AND MAY NOT SHOW ALL COMPONENTS, MATERIALS, OFFSETS, BENDS, ELBOWS AND OTHER SPECIFIC ELEMENTS THAT MAY BE REQUIRED FOR A COMPLETE INSTALLATION. THE CONTRACTOR SHALL BE RESPONSIBLE FOR PROVIDING ALL MATERIALS NEEDED FOR A COMPLETE AND FUNCTIONAL INSTALLATION.
- 2. ELECTRIC EQUIPMENT AND DEVICES (E.G. PBX, NETWORK SWITCHES) ARE SHOWN FOR REFERENCE ONLY. 3. REFER TO ARCHITECTURAL DETAIL PLANS FOR FINAL PATIENT ROOM DEVICE LOCATIONS. REFER TO ARCHITECTURAL DETAILS FOR OVERCOUNTER WAO HEIGHTS. REFER TO ARCHITECTURAL DETAILS FOR
- 4. HORIZONTAL DATA/VOICE/VIDEO CABLE SHALL TERMINATE IN THE TECHNOLOGY ROOM ON THE SAME FLOOR AS THE WORK AREA OUTLETS.
- 5. WORK AREA OUTLETS SHALL CONSIST OF SINGLE PLASTER REDUCING RINGS INSTALLED ON OVERSIZE DOUBLE GANG BACKBOXES, UNLESS OTHERWISE NOTED.
- 6. TV COAX CABLES SHALL BE COILED IN THE RESPECTIVE TECHNOLOGY ROOMS WITH A 20' SERVICE LOOP PRIOR TO TERMINATIONS. COILS SHALL BE SECURED TO THE AUDIOVISUAL WALL FIELD FOR AV CONTRACTOR.
- 7. COMMON LOW VOLTAGE CABLE RUNWAY IS 24" W X 6" HIGH. PROVIDE ALL MATERIALS AS NEEDED FOR A COMPLETE, MANUFACTURER-APPROVED SYSTEM USING CABLE TRAY MANUFACTURERS' MATERIALS AND PARTS WHEN AVAILABLE FROM THE MANUFACTURER AND AS INTENDED. REFER TO DRAWING 14.01 FOR DETAILS. ALL CHANGES IN DIRECTION AND INTERSECTIONS SHALL USE PRE-MANUFACTURED OR FIELD-INSTALLED SWEEPS AND TEES. ALL SWEEPS AND TEES SHALL MAINTAIN A 1 FOOT MINIMUM RADIUS IN CHANGES OF DIRECTION.
- 8. CABLE TRAY SHALL NOT PENETRATE WALLS. PROVIDE TRANSITION FROM CABLE TRAY TO LISTED FIRESTOP ASSEMBLIES IN ORDER TO PENETRATE FIRE/SMOKE WALLS. TRANSITION TO 4" CONDUITS/SLEEVES FOR NON-RATED WALLS. PROVIDE SUFFICIENT CONDUITS/SLEEVES TO ACCOMMODATE 100% VISUAL CABLE TRAY LOAD AT 50% VISUAL CONDUIT FILL.
- 9. REFER TO ELECTRICAL DRAWINGS & SPECIFICATIONS FOR SHARED FLOOR BOXES & LOW VOLTAGE CONDUIT.
- 10. PROVIDE BRACING TO MEET OSHPD SEISMIC REQUIREMENTS. REFER TO SHEET T4.02 FOR MORE INFORMATION 11. PROVIDE ALL OUTLET CONDUITS FROM WORK AREA OUTLETS., DEVICES OR PULL BOXES TO NEAREST CABLE
- 12. INSTALL CABLE TRAY @ 6" ABOVE CEILING.

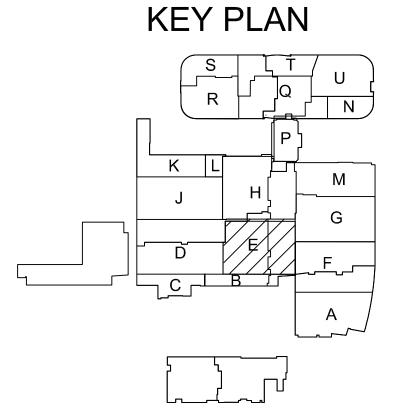

THESE DRAWINGS/DOCUMENTS HEREIN ATTACHED ARE THE PROPERTY OF BERGELECTRIC CORPORATION ANY REUSE OR REPRODUCTION OF THESE DOCUMENTS WITHOUT WRITTEN

PERMISSION OF BERGELECTRIC CORPORATION IS STRICTLY FORBIDDEN. ALL RIGHTS RESERVED. J.RAMIREZ

DESIGN SUPERVISOR:

INSTALL SUPERVISOR: Scott Adams Tel Data Systems Bergelectric Corporation 650 Opper Street Escondido, CA 92029

05-30-12 RECORD DRAWINGS

SHEET TITLE:


TELECOM


FLOOR PLAN LEVEL 1 AREA-E

> SCALE: 1/4"=1'0"

DRAWING NO.:

T3.1E RECORD DRAWING

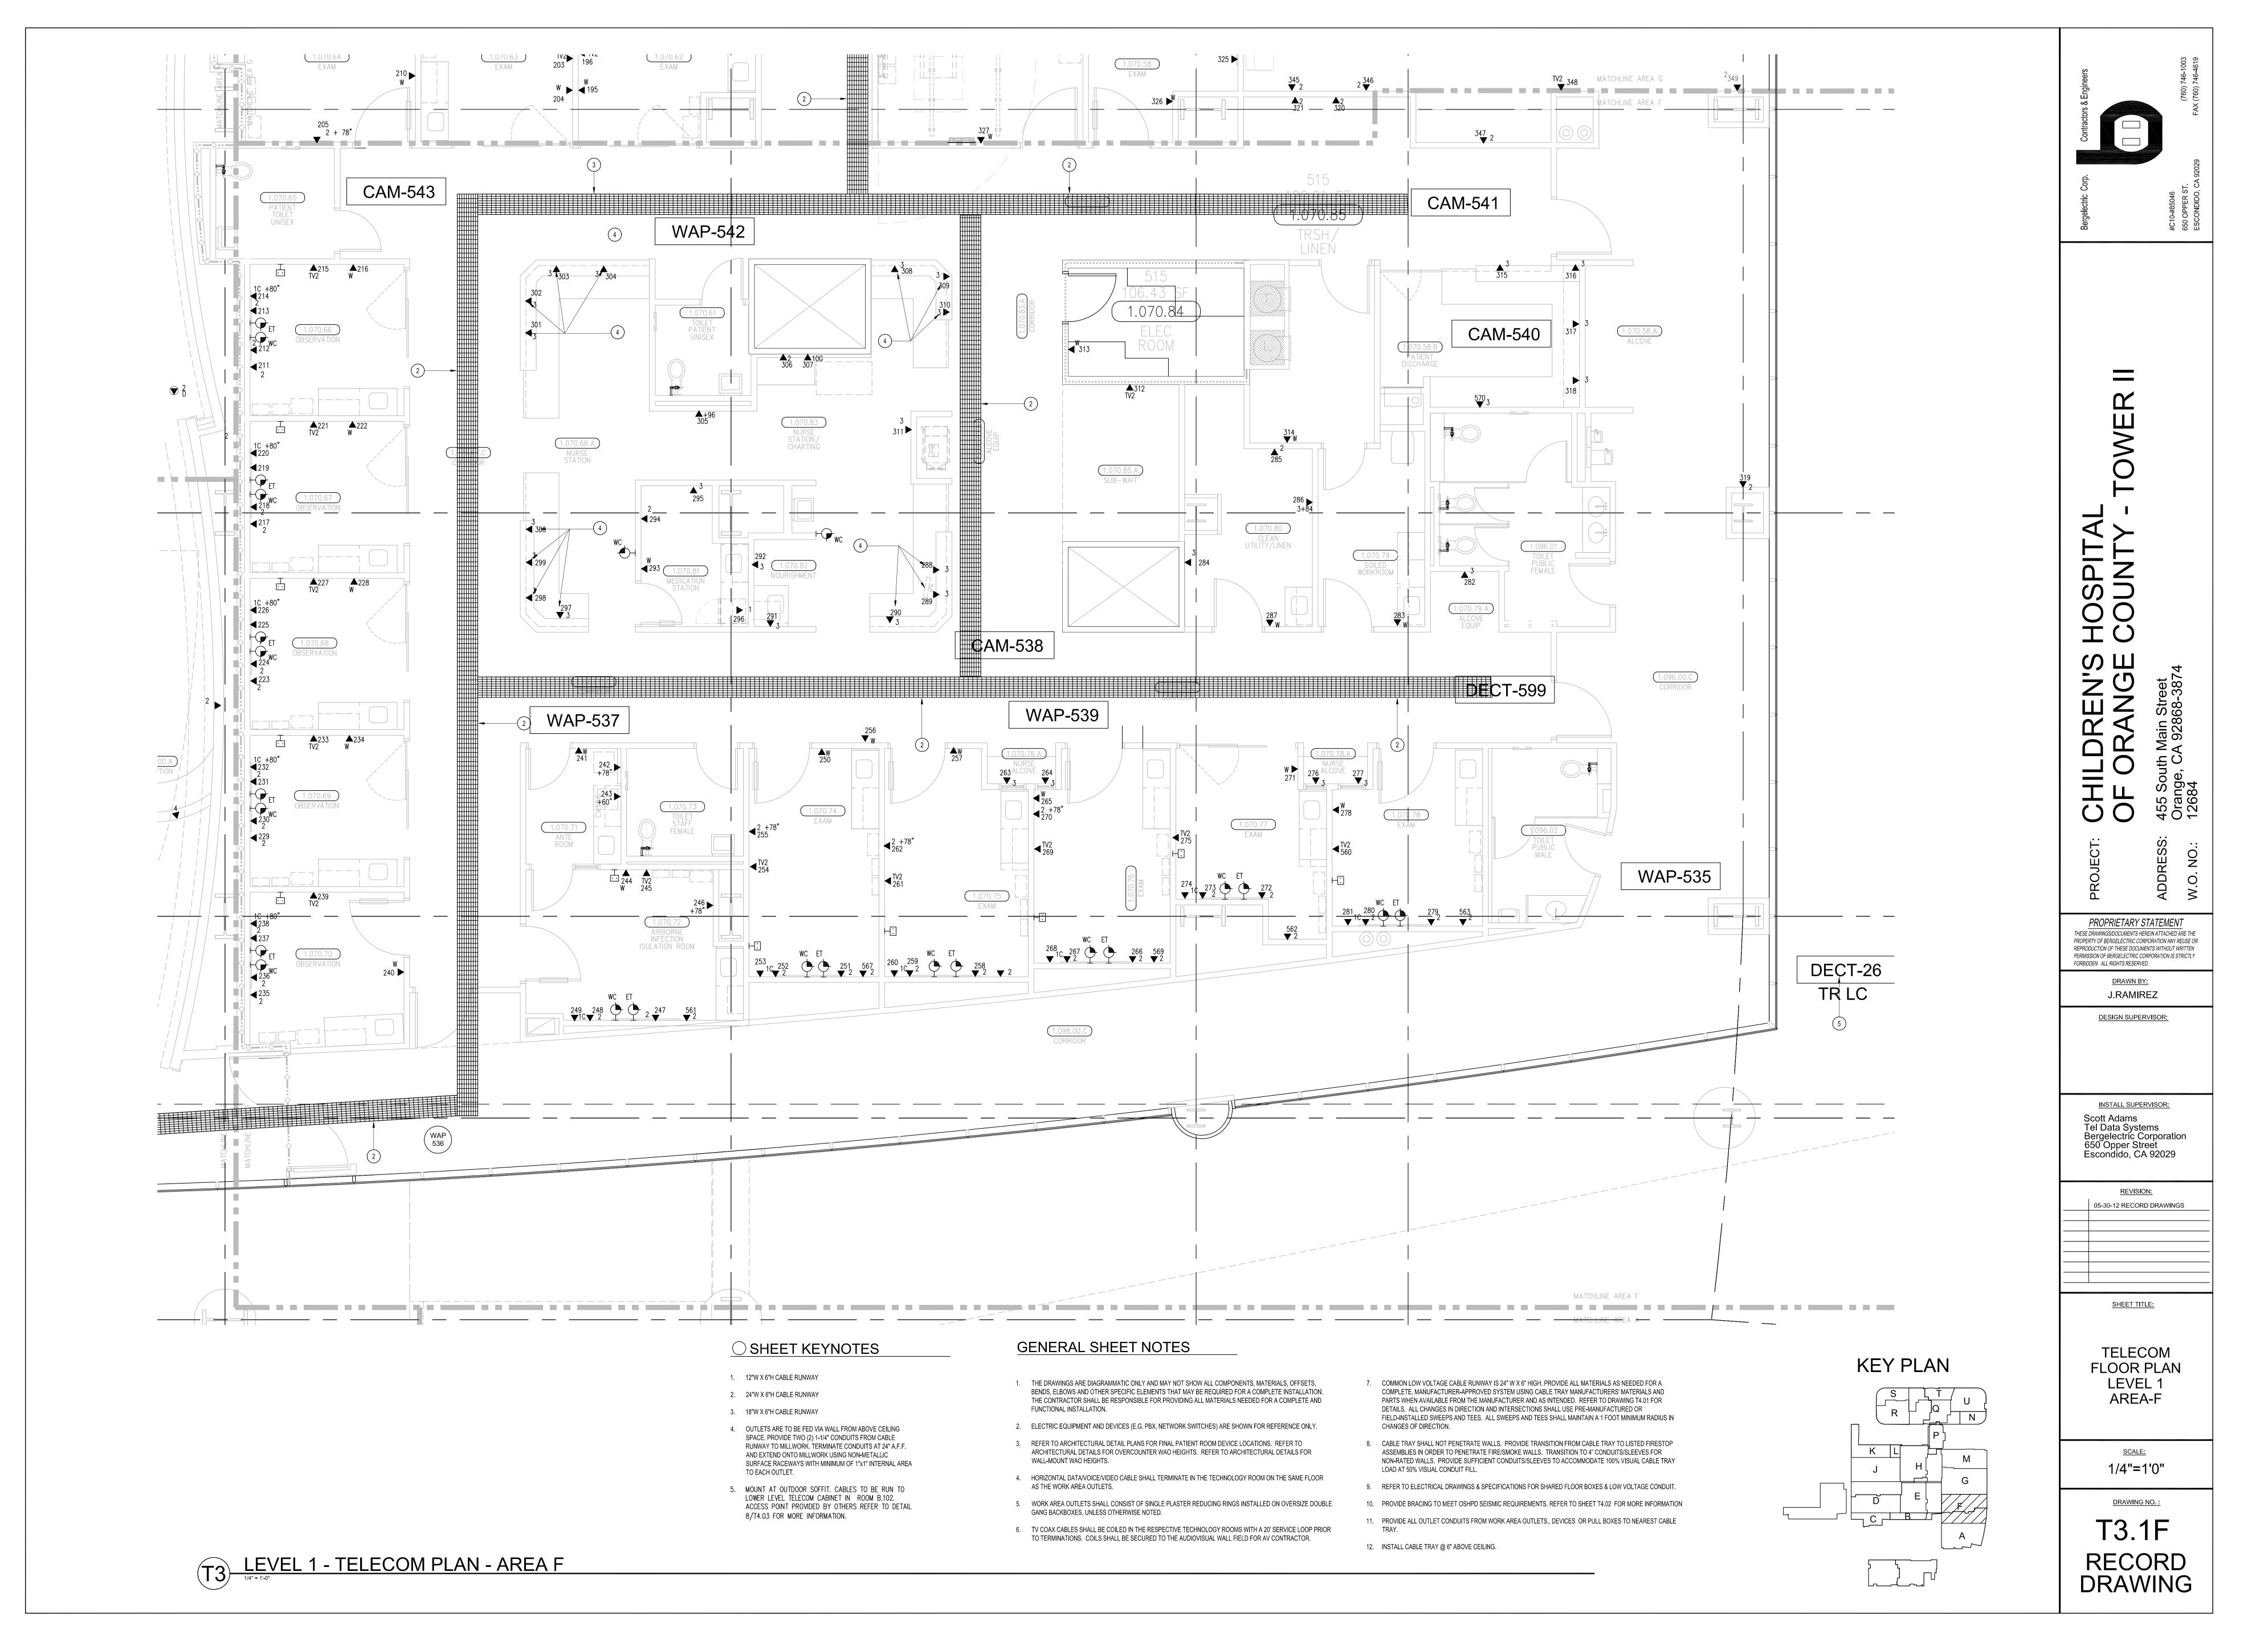

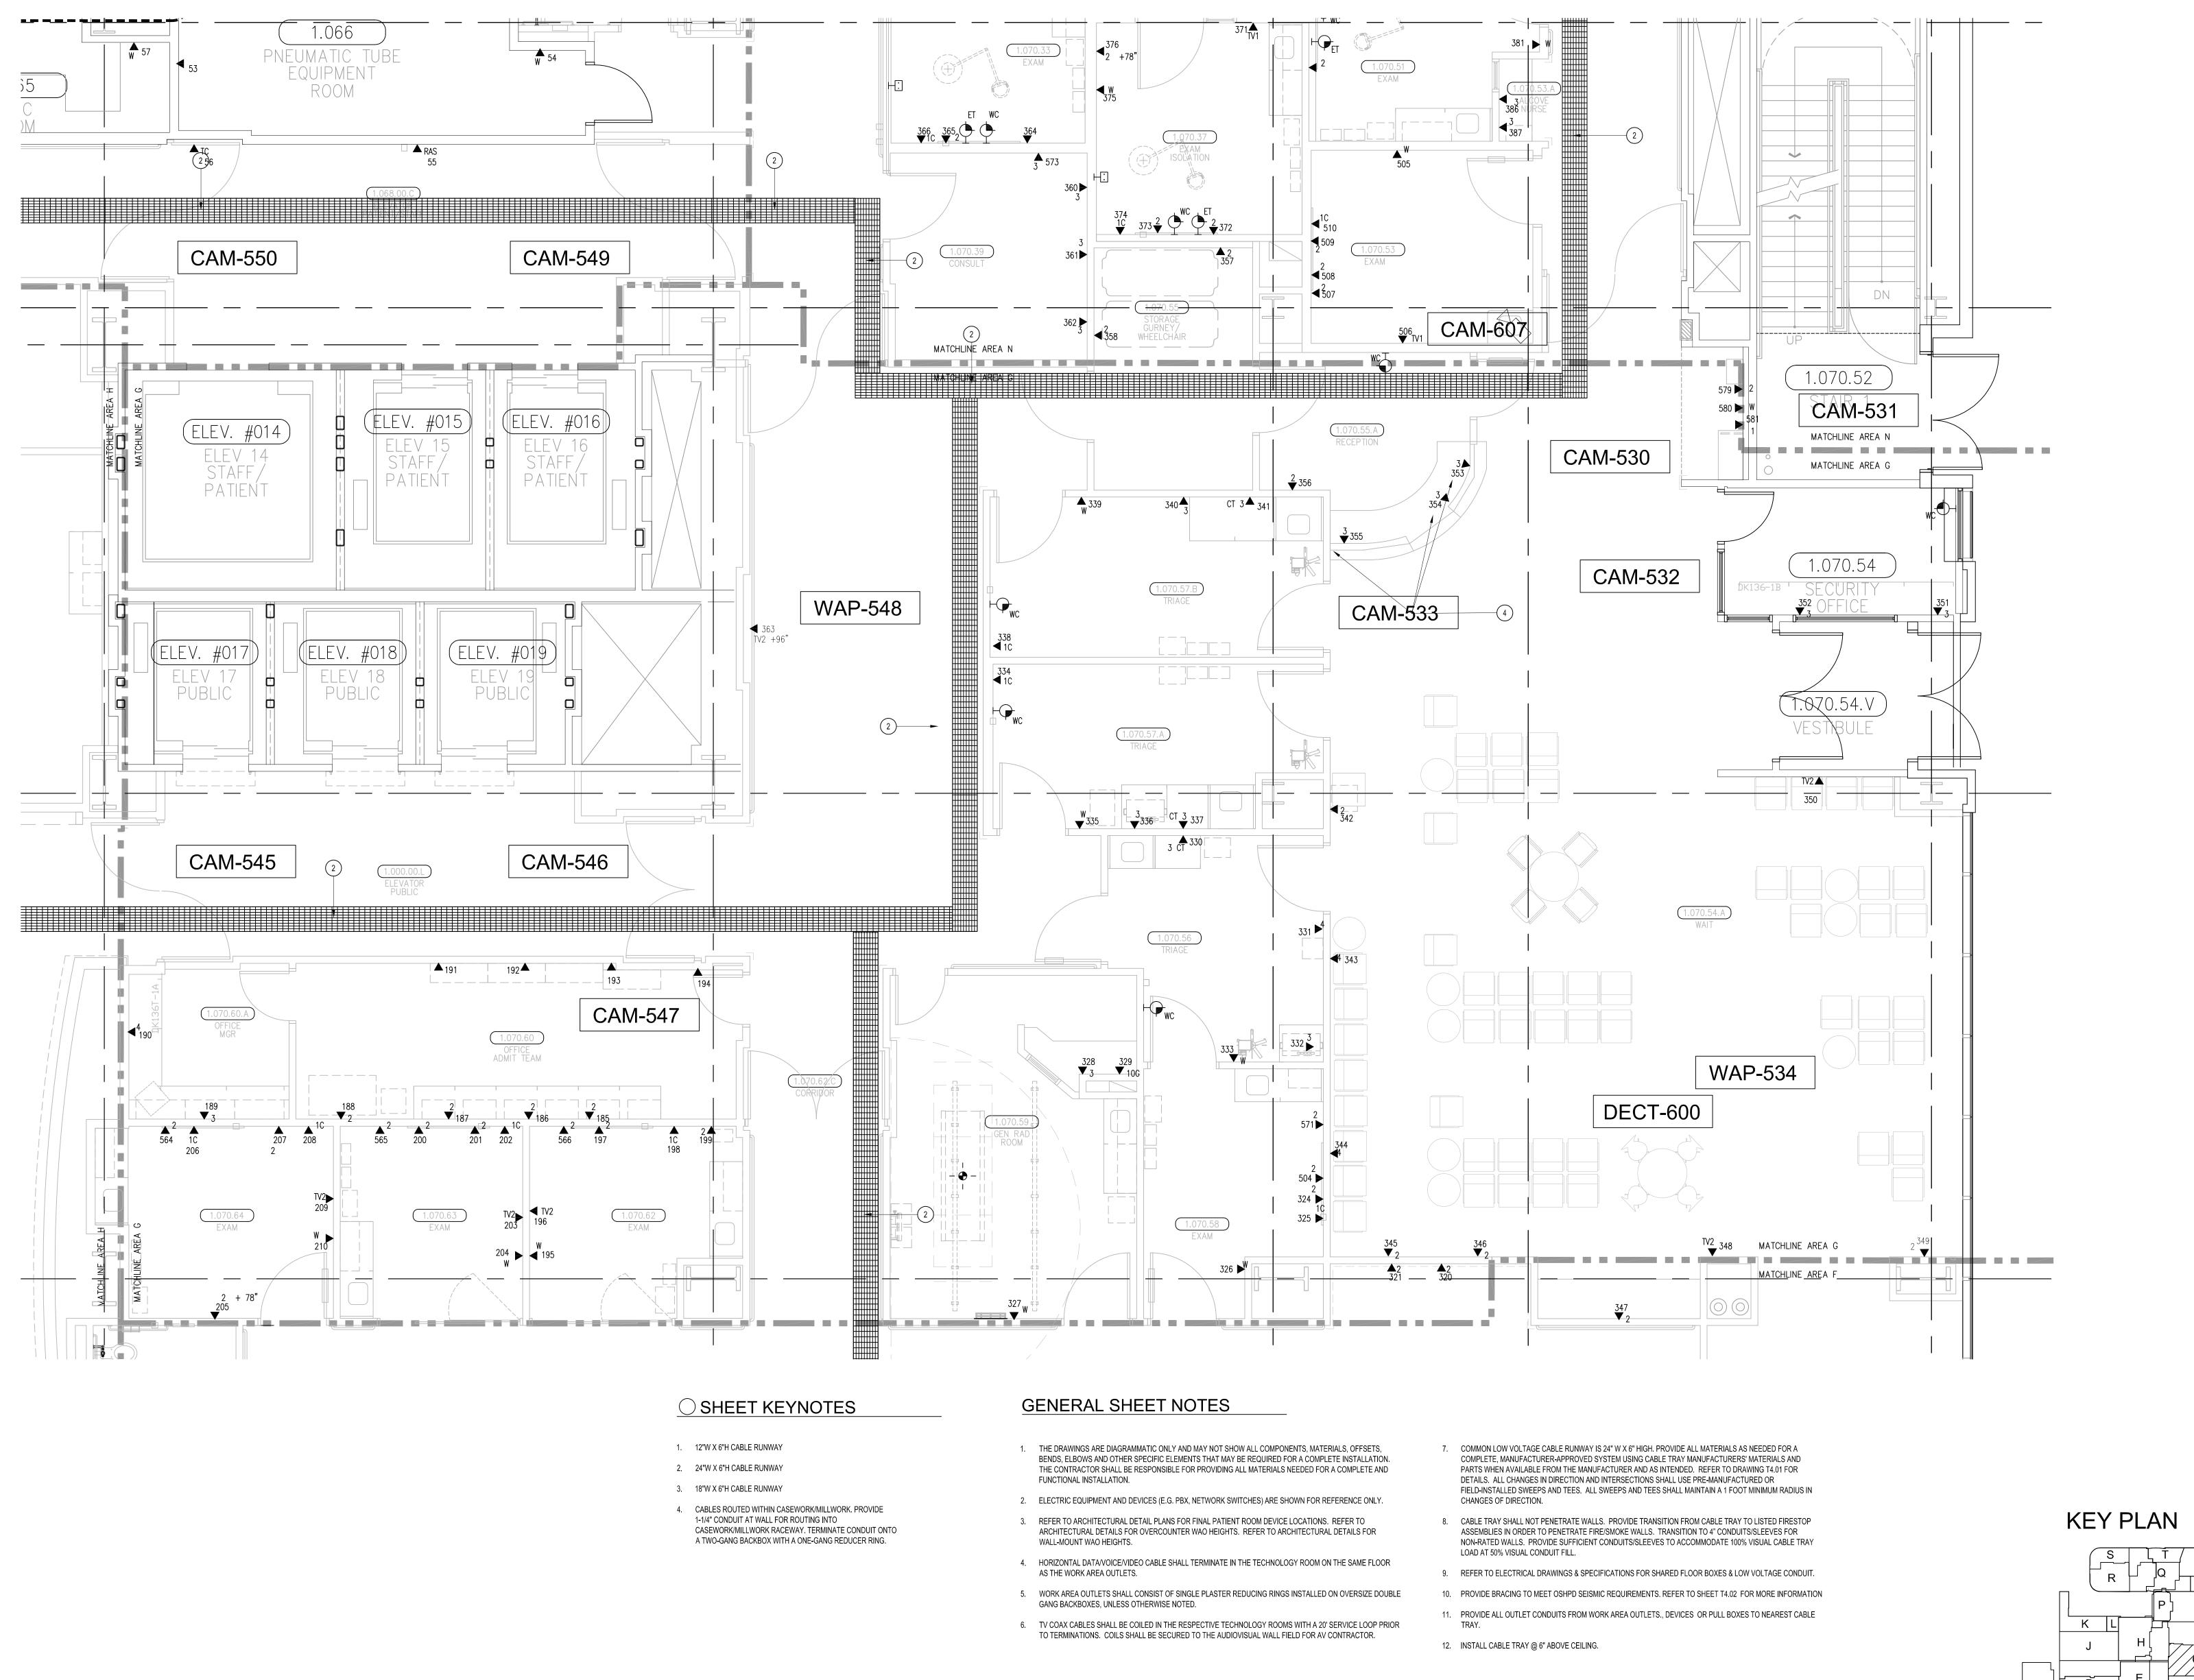

ergelectric Corp.

Contractors & Engineers

Contractors of Engineers

C10-#85046

C30 OPPER ST.

(760) 746-1003

SCONDIDO, CA 92029

FAX (760) 746-4619

REN'S HOSPITAL
ANGE COUNTY - TOWER II
2868-3874

PROPRIETARY STATEMENT

THESE DRAWINGS/DOCUMENTS HEREIN ATTACHED ARE THE

PROPERTY OF BERGELECTRIC CORPORATION ANY REUSE OR REPRODUCTION OF THESE DOCUMENTS WITHOUT WRITTEN PERMISSION OF BERGELECTRIC CORPORATION IS STRICTLY FORBIDDEN. ALL RIGHTS RESERVED.

J.RAMIREZ

DESIGN SUPERVISOR:

INSTALL SUPERVISOR:
Scott Adams
Tel Data Systems
Bergelectric Corporation
650 Opper Street
Escondido, CA 92029

REVISION:
05-30-12 RECORD DRAWINGS


SHEET TITLE:

TELECOM FLOOR PLAN LEVEL 1 AREA-G


SCALE: 1/4"=1'0"

DRAWING NO.:

T3.1G RECORD DRAWING

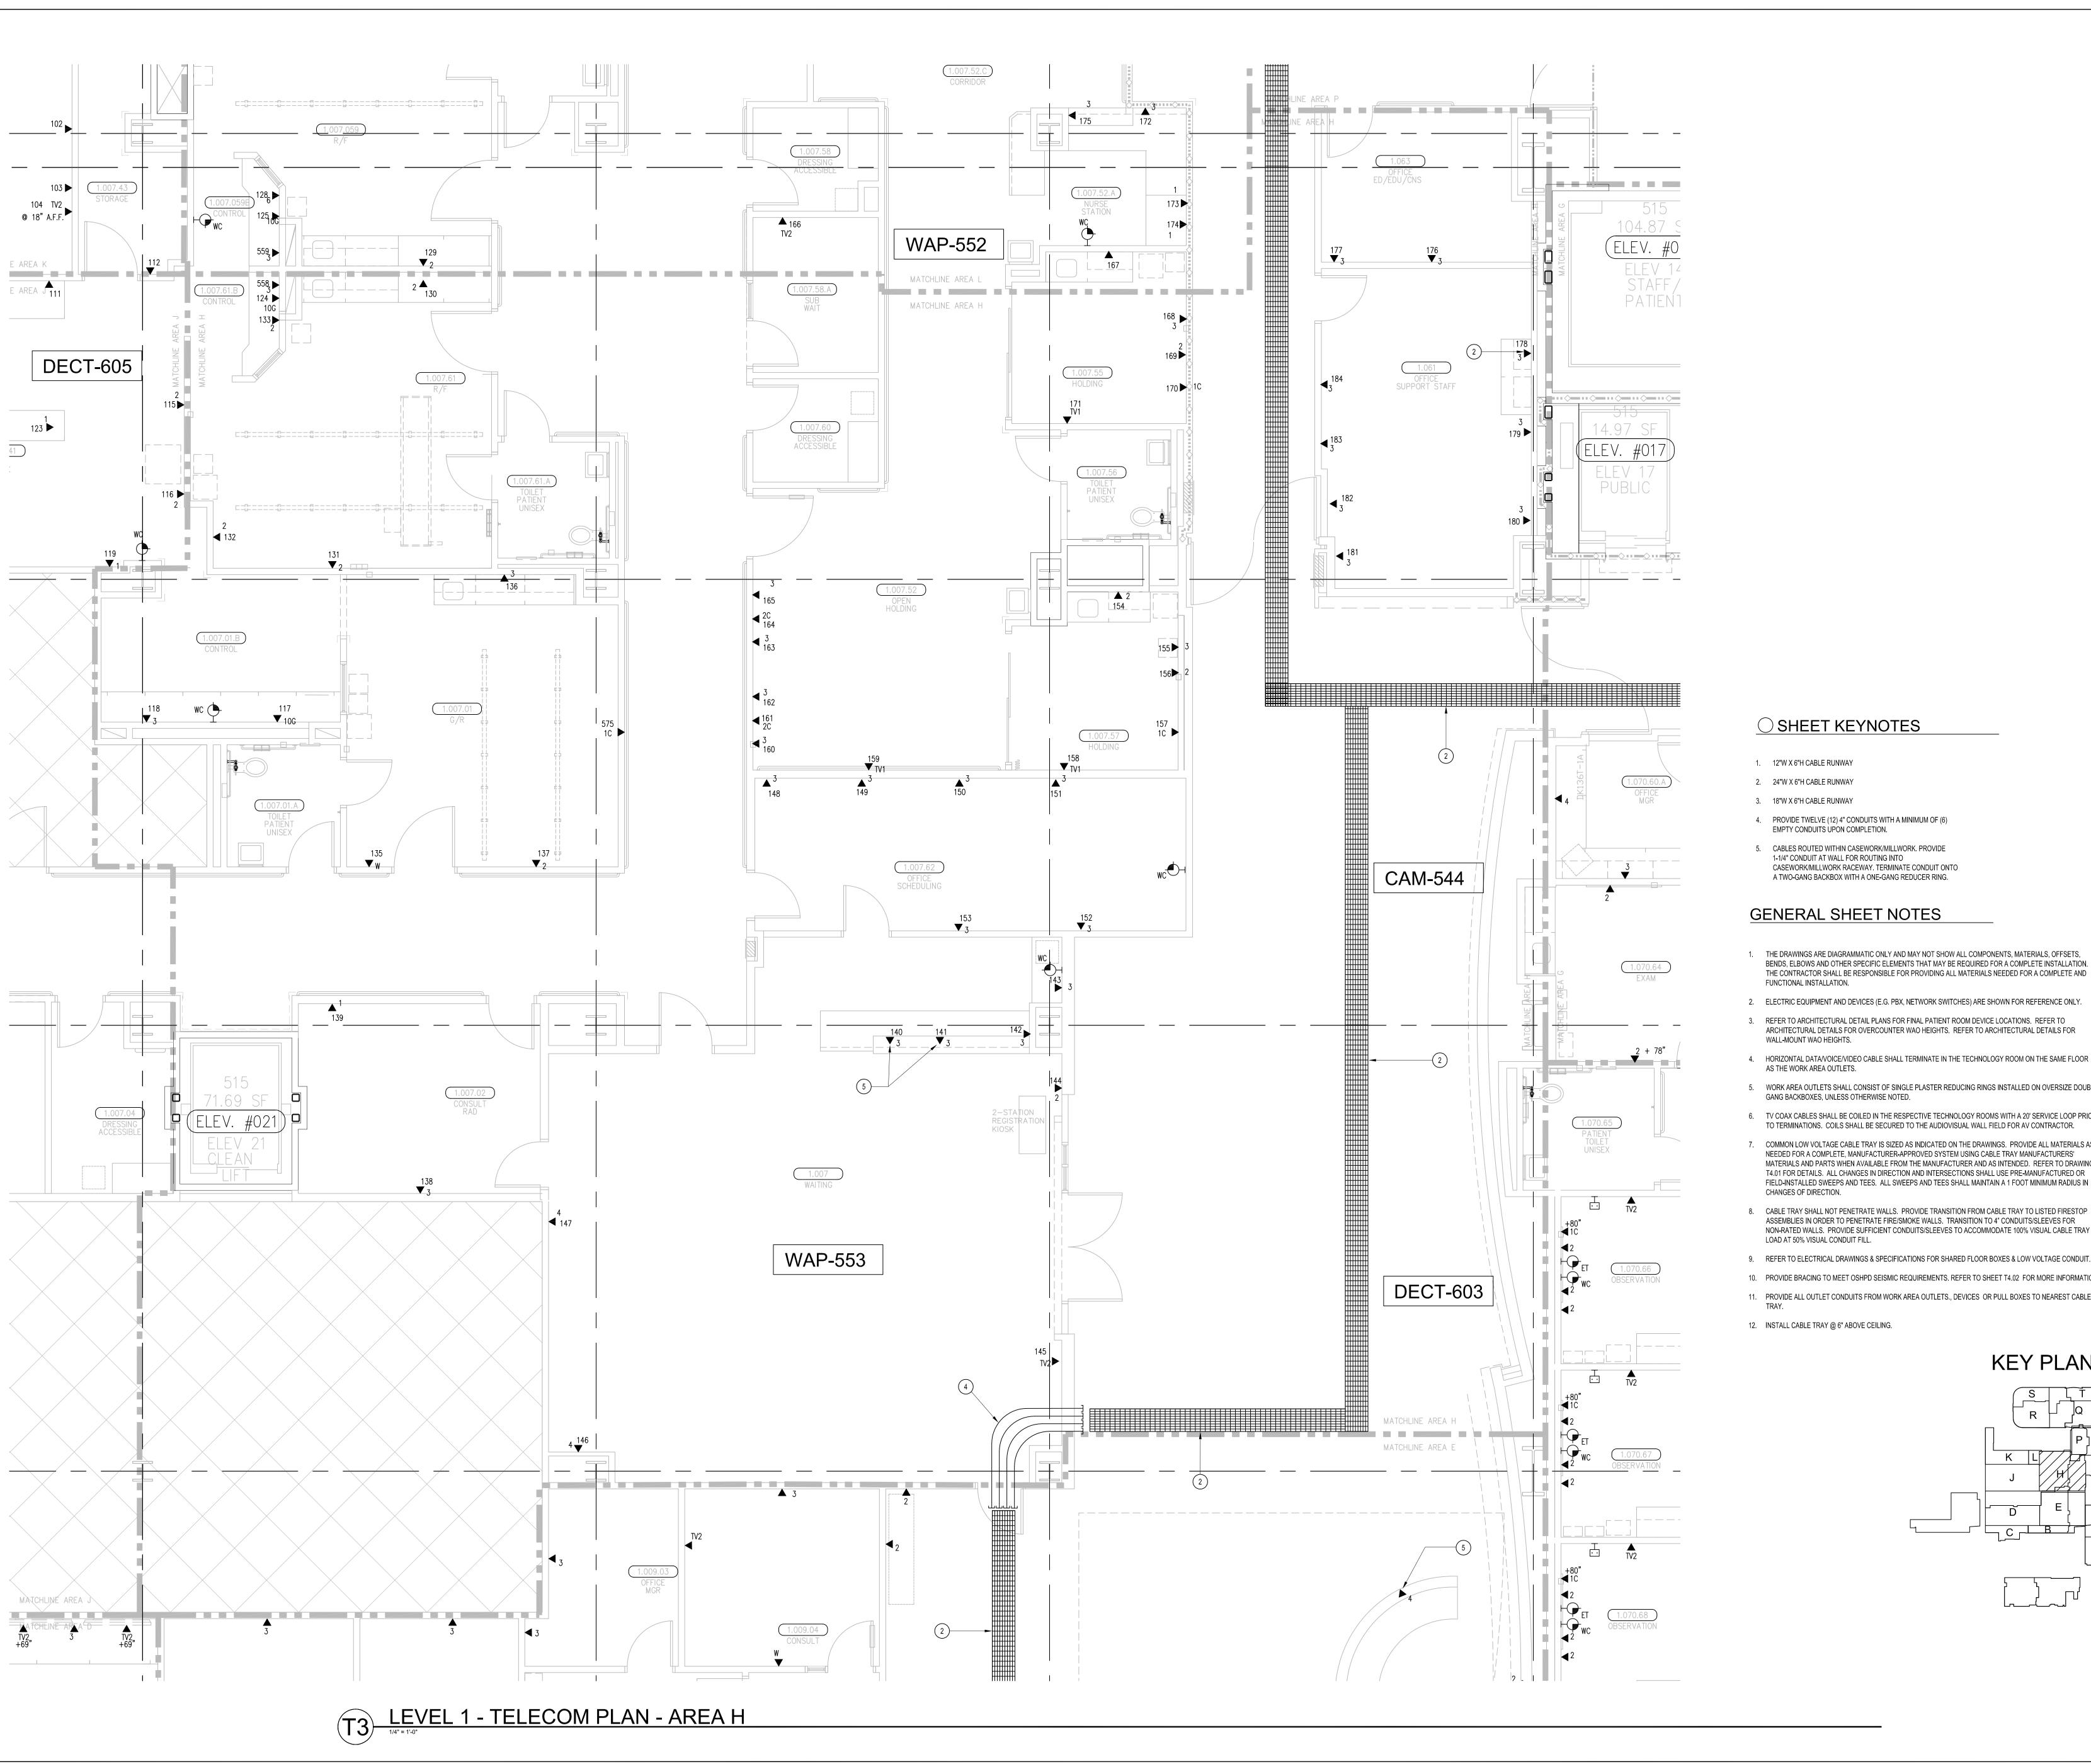

- 1. THE DRAWINGS ARE DIAGRAMMATIC ONLY AND MAY NOT SHOW ALL COMPONENTS, MATERIALS, OFFSETS, BENDS, ELBOWS AND OTHER SPECIFIC ELEMENTS THAT MAY BE REQUIRED FOR A COMPLETE INSTALLATION. THE CONTRACTOR SHALL BE RESPONSIBLE FOR PROVIDING ALL MATERIALS NEEDED FOR A COMPLETE AND
- B. REFER TO ARCHITECTURAL DETAIL PLANS FOR FINAL PATIENT ROOM DEVICE LOCATIONS. REFER TO ARCHITECTURAL DETAILS FOR OVERCOUNTER WAO HEIGHTS. REFER TO ARCHITECTURAL DETAILS FOR
- 5. WORK AREA OUTLETS SHALL CONSIST OF SINGLE PLASTER REDUCING RINGS INSTALLED ON OVERSIZE DOUBLE
- 6. TV COAX CABLES SHALL BE COILED IN THE RESPECTIVE TECHNOLOGY ROOMS WITH A 20' SERVICE LOOP PRIOR TO TERMINATIONS. COILS SHALL BE SECURED TO THE AUDIOVISUAL WALL FIELD FOR AV CONTRACTOR.
- 7. COMMON LOW VOLTAGE CABLE TRAY IS SIZED AS INDICATED ON THE DRAWINGS. PROVIDE ALL MATERIALS AS NEEDED FOR A COMPLETE, MANUFACTURER-APPROVED SYSTEM USING CABLE TRAY MANUFACTURERS' MATERIALS AND PARTS WHEN AVAILABLE FROM THE MANUFACTURER AND AS INTENDED. REFER TO DRAWING T4.01 FOR DETAILS. ALL CHANGES IN DIRECTION AND INTERSECTIONS SHALL USE PRE-MANUFACTURED OR FIELD-INSTALLED SWEEPS AND TEES. ALL SWEEPS AND TEES SHALL MAINTAIN A 1 FOOT MINIMUM RADIUS IN
- 8. CABLE TRAY SHALL NOT PENETRATE WALLS. PROVIDE TRANSITION FROM CABLE TRAY TO LISTED FIRESTOP ASSEMBLIES IN ORDER TO PENETRATE FIRE/SMOKE WALLS. TRANSITION TO 4" CONDUITS/SLEEVES FOR NON-RATED WALLS. PROVIDE SUFFICIENT CONDUITS/SLEEVES TO ACCOMMODATE 100% VISUAL CABLE TRAY
- 9. REFER TO ELECTRICAL DRAWINGS & SPECIFICATIONS FOR SHARED FLOOR BOXES & LOW VOLTAGE CONDUIT. 10. PROVIDE BRACING TO MEET OSHPD SEISMIC REQUIREMENTS. REFER TO SHEET T4.02 FOR MORE INFORMATION
- 11. PROVIDE ALL OUTLET CONDUITS FROM WORK AREA OUTLETS., DEVICES OR PULL BOXES TO NEAREST CABLE

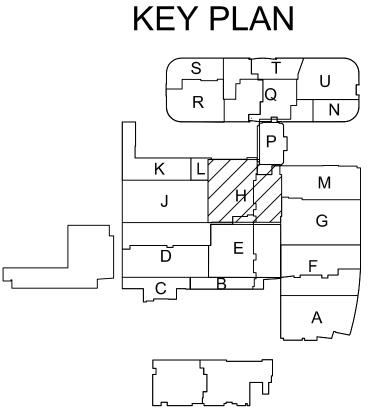

PROPRIETARY STATEMENT THESE DRAWINGS/DOCUMENTS HEREIN ATTACHED ARE THE PROPERTY OF BERGELECTRIC CORPORATION ANY REUSE OR REPRODUCTION OF THESE DOCUMENTS WITHOUT WRITTEN PERMISSION OF BERGELECTRIC CORPORATION IS STRICTLY

J.RAMIREZ

FORBIDDEN. ALL RIGHTS RESERVED.

DESIGN SUPERVISOR:

INSTALL SUPERVISOR: Scott Adams Tel Data Systems
Bergelectric Corporation
650 Opper Street

Escondido, CA 92029


05-30-12 RECORD DRAWINGS

SHEET TITLE:

TELECOM FLOOR PLAN LEVEL 1 AREA-H

> SCALE: 1/4"=1'0"

T3.1H RECORD DRAWING

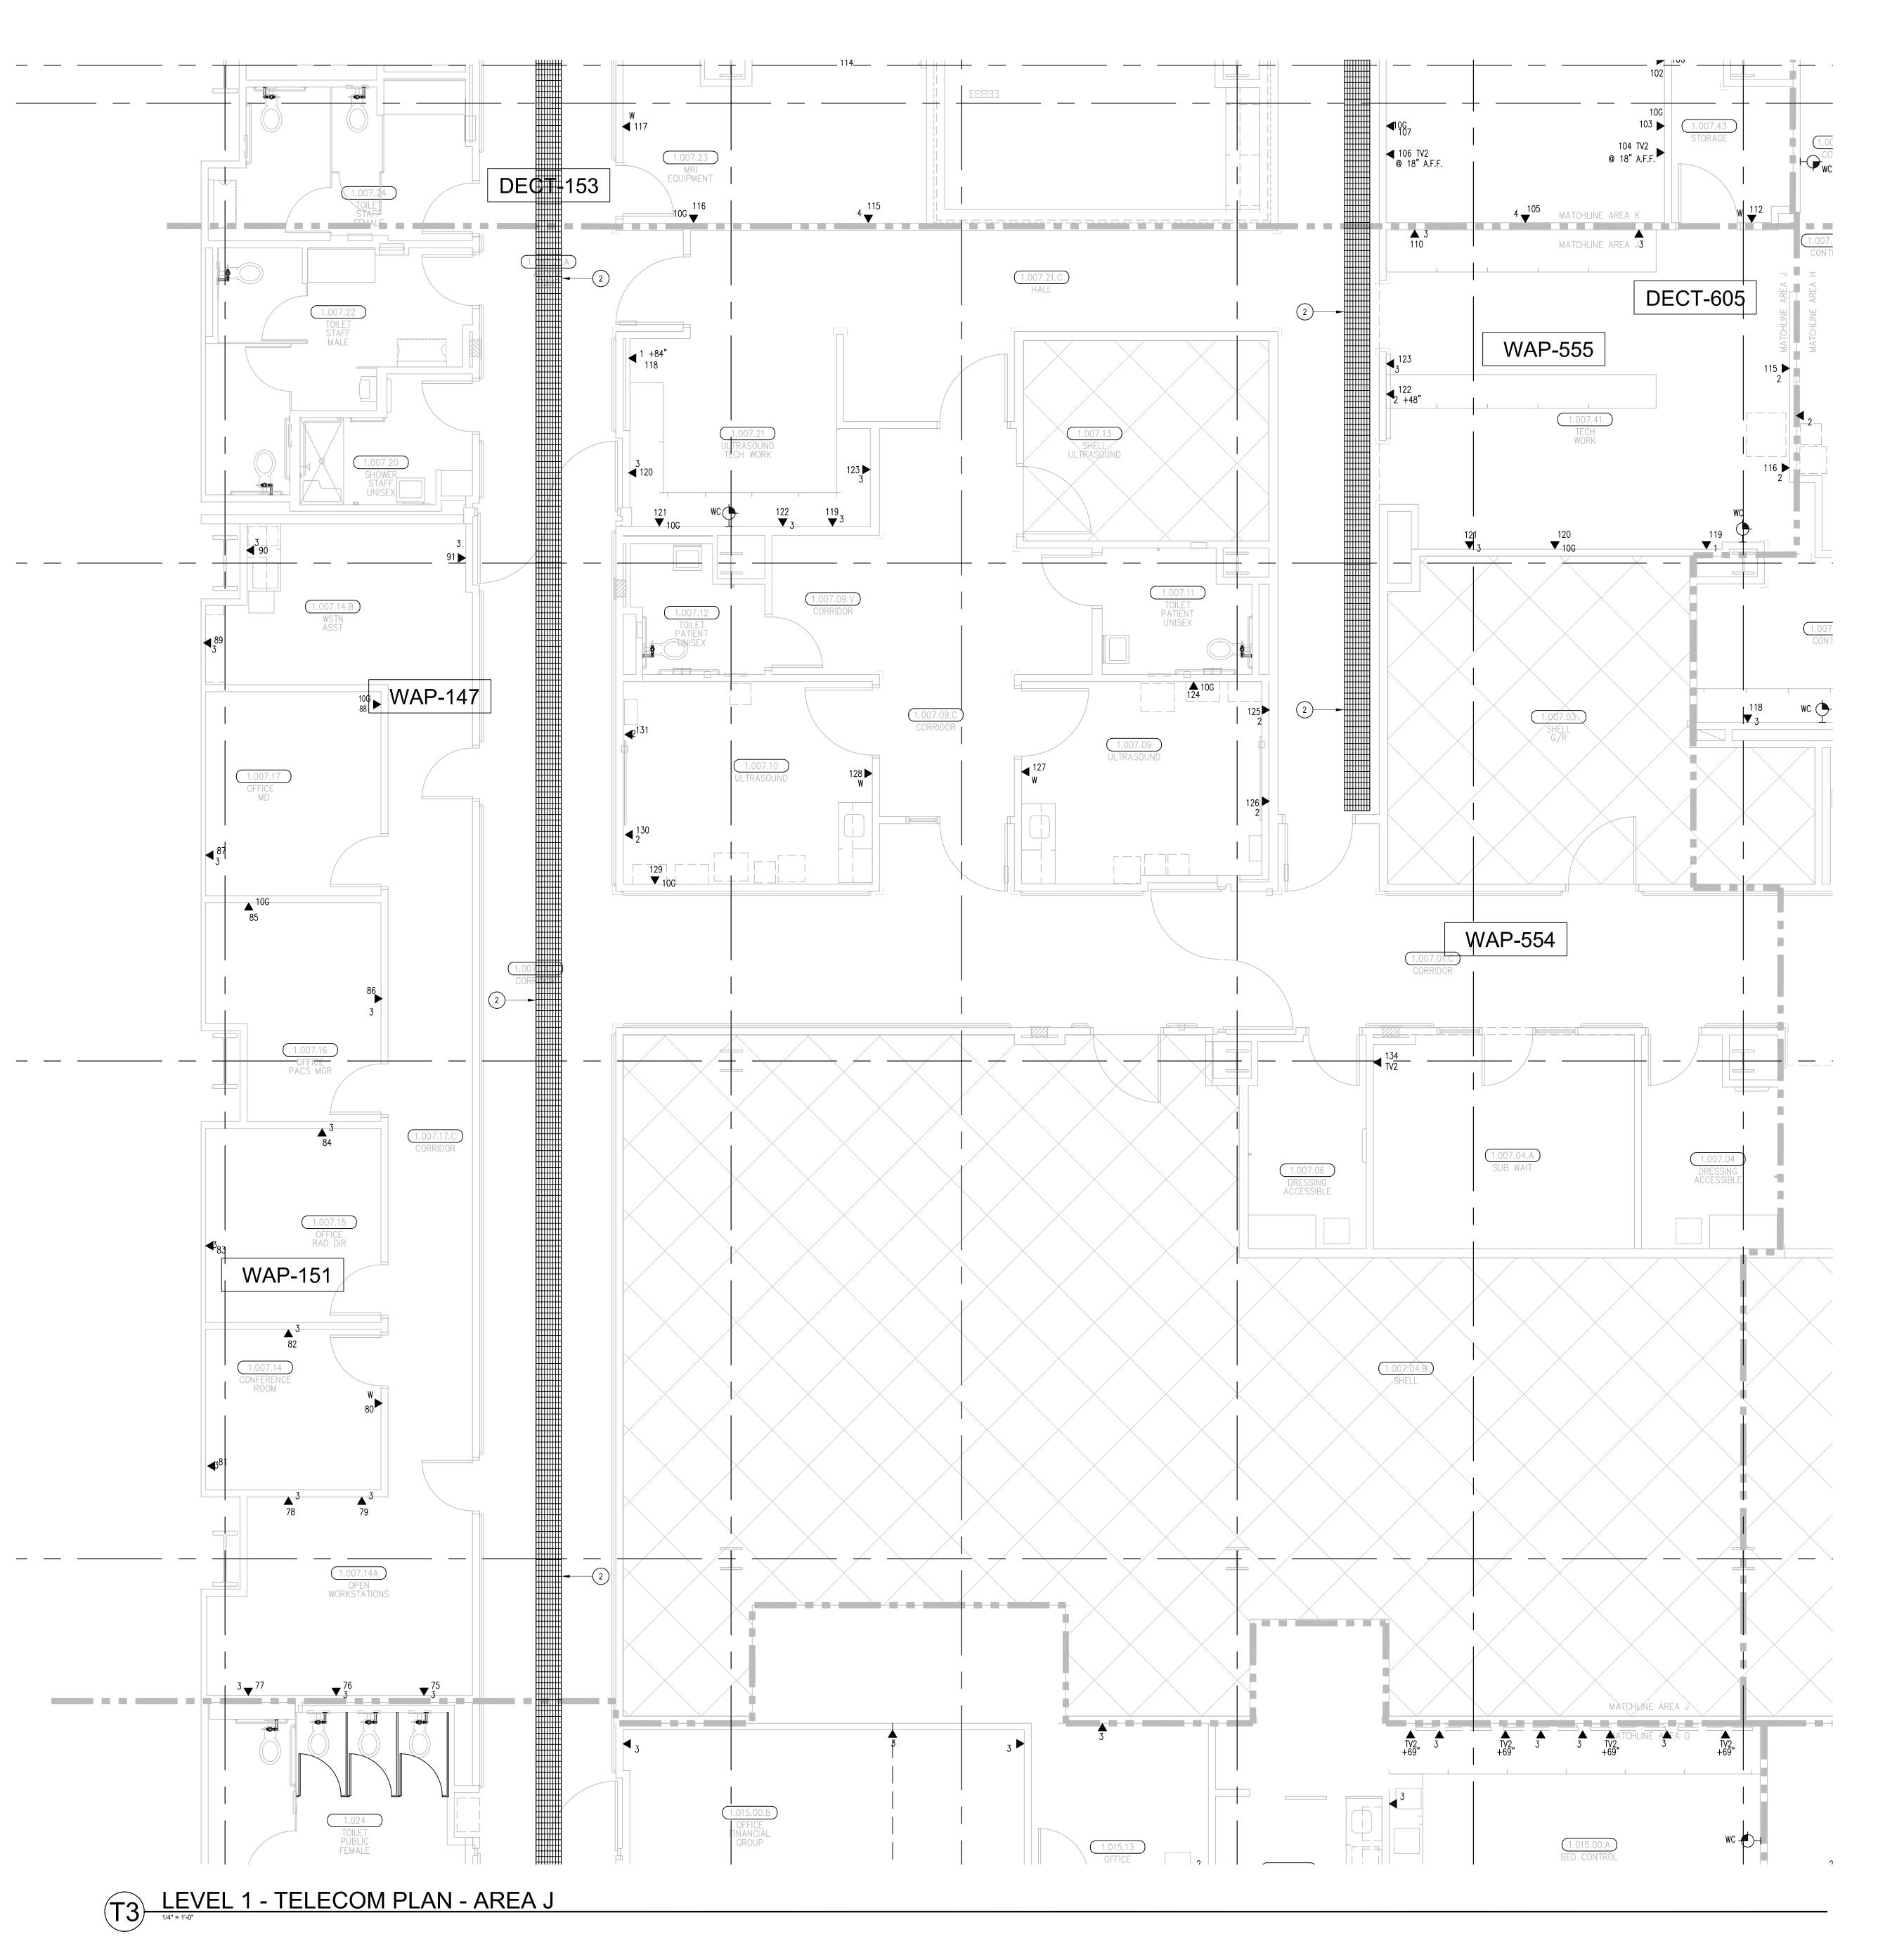




- 1. 12"W X 6"H CABLE RUNWAY
- 2. 24"W X 6"H CABLE RUNWAY
- 3. 18"W X 6"H CABLE RUNWAY

GENERAL SHEET NOTES

- 1. THE DRAWINGS ARE DIAGRAMMATIC ONLY AND MAY NOT SHOW ALL COMPONENTS, MATERIALS, OFFSETS, BENDS, ELBOWS AND OTHER SPECIFIC ELEMENTS THAT MAY BE REQUIRED FOR A COMPLETE INSTALLATION. THE CONTRACTOR SHALL BE RESPONSIBLE FOR PROVIDING ALL MATERIALS NEEDED FOR A COMPLETE AND FUNCTIONAL INSTALLATION.
- ELECTRIC EQUIPMENT AND DEVICES (E.G. PBX, NETWORK SWITCHES) ARE SHOWN FOR REFERENCE ONLY.
 REFER TO ARCHITECTURAL DETAIL PLANS FOR FINAL PATIENT ROOM DEVICE LOCATIONS. REFER TO
- ARCHITECTURAL DETAILS FOR OVERCOUNTER WAO HEIGHTS. REFER TO ARCHITECTURAL DETAILS FOR WALL-MOUNT WAO HEIGHTS.
- HORIZONTAL DATA/VOICE/VIDEO CABLE SHALL TERMINATE IN THE TECHNOLOGY ROOM ON THE SAME FLOOR
 AS THE WORK AREA OUTLETS.
- 5. WORK AREA OUTLETS SHALL CONSIST OF SINGLE PLASTER REDUCING RINGS INSTALLED ON OVERSIZE DOUBLE GANG BACKBOXES, UNLESS OTHERWISE NOTED.
- 6. TV COAX CABLES SHALL BE COILED IN THE RESPECTIVE TECHNOLOGY ROOMS WITH A 20' SERVICE LOOP PRIOR TO TERMINATIONS. COILS SHALL BE SECURED TO THE AUDIOVISUAL WALL FIELD FOR AV CONTRACTOR.
- 7. COMMON LOW VOLTAGE CABLE RUNWAY IS 24" W X 6" HIGH. PROVIDE ALL MATERIALS AS NEEDED FOR A COMPLETE, MANUFACTURER-APPROVED SYSTEM USING CABLE TRAY MANUFACTURERS' MATERIALS AND PARTS WHEN AVAILABLE FROM THE MANUFACTURER AND AS INTENDED. REFER TO DRAWING T4.01 FOR DETAILS. ALL CHANGES IN DIRECTION AND INTERSECTIONS SHALL USE PRE-MANUFACTURED OR FIELD-INSTALLED SWEEPS AND TEES. ALL SWEEPS AND TEES SHALL MAINTAIN A 1 FOOT MINIMUM RADIUS IN CHANGES OF DIRECTION.
- 8. CABLE TRAY SHALL NOT PENETRATE WALLS. PROVIDE TRANSITION FROM CABLE TRAY TO LISTED FIRESTOP ASSEMBLIES IN ORDER TO PENETRATE FIRE/SMOKE WALLS. TRANSITION TO 4" CONDUITS/SLEEVES FOR NON-RATED WALLS. PROVIDE SUFFICIENT CONDUITS/SLEEVES TO ACCOMMODATE 100% VISUAL CABLE TRAY LOAD AT 50% VISUAL CONDUIT FILL.
- 9. REFER TO ELECTRICAL DRAWINGS & SPECIFICATIONS FOR SHARED FLOOR BOXES & LOW VOLTAGE CONDUIT.
- 10. PROVIDE BRACING TO MEET OSHPD SEISMIC REQUIREMENTS. REFER TO SHEET T4.02 FOR MORE INFORMATION
- 11. PROVIDE ALL OUTLET CONDUITS FROM WORK AREA OUTLETS., DEVICES OR PULL BOXES TO NEAREST CABLE TRAY.
- 12. INSTALL CABLE TRAY @ 6" ABOVE CEILING.



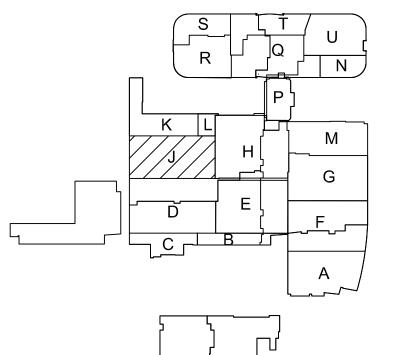

ctric Corp. Contractors & Engineers

Contractors & Engineers

S5046

S5046

CA 92029

FAX (760) 746-1003

FIND CA 92029

FAX (760) 746-4619

CHILDREN'S HOSPITAL
OF ORANGE COUNTY - TOWER

PROPRIETARY STATEMENT

THESE DRAWINGS/DOCUMENTS HEREIN ATTACHED ARE THE PROPERTY OF BERGELECTRIC CORPORATION ANY REUSE OR REPRODUCTION OF THESE DOCUMENTS WITHOUT WRITTEN PERMISSION OF BERGELECTRIC CORPORATION IS STRICTLY FORBIDDEN. ALL RIGHTS RESERVED.

DRAWN BY:
J.RAMIREZ

DESIGN SUPERVISOR:

INSTALL SUPERVISOR:

Scott Adams Tel Data Systems Bergelectric Corporation 650 Opper Street Escondido, CA 92029

REVISION:
05-30-12 RECORD DRAWINGS


SHEET TITLE:

TELECOM FLOOR PLAN LEVEL 1 AREA-J

> SCALE: 1/4"=1'0"

DRAWING NO. :

T3.1J RECORD DRAWING

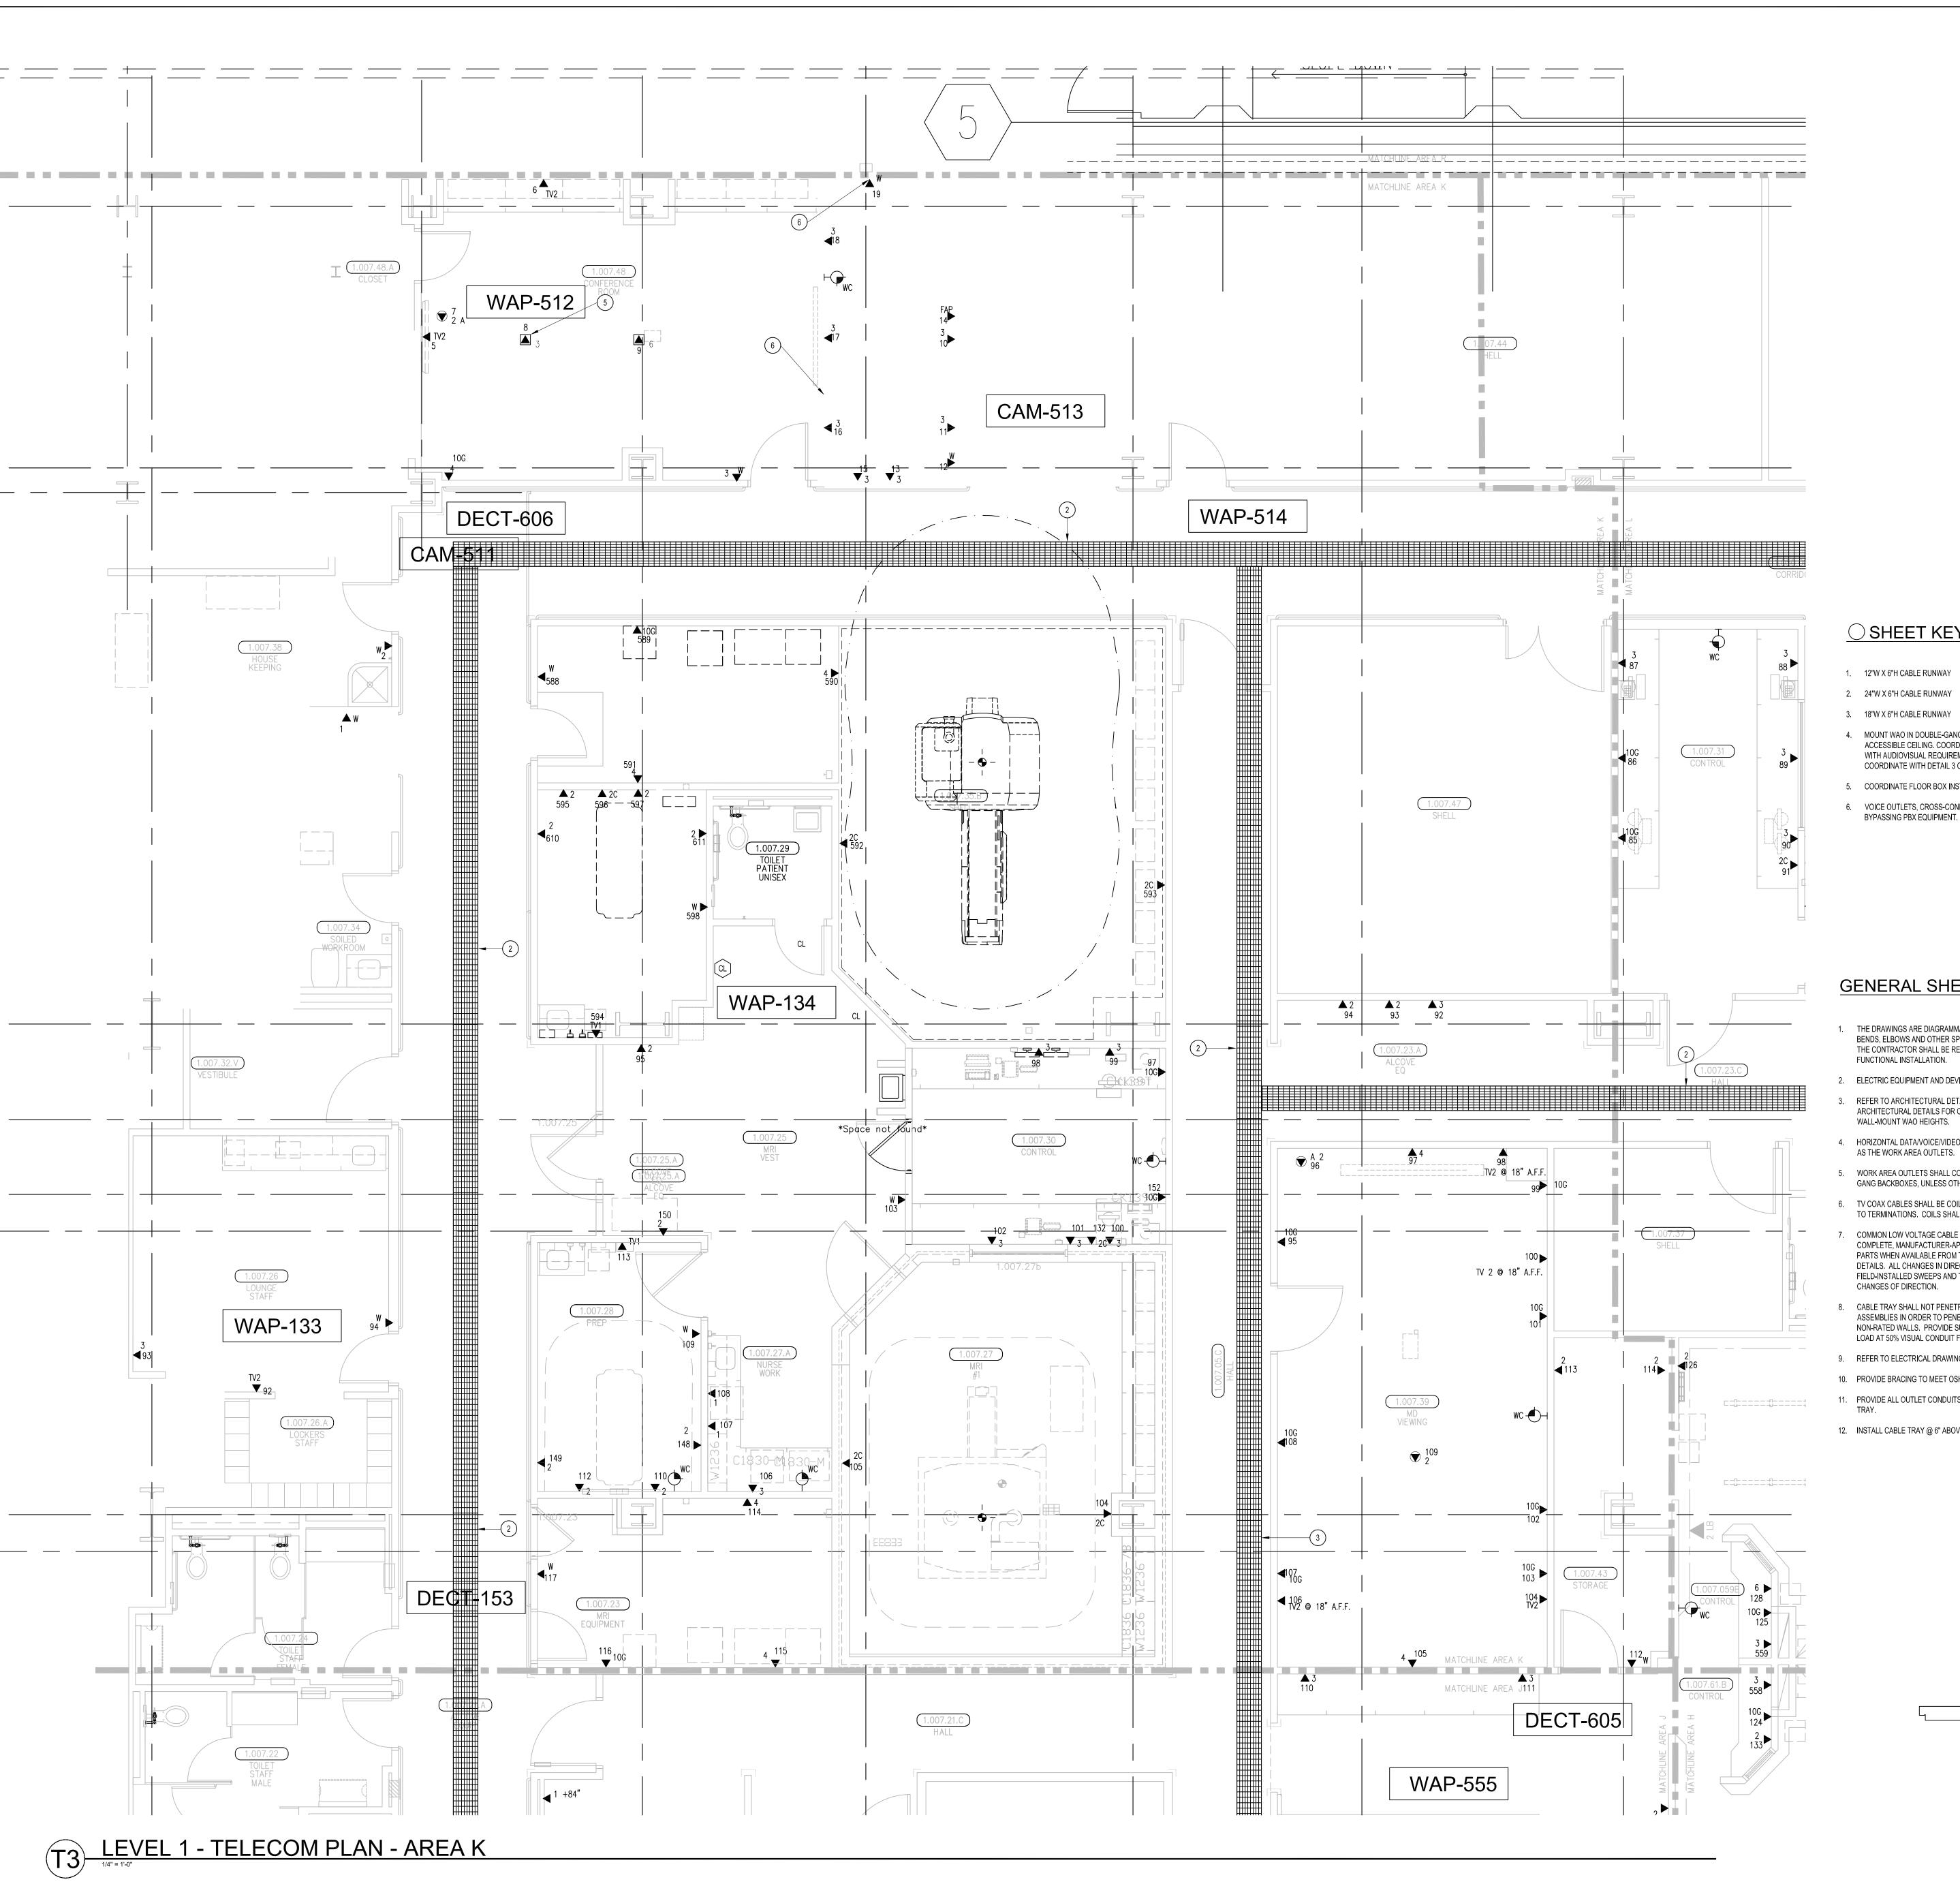




- 1. 12"W X 6"H CABLE RUNWAY
- 2. 24"W X 6"H CABLE RUNWAY
- 3. 18"W X 6"H CABLE RUNWAY
- 4. MOUNT WAO IN DOUBLE-GANG BACKBOX; STUB ONE (1) 1" EMT TO ACCESSIBLE CEILING. COORDINATE CABLING AND BACKBOX INSTALLATION WITH AUDIOVISUAL REQUIREMENTS AS DESCRIBED ON AV SHEET TA3.1C. COORDINATE WITH DETAIL 3 ON AV SHEET TA5.01 FOR MOUNTING HEIGHT.
- 5. COORDINATE FLOOR BOX INSTALLATION WITH AV SHEET TA3.1C.
- VOICE OUTLETS, CROSS-CONNECT TO SERVICE PROVIDER POTS LINES

GENERAL SHEET NOTES

- THE DRAWINGS ARE DIAGRAMMATIC ONLY AND MAY NOT SHOW ALL COMPONENTS, MATERIALS, OFFSETS, BENDS, ELBOWS AND OTHER SPECIFIC ELEMENTS THAT MAY BE REQUIRED FOR A COMPLETE INSTALLATION. THE CONTRACTOR SHALL BE RESPONSIBLE FOR PROVIDING ALL MATERIALS NEEDED FOR A COMPLETE AND
- ELECTRIC EQUIPMENT AND DEVICES (E.G. PBX, NETWORK SWITCHES) ARE SHOWN FOR REFERENCE ONLY. REFER TO ARCHITECTURAL DETAIL PLANS FOR FINAL PATIENT ROOM DEVICE LOCATIONS. REFER TO ARCHITECTURAL DETAILS FOR OVERCOUNTER WAO HEIGHTS. REFER TO ARCHITECTURAL DETAILS FOR
- HORIZONTAL DATA/VOICE/VIDEO CABLE SHALL TERMINATE IN THE TECHNOLOGY ROOM ON THE SAME FLOOR
- WORK AREA OUTLETS SHALL CONSIST OF SINGLE PLASTER REDUCING RINGS INSTALLED ON OVERSIZE DOUBLE GANG BACKBOXES, UNLESS OTHERWISE NOTED.
- TV COAX CABLES SHALL BE COILED IN THE RESPECTIVE TECHNOLOGY ROOMS WITH A 20' SERVICE LOOP PRIOR TO TERMINATIONS. COILS SHALL BE SECURED TO THE AUDIOVISUAL WALL FIELD FOR AV CONTRACTOR.
- PARTS WHEN AVAILABLE FROM THE MANUFACTURER AND AS INTENDED. REFER TO DRAWING T4.01 FOR DETAILS. ALL CHANGES IN DIRECTION AND INTERSECTIONS SHALL USE PRE-MANUFACTURED OR FIELD-INSTALLED SWEEPS AND TEES. ALL SWEEPS AND TEES SHALL MAINTAIN A 1 FOOT MINIMUM RADIUS IN
- CABLE TRAY SHALL NOT PENETRATE WALLS. PROVIDE TRANSITION FROM CABLE TRAY TO LISTED FIRESTOP ASSEMBLIES IN ORDER TO PENETRATE FIRE/SMOKE WALLS. TRANSITION TO 4" CONDUITS/SLEEVES FOR NON-RATED WALLS. PROVIDE SUFFICIENT CONDUITS/SLEEVES TO ACCOMMODATE 100% VISUAL CABLE TRAY LOAD AT 50% VISUAL CONDUIT FILL.
- REFER TO ELECTRICAL DRAWINGS & SPECIFICATIONS FOR SHARED FLOOR BOXES & LOW VOLTAGE CONDUIT.
- 10. PROVIDE BRACING TO MEET OSHPD SEISMIC REQUIREMENTS. REFER TO SHEET T4.02 FOR MORE INFORMATION
- 11. PROVIDE ALL OUTLET CONDUITS FROM WORK AREA OUTLETS., DEVICES OR PULL BOXES TO NEAREST CABLE
- 12. INSTALL CABLE TRAY @ 6" ABOVE CEILING.

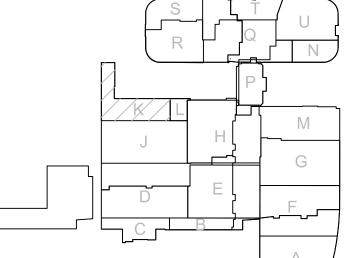

KEY PLAN

FLOOR PLAN LEVEL 1 AREA-K

T3.1K

PROPRIETARY STATEMENT THESE DRAWINGS/DOCUMENTS HEREIN ATTACHED ARE THE PROPERTY OF BERGELECTRIC CORPORATION ANY REUSE OR REPRODUCTION OF THESE DOCUMENTS WITHOUT WRITTEN PERMISSION OF BERGELECTRIC CORPORATION IS STRICTLY FORBIDDEN. ALL RIGHTS RESERVED.

J.RAMIREZ

DESIGN SUPERVISOR:

INSTALL SUPERVISOR:

Scott Adams Tel Data Systems Bergelectric Corporation 650 Opper Street Escondido, CA 92029

05-30-12 RECORD DRAWINGS


SHEET TITLE:

TELECOM

SCALE: 1/4"=1'0"

DRAWING NO.:

RECORD DRAWING

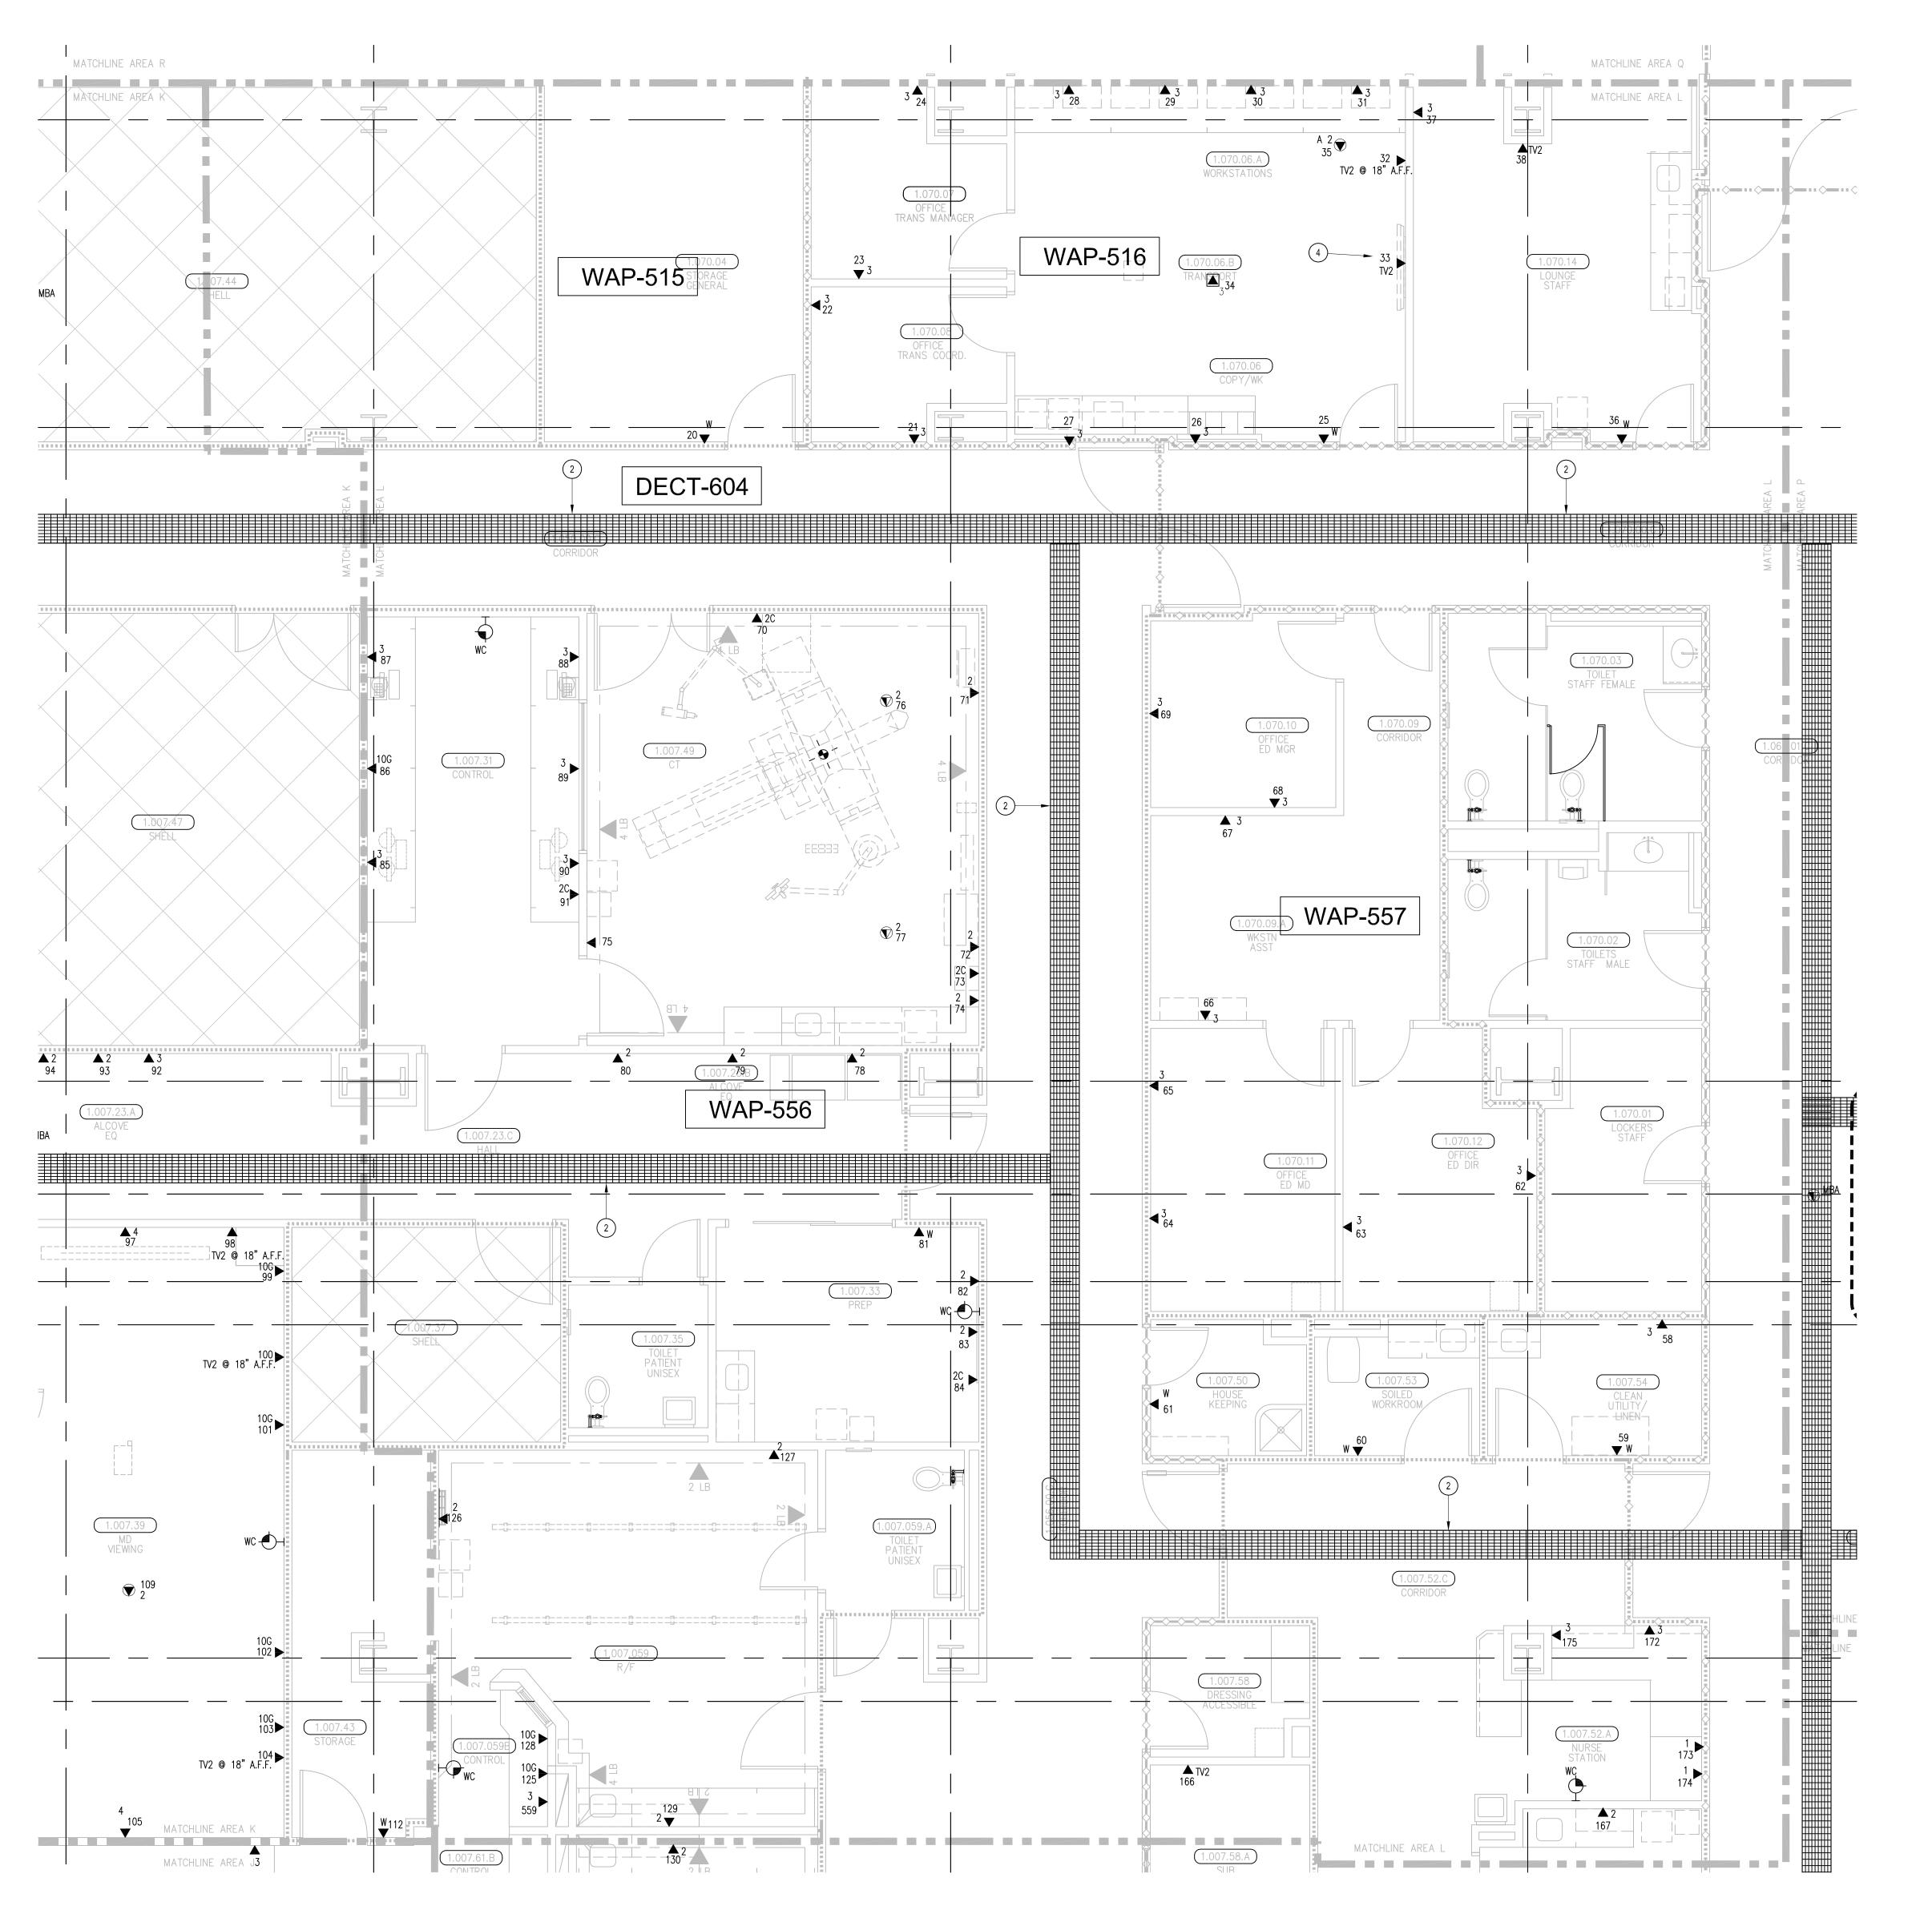

T3 LEVEL 1 - TELECOM PLAN - AREA L

SHEET KEYNOTES


- 1. 12"W X 6"H CABLE RUNWAY

- TO ACCESSIBLE CEILING. COORDINATE CABLING AND AS DESCRIBED ON AV SHEET TA3.1C. COORDINATE WITH DETAIL 3 ON AV SHEET TA5.01 FOR MOUNTING HEIGHT.

GENERAL SHEET NOTES

WALL-MOUNT WAO HEIGHTS.


- 1. THE DRAWINGS ARE DIAGRAMMATIC ONLY AND MAY NOT SHOW ALL COMPONENTS, MATERIALS, OFFSETS, BENDS, ELBOWS AND OTHER SPECIFIC ELEMENTS THAT MAY BE REQUIRED FOR A COMPLETE INSTALLATION. THE CONTRACTOR SHALL BE RESPONSIBLE FOR PROVIDING ALL MATERIALS NEEDED FOR A COMPLETE AND
- 2. ELECTRIC EQUIPMENT AND DEVICES (E.G. PBX, NETWORK SWITCHES) ARE SHOWN FOR REFERENCE ONLY. REFER TO ARCHITECTURAL DETAIL PLANS FOR FINAL PATIENT ROOM DEVICE LOCATIONS. REFER TO ARCHITECTURAL DETAILS FOR OVERCOUNTER WAO HEIGHTS. REFER TO ARCHITECTURAL DETAILS FOR
- AS THE WORK AREA OUTLETS.
- 5. WORK AREA OUTLETS SHALL CONSIST OF SINGLE PLASTER REDUCING RINGS INSTALLED ON OVERSIZE DOUBLE GANG BACKBOXES, UNLESS OTHERWISE NOTED.
- 6. TV COAX CABLES SHALL BE COILED IN THE RESPECTIVE TECHNOLOGY ROOMS WITH A 20' SERVICE LOOP PRIOR
- 7. COMMON LOW VOLTAGE CABLE RUNWAY IS 24" W X 6" HIGH. PROVIDE ALL MATERIALS AS NEEDED FOR A COMPLETE, MANUFACTURER-APPROVED SYSTEM USING CABLE TRAY MANUFACTURERS' MATERIALS AND PARTS WHEN AVAILABLE FROM THE MANUFACTURER AND AS INTENDED. REFER TO DRAWING T4.01 FOR DETAILS. ALL CHANGES IN DIRECTION AND INTERSECTIONS SHALL USE PRE-MANUFACTURED OR FIELD-INSTALLED SWEEPS AND TEES. ALL SWEEPS AND TEES SHALL MAINTAIN A 1 FOOT MINIMUM RADIUS IN CHANGES OF DIRECTION.
- CABLE TRAY SHALL NOT PENETRATE WALLS. PROVIDE TRANSITION FROM CABLE TRAY TO LISTED FIRESTOP ASSEMBLIES IN ORDER TO PENETRATE FIRE/SMOKE WALLS. TRANSITION TO 4" CONDUITS/SLEEVES FOR NON-RATED WALLS. PROVIDE SUFFICIENT CONDUITS/SLEEVES TO ACCOMMODATE 100% VISUAL CABLE TRAY LOAD AT 50% VISUAL CONDUIT FILL.
- 11. PROVIDE ALL OUTLET CONDUITS FROM WORK AREA OUTLETS., DEVICES OR PULL BOXES TO NEAREST CABLE
- 12. INSTALL CABLE TRAY @ 6" ABOVE CEILING.

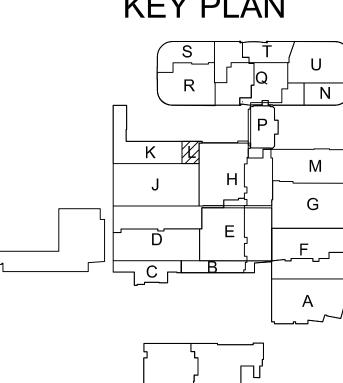



- 2. 24"W X 6"H CABLE RUNWAY
- 3. 18"W X 6"H CABLE RUNWAY
- 4. MOUNT WAO IN DOUBLE-GANG BACKBOX; STUB ONE (1) 1" EMT BACKBOX INSTALLATION WITH AUDIOVISUAL REQUIREMENTS

- FUNCTIONAL INSTALLATION.
- 4. HORIZONTAL DATA/VOICE/VIDEO CABLE SHALL TERMINATE IN THE TECHNOLOGY ROOM ON THE SAME FLOOR
- TO TERMINATIONS. COILS SHALL BE SECURED TO THE AUDIOVISUAL WALL FIELD FOR AV CONTRACTOR.
- 9. REFER TO ELECTRICAL DRAWINGS & SPECIFICATIONS FOR SHARED FLOOR BOXES & LOW VOLTAGE CONDUIT.
- 10. PROVIDE BRACING TO MEET OSHPD SEISMIC REQUIREMENTS. REFER TO SHEET T4.02 FOR MORE INFORMATION

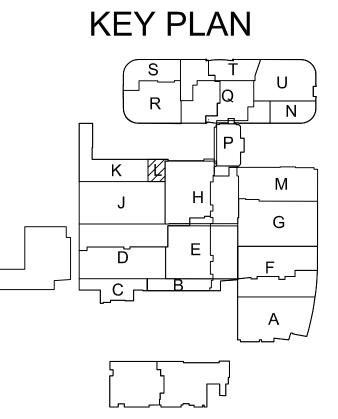

PROPRIETARY STATEMENT THESE DRAWINGS/DOCUMENTS HEREIN ATTACHED ARE THE PROPERTY OF BERGELECTRIC CORPORATION ANY REUSE OR REPRODUCTION OF THESE DOCUMENTS WITHOUT WRITTEN PERMISSION OF BERGELECTRIC CORPORATION IS STRICTLY FORBIDDEN. ALL RIGHTS RESERVED.

J.RAMIREZ

DESIGN SUPERVISOR:

INSTALL SUPERVISOR: Scott Adams Tel Data Systems
Bergelectric Corporation
650 Opper Street
Escondido, CA 92029


REVISION:
05-30-12 RECORD DRAWINGS

SHEET TITLE:

TELECOM FLOOR PLAN LEVEL 1 AREA-L

> SCALE: 1/4"=1'0"


T3.1L RECORD DRAWING

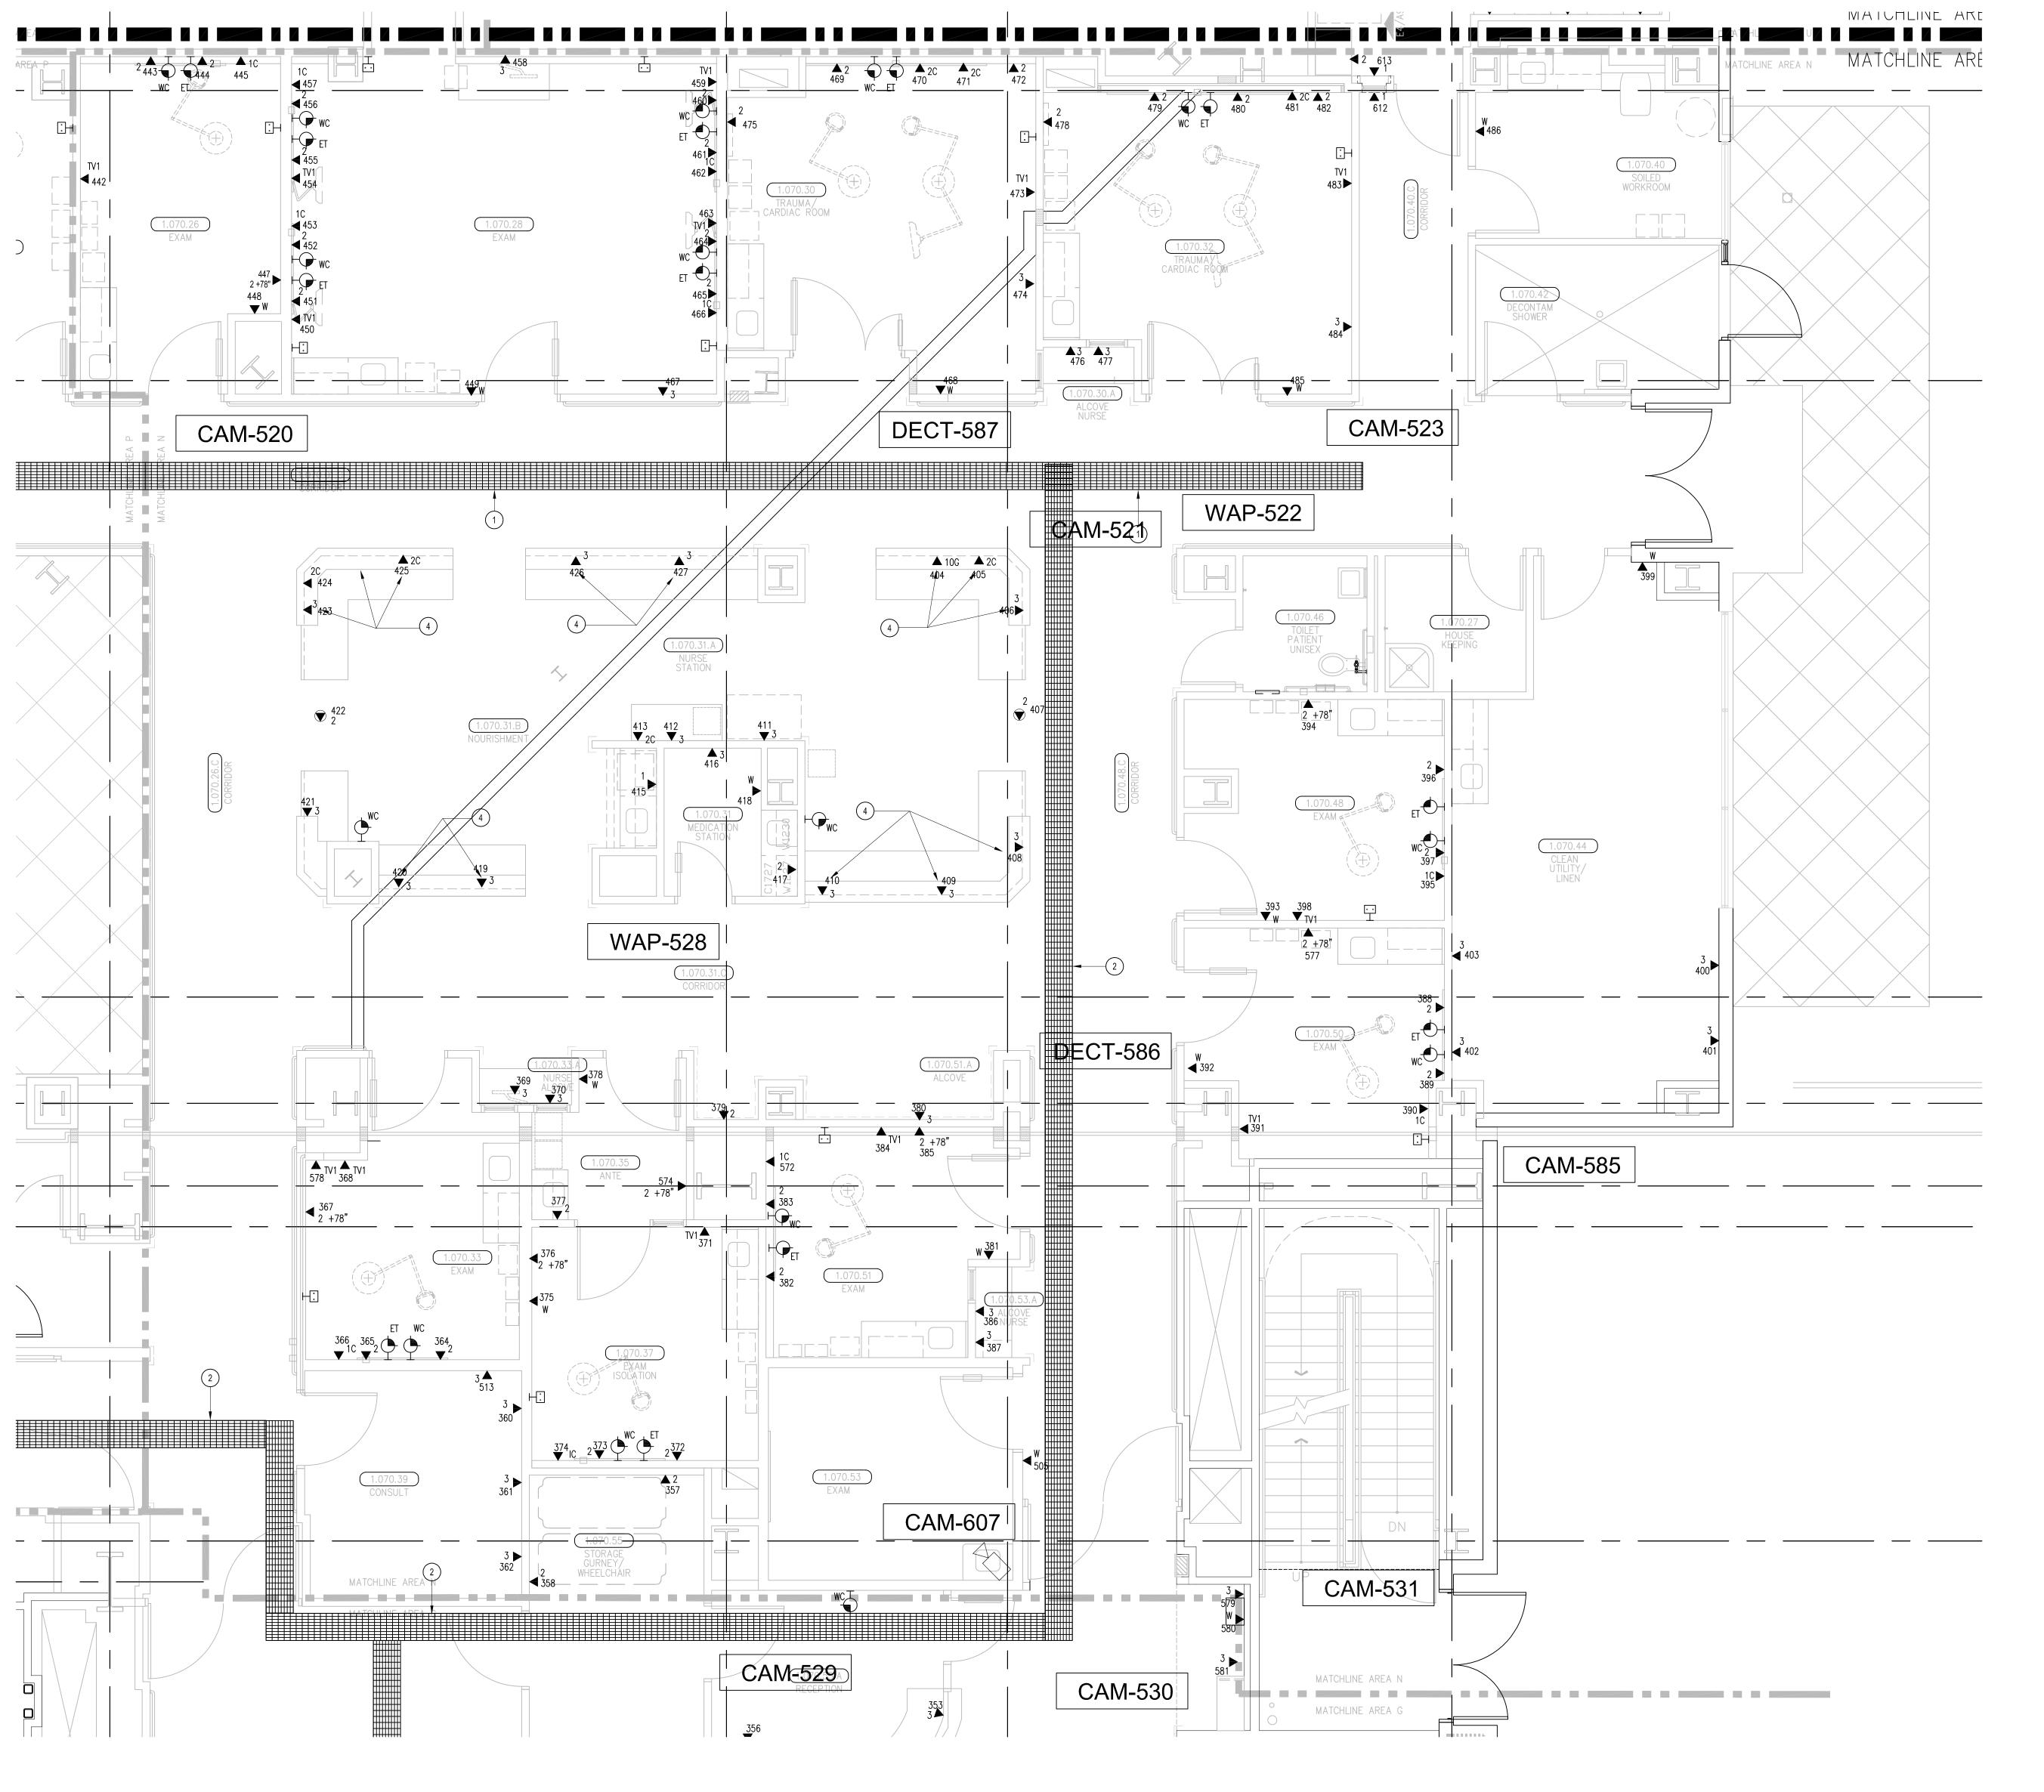


- 1. 12"W X 6"H CABLE RUNWAY
- 2. 24"W X 6"H CABLE RUNWAY
- 3. 18"W X 6"H CABLE RUNWAY
- 4. OUTLETS ARE TO BE FED VIA WALL FROM ABOVE CEILING SPACE. PROVIDE TWO (2) 1-1/4" CONDUITS FROM CABLE RUNWAY TO MILLWORK. TERMINATE CONDUITS AT 24" A.F.F. AND EXTEND ONTO MILLWORK USING NON-METALLIC SURFACE RACEWAYS WITH MINIMUM OF 1"x1" INTERNAL AREA TO EACH OUTLET.

GENERAL SHEET NOTES

- THE DRAWINGS ARE DIAGRAMMATIC ONLY AND MAY NOT SHOW ALL COMPONENTS, MATERIALS, OFFSETS, BENDS, ELBOWS AND OTHER SPECIFIC ELEMENTS THAT MAY BE REQUIRED FOR A COMPLETE INSTALLATION. THE CONTRACTOR SHALL BE RESPONSIBLE FOR PROVIDING ALL MATERIALS NEEDED FOR A COMPLETE AND FUNCTIONAL INSTALLATION.
- 2. ELECTRIC EQUIPMENT AND DEVICES (E.G. PBX, NETWORK SWITCHES) ARE SHOWN FOR REFERENCE ONLY. REFER TO ARCHITECTURAL DETAIL PLANS FOR FINAL PATIENT ROOM DEVICE LOCATIONS. REFER TO ARCHITECTURAL DETAILS FOR OVERCOUNTER WAO HEIGHTS. REFER TO ARCHITECTURAL DETAILS FOR WALL-MOUNT WAO HEIGHTS.
- 4. HORIZONTAL DATA/VOICE/VIDEO CABLE SHALL TERMINATE IN THE TECHNOLOGY ROOM ON THE SAME FLOOR AS THE WORK AREA OUTLETS.
- WORK AREA OUTLETS SHALL CONSIST OF SINGLE PLASTER REDUCING RINGS INSTALLED ON OVERSIZE DOUBLE GANG BACKBOXES, UNLESS OTHERWISE NOTED.
- 6. TV COAX CABLES SHALL BE COILED IN THE RESPECTIVE TECHNOLOGY ROOMS WITH A 20' SERVICE LOOP PRIOR TO TERMINATIONS. COILS SHALL BE SECURED TO THE AUDIOVISUAL WALL FIELD FOR AV CONTRACTOR.
- 7. COMMON LOW VOLTAGE CABLE RUNWAY IS 24" W X 6" HIGH. PROVIDE ALL MATERIALS AS NEEDED FOR A COMPLETE, MANUFACTURER-APPROVED SYSTEM USING CABLE TRAY MANUFACTURERS' MATERIALS AND PARTS WHEN AVAILABLE FROM THE MANUFACTURER AND AS INTENDED. REFER TO DRAWING T4.01 FOR DETAILS. ALL CHANGES IN DIRECTION AND INTERSECTIONS SHALL USE PRE-MANUFACTURED OR FIELD-INSTALLED SWEEPS AND TEES. ALL SWEEPS AND TEES SHALL MAINTAIN A 1 FOOT MINIMUM RADIUS IN CHANGES OF DIRECTION.
- CABLE TRAY SHALL NOT PENETRATE WALLS. PROVIDE TRANSITION FROM CABLE TRAY TO LISTED FIRESTOP ASSEMBLIES IN ORDER TO PENETRATE FIRE/SMOKE WALLS. TRANSITION TO 4" CONDUITS/SLEEVES FOR NON-RATED WALLS. PROVIDE SUFFICIENT CONDUITS/SLEEVES TO ACCOMMODATE 100% VISUAL CABLE TRAY LOAD AT 50% VISUAL CONDUIT FILL.
- 9. REFER TO ELECTRICAL DRAWINGS & SPECIFICATIONS FOR SHARED FLOOR BOXES & LOW VOLTAGE CONDUIT.
- 10. PROVIDE BRACING TO MEET OSHPD SEISMIC REQUIREMENTS. REFER TO SHEET T4.02 FOR MORE INFORMATION
- 11. PROVIDE ALL OUTLET CONDUITS FROM WORK AREA OUTLETS., DEVICES OR PULL BOXES TO NEAREST CABLE
- 12. INSTALL CABLE TRAY @ 6" ABOVE CEILING.

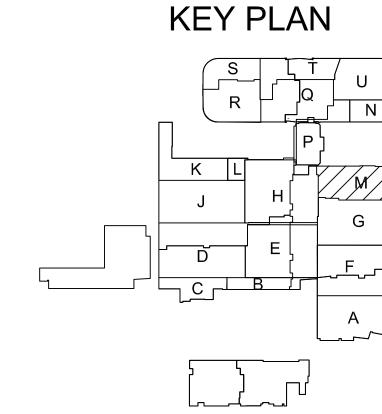

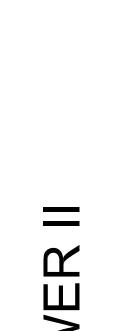

KEN'S NNGE Street 868-3874

PROPRIETARY STATEMENT

THESE DRAWINGS/DOCUMENTS HEREIN ATTACHED ARE THE PROPERTY OF BERGELECTRIC CORPORATION ANY REUSE OR REPRODUCTION OF THESE DOCUMENTS WITHOUT WRITTEN PERMISSION OF BERGELECTRIC CORPORATION IS STRICTLY FORBIDDEN. ALL RIGHTS RESERVED.

> J.RAMIREZ DESIGN SUPERVISOR:

INSTALL SUPERVISOR: Scott Adams Tel Data Systems Bergelectric Corporation 650 Opper Street Escondido, CA 92029

05-30-12 RECORD DRAWINGS


SHEET TITLE:

TELECOM FLOOR PLAN LEVEL 1 AREA-M

> SCALE: 1/4"=1'0"

T3.1M RECORD DRAWING

T3 LEVEL 1 - TELECOM PLAN - AREA M

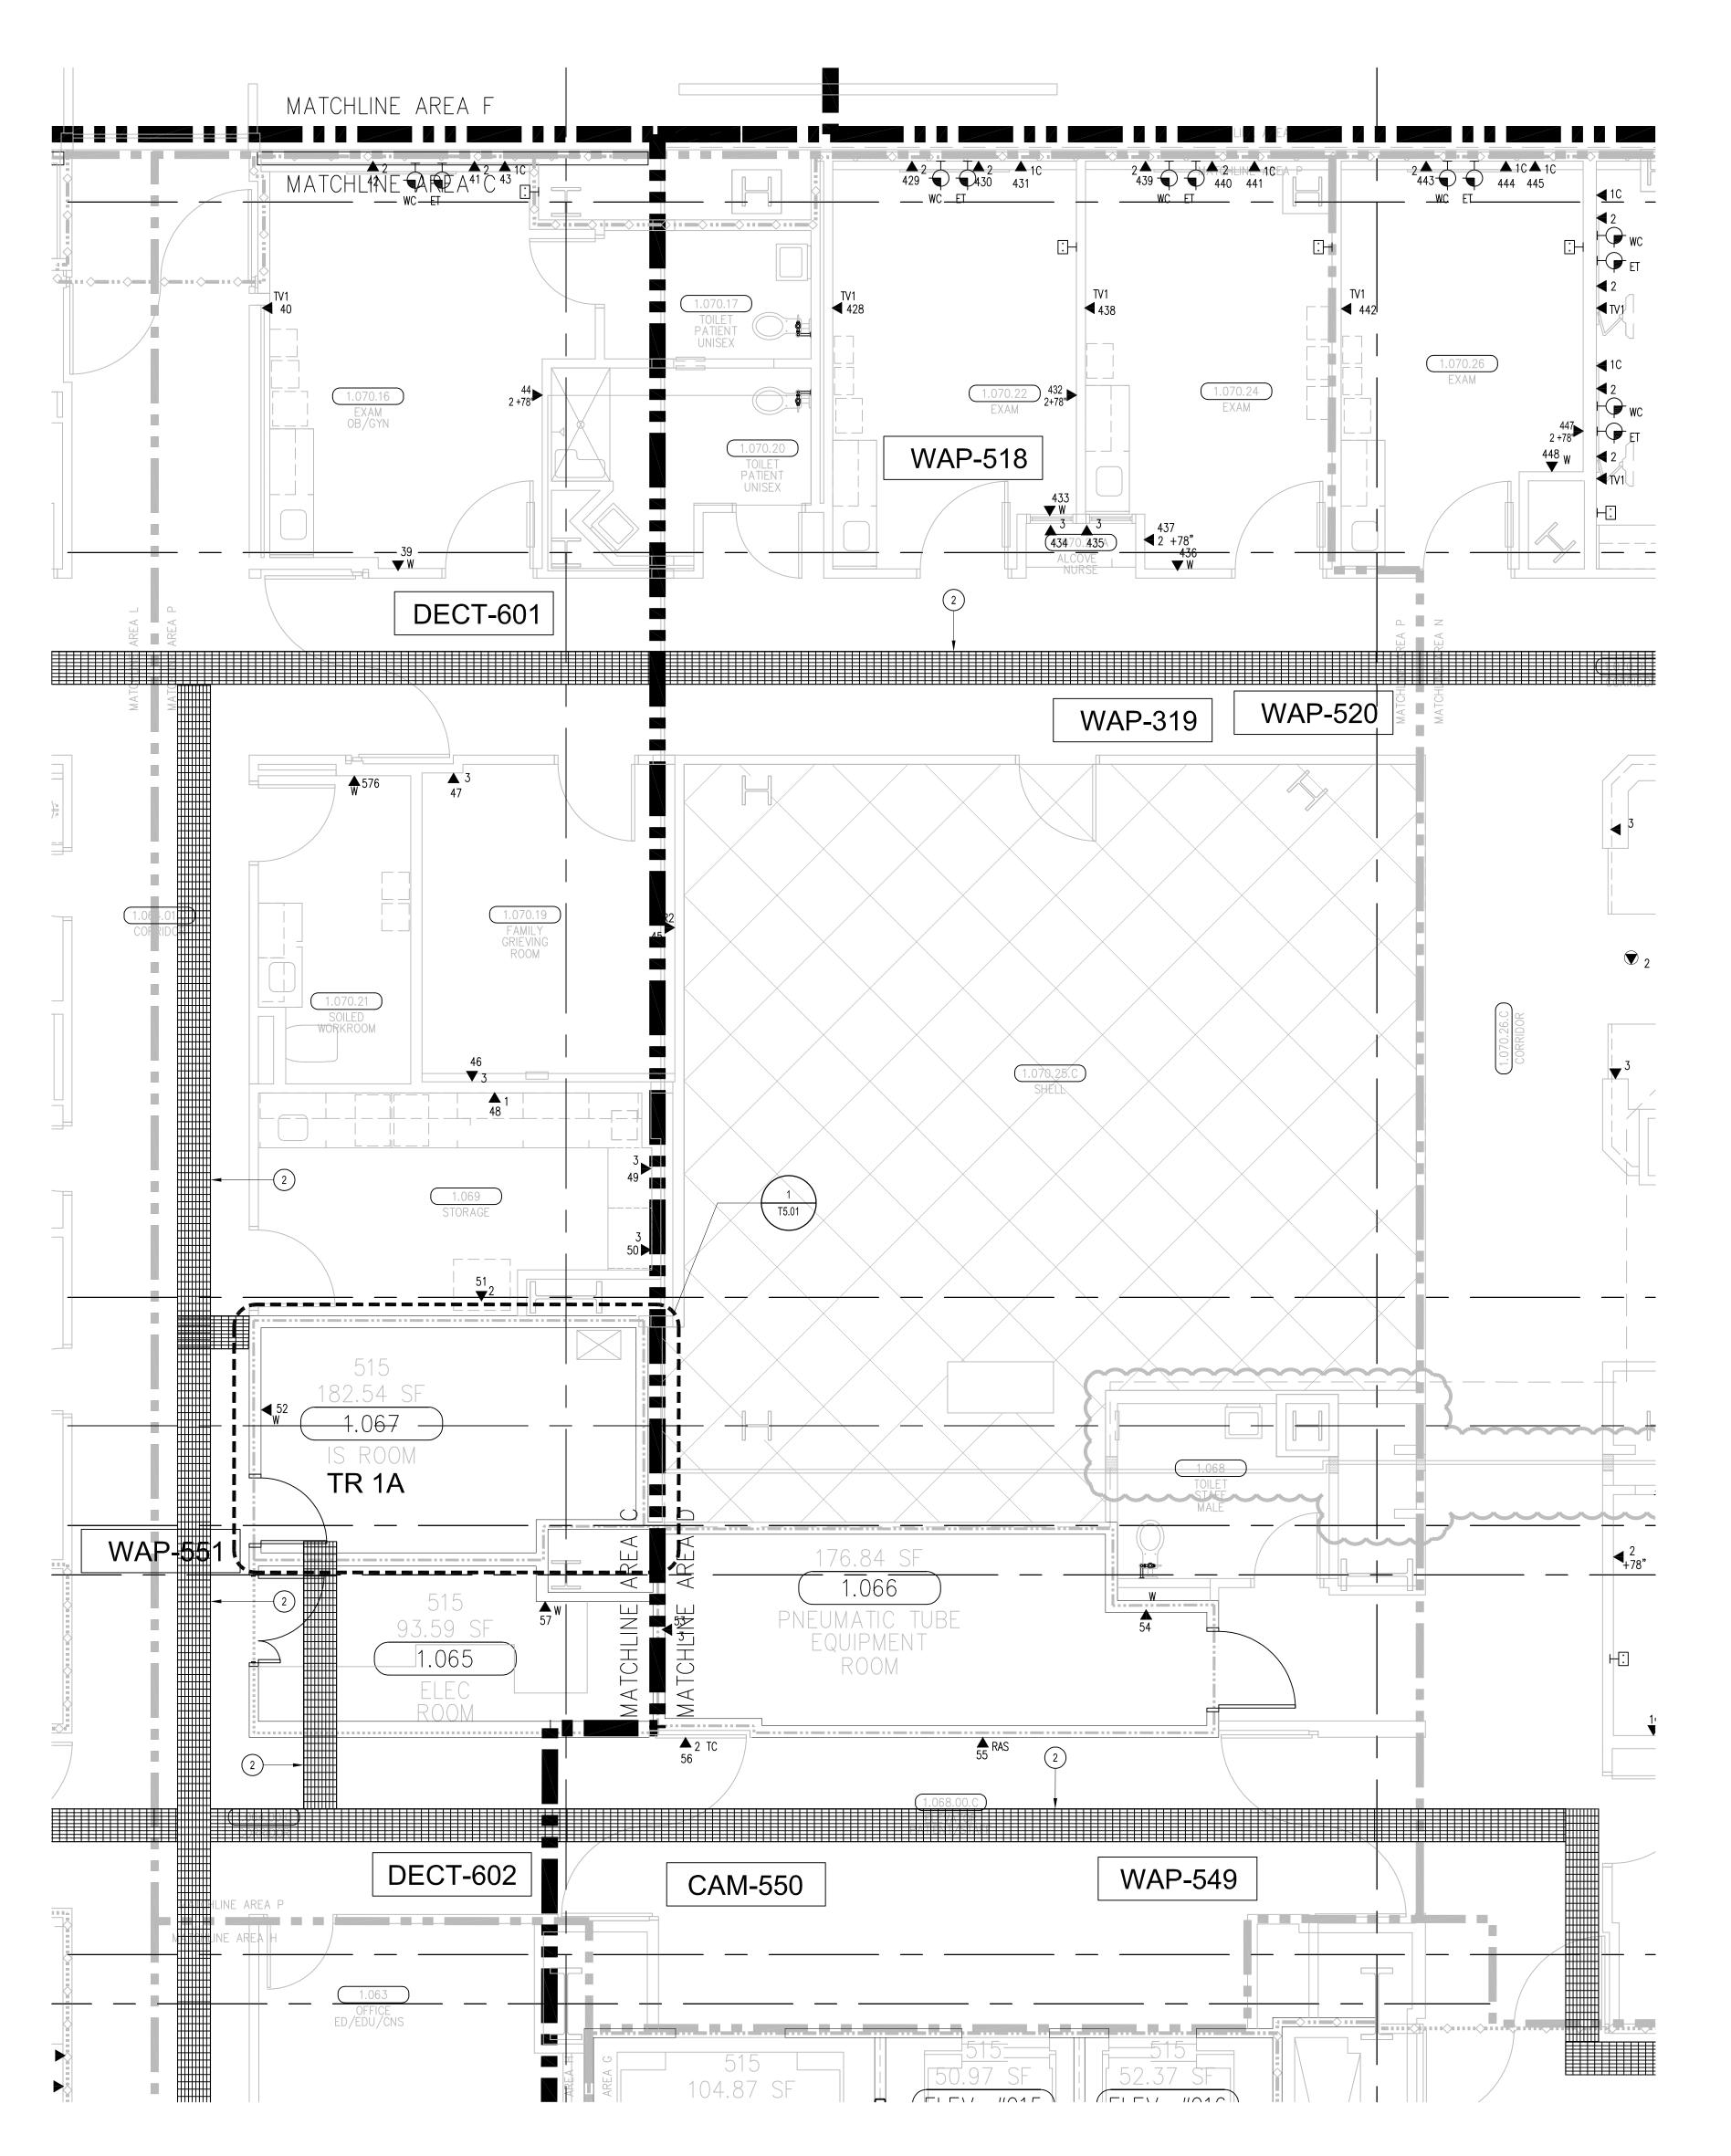



- 1. 12"W X 6"H CABLE RUNWAY
- 2. 24"W X 6"H CABLE RUNWAY
- 3. 18"W X 6"H CABLE RUNWAY

GENERAL SHEET NOTES

WALL-MOUNT WAO HEIGHTS.

- 1. THE DRAWINGS ARE DIAGRAMMATIC ONLY AND MAY NOT SHOW ALL COMPONENTS, MATERIALS, OFFSETS, BENDS, ELBOWS AND OTHER SPECIFIC ELEMENTS THAT MAY BE REQUIRED FOR A COMPLETE INSTALLATION. THE CONTRACTOR SHALL BE RESPONSIBLE FOR PROVIDING ALL MATERIALS NEEDED FOR A COMPLETE AND FUNCTIONAL INSTALLATION.
- ELECTRIC EQUIPMENT AND DEVICES (E.G. PBX, NETWORK SWITCHES) ARE SHOWN FOR REFERENCE ONLY.
 REFER TO ARCHITECTURAL DETAIL PLANS FOR FINAL PATIENT ROOM DEVICE LOCATIONS. REFER TO ARCHITECTURAL DETAILS FOR OVERCOUNTER WAO HEIGHTS. REFER TO ARCHITECTURAL DETAILS FOR
- 4. HORIZONTAL DATA/VOICE/VIDEO CABLE SHALL TERMINATE IN THE TECHNOLOGY ROOM ON THE SAME FLOOR AS THE WORK AREA OUTLETS.
- 5. WORK AREA OUTLETS SHALL CONSIST OF SINGLE PLASTER REDUCING RINGS INSTALLED ON OVERSIZE DOUBLE GANG BACKBOXES, UNLESS OTHERWISE NOTED.
- 6. TV COAX CABLES SHALL BE COILED IN THE RESPECTIVE TECHNOLOGY ROOMS WITH A 20' SERVICE LOOP PRIOR TO TERMINATIONS. COILS SHALL BE SECURED TO THE AUDIOVISUAL WALL FIELD FOR AV CONTRACTOR.
- 7. COMMON LOW VOLTAGE CABLE RUNWAY IS 24" W X 6" HIGH. PROVIDE ALL MATERIALS AS NEEDED FOR A COMPLETE, MANUFACTURER-APPROVED SYSTEM USING CABLE TRAY MANUFACTURERS' MATERIALS AND PARTS WHEN AVAILABLE FROM THE MANUFACTURER AND AS INTENDED. REFER TO DRAWING T4.01 FOR DETAILS. ALL CHANGES IN DIRECTION AND INTERSECTIONS SHALL USE PRE-MANUFACTURED OR FIELD-INSTALLED SWEEPS AND TEES. ALL SWEEPS AND TEES SHALL MAINTAIN A 1 FOOT MINIMUM RADIUS IN CHANGES OF DIRECTION.
- 8. CABLE TRAY SHALL NOT PENETRATE WALLS. PROVIDE TRANSITION FROM CABLE TRAY TO LISTED FIRESTOP ASSEMBLIES IN ORDER TO PENETRATE FIRE/SMOKE WALLS. TRANSITION TO 4" CONDUITS/SLEEVES FOR NON-RATED WALLS. PROVIDE SUFFICIENT CONDUITS/SLEEVES TO ACCOMMODATE 100% VISUAL CABLE TRAY LOAD AT 50% VISUAL CONDUIT FILL.
- 9. REFER TO ELECTRICAL DRAWINGS & SPECIFICATIONS FOR SHARED FLOOR BOXES & LOW VOLTAGE CONDUIT.
- 10. PROVIDE BRACING TO MEET OSHPD SEISMIC REQUIREMENTS. REFER TO SHEET T4.02 FOR MORE INFORMATION
- 11. PROVIDE ALL OUTLET CONDUITS FROM WORK AREA OUTLETS., DEVICES OR PULL BOXES TO NEAREST CABLE
- 12. INSTALL CABLE TRAY @ 6" ABOVE CEILING.

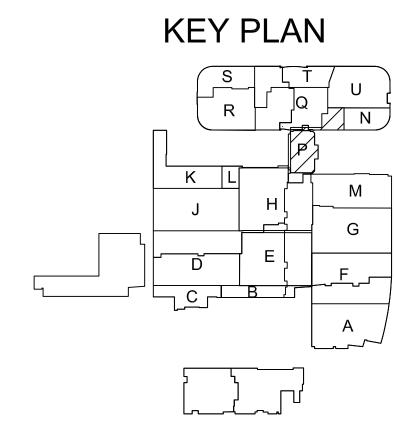

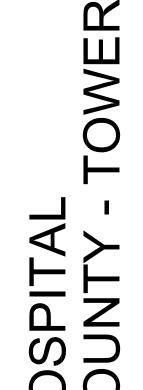

South Main Street ge, CA 92868-3874

05-30-12 RECORD S AV BNGS

ADDRESS: W.O. NO.:

PROPRIETARY STATEMENT

THESE DRAWINGS/DOCUMENTS HEREIN ATTACHED ARE THE PROPERTY OF BERGELECTRIC CORPORATION ANY REUSE OR REPRODUCTION OF THESE DOCUMENTS WITHOUT WRITTEN PERMISSION OF BERGELECTRIC CORPORATION IS STRICTLY FORBIDDEN. ALL RIGHTS RESERVED.

DRAWN BY:
J.RAMIREZ

DESIGN SUPERVISOR:

INSTALL SUPERVISOR:

Scott Adams Tel Data Systems Bergelectric Corporation 650 Opper Street Escondido, CA 92029

REVISION:

05-30-12 RECORD DRAWINGS

SHEET TITLE:


TELECOM FLOOR PLAN LEVEL 1 AREA-P

> scale: 1/4"=1'0"

DRAWING NO.

T3.1P RECORD DRAWING


T3 LEVEL 1 - TELECOM PLAN - AREA P

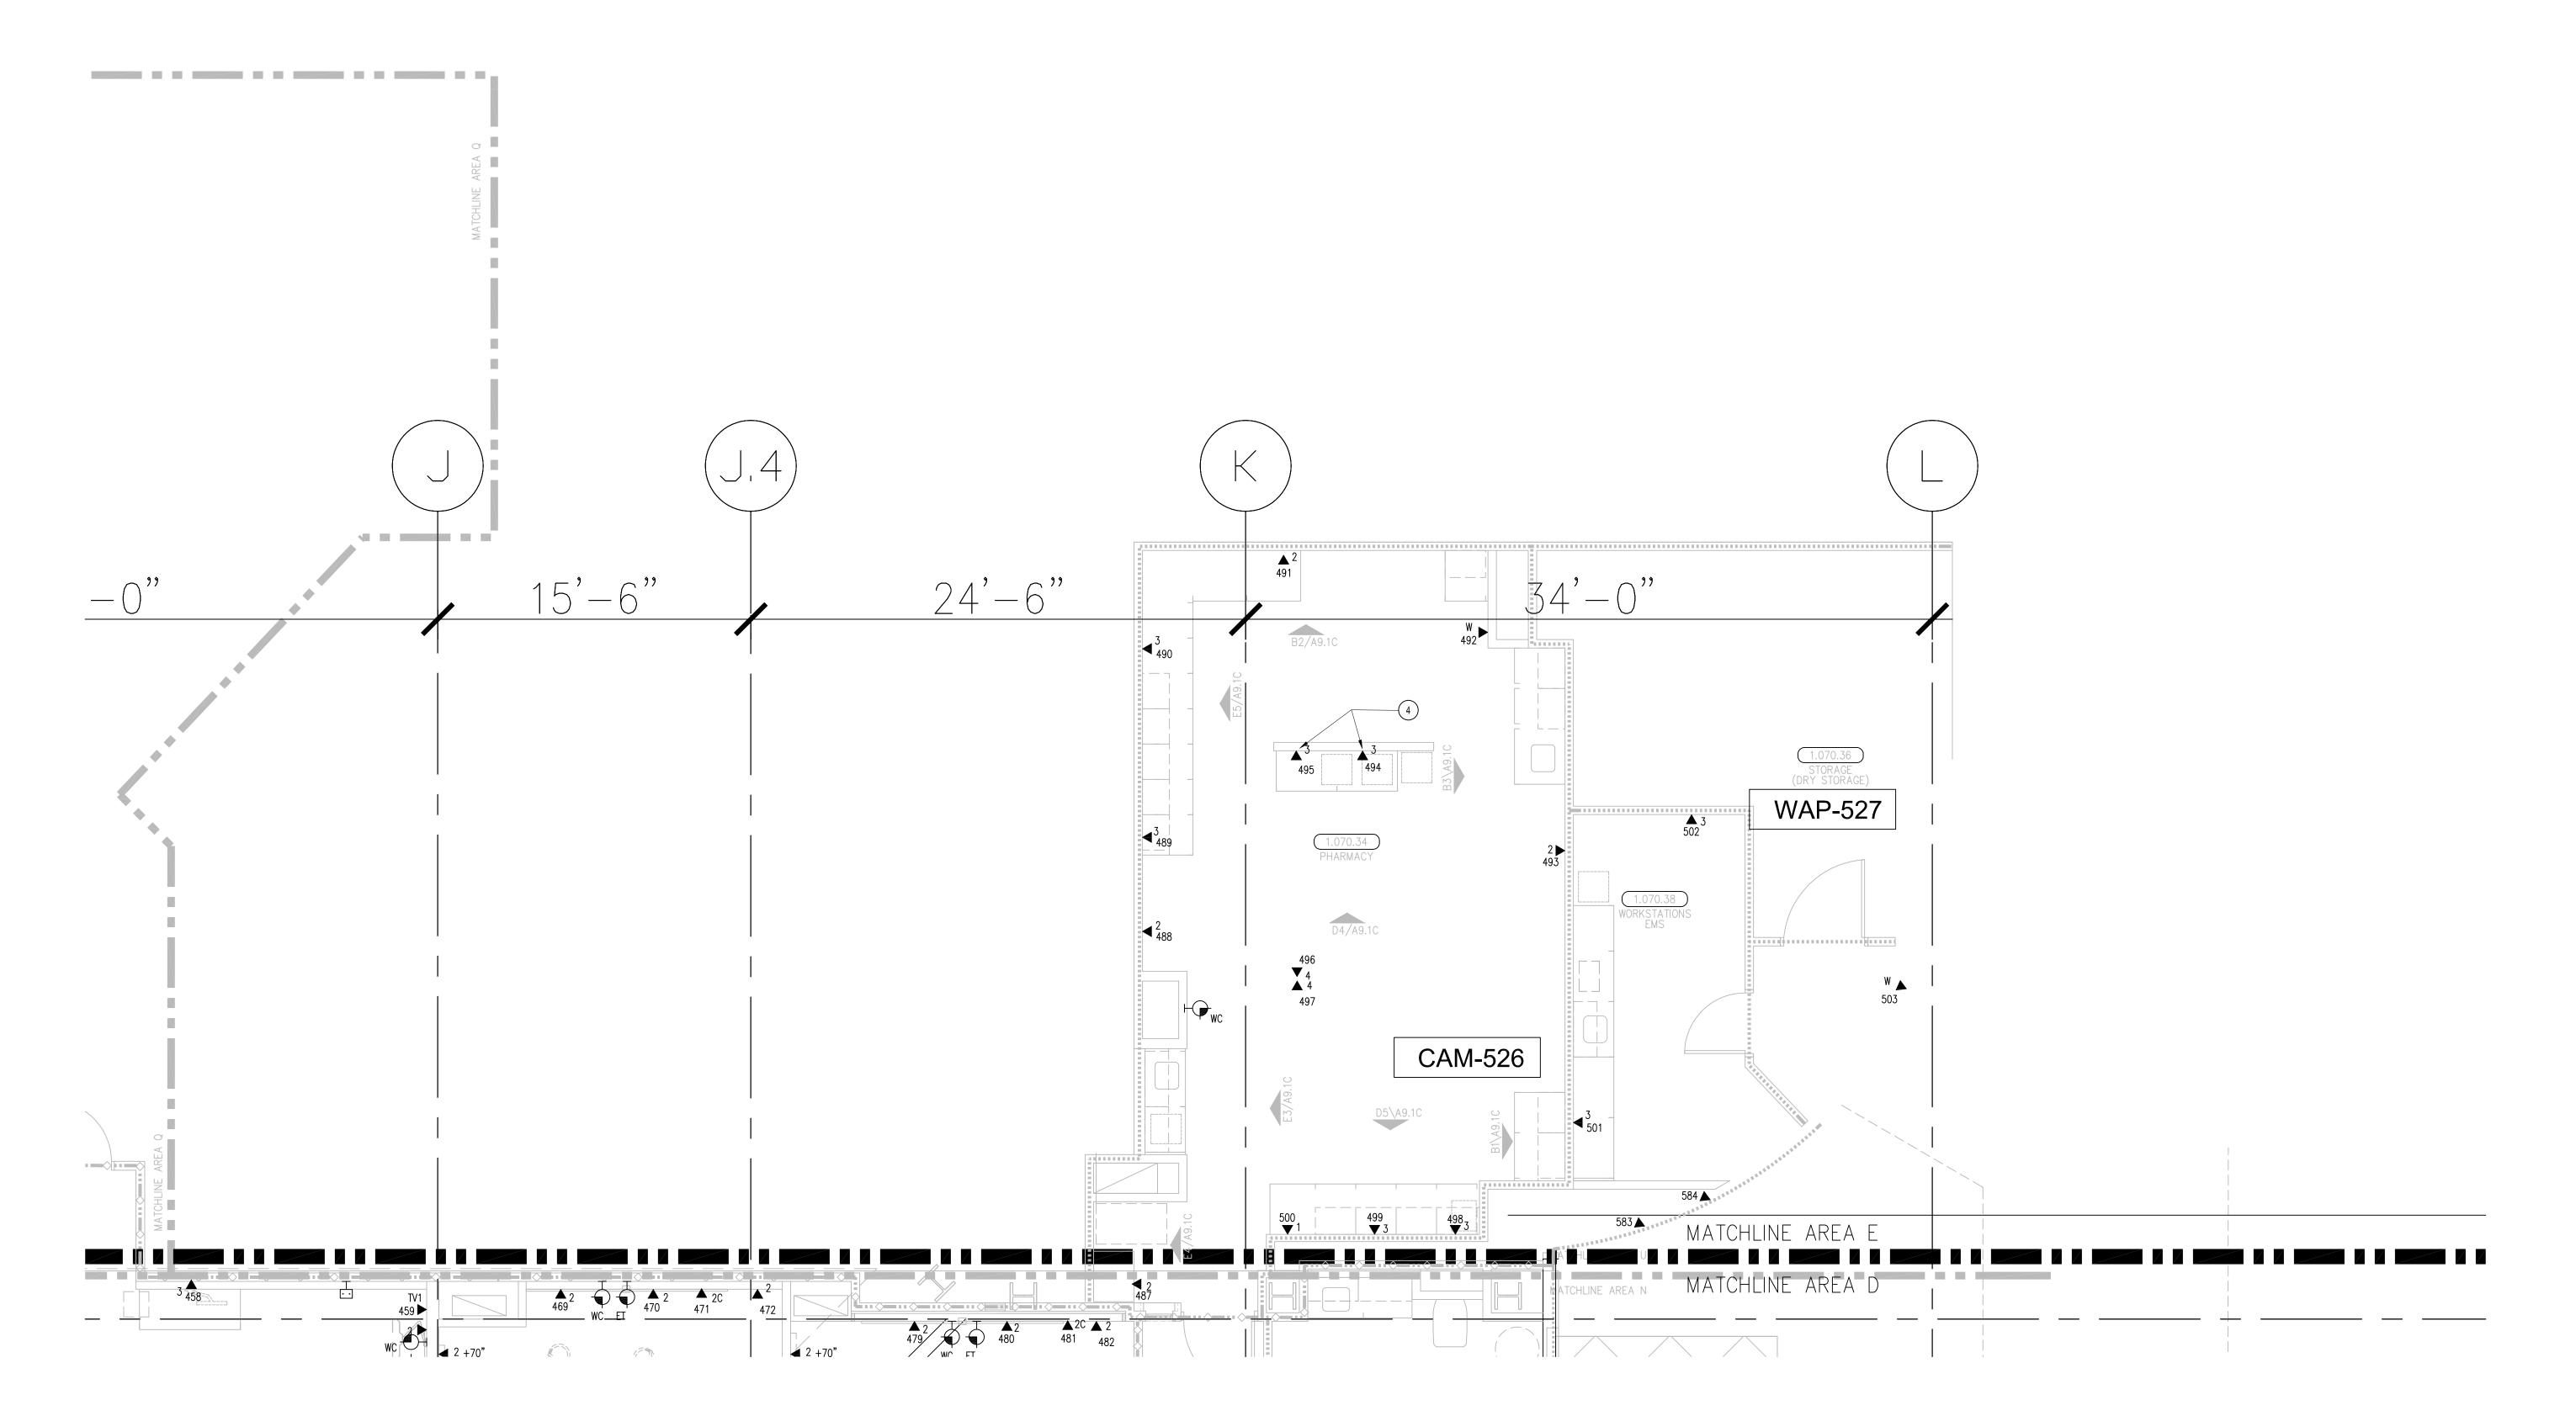


- 1. 12"W X 6"H CABLE RUNWAY
- 2. 24"W X 6"H CABLE RUNWAY
- 3. 18"W X 6"H CABLE RUNWAY
- 4. OUTLETS ARE TO BE FED VIA WALL FROM ABOVE CEILING SPACE. PROVIDE TWO (2) 1-1/4" CONDUITS FROM CABLE RUNWAY TO MILLWORK. TERMINATE CONDUITS AT 24" A.F.F. AND EXTEND ONTO MILLWORK USING NON-METALLIC SURFACE RACEWAYS WITH MINIMUM OF 1"x1" INTERNAL AREA TO EACH OUTLET.

GENERAL SHEET NOTES

- 1. THE DRAWINGS ARE DIAGRAMMATIC ONLY AND MAY NOT SHOW ALL COMPONENTS, MATERIALS, OFFSETS, BENDS, ELBOWS AND OTHER SPECIFIC ELEMENTS THAT MAY BE REQUIRED FOR A COMPLETE INSTALLATION. THE CONTRACTOR SHALL BE RESPONSIBLE FOR PROVIDING ALL MATERIALS NEEDED FOR A COMPLETE AND FUNCTIONAL INSTALLATION.
- 2. ELECTRIC EQUIPMENT AND DEVICES (E.G. PBX, NETWORK SWITCHES) ARE SHOWN FOR REFERENCE ONLY. 3. REFER TO ARCHITECTURAL DETAIL PLANS FOR FINAL PATIENT ROOM DEVICE LOCATIONS. REFER TO
- ARCHITECTURAL DETAILS FOR OVERCOUNTER WAO HEIGHTS. REFER TO ARCHITECTURAL DETAILS FOR WALL-MOUNT WAO HEIGHTS.
- 4. HORIZONTAL DATA/VOICE/VIDEO CABLE SHALL TERMINATE IN THE TECHNOLOGY ROOM ON THE SAME FLOOR AS THE WORK AREA OUTLETS.
- 5. WORK AREA OUTLETS SHALL CONSIST OF SINGLE PLASTER REDUCING RINGS INSTALLED ON OVERSIZE DOUBLE GANG BACKBOXES, UNLESS OTHERWISE NOTED.
- 6. TV COAX CABLES SHALL BE COILED IN THE RESPECTIVE TECHNOLOGY ROOMS WITH A 20' SERVICE LOOP PRIOR
- TO TERMINATIONS. COILS SHALL BE SECURED TO THE AUDIOVISUAL WALL FIELD FOR AV CONTRACTOR.
- 7. COMMON LOW VOLTAGE CABLE RUNWAY IS 24" W X 6" HIGH. PROVIDE ALL MATERIALS AS NEEDED FOR A COMPLETE, MANUFACTURER-APPROVED SYSTEM USING CABLE TRAY MANUFACTURERS' MATERIALS AND PARTS WHEN AVAILABLE FROM THE MANUFACTURER AND AS INTENDED. REFER TO DRAWING T4.01 FOR DETAILS. ALL CHANGES IN DIRECTION AND INTERSECTIONS SHALL USE PRE-MANUFACTURED OR FIELD-INSTALLED SWEEPS AND TEES. ALL SWEEPS AND TEES SHALL MAINTAIN A 1 FOOT MINIMUM RADIUS IN CHANGES OF DIRECTION.
- 8. CABLE TRAY SHALL NOT PENETRATE WALLS. PROVIDE TRANSITION FROM CABLE TRAY TO LISTED FIRESTOP ASSEMBLIES IN ORDER TO PENETRATE FIRE/SMOKE WALLS. TRANSITION TO 4" CONDUITS/SLEEVES FOR NON-RATED WALLS. PROVIDE SUFFICIENT CONDUITS/SLEEVES TO ACCOMMODATE 100% VISUAL CABLE TRAY LOAD AT 50% VISUAL CONDUIT FILL.
- 9. REFER TO ELECTRICAL DRAWINGS & SPECIFICATIONS FOR SHARED FLOOR BOXES & LOW VOLTAGE CONDUIT.
- 10. PROVIDE BRACING TO MEET OSHPD SEISMIC REQUIREMENTS. REFER TO SHEET T4.02 FOR MORE INFORMATION
- 11. PROVIDE ALL OUTLET CONDUITS FROM WORK AREA OUTLETS., DEVICES OR PULL BOXES TO NEAREST CABLE
- 12. INSTALL CABLE TRAY @ 6" ABOVE CEILING.

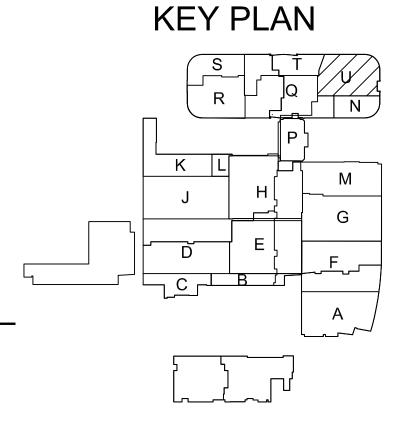

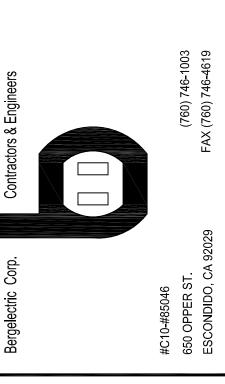

PROPRIETARY STATEMENT THESE DRAWINGS/DOCUMENTS HEREIN ATTACHED ARE THE PROPERTY OF BERGELECTRIC CORPORATION ANY REUSE OR

REPRODUCTION OF THESE DOCUMENTS WITHOUT WRITTEN PERMISSION OF BERGELECTRIC CORPORATION IS STRICTLY FORBIDDEN. ALL RIGHTS RESERVED.

J.RAMIREZ

DESIGN SUPERVISOR:

INSTALL SUPERVISOR: Scott Adams Tel Data Systems
Bergelectric Corporation
650 Opper Street
Escondido, CA 92029

05-30-12 RECORD DRAWINGS

SHEET TITLE:

TELECOM FLOOR PLAN LEVEL 1 AREA-U

> SCALE: 1/4"=1'0"

DRAWING NO. :

T3.1U RECORD DRAWING

T3 LEVEL 1 - TELECOM PLAN - AREA U