

PERMISSION OF BERGELECTRIC CORPORATION IS STRICTLY FORBIDDEN. ALL RIGHTS RESERVED. J.RAMIREZ

PROPRIETARY STATEMENT

DESIGN SUPERVISOR:

INSTALL SUPERVISOR: Scott Adams Tel Data Systems Bergelectric Corporation 650 Opper Street Escondido, CA 92029

05-30-12 RECORD DRAWINGS


SHEET TITLE:


TELECOM FLOOR PLAN LOWER LEVEL OVERALL

> SCALE: 1/16"=1'0"

DRAWING NO.:

T3.0 RECORD DRAWING

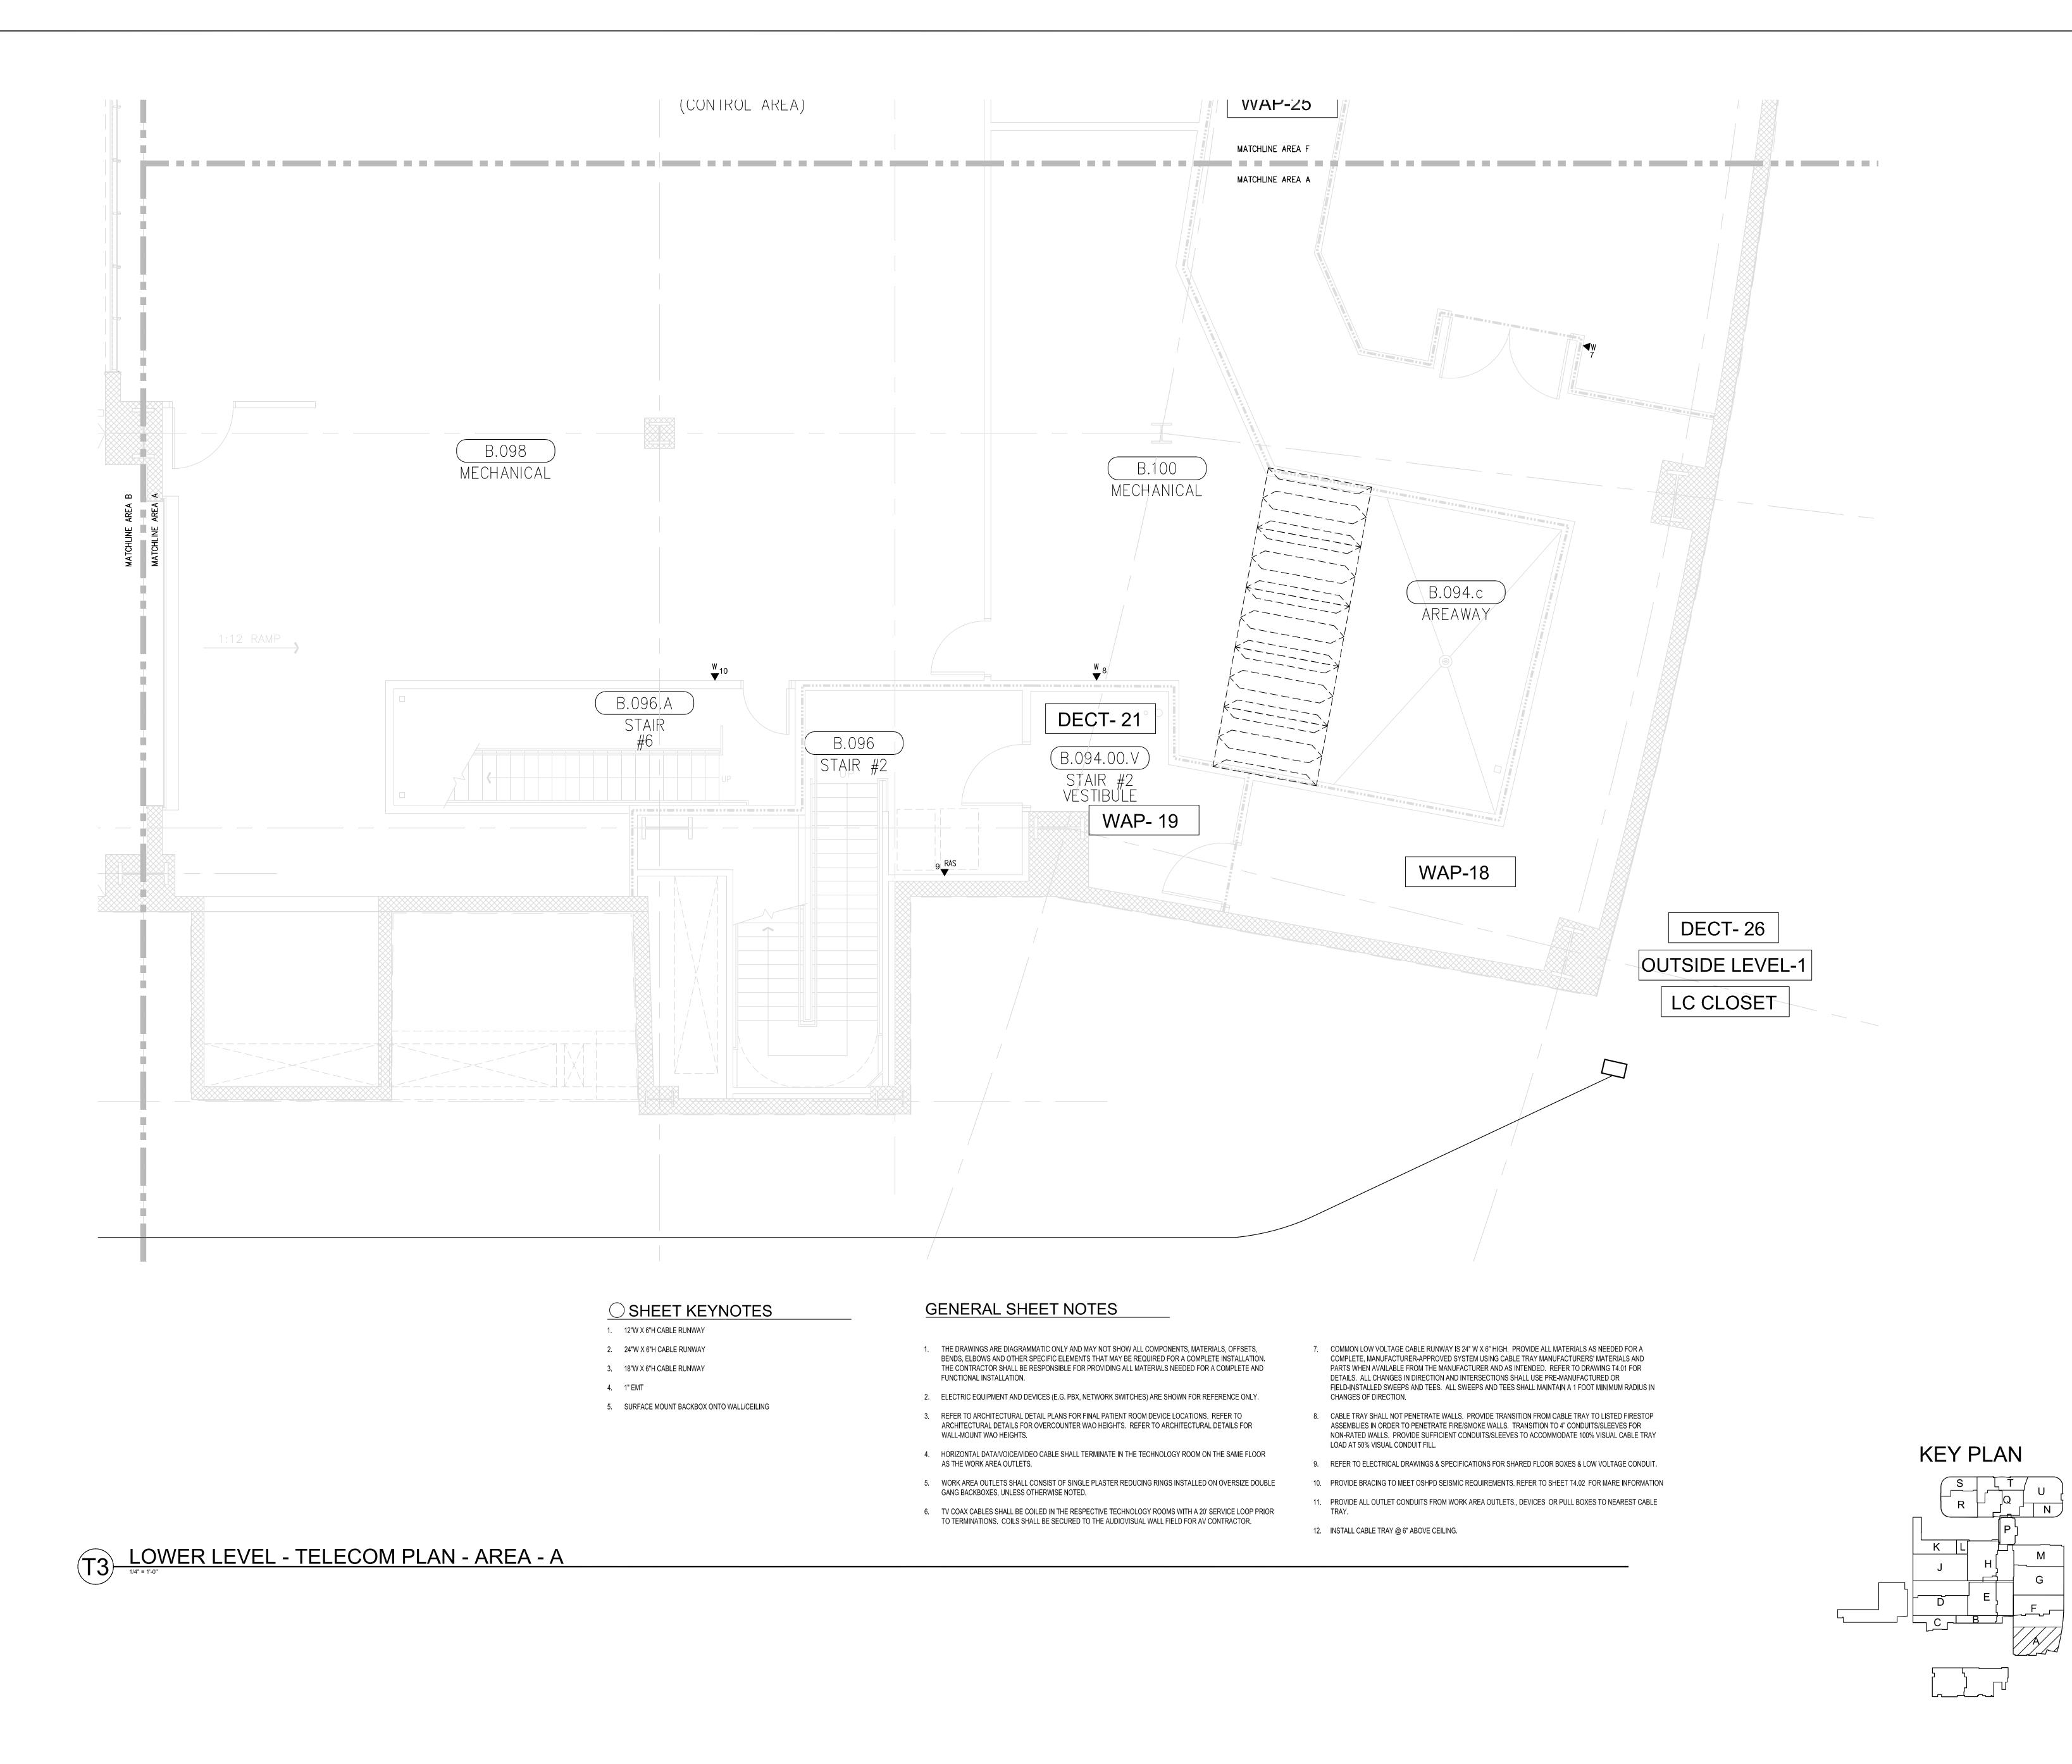

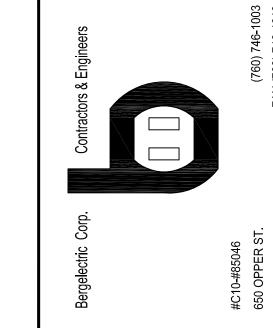

REN'S HOSPITAL ANGE COUNTY - TOWER II

ROJECT: C

PROPRIETARY STATEMENT

THESE DRAWINGS/DOCUMENTS HEREIN ATTACHED ARE THE PROPERTY OF BERGELECTRIC CORPORATION ANY REUSE OR REPRODUCTION OF THESE DOCUMENTS WITHOUT WRITTEN PERMISSION OF BERGELECTRIC CORPORATION IS STRICTLY FORBIDDEN. ALL RIGHTS RESERVED.

DRAWN BY:
J.RAMIREZ

DESIGN SUPERVISOR:

INSTALL SUPERVISOR:

Scott Adams
Tel Data Systems
Bergelectric Corporation
650 Opper Street
Escondido, CA 92029

REVISION:

05-30-12 RECORD DRAWINGS


SHEET TITLE:

TELECOM FLOOR PLAN LOWER LEVEL AREA-A

> SCALE: 1/4"=1'0"

DRAWING NO. :

T3.0A RECORD DRAWING

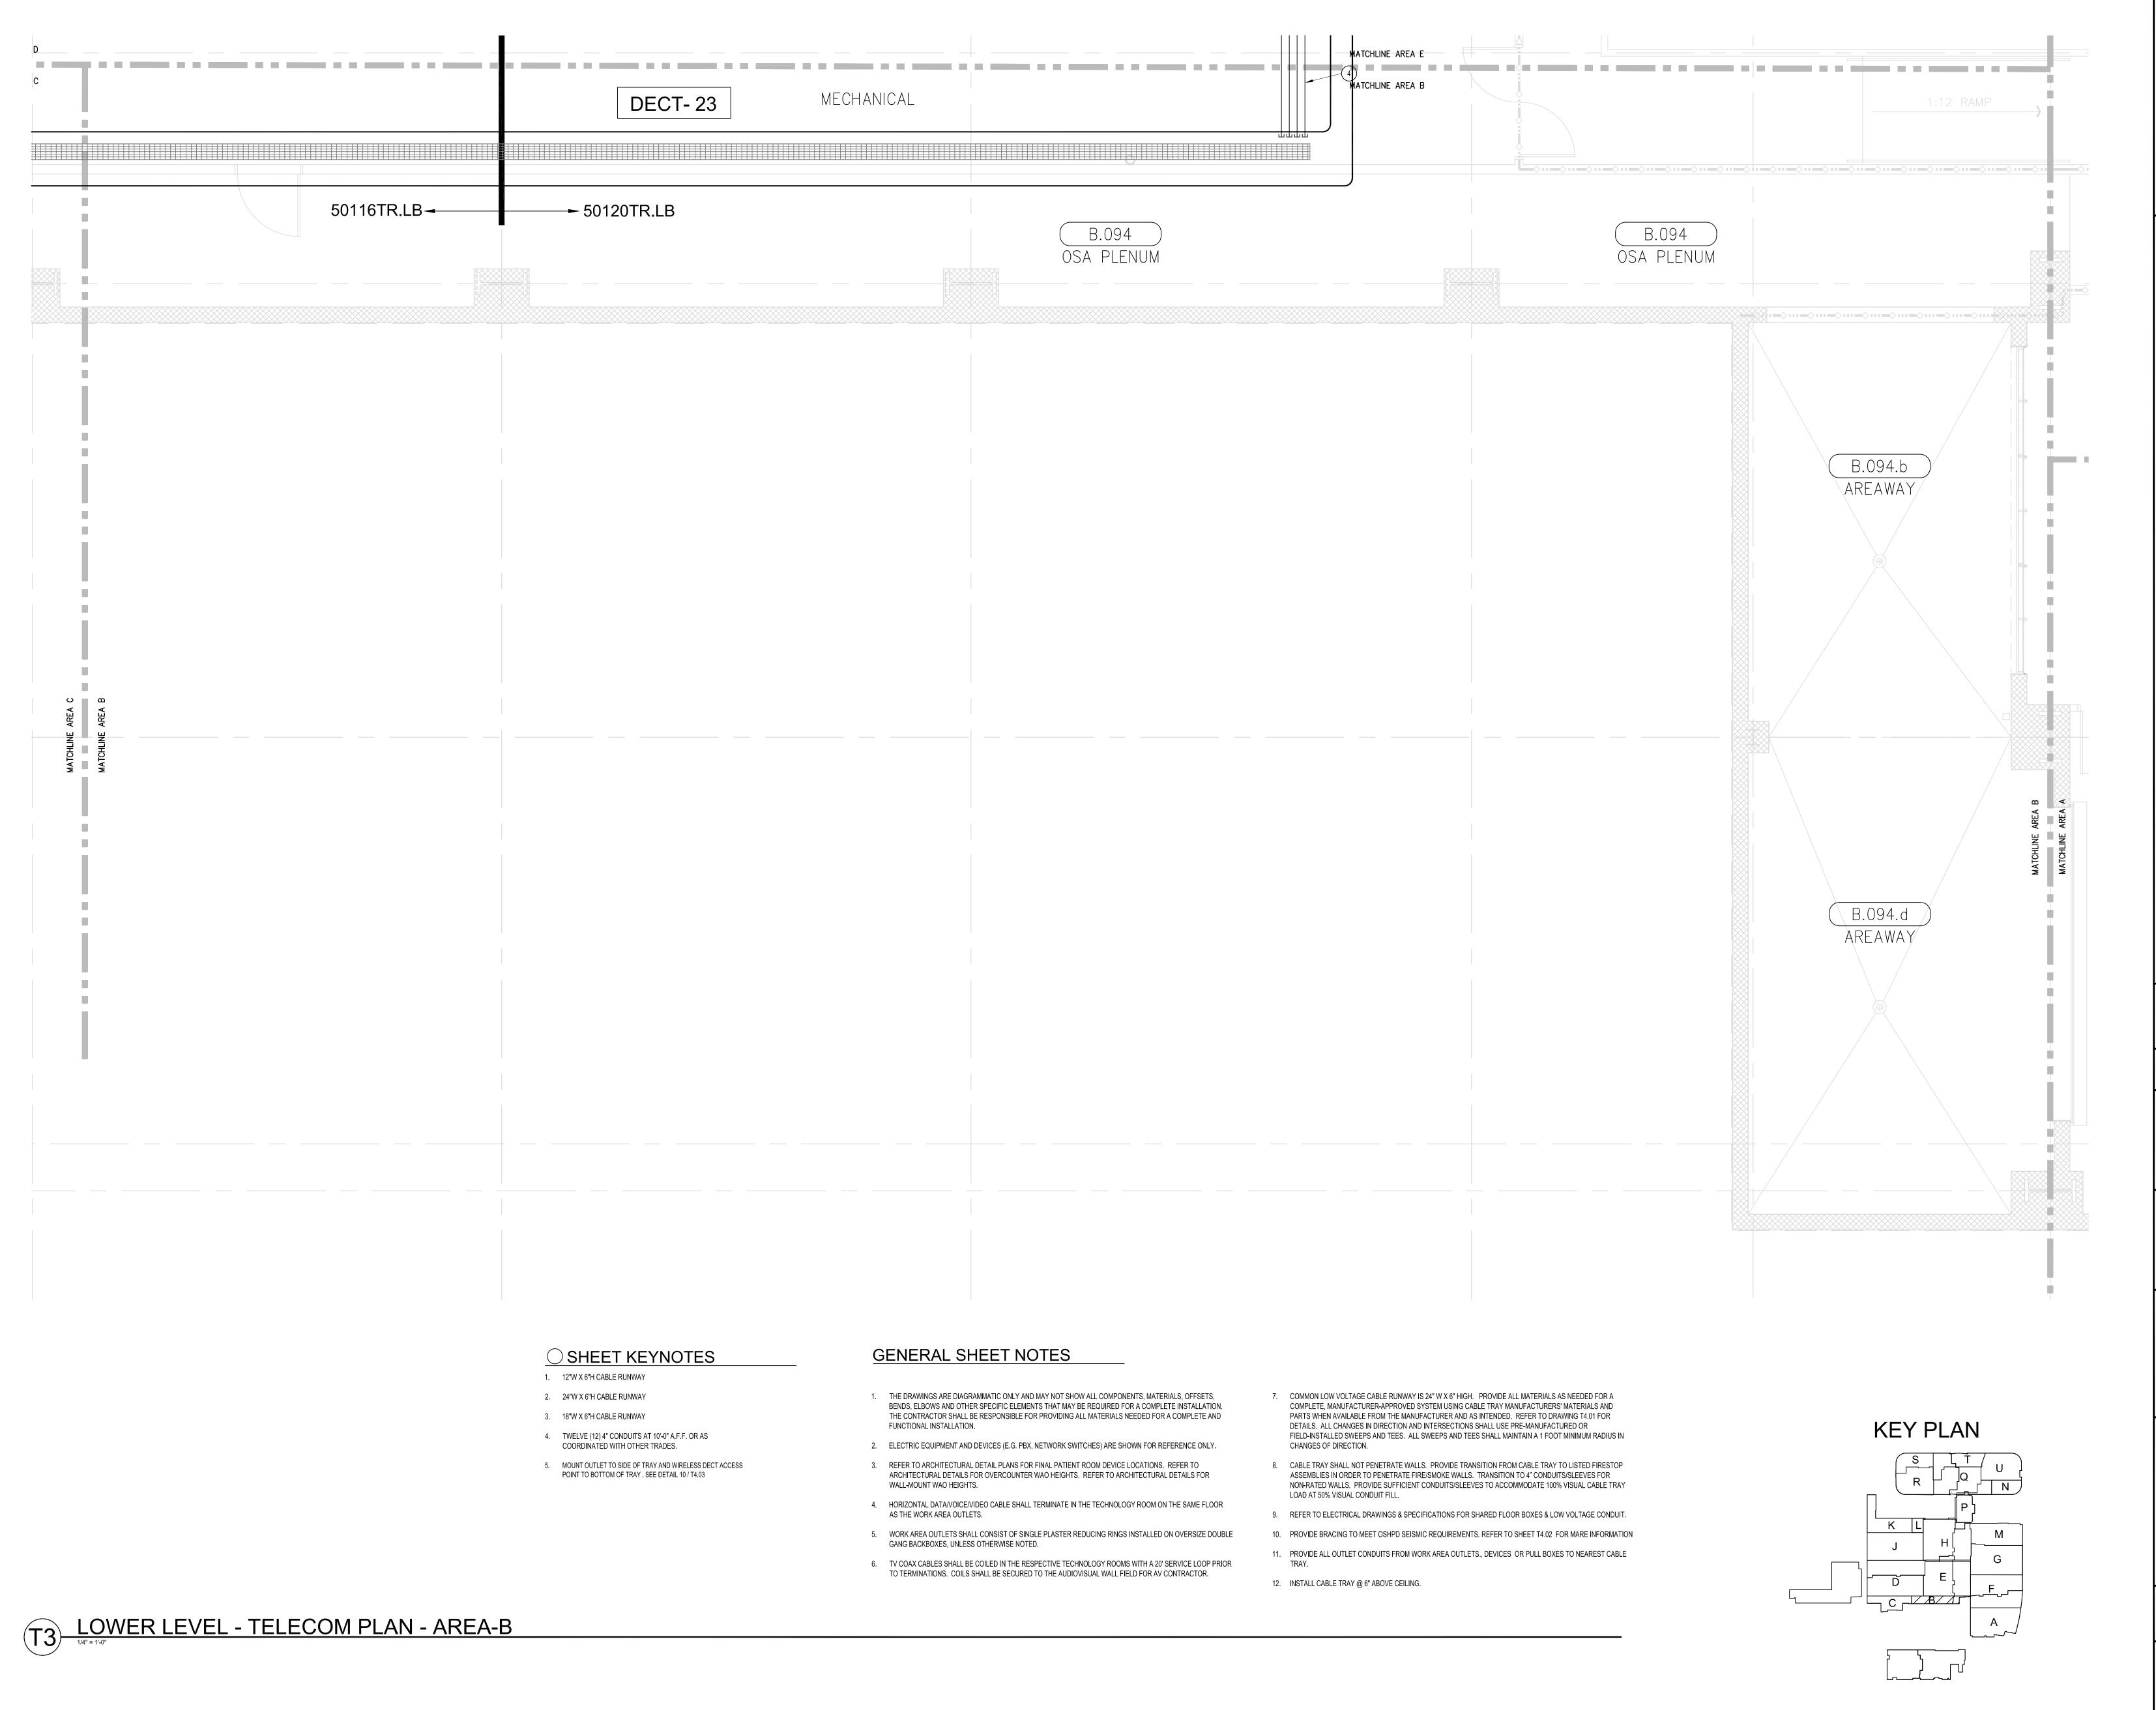

PROPRIETARY STATEMENT

THESE DRAWINGS/DOCUMENTS HEREIN ATTACHED ARE THE PROPERTY OF BERGELECTRIC CORPORATION ANY REUSE OR REPRODUCTION OF THESE DOCUMENTS WITHOUT WRITTEN PERMISSION OF BERGELECTRIC CORPORATION IS STRICTLY FORBIDDEN. ALL RIGHTS RESERVED.

J.RAMIREZ

DESIGN SUPERVISOR:

INSTALL SUPERVISOR: Scott Adams

Tel Data Systems
Bergelectric Corporation
650 Opper Street
Escondido, CA 92029

05-30-12 RECORD DRAWINGS


SHEET TITLE:

TELECOM FLOOR PLAN LOWER LEVEL AREA-B

> SCALE: 1/4"=1'0"

DRAWING NO. :

T3.0B RECORD DRAWING

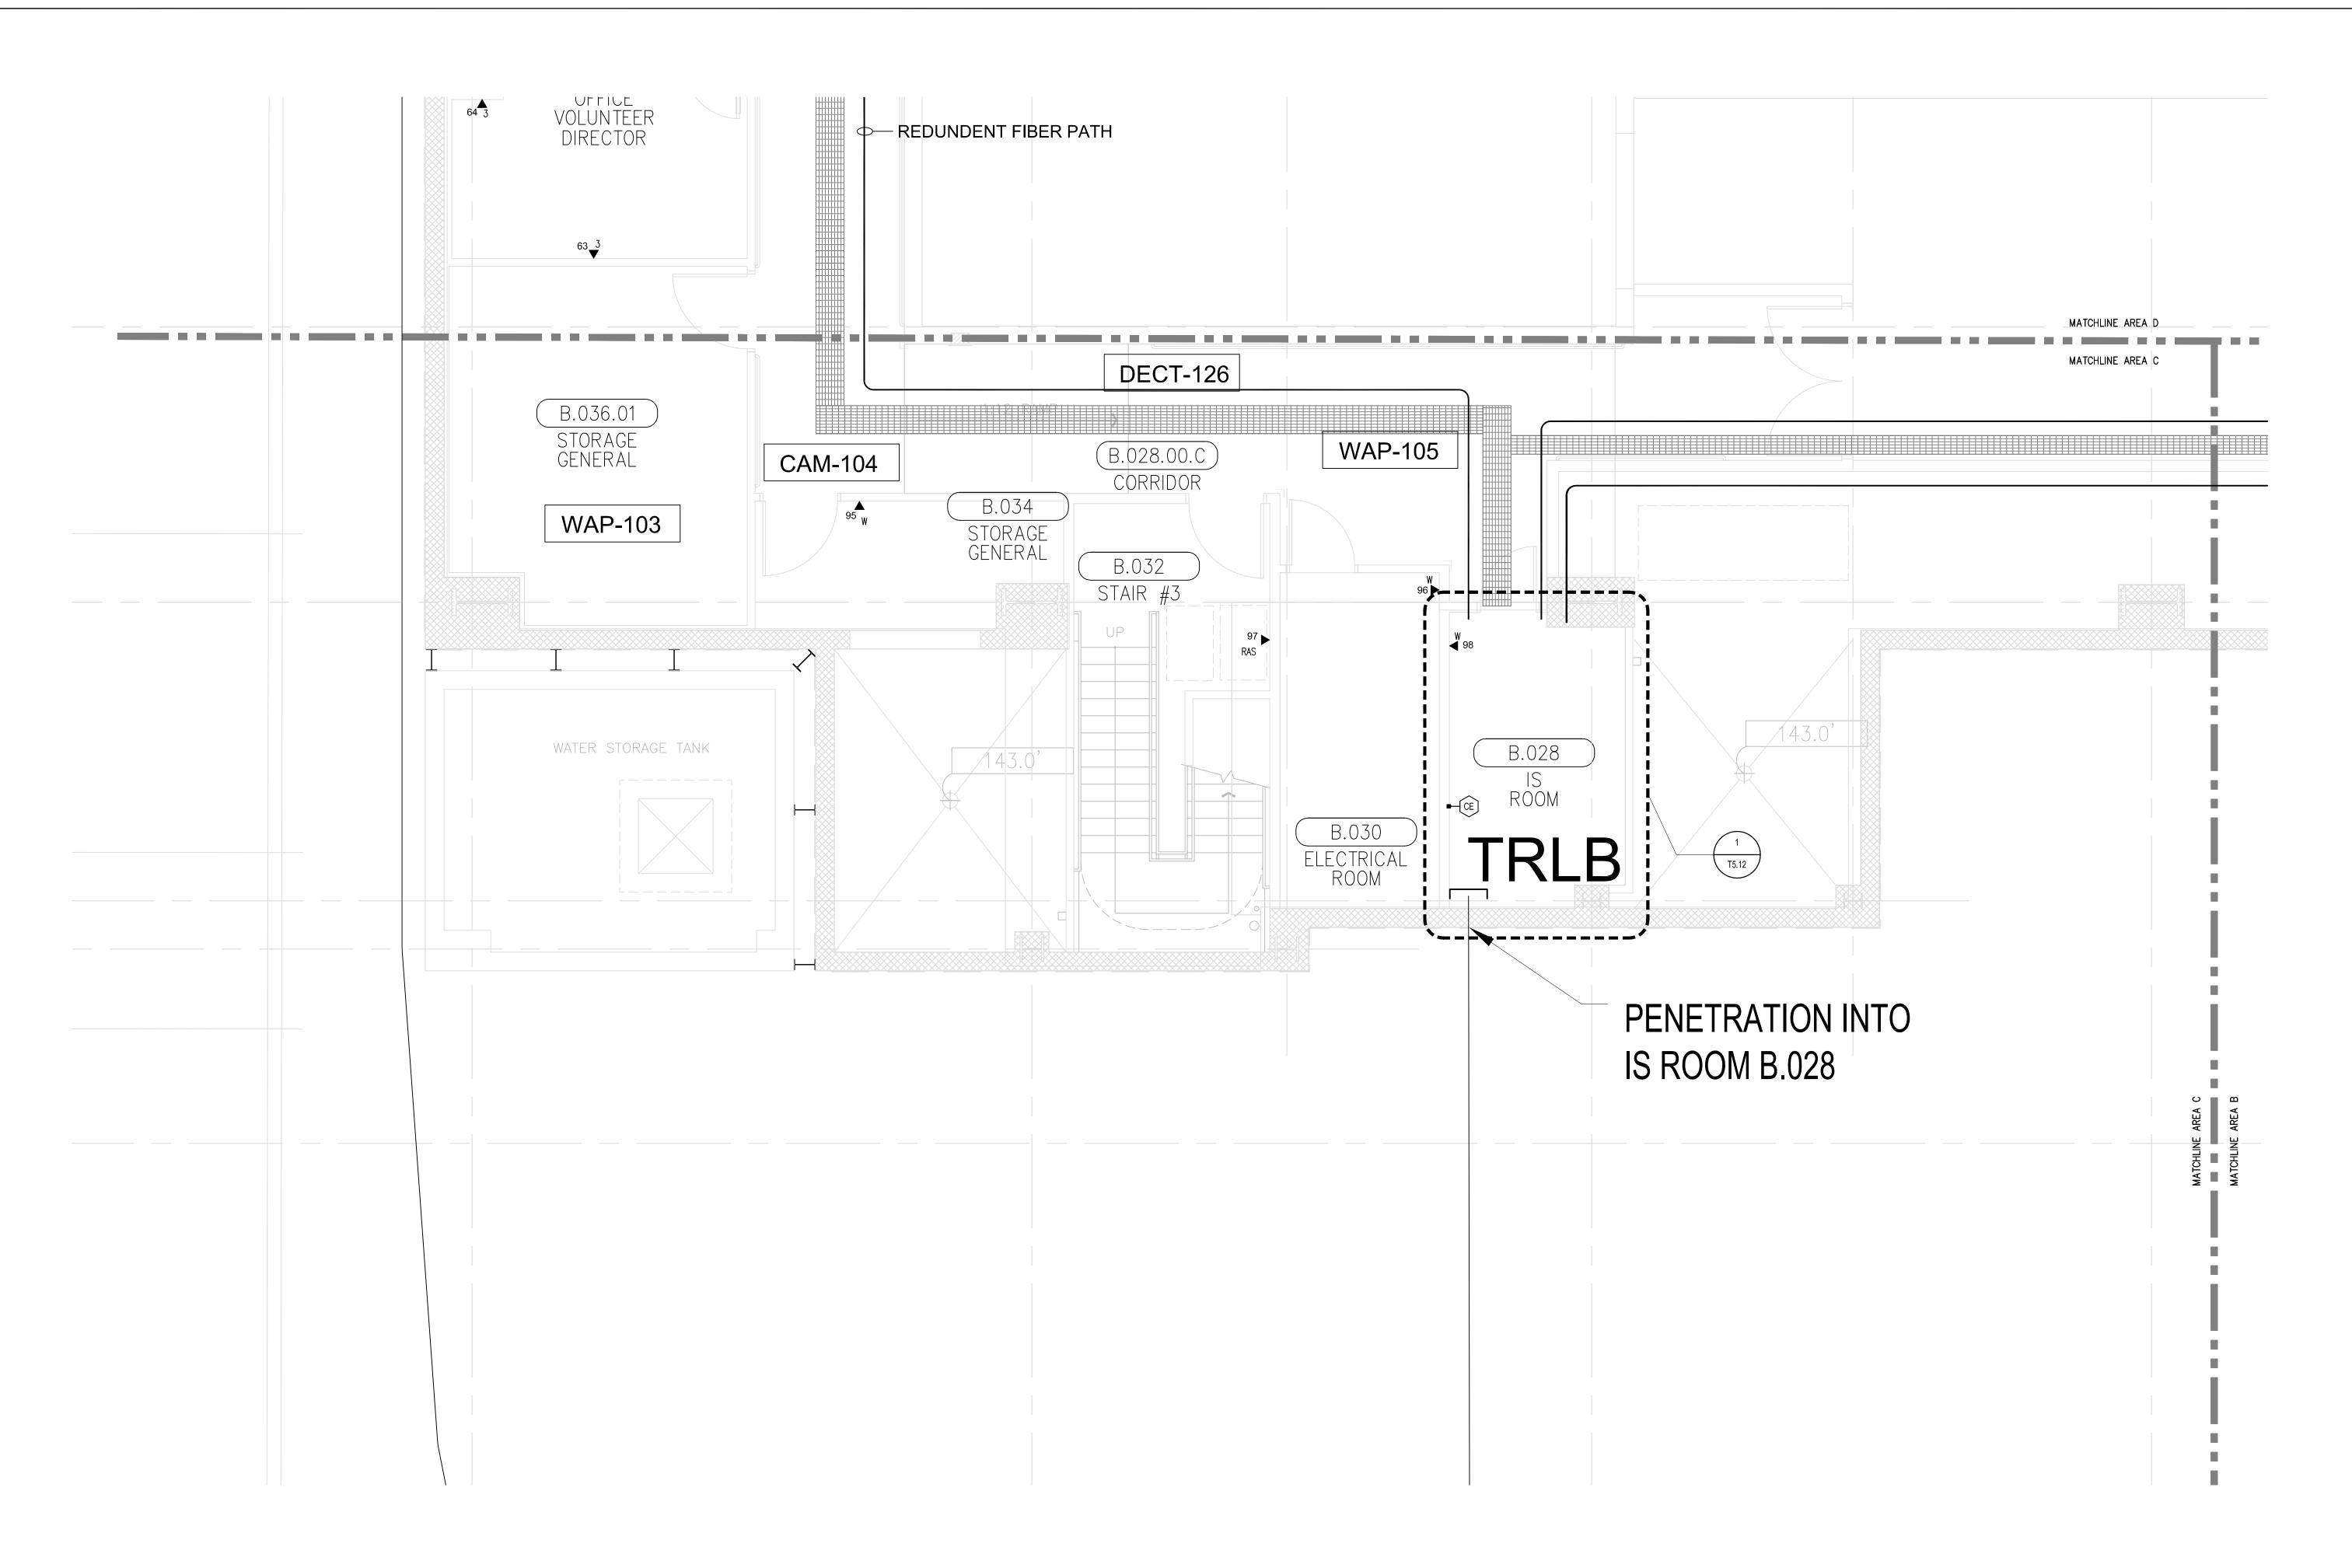

SHEET KEYNOTES

1. 12"W X 6"H CABLE RUNWAY

2. 24"W X 6"H CABLE RUNWAY

3. 18"W X 6"H CABLE RUNWAY

A 4. COORDINATE LOCATION, ELEVATION, AND SLEEVE COUNT WITH DRAWING T1.10.

GENERAL SHEET NOTES

WALL-MOUNT WAO HEIGHTS.

- 1. THE DRAWINGS ARE DIAGRAMMATIC ONLY AND MAY NOT SHOW ALL COMPONENTS, MATERIALS, OFFSETS, BENDS, ELBOWS AND OTHER SPECIFIC ELEMENTS THAT MAY BE REQUIRED FOR A COMPLETE INSTALLATION. THE CONTRACTOR SHALL BE RESPONSIBLE FOR PROVIDING ALL MATERIALS NEEDED FOR A COMPLETE AND FUNCTIONAL INSTALLATION.
- 2. ELECTRIC EQUIPMENT AND DEVICES (E.G. PBX, NETWORK SWITCHES) ARE SHOWN FOR REFERENCE ONLY. REFER TO ARCHITECTURAL DETAIL PLANS FOR FINAL PATIENT ROOM DEVICE LOCATIONS. REFER TO ARCHITECTURAL DETAILS FOR OVERCOUNTER WAO HEIGHTS. REFER TO ARCHITECTURAL DETAILS FOR
- 4. HORIZONTAL DATA/VOICE/VIDEO CABLE SHALL TERMINATE IN THE TECHNOLOGY ROOM ON THE SAME FLOOR AS THE WORK AREA OUTLETS.
- 5. WORK AREA OUTLETS SHALL CONSIST OF SINGLE PLASTER REDUCING RINGS INSTALLED ON OVERSIZE DOUBLE GANG BACKBOXES, UNLESS OTHERWISE NOTED.
- 6. TV COAX CABLES SHALL BE COILED IN THE RESPECTIVE TECHNOLOGY ROOMS WITH A 20' SERVICE LOOP PRIOR TO TERMINATIONS. COILS SHALL BE SECURED TO THE AUDIOVISUAL WALL FIELD FOR AV CONTRACTOR.
- 7. COMMON LOW VOLTAGE CABLE RUNWAY IS 24" W X 6" HIGH. PROVIDE ALL MATERIALS AS NEEDED FOR A COMPLETE, MANUFACTURER-APPROVED SYSTEM USING CABLE TRAY MANUFACTURERS' MATERIALS AND PARTS WHEN AVAILABLE FROM THE MANUFACTURER AND AS INTENDED. REFER TO DRAWING T4.01 FOR DETAILS. ALL CHANGES IN DIRECTION AND INTERSECTIONS SHALL USE PRE-MANUFACTURED OR FIELD-INSTALLED SWEEPS AND TEES. ALL SWEEPS AND TEES SHALL MAINTAIN A 1 FOOT MINIMUM RADIUS IN CHANGES OF DIRECTION.
- 8. CABLE TRAY SHALL NOT PENETRATE WALLS. PROVIDE TRANSITION FROM CABLE TRAY TO LISTED FIRESTOP ASSEMBLIES IN ORDER TO PENETRATE FIRE/SMOKE WALLS. TRANSITION TO 4" CONDUITS/SLEEVES FOR NON-RATED WALLS. PROVIDE SUFFICIENT CONDUITS/SLEEVES TO ACCOMMODATE 100% VISUAL CABLE TRAY LOAD AT 50% VISUAL CONDUIT FILL.
- 9. REFER TO ELECTRICAL DRAWINGS & SPECIFICATIONS FOR SHARED FLOOR BOXES & LOW VOLTAGE CONDUIT.
- 10. PROVIDE BRACING TO MEET OSHPD SEISMIC REQUIREMENTS. REFER TO SHEET T4.02 FOR MARE INFORMATION
- 12. INSTALL CABLE TRAY @ 6" ABOVE CEILING.

KEY PLAN

CHILDREN'S IOF ORANGE

455 South Main Street
Orange, CA 92868-3874

PROPRIETARY STATEMENT THESE DRAWINGS/DOCUMENTS HEREIN ATTACHED ARE THE PROPERTY OF BERGELECTRIC CORPORATION ANY REUSE OR REPRODUCTION OF THESE DOCUMENTS WITHOUT WRITTEN PERMISSION OF BERGELECTRIC CORPORATION IS STRICTLY

J.RAMIREZ

DESIGN SUPERVISOR:

FORBIDDEN. ALL RIGHTS RESERVED.

INSTALL SUPERVISOR: Scott Adams Tel Data Systems
Bergelectric Corporation
650 Opper Street
Escondido, CA 92029

05-30-12 RECORD DRAWINGS

SHEET TITLE:


TELECOM FLOOR PLAN LOWER LEVEL AREA-C


> SCALE: 1/4"=1'0"

> > DRAWING NO.:

T3.0C RECORD DRAWING

T3 LOWER LEVEL - TELECOM PLAN - AREA-C

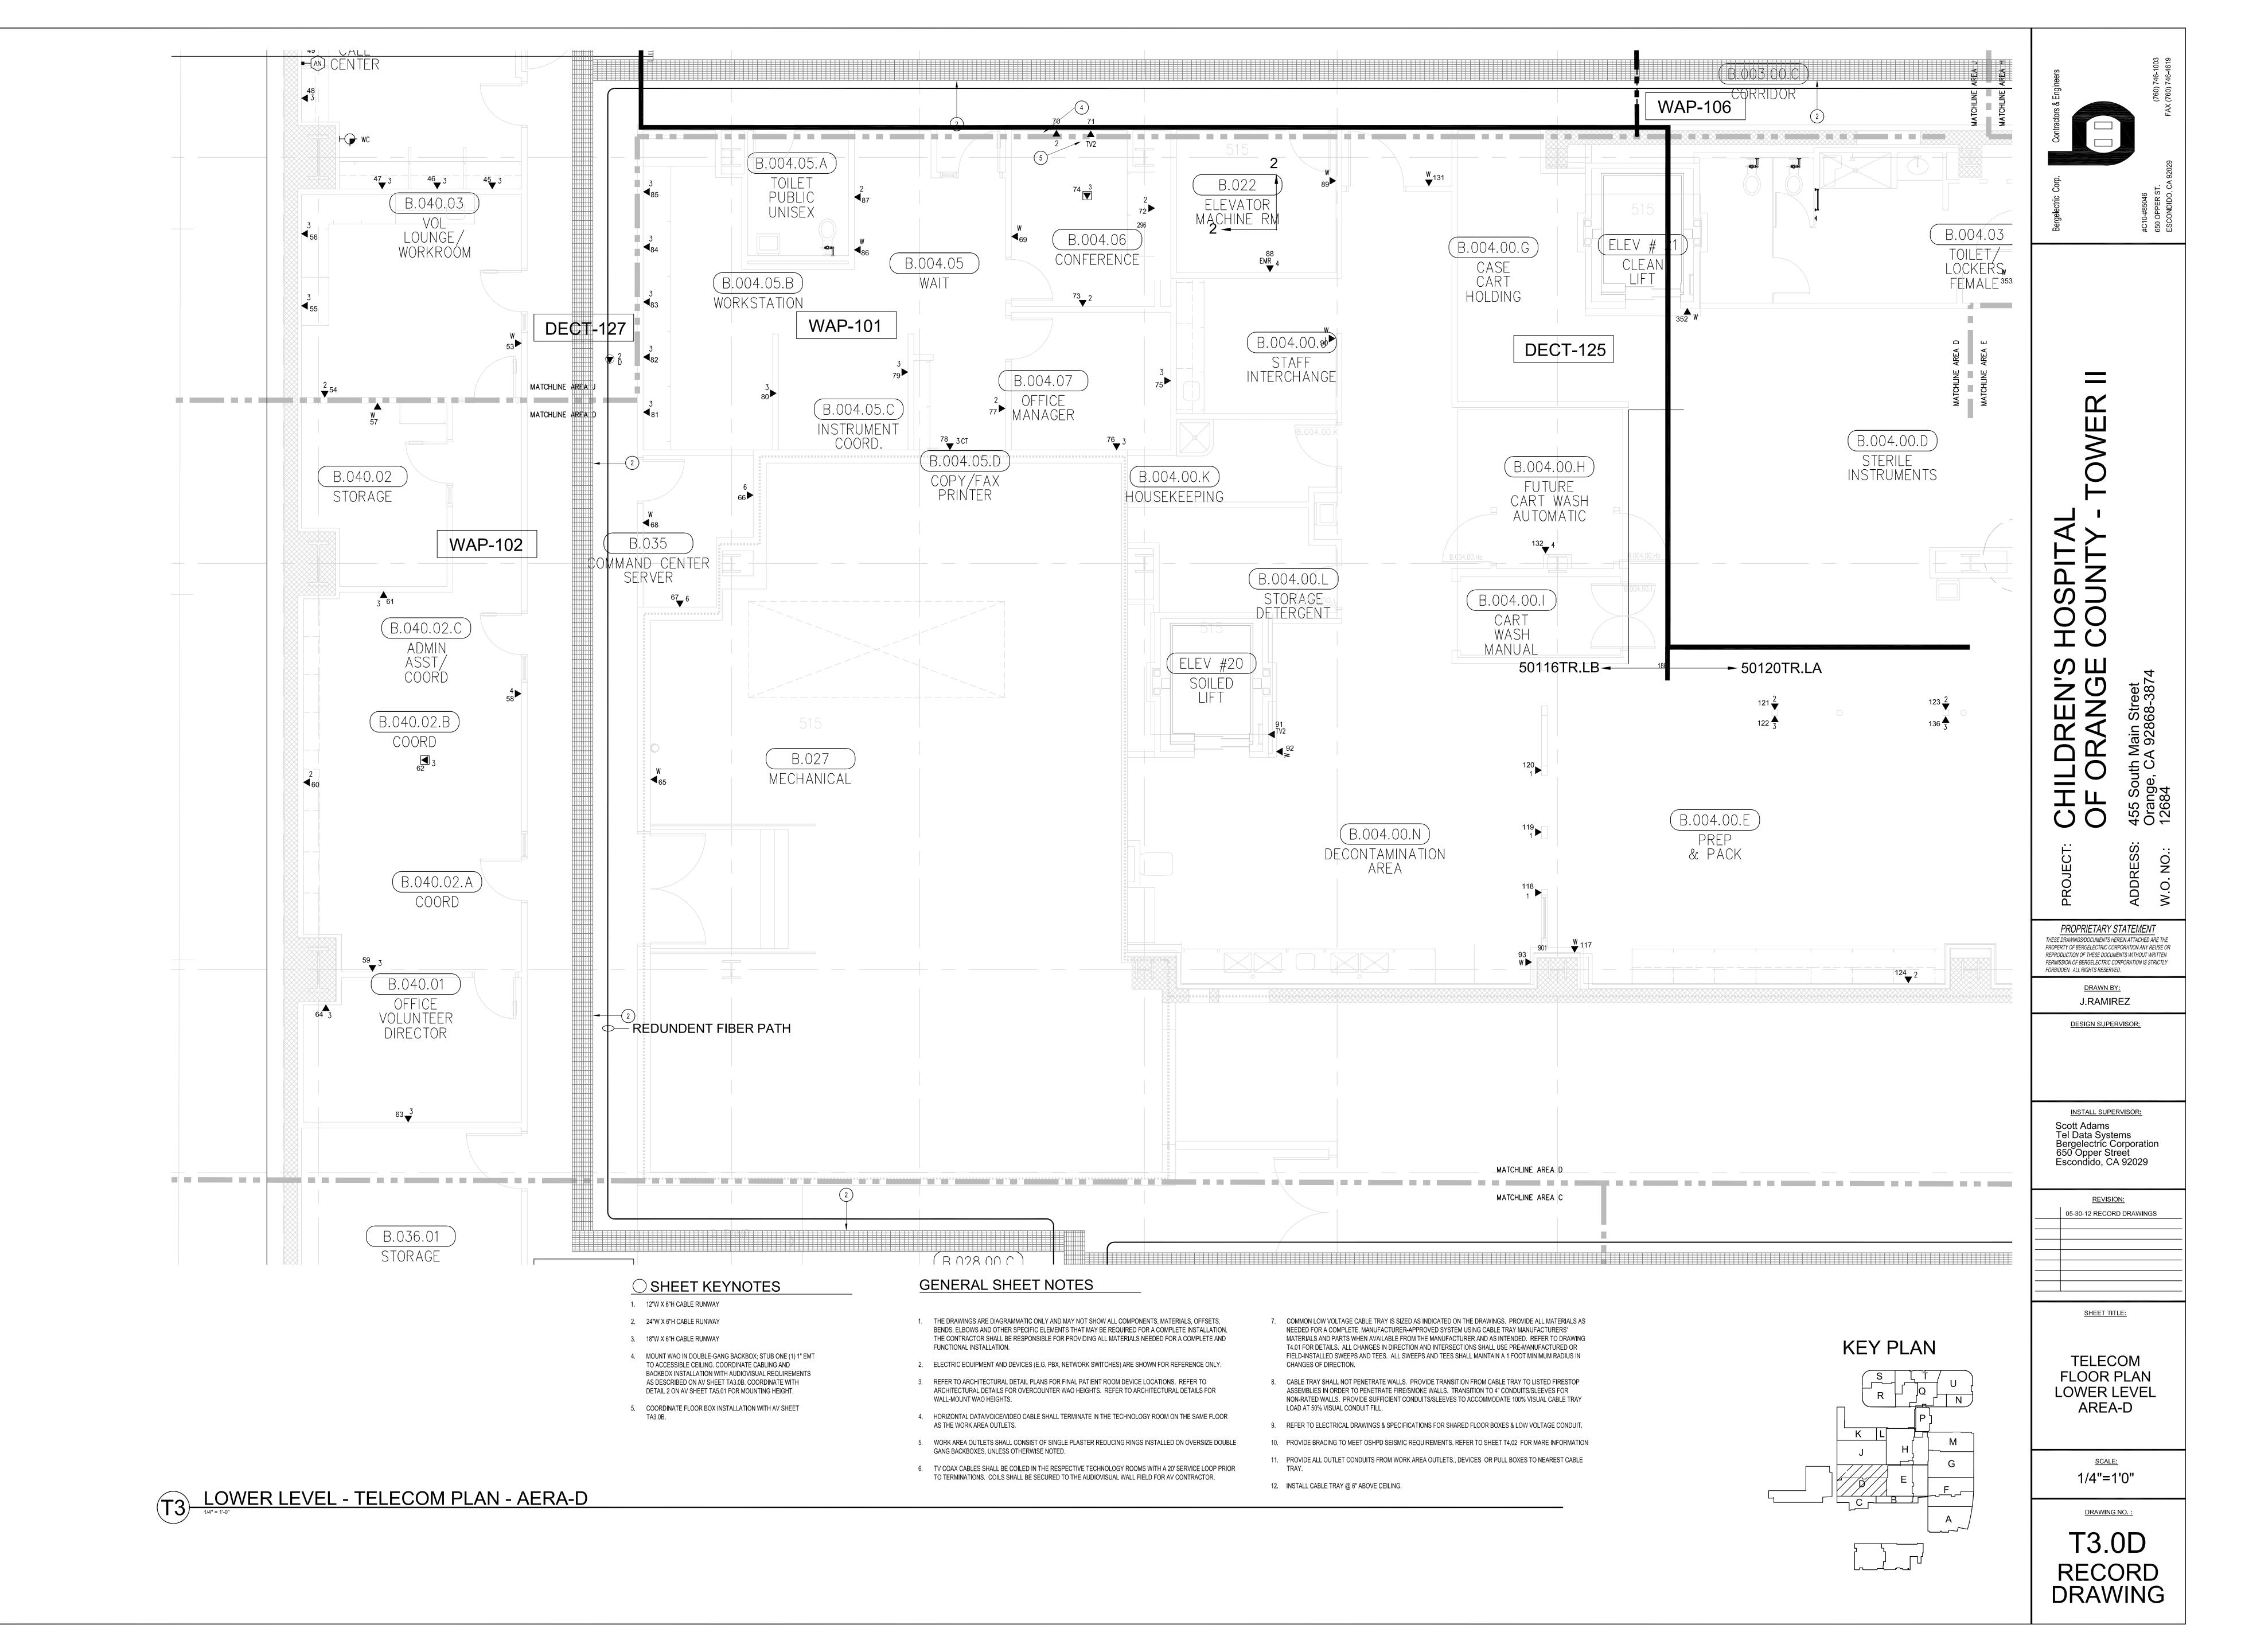

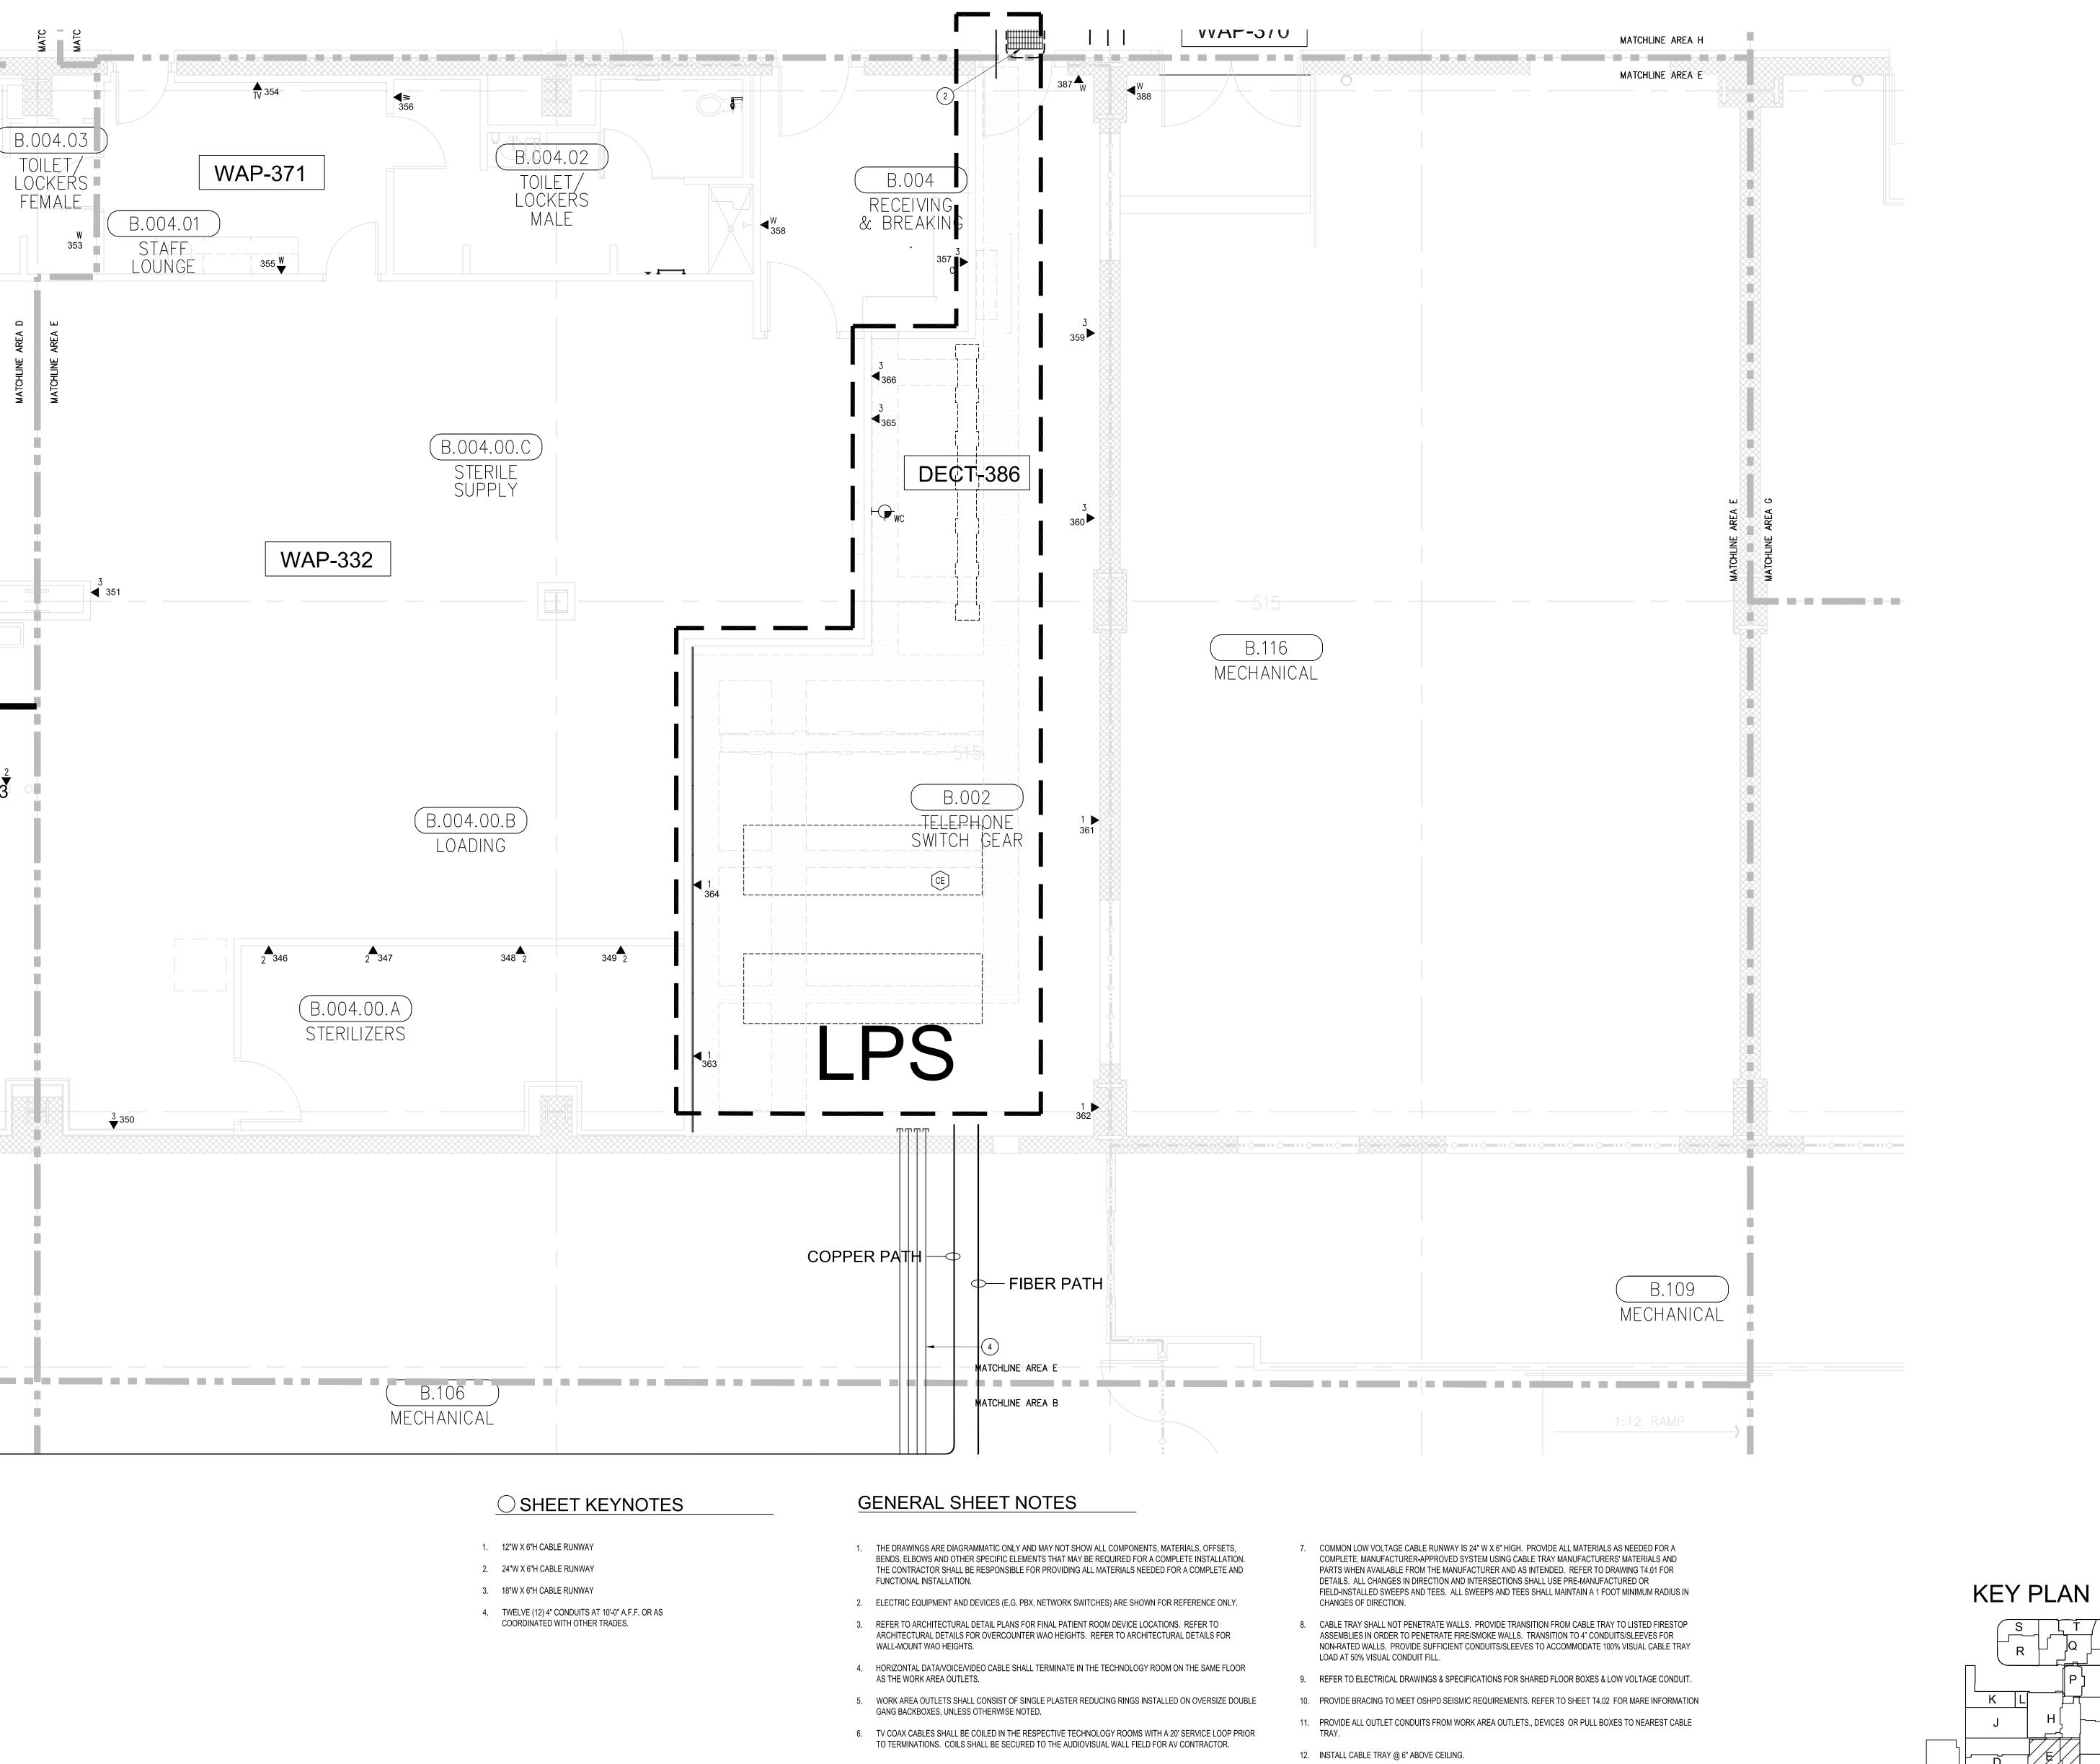

PROPRIETARY STATEMENT THESE DRAWINGS/DOCUMENTS HEREIN ATTACHED ARE THE PROPERTY OF BERGELECTRIC CORPORATION ANY REUSE OR REPRODUCTION OF THESE DOCUMENTS WITHOUT WRITTEN PERMISSION OF BERGELECTRIC CORPORATION IS STRICTLY FORBIDDEN. ALL RIGHTS RESERVED.

J.RAMIREZ

DESIGN SUPERVISOR:

INSTALL SUPERVISOR: Scott Adams Tel Data Systems
Bergelectric Corporation
650 Opper Street
Escondido, CA 92029

05-30-12 RECORD DRAWINGS


SHEET TITLE:

TELECOM FLOOR PLAN LOWER LEVEL AREA-E

> SCALE: 1/4"=1'0"

DRAWING NO.:

T3.0E RECORD DRAWING

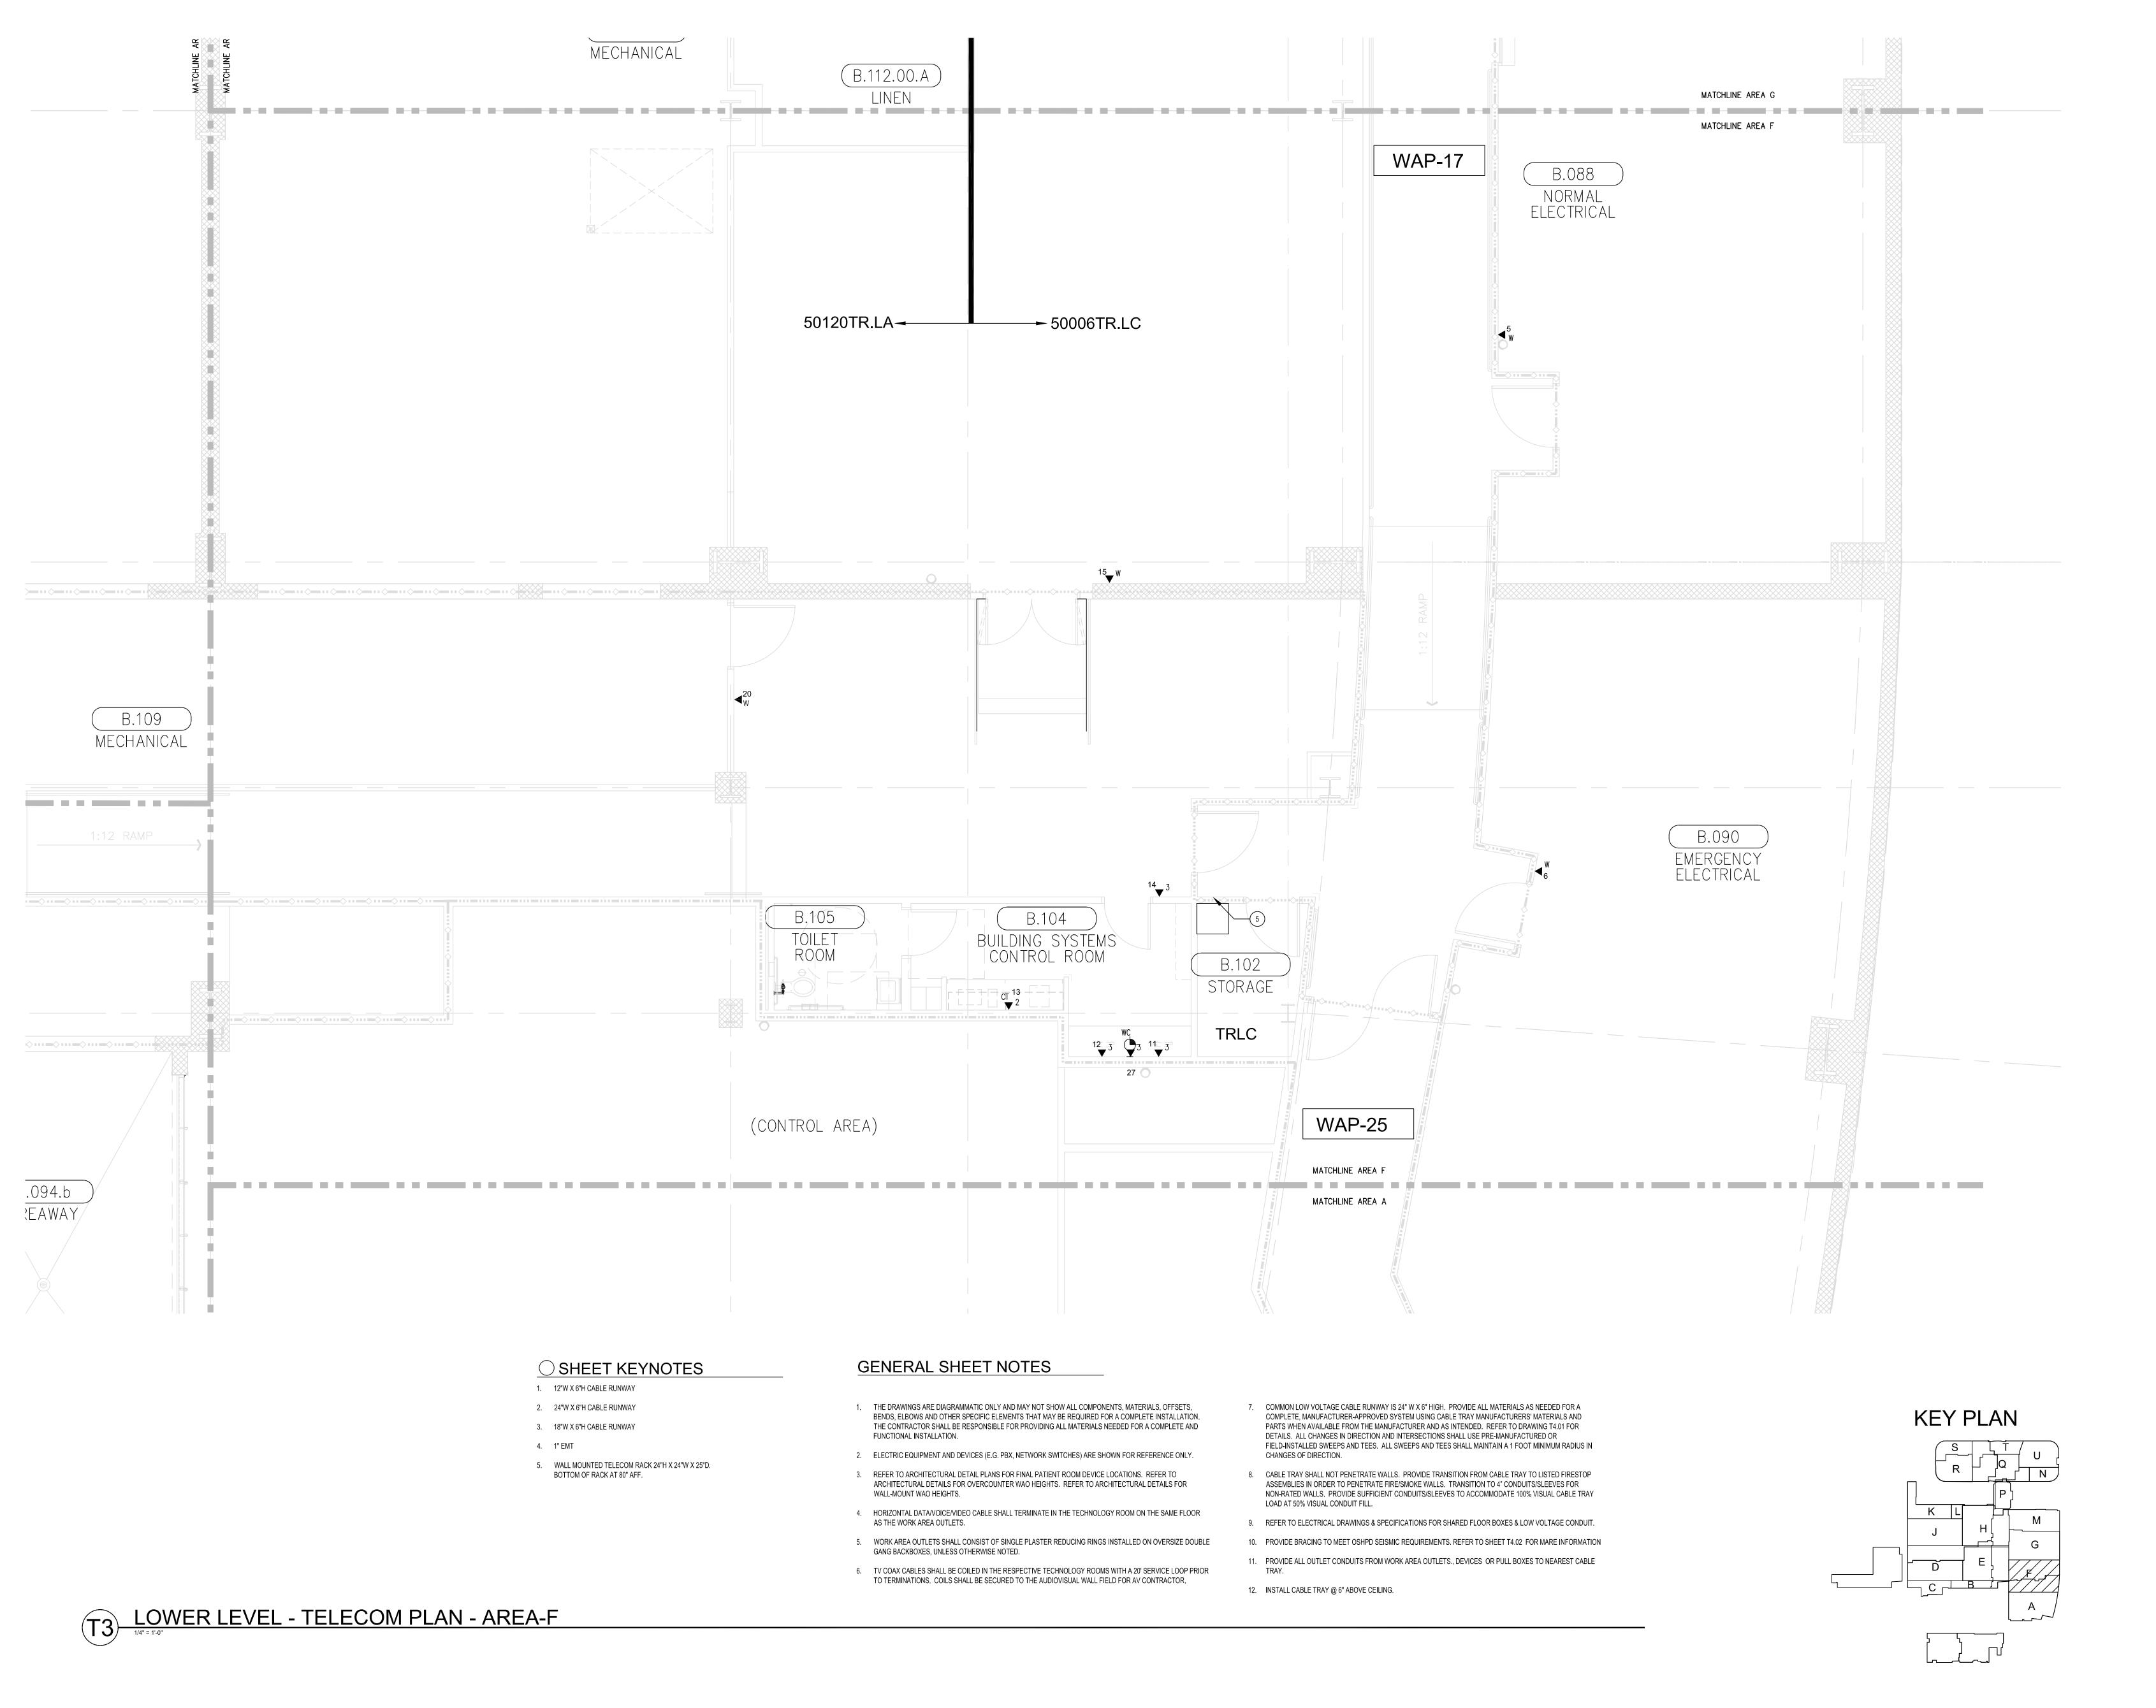

PROPRIETARY STATEMENT THESE DRAWINGS/DOCUMENTS HEREIN ATTACHED ARE THE PROPERTY OF BERGELECTRIC CORPORATION ANY REUSE OR REPRODUCTION OF THESE DOCUMENTS WITHOUT WRITTEN PERMISSION OF BERGELECTRIC CORPORATION IS STRICTLY FORBIDDEN. ALL RIGHTS RESERVED.

J.RAMIREZ

DESIGN SUPERVISOR:

INSTALL SUPERVISOR: Scott Adams Tel Data Systems
Bergelectric Corporation
650 Opper Street
Escondido, CA 92029

05-30-12 RECORD DRAWINGS


SHEET TITLE:

TELECOM FLOOR PLAN LOWER LEVEL AREA-F

> SCALE: 1/4"=1'0"

DRAWING NO.:

T3.0F RECORD DRAWING

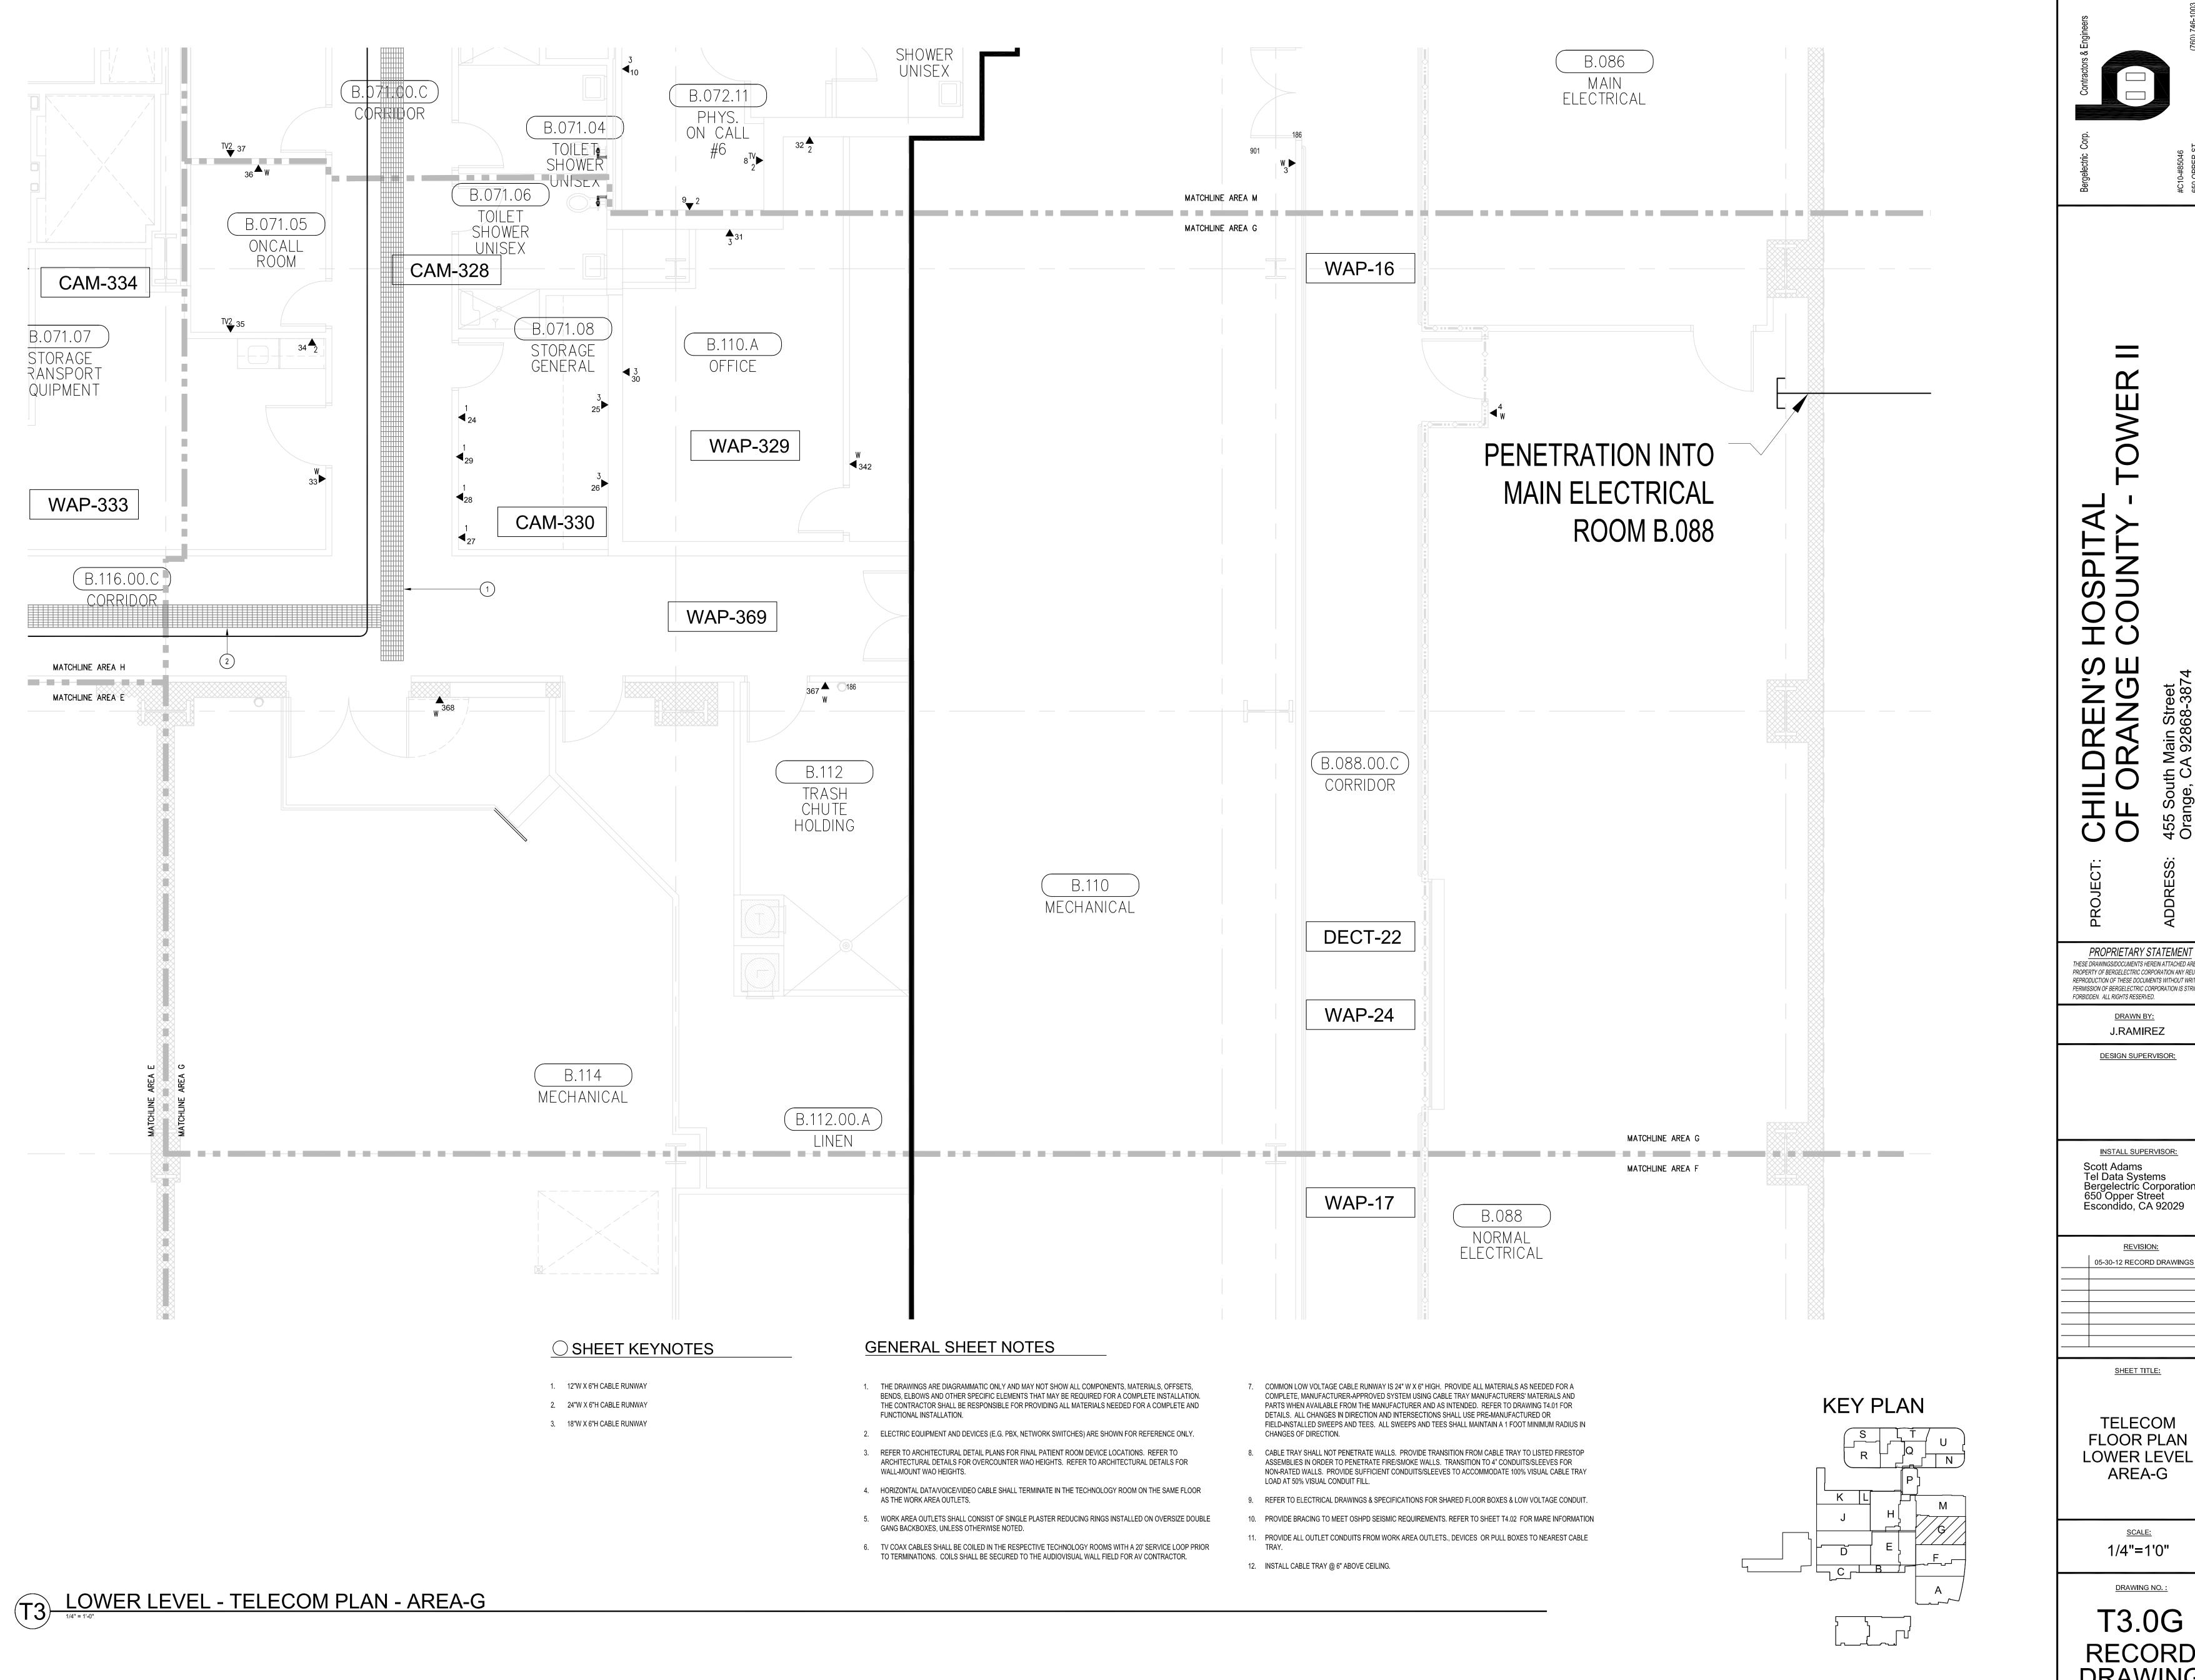

THESE DRAWINGS/DOCUMENTS HEREIN ATTACHED ARE THE

PROPERTY OF BERGELECTRIC CORPORATION ANY REUSE OR REPRODUCTION OF THESE DOCUMENTS WITHOUT WRITTEN PERMISSION OF BERGELECTRIC CORPORATION IS STRICTLY


INSTALL SUPERVISOR: Tel Data Systems
Bergelectric Corporation
650 Opper Street
Escondido, CA 92029

05-30-12 RECORD DRAWINGS

SHEET TITLE:

TELECOM FLOOR PLAN

T3.0G RECORD DRAWING

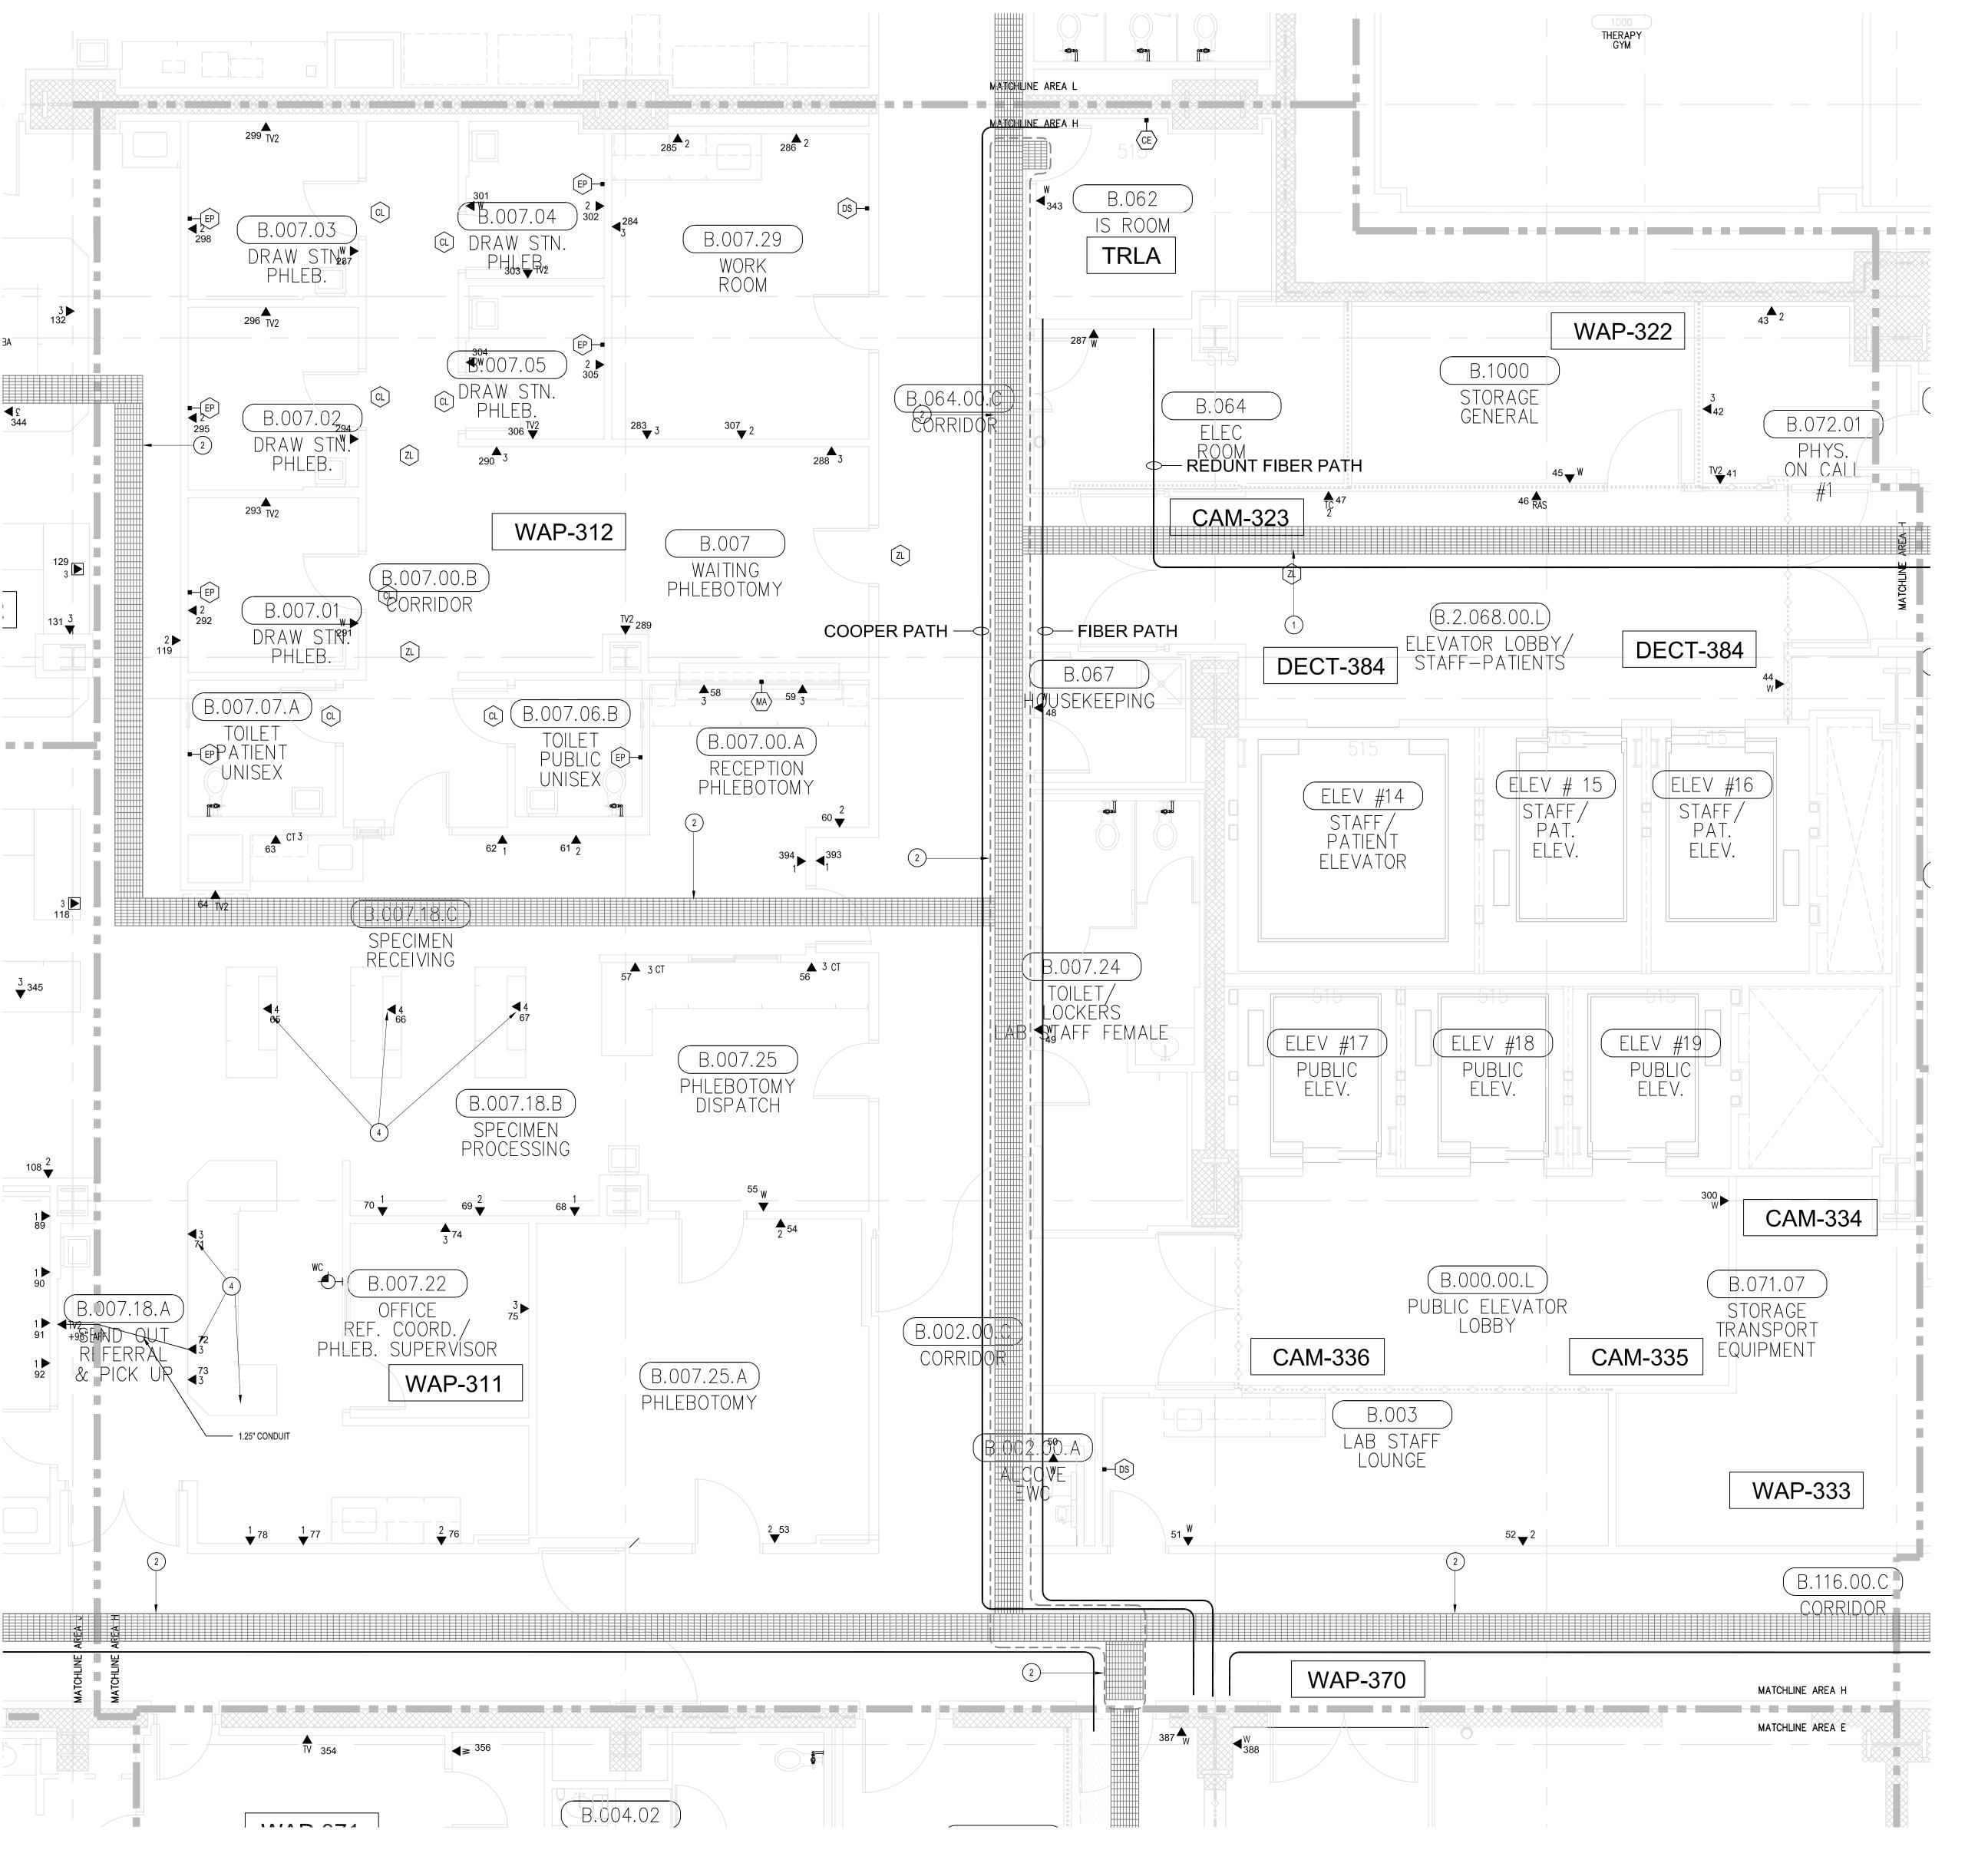

○ SHEET KEYNOTES

- 1. 12"W X 6"H CABLE RUNWAY
- 2. 24"W X 6"H CABLE RUNWAY
- 3. 18"W X 6"H CABLE RUNWAY
- 4. OUTLETS ARE TO BE FED VIA WALL FROM ABOVE CEILING SPACE. PROVIDE TWO (2) 1-1/4" CONDUITS FROM CABLE RUNWAY TO MILLWORK. TERMINATE CONDUITS AT 24" A.F.F. AND EXTEND ONTO MILLWORK USING NON-METALLIC SURFACE RACEWAYS WITH MINIMUM OF 1"x1" INTERNAL AREA TO EACH OUTLET.

GENERAL SHEET NOTES

- 1. THE DRAWINGS ARE DIAGRAMMATIC ONLY AND MAY NOT SHOW ALL COMPONENTS, MATERIALS, OFFSETS, BENDS, ELBOWS AND OTHER SPECIFIC ELEMENTS THAT MAY BE REQUIRED FOR A COMPLETE INSTALLATION. THE CONTRACTOR SHALL BE RESPONSIBLE FOR PROVIDING ALL MATERIALS NEEDED FOR A COMPLETE AND FUNCTIONAL INSTALLATION.
- 2. ELECTRIC EQUIPMENT AND DEVICES (E.G. PBX, NETWORK SWITCHES) ARE SHOWN FOR REFERENCE ONLY.
- 3. REFER TO ARCHITECTURAL DETAIL PLANS FOR FINAL PATIENT ROOM DEVICE LOCATIONS. REFER TO ARCHITECTURAL DETAILS FOR OVERCOUNTER WAO HEIGHTS. REFER TO ARCHITECTURAL DETAILS FOR WALL-MOUNT WAO HEIGHTS.
- 4. HORIZONTAL DATA/VOICE/VIDEO CABLE SHALL TERMINATE IN THE TECHNOLOGY ROOM ON THE SAME FLOOR AS THE WORK AREA OUTLETS.
- 5. WORK AREA OUTLETS SHALL CONSIST OF SINGLE PLASTER REDUCING RINGS INSTALLED ON OVERSIZE DOUBLE GANG BACKBOXES, UNLESS OTHERWISE NOTED.
- TV COAX CABLES SHALL BE COILED IN THE RESPECTIVE TECHNOLOGY ROOMS WITH A 20' SERVICE LOOP PRIOR TO TERMINATIONS. COILS SHALL BE SECURED TO THE AUDIOVISUAL WALL FIELD FOR AV CONTRACTOR.
 COMMON LOW VOLTAGE CABLE RUNWAY IS 24" W X 6" HIGH. PROVIDE ALL MATERIALS AS NEEDED FOR A COMPLETE, MANUFACTURER-APPROVED SYSTEM USING CABLE TRAY MANUFACTURERS' MATERIALS AND

PARTS WHEN AVAILABLE FROM THE MANUFACTURER AND AS INTENDED. REFER TO DRAWING T4.01 FOR

FIELD-INSTALLED SWEEPS AND TEES. ALL SWEEPS AND TEES SHALL MAINTAIN A 1 FOOT MINIMUM RADIUS IN CHANGES OF DIRECTION.


8. CABLE TRAY SHALL NOT PENETRATE WALLS. PROVIDE TRANSITION FROM CABLE TRAY TO LISTED FIRESTOP ASSEMBLIES IN ORDER TO PENETRATE FIRE/SMOKE WALLS. TRANSITION TO 4" CONDUITS/SLEEVES FOR


NON-RATED WALLS. PROVIDE SUFFICIENT CONDUITS/SLEEVES TO ACCOMMODATE 100% VISUAL CABLE TRAY

DETAILS. ALL CHANGES IN DIRECTION AND INTERSECTIONS SHALL USE PRE-MANUFACTURED OR

- 9. REFER TO ELECTRICAL DRAWINGS & SPECIFICATIONS FOR SHARED FLOOR BOXES & LOW VOLTAGE CONDUIT.
- 10. PROVIDE BRACING TO MEET OSHPD SEISMIC REQUIREMENTS. REFER TO SHEET T4.02 FOR MARE INFORMATION
- 11. PROVIDE ALL OUTLET CONDUITS FROM WORK AREA OUTLETS., DEVICES OR PULL BOXES TO NEAREST CABLE TRAY
- 12. INSTALL CABLE TRAY @ 6" ABOVE CEILING.

LOAD AT 50% VISUAL CONDUIT FILL.

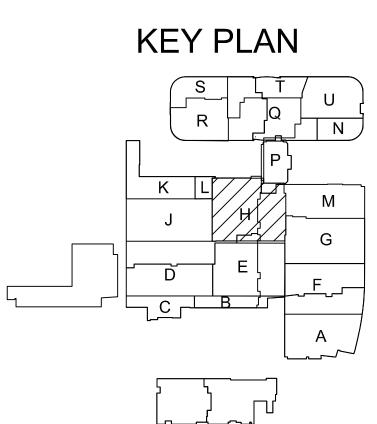

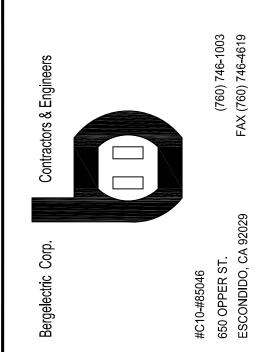

HLDREN'S HOSPITAL

- ORANGE COUNTY - TOWER

South Main Street
ige, CA 92868-3874

PROPRIETARY STATEMENT

THESE DRAWINGS/DOCUMENTS HEREIN ATTACHED ARE THE PROPERTY OF BERGELECTRIC CORPORATION ANY REUSE OR REPRODUCTION OF THESE DOCUMENTS WITHOUT WRITTEN

DRAWN BY:
J.RAMIREZ

FORBIDDEN. ALL RIGHTS RESERVED.

PERMISSION OF BERGELECTRIC CORPORATION IS STRICTLY

DESIGN SUPERVISOR:

INSTALL SUPERVISOR:

Scott Adams
Tel Data Systems
Bergelectric Corporation
650 Opper Street
Escondido, CA 92029

REVISION:
05-30-12 RECORD DRAWINGS

SHEET TITLE:


SHEET TITLE:


TELECOM FLOOR PLAN LOWER LEVEL AREA-H

> SCALE: 1/4"=1'0"

DRAWING NO. :

T3.0H RECORD DRAWING

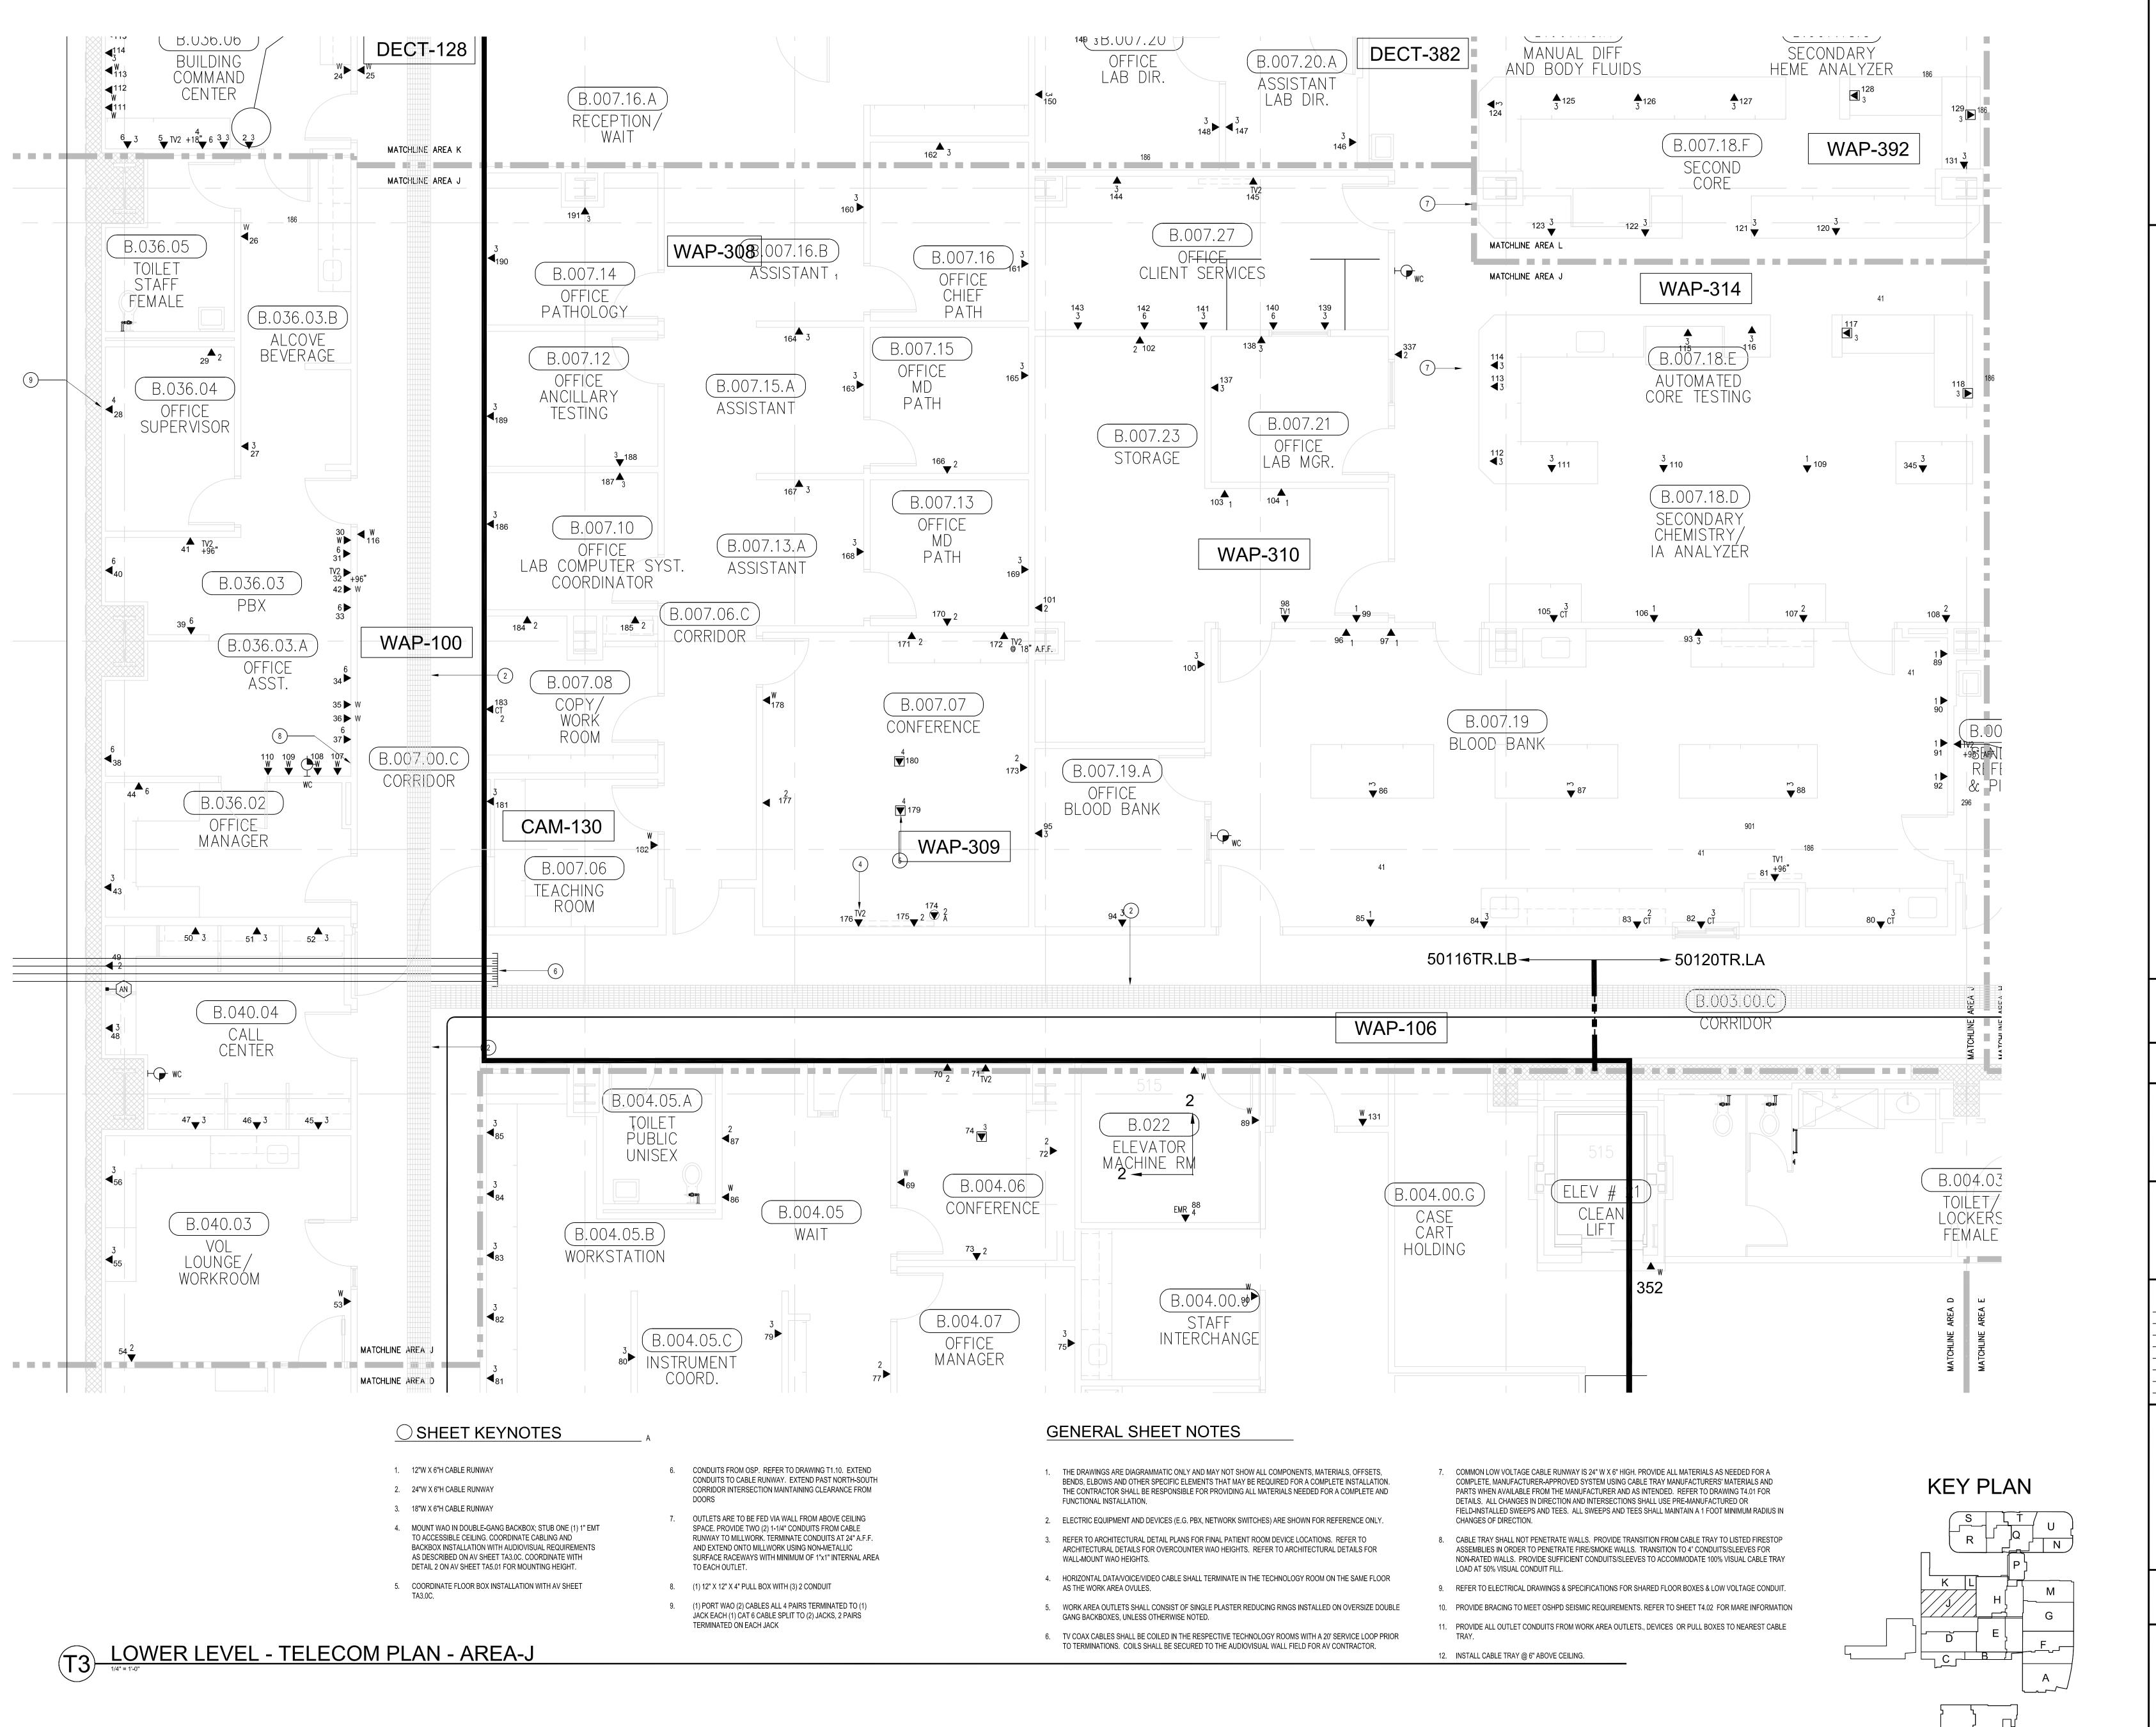

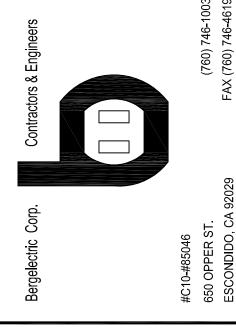

PROJECT: CHILDREN'S HOSPITAL

OF ORANGE COUNTY - TOWER II

ADDRESS: 455 South Main Street
Orange, CA 92868-3874

PROPRIETARY STATEMENT

THESE DRAWINGS/DOCUMENTS HEREIN ATTACHED ARE THE PROPERTY OF BERGELECTRIC CORPORATION ANY REUSE OR REPRODUCTION OF THESE DOCUMENTS WITHOUT WRITTEN PERMISSION OF BERGELECTRIC CORPORATION IS STRICTLY FORBIDDEN. ALL RIGHTS RESERVED.

DRAWN BY:

J.RAMIREZ

DESIGN SUPERVISOR:

INSTALL SUPERVISOR:

Scott Adams
Tel Data Systems
Bergelectric Corporation
650 Opper Street
Escondido, CA 92029

REVISION:
05-30-12 RECORD DRAWINGS


SHEET TITLE:

TELECOM FLOOR PLAN LOWER LEVEL AREA-J

> SCALE: 1/4"=1'0"

DRAWING NO. :

T3.0J RECORD DRAWING

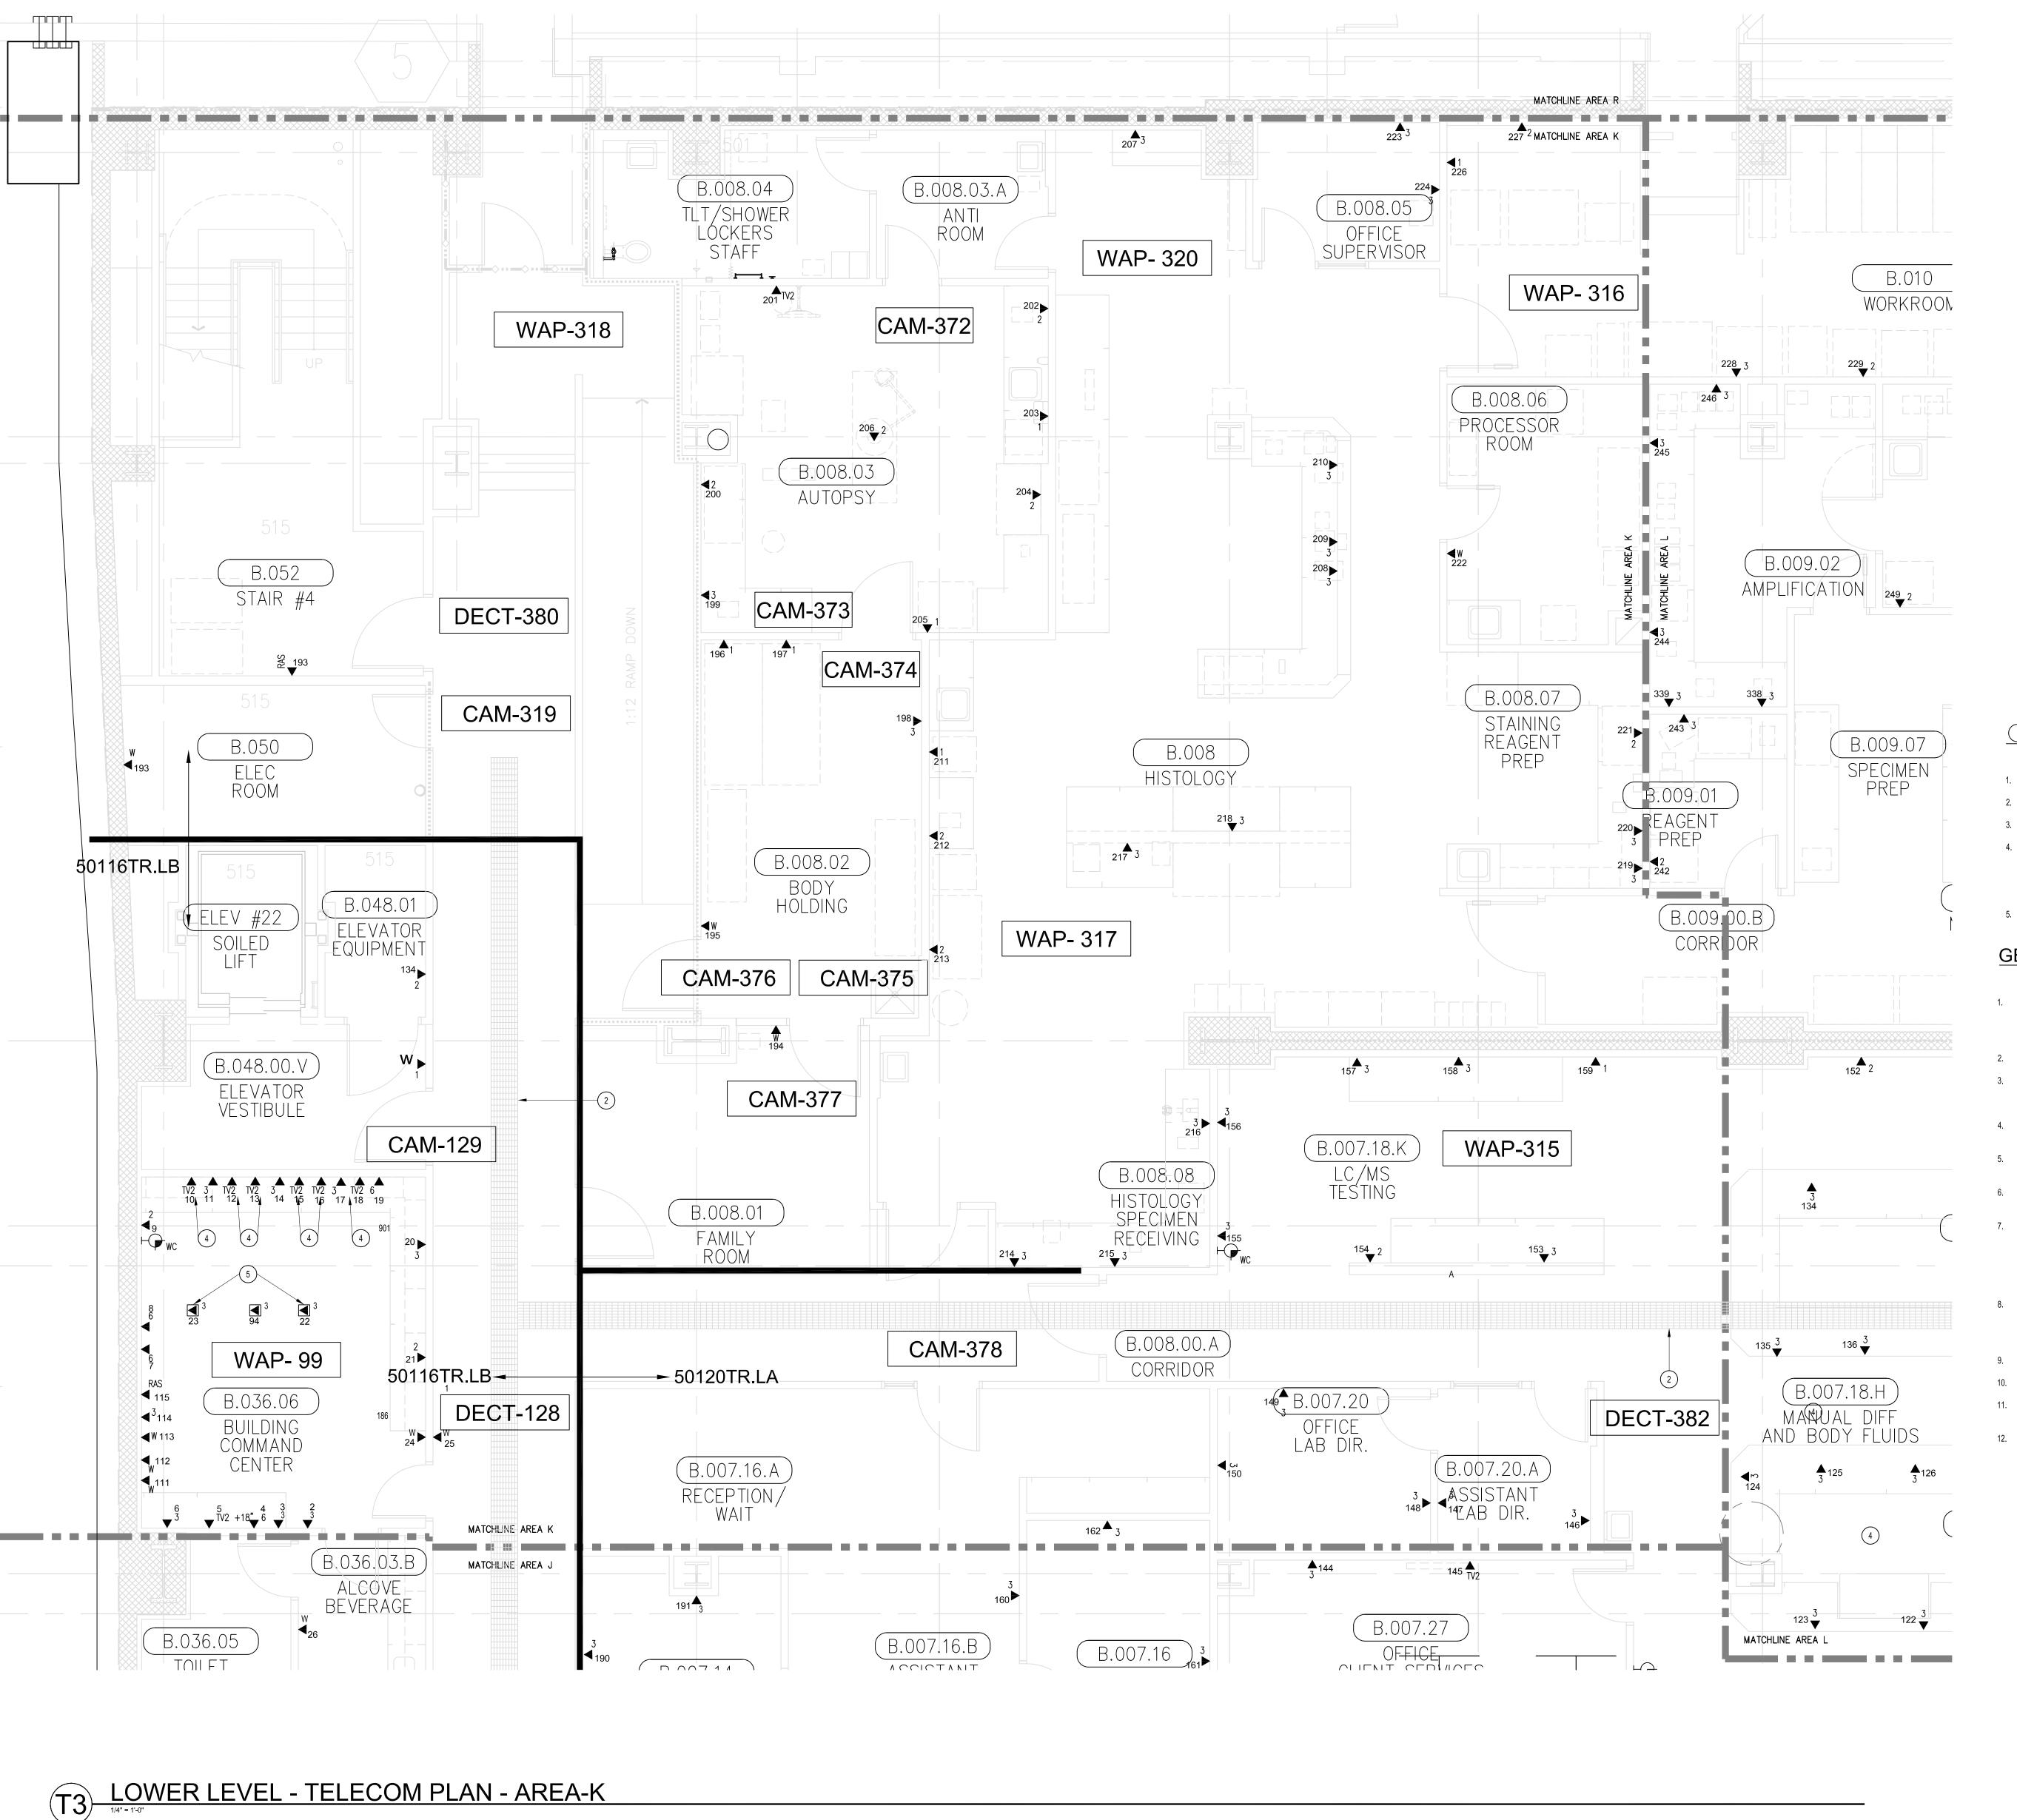

SHEET KEYNOTES

1. 12"W X 6"H CABLE RUNWAY

2. 24"W X 6"H CABLE RUNWAY


3. 18"W X 6"H CABLE RUNWAY

4. MOUNT WAO IN DOUBLE-GANG BACKBOX; STUB ONE (1) 1" EMT TO ACCESSIBLE CEILING. COORDINATE CABLING AND BACKBOX INSTALLATION WITH AUDIOVISUAL REQUIREMENTS AS DESCRIBED ON AV SHEET TA3.0C. COORDINATE WITH DETAIL 1 ON AV SHEET TA5.01 FOR MOUNTING HEIGHT.

5. COORDINATE FLOOR BOX INSTALLATION WITH AV SHEET

GENERAL SHEET NOTES

- 1. THE DRAWINGS ARE DIAGRAMMATIC ONLY AND MAY NOT SHOW ALL COMPONENTS, MATERIALS, OFFSETS, BENDS, ELBOWS AND OTHER SPECIFIC ELEMENTS THAT MAY BE REQUIRED FOR A COMPLETE INSTALLATION. THE CONTRACTOR SHALL BE RESPONSIBLE FOR PROVIDING ALL MATERIALS NEEDED FOR A COMPLETE AND FUNCTIONAL INSTALLATION.
- 2. ELECTRIC EQUIPMENT AND DEVICES (E.G. PBX, NETWORK SWITCHES) ARE SHOWN FOR REFERENCE ONLY.
- 3. REFER TO ARCHITECTURAL DETAIL PLANS FOR FINAL PATIENT ROOM DEVICE LOCATIONS. REFER TO ARCHITECTURAL DETAILS FOR OVERCOUNTER WAO HEIGHTS. REFER TO ARCHITECTURAL DETAILS FOR WALL-MOUNT WAO HEIGHTS.
- HORIZONTAL DATA/VOICE/VIDEO CABLE SHALL TERMINATE IN THE TECHNOLOGY ROOM ON THE SAME FLOOR AS THE WORK AREA OUTLETS.
- 5. WORK AREA OUTLETS SHALL CONSIST OF SINGLE PLASTER REDUCING RINGS INSTALLED ON OVERSIZE DOUBLE GANG BACKBOXES, UNLESS OTHERWISE NOTED.
- 6. TV COAX CABLES SHALL BE COILED IN THE RESPECTIVE TECHNOLOGY ROOMS WITH A 20' SERVICE LOOP PRIOR TO TERMINATIONS. COILS SHALL BE SECURED TO THE AUDIOVISUAL WALL FIELD FOR AV CONTRACTOR.
- COMMON LOW VOLTAGE CABLE RUNWAY IS 24" W X 6" HIGH. PROVIDE ALL MATERIALS AS NEEDED FOR A COMPLETE, MANUFACTURER-APPROVED SYSTEM USING CABLE TRAY MANUFACTURERS' MATERIALS AND PARTS WHEN AVAILABLE FROM THE MANUFACTURER AND AS INTENDED. REFER TO DRAWING T4.01 FOR DETAILS. ALL CHANGES IN DIRECTION AND INTERSECTIONS SHALL USE PRE-MANUFACTURED OR FIELD-INSTALLED SWEEPS AND TEES. ALL SWEEPS AND TEES SHALL MAINTAIN A 1 FOOT MINIMUM RADIUS IN
- CABLE TRAY SHALL NOT PENETRATE WALLS. PROVIDE TRANSITION FROM CABLE TRAY TO LISTED FIRESTOP ASSEMBLIES IN ORDER TO PENETRATE FIRE/SMOKE WALLS. TRANSITION TO 4" CONDUITS/SLEEVES FOR NON-RATED WALLS. PROVIDE SUFFICIENT CONDUITS/SLEEVES TO ACCOMMODATE 100% VISUAL CABLE TRAY
- LOAD AT 50% VISUAL CONDUIT FILL. 9. REFER TO ELECTRICAL DRAWINGS & SPECIFICATIONS FOR SHARED FLOOR BOXES & LOW VOLTAGE CONDUIT.
- 10. PROVIDE BRACING TO MEET OSHPD SEISMIC REQUIREMENTS. REFER TO SHEET T4.02 FOR MARE INFORMATION
- 11. PROVIDE ALL OUTLET CONDUITS FROM WORK AREA OUTLETS., DEVICES OR PULL BOXES TO NEAREST CABLE
- 12. INSTALL CABLE TRAY @ 6" ABOVE CEILING.

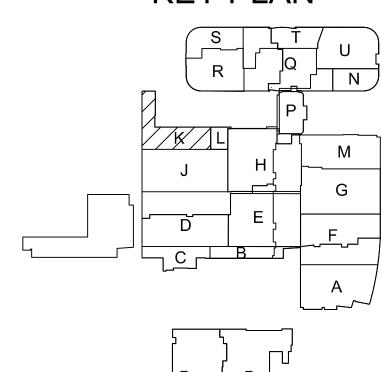

KEY PLAN

HOSPIT HLDREN'S : ORANGE

PROPRIETARY STATEMENT THESE DRAWINGS/DOCUMENTS HEREIN ATTACHED ARE THE PROPERTY OF BERGELECTRIC CORPORATION ANY REUSE OR REPRODUCTION OF THESE DOCUMENTS WITHOUT WRITTEN

J.RAMIREZ

PERMISSION OF BERGELECTRIC CORPORATION IS STRICTLY

FORBIDDEN. ALL RIGHTS RESERVED.

DESIGN SUPERVISOR:

INSTALL SUPERVISOR: Scott Adams Tel Data Systems
Bergelectric Corporation
650 Opper Street
Escondido, CA 92029

05-30-12 RECORD DRAWINGS


SHEET TITLE:

TELECOM FLOOR PLAN LOWER LEVEL AREA-K

> SCALE: 1/4"=1'0"

DRAWING NO.:

T3.0K RECORD DRAWING

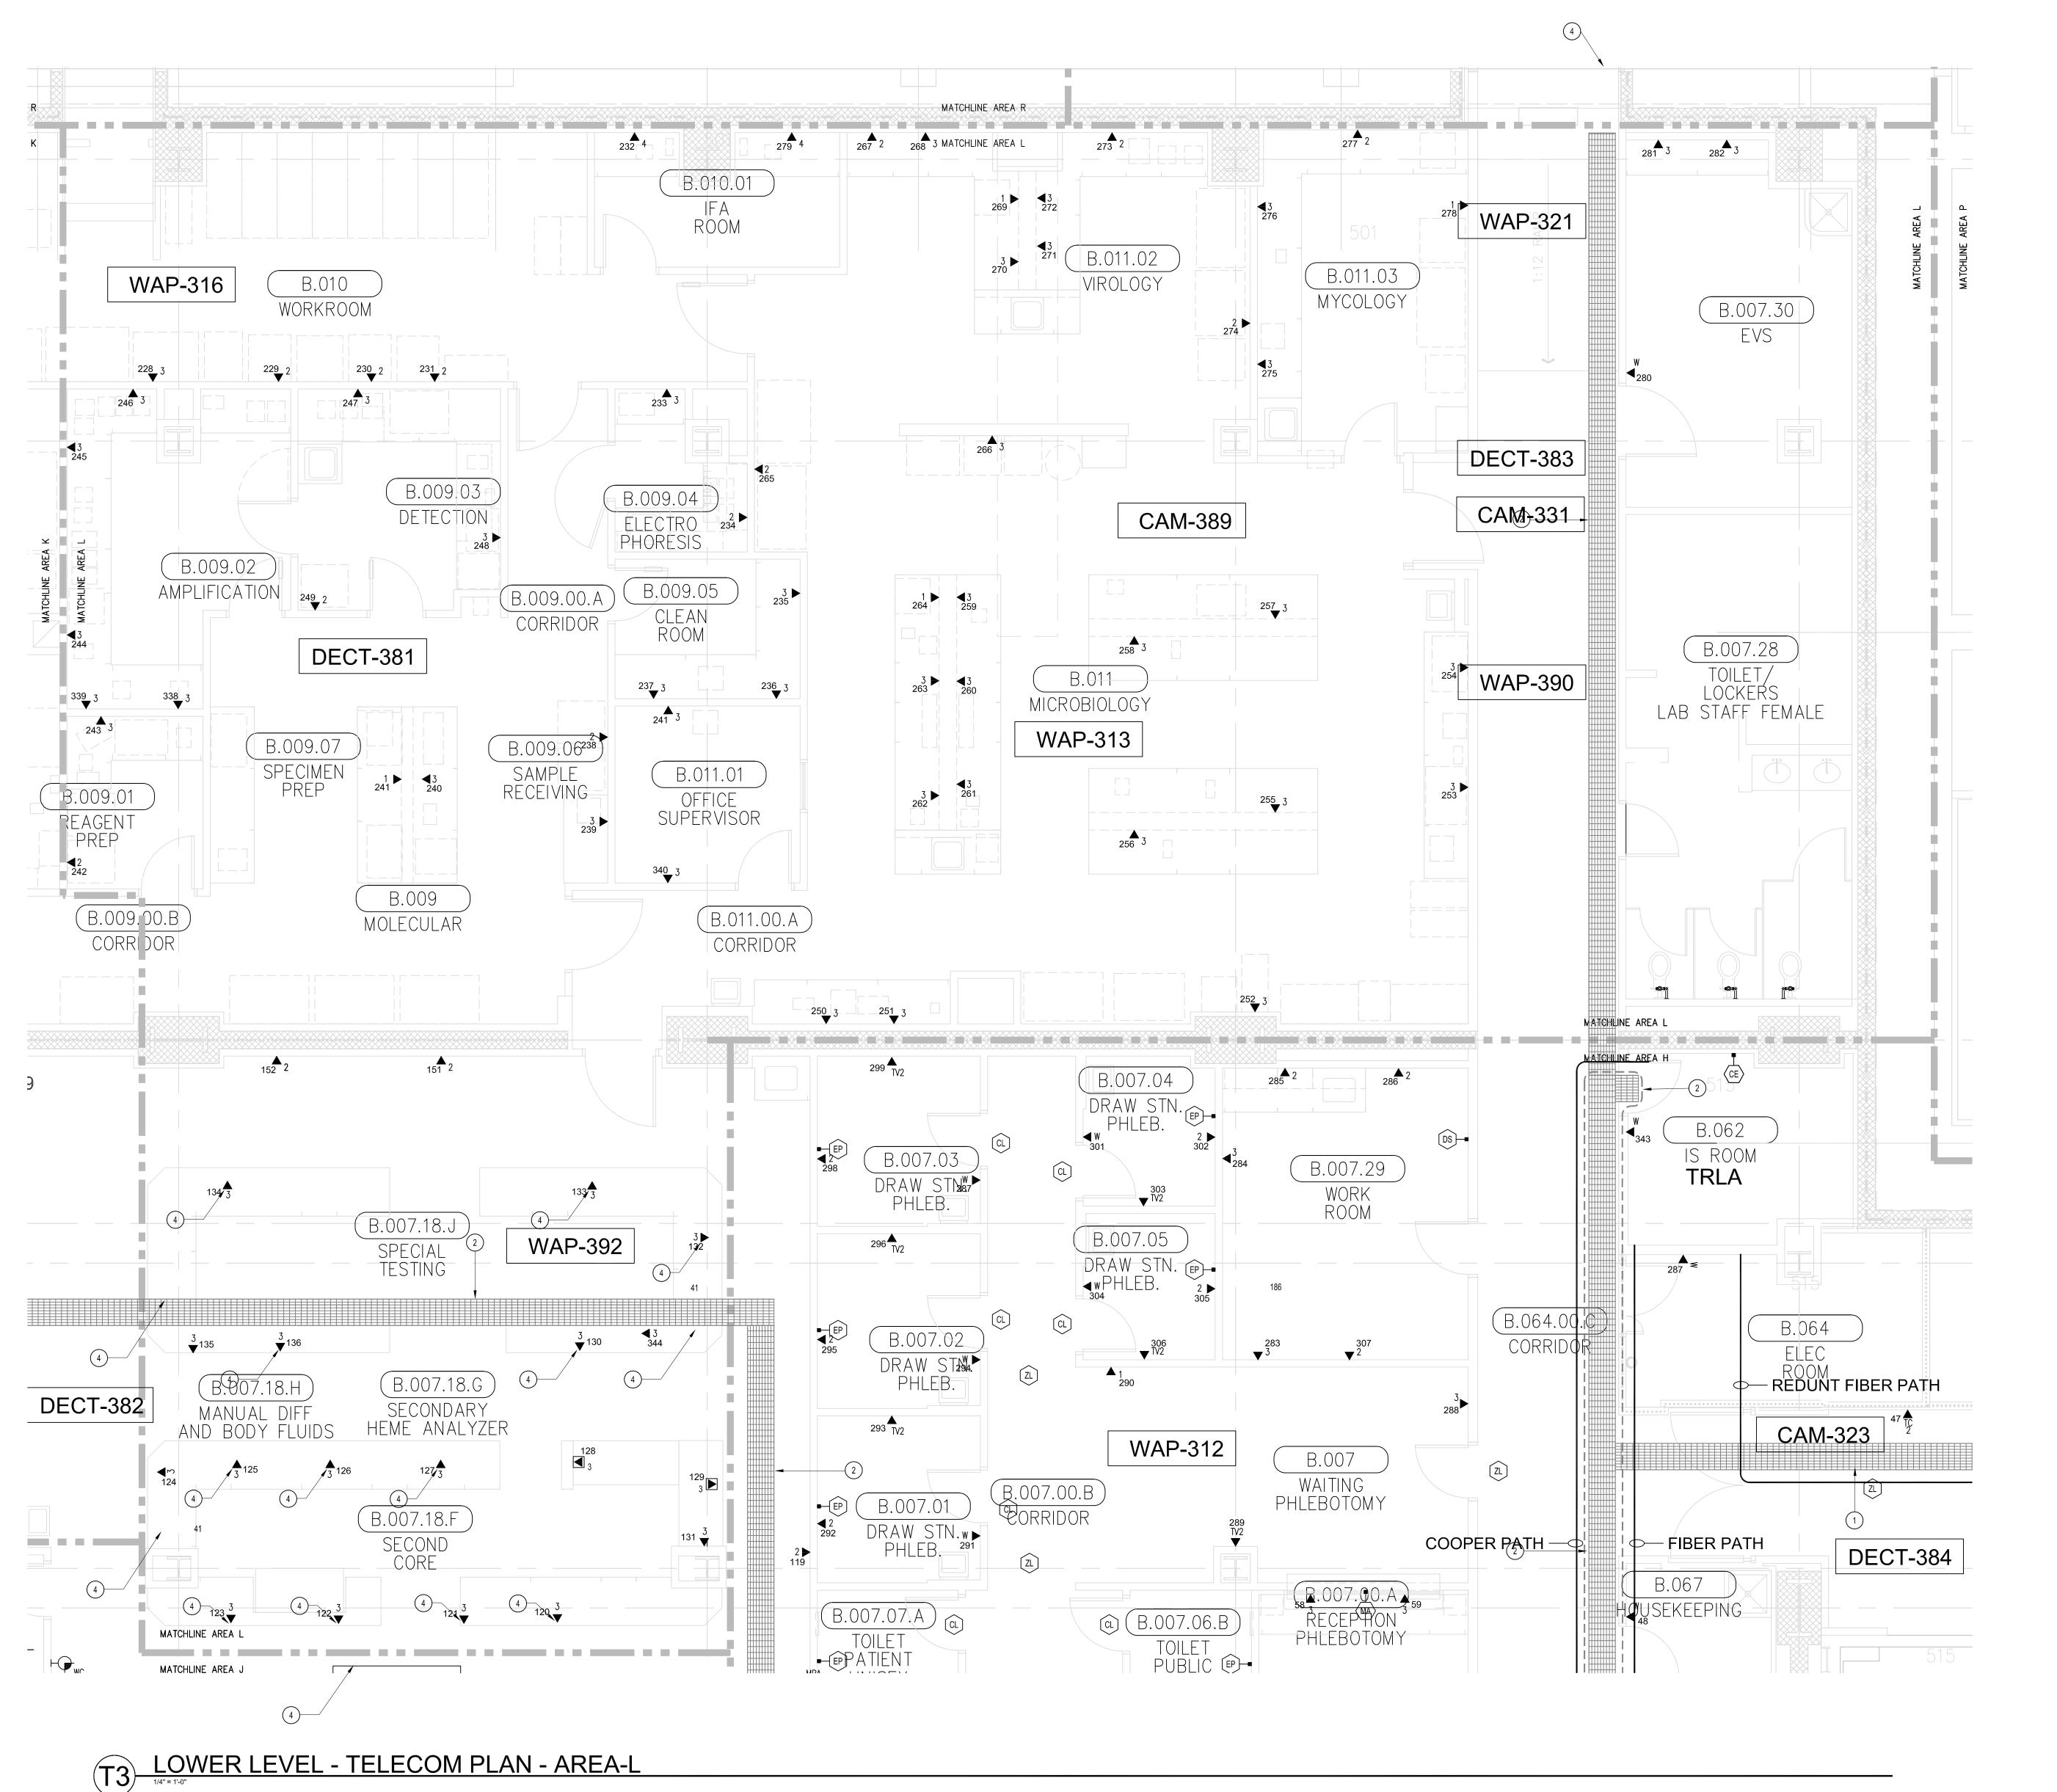


SHEET KEYNOTES

- 1. 12"W X 6"H CABLE RUNWAY
- 2. 24"W X 6"H CABLE RUNWAY
- 3. 18"W X 6"H CABLE RUNWAY
- 4. OUTLETS ARE TO BE FED VIA WALL FROM ABOVE CEILING SPACE. PROVIDE TWO (2) 1-1/4" CONDUITS FROM CABLE RUNWAY TO MILLWORK. TERMINATE CONDUITS AT 24" A.F.F. AND EXTEND ONTO MILLWORK USING NON-METALLIC SURFACE RACEWAYS WITH MINIMUM OF 1"x1" INTERNAL AREA TO FACH OUTLET.
- 5. OUTLETS TO BE FED FROM FLOORBOX.

GENERAL SHEET NOTES

- 1. THE DRAWINGS ARE DIAGRAMMATIC ONLY AND MAY NOT SHOW ALL COMPONENTS, MATERIALS, OFFSETS, BENDS, ELBOWS AND OTHER SPECIFIC ELEMENTS THAT MAY BE REQUIRED FOR A COMPLETE INSTALLATION. THE CONTRACTOR SHALL BE RESPONSIBLE FOR PROVIDING ALL MATERIALS NEEDED FOR A COMPLETE AND FUNCTIONAL INSTALLATION.
- ELECTRIC EQUIPMENT AND DEVICES (E.G. PBX, NETWORK SWITCHES) ARE SHOWN FOR REFERENCE ONLY.
 REFER TO ARCHITECTURAL DETAIL PLANS FOR FINAL PATIENT ROOM DEVICE LOCATIONS. REFER TO ARCHITECTURAL DETAILS FOR OVERCOUNTER WAO HEIGHTS. REFER TO ARCHITECTURAL DETAILS FOR WALL-MOUNT WAO HEIGHTS.
- 4. HORIZONTAL DATA/VOICE/VIDEO CABLE SHALL TERMINATE IN THE TECHNOLOGY ROOM ON THE SAME FLOOR AS THE WORK AREA OUTLETS.
- 5. WORK AREA OUTLETS SHALL CONSIST OF SINGLE PLASTER REDUCING RINGS INSTALLED ON OVERSIZE DOUBLE GANG BACKBOXES, UNLESS OTHERWISE NOTED.
- 6. TV COAX CABLES SHALL BE COILED IN THE RESPECTIVE TECHNOLOGY ROOMS WITH A 20' SERVICE LOOP PRIOR TO TERMINATIONS. COILS SHALL BE SECURED TO THE AUDIOVISUAL WALL FIELD FOR AV CONTRACTOR.
- 7. COMMON LOW VOLTAGE CABLE RUNWAY IS 24" W X 6" HIGH. PROVIDE ALL MATERIALS AS NEEDED FOR A COMPLETE, MANUFACTURER-APPROVED SYSTEM USING CABLE TRAY MANUFACTURERS' MATERIALS AND PARTS WHEN AVAILABLE FROM THE MANUFACTURER AND AS INTENDED. REFER TO DRAWING T4.01 FOR DETAILS. ALL CHANGES IN DIRECTION AND INTERSECTIONS SHALL USE PRE-MANUFACTURED OR FIELD-INSTALLED SWEEPS AND TEES. ALL SWEEPS AND TEES SHALL MAINTAIN A 1 FOOT MINIMUM RADIUS IN CHANGES OF DIRECTION.
- 8. CABLE TRAY SHALL NOT PENETRATE WALLS. PROVIDE TRANSITION FROM CABLE TRAY TO LISTED FIRESTOP ASSEMBLIES IN ORDER TO PENETRATE FIRE/SMOKE WALLS. TRANSITION TO 4" CONDUITS/SLEEVES FOR NON-RATED WALLS. PROVIDE SUFFICIENT CONDUITS/SLEEVES TO ACCOMMODATE 100% VISUAL CABLE TRAY LOAD AT 50% VISUAL CONDUIT FILL.
- 9. REFER TO ELECTRICAL DRAWINGS & SPECIFICATIONS FOR SHARED FLOOR BOXES & LOW VOLTAGE CONDUIT.
- 10. PROVIDE BRACING TO MEET OSHPD SEISMIC REQUIREMENTS. REFER TO SHEET T4.02 FOR MARE INFORMATION
 11. PROVIDE ALL OUTLET CONDUITS FROM WORK AREA OUTLETS., DEVICES OR PULL BOXES TO NEAREST CABLE
- 12. INSTALL CABLE TRAY @ 6" ABOVE CEILING.



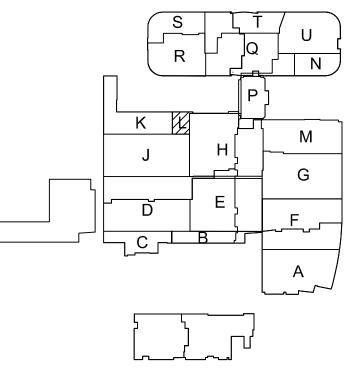

Bergelectric Corp.

Contractors & Engineers

Contractors & Engineers

#C10-#85046

#C10-#85046

650 OPPER ST.

(760) 746-100

CHILDREN'S HOSPITAL
OF ORANGE COUNTY - TOWEF

PROPRIETARY STATEMENT

THESE DRAWINGS/DOCUMENTS HEREIN ATTACHED ARE THE PROPERTY OF BERGELECTRIC CORPORATION ANY REUSE OR REPRODUCTION OF THESE DOCUMENTS WITHOUT WRITTEN PERMISSION OF BERGELECTRIC CORPORATION IS STRICTLY FORBIDDEN. ALL RIGHTS RESERVED.

DRAWN BY:
J.RAMIREZ

DESIGN SUPERVISOR:

INSTALL SUPERVISOR:
Scott Adams

Bergelectric Corporation

Tel Data Systems

650 Opper Street

Escondido, CA 92029

REVISION:

05-30-12 RECORD DRAWINGS


SHEET TITLE:

TELECOM FLOOR PLAN LOWER LEVEL AREA-L

> SCALE: 1/4"=1'0"

DRAWING NO. :

T3.0L RECORD DRAWING

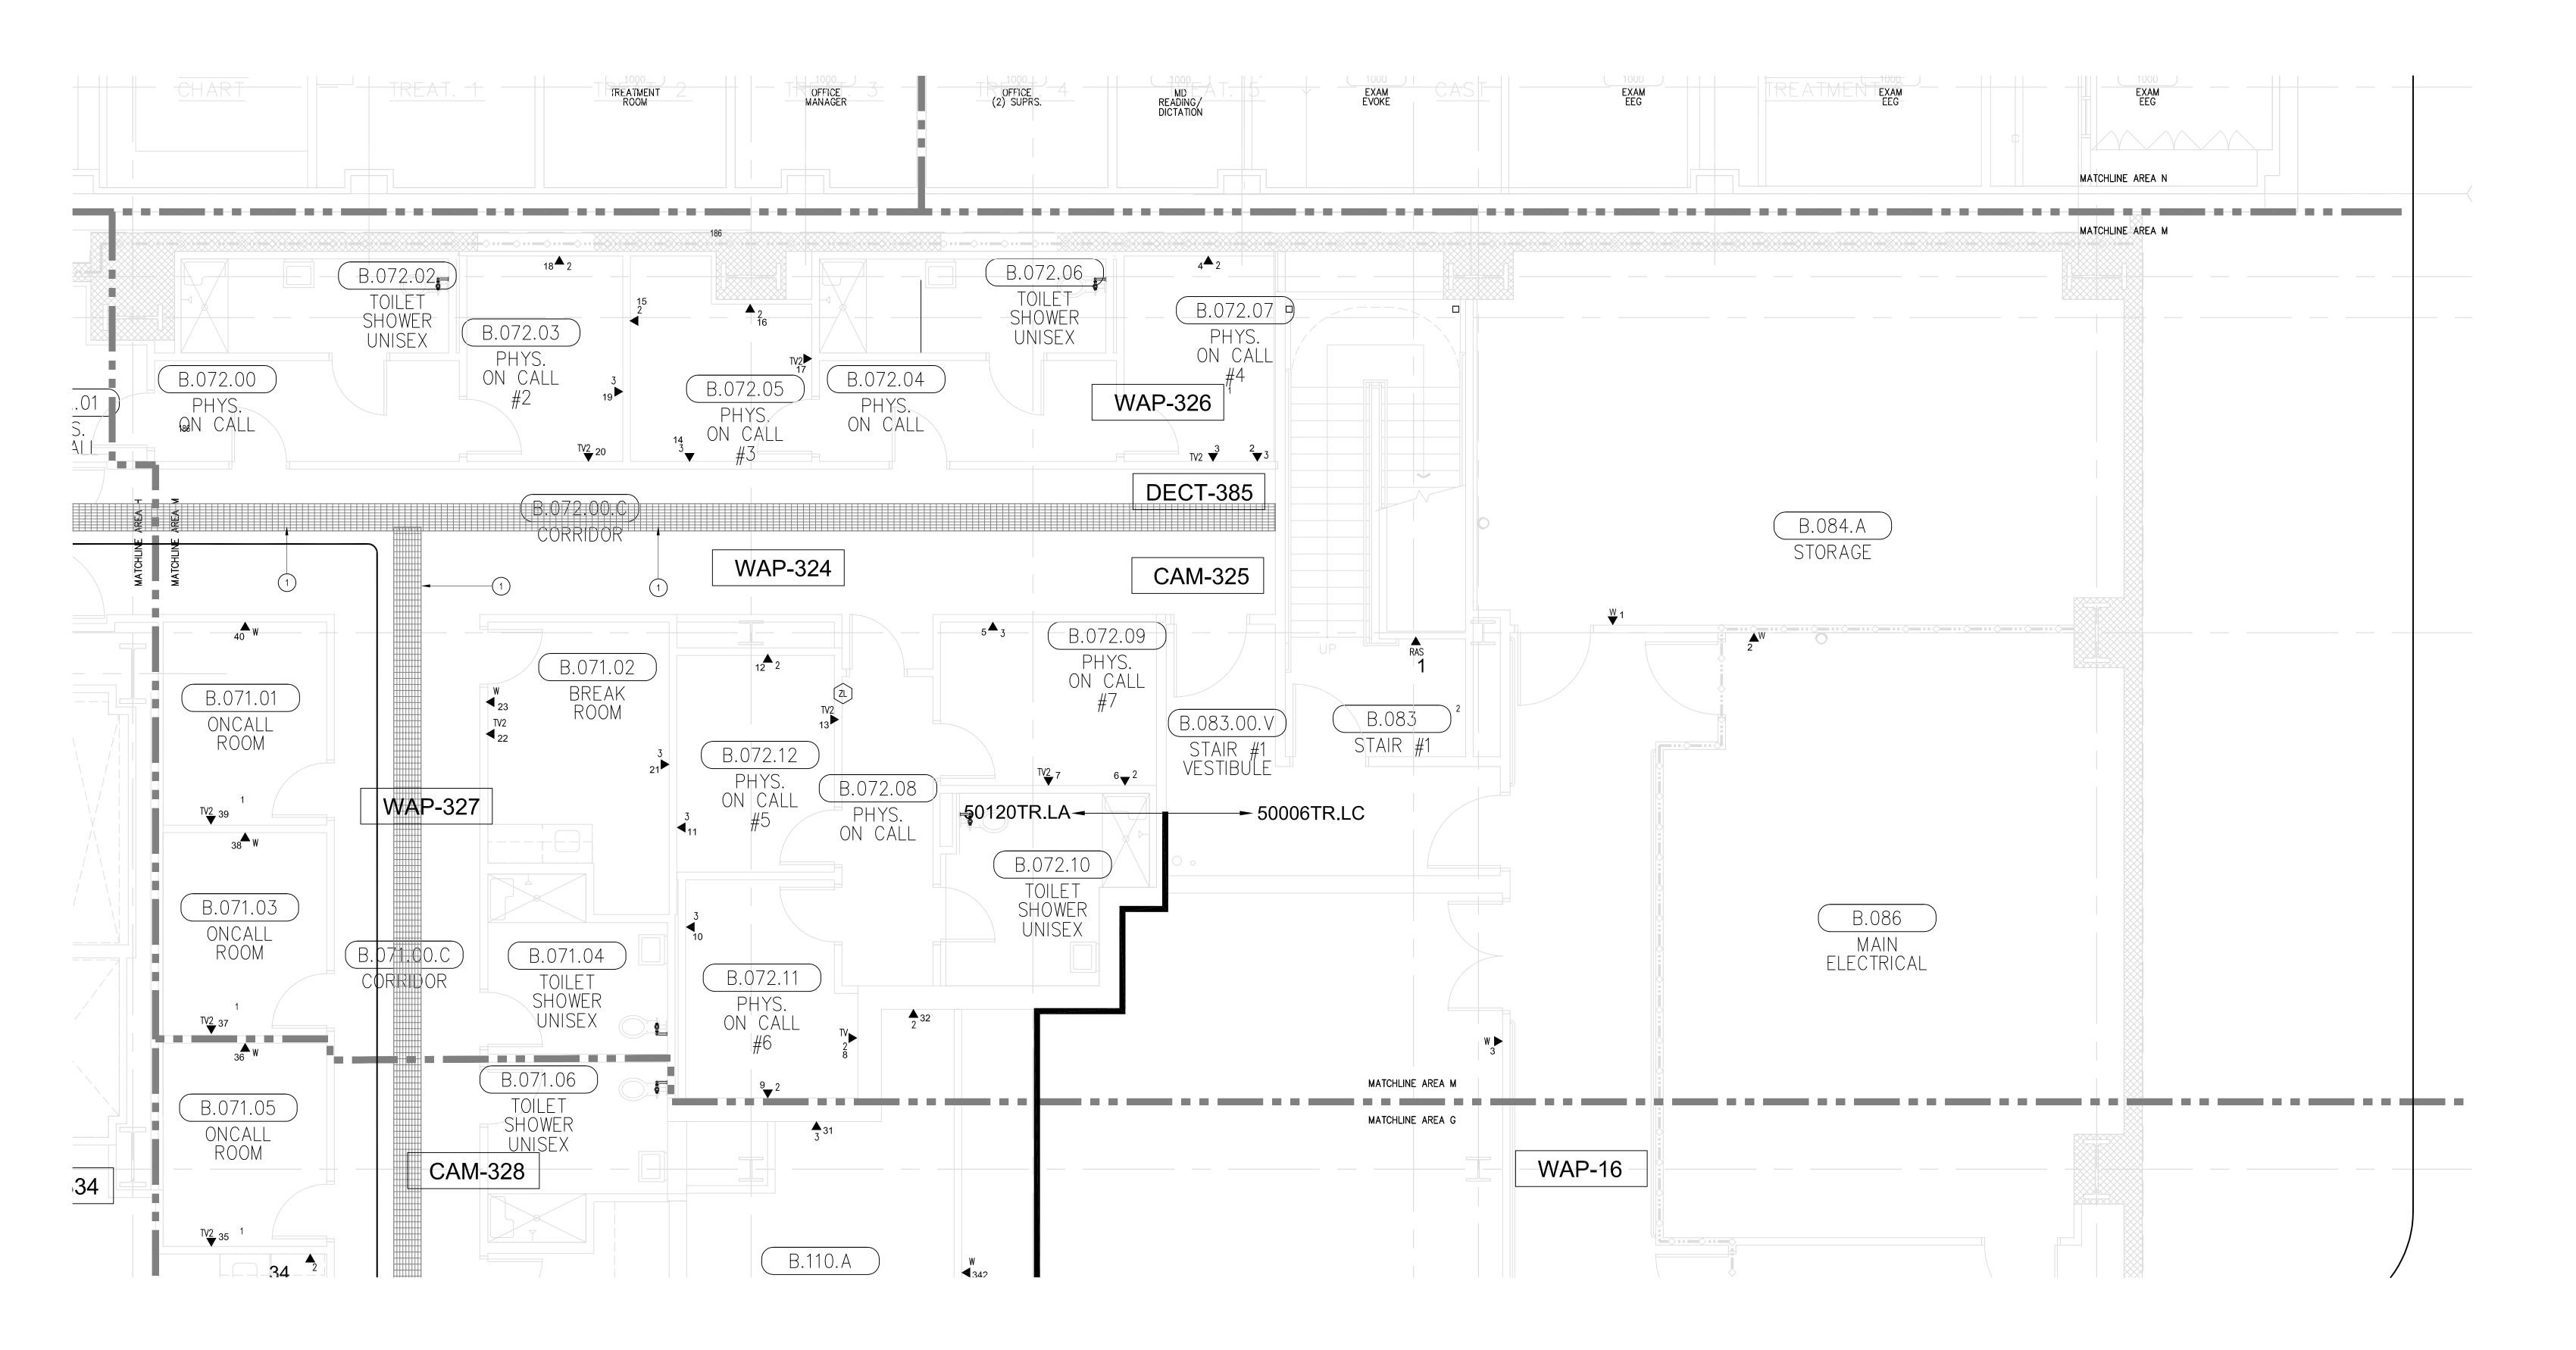



O SHEET KEYNOTES

- 1. 12"W X 6"H CABLE RUNWAY
- 2. 24"W X 6"H CABLE RUNWAY
- 3. 18"W X 6"H CABLE RUNWAY

GENERAL SHEET NOTES

- 1. THE DRAWINGS ARE DIAGRAMMATIC ONLY AND MAY NOT SHOW ALL COMPONENTS, MATERIALS, OFFSETS, BENDS, ELBOWS AND OTHER SPECIFIC ELEMENTS THAT MAY BE REQUIRED FOR A COMPLETE INSTALLATION. THE CONTRACTOR SHALL BE RESPONSIBLE FOR PROVIDING ALL MATERIALS NEEDED FOR A COMPLETE AND
- 2. ELECTRIC EQUIPMENT AND DEVICES (E.G. PBX, NETWORK SWITCHES) ARE SHOWN FOR REFERENCE ONLY. 3. REFER TO ARCHITECTURAL DETAIL PLANS FOR FINAL PATIENT ROOM DEVICE LOCATIONS. REFER TO
- ARCHITECTURAL DETAILS FOR OVERCOUNTER WAO HEIGHTS. REFER TO ARCHITECTURAL DETAILS FOR WALL-MOUNT WAO HEIGHTS.
- 4. HORIZONTAL DATA/VOICE/VIDEO CABLE SHALL TERMINATE IN THE TECHNOLOGY ROOM ON THE SAME FLOOR AS THE WORK AREA OUTLETS.
- 5. WORK AREA OUTLETS SHALL CONSIST OF SINGLE PLASTER REDUCING RINGS INSTALLED ON OVERSIZE DOUBLE GANG BACKBOXES, UNLESS OTHERWISE NOTED.
- 6. TV COAX CABLES SHALL BE COILED IN THE RESPECTIVE TECHNOLOGY ROOMS WITH A 20' SERVICE LOOP PRIOR TO TERMINATIONS. COILS SHALL BE SECURED TO THE AUDIOVISUAL WALL FIELD FOR AV CONTRACTOR.
- 7. COMMON LOW VOLTAGE CABLE TRAY IS SIZED AS INDICATED ON THE DRAWINGS. PROVIDE ALL MATERIALS AS NEEDED FOR A COMPLETE, MANUFACTURER-APPROVED SYSTEM USING CABLE TRAY MANUFACTURERS' MATERIALS AND PARTS WHEN AVAILABLE FROM THE MANUFACTURER AND AS INTENDED. REFER TO DRAWING T4.01 FOR DETAILS. ALL CHANGES IN DIRECTION AND INTERSECTIONS SHALL USE PRE-MANUFACTURED OR FIELD-INSTALLED SWEEPS AND TEES. ALL SWEEPS AND TEES SHALL MAINTAIN A 1 FOOT MINIMUM RADIUS IN CHANGES OF DIRECTION.
- 8. CABLE TRAY SHALL NOT PENETRATE WALLS. PROVIDE TRANSITION FROM CABLE TRAY TO LISTED FIRESTOP ASSEMBLIES IN ORDER TO PENETRATE FIRE/SMOKE WALLS. TRANSITION TO 4" CONDUITS/SLEEVES FOR NON-RATED WALLS. PROVIDE SUFFICIENT CONDUITS/SLEEVES TO ACCOMMODATE 100% VISUAL CABLE TRAY LOAD AT 50% VISUAL CONDUIT FILL.
- 9. REFER TO ELECTRICAL DRAWINGS & SPECIFICATIONS FOR SHARED FLOOR BOXES & LOW VOLTAGE CONDUIT. 10. PROVIDE BRACING TO MEET OSHPD SEISMIC REQUIREMENTS. REFER TO SHEET T4.02 FOR MARE INFORMATION
- 11. PROVIDE ALL OUTLET CONDUITS FROM WORK AREA OUTLETS., DEVICES OR PULL BOXES TO NEAREST CABLE
- 12. INSTALL CABLE TRAY @ 6" ABOVE CEILING.

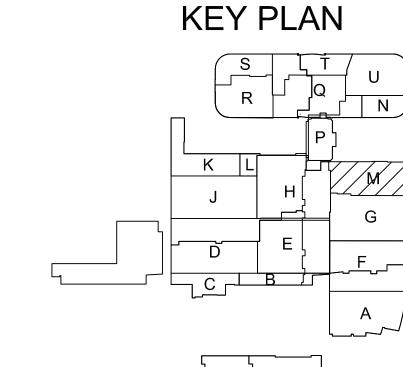

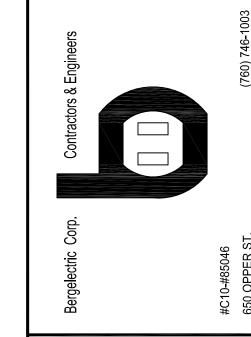

PROPRIETARY STATEMENT THESE DRAWINGS/DOCUMENTS HEREIN ATTACHED ARE THE

PROPERTY OF BERGELECTRIC CORPORATION ANY REUSE OR REPRODUCTION OF THESE DOCUMENTS WITHOUT WRITTEN PERMISSION OF BERGELECTRIC CORPORATION IS STRICTLY FORBIDDEN. ALL RIGHTS RESERVED.

J.RAMIREZ DESIGN SUPERVISOR:

INSTALL SUPERVISOR: Scott Adams Tel Data Systems Bergelectric Corporation 650 Opper Street Escondido, CA 92029

05-30-12 RECORD DRAWINGS

SHEET TITLE:


TELECOM FLOOR PLAN LOWER LEVEL AREA-M

> SCALE: 1/4"=1'0"

DRAWING NO.:

T3.0M RECORD DRAWING

T3 LOWER LEVEL - TELECOM PLAN - AREA-M

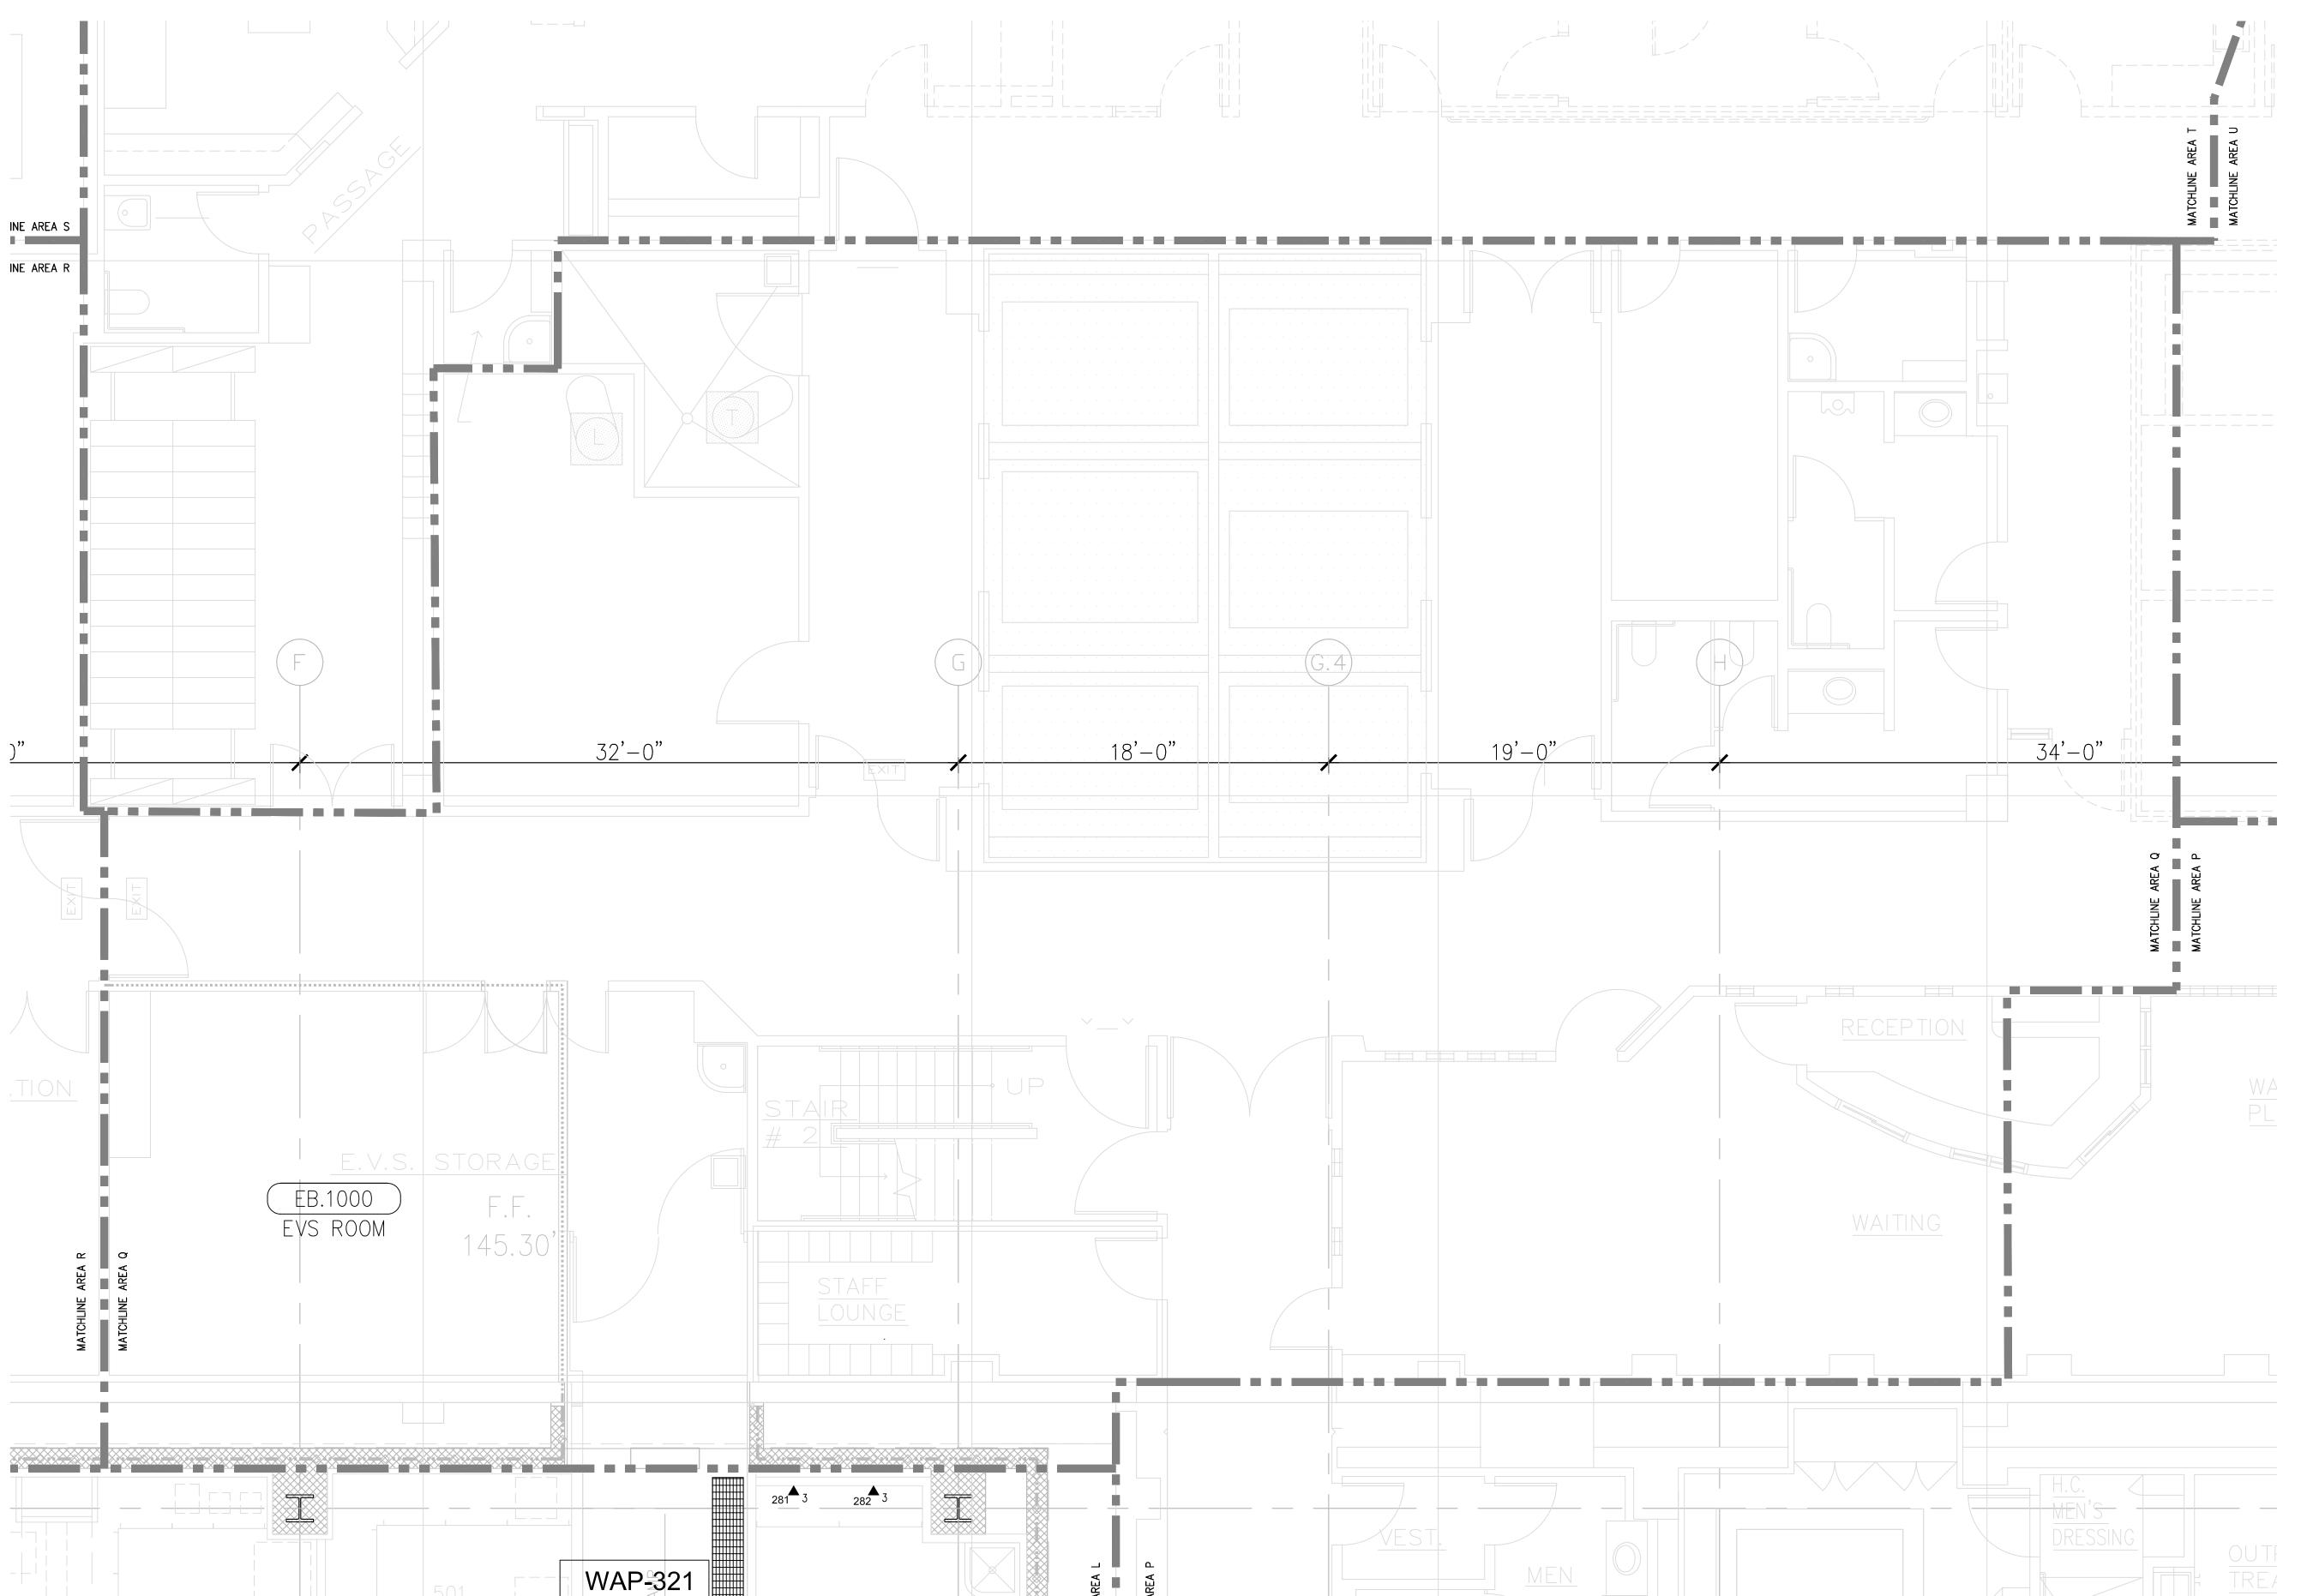

○ SHEET KEYNOTES

1. 12"W X 6"H CABLE RUNWAY

24"W X 6"H CABLE RUNWAY
 18"W X 6"H CABLE RUNWAY

GENERAL SHEET NOTES

1. THE DRAWINGS ARE DIAGRAMMATIC ONLY AND MAY NOT SHOW ALL COMPONENTS, MATERIALS, OFFSETS, BENDS, ELBOWS AND OTHER SPECIFIC ELEMENTS THAT MAY BE REQUIRED FOR A COMPLETE INSTALLATION. THE CONTRACTOR SHALL BE RESPONSIBLE FOR PROVIDING ALL MATERIALS NEEDED FOR A COMPLETE AND FUNCTIONAL INSTALLATION.

ELECTRIC EQUIPMENT AND DEVICES (E.G. PBX, NETWORK SWITCHES) ARE SHOWN FOR REFERENCE ONLY.
 REFER TO ARCHITECTURAL DETAIL PLANS FOR FINAL PATIENT ROOM DEVICE LOCATIONS. REFER TO ARCHITECTURAL DETAILS FOR OVERCOUNTER WAO HEIGHTS. REFER TO ARCHITECTURAL DETAILS FOR

WALL-MOUNT WAO HEIGHTS.
4. HORIZONTAL DATA/VOICE/VIDEO CABLE SHALL TERMINATE IN THE TECHNOLOGY ROOM ON THE SAME FLOOR AS THE WORK AREA OUTLETS.

5. WORK AREA OUTLETS SHALL CONSIST OF SINGLE PLASTER REDUCING RINGS INSTALLED ON OVERSIZE DOUBLE GANG BACKBOXES, UNLESS OTHERWISE NOTED.

6. TV COAX CABLES SHALL BE COILED IN THE RESPECTIVE TECHNOLOGY ROOMS WITH A 20' SERVICE LOOP PRIOR TO TERMINATIONS. COILS SHALL BE SECURED TO THE AUDIOVISUAL WALL FIELD FOR AV CONTRACTOR.

7. COMMON LOW VOLTAGE CABLE TRAY IS SIZED AS INDICATED ON THE DRAWINGS. PROVIDE ALL MATERIALS AS NEEDED FOR A COMPLETE, MANUFACTURER-APPROVED SYSTEM USING CABLE TRAY MANUFACTURERS' MATERIALS AND PARTS WHEN AVAILABLE FROM THE MANUFACTURER AND AS INTENDED. REFER TO DRAWING T4.01 FOR DETAILS. ALL CHANGES IN DIRECTION AND INTERSECTIONS SHALL USE PRE-MANUFACTURED OR FIELD-INSTALLED SWEEPS AND TEES. ALL SWEEPS AND TEES SHALL MAINTAIN A 1 FOOT MINIMUM RADIUS IN CHANGES OF DIRECTION.

8. CABLE TRAY SHALL NOT PENETRATE WALLS. PROVIDE TRANSITION FROM CABLE TRAY TO LISTED FIRESTOP ASSEMBLIES IN ORDER TO PENETRATE FIRE/SMOKE WALLS. TRANSITION TO 4" CONDUITS/SLEEVES FOR NON-RATED WALLS. PROVIDE SUFFICIENT CONDUITS/SLEEVES TO ACCOMMODATE 100% VISUAL CABLE TRAY LOAD AT 50% VISUAL CONDUIT FILL.


9. REFER TO ELECTRICAL DRAWINGS & SPECIFICATIONS FOR SHARED FLOOR BOXES & LOW VOLTAGE CONDUIT.


10. PROVIDE BRACING TO MEET OSHPD SEISMIC REQUIREMENTS. REFER TO SHEET T4.02 FOR MARE INFORMATION

11. PROVIDE ALL OUTLET CONDUITS FROM WORK AREA OUTLETS., DEVICES OR PULL BOXES TO NEAREST CABLE TRAY.

12. INSTALL CABLE TRAY @ 6" ABOVE CEILING.

KEY PLAN

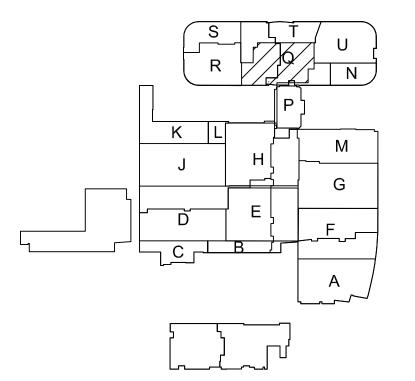

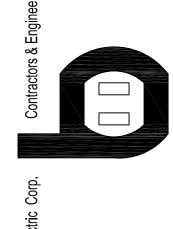

ILDREN'S HOSPITAL

PROPRIETARY STATEMENT

THESE DRAWINGS/DOCUMENTS HEREIN ATTACHED ARE THE PROPERTY OF BERGELECTRIC CORPORATION ANY REUSE OR REPRODUCTION OF THESE DOCUMENTS WITHOUT WRITTEN PERMISSION OF BERGELECTRIC CORPORATION IS STRICTLY FORBIDDEN. ALL RIGHTS RESERVED.

DRAWN BY:
J.RAMIREZ

DESIGN SUPERVISOR:

INSTALL SUPERVISOR:

Scott Adams Tel Data Systems Bergelectric Corporation 650 Opper Street Escondido, CA 92029

REVISION:

05-30-12 RECORD DRAWINGS

SHEET TITLE:

TELECOM FLOOR PLAN LOWER LEVEL AREA-Q

> SCALE: 1/4"=1'0"

> > DRAWING NO. :

T3.0Q RECORD DRAWING

T3 LOWER LEVEL - TELECOM PLAN - AREA-Q