

ARCHITECT OF RECORD

ARCHITECT - PAUL C. GLORIO


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Project No. 2305-163-07



REVISIONS:

APPROVA

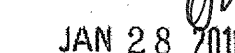

Office of Statewide Health
Planning & Development
FACILITIES DEVELOPMENT DIVISION

PROJECT NAME

455 S. Main St.
Orange, CA 92868-3874

TOWER II



PROJECT NUMBER

OSHPD - PROJECT NUMBER
IL 072072-30

ISSUE

OSHPD PERMIT

DATE _____

01/27/2010

SCALE


$$1'' = 20' - 0''$$

DRAWING TITLE

LEVEL 6 COMPOSITE MECHANICAL PLAN & AIR BALANCE TABLE

DRAWING NUMBER

M1.60

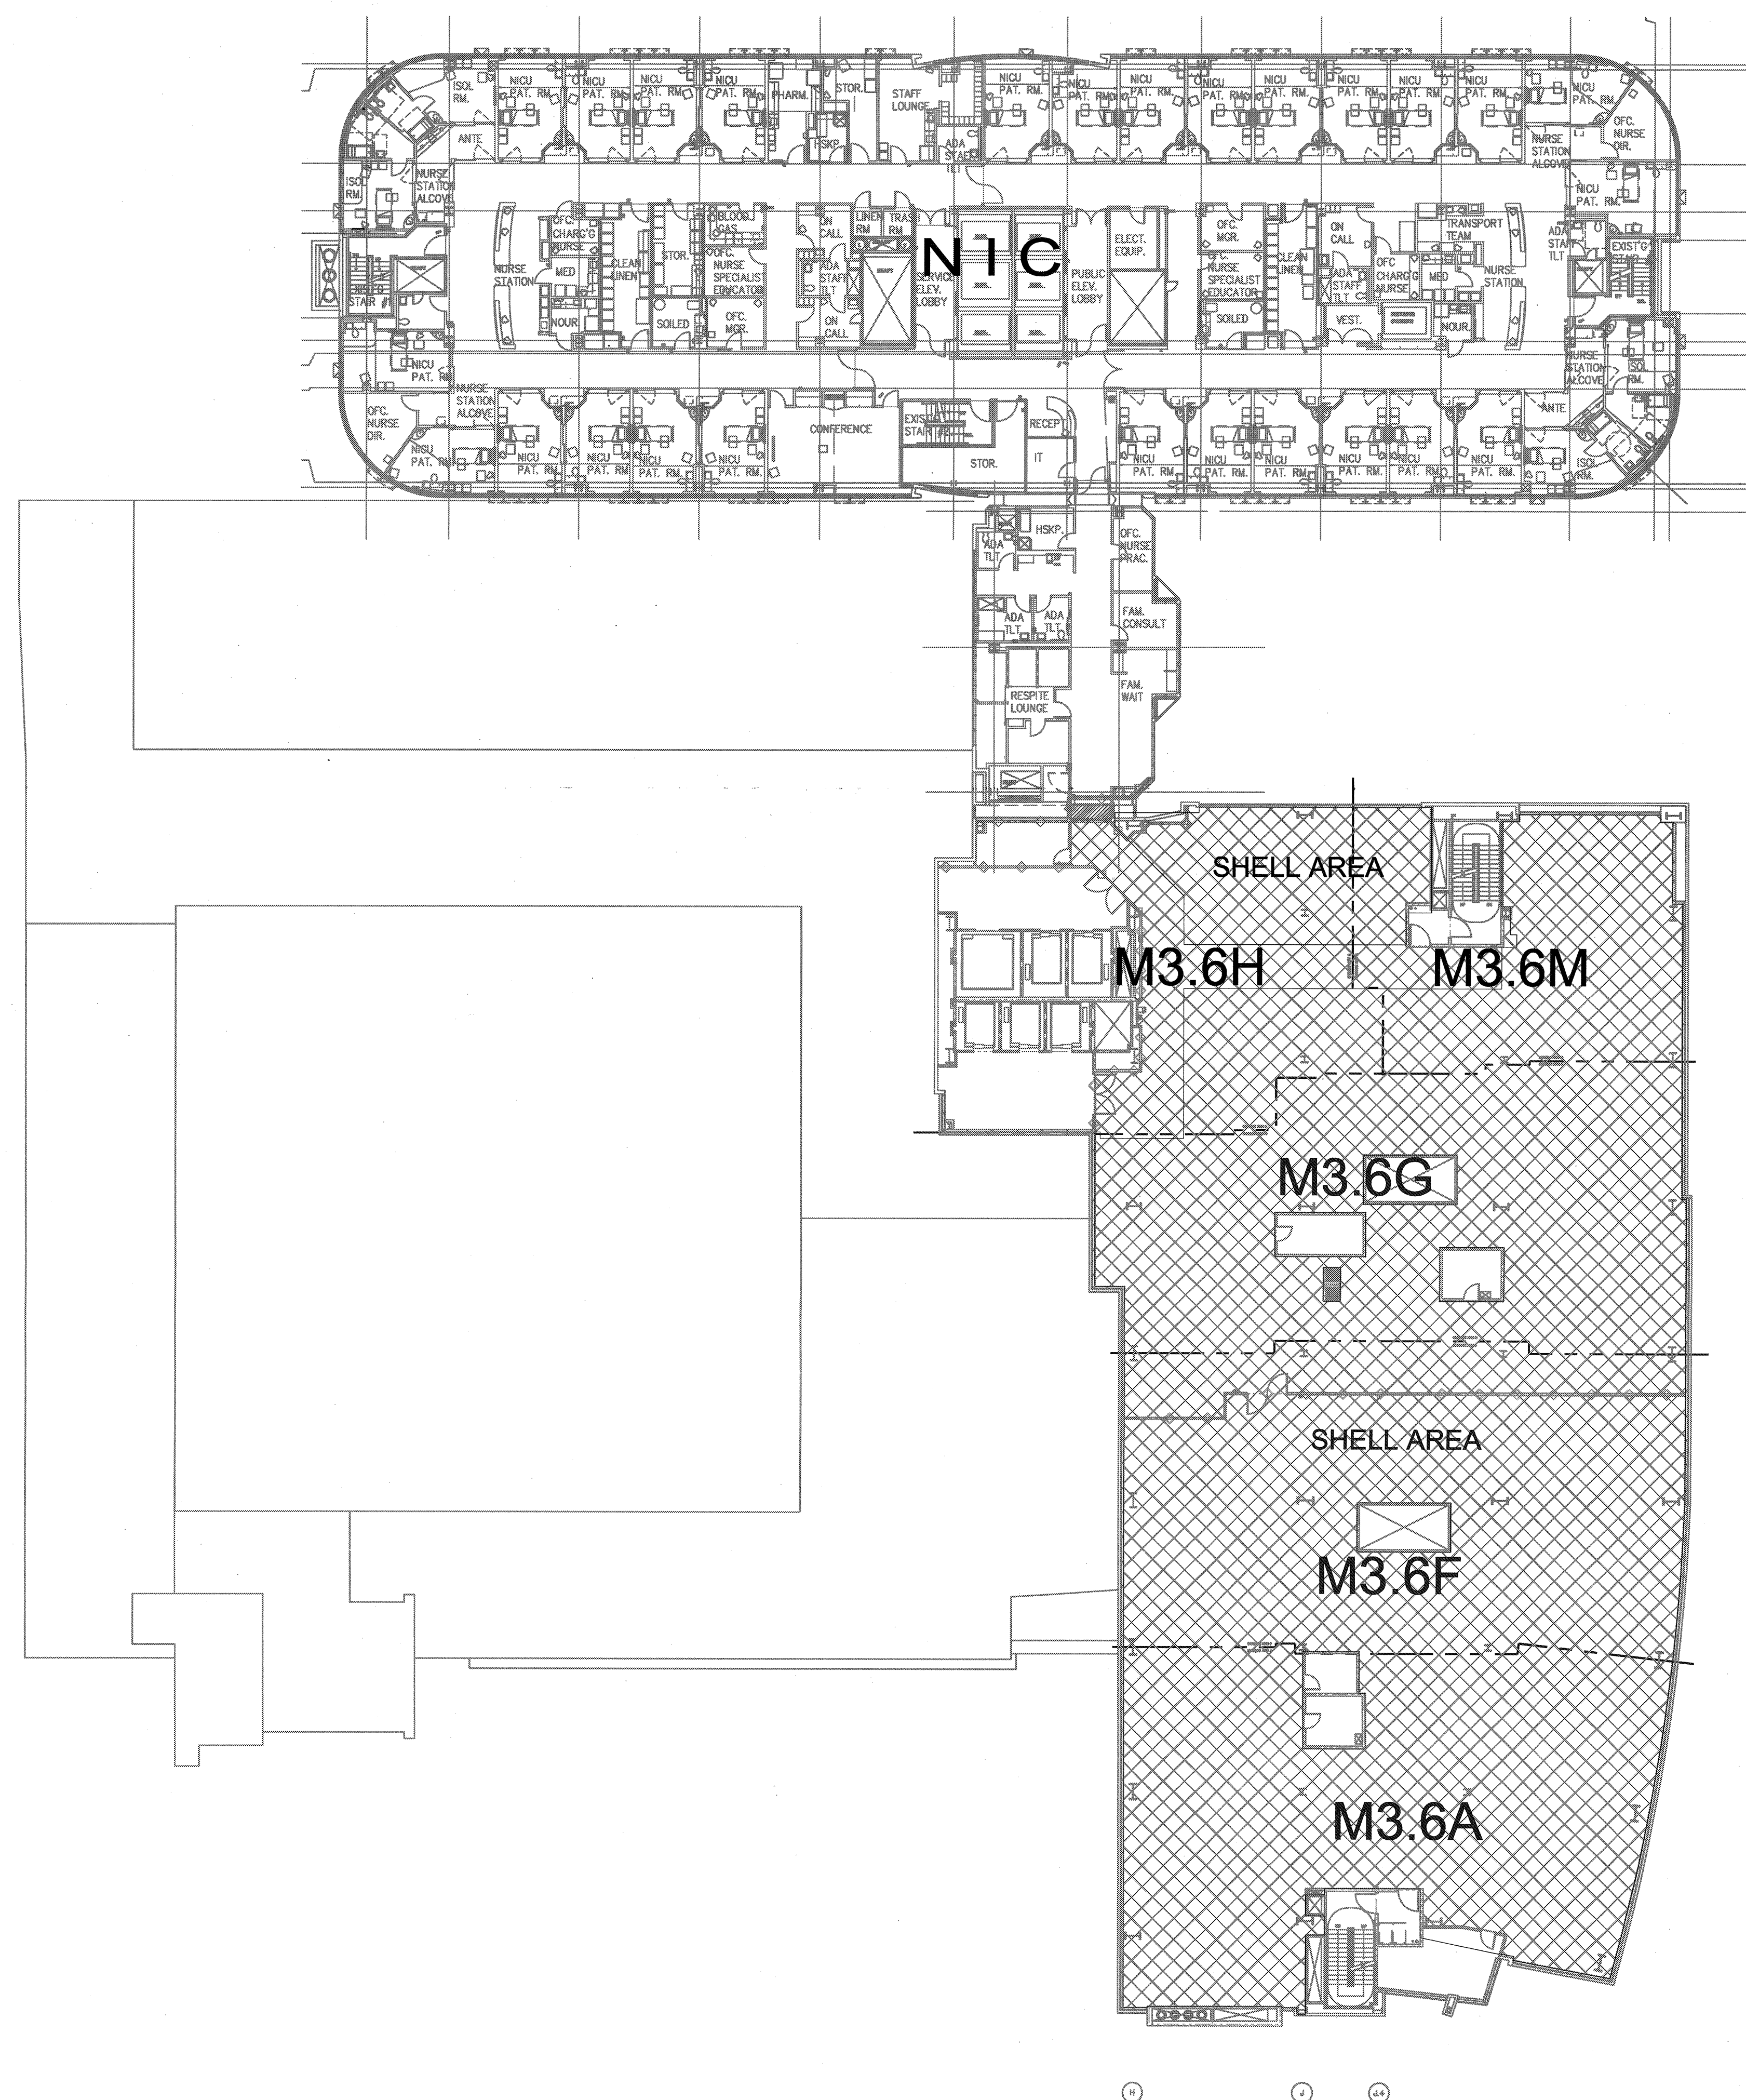

A1 Key Plan

LEVEL 6 COMPOSITE MECHANICAL PLAN

ROOM AIR BALANCE TABLE - TOWER II - SIXTH FLOOR NORTH											
ROOM NUMBER/NAME	ROOM AREA (FT.) ²	CEILING HEIGHT (FT.)	CMC		PRESSURE +/-	OSA AC/HR	SUPPLY CFM	RETURN CFM	EXHAUST CFM	INFILTRATION CFM	EXFILTRATION CFM
			AC/HR.	REQUIRED SUPPLY AC/HR.							
6.000.00L PUBLIC ELEVATOR LOBBY	451	9	4	271	E	4	800	800	0	0	0
6.068.00L PATIENT / STAFF ELEVATOR LOBBY	350	9	4	210	E	3	500	0	500	0	0
6.073.00.C & 6.079.00.C CORRIDOR	1843	9	4	1,106	E	1	1,200	1,200	0	0	0
6.003 SHELL SPACE	134	9	4	80	E	2	200	200	0	0	0
6.139 ELECTRICAL ROOM	138	9	4	83	E	14	1,000	1000	0	0	0
6.103.02 IS ROOM	120	9	4	72	E	21	1,250	1250	0	0	0
SHELL SPACE FOR THE LEVEL 6	11291	9	2	3,387	E	3	4,000	4000	0	0	0

ROOM AIR BALANCE TABLE - TOWER II LEVEL 6

SCALE
NONE