


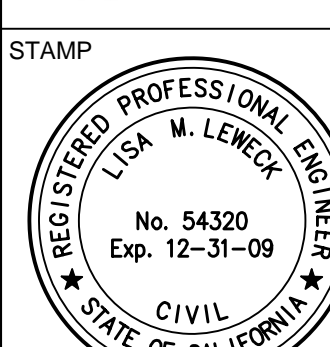

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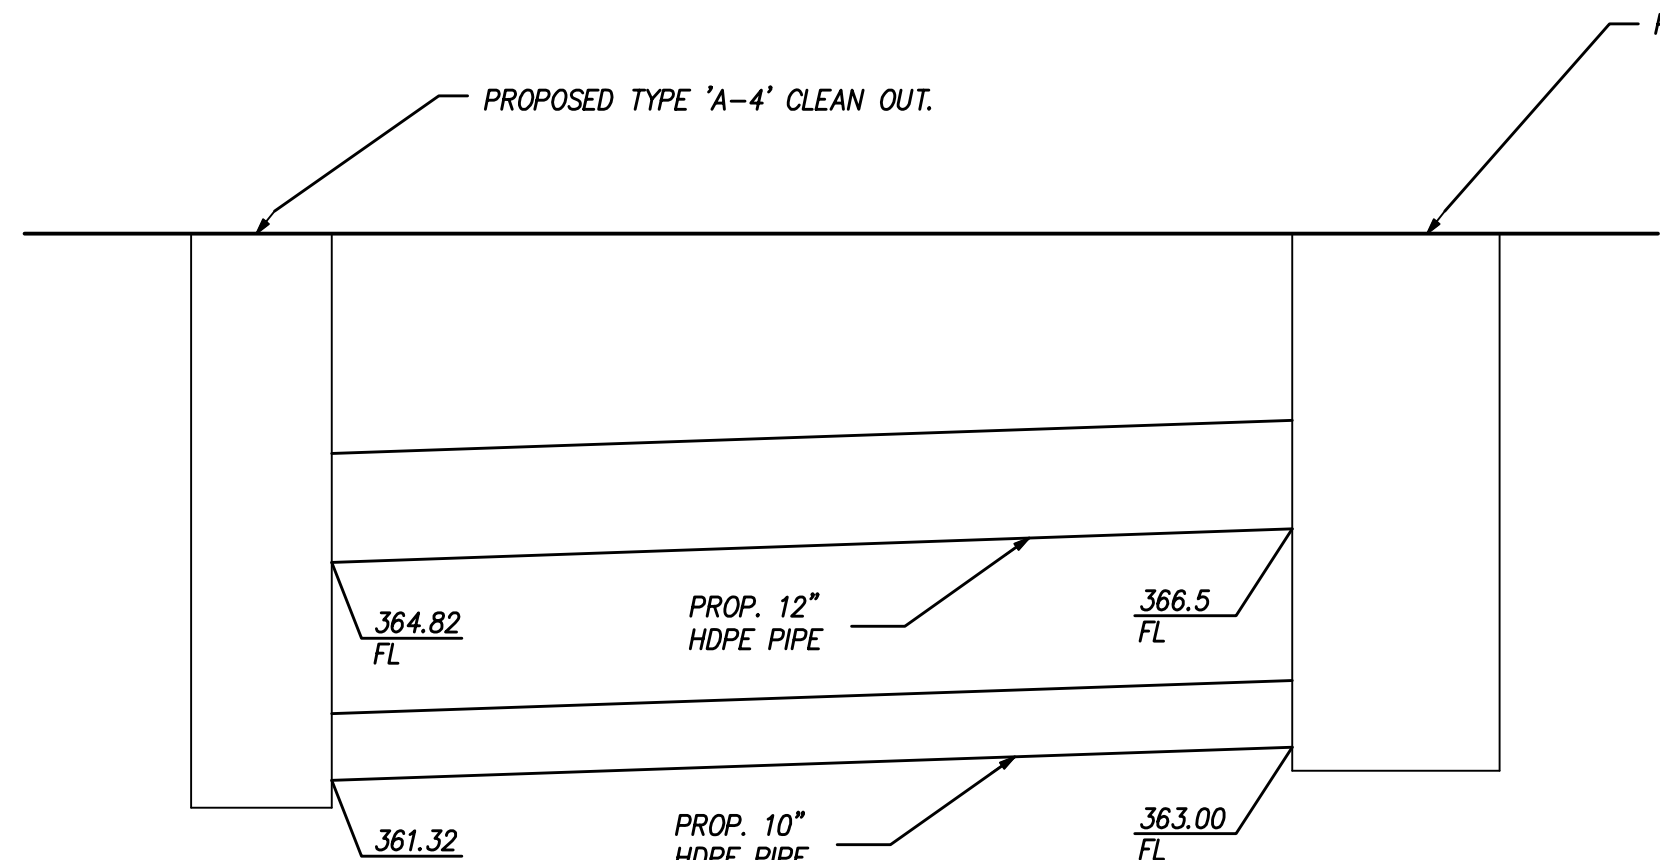


SHEET NAME  
GRADING & STORM DRAIN PLAN  
DRAWN BY:  
PROJECT #:  
SHEET NUMBER




**CONSTRUCTION NOTES:**

- PROPOSED 18" HIGH DENSITY POLYETHYLENE PIPE.
- PROPOSED TYPE "A-4" CLEAN OUT.
- PROPOSED TRENCH DRAIN.
- EXISTING CURB INLET TO REMAIN, BOTTOM OF INLET TO BE REDONE SO F.L. COMING IN WILL FLOW DOWN STREAM.
- PROPOSED 12" HIGH DENSITY POLYETHYLENE PIPE.
- PROPOSED 24"x24" CATCH BASIN WITH 5" WALLS, DWG. NO. 2424, BROOKS PRODUCTS INC. WITH CLEARWATER BMP UNIT PER CLEARWATER SOLUTIONS INC. OR EQUAL.
- PROPOSED 60" RETENTION BASIN.
- PROPOSED 6" STORM DRAIN PIPE FOR FOUNDATION DRAIN PER PLUMBING PLAN.
- PROPOSED BIURETENTION AREA.
- PROPOSED 4" FOUNDATION DRAIN PER BUILDING PLANS.
- PROPOSED TYPE AS C.O. PER D-9 RSDSD.
- PROPOSED 8" STORM DRAIN PIPE FOR ROOF DRAINAGE PER PLUMBING PLAN.
- PROPOSED 8" INLINE DRAIN WITH SOLID GRADE.
- PROPOSED 18" HOPE PIPE FOR INTERCONNECTION.
- PROPOSED 6" WALL DRAIN.
- EXISTING 12" STORM DRAIN PIPE TO BE REMOVED.
- PROPOSED 10" HIGH DENSITY POLYETHYLENE PIPE.
- EXISTING CURB INLET TO REMAIN.
- EXISTING AREA DRAIN TO BE REMOVED.
- PROPOSED CATCH BASIN - TYPE I PER D-29 RSDSD.
- PROPOSED 24" x 24" CATCH BASIN WITH 5" WALLS, DWG. NO. 2424, BROOKS PRODUCTS INC. OR EQUAL.
- WITH CLEARWATER BMP UNIT PER CLEARWATER SOLUTIONS INC. OR EQUAL.
- PROPOSED TYPE AS C.O. PER D-9 RSDSD, WITH CORRUGATED STEEL PIPE INLETS (D-17A) IN LIEU OF MANHOLE FRAME (M-3).
- PROPOSED 4" PVC PERFORATED PIPE.
- EXIST. CLEAN OUT TO REMAIN.




**A OUTLET CONTROL DETAIL ELEVATION**


**NOTE:**  
SEE SHEET C1010 FOR WATER, SEWER, AND RECLAIMED WATER INFORMATION

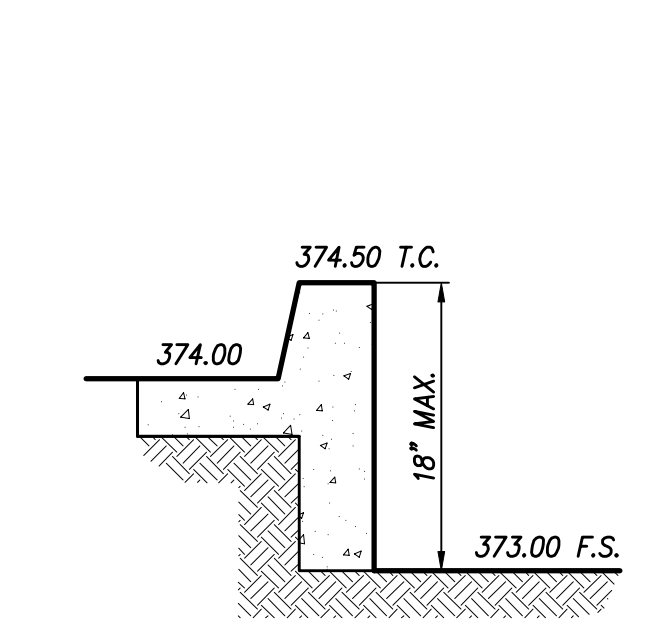

**SECTION B-B**  
NOT TO SCALE

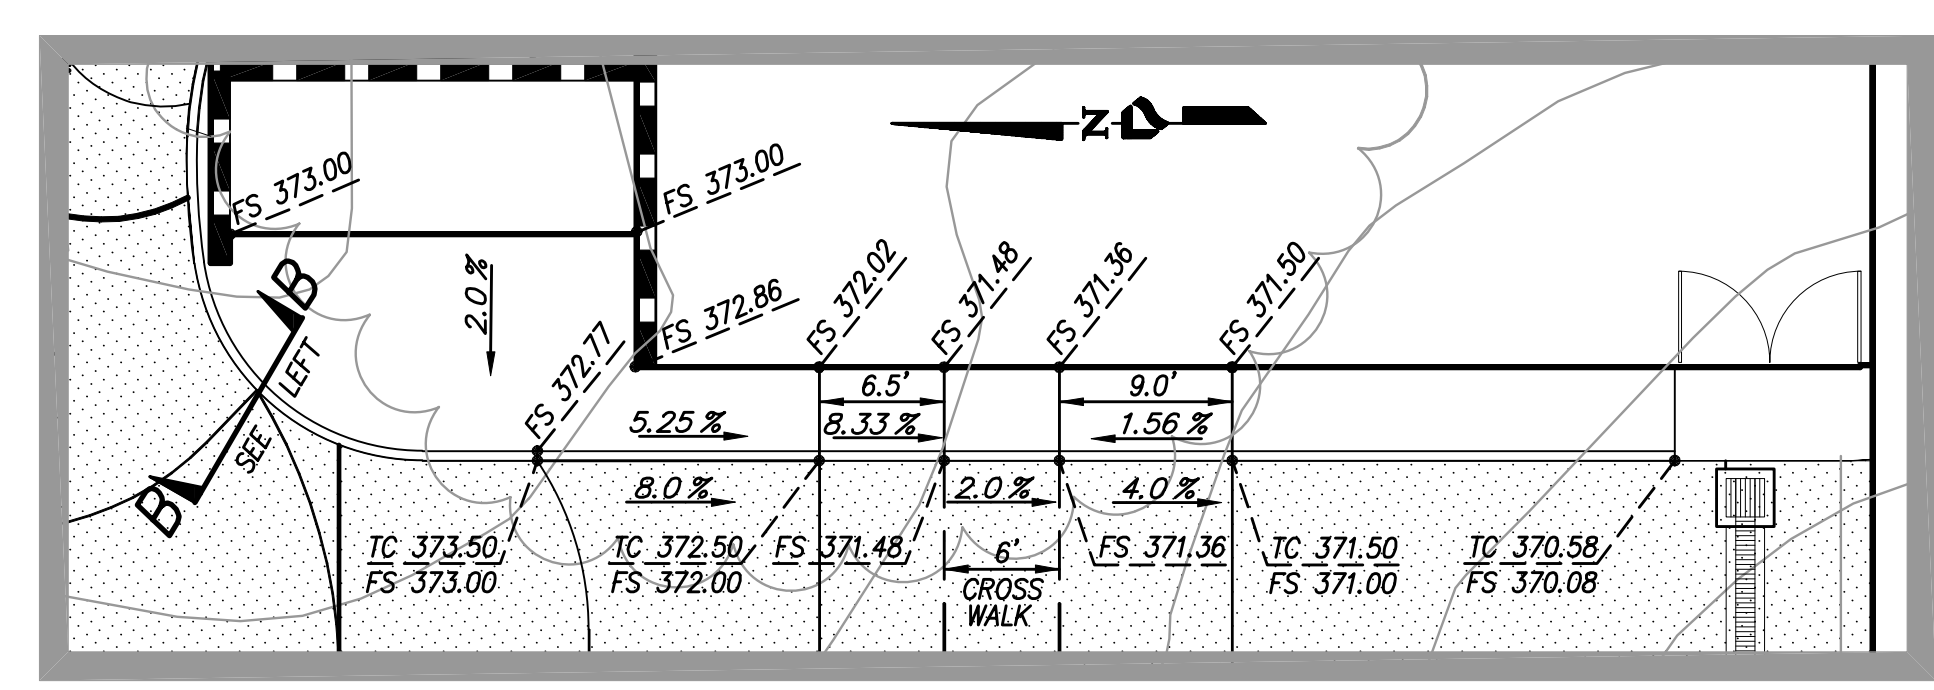

**DETAIL C**  
SCALE: 1"=10'

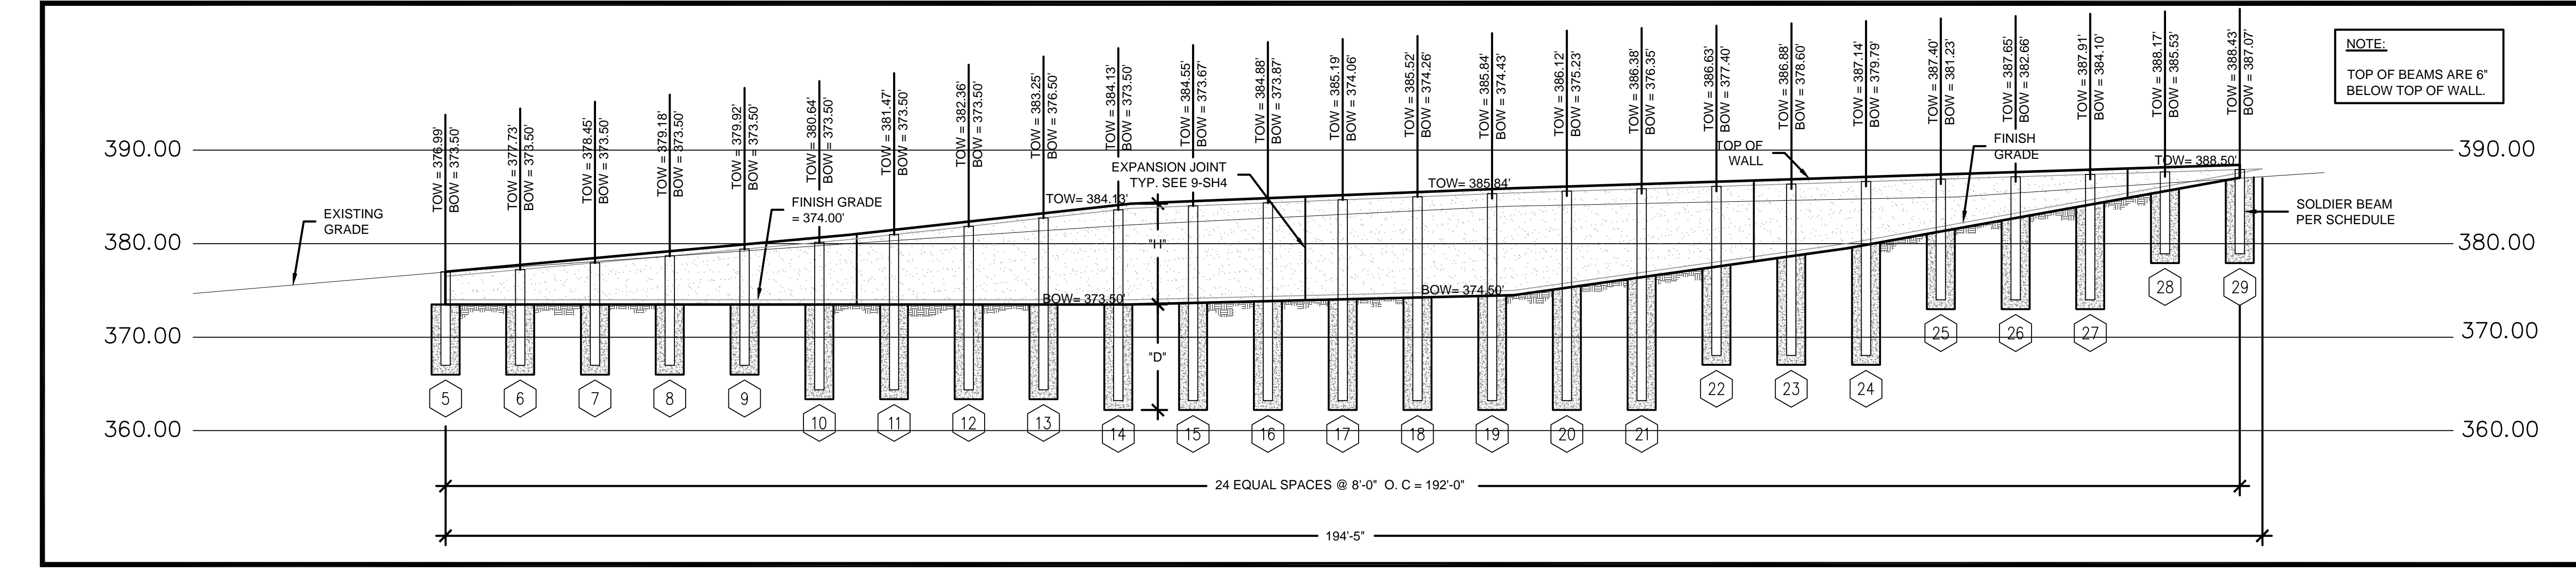

**SHORING ELEVATION PER ANDERSON DRILLING (FOR REFERENCE ONLY NOT A PART OF THIS PLAN OR PERMIT)**

SCALES: 1"=10'