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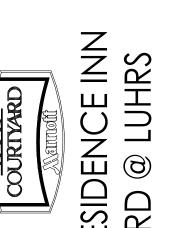
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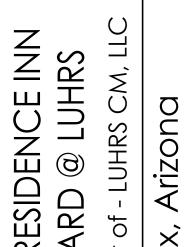


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03/09/15 02/02/15 **INSTRUCTION BULLETIN 1** 02/23/15 **INSTRUCTION BULLETIN 2 INSTRUCTION BULLETIN 3** 



PROJECT NO.: 12-1601

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FINAL FOR CONSTRUCTION - 05/18/15

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**AWBREY** 

COOK

38897 CLIFFORD W. 05/18/15

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CONSULTANTS:

CONSTRUCTION BID SET ADDENDUM A

# WATER CALCULATIONS

HORIZONTAL PIPE LENGTH  TAP TO METER  METER TO LAST FIXTURE  VERTICAL RISE  VALVES AND FITTINGS (20%)		= = =	10 FT. 150 FT. 50 FT. 40 FT.
	TOTAL LENGTH	=	250 FT.
P.S.I. LOSS			
RISE 50 x 0.43 6 " METER ———————————————————————————————————		= = = =	21.5 P.S.I. 3.5 P.S.I. 2.0 P.S.I. 25.0 P.S.I. 12.0 P.S.I.
	TOTAL LOSS	= _	64.0 P.S.I.
TOTAL F.U. 3075.5 = 435 GPM	STREET PRESS  TOTAL LOSS	= =	75.0 P.S.I. 64.0 P.S.I.
	DIFFERENCE	=	11.0 P.S.I.

MAX. P.S.I. DROP

x 100 = 4.4 ALLOWABLE / 100 FT.

# WATER CALCULATIONS

TENTH TO NINETEENTH FLOORS (BP-3)

11 P.S.I. DIFFERENCE

250' TOTAL LENGTH

HORIZONTAL PIPE LENGTH			
FROM BP-3 TO LAST FIXTURE  VERTICAL RISE  VALVES AND FITTINGS (20%)		= = =	150 FT. 205 FT. 70 FT.
	TOTAL LENGTH	=	425 FT.
P.S.I. LOSS			
RISE 205 x 0.43 — FIXTURE — PRESSURE REDUCING VALVE — — —		= =	88.0 P.S.I. 8.0 P.S.I. 5.8 P.S.I.
	TOTAL LOSS	= _	101.8 P.S.I.
TOTAL F.U. 1450 = 265 GPM	PUMP PRESS  — TOTAL LOSS	= =	150.0 P.S.I. 101.8 P.S.I.
	DIFFERENCE	=	48.2 P.S.I.

#### **ACOUSTICAL INSTALLATION NOTES:**

48.2 P.S.I. DIFFERENCE

425' TOTAL LENGTH

1. PIPES, CONDUIT, DUCTWORK, OR ANY OTHER HARDWARE IN COMMON WALLS SHALL BE ATTACHED ONLY TO THE SIDE OF THE WALL THAT IS SERVICED BY SUCH PIPING, AND MAY NOT AT ANY POINT BE ATTACHED TO THE OPPOSITE WALL. ALL SUCH HARDWARE SHALL BE RESILIENTLY MOUNTED. METAL PLUMBERS TAPE ALONE IS NOT SUFFICIENT AS A RESILIENT

x 100 = 11.3 ALLOWABLE / 100 FT.

- 2. ANY PLUMBING, CONDUIT, OR DUCTWORK SHALL BE ATTACHED TO THE FLOOR JOISTS WITH RESILIENT HANGERS AND SHALL NOT BE CONNECTED TO THE CEILING GYPSUM BOARD IN ANY
- 3. WHEN A DRAIN IS RUN IN A WALL THAT IS NOT A COMMON WALL, THE WALL MUST BE INSULATED (I.E., 3-1/2" SOUND INSULATION BLANKET). THE INSULATION MUST BE LOCATED ON BOTH SIDES OF THE PIPE, AND SHALL EXTEND FOR FOUR (4) FEET ON EITHER SIDE OF THE PIPE. DEPENDING ON THE SIZE OF THE WASTE LINE, THIS MAY REQUIRE GOING TO 2" X 6" STUD CONSTRUCTION FOR THESE WALLS (SEE NEXT ITEM).
- 4. CAST IRON WASTE LINES SHALL NEVER COME IN CONTACT WITH THE GYPSUM BOARD. SINGLE STUD WALLS CONTAINING DRAIN LINES 3" O.D. OR GREATER SHALL BE CONSTRUCTED WITH 2" X 6" STUDS.
- 5. THERE SHALL BE NO RIGID CONNECTIONS BETWEEN THE DRAINPIPE AND THE MID-PORTION OF THE WALL. THE ONLY CONNECTIONS SHALL BE AT THE FLOOR PLATE AND CEILING PLATE. AT THE CEILING PLATE, THE HOLE THAT THE DRAINPIPE PASSES THROUGH SHALL BE CLEANED OUT AND EITHER STUFFED WITH INSULATION TO FORM A COLLAR, FILLED WITH CAULK, OR BE WRAPPED WITH A RUBBER COLLAR. SPRAY FOAM IS NOT ACCEPTABLE BECAUSE IT WILL HARDEN
- 6. PLUMBING ISOLATION WITH FELT OR NEOPRENE IS RECOMMENDED FOR ALL PLUMBING IN THE COMMON WALL. THE RESILIENT MATERIAL RECOMMENDED FOR THIS APPLICATION IS NEOPRENE OR FELT WITH A MINIMUM THICKNESS OF 3/8". PRE- FABRICATED ISOLATORS ARE AVAILABLE WITH RESILIENT INSERTS INTEGRATED INTO THE DESIGN. SPECIALTY PRODUCTS MAKES "ACOUSTO-PLUMB" ISOLATORS THAT HAVE RUBBER INSERTS THAT HELP MINIMIZE THE TRANSMISSION OF THE PLUMBING NOISE TO THE STRUCTURE. (MANY MANUFACTURES, INCLUDING SPECIALTY PRODUCTS, ALSO MAKE PLASTIC ISOLATORS AS PART OF OTHER PRODUCT LINES THAT ARE NOT DESIGNED FOR NOISE CONTROL AND ARE NOT ACCEPTABLE FOR THIS USE). PLASTIC ISOLATORS OR "J" NAILS WITHOUT THE NEOPRENE ARE NOT A SUITABLE SUBSTITUTE FOR RESILIENT MOUNTINGS.
- 7. THE STUB-OUTS FOR THE SHOWERS, SINKS AND WATER CLOSET PLUMBING SHALL BE RESILIENTLY MOUNTED WHEN IN THE COMMON WALL. THESE MOUNTS ALLOW FOR A RIGID

PLUMBING CONNECTION THAT IS ACOUSTICALLY RESILIENT.

- 8. ALL WATER SUPPLY AND WASTE LINES SHALL BE ATTACHED TO THE STRUCTURE ONLY WITH ACOUSTO-PLUMB FITTINGS OR WRAPPED WITH 3/8" NEOPRENE OR FELT. THESE PLUMBING LINES SHALL NOT COME IN DIRECT CONTACT WITH THE FRAMING, HVAC DUCTING, OR ANY OTHER PLUMBING LINES.
- 9. THERE SHALL BE NO CONNECTION BETWEEN THE PLUMBING LINES AND THE GYPSUM BOARD IN ANY WALLS. THE HOLES CUT IN THE DRYWALL FOR THE SOURCE LINES SHALL BE JUST LARGE ENOUGH SO THAT THERE IS NO CONTACT BETWEEN THE SOURCE LINES AND THE DRYWALL.
- 10. CAST IRON WASTE LINES SHALL BE USED IN ALL COMMON WALLS AND COMMON FLOOR-CEILING ASSEMBLIES. THIS CAST IRON REQUIREMENT EXTENDS FROM THE POINT OF PENETRATION OF A COMMON WALL OR FLOOR TO THE STUB OUT IN THE SLAB. SHORT LATERAL RUNS INTO THE UNIT, NOT IN THE COMMON WALL, MAY BE PLASTIC PROVIDED SUCH RUNS ARE 24 INCHES OR LESS. ALL LATERAL RUNS SHOULD BE WRAPPED WITH INSULATION.
- 11. ALL WATER CLOSETS ARE TO BE 1.6-GALLON WATER SAVER TOILETS. THE DRAINPIPE SHALL BE RESILIENTLY MOUNTED OR HUNG WITH NO RIGID CONNECTIONS.
- 12. ALL PLUMBING, CONDUIT, DUCT WORK, GAS LINES OR ANY OTHER PENETRATIONS OF COMMON WALLS IN PLENUM SPACES SHALL BE SEALED WITH INSULATION STUFFING AND CAULK.

#### **COMMISSIONING REQUIREMENTS**

DOMESTIC HOT WATER SYSTEM REPRESENTATIVES FROM LSW ENGINEERS WILL ADMINISTER A COMMISSIONING AND VERIFICATION ON THE OPERATIONS OF THE BOILER PLANT SYSTEM. A REPRESENTATIVE FROM THE PLUMBING CONTRACTOR AND THE SYSTEM MANUFACTURER SHALL BE ON SITE FOR TWO (2) CONSECUTIVE DAYS TO ASSIST IN THIS EFFORT. THE GENERAL CONTRACTOR IS RESPONSIBLE TO PRE-CERTIFY THE DOMESTIC HOT WATER SYSTEM FUNCTIONS PER THE DRAWINGS AND SPECIFICATION PRIOR TO THE FORMAL COMMISSIONING BY LSW ENGINEERS.

SEWAGE EJECTOR SYSTEM

REPRESENTATIVES FROM LSW ENGINEERS WILL ADMINISTER A COMMISSIONING AND VERIFICATION ON THE OPERATIONS OF THE SEWAGE EJECTOR SYSTEM. A REPRESENTATIVE FROM THE PLUMBING CONTRACTOR AND THE SYSTEM MANUFACTURER SHALL BE ON SITE FOR ONE (1) DAY TO ASSIST IN THIS EFFORT. THE GENERAL CONTRACTOR IS RESPONSIBLE TO PRE-CERTIFY THE DOMESTIC HOT WATER SYSTEM FUNCTIONS PER THE DRAWINGS AND SPECIFICATION PRIOR TO THE FORMAL COMMISSIONING BY LSW ENGINEERS.

## WATER CALCULATIONS

FIFTH TO NINTH FLOORS (BF	P-2)			
ORIZONTAL PIPE LENGTH				
LIVITOAL IVIOL			= = = =	150 FT. 105 FT. 50 FT.
		TOTAL LENGTH	=	305 FT.
.S.I. LOSS				
ISE 105 x 0.43 ————————————————————————————————————			= =	45.0 P.S. 8.0 P.S. 5.8 P.S.
		TOTAL LOSS	= _	58.8 P.S.
OTAL F.U. 750 = 170 GPM	-	PUMP PRESS - TOTAL LOSS	= =	100.0 P.S. 58.8 P.S.
		DIFFERENCE	=	41.2 P.S.
41.2 P.S.I. DIFFERENCE	x 100 = 13.5	MAX. P.S.I. DROP ALLOWABLE / 100 FT.		

OF PIPE

#### WATER CALCULATIONS TWENTIETH FLOOR (BP-1)

305' TOTAL LENGTH

HORIZONTAL PIPE LENGTH			
FROM BP-1 TO LAST FIXTURE VERTICAL RISE VALVES AND FITTINGS (20%)		= = =	150 FT. 220 FT. 75 FT.
	TOTAL LENGTH	=	445 FT.
P.S.I. LOSS			
RISE 220 x 0.43 ————————————————————————————————————		==	94.6 P.S.I. 25.0 P.S.I. 5.8 P.S.I.
	TOTAL LOSS	= _	125.4 P.S.I.
TOTAL F.U. 2000 = 325 GPM COOLING TOWERS = 50 GPM	PUMP PRESS  — TOTAL LOSS	= =	180.0 P.S.I. 125.4 P.S.I.
TOTAL = 375 GPM	DIFFERENCE	=	54.6 P.S.I.
54.6 P.S.I. DIFFERENCE 445' TOTAL LENGTH	x 100 = 12.3 MAX. P.S.I. DROP ALLOWABLE / 100 FT. OF PIPE		

#### GENERAL PLUMBING NOTES:

- 1. A BOOK SPECIFICATION HAS BEEN PREPARED FOR THIS PROJECT. REFER TO THE BOOK
- SPECIFICATIONS FOR ADDITIONAL PROJECT REQUIREMENTS. 2. ALL MATERIALS THAT WILL BE IN CONTACT WITH THE POTABLE WATER SUPPLY SHALL BE TESTED
- AND MARKED AS "LEAD FREE". 3. ALL PLUMBING FIXTURES SHALL COMPLY WITH THE WATER CONSERVATION ACT.
- 4. SANITARY WASTE AND VENT PIPING SHALL BE NO HUB CAST IRON, CONFORMING TO ASTM A-888-04A. ALL HORIZONTAL WASTE PIPING TO BE SLOPED AT 1/4" MINIMUM UNLESS NOTED OTHERWISE.
- 5. ROOF DRAINAGE PIPING SHALL BE NO HUB CAST IRON, CONFORMING TO ASTM A-888 OR HUB AND SPIGOT, CAST IRON PIPE, CONFORMING TO ASTM A-74. SLOPE ALL HORIZONTAL PIPING AT A MINIMUM OF 1/4" PER FOOT UNLESS NOTED OTHERWISE.
- 6. PROVIDE HEAVY-DUTY, FOUR BAND, HUBLESS PIPING COUPLINGS, CONFORMING TO ASTM C1277 OR ASTM C1540, ON ALL WASTE AND ROOF DRAINAGE PIPING. PROVIDE STANDARD DUTY, HUBLESS PIPING COUPLINGS, CONFORMING TO ASTM C1277 OR ASTM C1540, ON ALL VENT PIPING.
- 7. DOMESTIC WATER PIPING SHALL BE TYPE "L" HARD DRAWN COPPER, CONFORMING TO ASTM B88, OR TYPE "K" HARD DRAWN COPPER, CONFORMING TO ASTM B88, OR TYPE "K" SOFT COPPER CONFORMING TO ASTM B88. FITTINGS SHALL BE SOLDER JOINT FITTINGS COMPLYING WITH ASME B16.18 FOR TYPR "L" OR ASME B16.22 FOR TYPE "K" AND SOLDERED WITH SOLDER COMPLYING WITH
- 8. HOT WATER AND HOT WATER RETURN PIPING INSULATION SHALL BE A MINIMUM OF 1" THICK AND HAVING A CONDUCTIVITY NOT EXCEEDING 0.27 BTU/HR SQ.FT. AT 120 DEGREES PER 2012 IECC
- 9. VALVES USED IN DOMESTIC WATER PIPING SHALL BE MSS SP-110, 150 PSIG SWP AND/OR 600 PSIG CWP RATED, FULL PORT, BRONZE BALL VALVES WITH CHROME PLATED BRASS BALL, TEFLON SEAT WITH SOLDERED OR THREADED ENDS.
- 10. PROVIDE MECHANICAL SHOCK ABSORBER AT ALL GROUP OF FIXTURES USING FLUSH VALVES, OR AT SINGLE FIXTURES USING A FLUSH VALVE AND AT ANY FIXTURE USING A QUICK CLOSING VALVE
- 11. INSTALL ALL CLEANOUTS PER CURRENT ADOPTED CODES. COORDINATE EXACT LOCATIONS WITH ARCHITECTURAL PLANS TO MINIMIZE CLEANOUTS IN PUBLIC OR DECORATIVE AREAS.

12. FUEL GAS PIPING SHALL BE SCHEDULE 40 BLACK STEEL PIPE CONFORMING TO ASTM A53 ABOVE

- GRADE WITH MALLEABLE THREADED FITTINGS .
- 13. VALVES USED IN FUEL GAS PIPING SHALL BE MSS SP-110, 150 PSIG SWP AND/OR 600 PSIG CWP RATED, FULL PORT, BRONZE BALL VALVES WITH CHROME PLATED BRASS BALL, TEFLON SEAT WITH SOLDERED OR THREADED ENDS.
- 14. PROVIDE ACCESS PANELS FOR ALL ITEMS NEEDING MAINTENANCE, ADJUSTMENT OR REPLACEMENT ABOVE NON-ACCESSIBLE (HARD) CEILINGS OR WALLS. COORDINATE EXACT LOCATION AND TYPE OF ACCESS PANELS WITH THE GENERAL CONTRACTOR.

DOMESTIC WATER PIPE SIZING CHART							
	BASED ON 5 PSI DROP / 100 FT OF PIPE MAX						
PIPE SIZE	MAX FU FLUSH VALVE	MAX FU FLUSH TANK					
3/4"	-	7					
1"	-	18					
1-1/4"	7	38					
1-1/2"	25	79					
2"	133	250					
2-1/2"	550	625					
3"	1100	1100					
4"	2475	2475					

	FIXTURE CONNECTION SCHEDULE						
MARK	DESCRIPTION	W	V	CW	HW	REMARKS	
WC	WATER CLOSET	4"	2"	1"	-	FLUSH VALVE, WALL MOUNT	
WC	WATER CLOSET	3"	2"	1/2"	-	FLUSH TANK, FLOOR MOUNT	
UR	URINAL	2"	1-1/2"	3/4"	-	WALL MOUNT	
LAV	LAVATORY	2"	1-1/2"	1/2"	1/2"		
KS	KITCHEN SINK	2"	1-1/2"	1/2"	1/2"		
LS	LAUNDRY SINK	2"	1-1/2"	1/2"	1/2"		
MS	MOP SINK	3"	1-1/2"	3/4"	3/4"		
ВТ	BATH TUB/SHOWER	2"	1-1/2"	3/4"	3/4"		
НВ	HOSE BIBB	-	-	3/4"	-	WITH VACUUM BREAKER	
FD	FLOOR DRAIN	2" UNO	1-1/2" UNO	-	-		
FS	FLOOR SINK	2" UNO	1-1/2" UNO	-	-		
WB	WASHER BOX	2"	1-1/2"	3/4"	3/4"		
IMB	ICE MAKER BOX	-	-	1/2"	-		
EEW	EMERGENCY EYE WASH	-	-	1/2"	1/2"	PROVIDED WITH MIXING VALVE SET TO DELIVER 95 DEGREE F. WATER.	

	FIXTURE		T (LOOL)	2006 UPC A	PPENDIX A	
MARK	DESCRIPTION	QTY	FU F	EACH		AL FU
		٦	WASTE	WATER	WASTE	WATER
WC	WATER CLOSET (FLUSH VALVE, 1.6 GPF) (PUBLIC)	39	4	5	156	195
WC	WATER CLOSET (FLUSH TANK, 1.6 GPF) (PRIVATE)	320	3	2.5	960	800
UR	URINAL (1.0 GPF)	7	2	4	14	28
LAV	LAVATORY	344	1	1	344	344
HS	HAND SINK	5	2	2	10	10
KS	KITCHEN SINK (RESID.)	200	2	1.5	400	300
BS	BREAKROOM SINK	1	2	2	2	2
LS	LAUNDRY SINK	1	2	2	2	2
SK	3-COMPARTMENT SINK	1	6	8	6	8
MS	MOP SINK	4	3	3	12	12
ВТ	BATH TUB/SHOWER	320	2	4	640	1280
НВ	1ST HOSE BIBB	1	-	2.5	-	2.5
НВ	ADDITIONAL HOSE BIBB	14	-	1	-	14
FD	2" FLOOR DRAIN	11	2	-	22	-
FD	3" FLOOR DRAIN	4	6	-	24	-
FS	2" FLOOR SINK	15	4	-	60	-
FS	3" FLOOR SINK	13	6	-	78	-
FS	4" FLOOR SINK	9	8	-	72	-
ACW	AUTOMATIC CLOTHES WASHER	7	3	4	21	28
SH	POOL AREA SHOWER	1	2	4	2	4
LT	4" LINT TROUGH	3	8	-	24	-
<u>-</u>	KITCHEN FIXTURES	23	-	2	-	46
		I	1	TOTALS	2849	3075.5
OTES:					EQUIVALENT GPM	435

I. WATER FIXTURE UNITS = 3,075.5 = 435 GPM. USE 6" BUILDING SUPPLY WITH 6" COMPOUND METER. 2. DRAIN FIXTURE UNITS =2,849. USE 10" BUILDING SEWER MAIN.

#### GREASE INTERCEPTOR SIZING

1.	CONNECTED FIXTURES

- MS-1 MOP SINK 2-087 PREP TABLE
- 2-102 3-COMPARTMENT POT SINK 2-115 COMBI-OVEN STEAMER
- 2-116 TILT-SKILLET
- 2-120 CONV. STEAMER/KETTLE 2-122 CHEF'S COUNTER 2-128 2-WELL HOT FOOD COUNTER
- 2-143 WARE WASHER 2-146 DISHTABLE
- <u>2-147 DISPOSER</u> 11 FIXTURES x 3 DFU = 33 DFU
- 2. 33 FU'S x 3 GPM / FU x 12 MINUTE RETENTION TIME = 1,188 GALLONS MINIMUM STORAGE CAPACITY
- USE "JENSEN PRECAST" MODEL NO. CL1500ECE-G, 1500 GALLON STORAGE 3-COMPARTMENT INDUSTRIAL WASTE INTERCEPTOR" WITH CONCRETE EXTENSION RINGS AND AIRTIGHT TRAFFIC COVERS. INSTALL IN ACCORDANCE WITH COP STANDARDS AND GREASE WASTE INTERCEPTOR REQUIREMENTS.

SYMBOL ABBR DESCRIPTION						
		WAGTE DIDING				
	W	WASTE PIPING				
- GW	GW	KITCHEN GREASE WASTE PIPING				
	V	VENT PIPING				
·	CW SCW	COLD WATER PIPING SOFT COLD WATER PIPING				
	HW	SOFT HOT WATER PIPING				
165°	HW (165°F)	HOT WATER AT 165°F PIPING (ALL OTHER HW PIPING AT 124°F)				
	HW	SOFT HOT WATER PIPING				
165°	HW (165°F)	HOT WATER RETURN AT 165°F PIPING				
		(ALL OTHER HWR PIPING AT 124°F)				
SYSTEM TYPE		ABOVE GRADE PIPING:				
#" * <b>1</b>	CD	CONDENSATE DRAIN PIPING				
	D FL G	EQUIPMENT DRAIN PIPING FIRE LINE PIPING NATURAL GAS PIPING				
PIPE SIZE	ODL RDL	OVERFLOW DRAIN LEADER PIPING  ROOF DRAIN LEADER PIPING				
₩	GV	GATE VALVE				
		BALL VALVE				
N	СНК	CHECK VALVE				
		BUTTERFLY VALVE				
		UNION				
		LUBRICATED PLUG VALVE				
<b>c</b> ———	DN	RISER DOWN				
o	UP	RISER UP				
	RPBFP	REDUCED PRESSURE PRINCIPLE BACKFLOW PREVENTER				
	PRV	PRESSURE REDUCING VALVE				
<u>∞</u>		BALANCING VALVE				
Ø	FCO SCO	FLOOR CLEAN OUT SURFACE CLEAN OUT				
H	wco	WALL CLEAN OUT				
<b>–</b>	СО	CLEAN OUT				
© / o	RD/OD	ROOF DRAIN / OVERFLOW DRAIN				
ال ا	VTR	VENT THROUGH ROOF				
—	НВ	HOSE BIBB				
	FS	FLOOR SINK				
Φ	FD	FLOOR DRAIN				
þ	WHA	WATER HAMMER ARRESTOR				
<b>→</b>	FDC	FIRE DEPARTMENT CONNECTION				
•		FIRE SPRINKLER RISER				
<b>—</b> ⊅		BELL				
•	POC	POINT OF CONNECTION				
0-000		THIS SYMBOL DENOTES FOOD SERVICE AND LAUNDRY EQUIPMENT PLUMBING ITEMS BY OTHERS. REFER TO SHEETS FS&L-2 AND FS&L-3				

	ABBREVIATIONS					
#	NUMBER	IN HG	INCHES MERCURY			
#/P###	DETAIL # ON SHEET P###	I W	INDIRECT WASTE			
°F	DEGREES FAHRENHEIT	KW	KILOWATT			
A	AMPS	LAT	LEAVING AIR TEMPERATURE			
ACFM	ACTUAL CFM	LBS	POUNDS			
ADA	AMERICANS WITH DISABILITIES ACT	LF	LINEAR FOOT			
AFF	ABOVE FINISHED FLOOR	MAX	MAXIMUM			
AFG	ABOVE FINISHED GRADE	MBH	THOUSAND BTU PER HOUR			
AMB	AMBIENT	MCA	MINIMUM CIRCUIT AMPS			
AP	ACCESS PANEL	MIN	MINIMUM			
AV	AUTOMATIC AIR VENT	MOCP	MAXIMUM OVER CURRENT PROTECTION			
BFF	BELOW FINISHED FLOOR	NC	NORMALLY CLOSED			
BFG	BELOW FINISHED GRADE	NIC	NOT IN CONTRACT			
BTUH	BRITISH THERMAL UNITS PER HOUR	NO	NORMALLY OPEN			
CAP	CAPACITY	NTS	NOT TO SCALE			
CFH	CUBIC FEET PER HOUR	OPER	OPERATING			
CFM	CUBIC FEET PER MINUTE	P&T	PRESSURE AND TEMPERATURE			
CLG	COOLING	PD	PRESSURE DROP			
CMPR	COMPRESSOR	PH	PHASE			
CONC	CONCRETE	PLUM	PLUMBING			
CONT	CONTINUOUS OR CONTINUATION	PRESS	PRESSURE			
CU FT	CUBIC FEET	PSI	POUNDS PER SQUARE INCH			
CW	COLD WATER	PSIA	POUNDS PER SQUARE INCH ABSOLUTE			
DB	DECIBELS	PSIG	POUNDS PER SQUARE INCH GAGE			
DB	DRY BULB TEMPERATURE	QTY	QUANTITY			
DIA OR Ø	DIAMETER	REQ'D	REQUIRED			
DN	DOWN	RFF	REFERENCED FINISHED FLOOR			
DWG	DRAWING(S)	RPM	REVOLUTIONS PER MINUTE			
EAT	ENTERING AIR TEMPERATURE	SCFM	CFM AT STANDARD CONDITIONS			
EFF	EFFICIENCY	SF	SQUARE FEET OR SQUARE FOOT			
ELEV	ELEVATION	SOV	SHUT-OFF VALVE			
EXT	EXTERNAL	SQ	SQUARE			
FD	FLOOR DRAIN	SYS	SYSTEM			
FF	FINISHED FLOOR	TEMP	TEMPERATURE			
FLA	FULL LOAD AMPS	TP	TRAP PRIMER			
FOB	FLOOR OUTLET BOX	TOT	TOTAL			
FS	FLOOR SINK	TW	TEMPERED WATER			
FSR	FIRE SPRINKLER RISER	TYP	TYPICAL			
FT	FEET OR FOOT	UNO	UNLESS NOTEI OTHERWISE			
FU	FIXTURE UNITS	V	VENT OR VOLT S)			
GA	GAGE	VERT	VERTICAL			
GAL	GALLON(S)	VOL	VOLUME			
GPH	GALLONS PER HOUR	W	WASTE			
GPM	GALLONS PER MINUTE	W	WATTS			
GRS	GRAINS	W/	WITH			
HORZ	HORIZONTAL	W/O	WITHOUT			
HP	HORSE POWER	WC	WATER COLUNN			
Н	HEIGHT	WOB	WALL OUTLET BOX			
HW	HOT WATER	WT	WEIGHT			

INVERT ELEVATION



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CONSULTANTS:



CONSTRUCTION BID SET 03/09/201 ADDENDUM A 02/02/20 NSTRUCTION BULLETIN 1 02/23/201


2 INSTRUCTION BULLETIN 2 05/11/201


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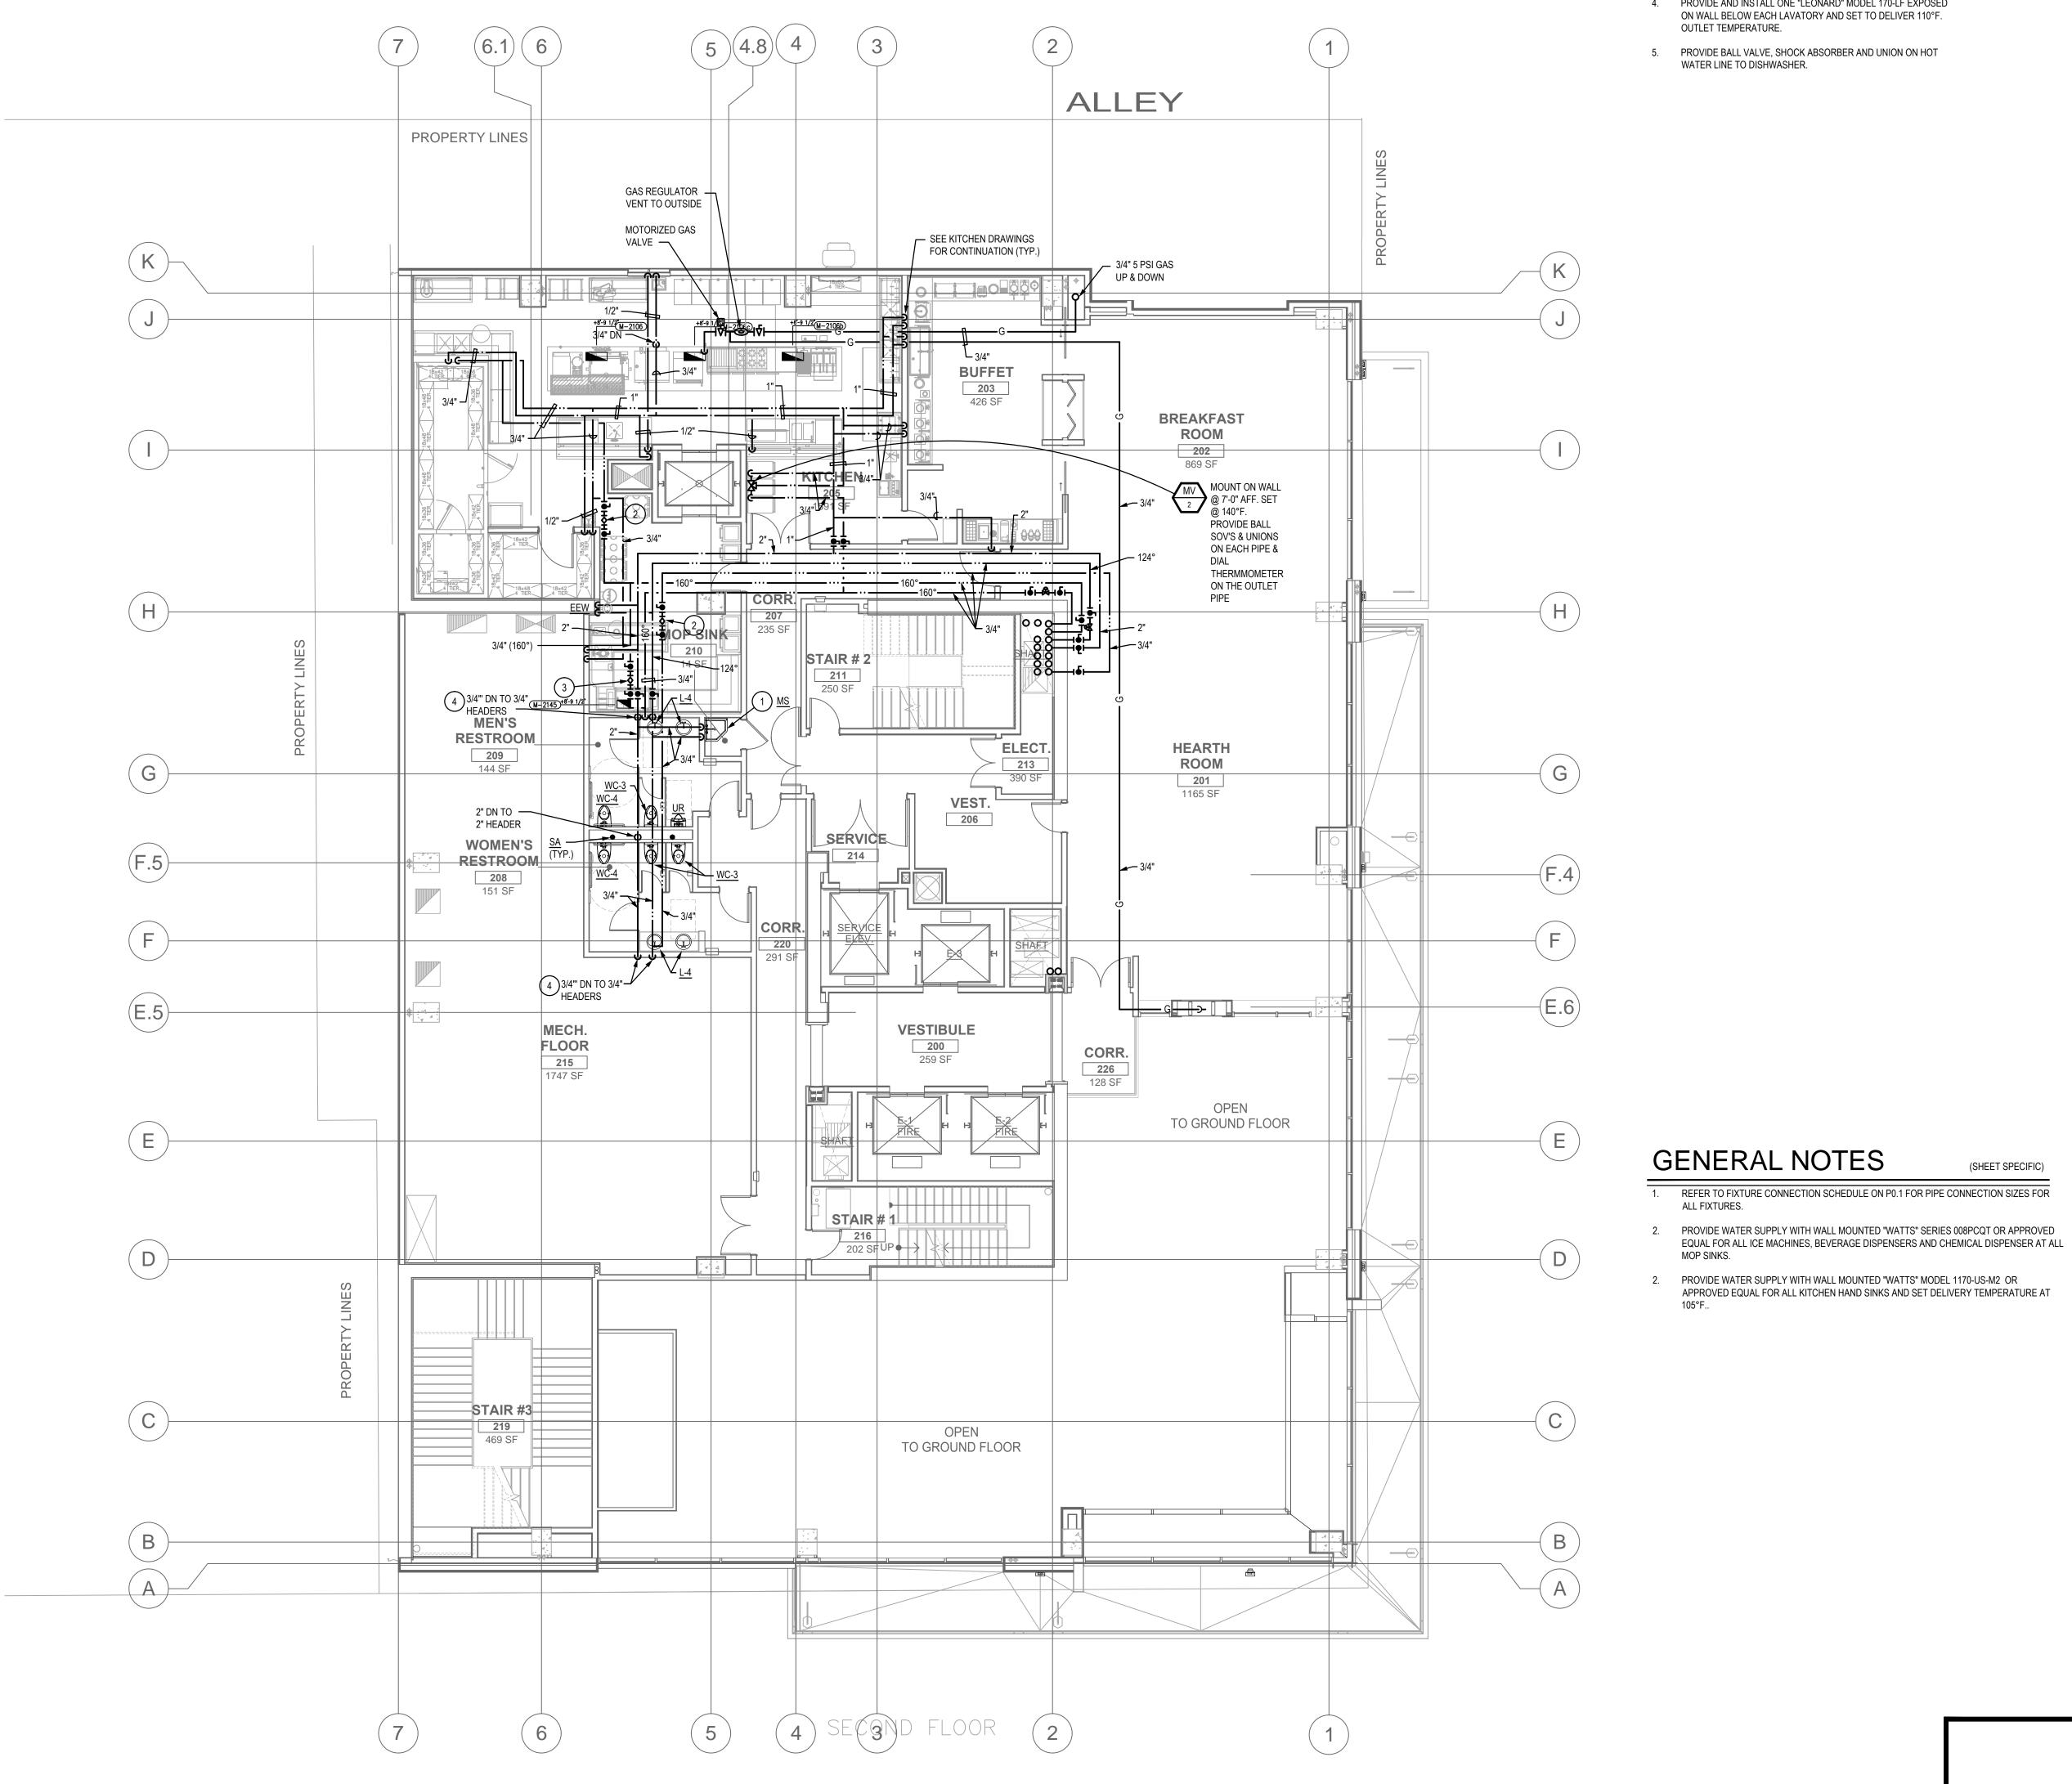
PROJECT NO.: **12-1601** PLUMBING LEGEND,

**SCHEDULES AND** 

**CALCULATIONS** 



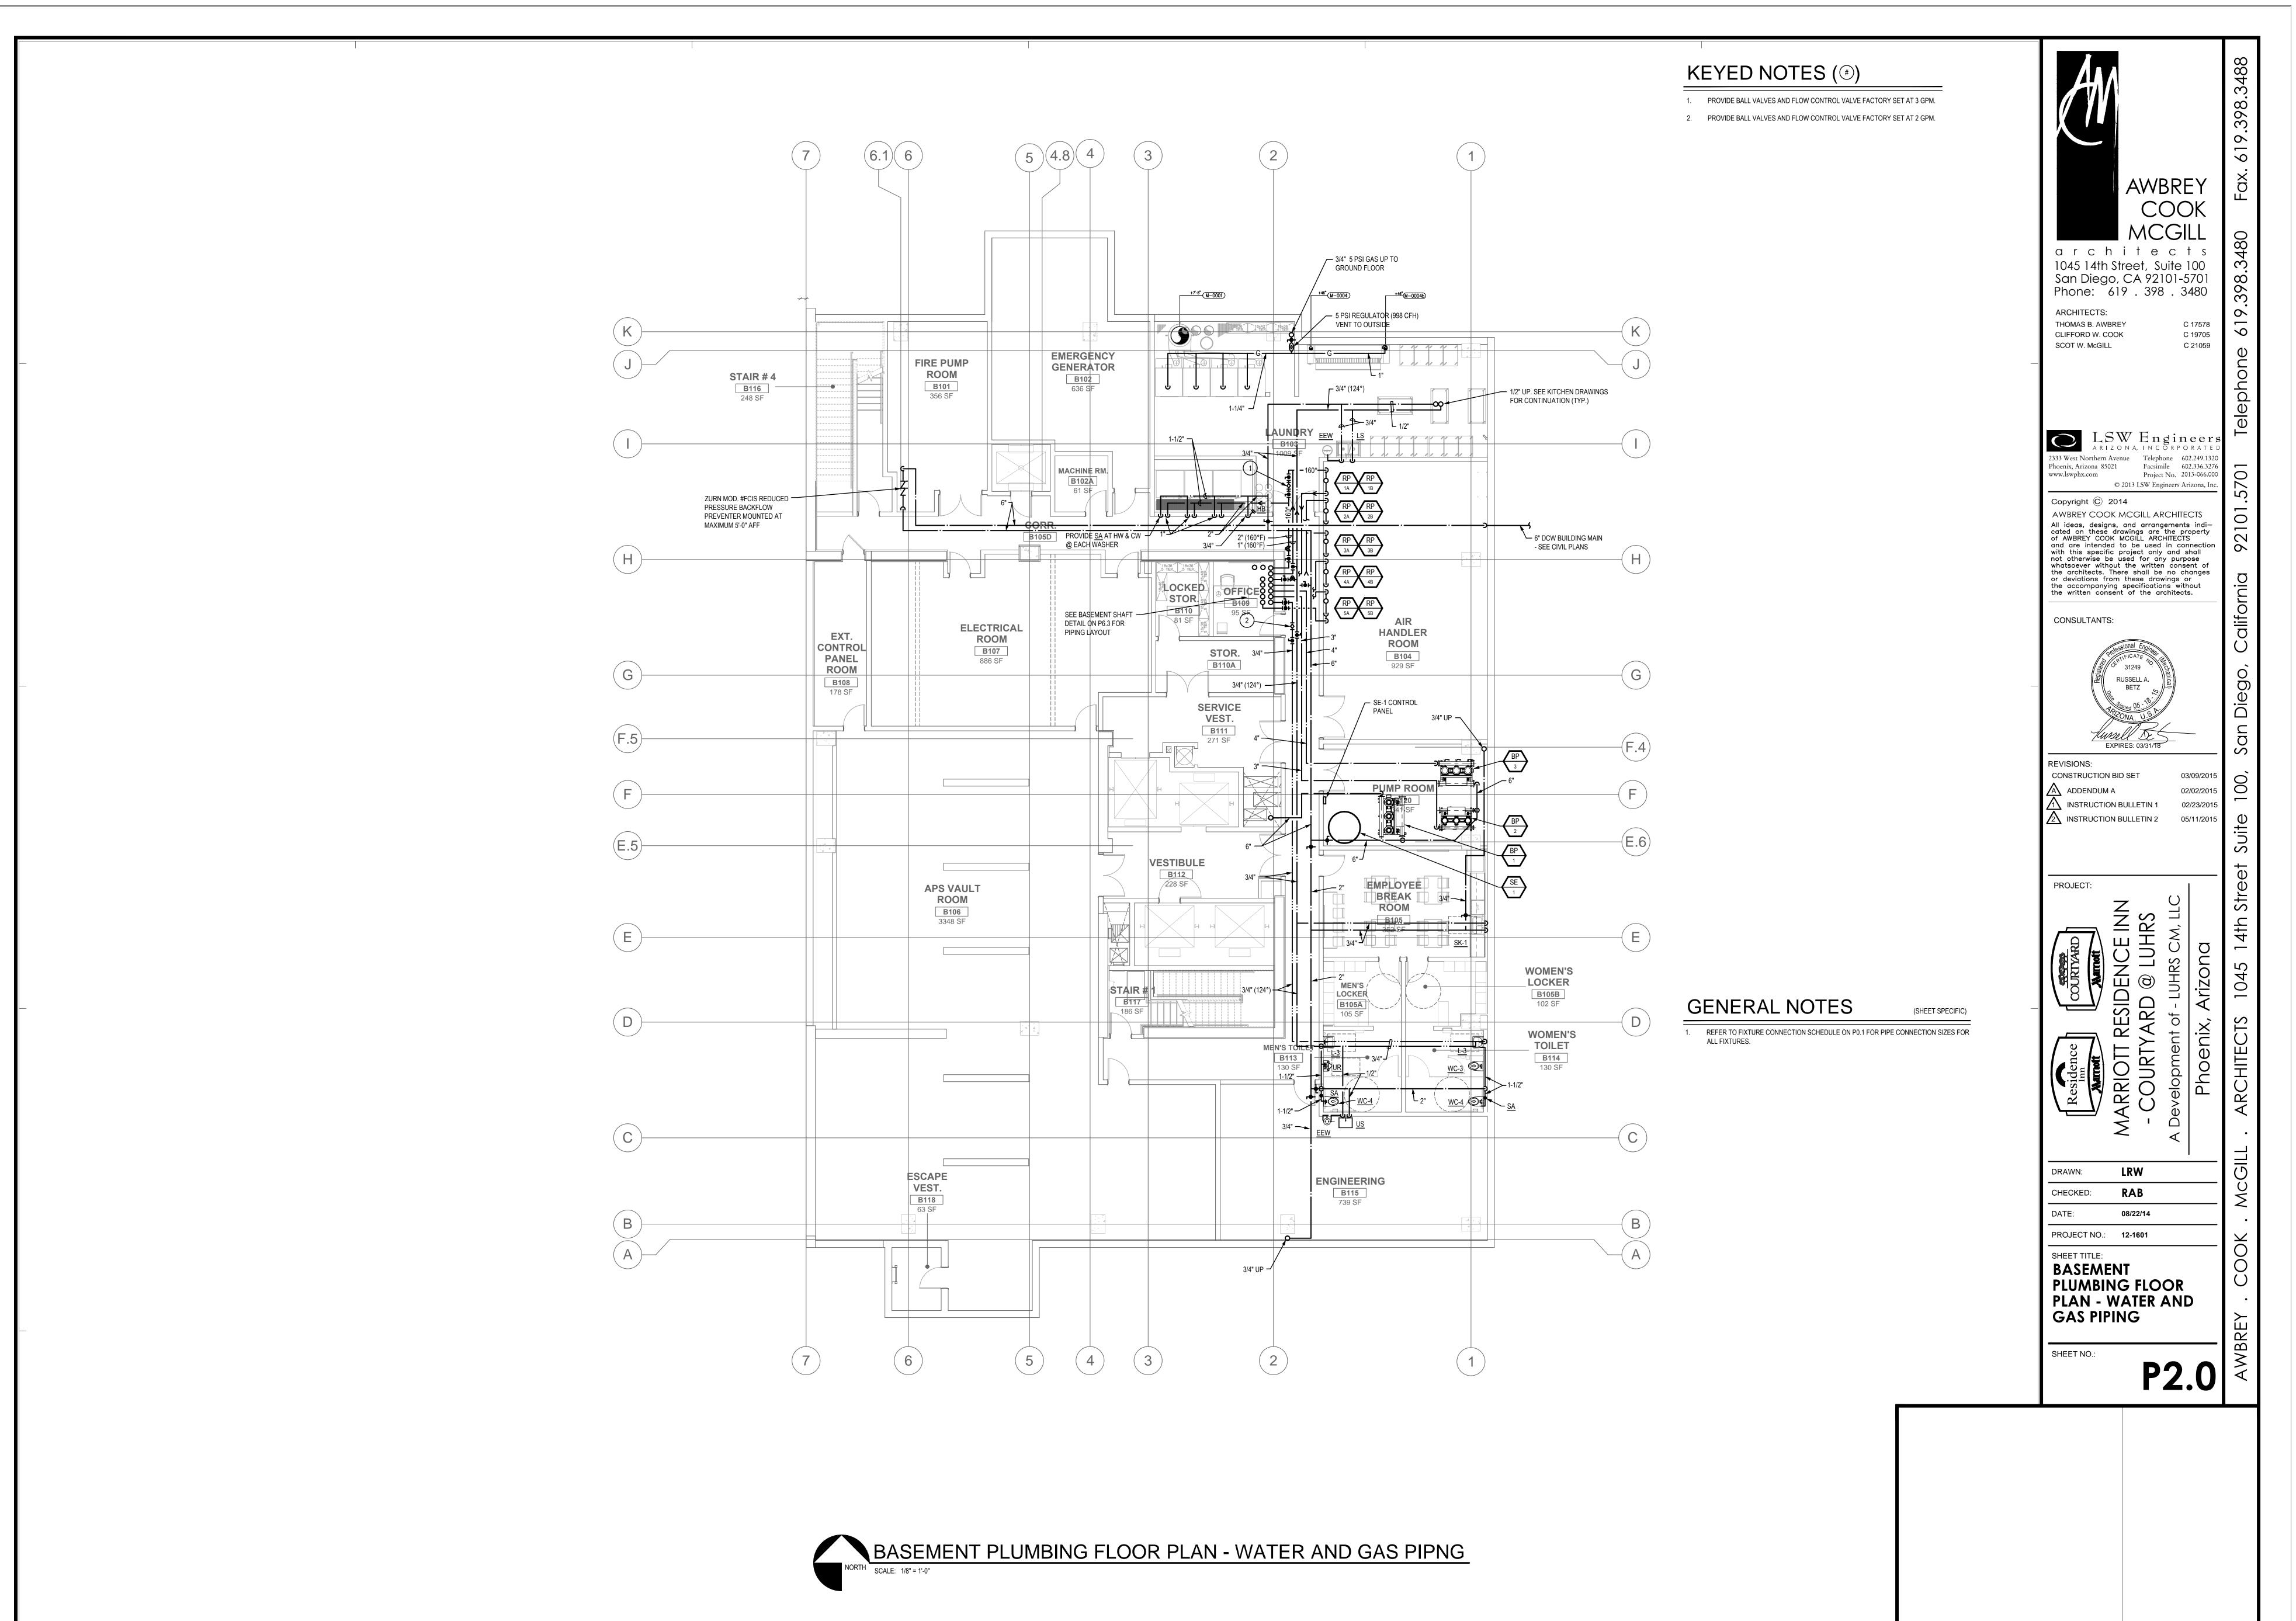

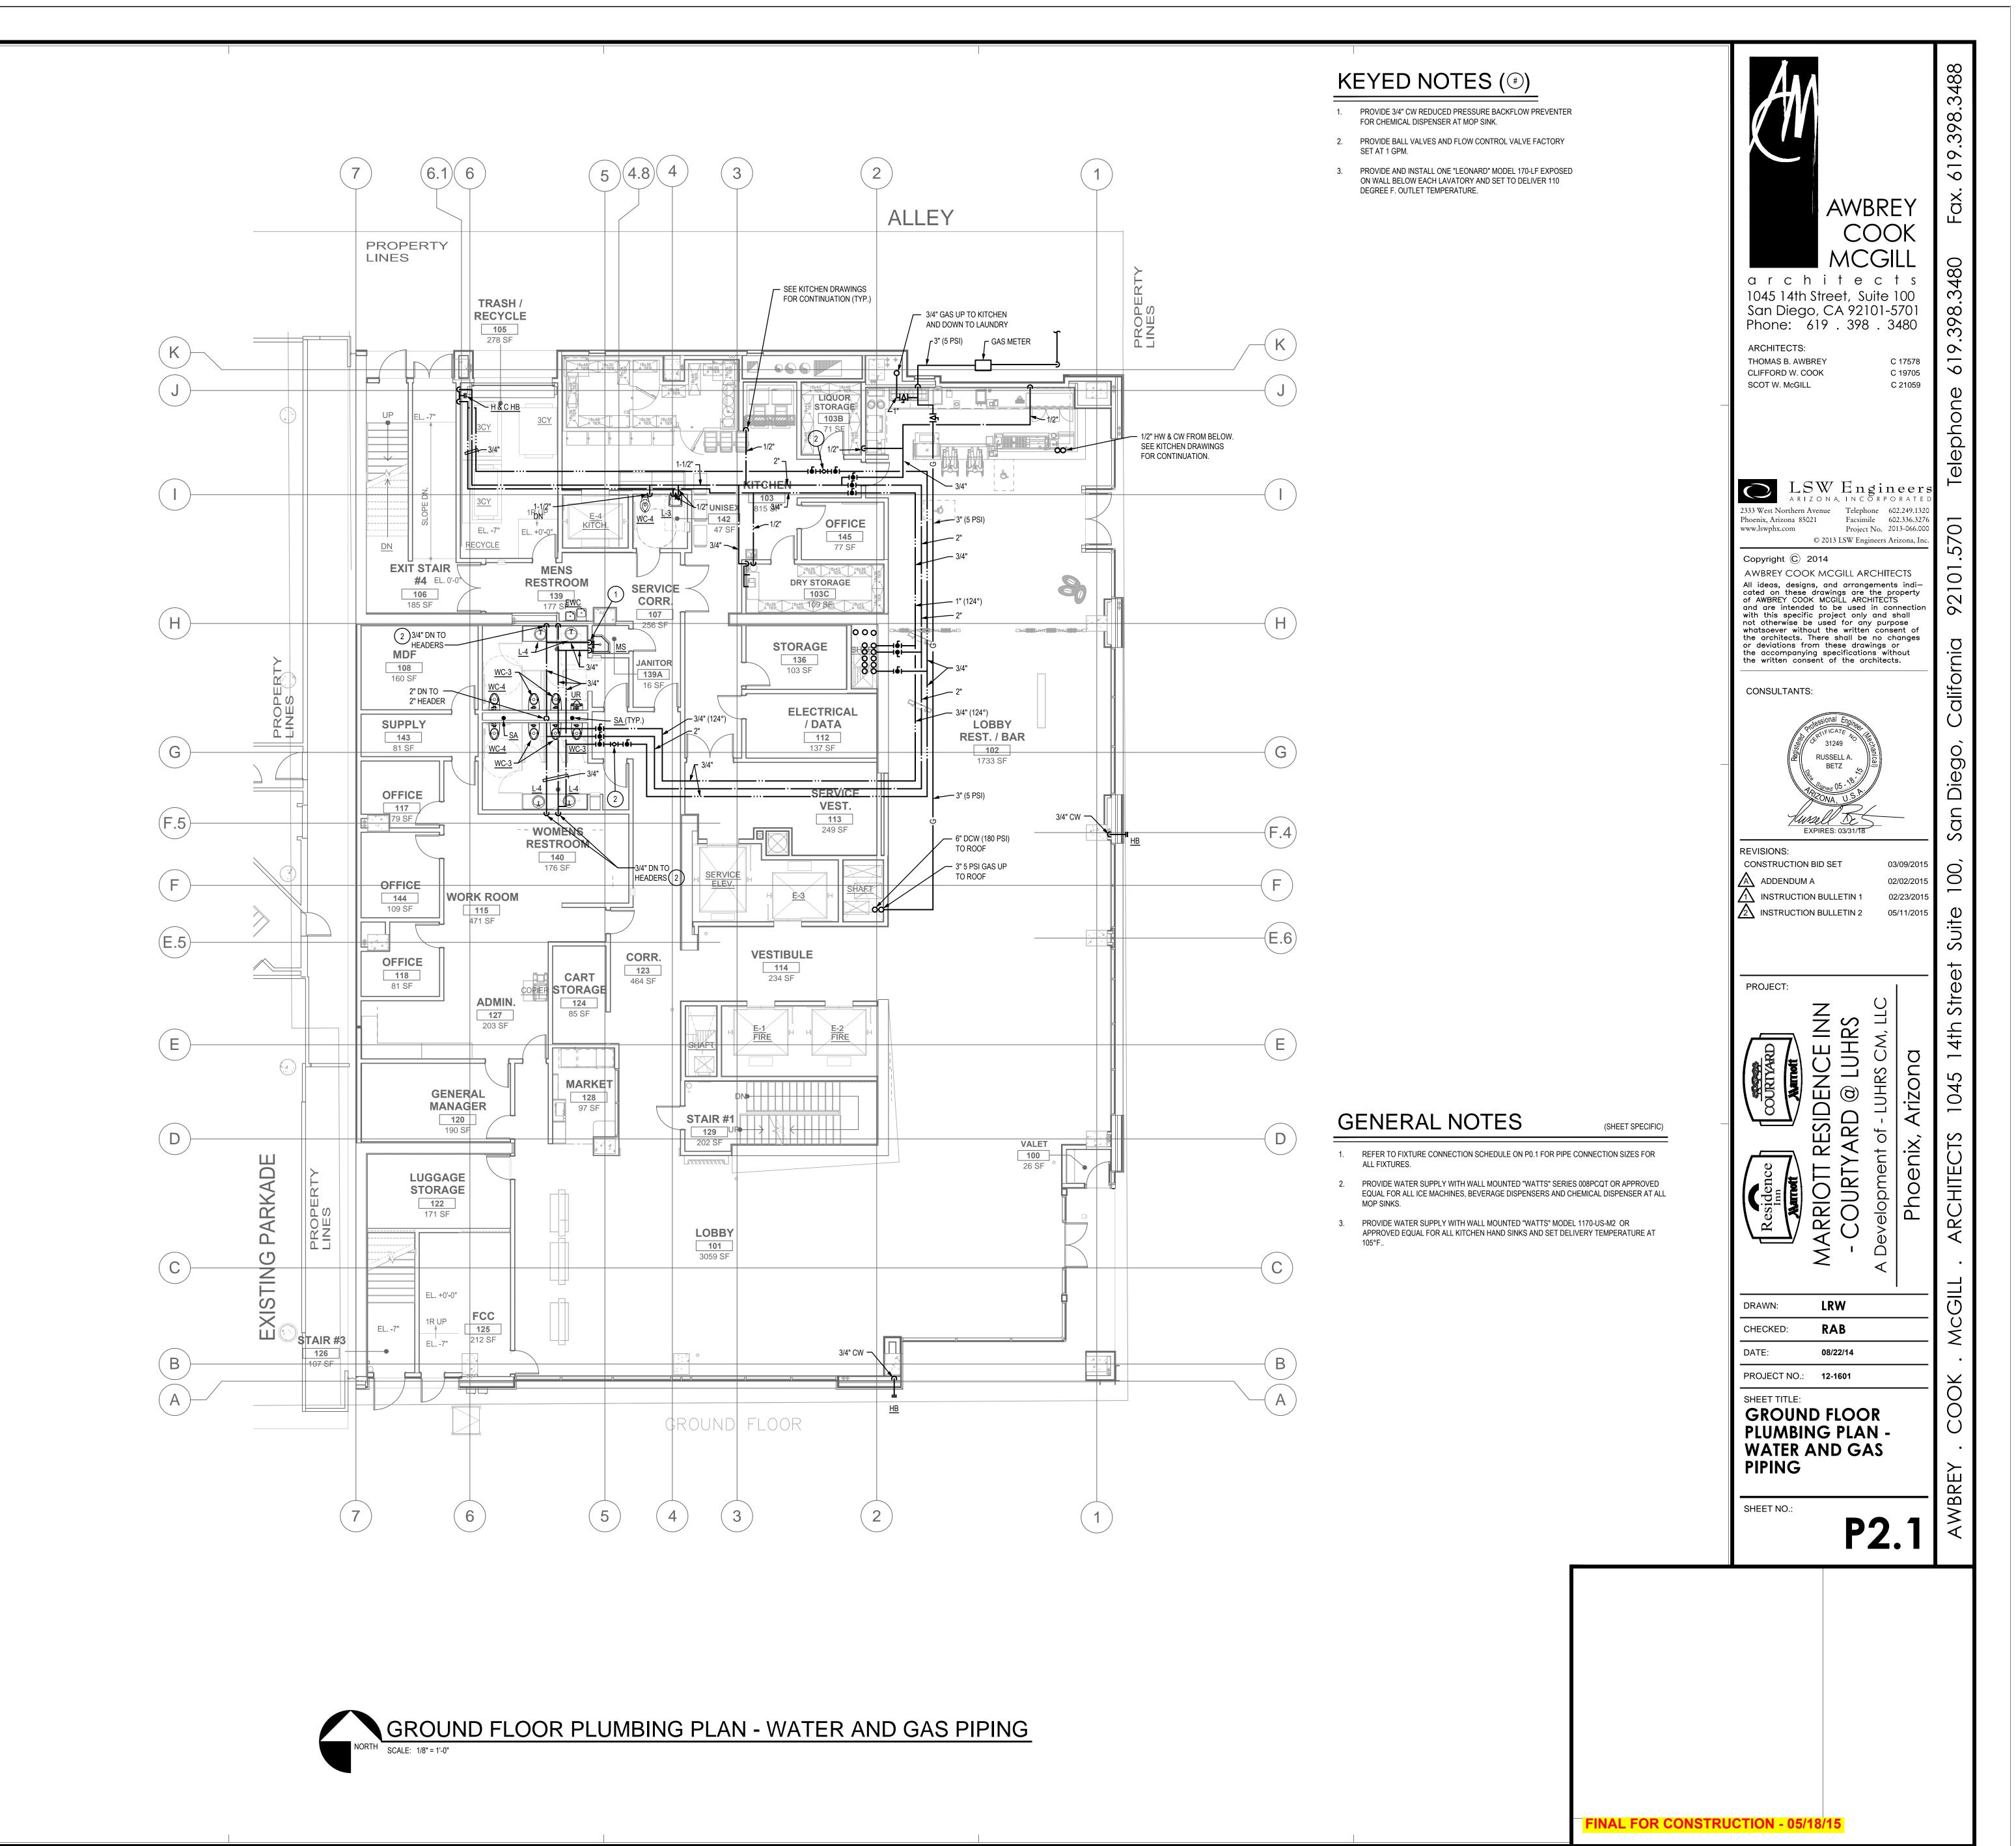

- 1. PROVIDE 3/4" CW REDUCED PRESSURE BACKFLOW PREVENTER FOR CHEMICAL DISPENSER AT MOP SINK.
- 2. PROVIDE BALL VALVES AND FLOW CONTROL VALVE FACTORY SET AT 1 GPM.
- 3. PROVIDE BALL VALVES AND FLOW CONTROL VALVE FACTORY SET AT 2 GPM.
- 4. PROVIDE AND INSTALL ONE "LEONARD" MODEL 170-LF EXPOSED ON WALL BELOW EACH LAVATORY AND SET TO DELIVER 110°F. OUTLET TEMPERATURE.
- 5. PROVIDE BALL VALVE, SHOCK ABSORBER AND UNION ON HOT WATER LINE TO DISHWASHER.



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CONSULTANTS:



CONSTRUCTION BID SET A ADDENDUM A 1 INSTRUCTION BULLETIN 1 INSTRUCTION BULLETIN 2 05/11/2015

(SHEET SPECIFIC)

ALL FIXTURES.

PROVIDE WATER SUPPLY WITH WALL MOUNTED "WATTS" MODEL 1170-US-M2 OR APPROVED EQUAL FOR ALL KITCHEN HAND SINKS AND SET DELIVERY TEMPERATURE AT 105°F..


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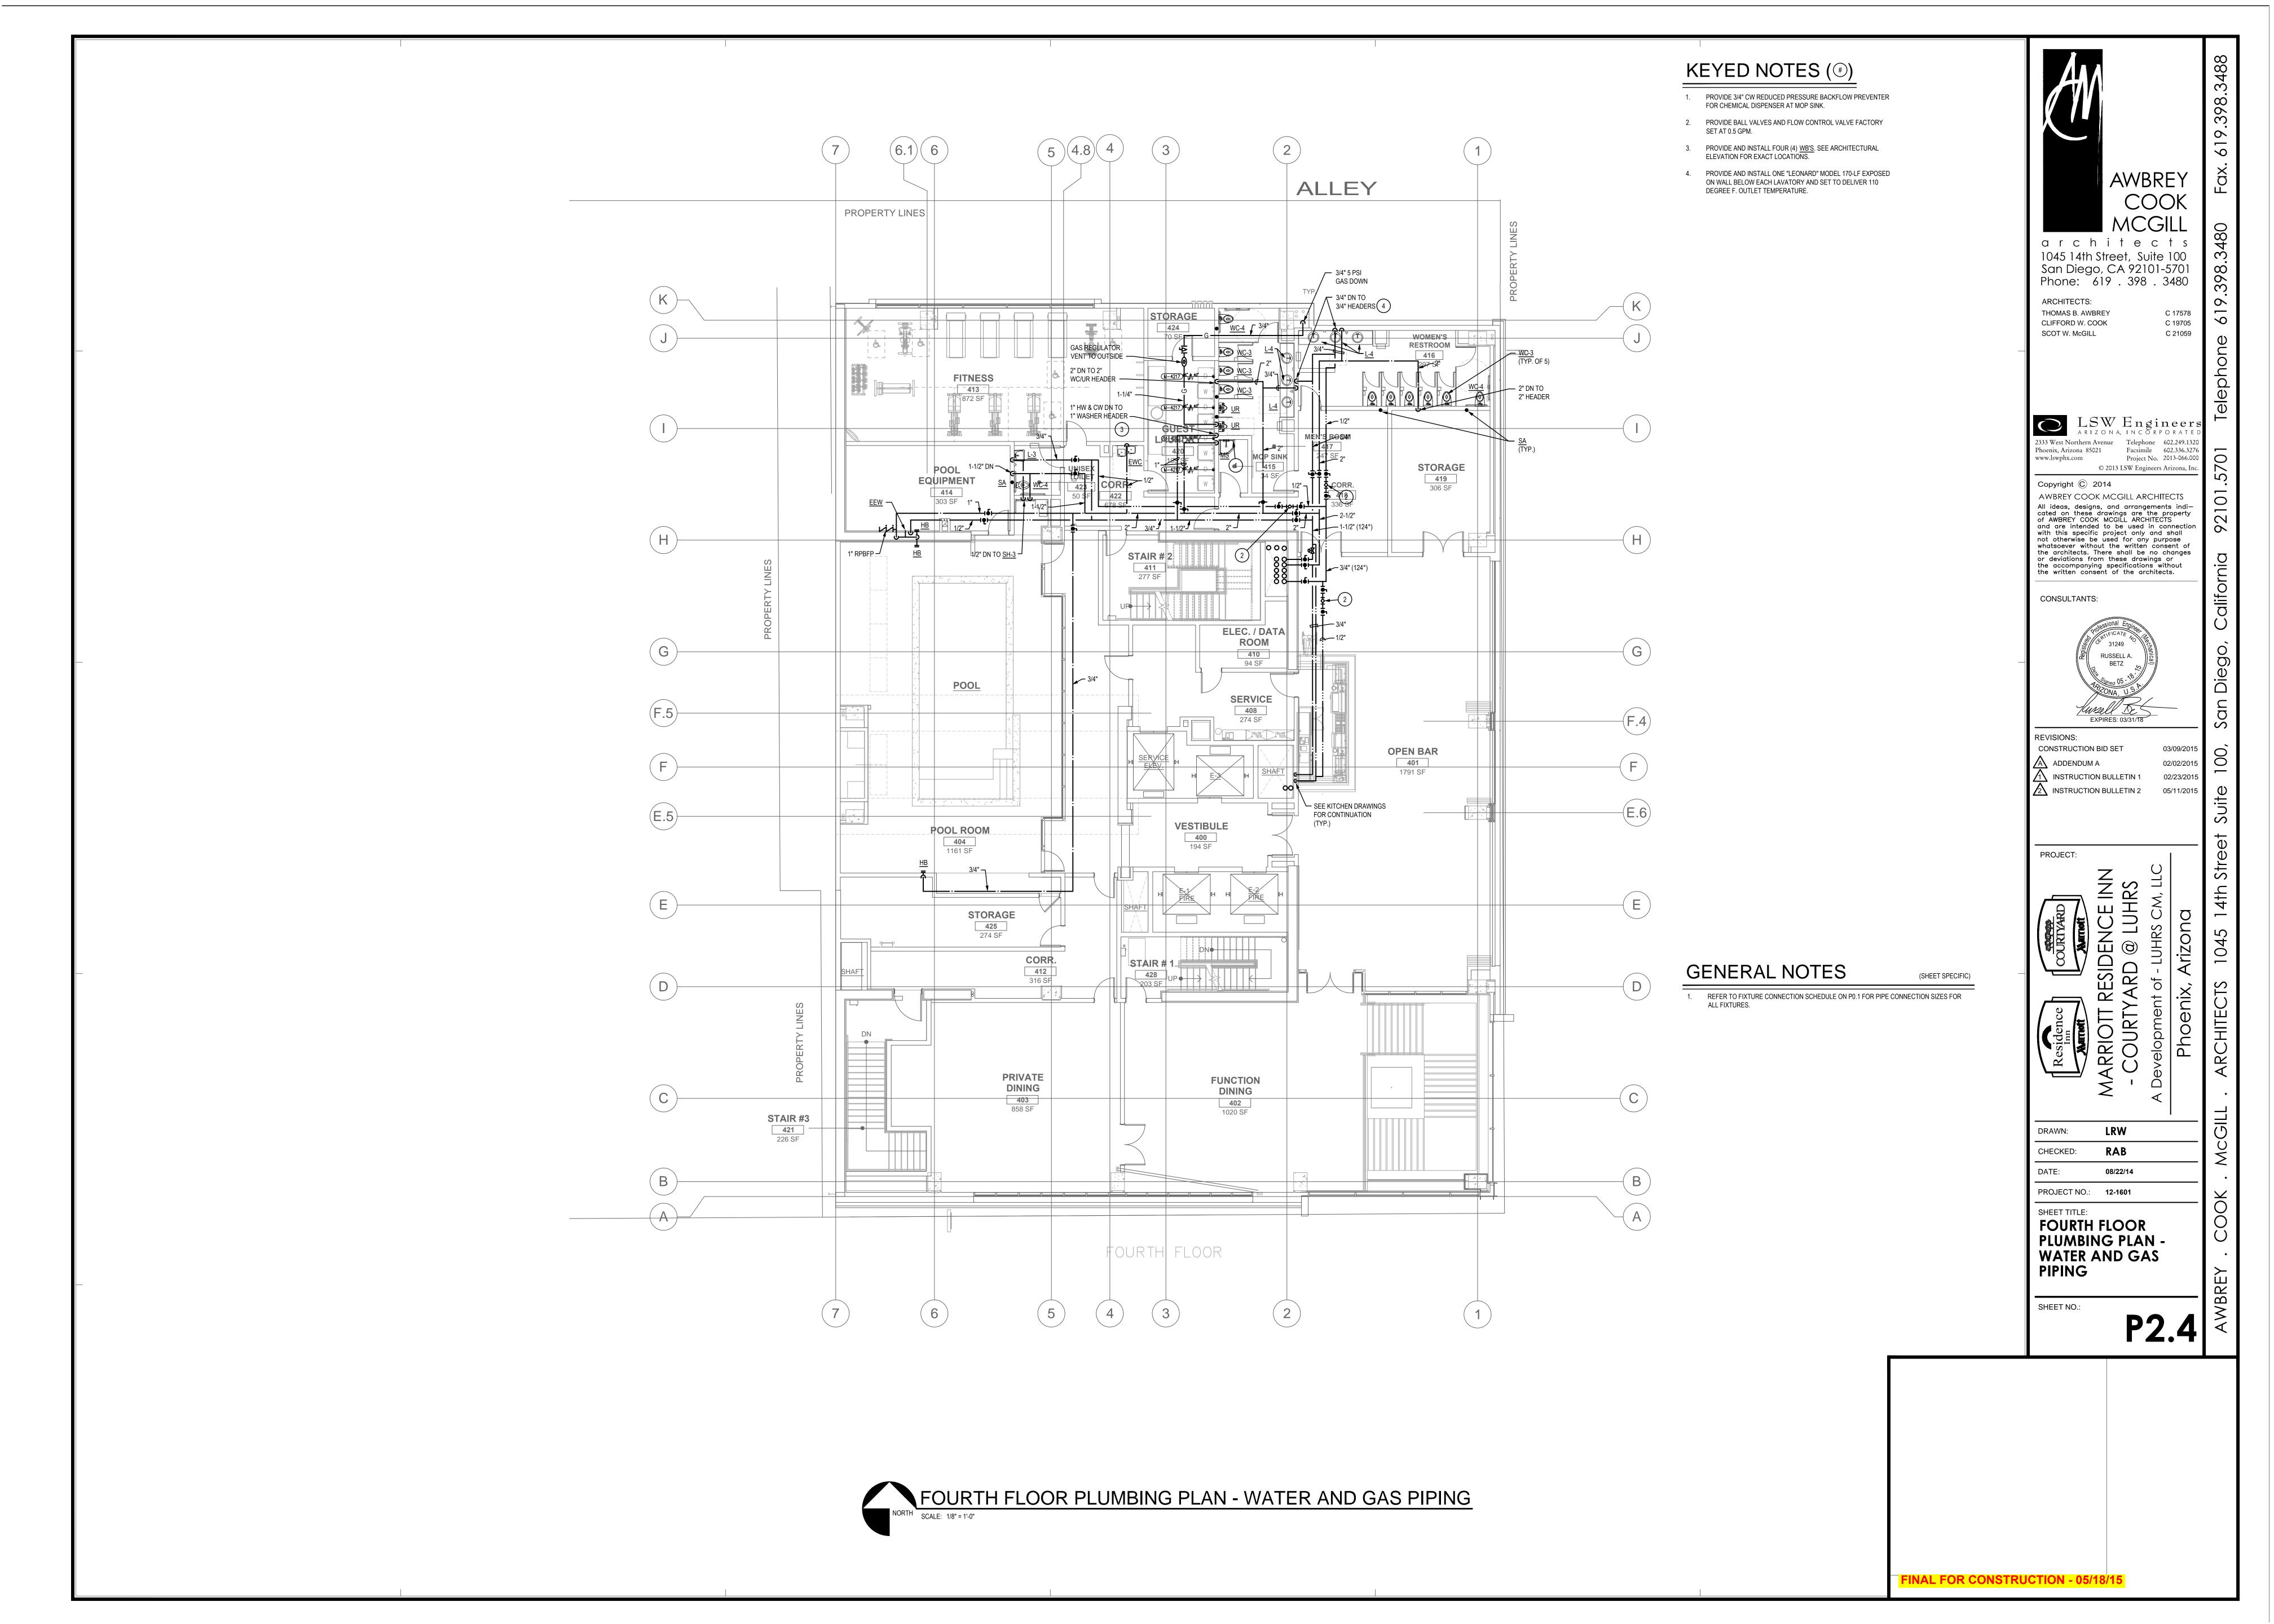
PROJECT NO.: **12-1601** 


SECOND FLOOR
PLUMBING PLAN WATER AND GAS **PIPING** 


SECOND FLOOR PLUMBING PLAN - WATER AND GAS PIPING

NORTH SCALE: 1/8" = 1'-0"



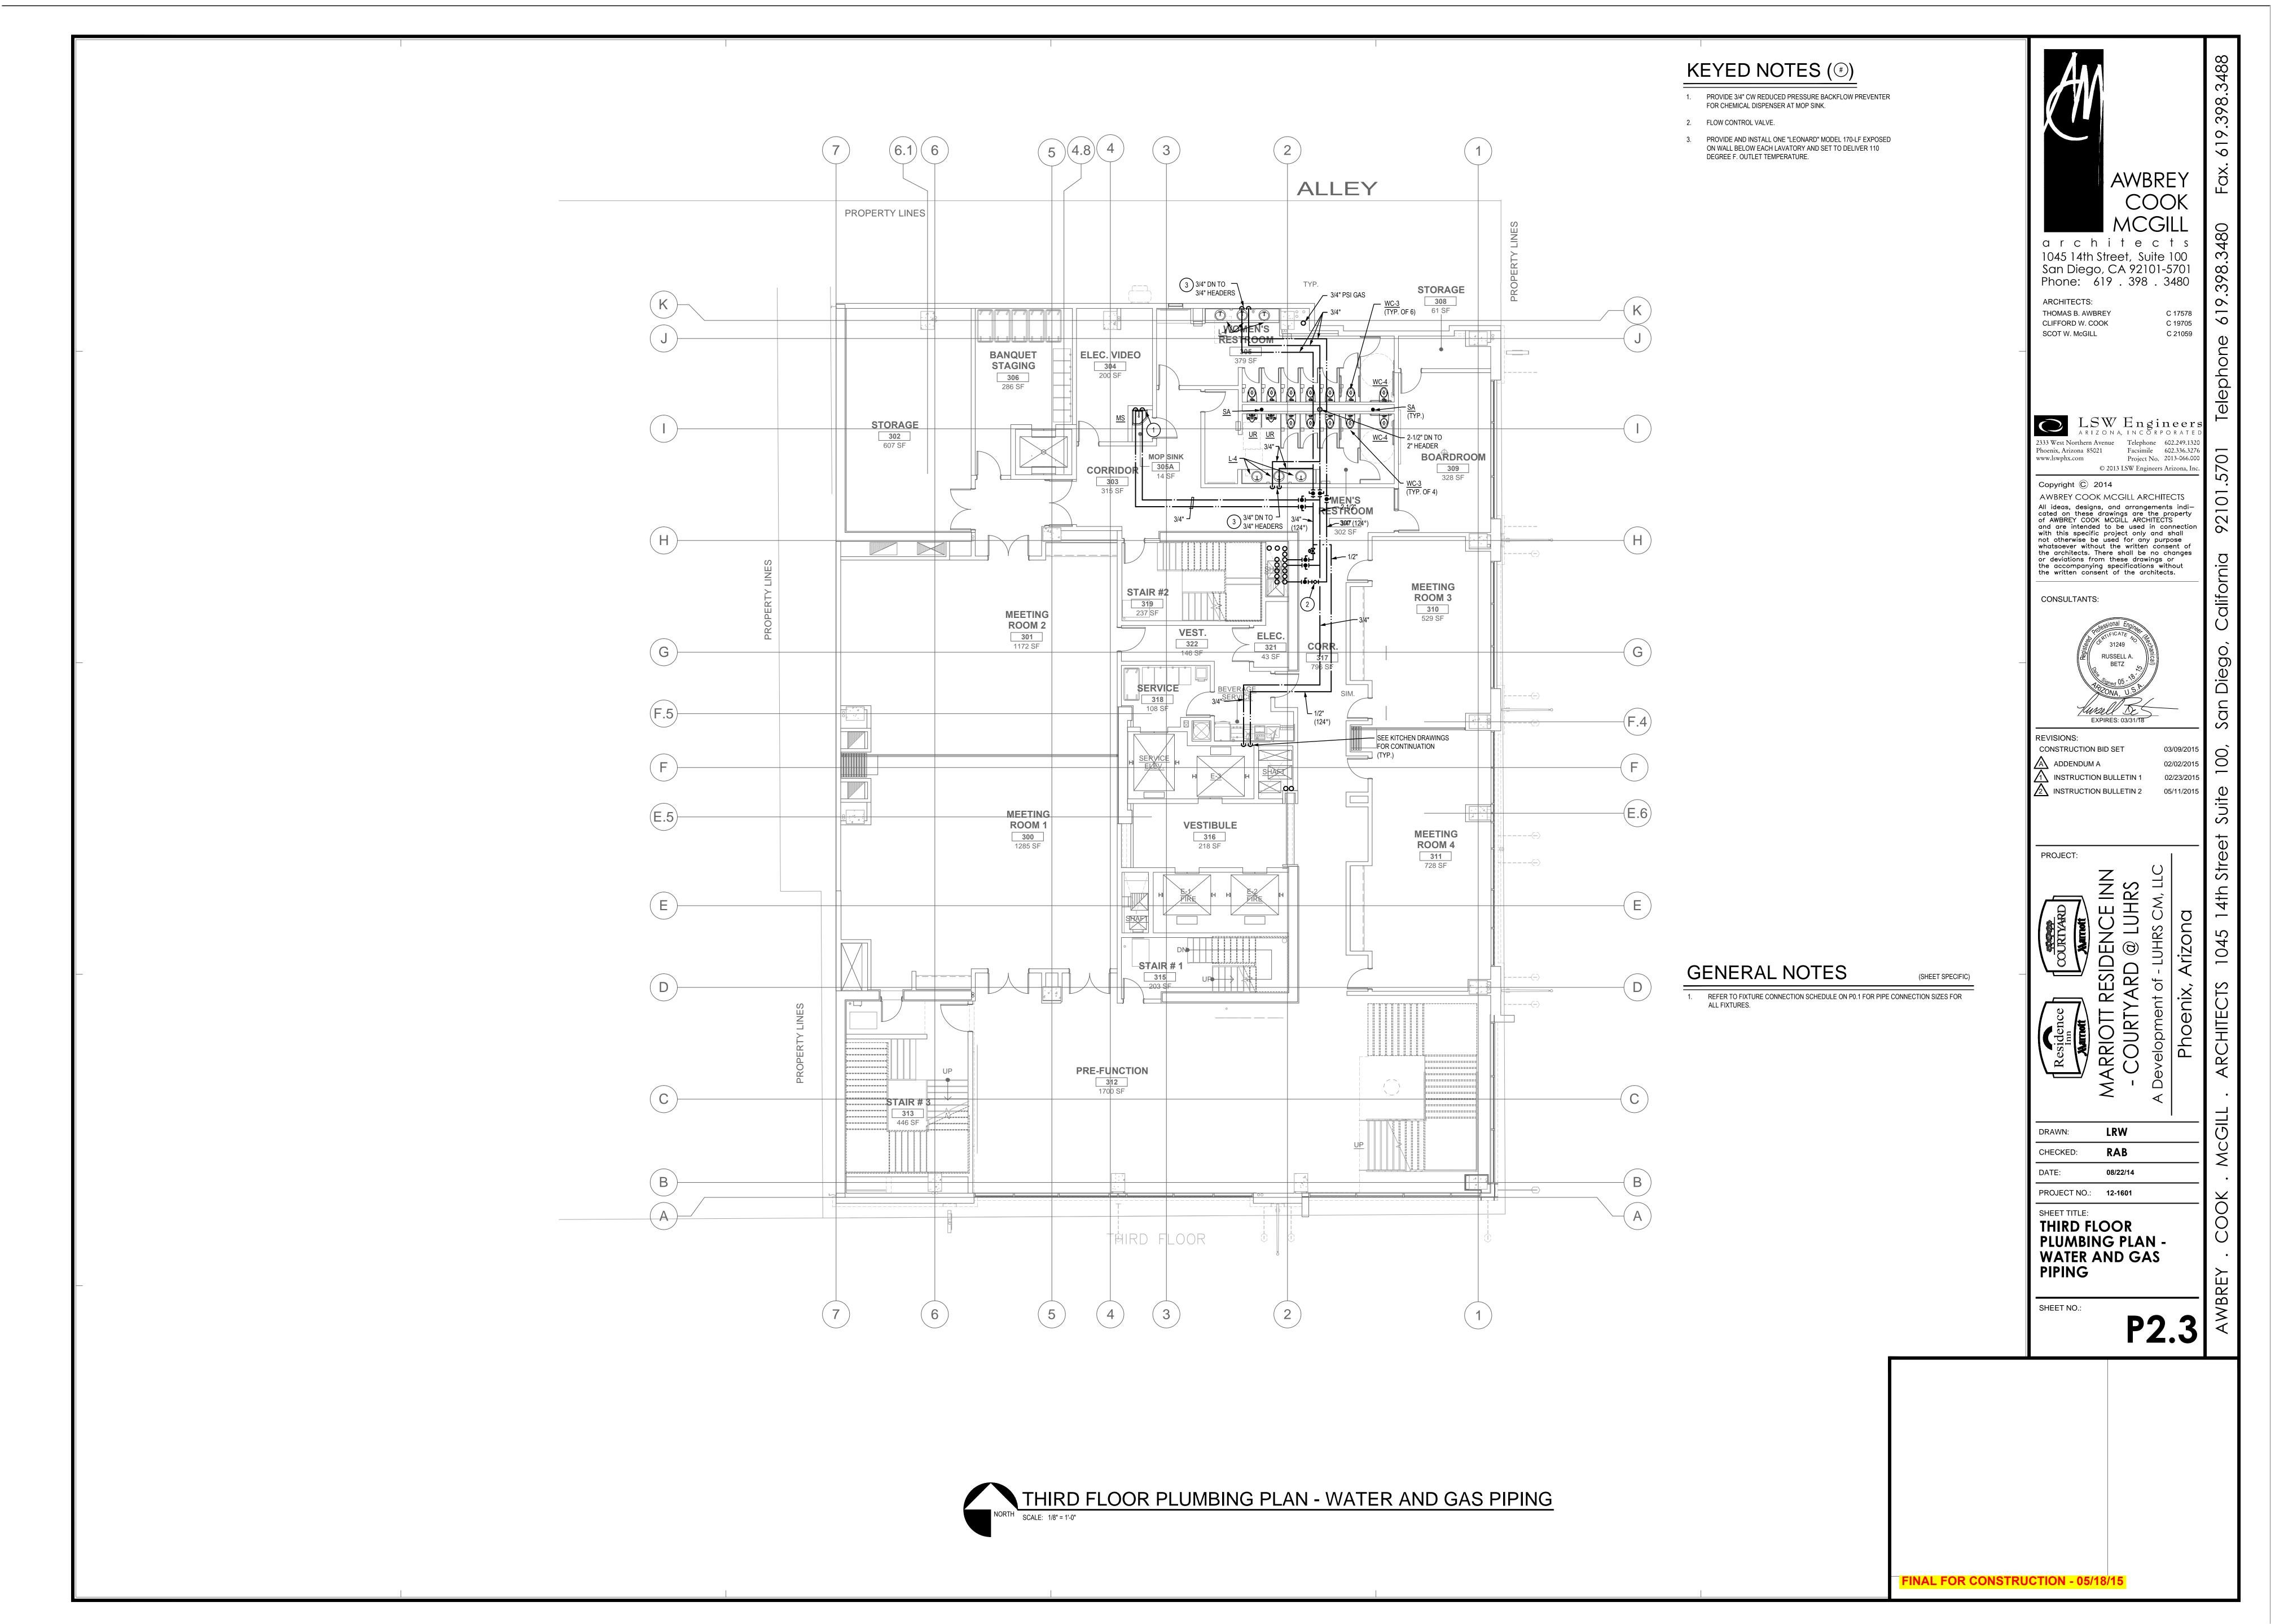

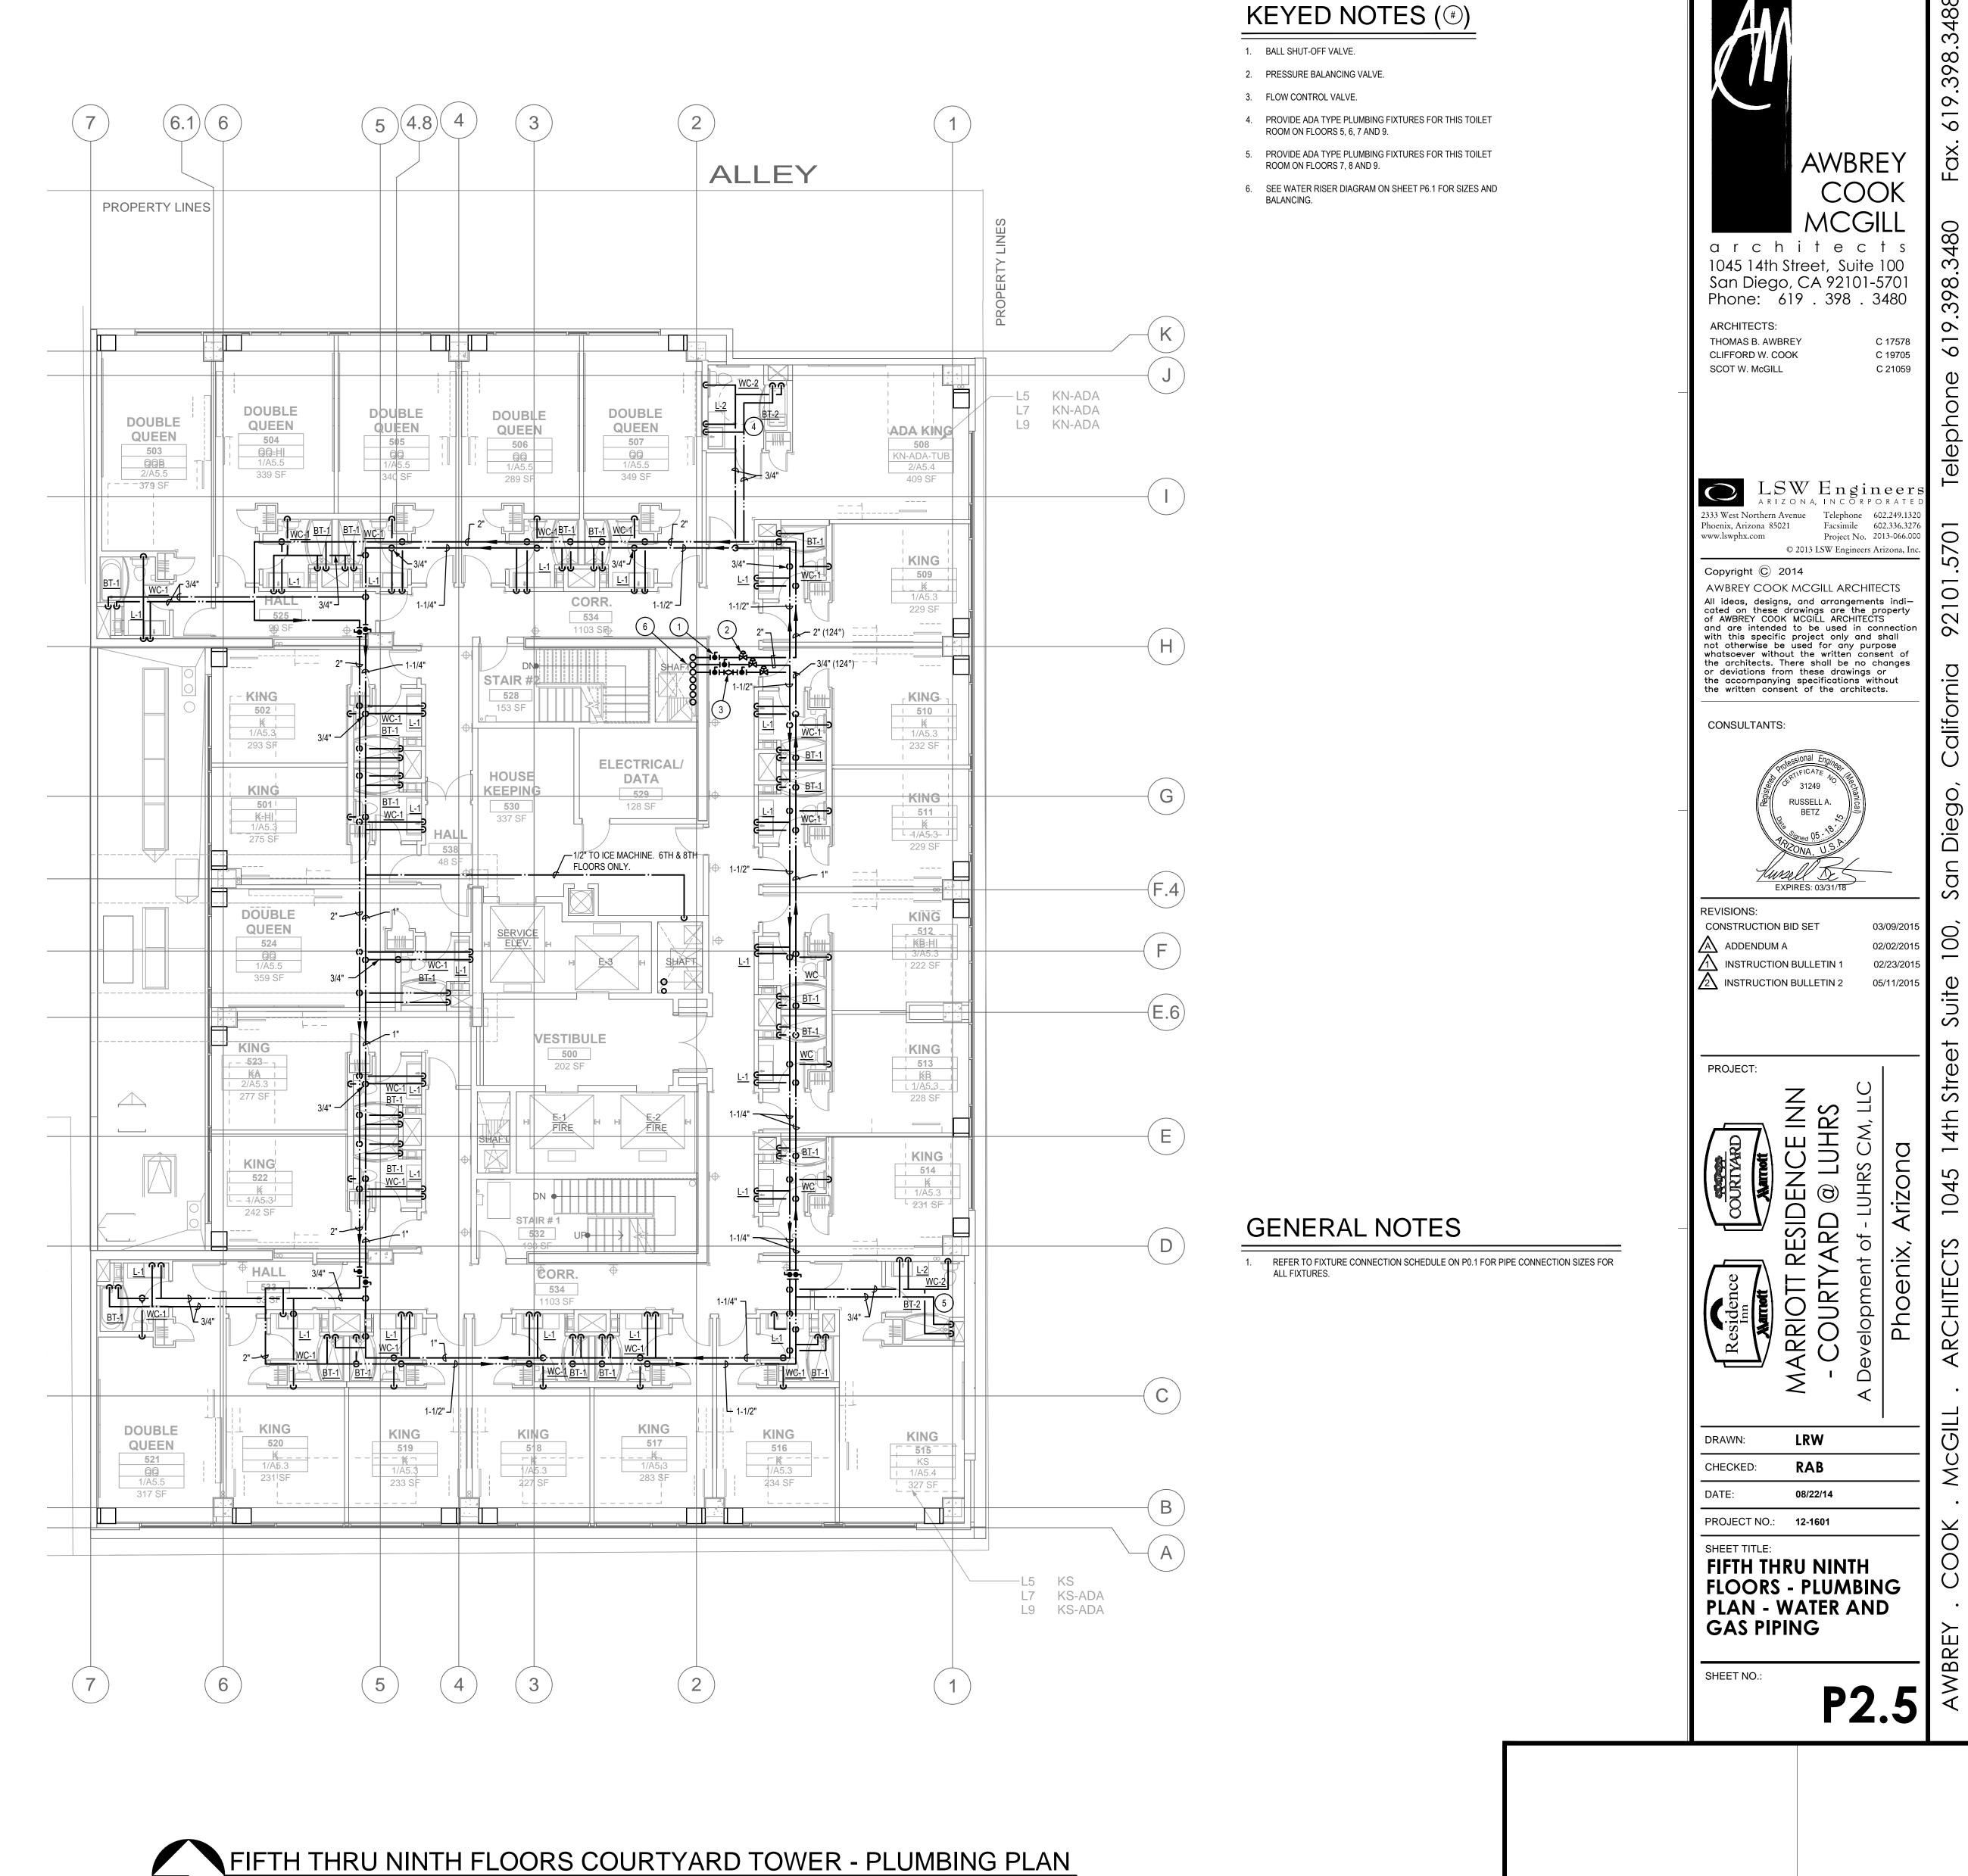

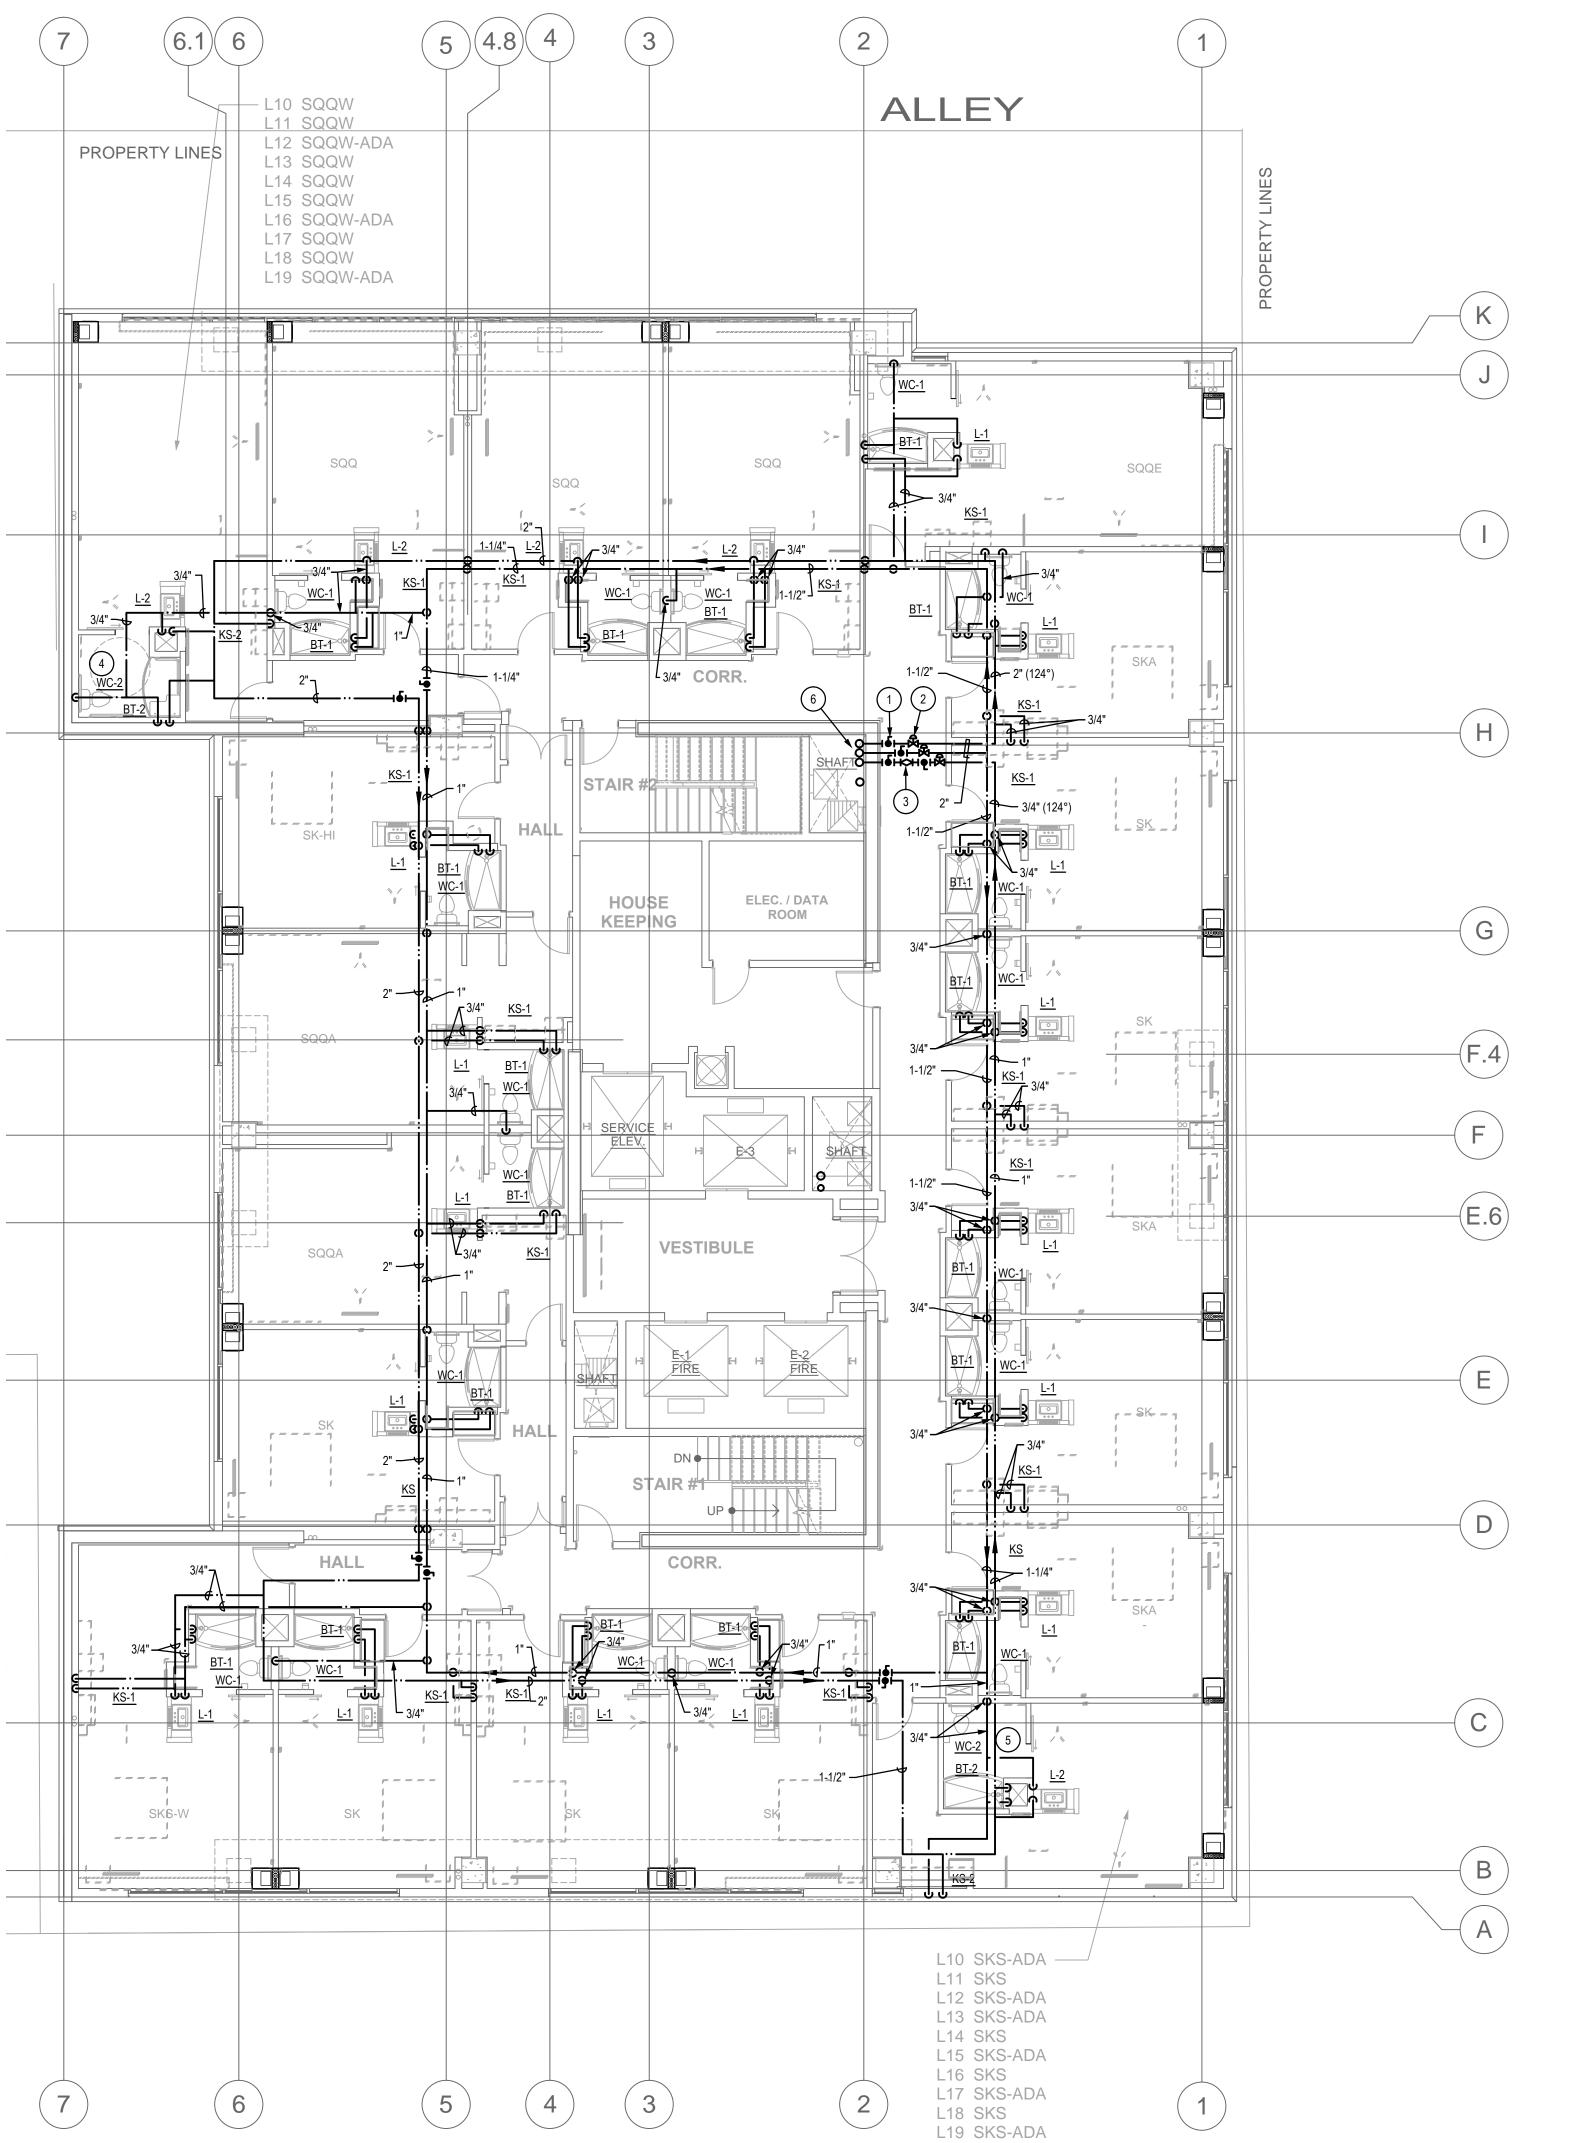




1. BALL SHUT-OFF VALVE.

- PRESSURE BALANCING VALVE.
- 3. FLOW CONTROL VALVE.
- 4. PROVIDE ADA TYPE PLUMBING FIXTURES FOR THIS TOILET ROOM ON FLOORS 10, 12, 16 AND 19.
- 5. PROVIDE ADA TYPE PLUMBING FIXTURES FOR THIS TOILET ROOM ON FLOORS 10, 12, 13, 15, 17 AND 19.
- 6. SEE WATER RISER DIAGRAM ON SHEET P6.1 FOR SIZES AND BALANCING.

#### **GENERAL NOTES**

1. REFER TO FIXTURE CONNECTION SCHEDULE ON P0.1 FOR PIPE CONNECTION SIZES FOR ALL FIXTURES.

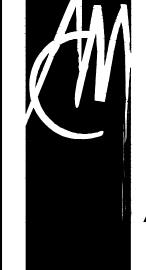

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CONSULTANTS:



REVISIONS:

CONSTRUCTION BID SET

ADDENDUM A

INSTRUCTION BULLETIN 1

INSTRUCTION BULLETIN 2

03/09/201 02/02/201 TIN 1 02/23/201 TIN 2 05/11/201

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CHECKED: RAB

DATE: 08/22/14

OJECT NO.: 12-1601


TENTH THRU
NINETEENTH FLOORS
PLUMBING PLAN WATER AND GAS
PIPING

SHEET NO.:

P2.6


TENTH THRU NINETEENTH FLOORS RESIDENCE INN TOWER - PLUMBING PLAN

SCALE: 1/8" = 1'-0"

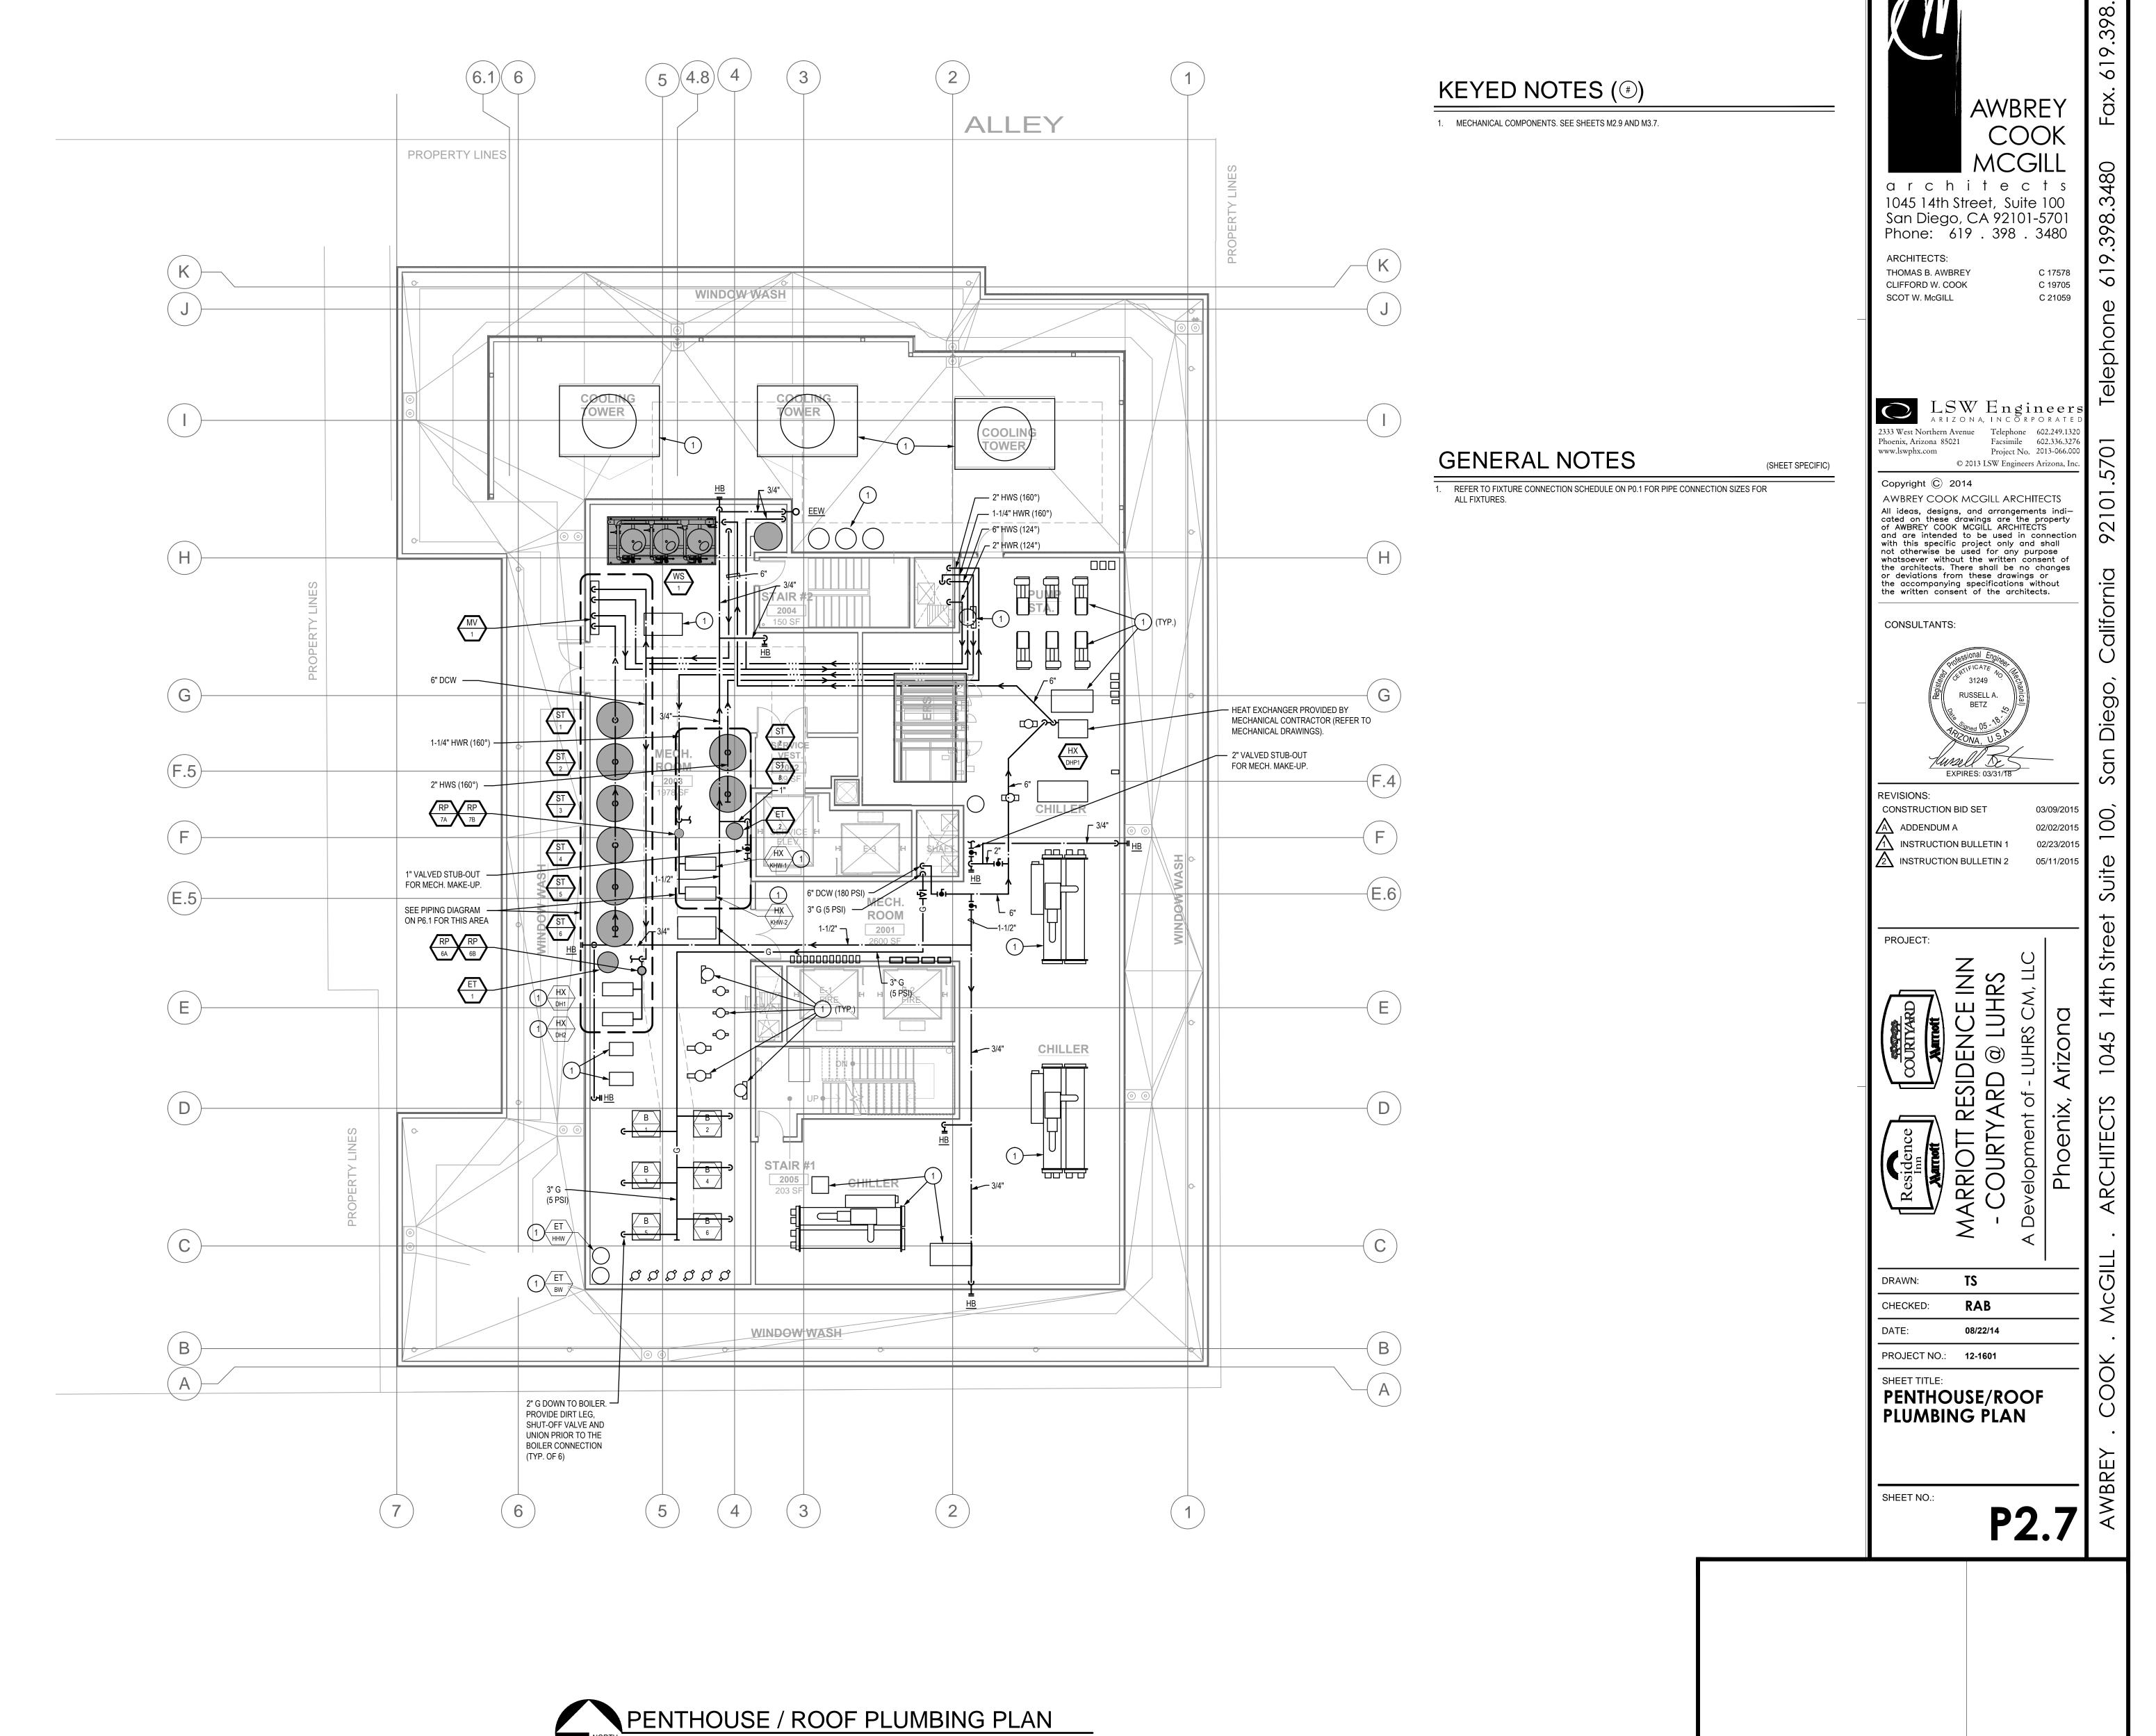

PENTHOUSE / ROOF PLUMBING PLAN

SCALE: 1/8" = 1'-0"

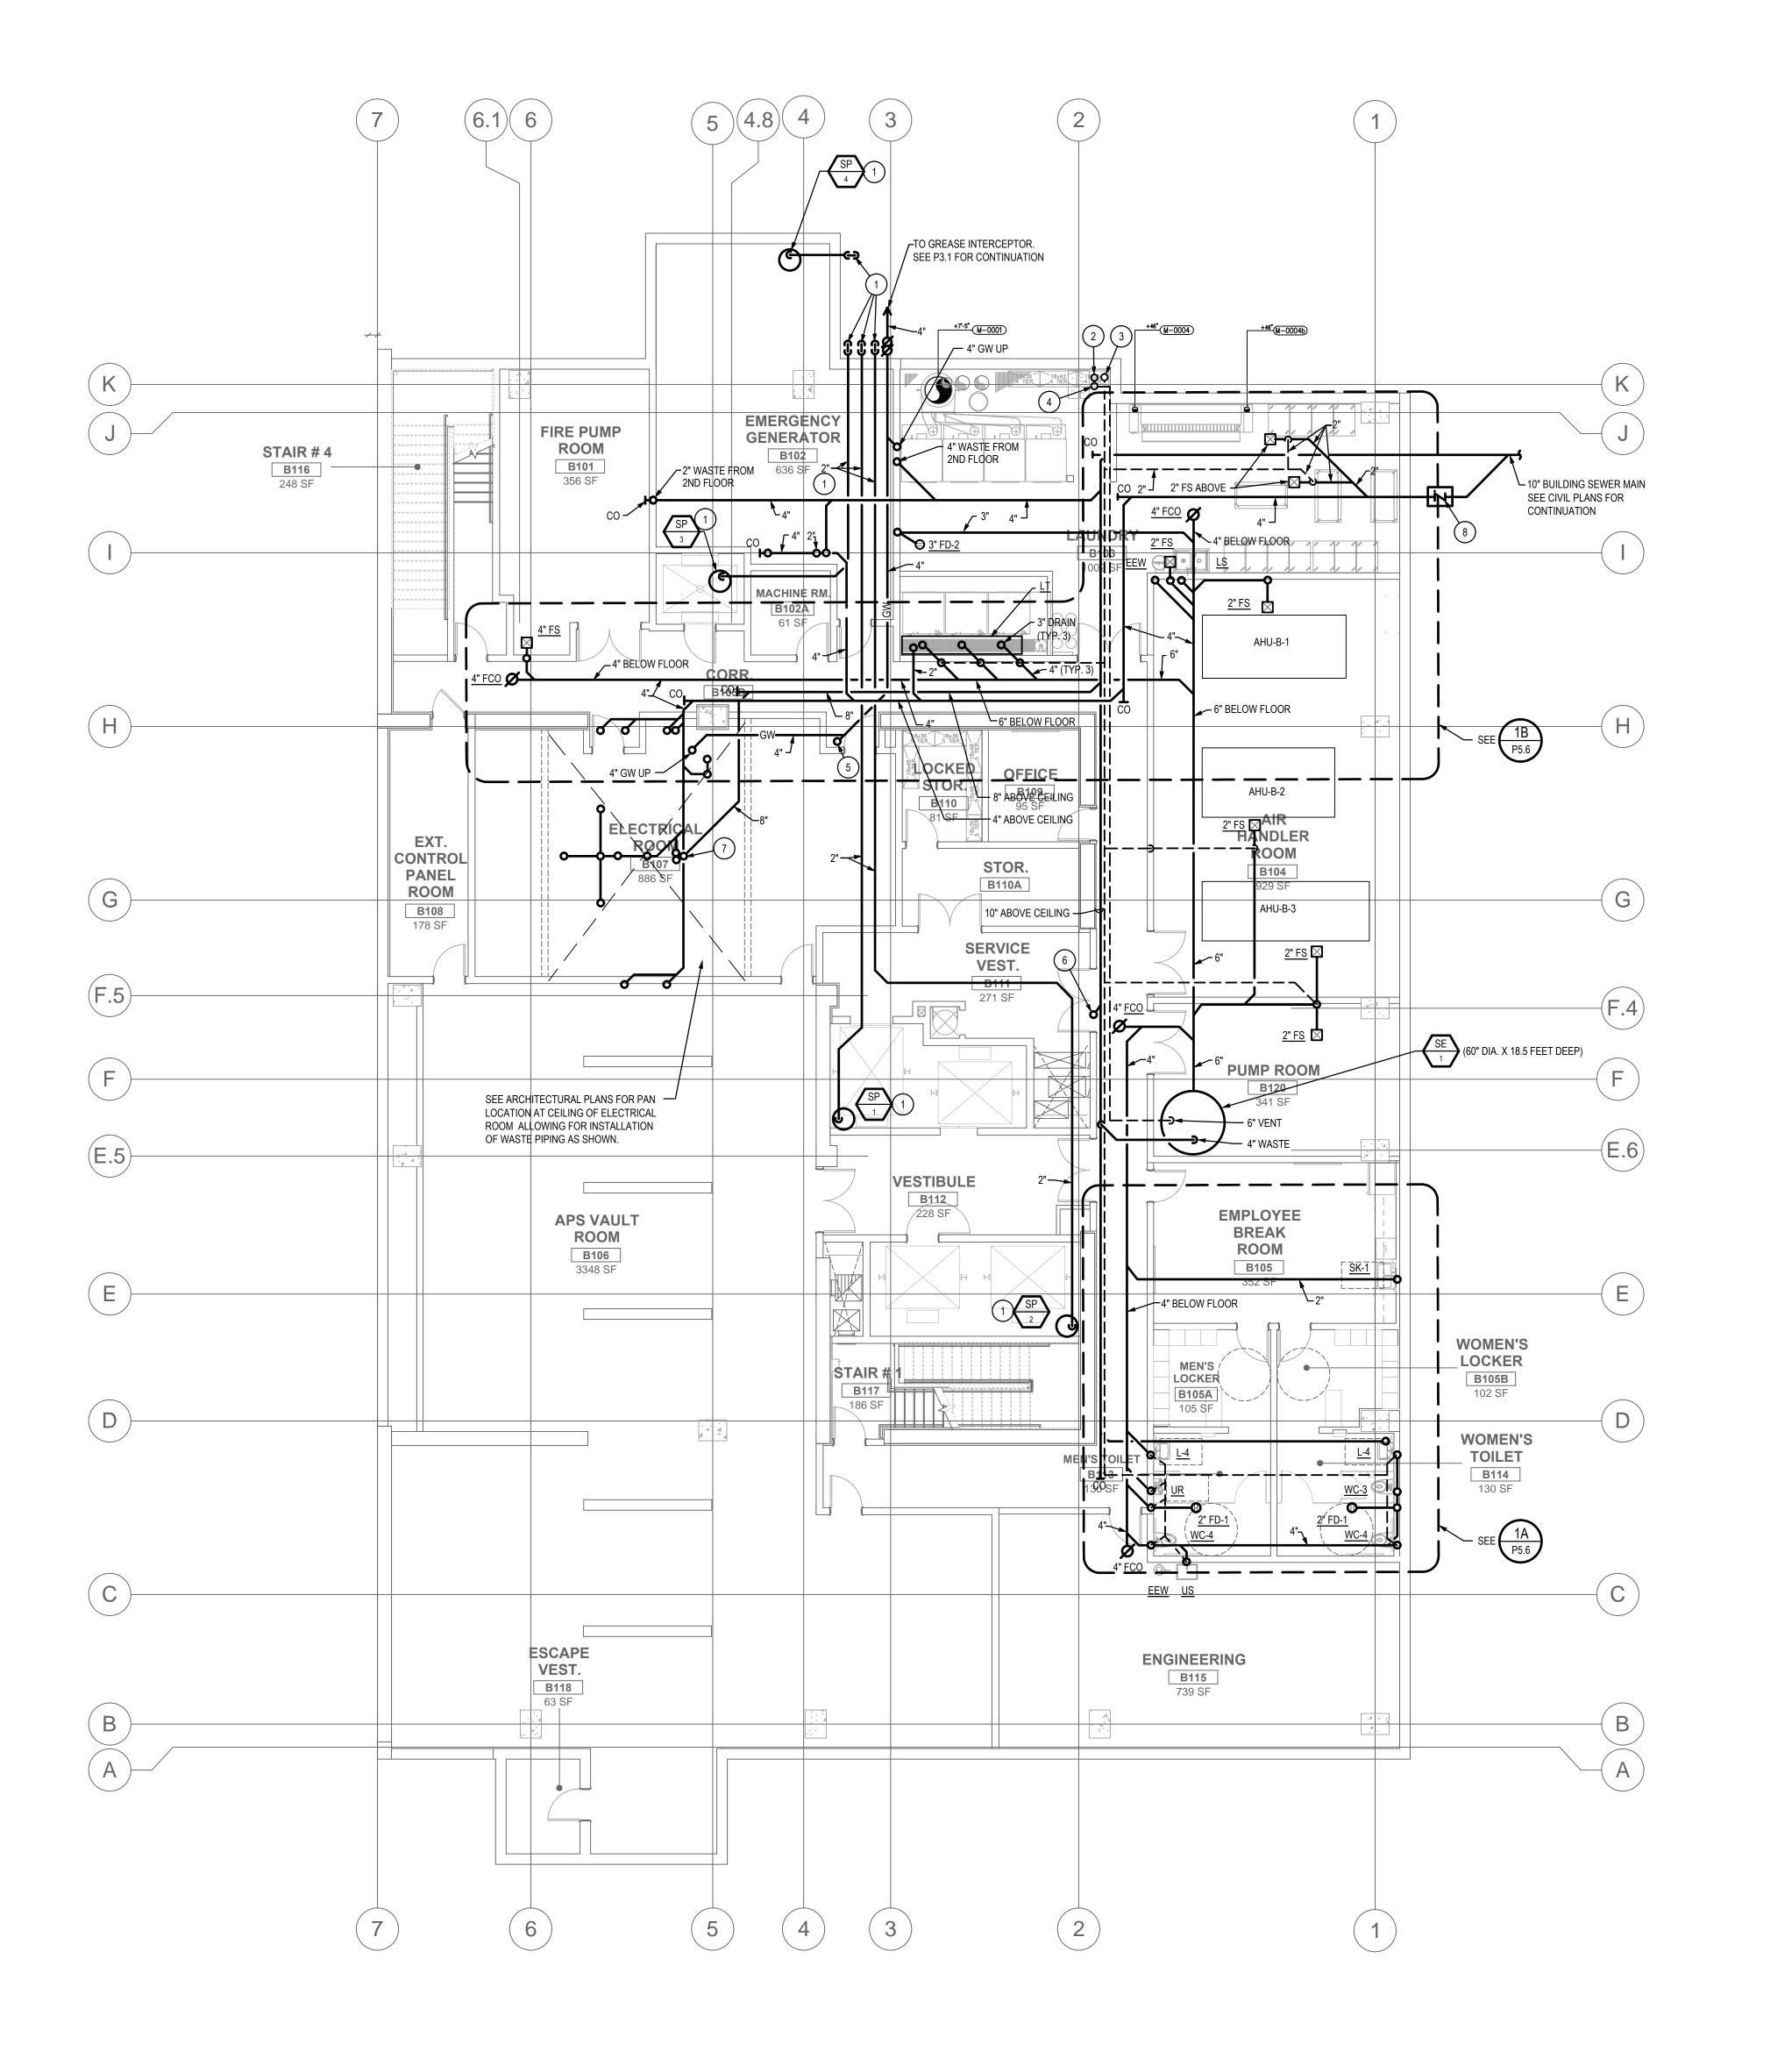



- RUN 2" DRAIN LINE FROM ELEVATOR PIT SUMP PUMP BELOW BASEMENT FLOOR TO EXTERIOR OF BUILDING AND TURN UP TO DAYLIGHT AND ELBOW DOWN AT 6" ABOVE FINISH GRADE.
- 2. RUN 4" VENT UP IN CHASE TO VENT THRU ROOF.
- 3. RUN 6" VENT UP FROM SEWAGE EJECTOR TO VENT THRU ROOF.
- 4. RUN 3" VENT FROM DOMESTIC WASTE FIXTURES UP THRU 1ST FLOOR. SEE SHEET
- 5. 4" GREASE WASTE DOWN FROM 4" FCO ON GROUND FLOOR. SEE SHEET P3.1.
- 6. 6" WASTE DOWN THRU GROUND FLOOR.
- 7. 8" WASTE DOWN THRU GROUND FLOOR.

GENERAL NOTES

8. PROVIDE WITH FULL SIZE BACKWATER VALVE (SERVING ALL GROUND FLOOR PLUMBING FIXTURES ONLY) LOCATED WITHIN VALVE BOX WITH COVER.

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CONSULTANTS:



REVISIONS:

CONSTRUCTION BID SET

ADDENDUM A

INSTRUCTION BULLETIN 1

INSTRUCTION BULLETIN 2

02/02/20<sup>2</sup>
ULLETIN 1 02/23/20<sup>2</sup>
ULLETIN 2 05/11/20<sup>2</sup>

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- COURTYARD @
Development of - LUF

(SHEET SPECIFIC)

DRAWN: LRW
CHECKED: RAB

DJECT NO.: 12-1601


BASEMENT
PLUMBING FLOOR
PLAN - WASTE, DRAIN
AND VENT PIPING


HEET NO.:


P3.0


BASEMENT PLUMBING FLOOR PLAN - WASTE, DRAIN AND VENT PIPNG


NORTH SCALE: 1/8" = 1'-0"

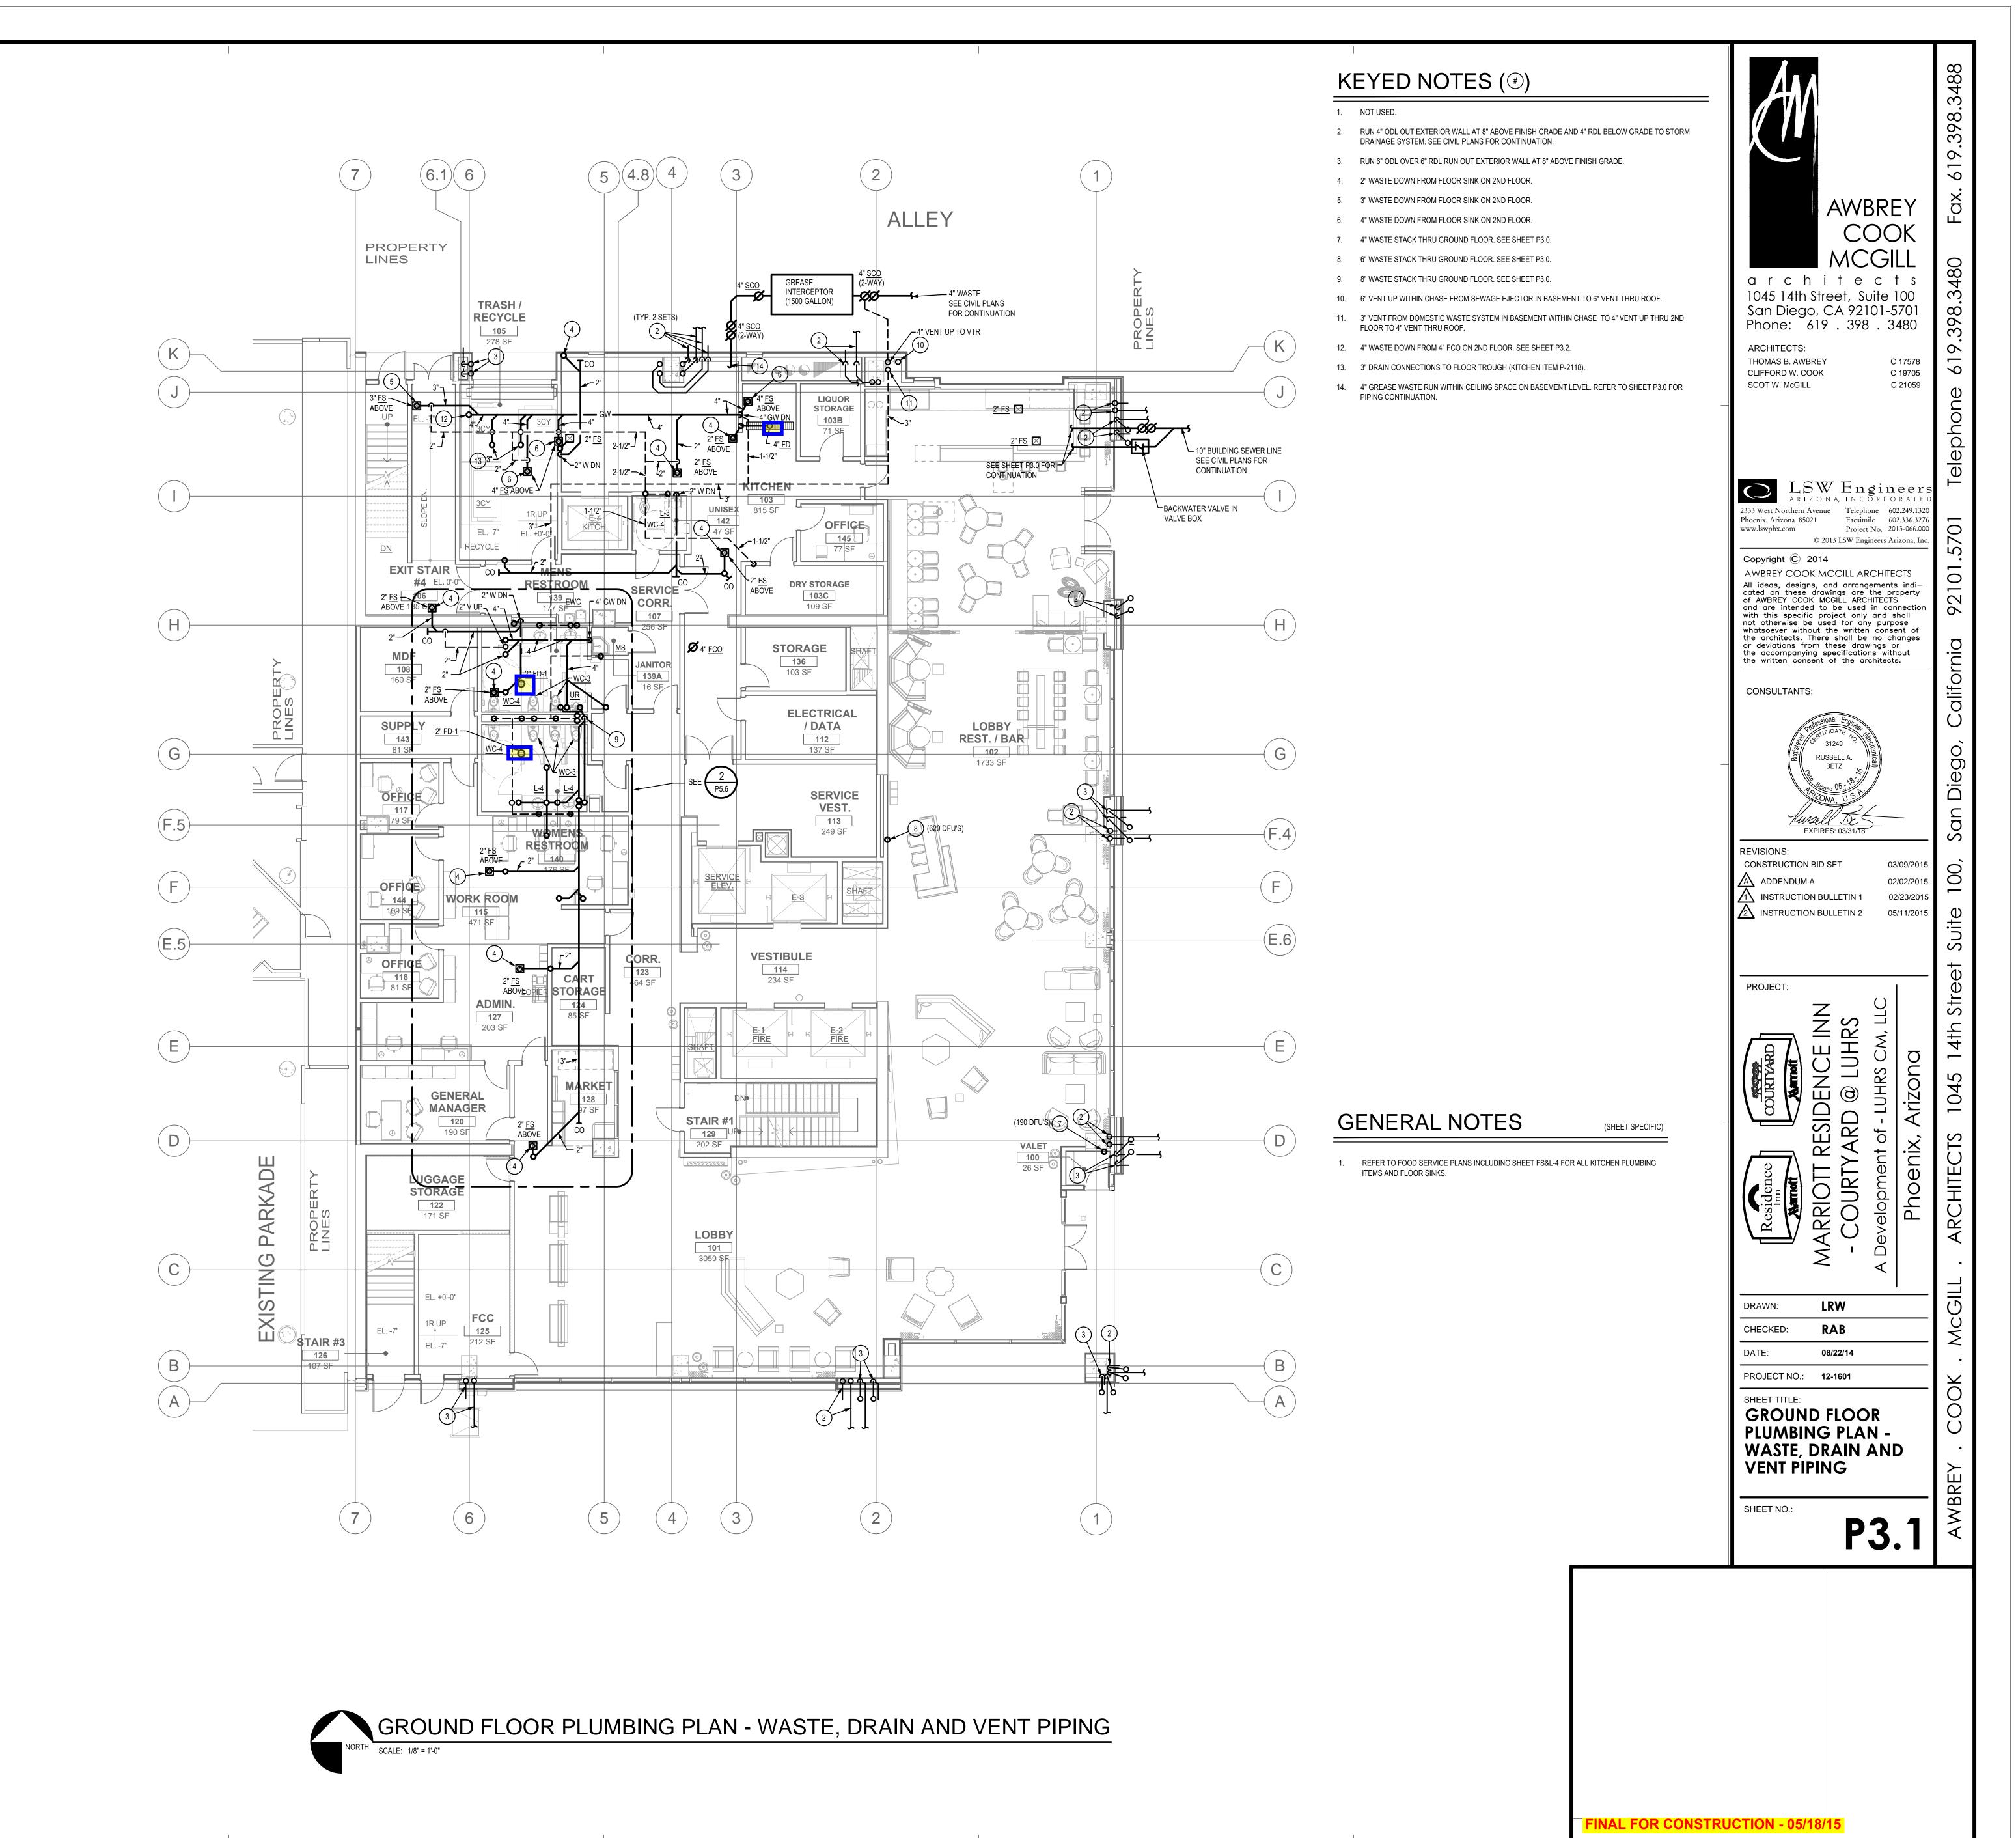

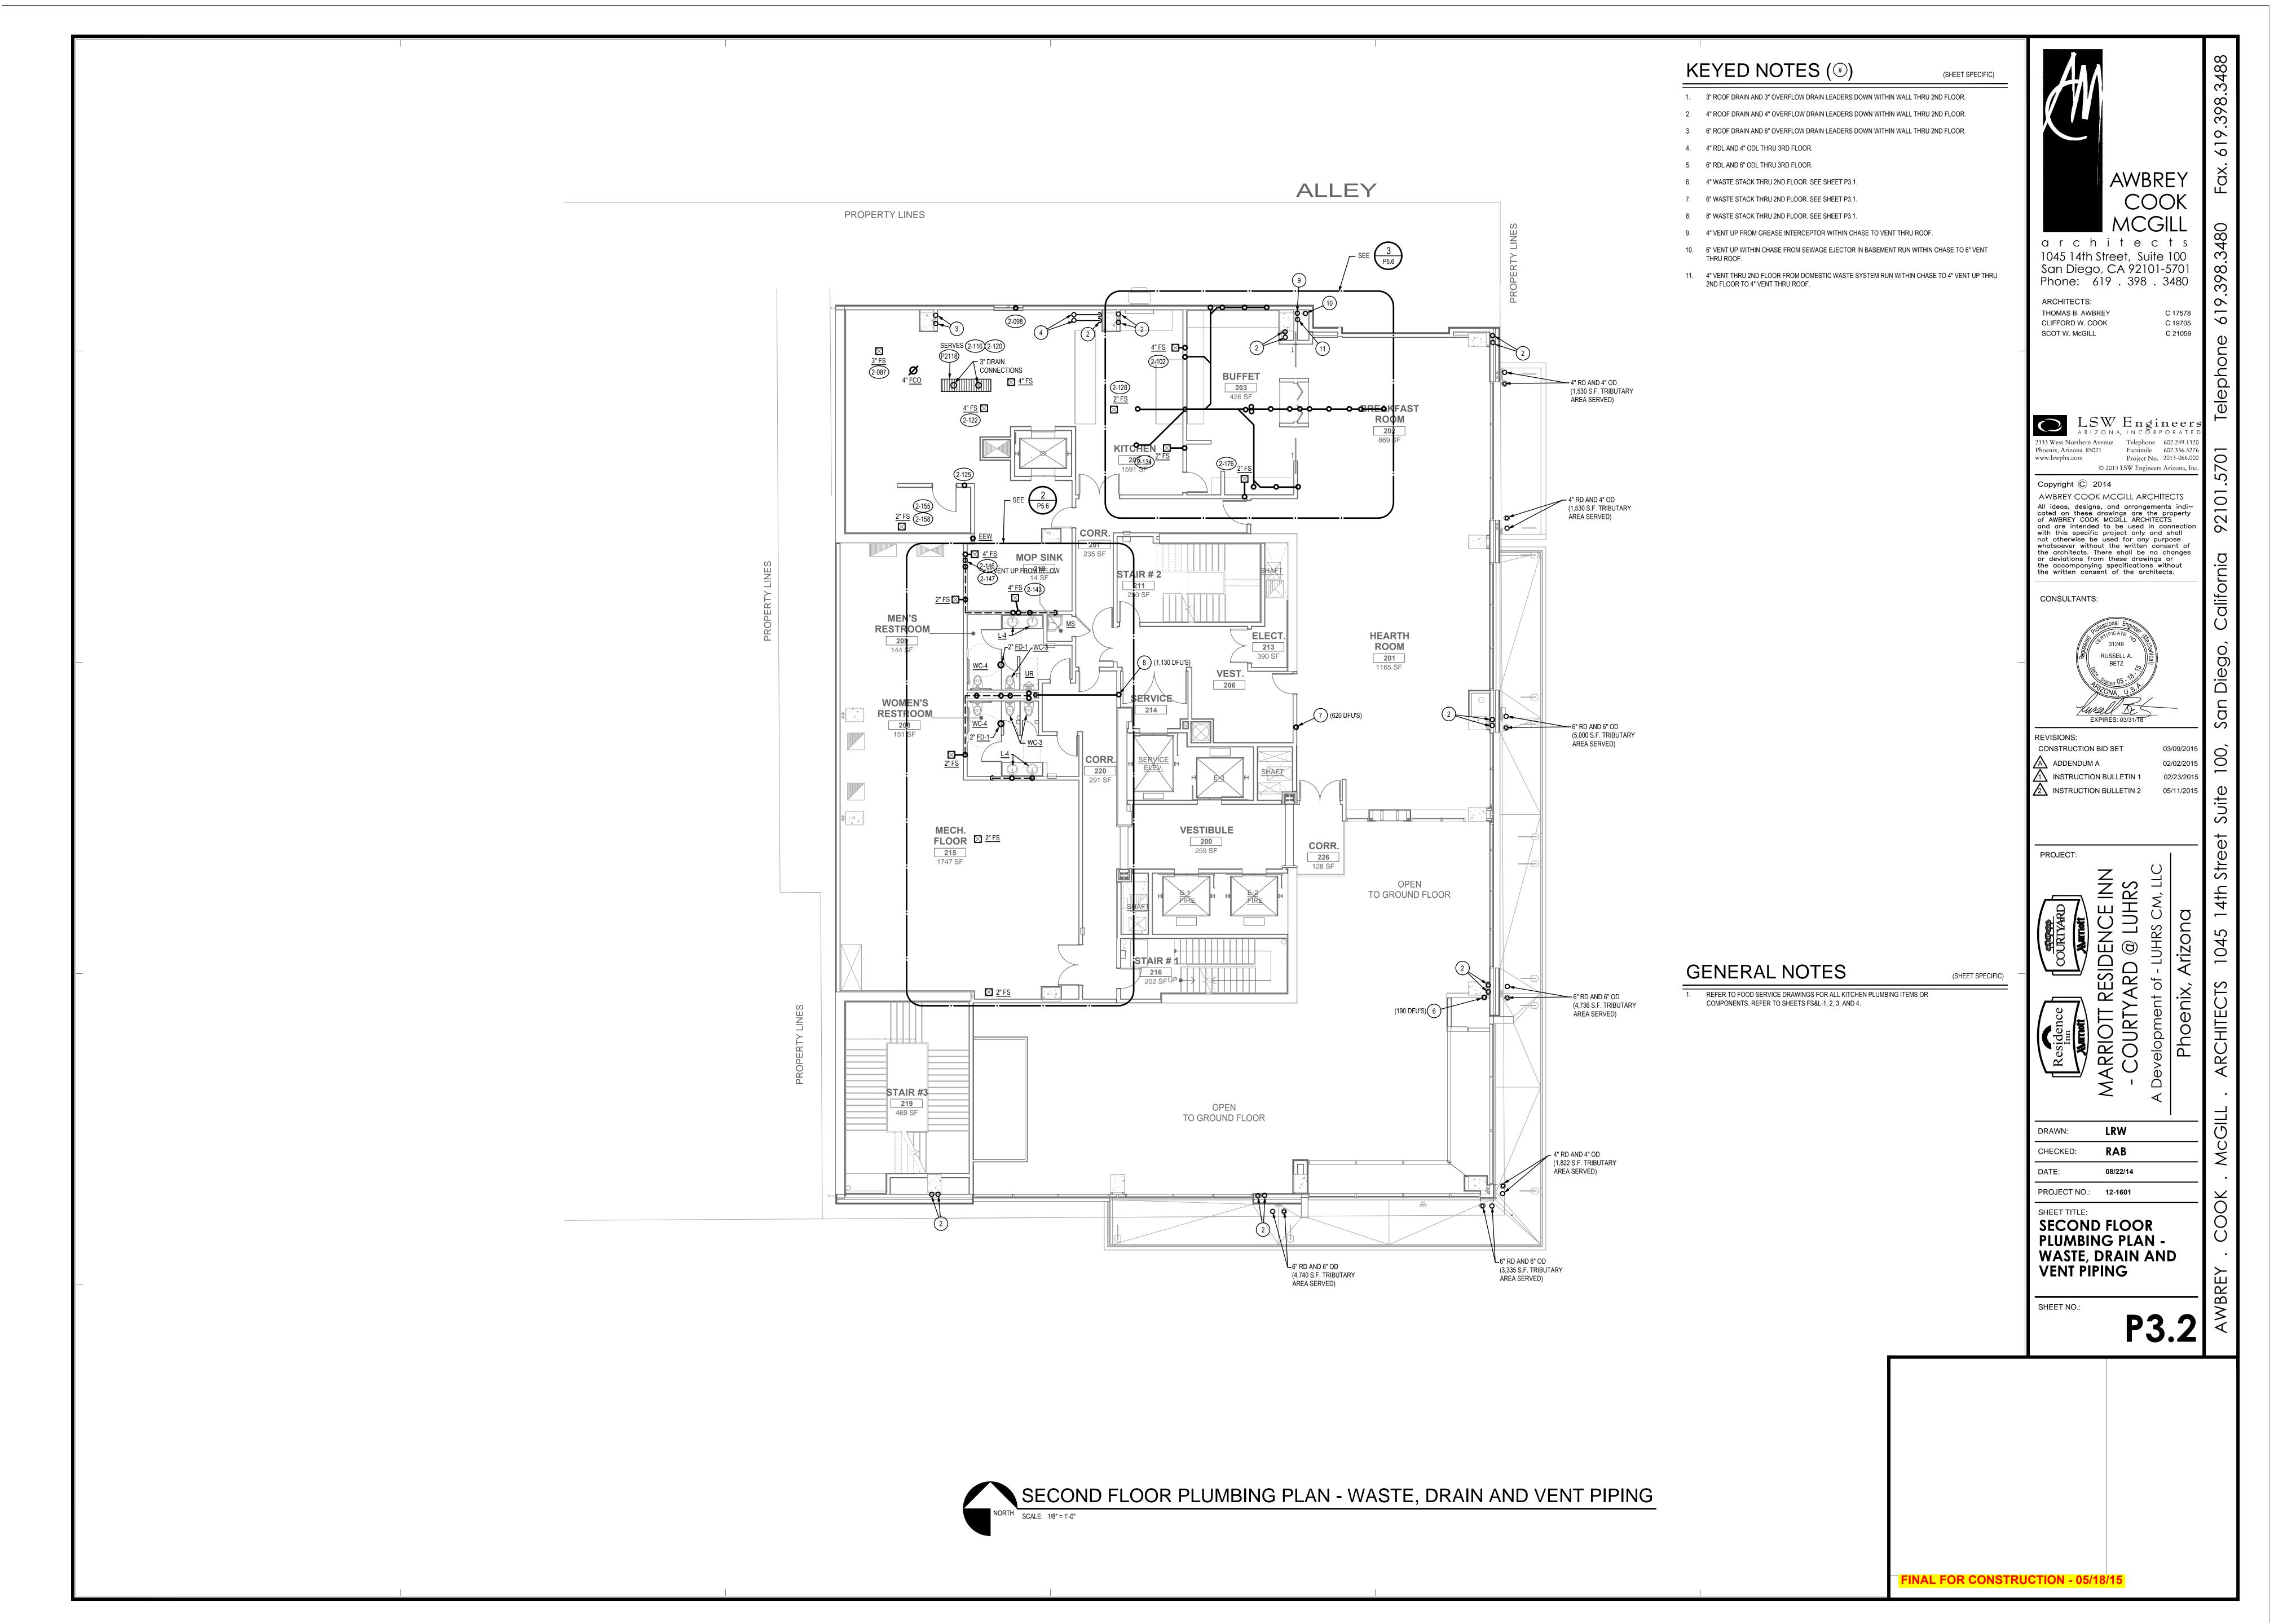

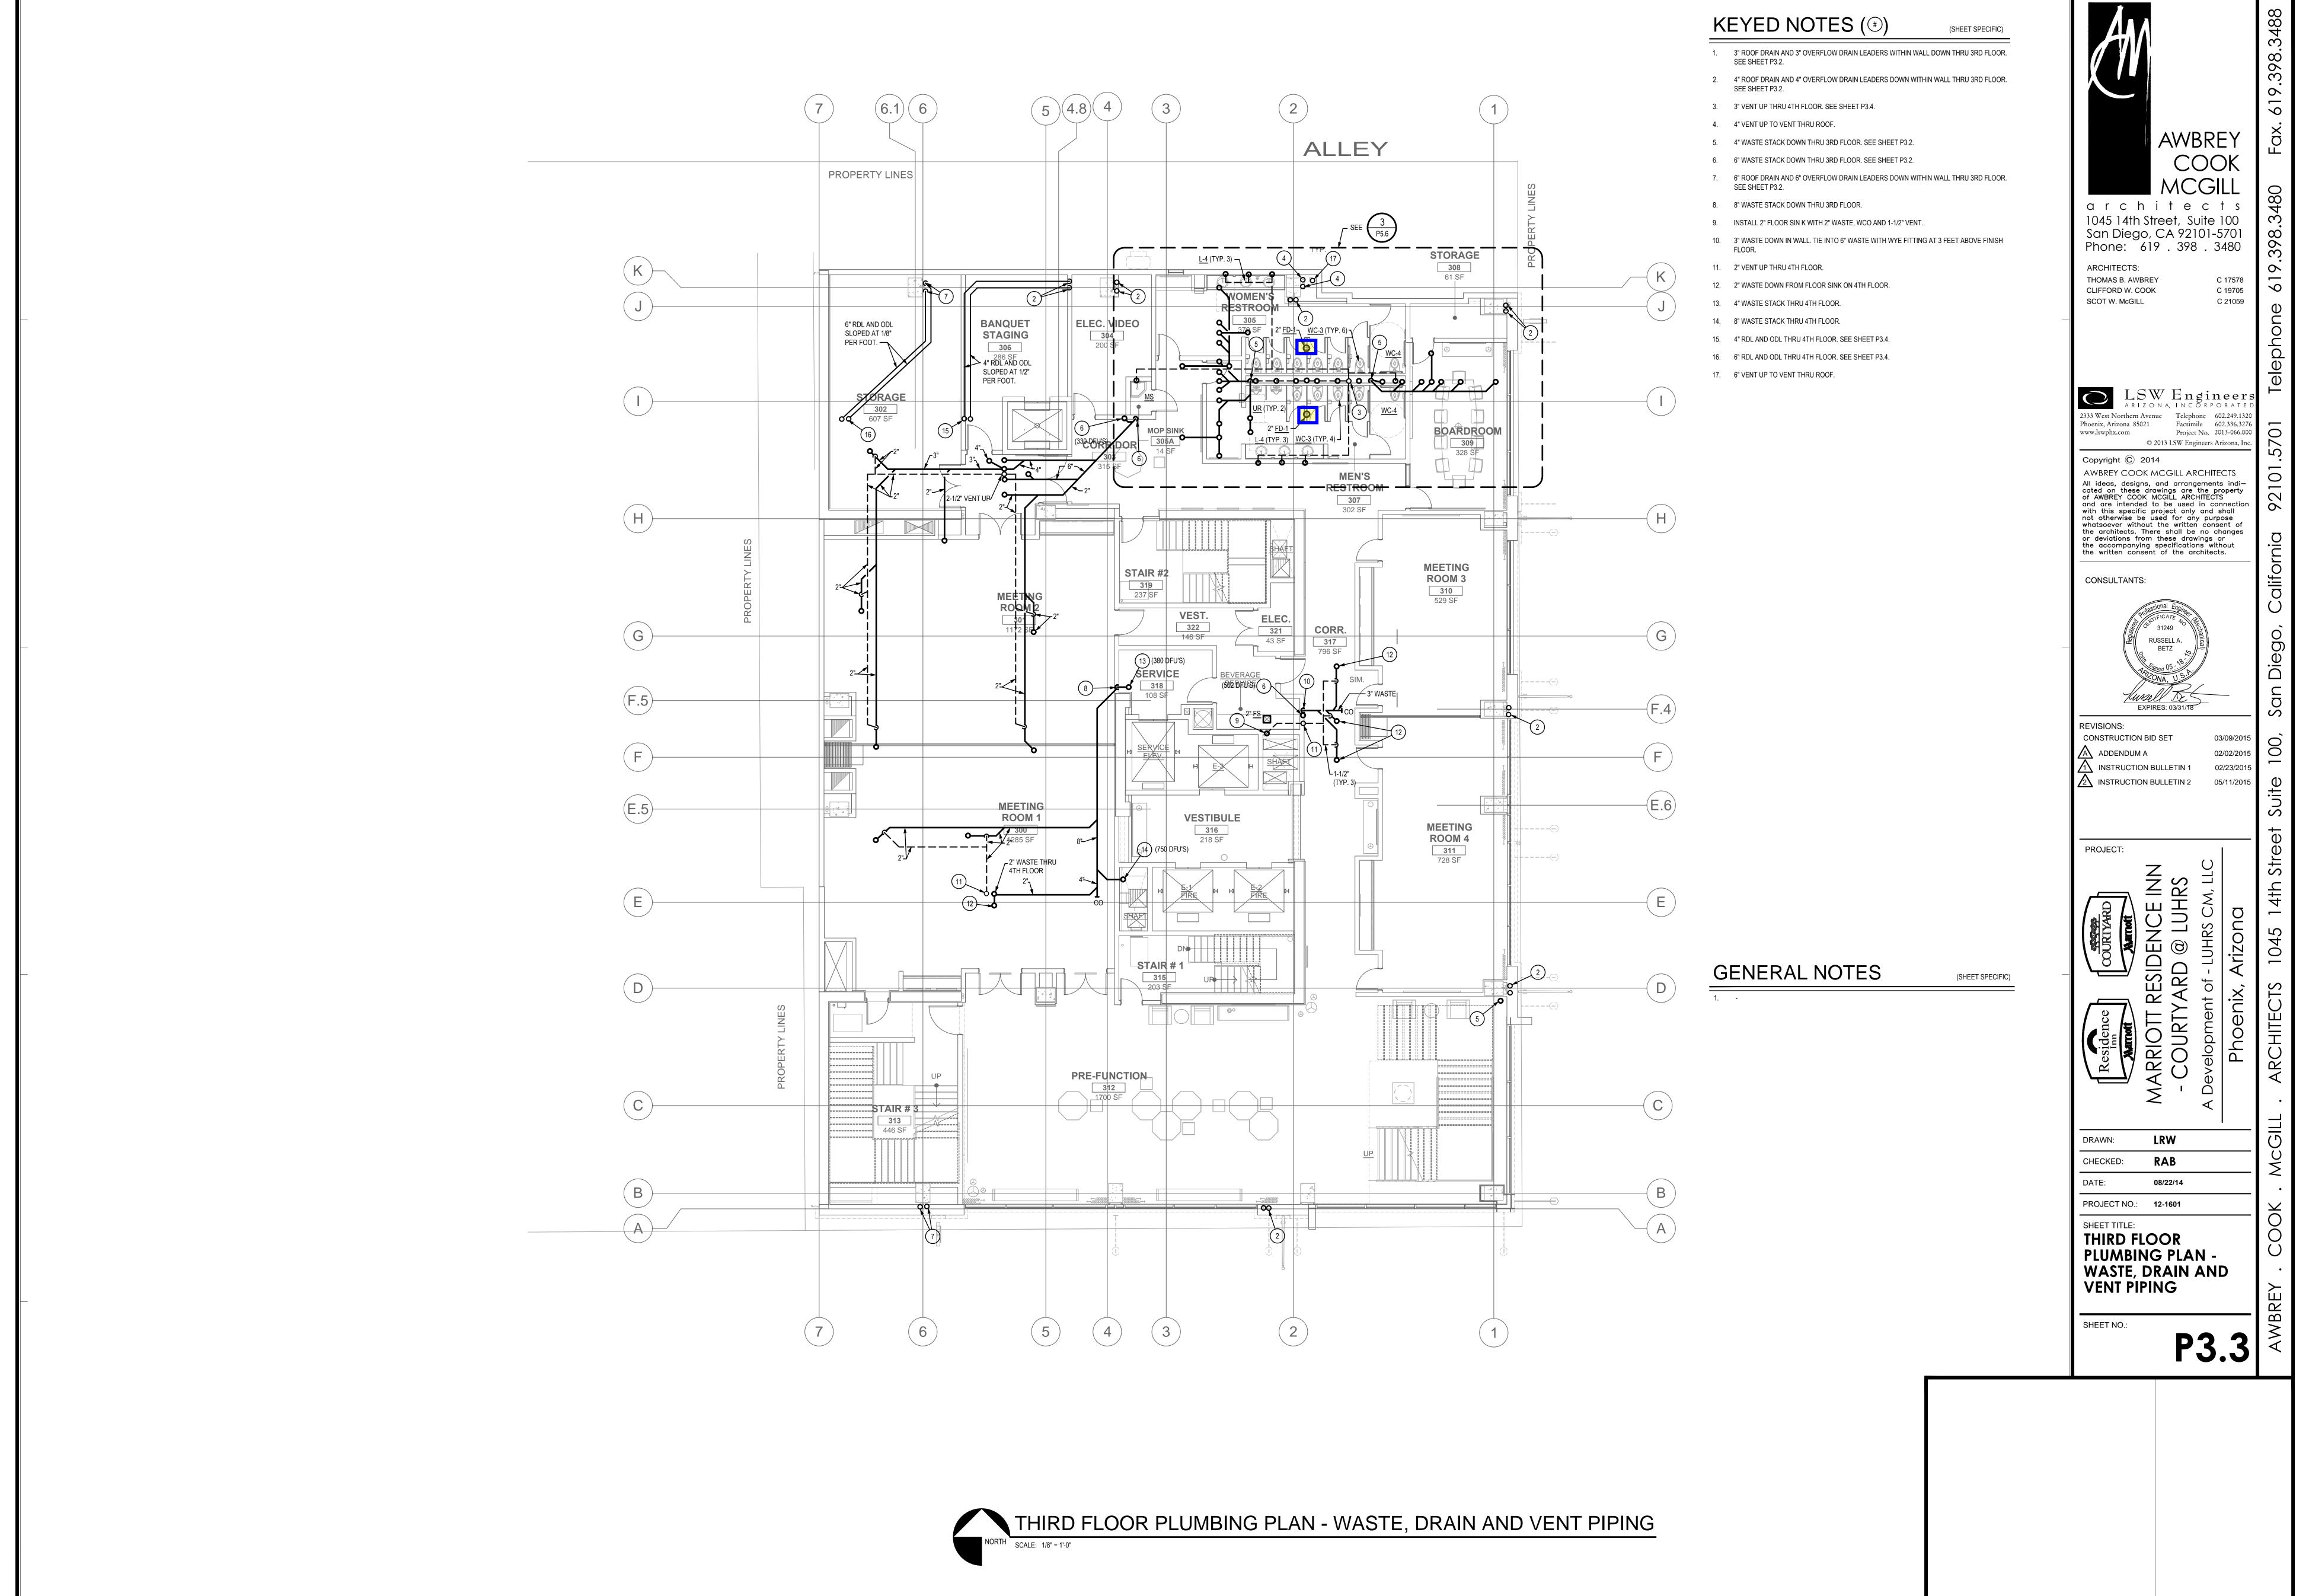

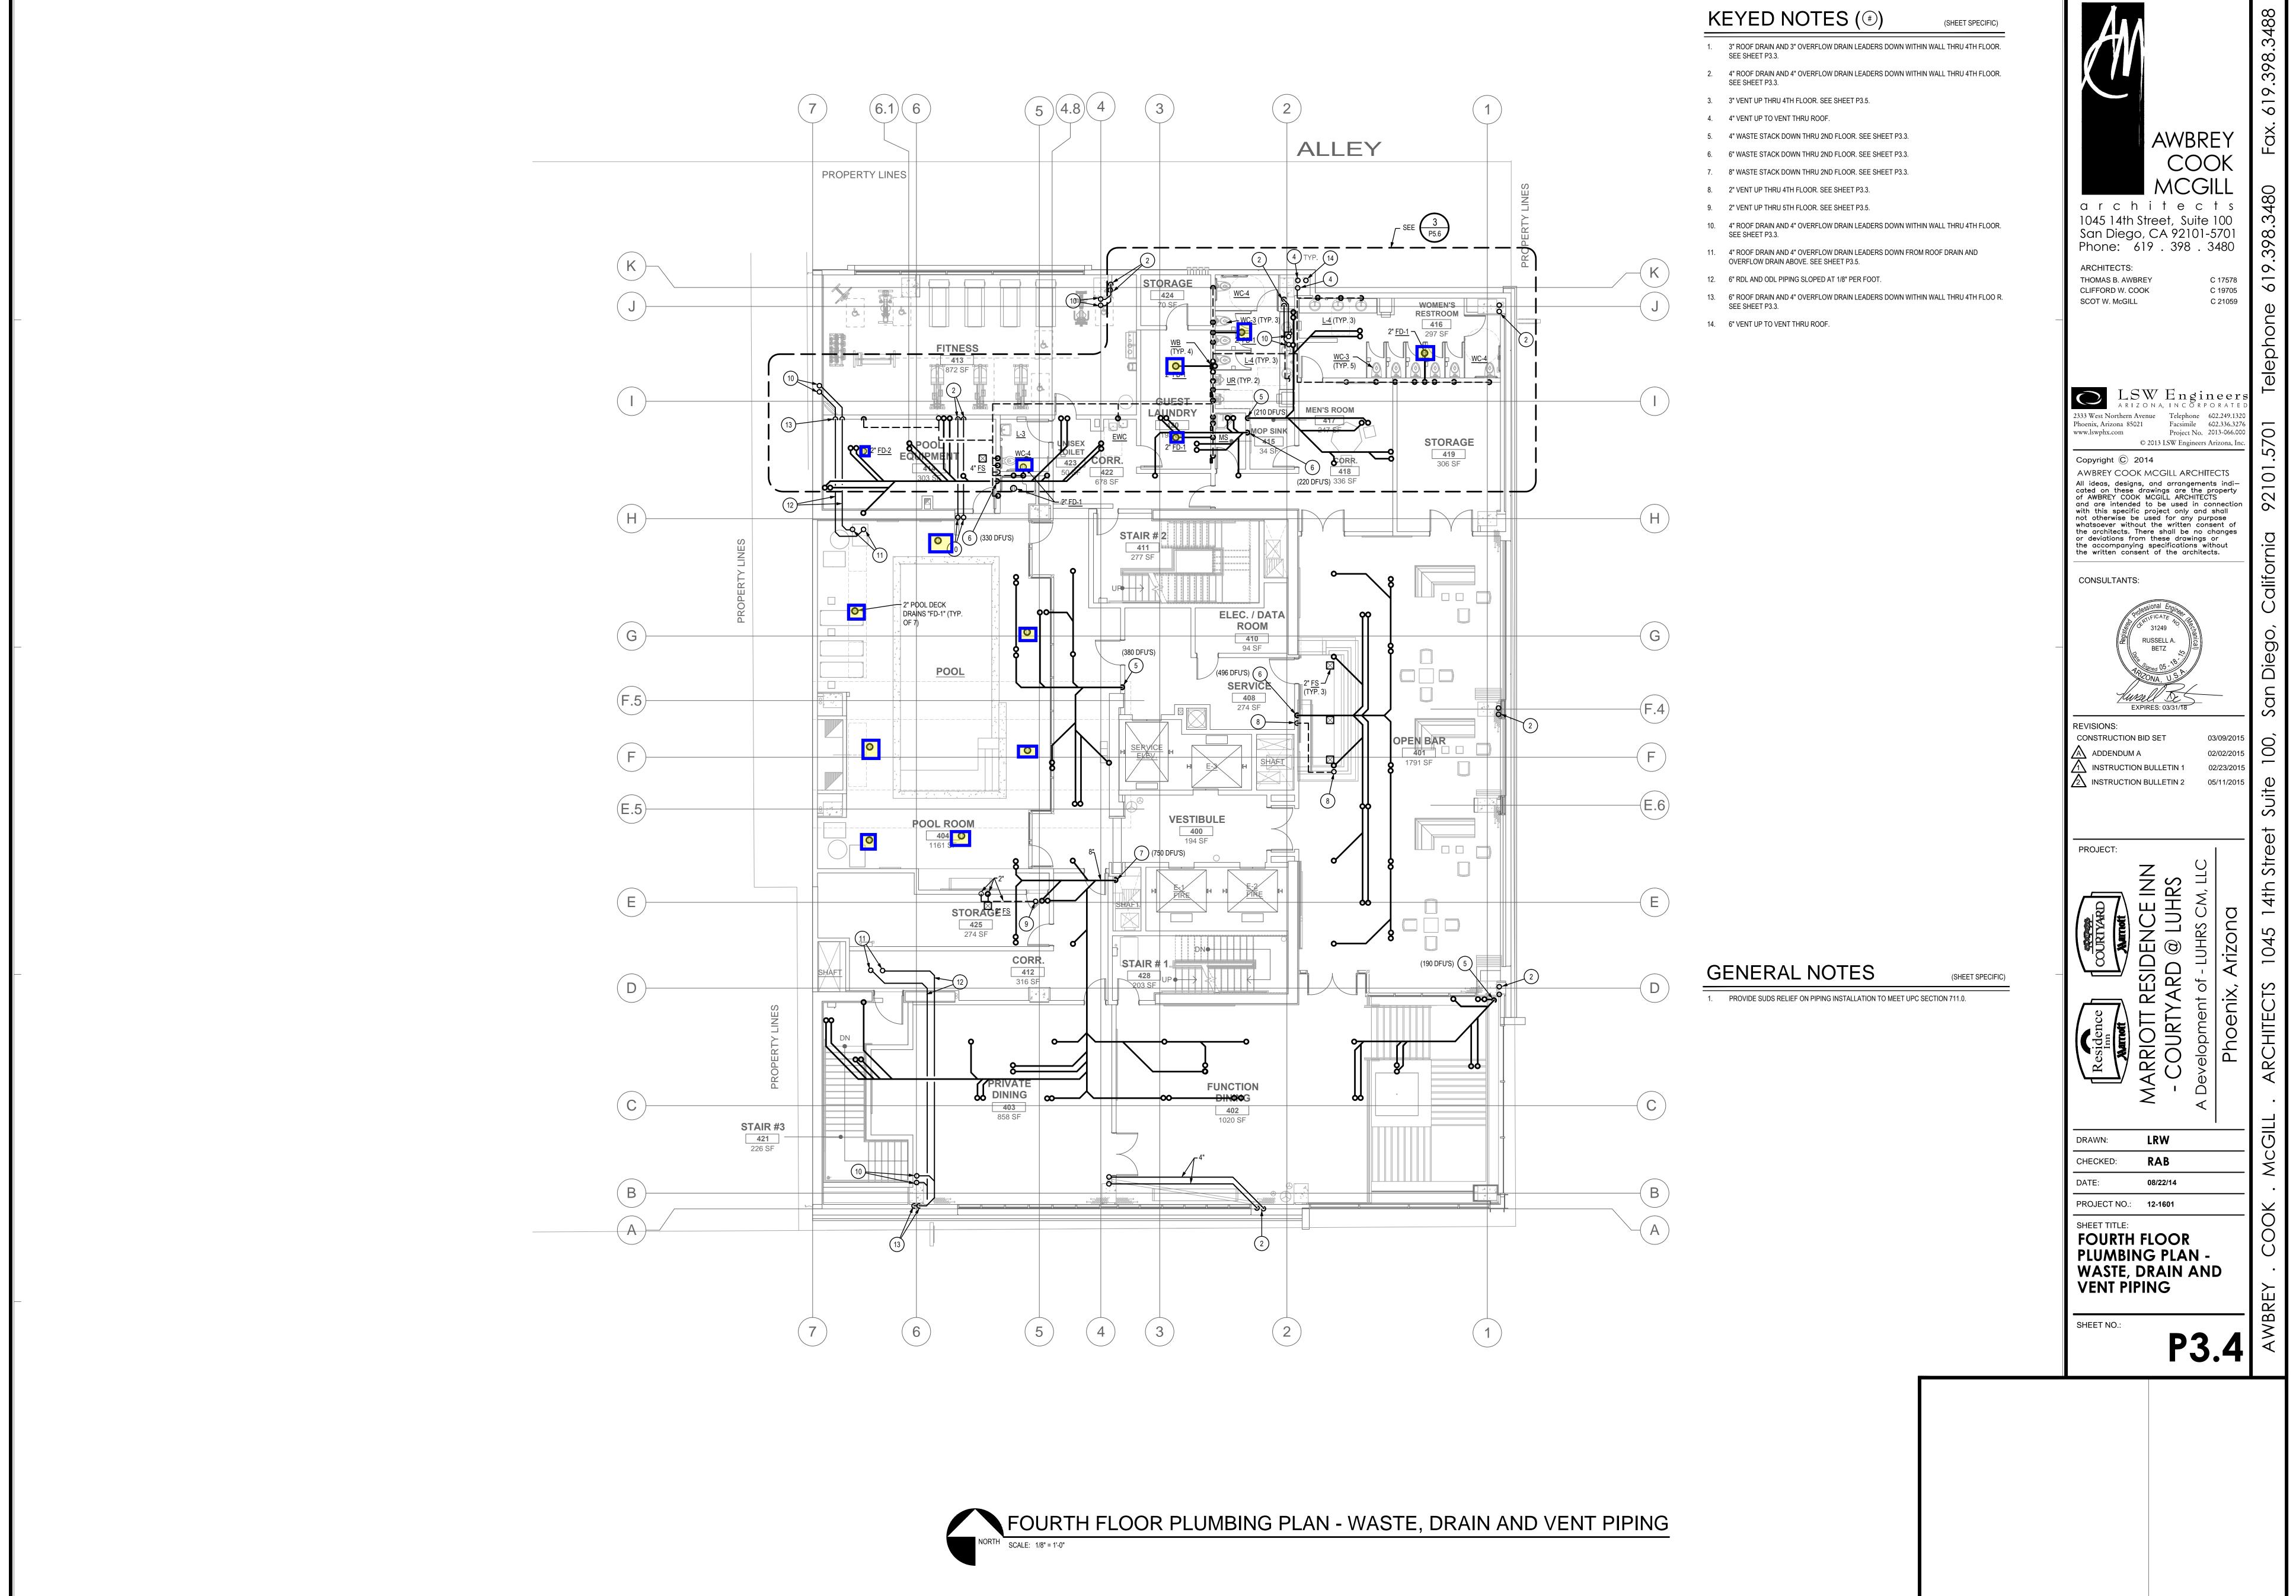

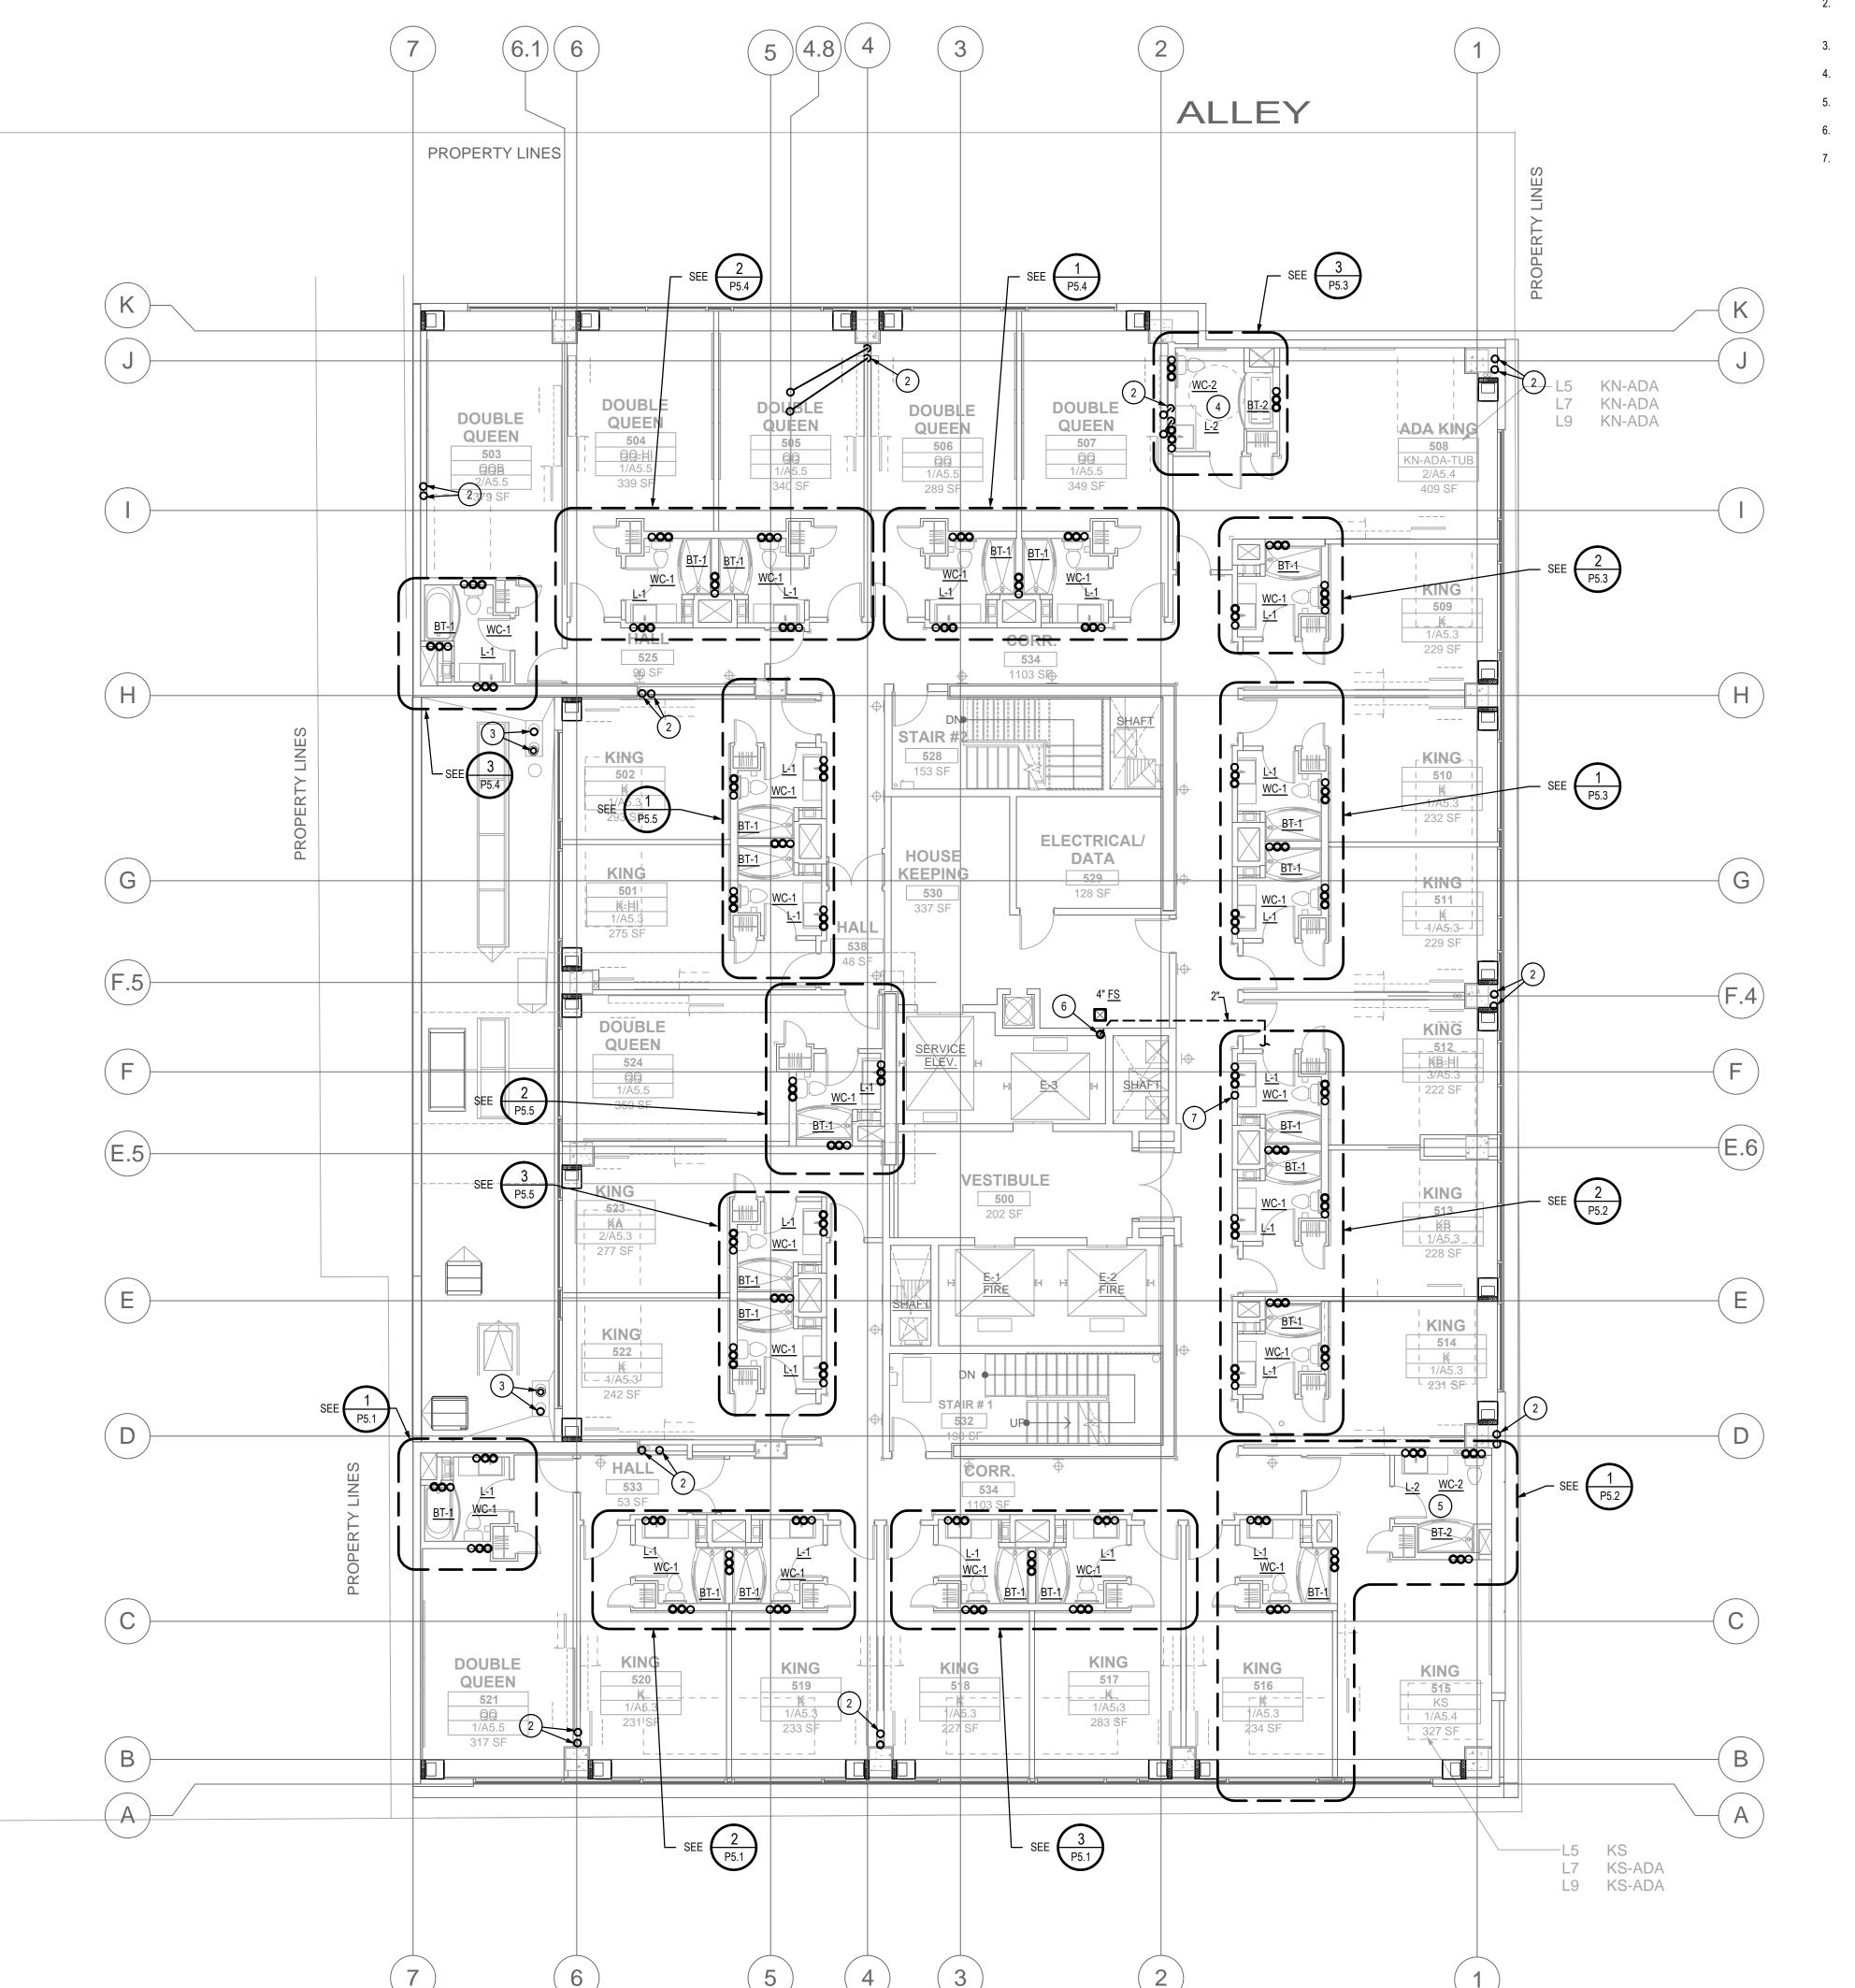

(SHEET SPECIFIC)

- 1. 3" ROOF DRAIN AND 3" OVERFLOW DRAIN LEADERS DOWN WITHIN WALL THRU FLOORS TO 4TH FLOOR. SEE SHEET P3.4.
- 2. 4" ROOF DRAIN AND 4" OVERFLOW DRAIN LEADERS DOWN WITHIN WALL THRU FLOORS TO 4TH FLOOR. SEE SHEET P3.4.
- 3. 4" RD AND 4" OD (2,875 S.F. TRIBUTARY AREA SERVED)
- 4. PROVIDE ADA TYPE PLUMBING FIXTURES FOR THIS TOILET ROOM ON FLOORS 5, 6 AND 7.
- 5. PROVIDE ADA TYPE PLUMBING FIXTURES FOR THIS TOILET ROOM ON FLOORS 7 AND 8.
- 6. INSTALL 4" FLOOR SINK WITH 4" WASTE, WCO AND 2" VENT ON FLOORS 6 AND 8.
- 7. 2" VENT UP FROM 4TH FLOOR.



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INSTRUCTION BULLETIN 2

BULLETIN 1 02/23 BULLETIN 2 05/11

PROJECT:

ESIDENCE INN ARD @ LUHRS



DRAWN: LRW

CHECKED: RAB

DATE: 08/22/14


ROJECT NO.: 12-1601

FIFTH THRU EIGHTH
FLOORS - PLUMBING
PLAN - WASTE, DRAIN
AND VENT PIPING


HEET NO.:

P3.5

FIFTH THRU EIGHTH FLOOR PLUMBING PLAN - WASTE, DRAIN AND VENT PIPING
SCALE: 1/8" = 1'-0"

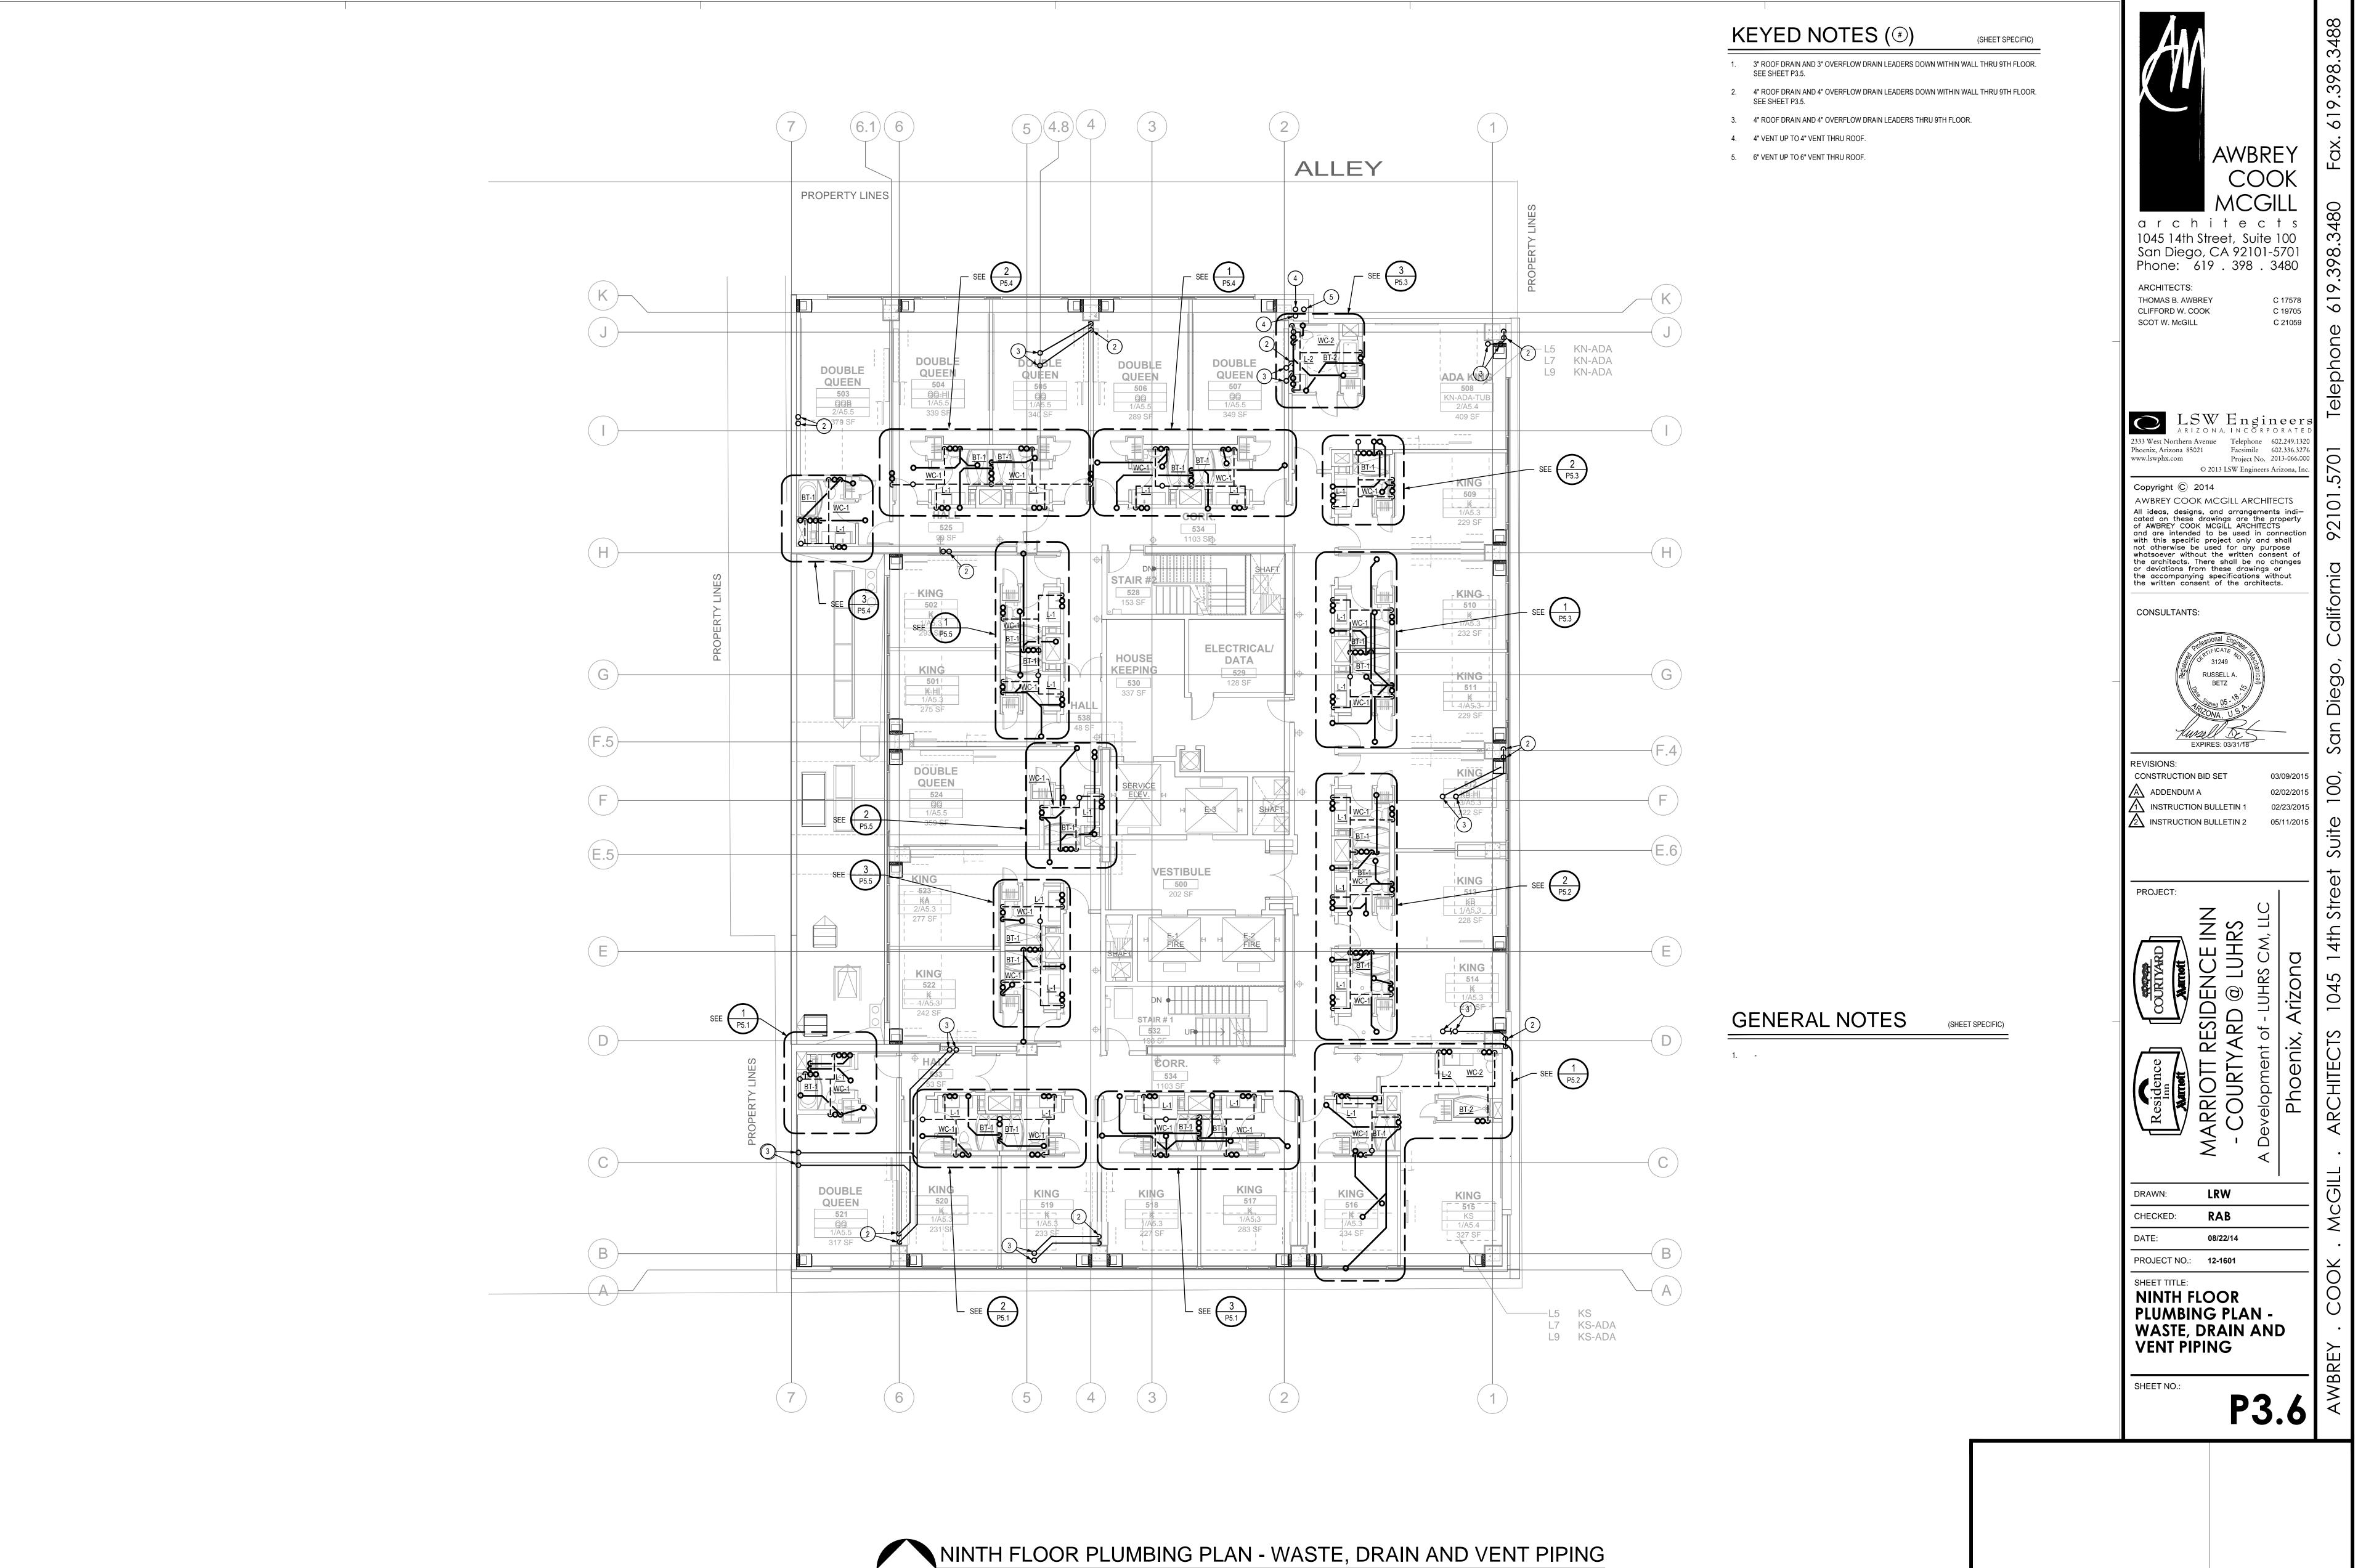

NORTH SCALE: 1/8" = 1'-0"

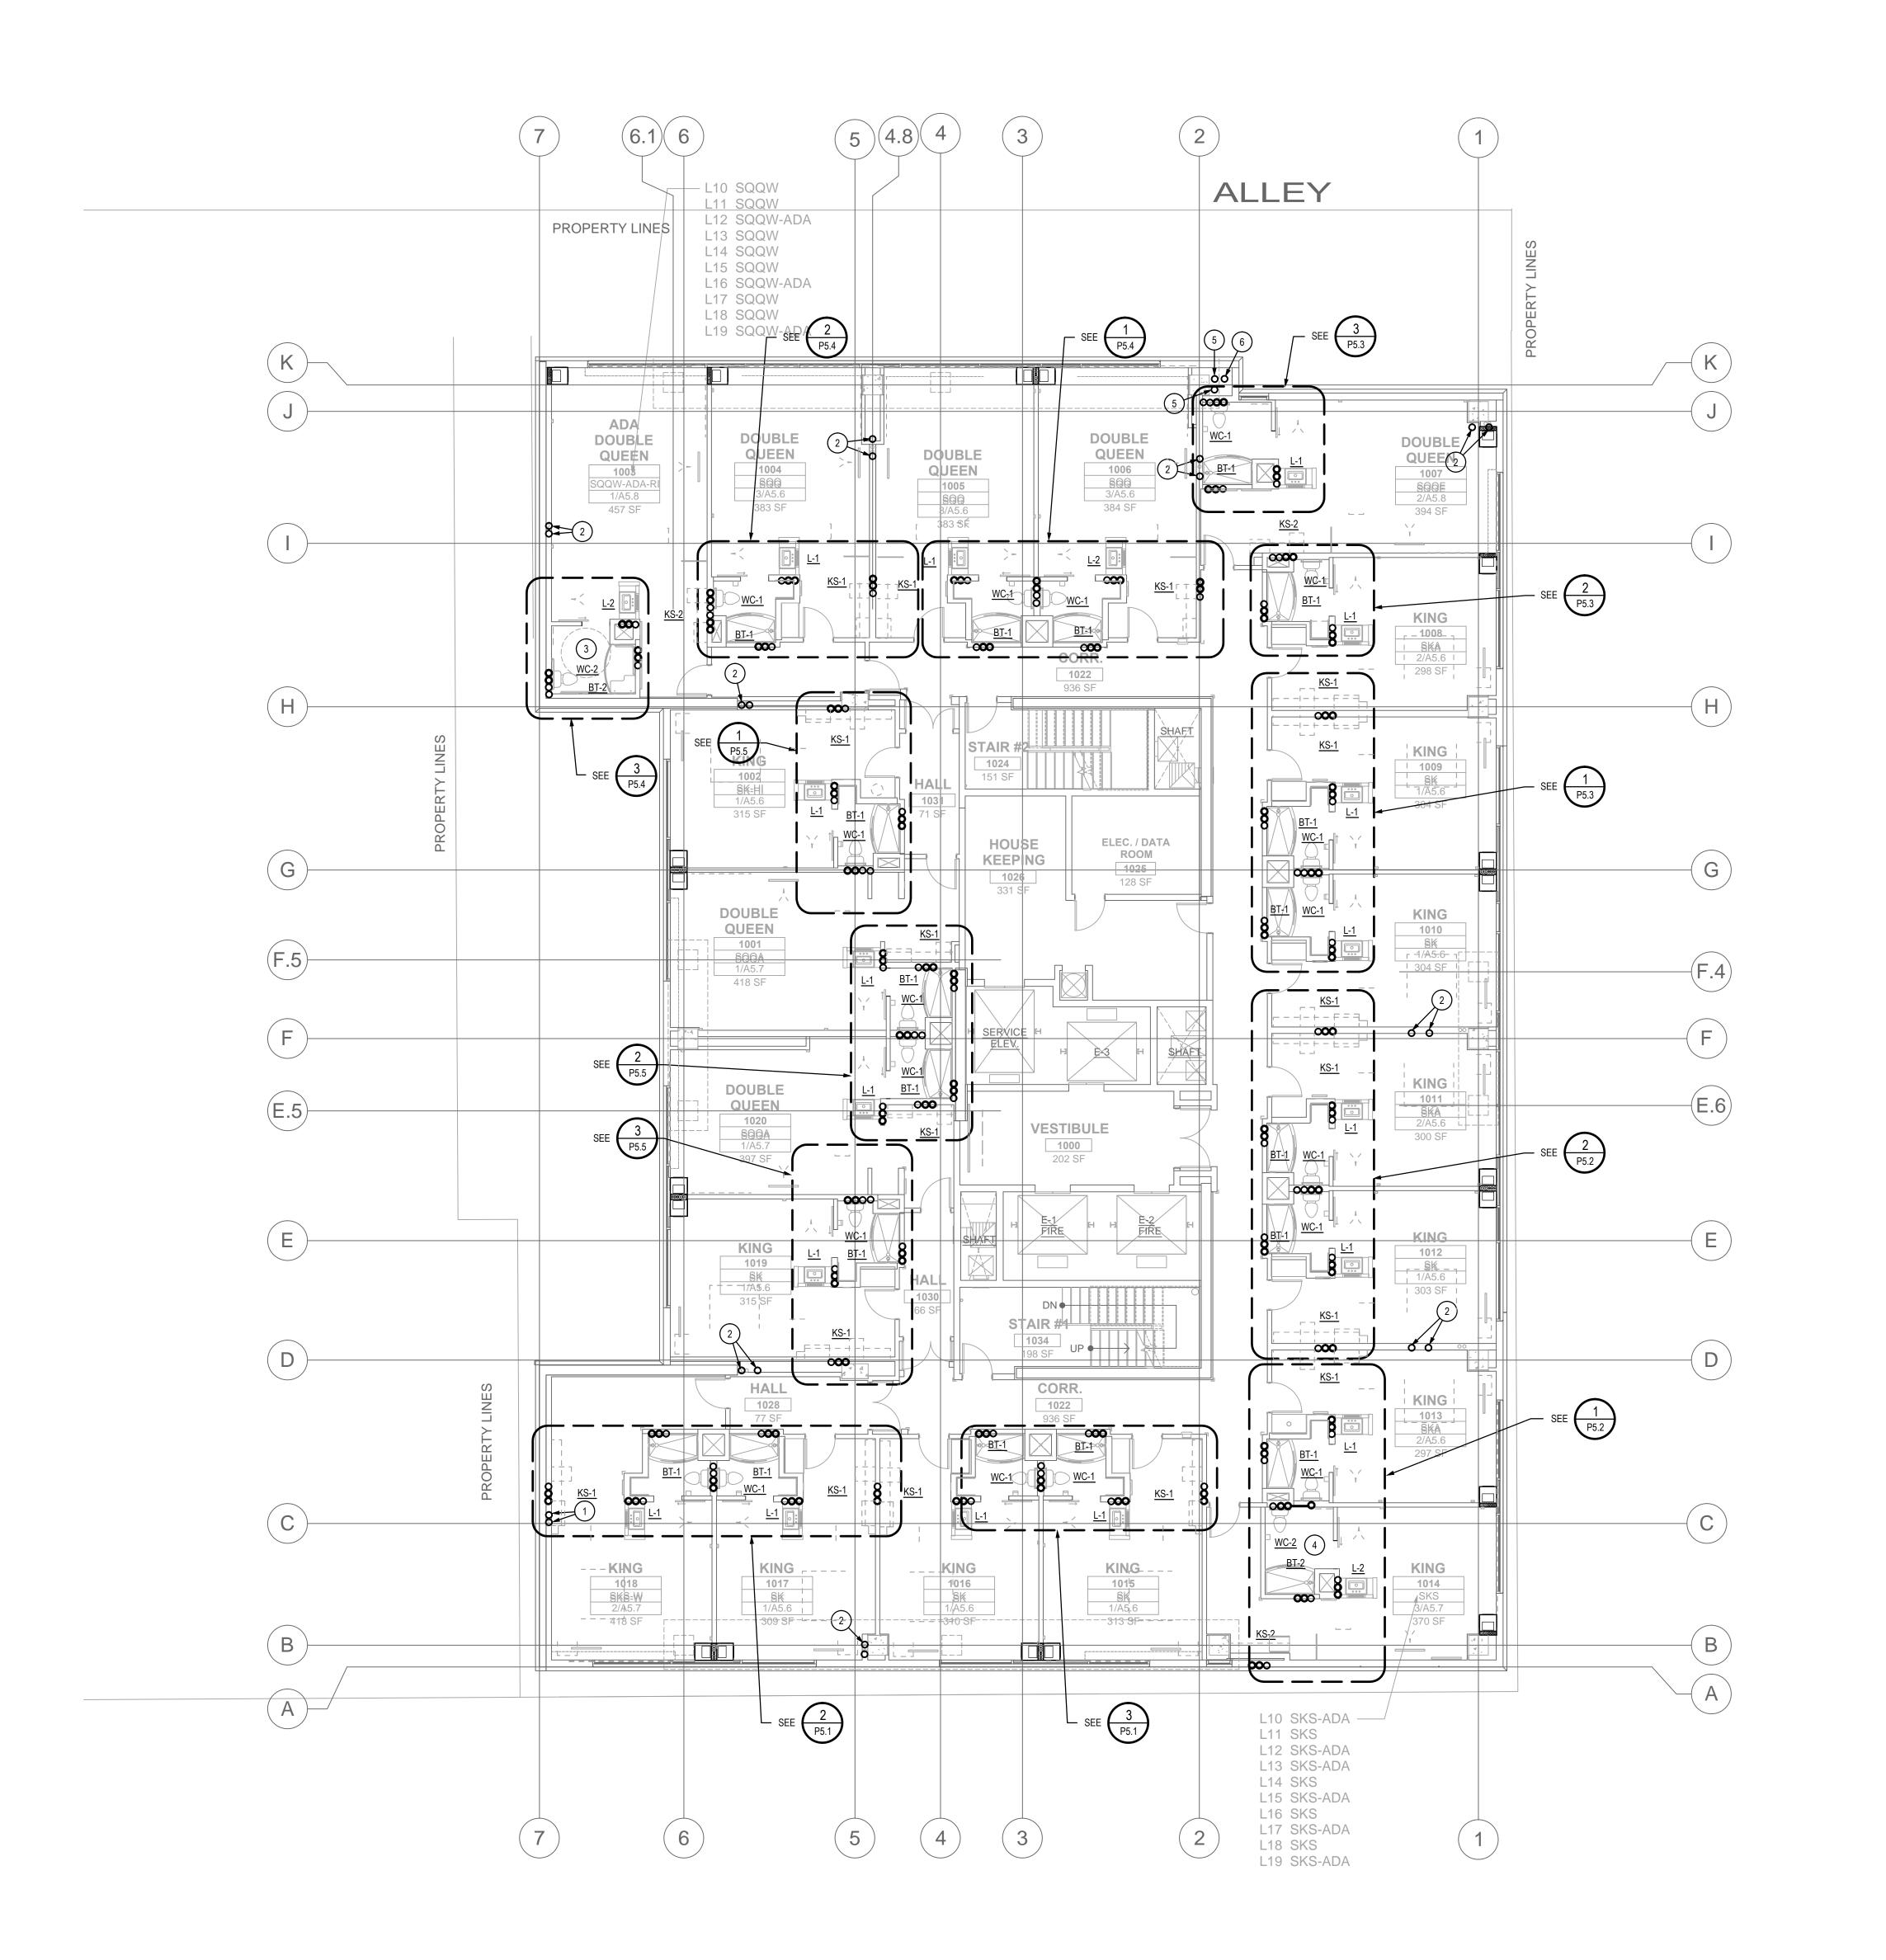

(SHEET SPECIFIC)

- 1. NEW 3" ROOF DRAIN AND 3" OVERFLOW DRAIN DOWN WITHIN WALL.
- 2. NEW 4" ROOF DRAIN AND 4" OVERFLOW DRAIN DOWN WITHIN WALL.
- 3. PROVIDE ADA TYPE PLUMBING FIXTURES FOR THIS TOILET ROOM ON FLOORS 12, 16 AND 16.
- 4. PROVIDE ADA TYPE PLUMBING FIXTURES FOR THIS TOILET ROOM ON FLOORS 10, 12, 13, 15, 17 AND 19.
- 5. 4" VENT UP TO 4" VENT THRU ROOF.
- 6. 6" VENT UP TO 6" VENT THRU ROOF.

GENERAL NOTES

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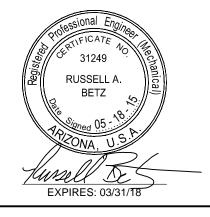
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CONSULTANTS:



REVISIONS:

CONSTRUCTION BID SET

A ADDENDUM A

INSTRUCTION BULLETIN 1

INSTRUCTION BULLETIN 2

PROJECT:

IOTT RESIDENCE IN URTYARD @ LUHRS CM, I Arizona

DRAWN: LRW
CHECKED: RAB

OJECT NO.: 12-1601


TENTH THRU
EIGHTEENTH FLOORS
PLUMBING PLAN WASTE, DRAIN AND
VENT PIPING

SHEET NO.:

P3.7

TENTH THRU EIGHTEENTH FLOOR PLUMBING PLAN - WASTE, DRAIN AND VENT PIPING

SCALE: 1/8" = 1'-0"

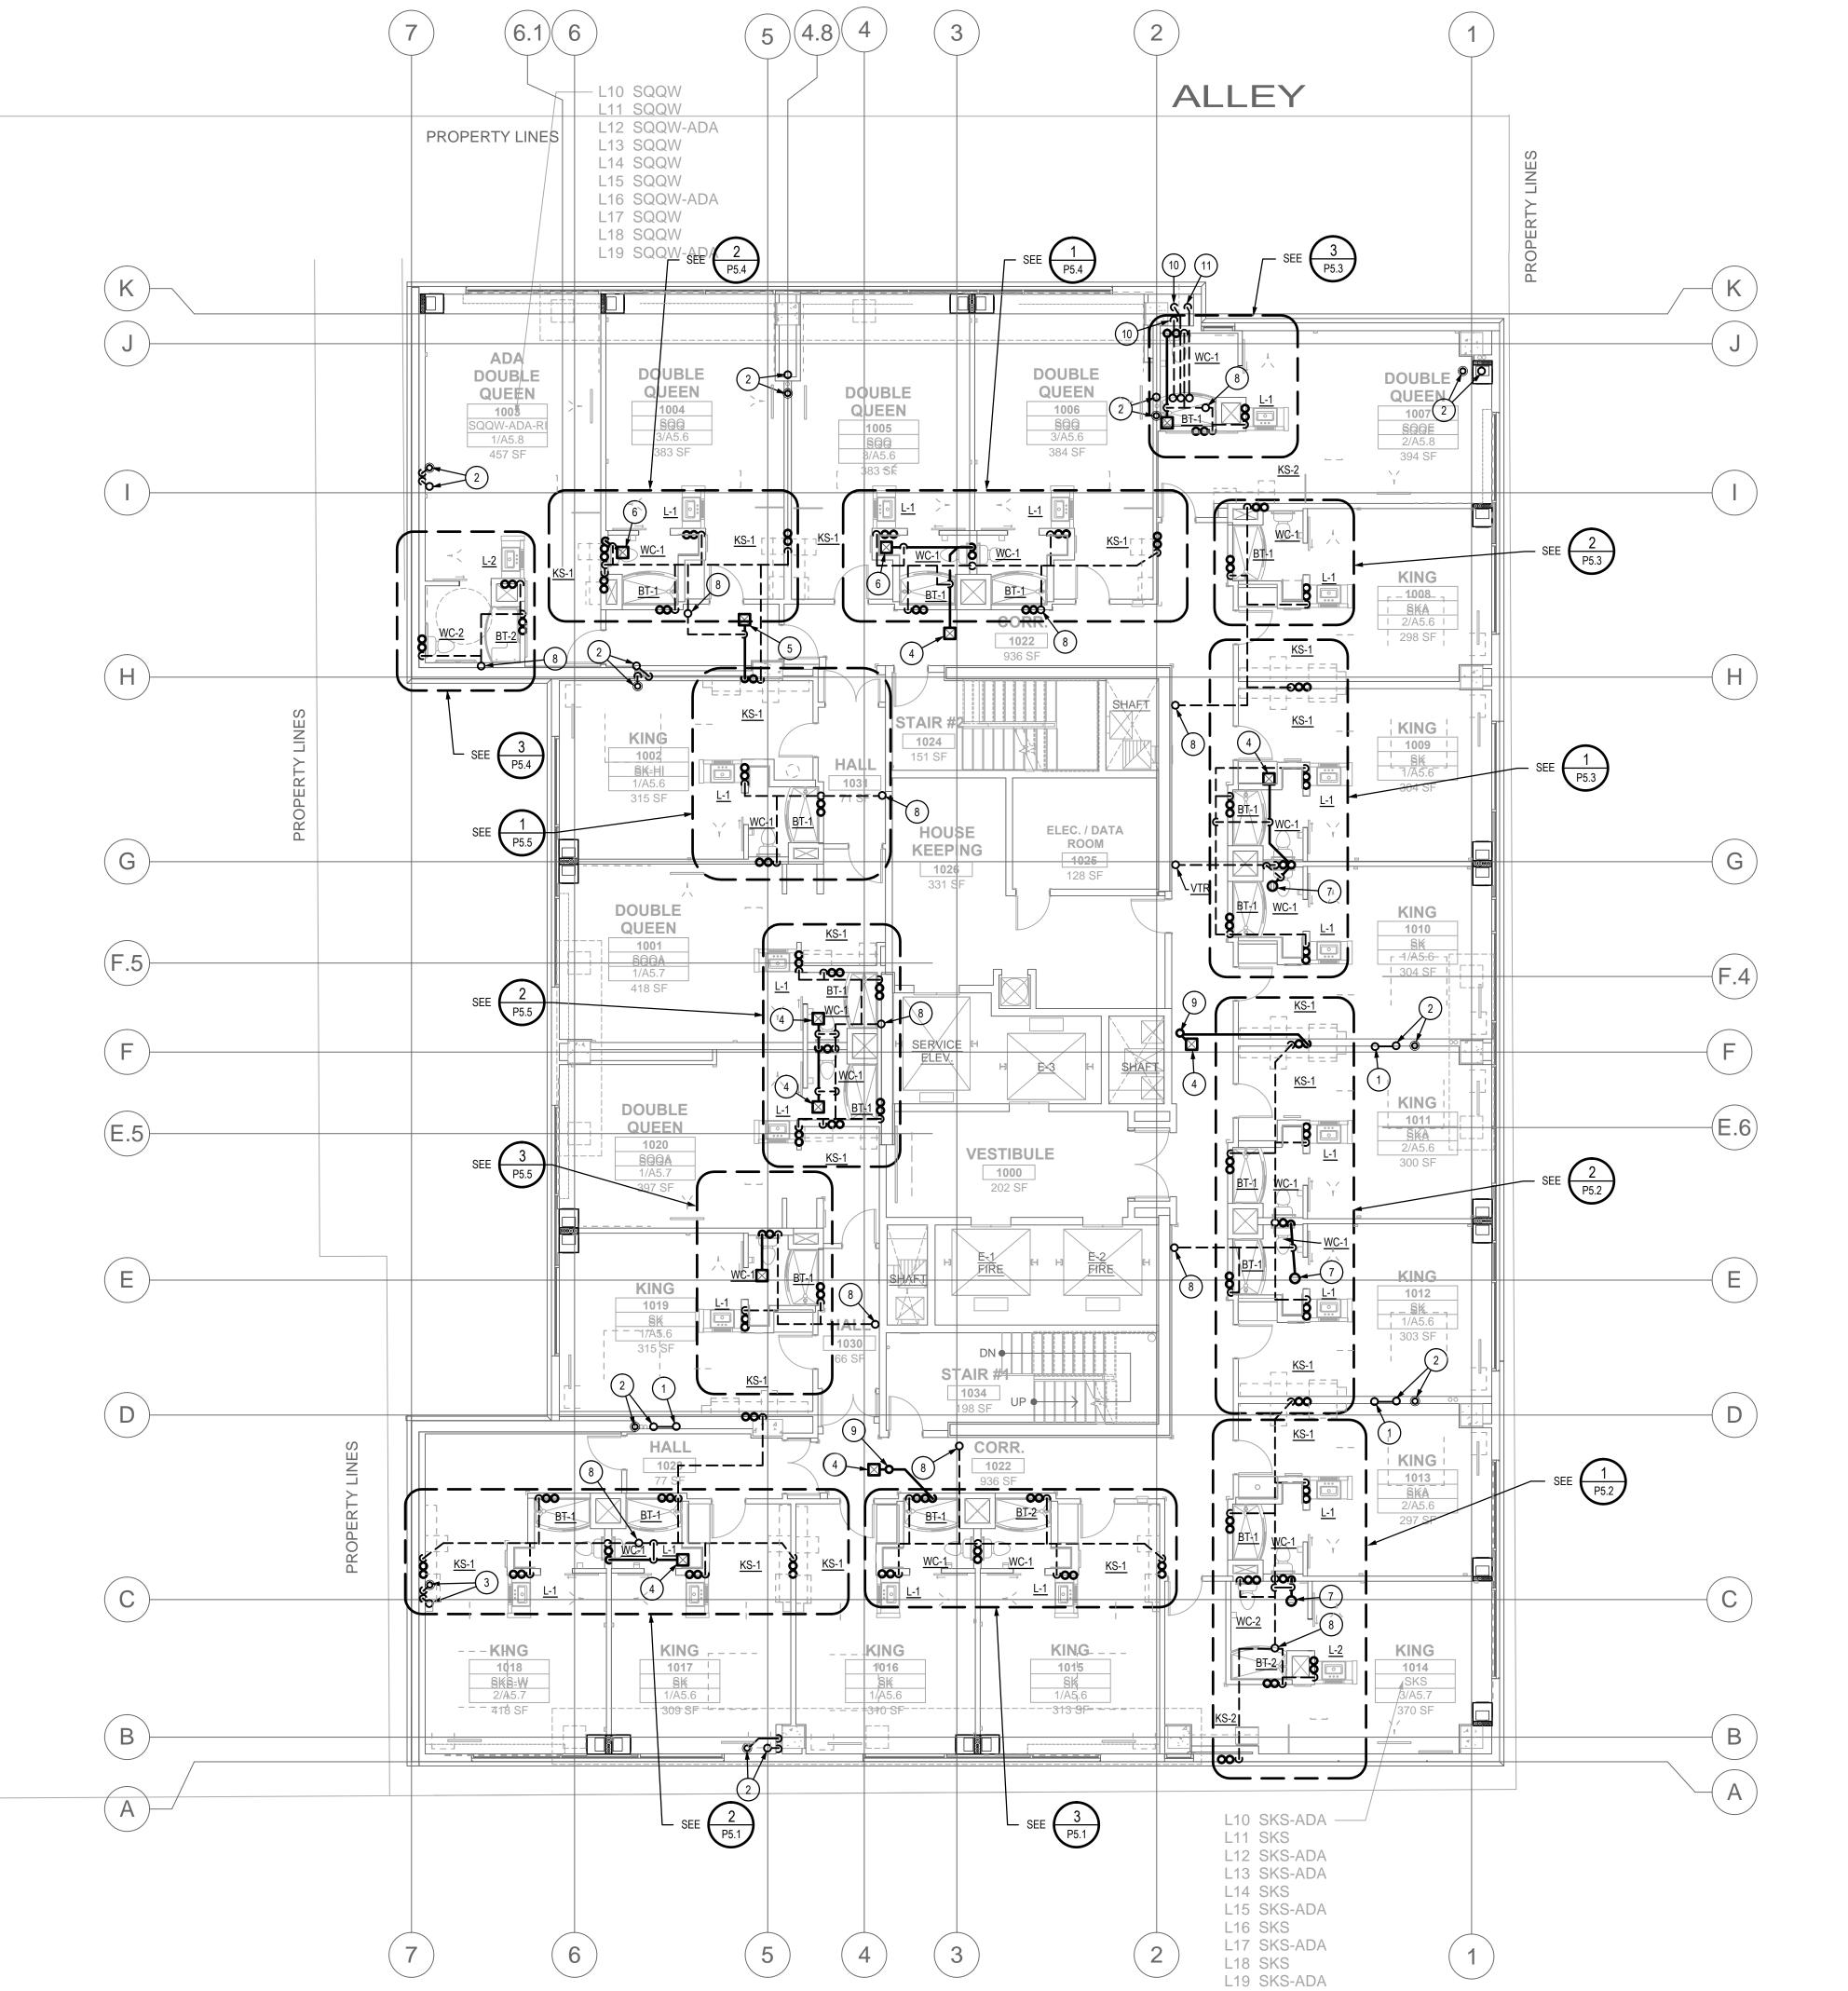

(SHEET SPECIFIC)

RUN ROVERFLOW DRAIN LEADER DOWN THRU PENTHOUSE FLOOR AND COMBINE TOGETHER TO OTHER OVERFLOW DRAIN WITH WYE FITTING AFTER 6 FOOT VERTICAL DROP WITHIN WALL.

2. NEW 4" ROOF DRAIN AND 4" OVERFLOW DRAIN DOWN WITHIN WALL THRU 19TH FLOOR. SEE SHEET P3.7.

NOT USED.

4. NEW 2" WASTE THRU PENTHOUSE LEVEL FROM FLOOR SINK. SEE SHEET P3.9.

5. NEW 3" WASTE THRU PENTHOUSE LEVEL FROM FLOOR SINK. SEE SHEET P3.9.

6. NEW 4" WASTE THRU PENTHOUSE LEVEL FROM FLOOR SINK. SEE SHEET P3.9.

7. NEW 2" WASTE THRU PENTHOUSE LEVEL FROM FLOOR DRAIN. SEE SHEET P3.9. 8. NEW 4" VTR. SEE SHEET P3.9.

GENERAL NOTES

ALL ROOF DRAIN AND OVERFLOW DRAIN PIPING AREAS INCLUDE TRIBUTARY VERTICAL WALL AREAS IN SQUARE FEET INDICATED ON THE ROOF PLAN. SEE SHEET P3.10.

SLOPE ALL HORIZONTAL ROOF DRAINAGE PIPING AT 1/4" PER FOOT UNLESS NOTED OTHERWISE.

9. NEW 2" WASTE WITH WCO IN PENTHOUSE AND 2" VTR. SEE SHEET P3.9.

11. 6" VENT UP TO 6" VTR.

10. 4" VENT UP TO 4" VTR.

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CONSULTANTS:



CONSTRUCTION BID SET A ADDENDUM A 1 INSTRUCTION BULLETIN 1 2 INSTRUCTION BULLETIN 2


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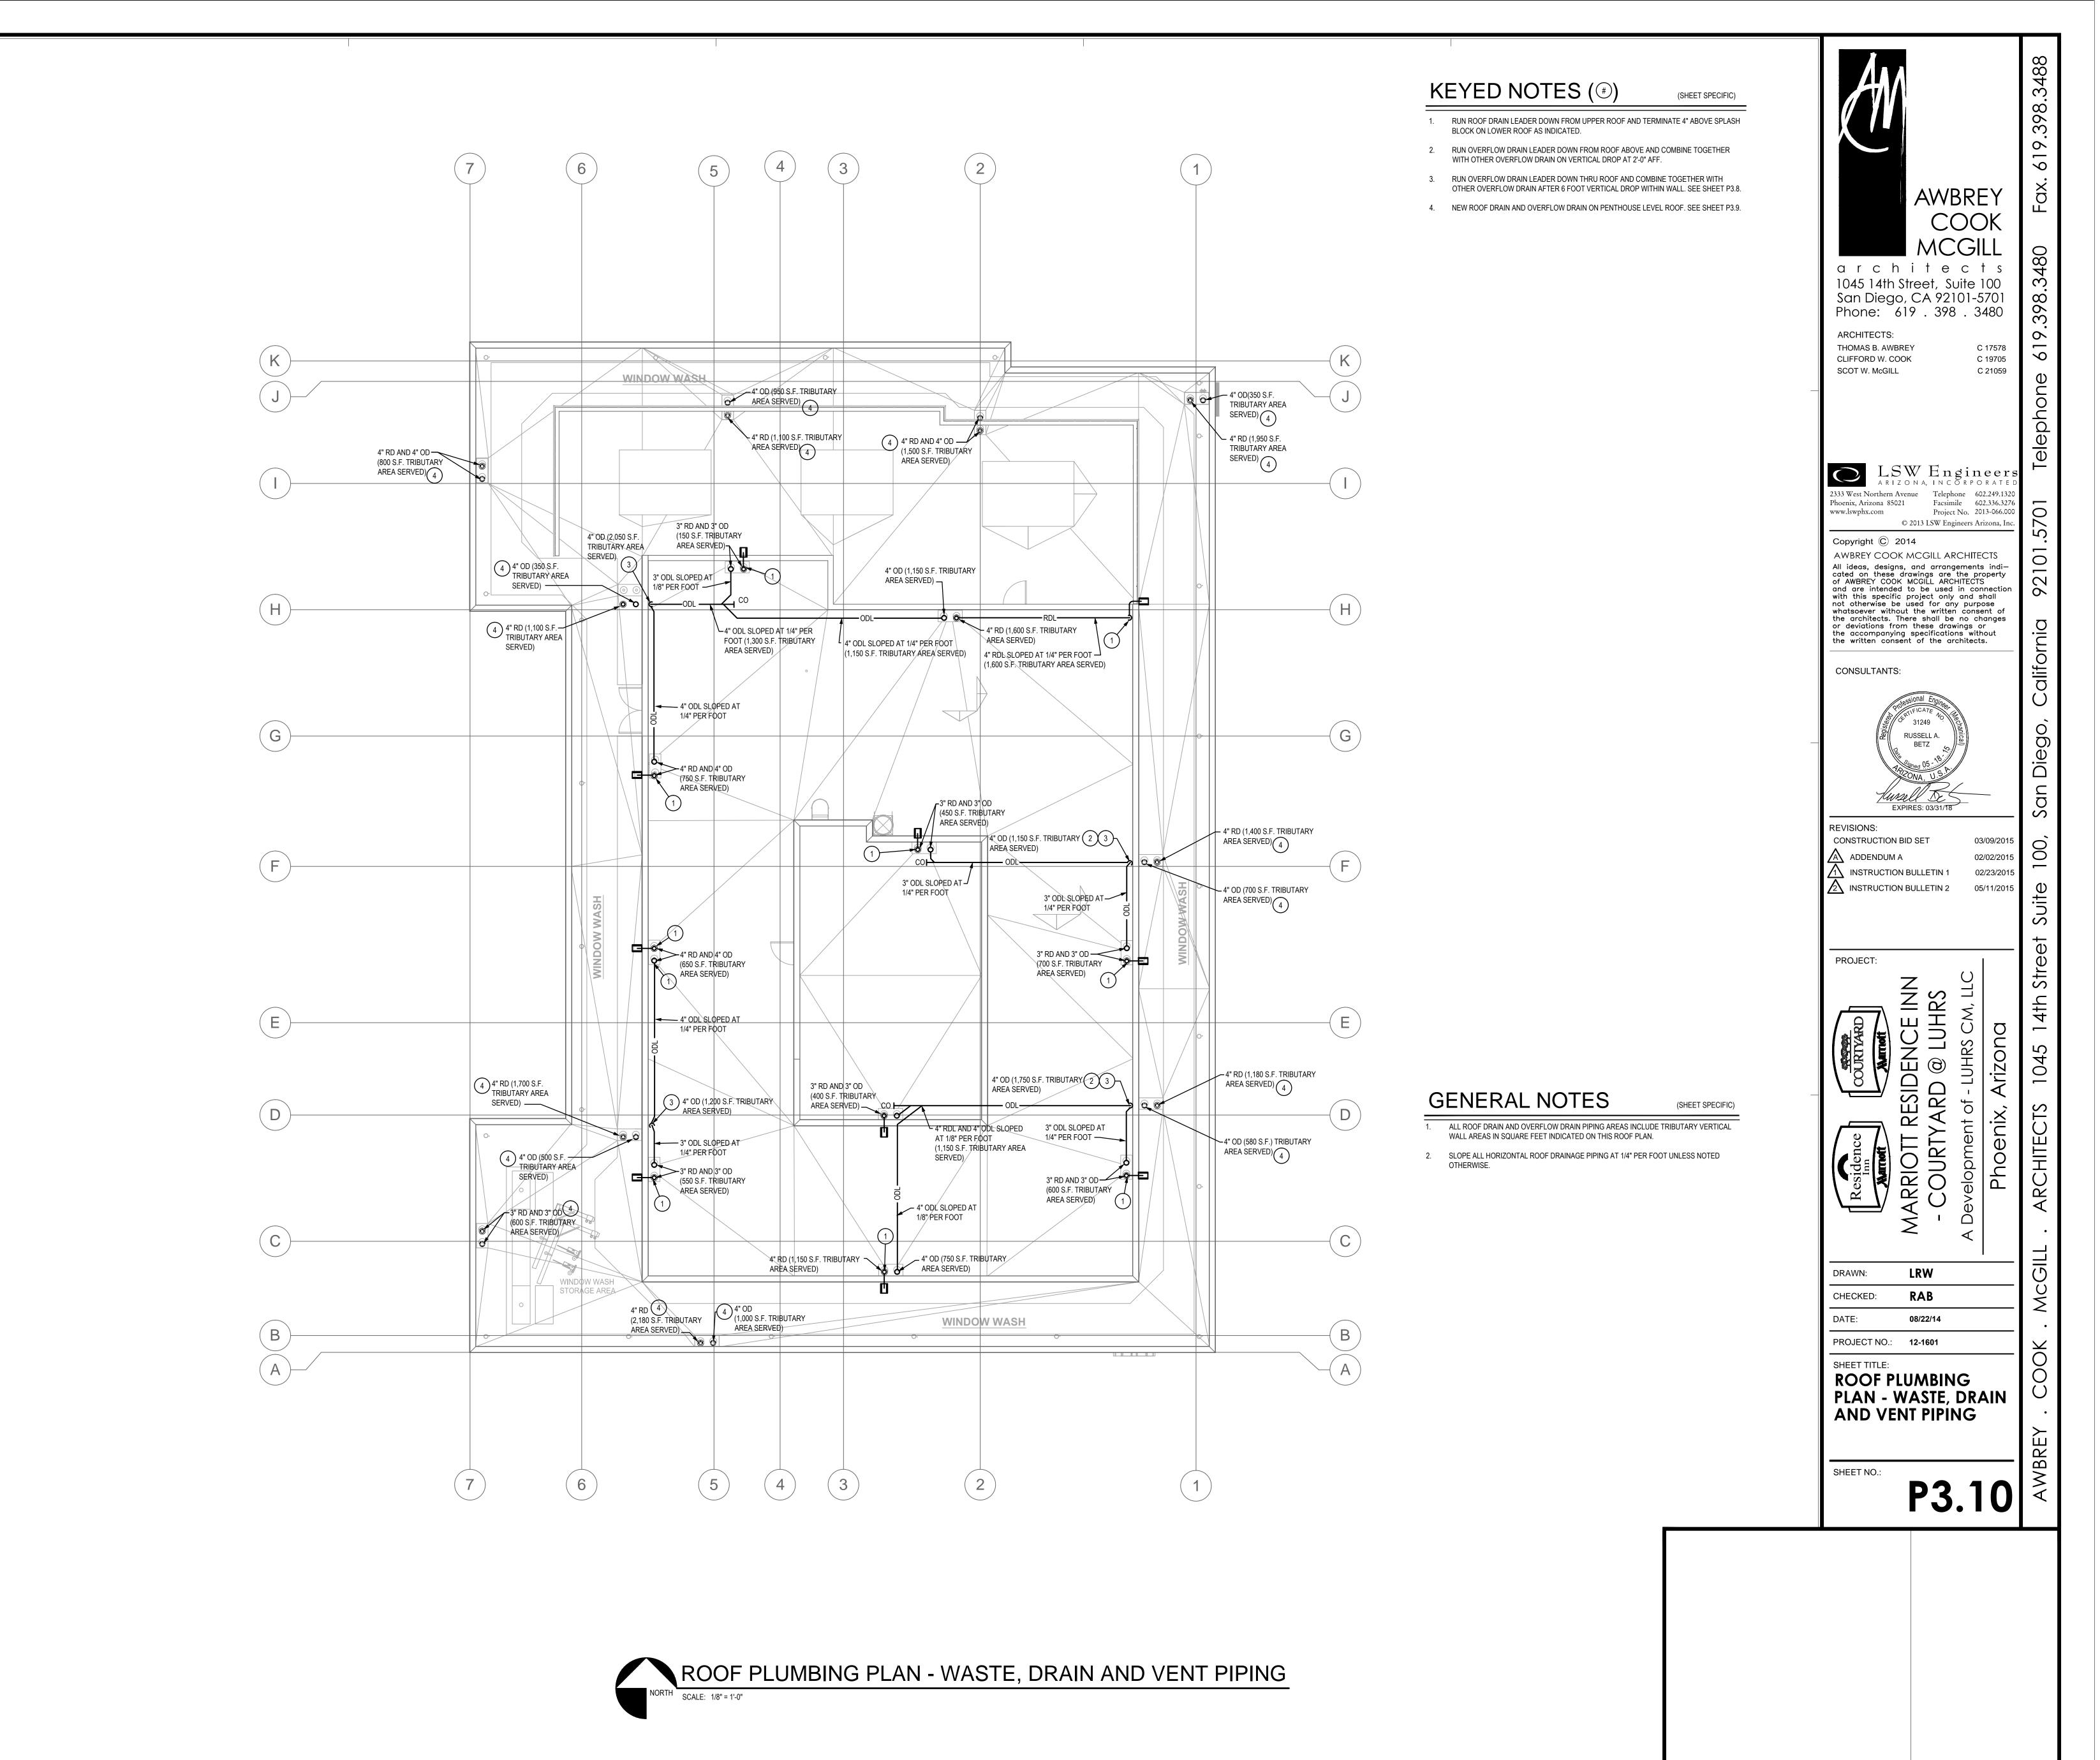
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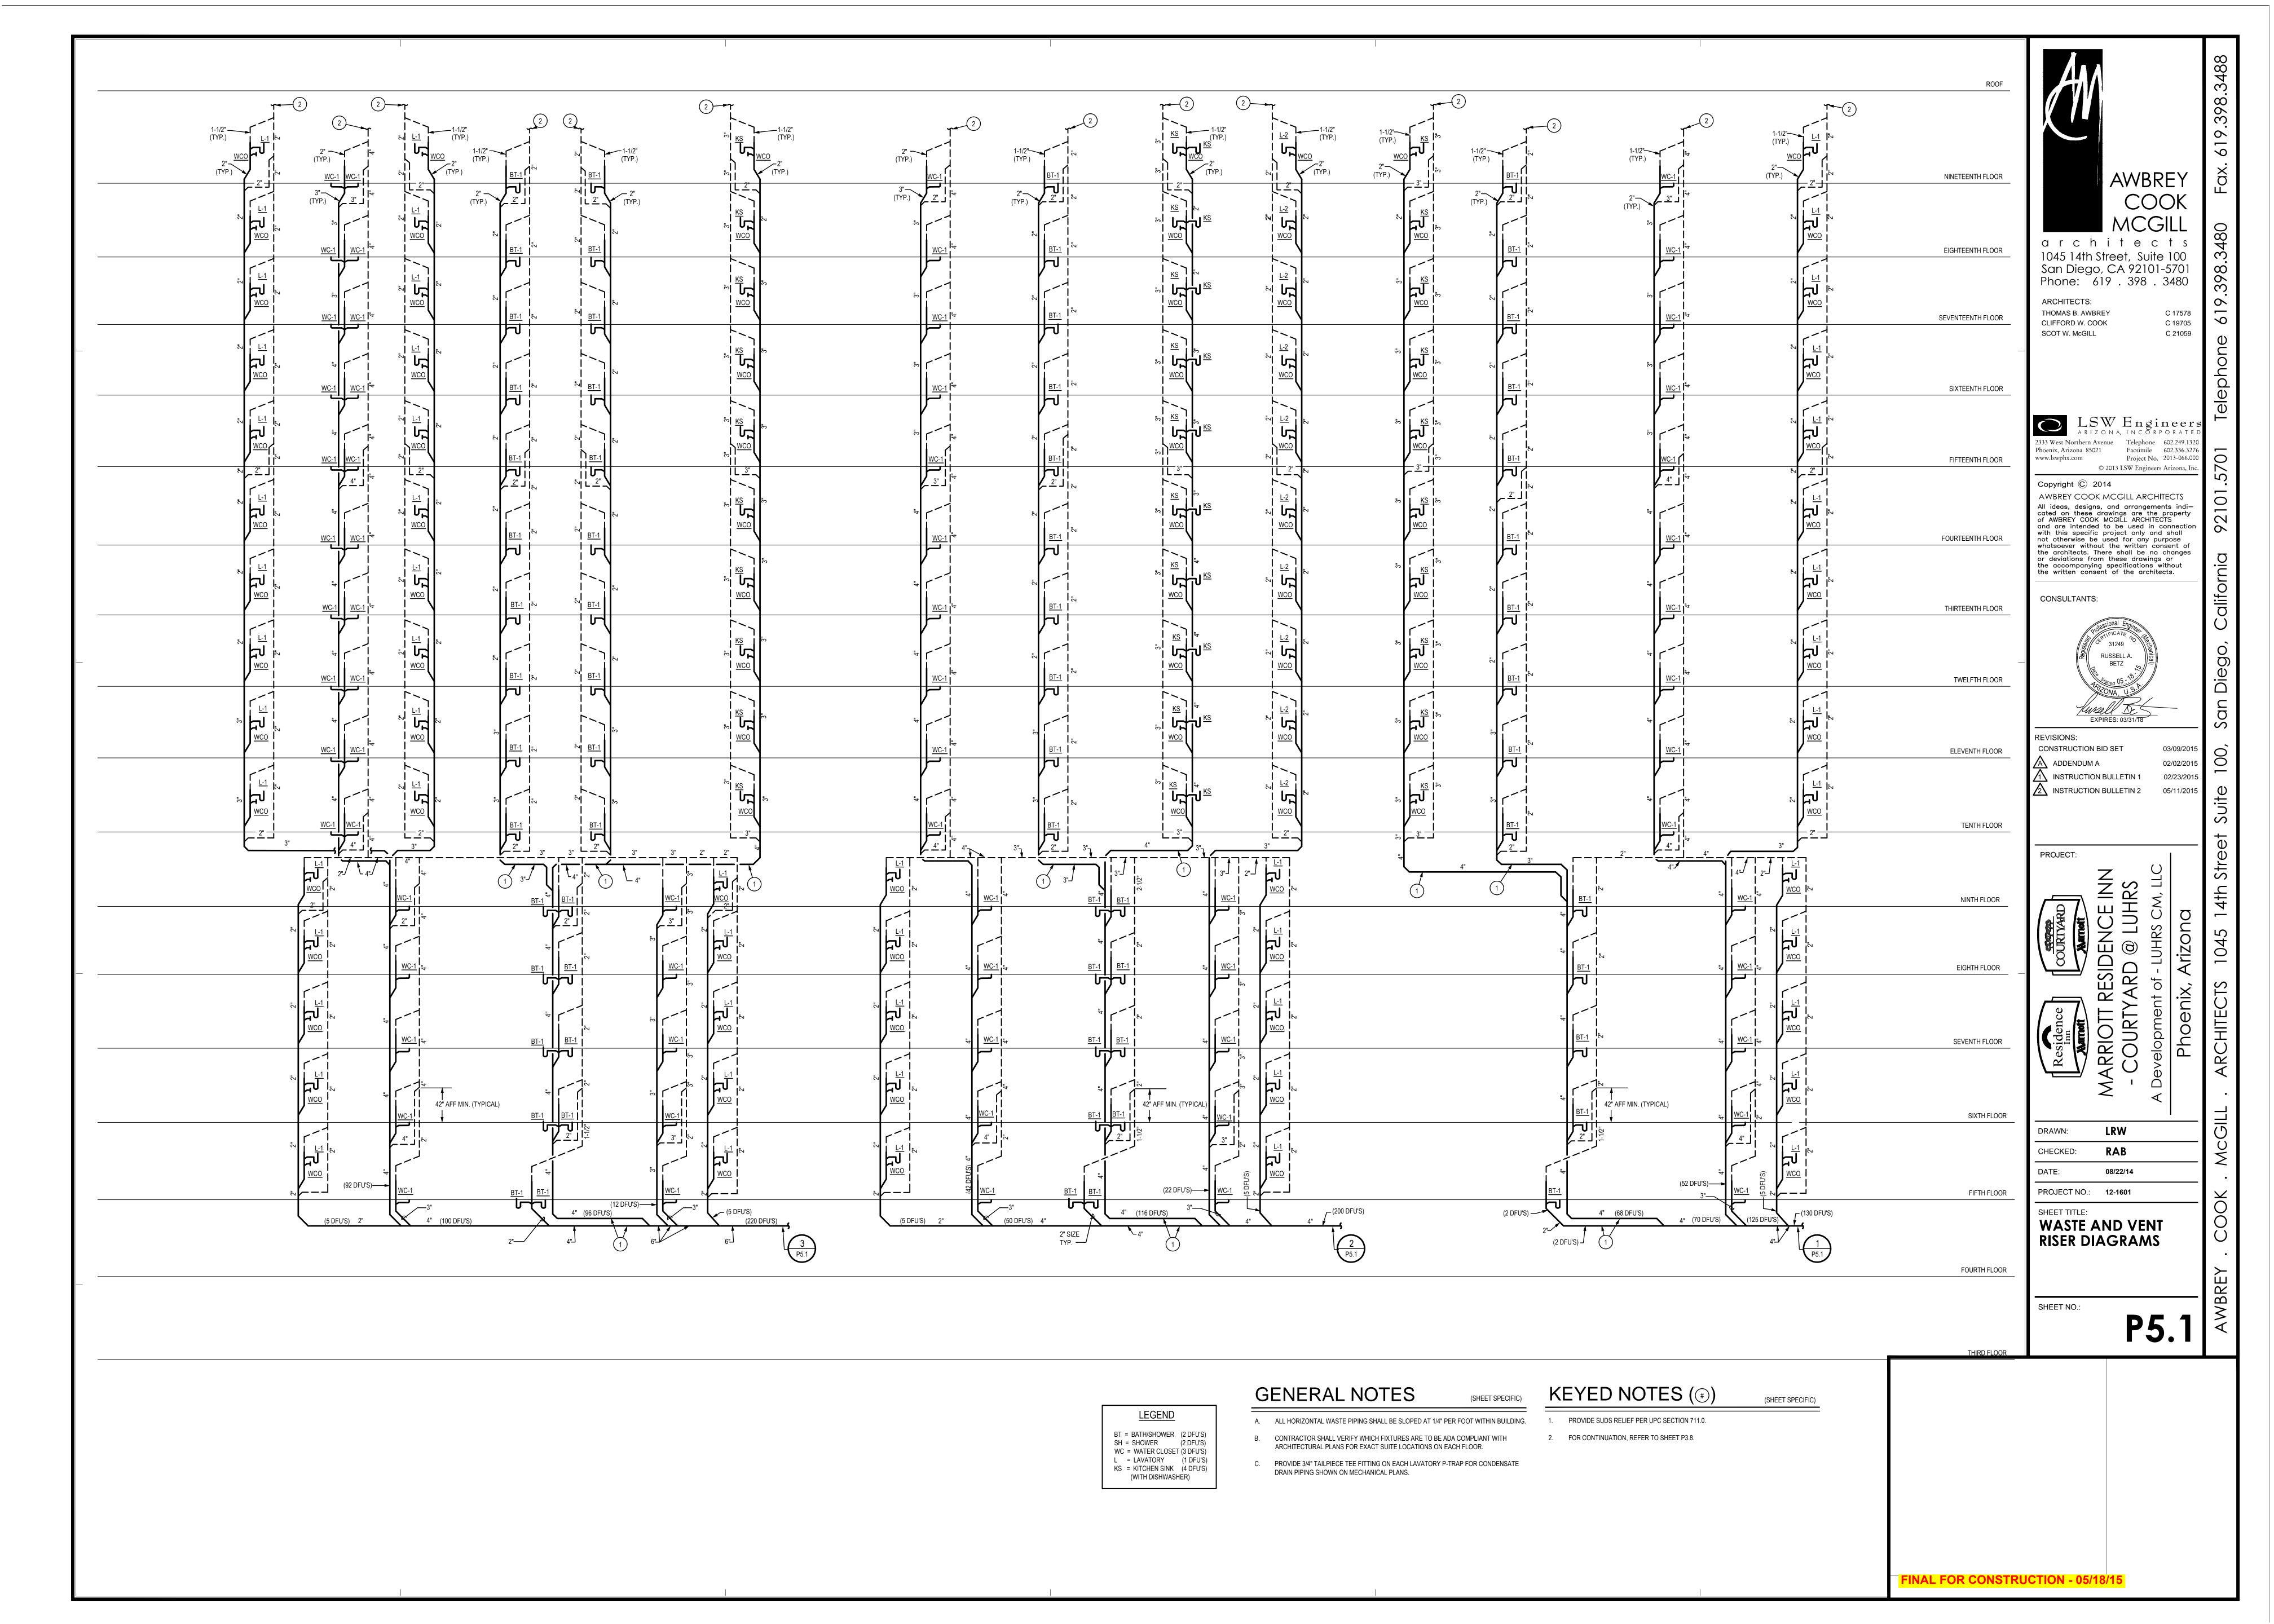
NINETEENTH FLOOR


PLUMBING PLAN -WASTE, DRAIN AND **VENT PIPING** 


NINETEENTH FLOOR PLUMBING PLAN - WASTE, DRAIN AND VENT PIPING







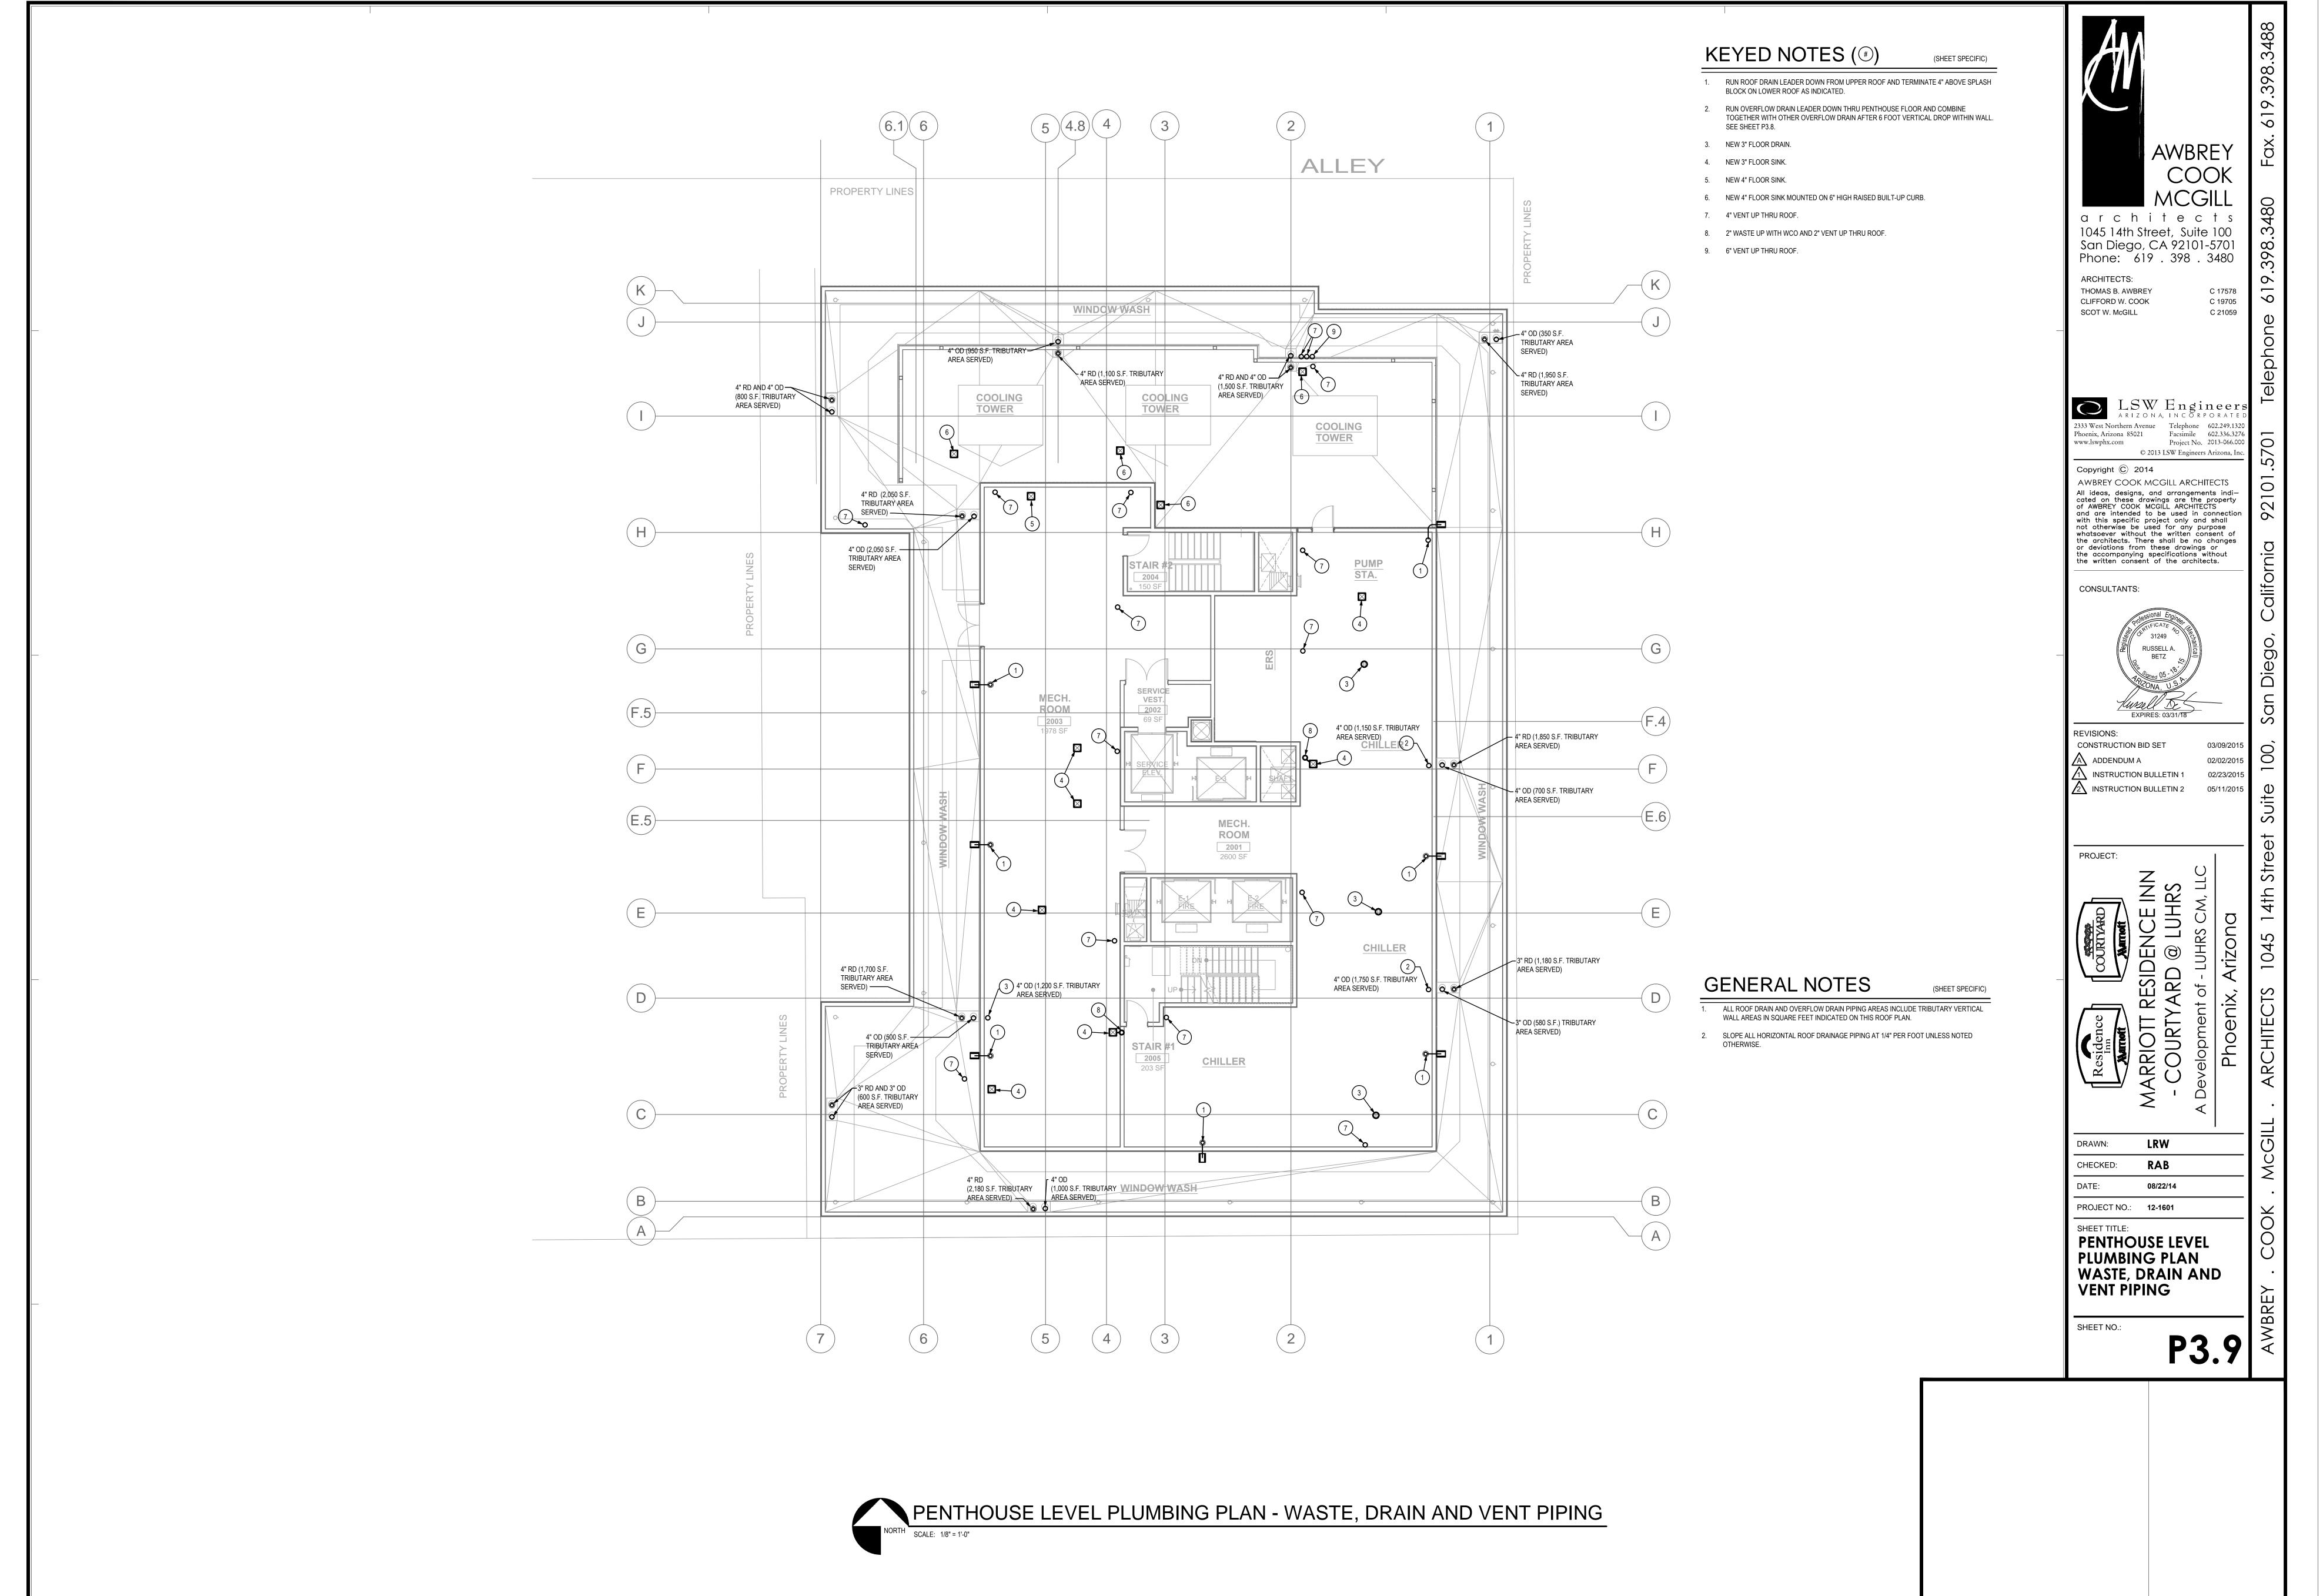


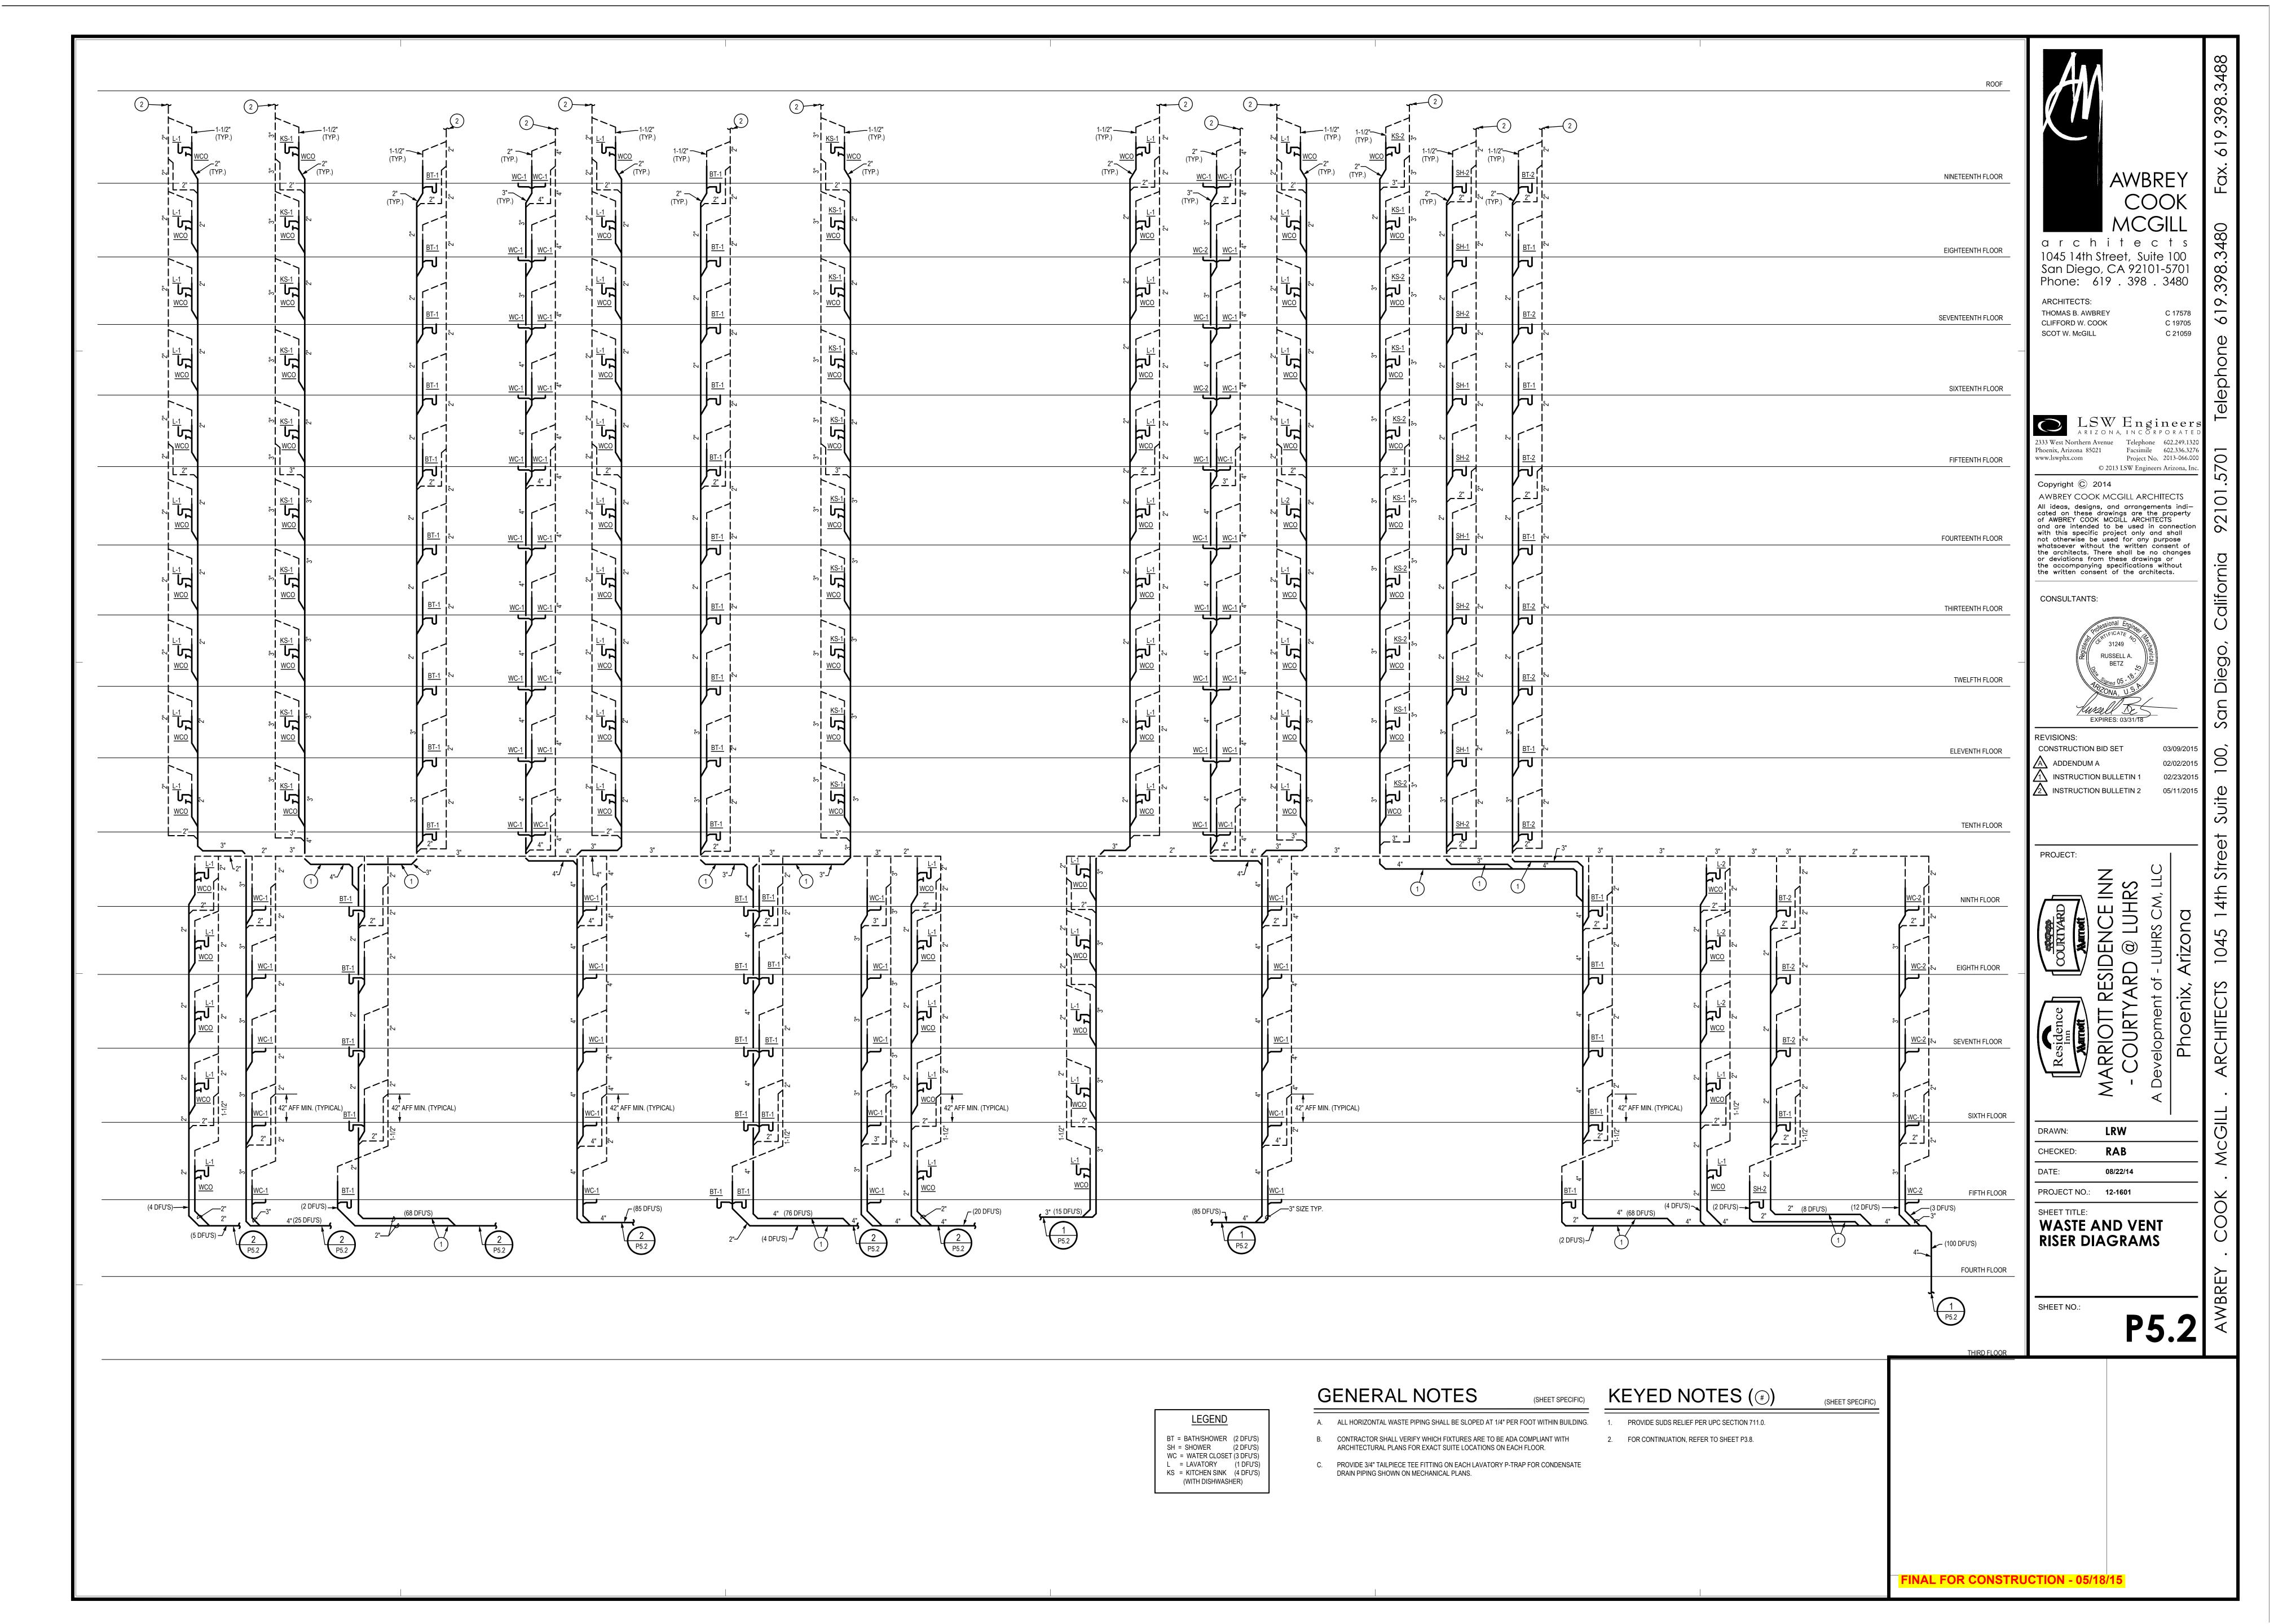

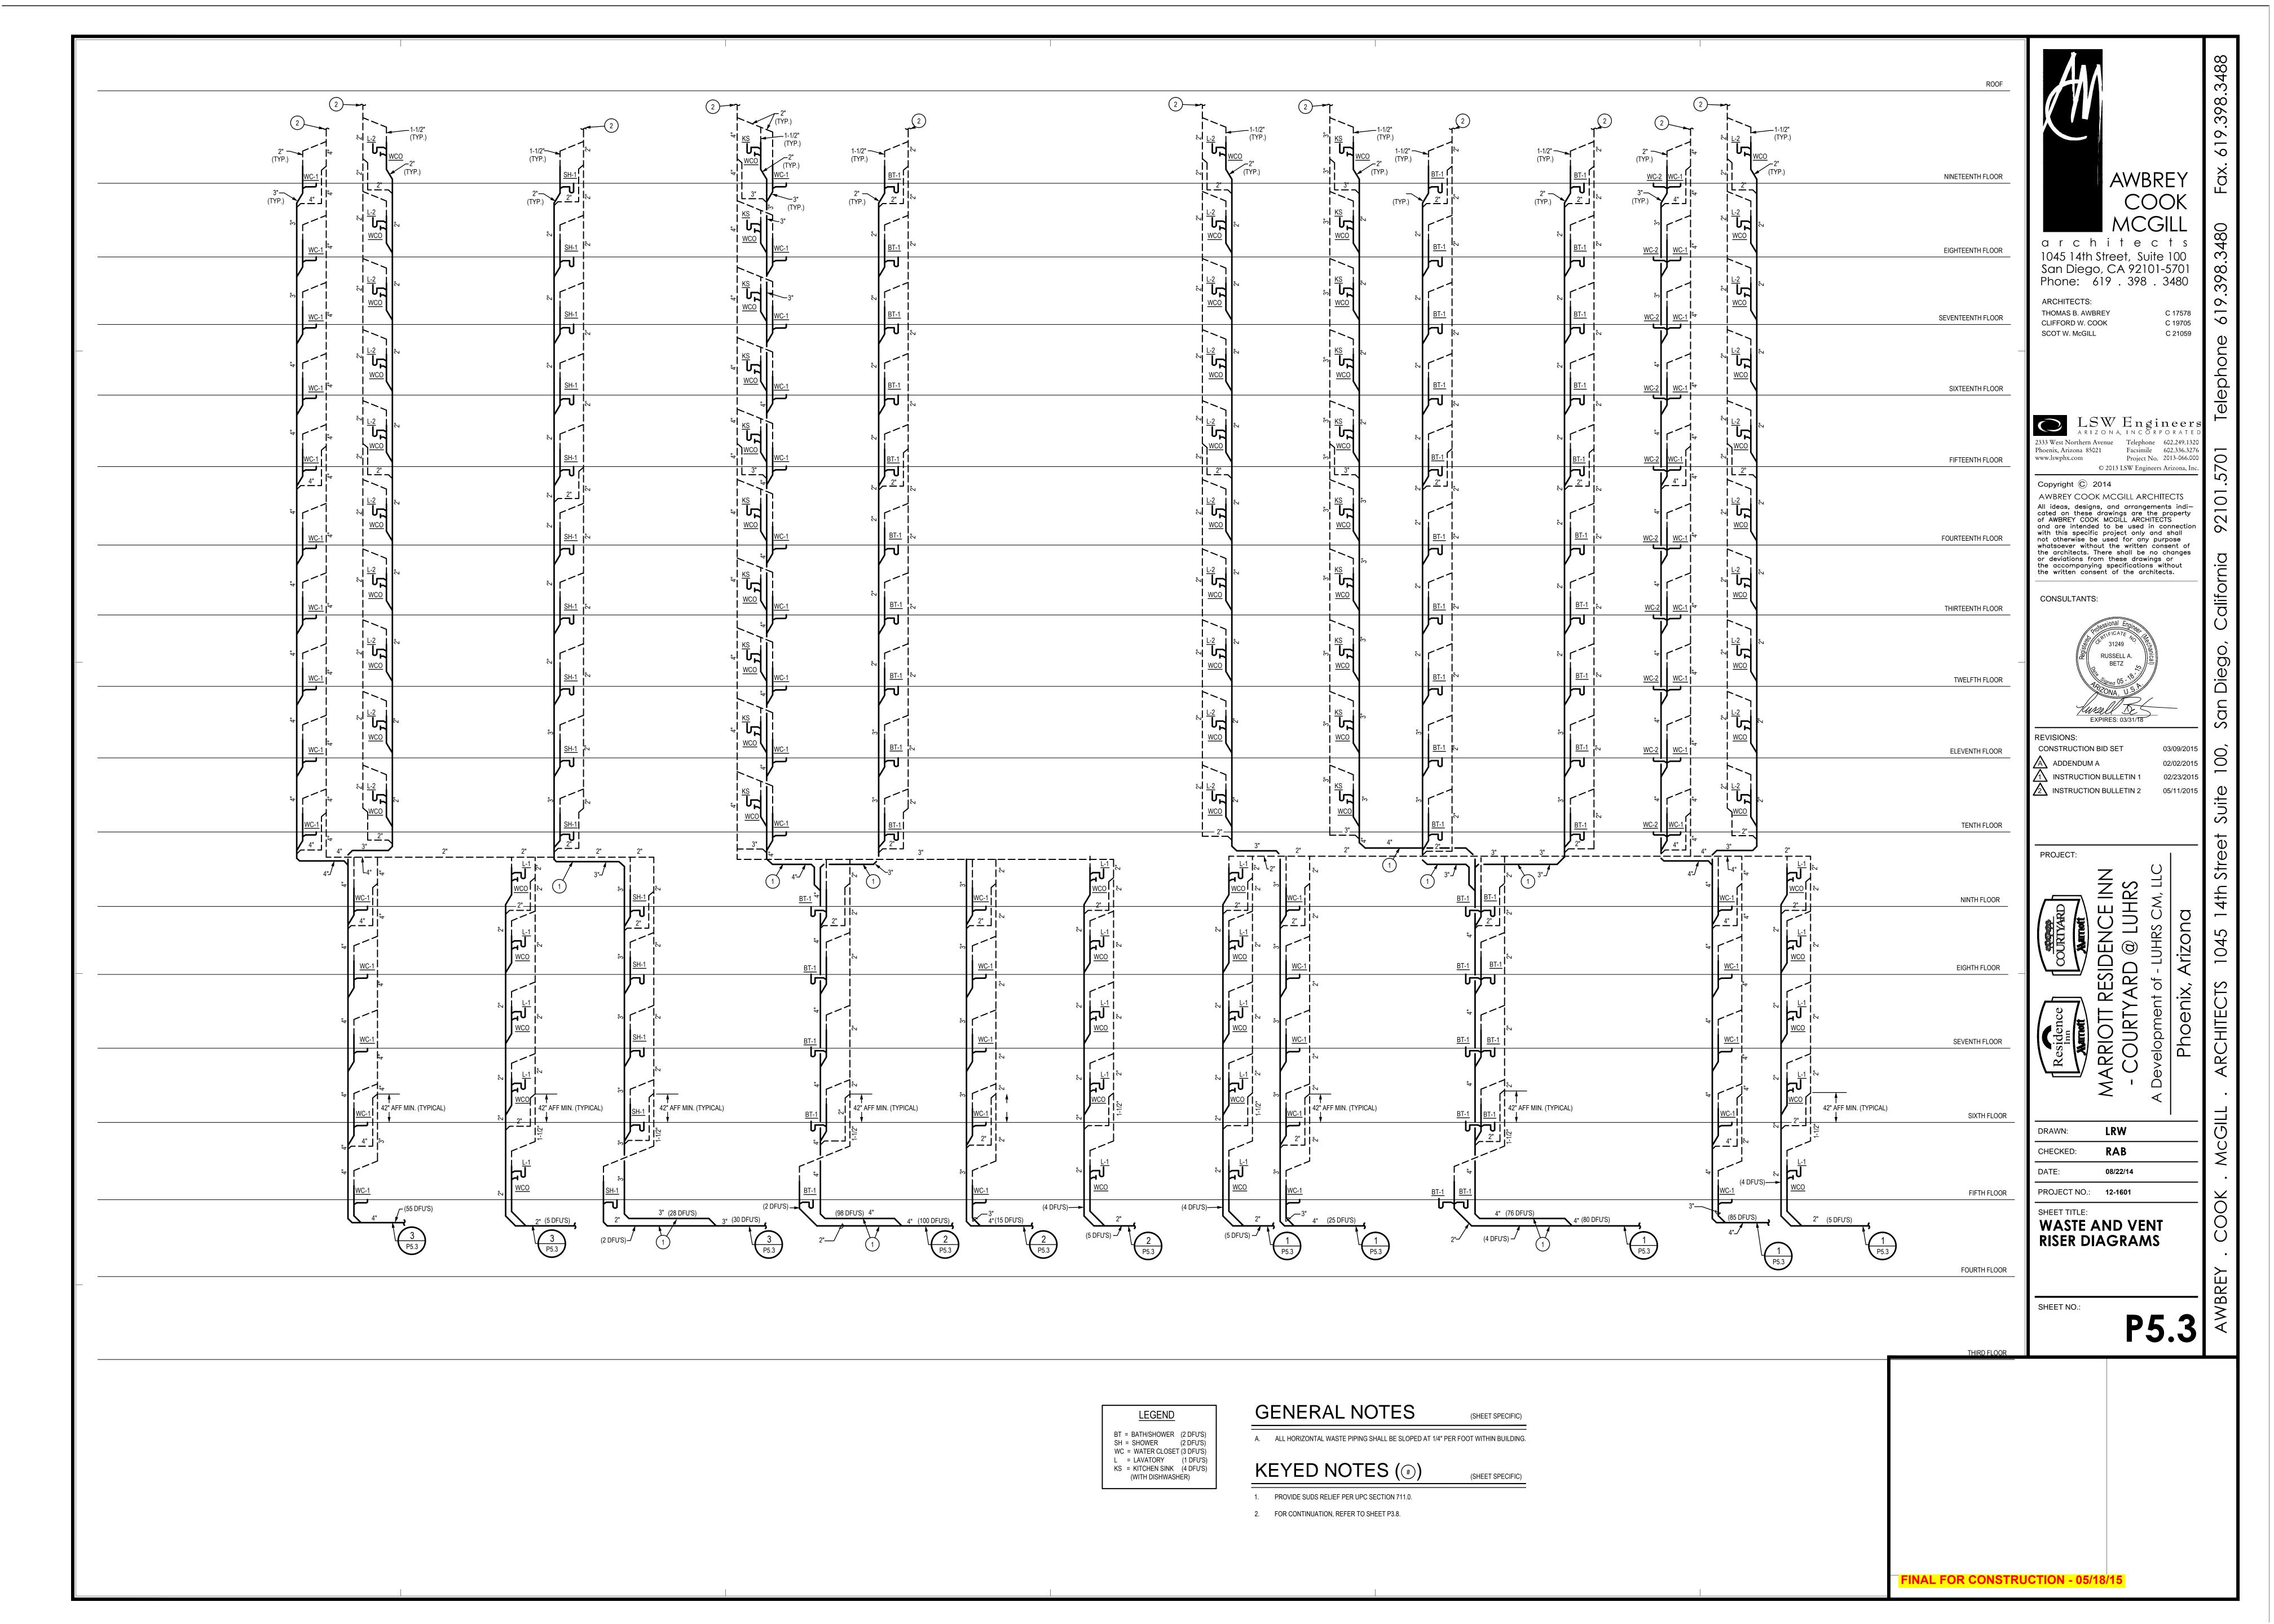

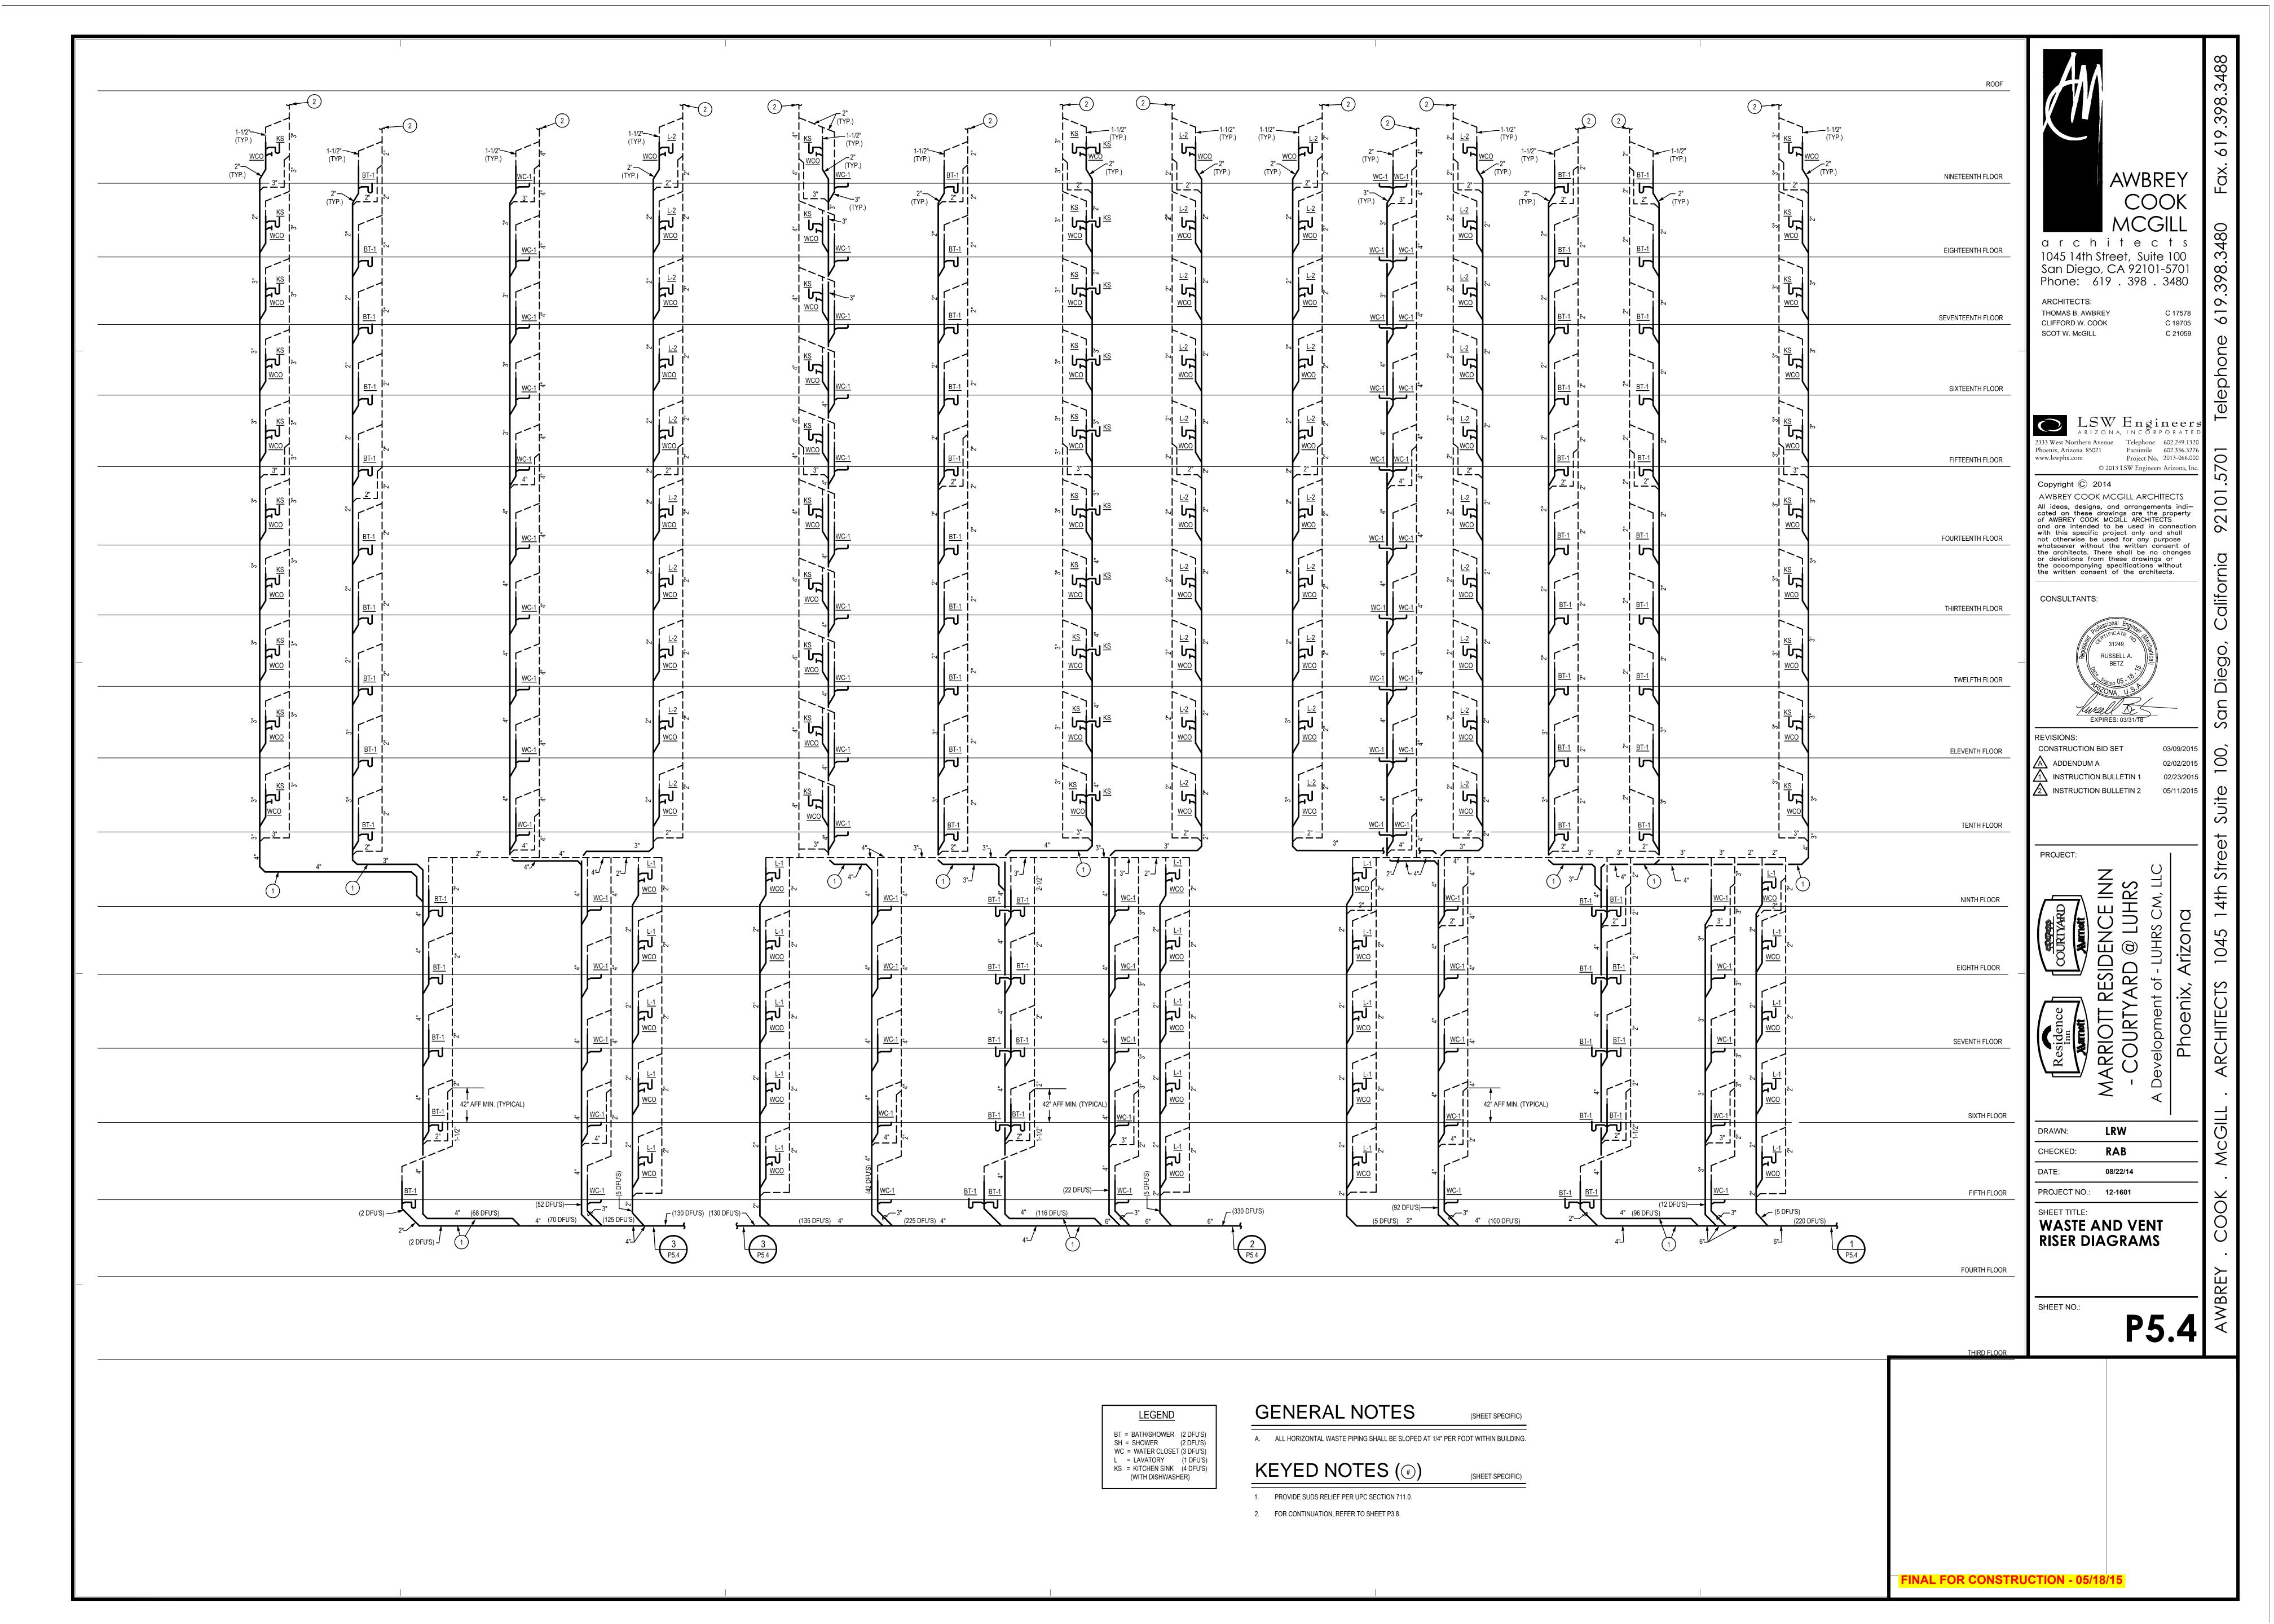

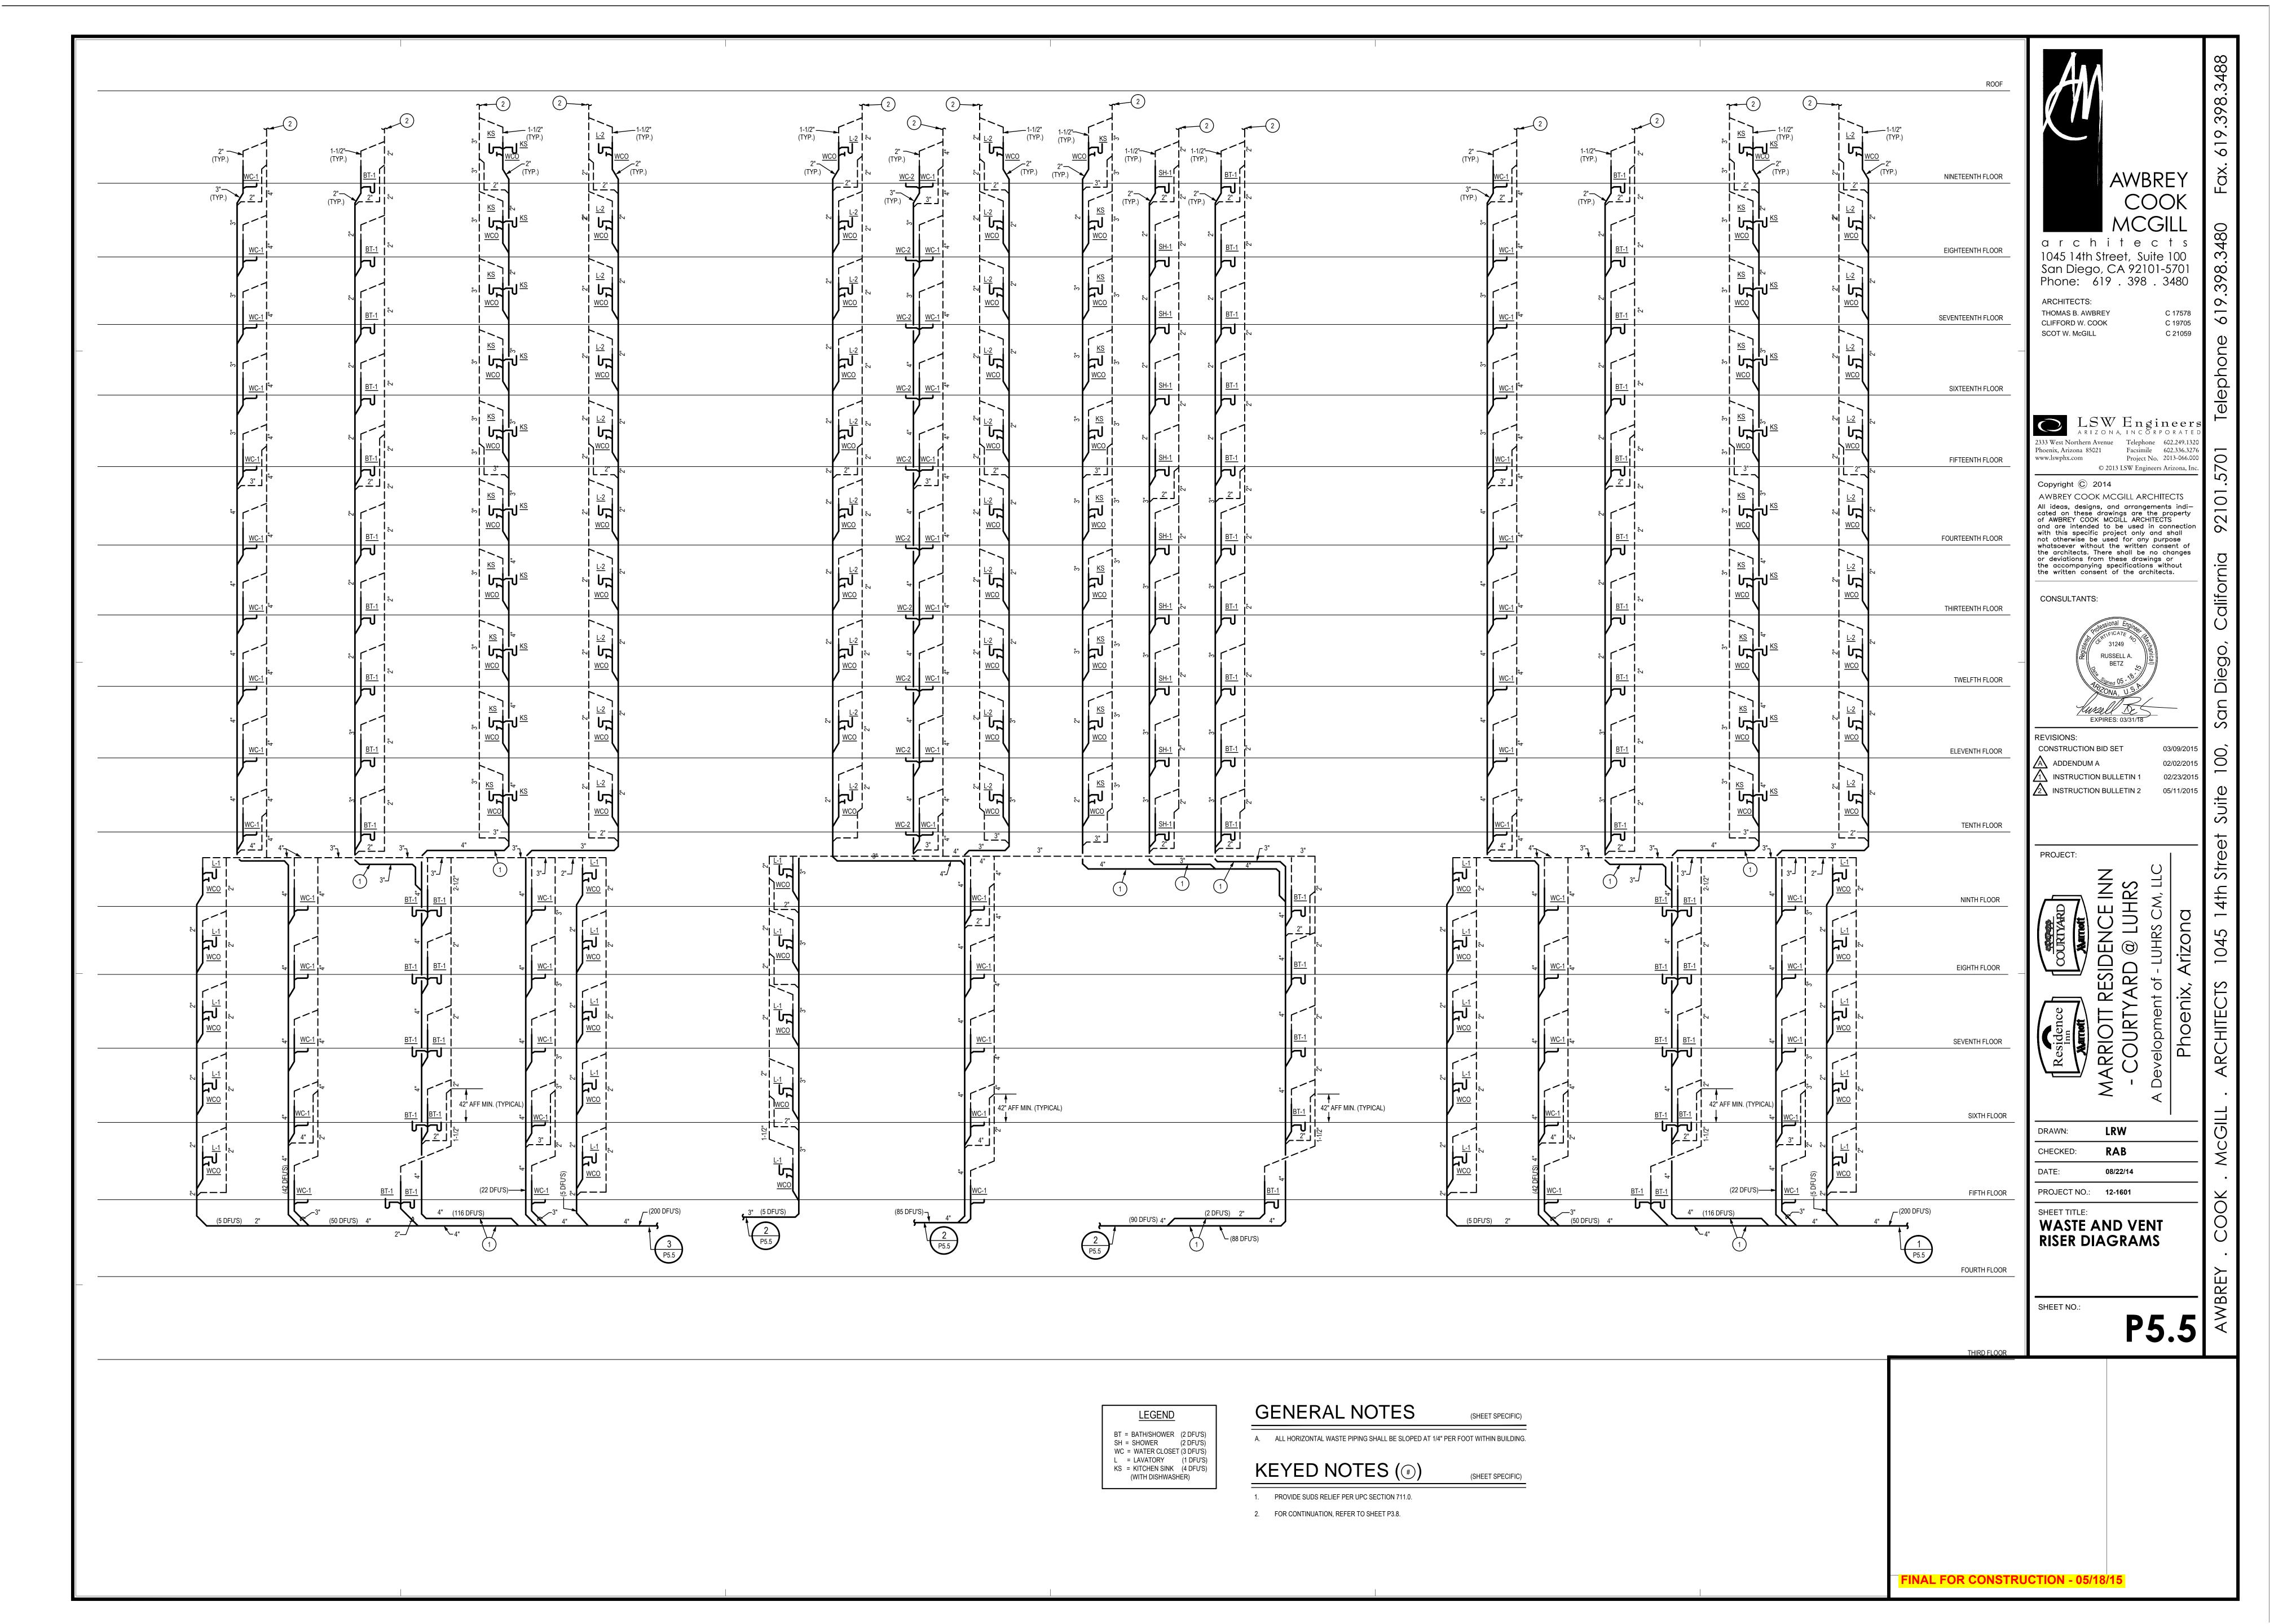

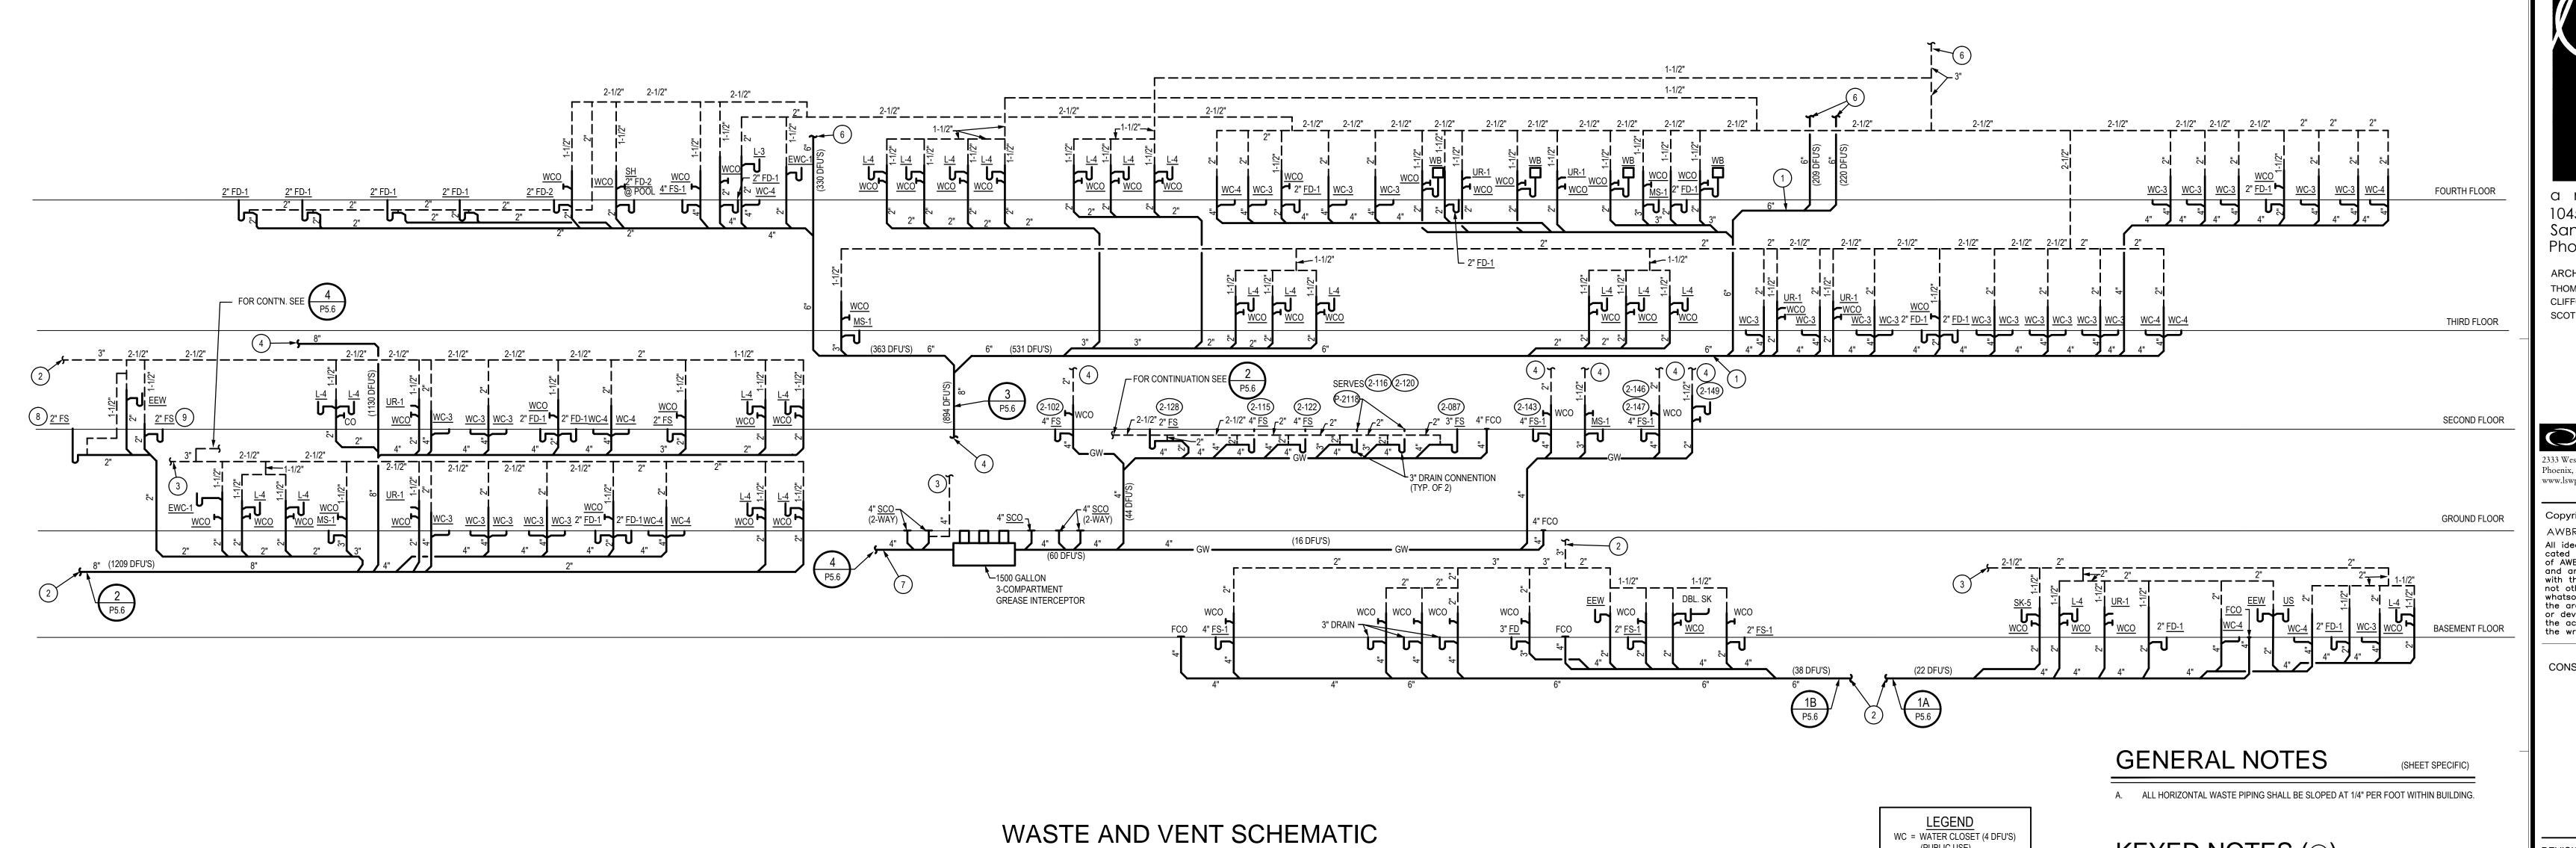

(SHEET SPECIFIC)

3. FOR CONTINUATION, REFER TO SHEET P3.1.

4. FOR CONTINUATION, REFER TO SHEET P3.2.

6. FOR CONTINUATION, REFER TO SHEET P3.4.

7. 4" WASTE TO SANITARY SEWER, SEE SHEET P3.1.

CONDENSATE DRAIN.

9. LOCATED IN MECHANICAL ROOM 215 SERVING

1. PROVIDE SUDS RELIEF PER UPC SECTION 711.0.

(PUBLIC USE) L = LAVATORY (1 DFU'S)

EWC =ELECTRIC (1 DFU)

SH = SHOWER (2 DFU'S)

LS = LAUNDRY SINK (2 DFU'S)

WATER COOLER

UR = URINAL

SK = SINK

FD = FD (2") FD = FD (3") FS = FS (2")

FS = FS(3")

FS = FS (4")

MS = MOP SINK

(2 DFU'S)

(2 DFU'S)

(3 DFU'S)

(4 DFU'S)

(6 DFU'S) (4 DFU'S)

(6 DFU'S)

(8 DFU'S)

2. FOR CONTINUATION, REFER TO SHEET P3.0.

5. FOR CONTINUATION, REFER TO SHEET P3.3.

8. LOCATED IN DRY STORAGE SERVING CONDENSATE DRAINS FROM COOLER AND FREEZER COILS.



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 2013-066.000


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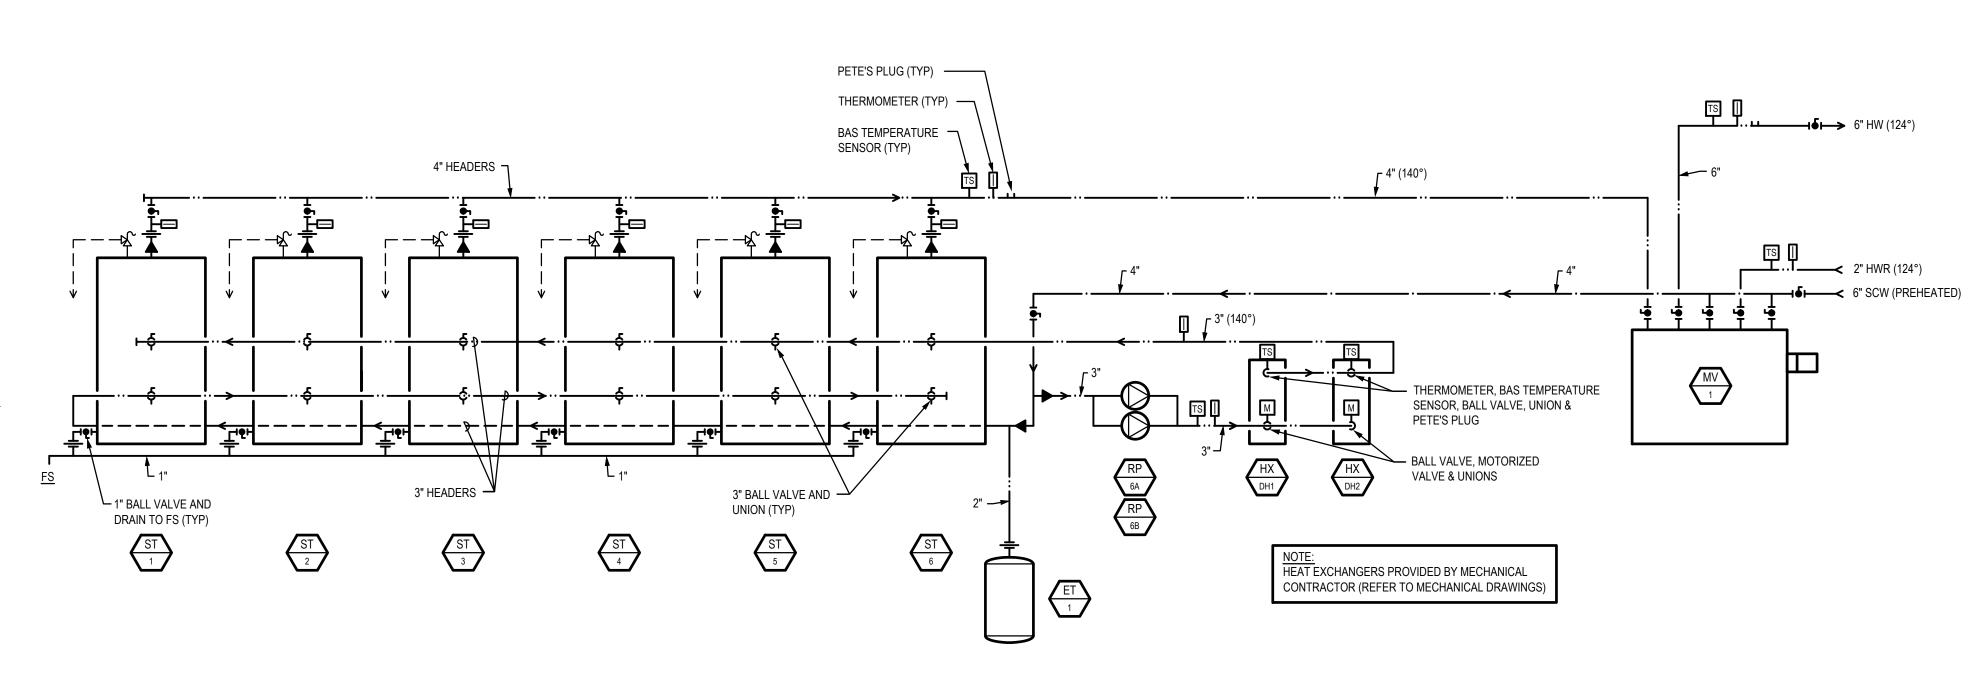


CONSTRUCTION BID SET 03/09/2015 A ADDENDUM A 02/02/201 1 INSTRUCTION BULLETIN 1 02/23/2015 2 INSTRUCTION BULLETIN 2




LRW DRAWN: **RAB** CHECKED:

PROJECT NO.: **12-1601 WASTE AND VENT** RISER DIAGRAMS

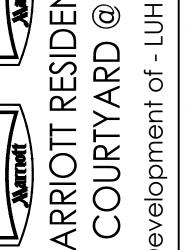


# 124° DHW PIPING DIAGRAM


NOT TO SCALE

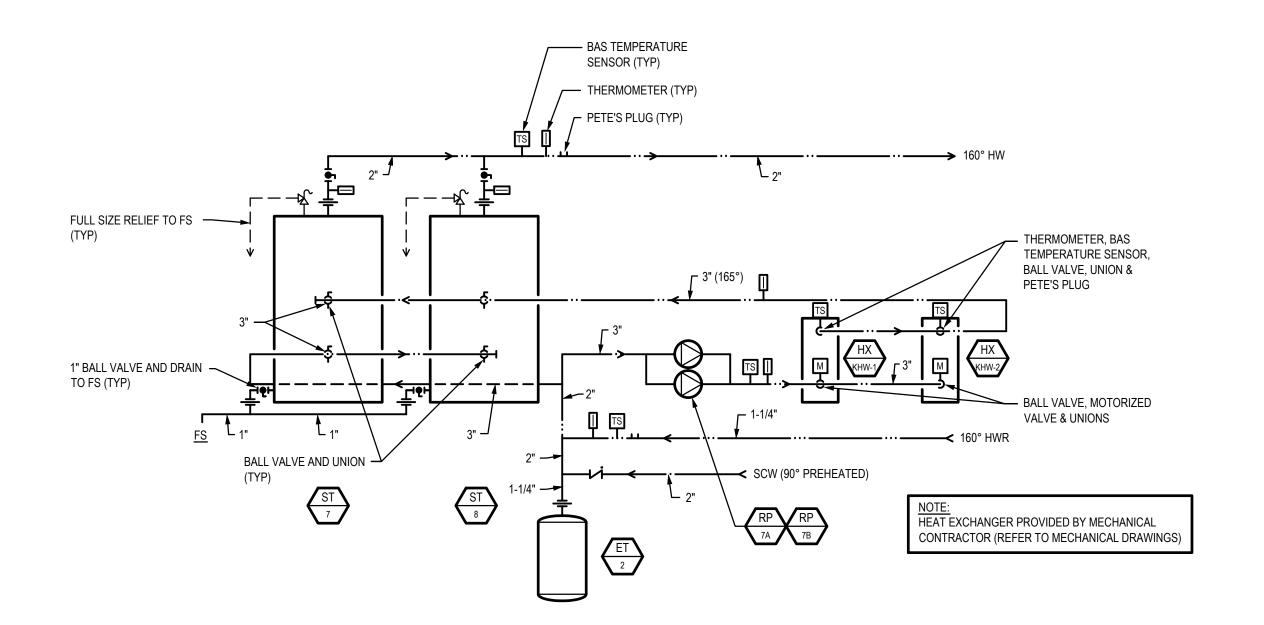

160° DHW PIPING DIAGRAM

NOT TO SCALE

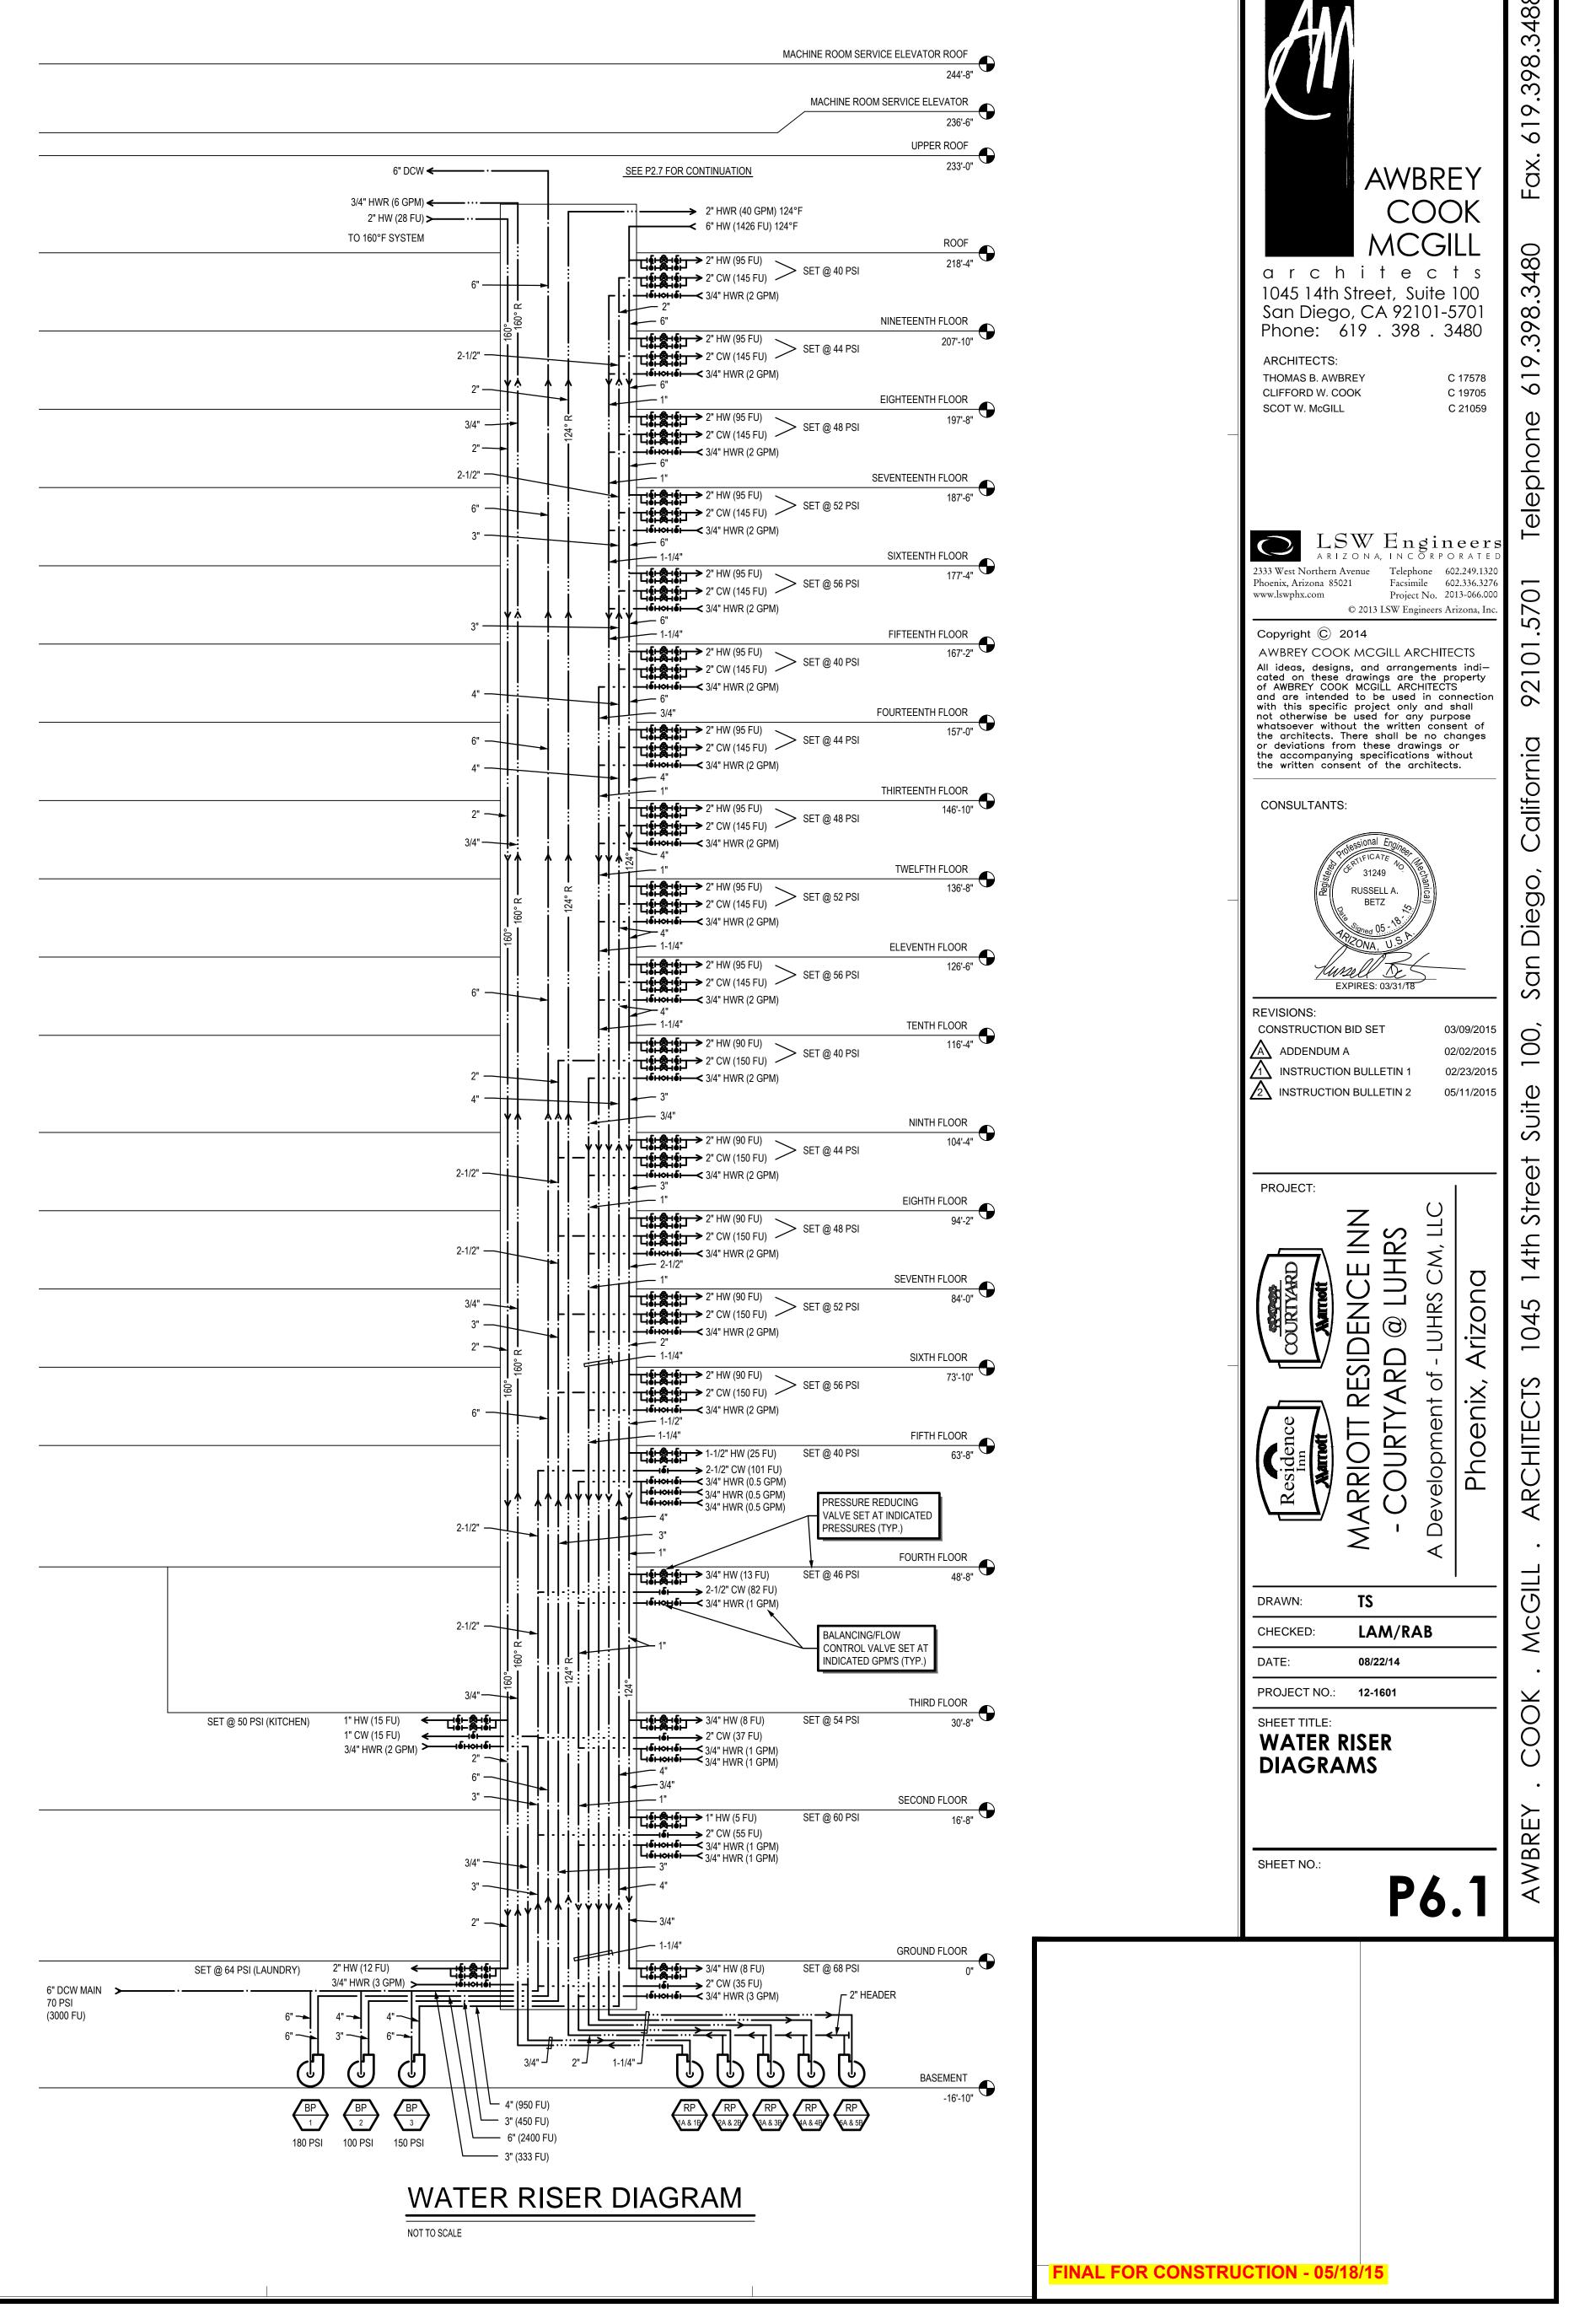

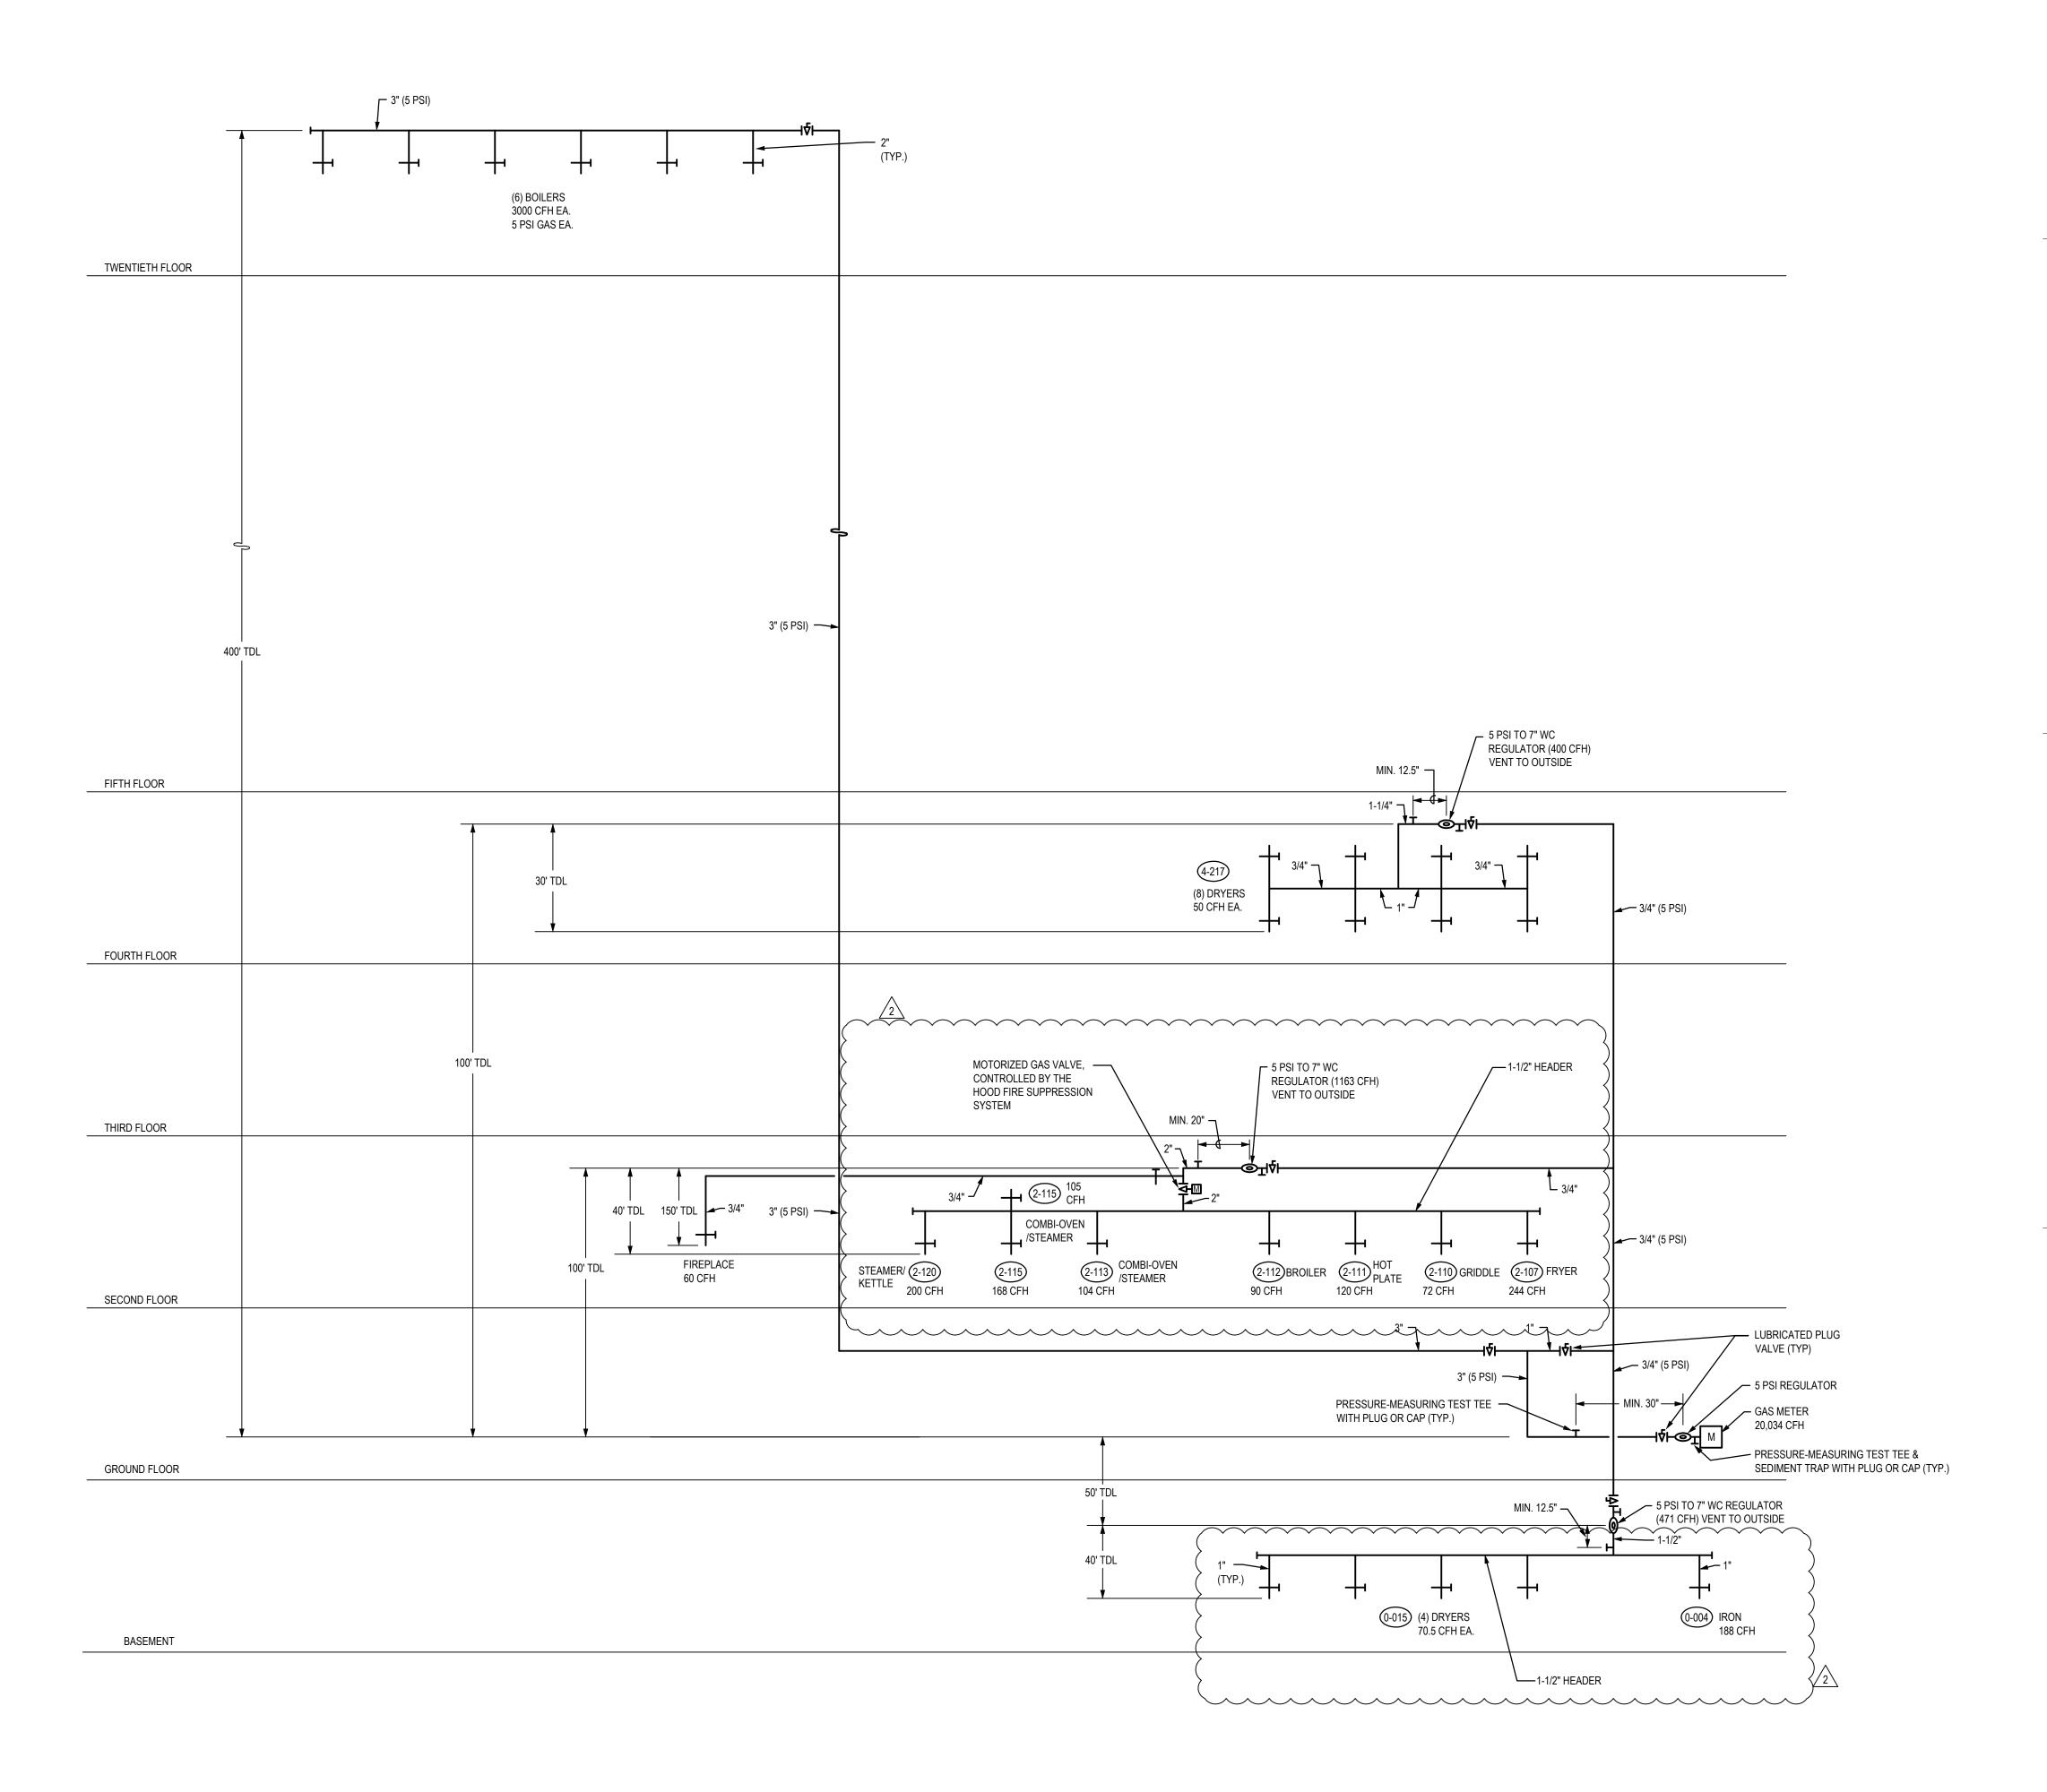



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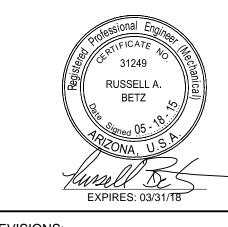
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CONSULTANTS:



REVISIONS:

CONSTRUCTION BID SET

03/09/2015

ADDENDUM A

02/02/2015

INSTRUCTION BULLETIN 1

02/23/2015

05/11/2015

PROJECT:

COURTYARD

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DRAWN: TS

CHECKED: LAM/RAB

DATE: 08/22/14

SHEET TITLE:

GAS RISER


DIAGRAMS

P6.2

GAS DIAGRAM

NOT TO SCALE 20,034 CFH


20,001 0111

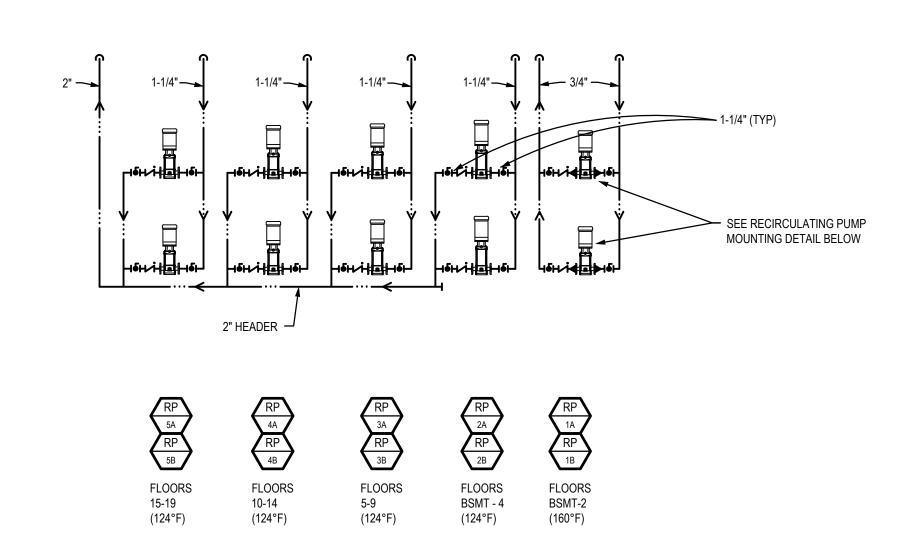

# DOMESTIC HOT WATER RECIRCULATING PUMPS


NOT TO SCALE

AIR HANDLER ROOM B104

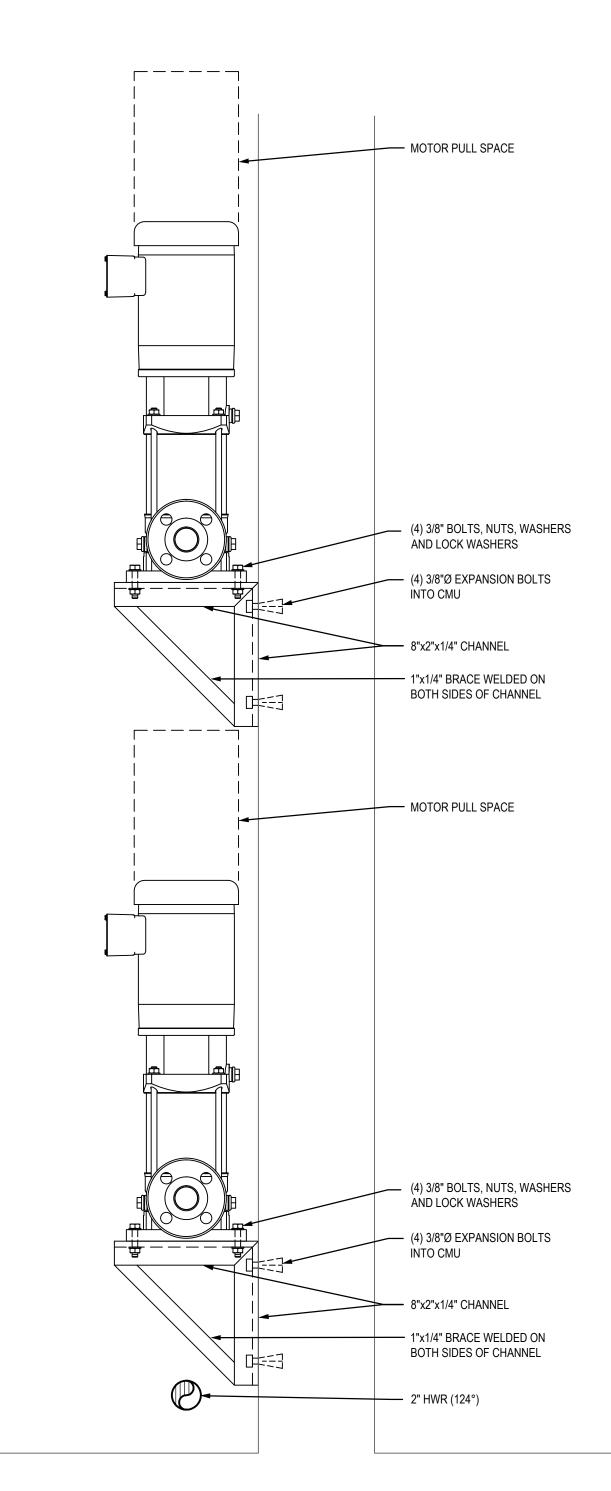


# RECIRCULATING PUMP MOUNTING DETAIL

NOT TO SCALE

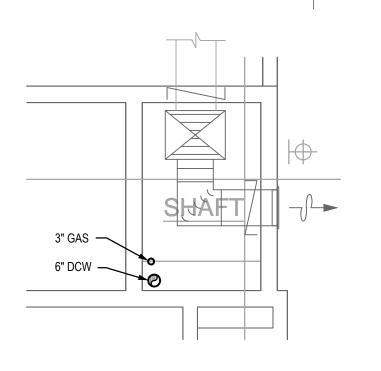


# 5TH TO 19TH FLOORS

SCALE: 1/4" = 1'-0

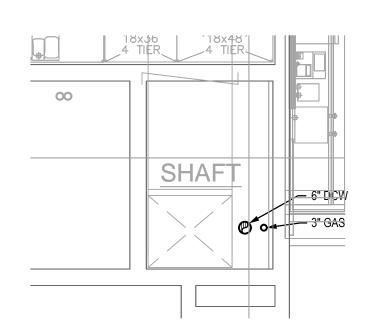


#### 4TH FLOOR SHAFT

SCALE: 1/4" = 1'-0"

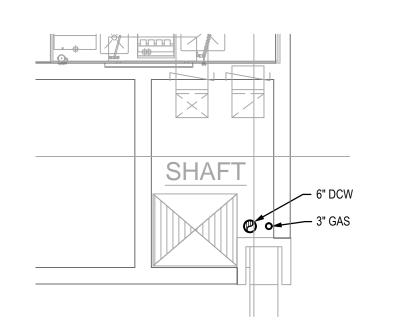


#### 3RD FLOOR SHAFT

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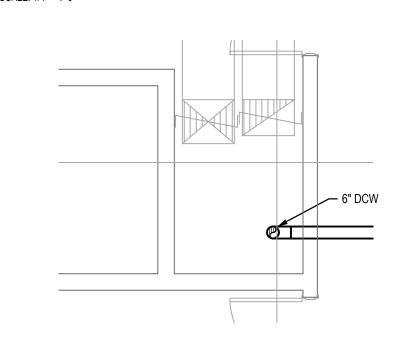
#### 2ND FLOOR SHAFT

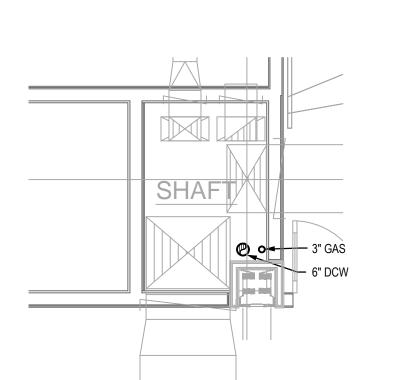CALE: 1/4" = 1'-0"



#### GROUND FLOOR SHAFT

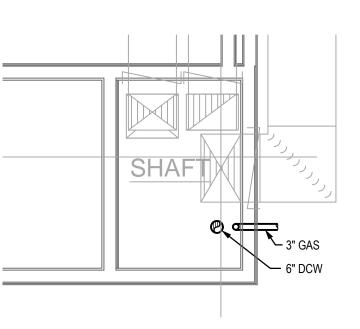
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### BASEMENT FLOOR SHAFT


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SHAFT #3




#### 5TH TO 19TH FLOORS

SCALE: 1/4" = 1'-0"

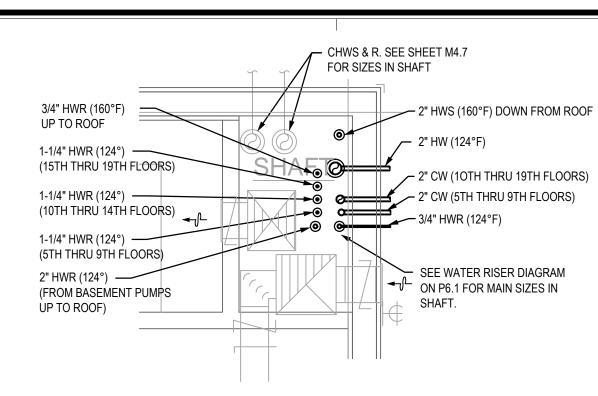

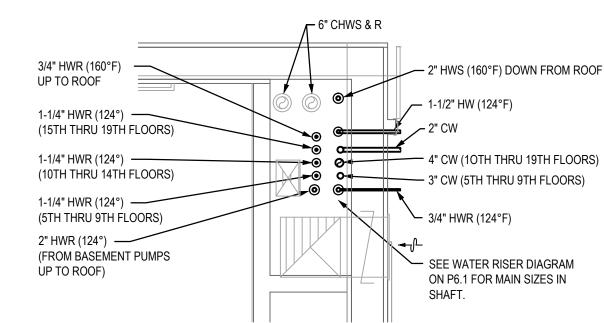
### 4TH FLOOR SHAFT

00415 4/48 4108

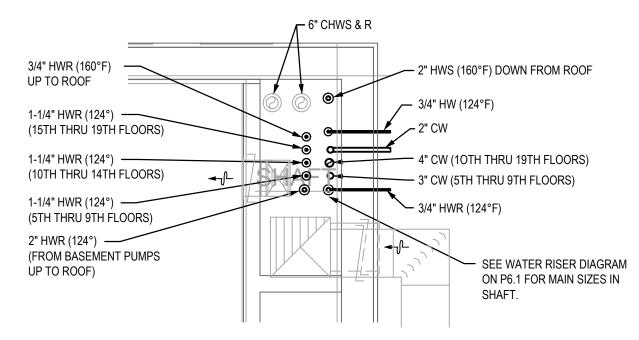


#### 3RD FLOOR SHAFT

SCALE: 1/4" = 1'-0"

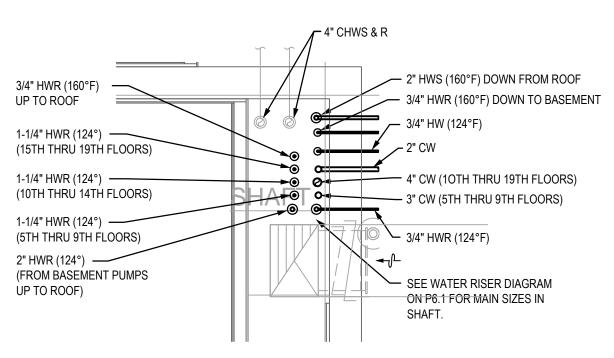


#### 2ND FLOOR SHAFT

SCALE: 1/4" = 1'-0"

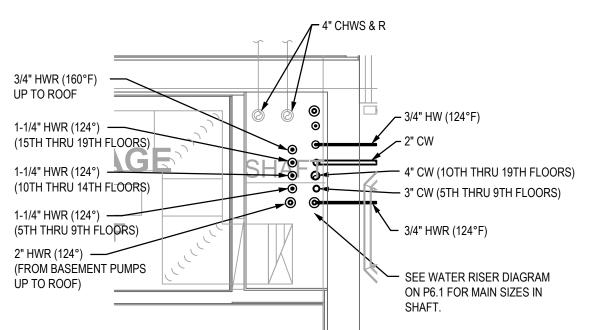

#### **GROUND FLOOR SHAFT**

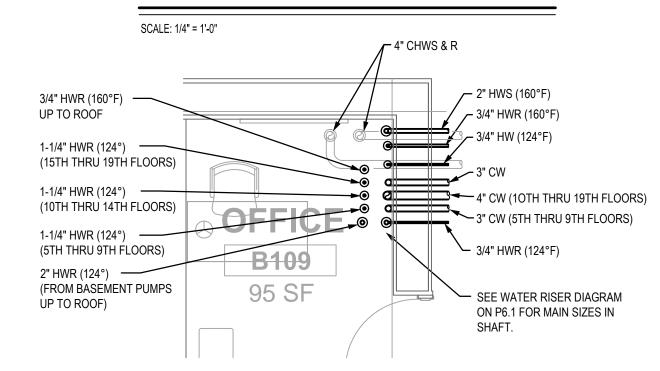

### BASEMENT FLOOR PLAN

SCALE: 1/4" = 1'-0"

SHAFT #2

AWBREY
COOK
MCGILL
architectsuite 100

architects
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Phone: 619.398.3480

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9

ARCHITECTS:
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CLIFFORD W. COOK
SCOT W. McGILL

LSW Engineers

ARIZONA, INCORPORATED

2333 West Northern Avenue Phoenix, Arizona 85021 Facsimile 602.336.3276

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Project No. 2013-066.000

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AWBREY COOK MCGILL ARCHITECTS

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or deviations from these drawings or the accompanying specifications without the written consent of the architects.

CONSULTANTS:



EXPIRES: 03/31/18

REVISIONS:


CONSTRUCTION BID SET 03/09/201

A ADDENDUM A 02/02/201

INSTRUCTION BULLETIN 1 02/23/207

INSTRUCTION BULLETIN 2 05/11/2

ESIDENCE INNARD (2) LUHRS

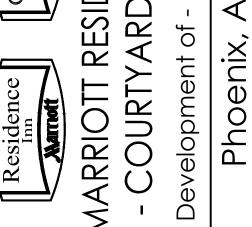


DRAWN: TS

CHECKED: LAM/RAB

DATE: 08/22/14

SHAFT DETAILS

P6.

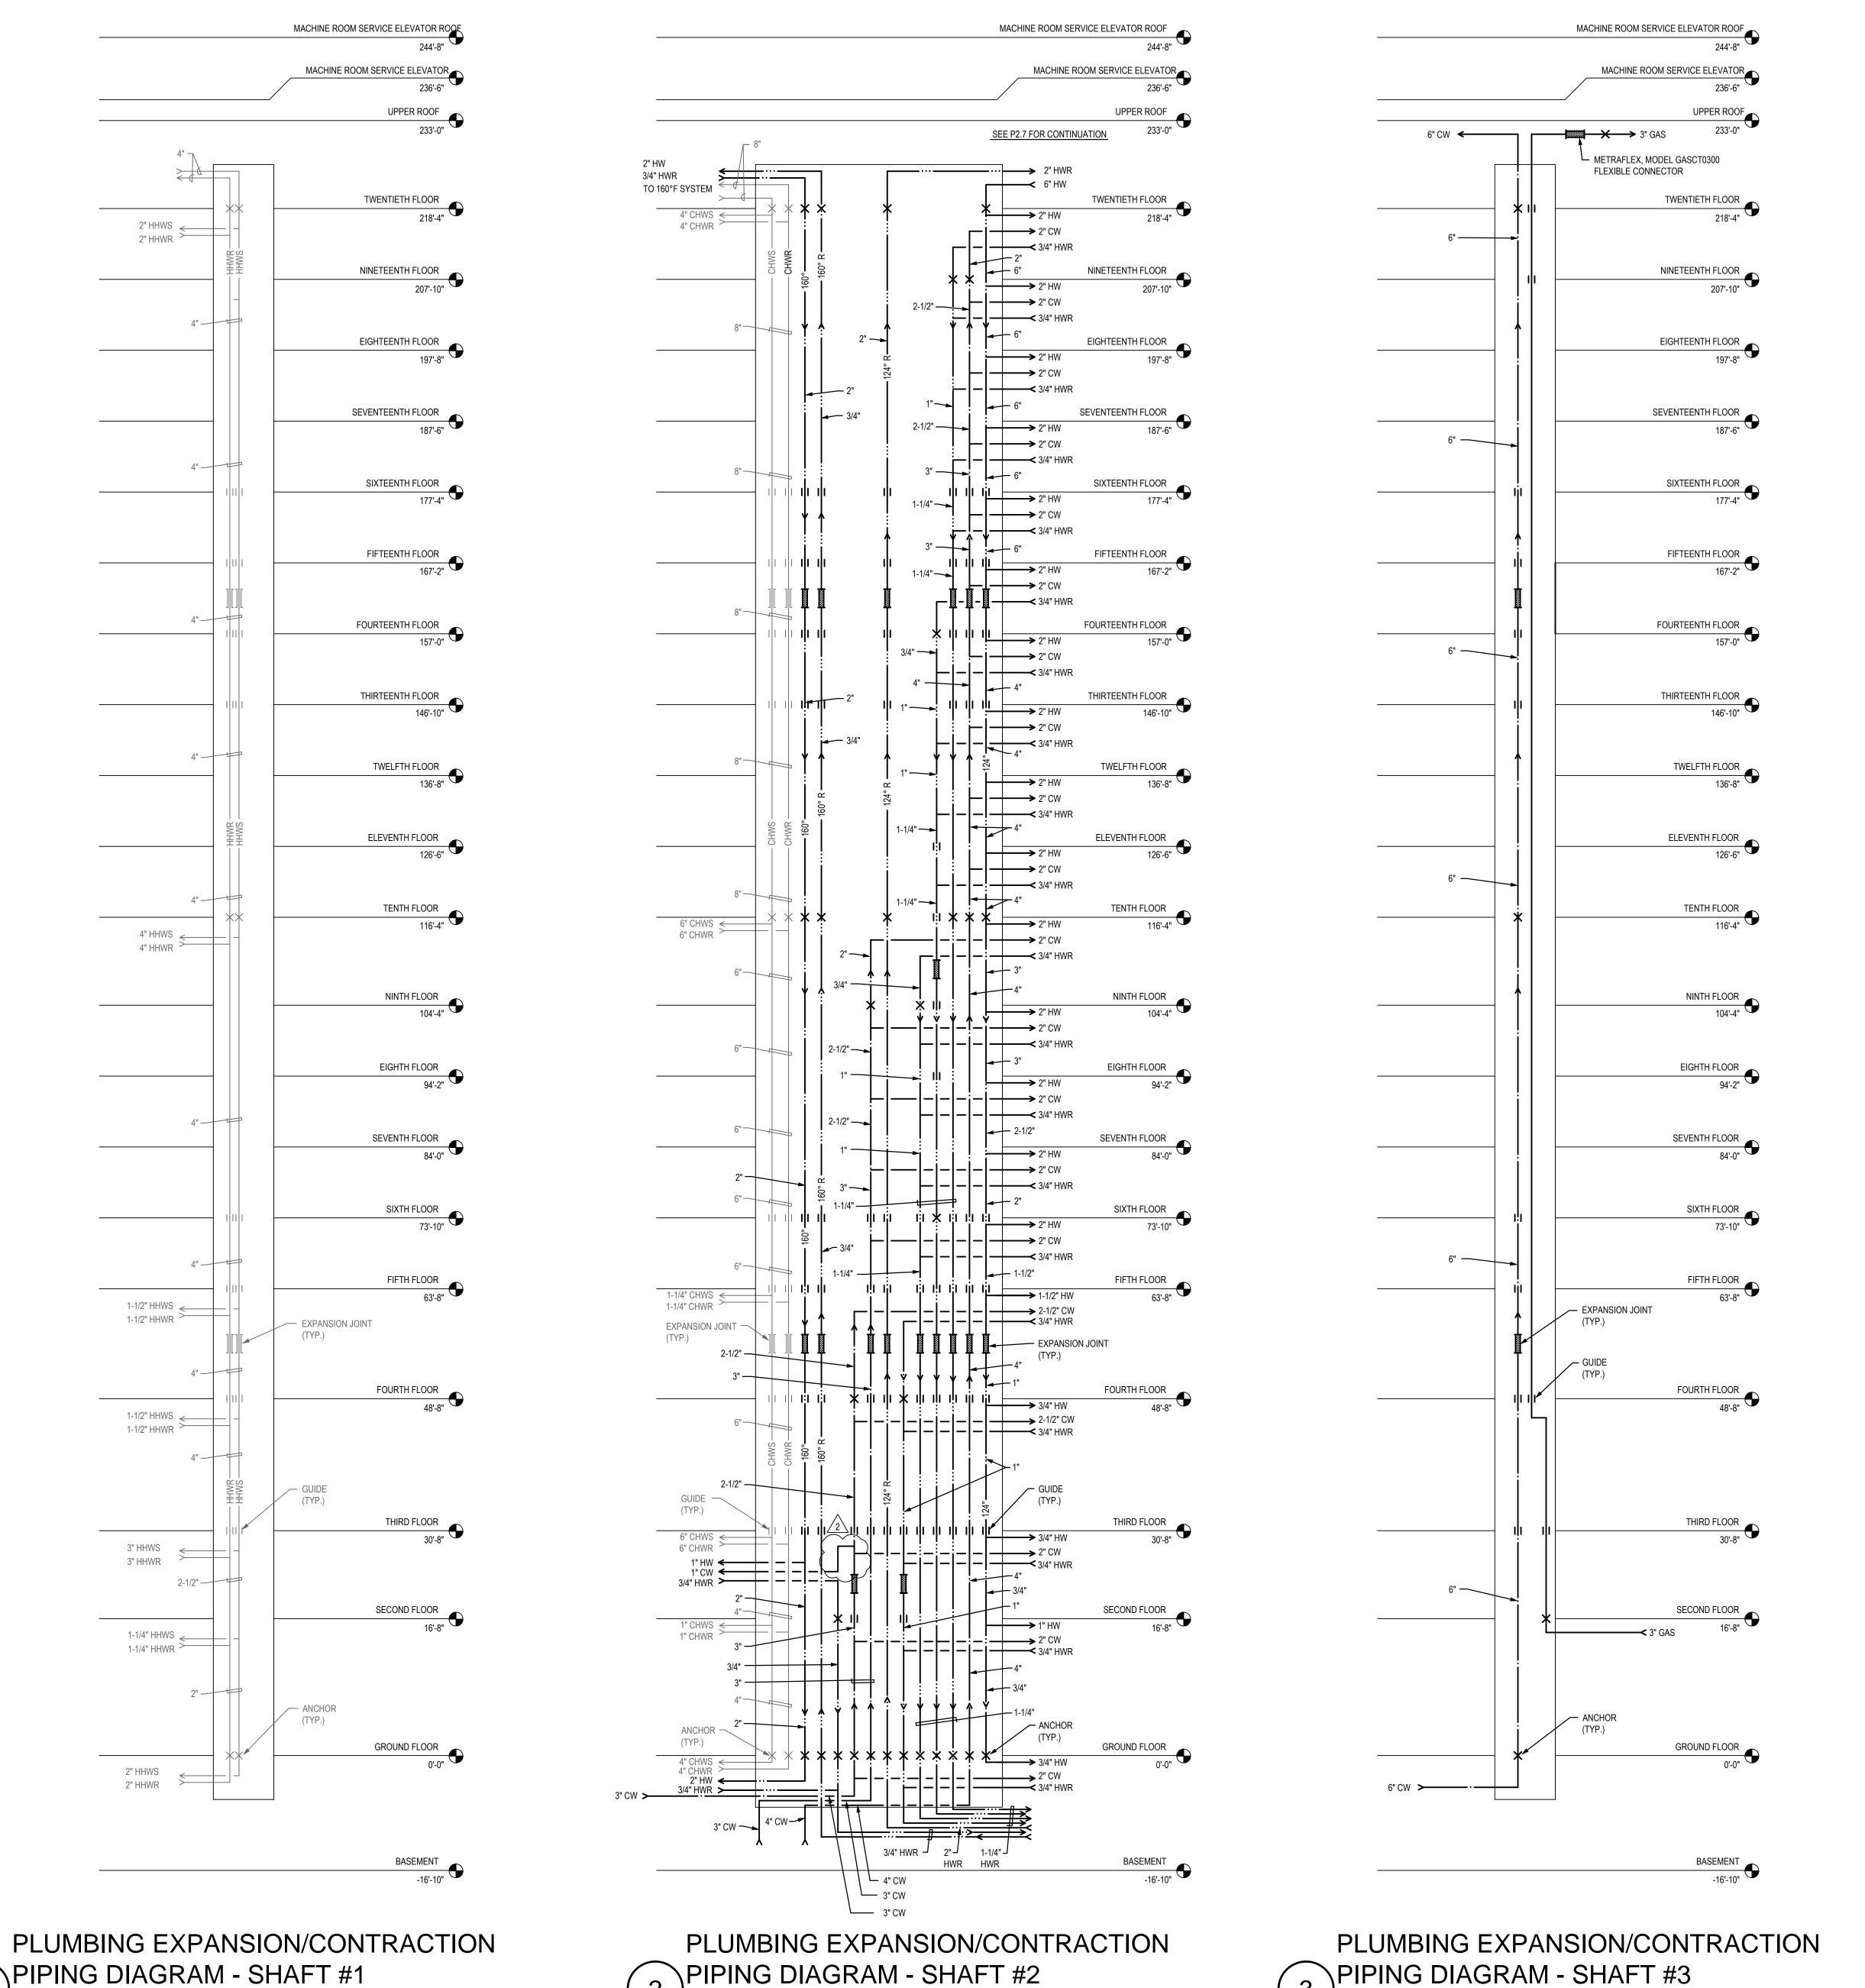

PIPE SHAFT EXPANSION & CONTRACTION GENERAL NOTES THIS DRAWING REPRESENTS A PERFORMANCE DESIGN INTENT TO ADDRESS THE SUPPORT AND EXPANSION/CONTRACTION OF THE PIPING ROUTED IN THE SHAFTS ON THIS PROJECT. THE ENTIRE INSTALLATION OF THE ANCHORS, GUIDES AND EXPANSION JOINTS IS TO BE PER THE MANUFACTURER'S WRITTEN REQUIREMENTS. THIS CONTRACTOR IS TO PROVIDE A SHOP DRAWING SUBMITTAL OF THE CALCULATIONS AND MANUFACTURER'S REQUIREMENTS OF PREDICTED PIPE EXPANSION AND ANCHOR FORCES FOR THE ENGINEER'S REVIEW. APPROVED MANUFACTURERS OF THIS SYSTEM 2. MASON ADSCO METRAFLEX EXPANSION JOINT MODEL NO'S AND GUIDE SHOWN FOR REFERENCE. EXPANSION JOINT FOR COPPER PIPING 4" AND SMALLER: METRAFLEX MODEL HPFF 3, HIGH PRESSURE AXIAL EXTERNALLY PRESSURIZED EXPANSION JOINT. EXPANSION JOINT FOR COPPER PIPING ABOVE 4": METRAFLEX "METRAGATOR" 300 PSI STAINLESS STEEL 4" AXIAL EXTERNALLY PRESSURIZED EXPANSION JOINT **EXPANSION JOINT FOR STEEL PIPING:** METRAFLEX "METRAGATOR" 300 PSI STEEL 4" AXIAL EXTERNALLY PRESSURIZED GUIDE: METRAFLEX VIBRATION ISOLATING RISER GUIDE (PROVIDE OPTIONAL DIELECTRIC SPACER FOR COPPER PIPE).

TEMPERATURE PARAMETERS:	
AMBIANT INSTALLATION TEMPERATURE:	40°F WINTER 120°F SUMMER
2. DOMESTIC COLD WATER:	70°F
3. DOMESTIC HOT WATER: PUBLIC USE: KITCHEN / LAUNDRY:	124°F 160°F
4. RECIRCULATION PIPING: PUBLIC USE: KITCHEN / LAUNDRY:	124°F 160°F

MECHANICAL PIPING SHOWN LIGHT IS FOR REFERENCE ONLY.

C 17578

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ARCHITECTS: THOMAS B. AWBREY CLIFFORD W. COOK SCOT W. McGILL

LSW Engineer Phoenix, Arizona 85021 Facsimile 602.336.3276 Project No. 2013-066.000

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or deviations from these drawings or the accompanying specifications without the written consent of the architects.

CONSULTANTS:



CONSTRUCTION BID SET A ADDENDUM A 02/02/201 1 INSTRUCTION BULLETIN 1 2 INSTRUCTION BULLETIN 2


TS DRAWN: LAM/RAB CHECKED:

PROJECT NO.: **12-1601** SHEET TITLE:

**PLUMBING EXPANSION/** CONTRACTION PIPING DIAGRAM

SHEET NO.:

\PIPING DIAGRAM - SHAFT #3

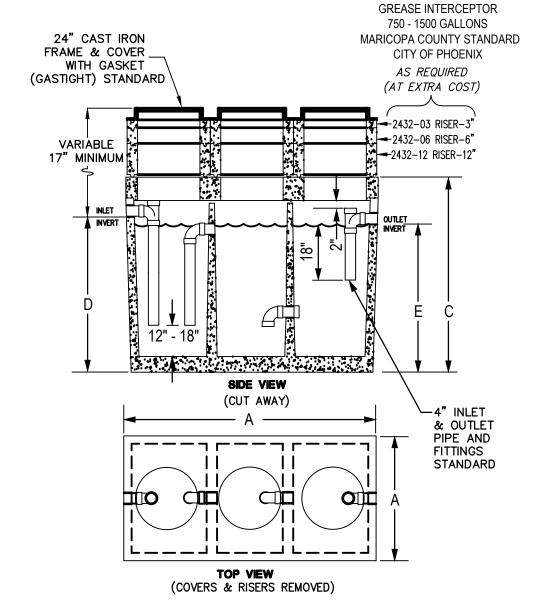


MODEL	LIQUID	DIMENSION	DIMENSION	DIMENSION	DIMENSION	DIMENSION	MINIMUM	MINIMUM
NUMBER	CAPACITY GALLONS	A	В	С	D	E	EXCAVATION WIDTH	LENGTH
CL750ECE-0	G 750	4'-0"	8'-1"	6'-3"	5'-0"	4'-9"	5'-0"	9'-1"
CL1000ECE-	G 1000	5'-1"	8'-2"	6'-3"	5'-0"	4'-9"	6'-1"	9'-2"
CL1200ECE-	G 1200	5 <b>'</b> –9 <b>"</b>	8'-6"	6'-6"	5'-0"	4'-9"	6'-9"	9'-6"
CL1500ECE-	G 1500	5 <b>'</b> -7 <b>"</b>	10'-8"	6'-3"	5'-0"	4'-9"	6' <b>-</b> 7"	11'–8"

BOX DESIGN LOAD: H-20 TRAFFIC.

FOR COMPLETE DESIGN AND PRODUCT INFORMATION CONTACT JENSEN PRECAST.


NOT TO SCALE

# 3-COMP. GREASE INTERCEPTOR DETAIL

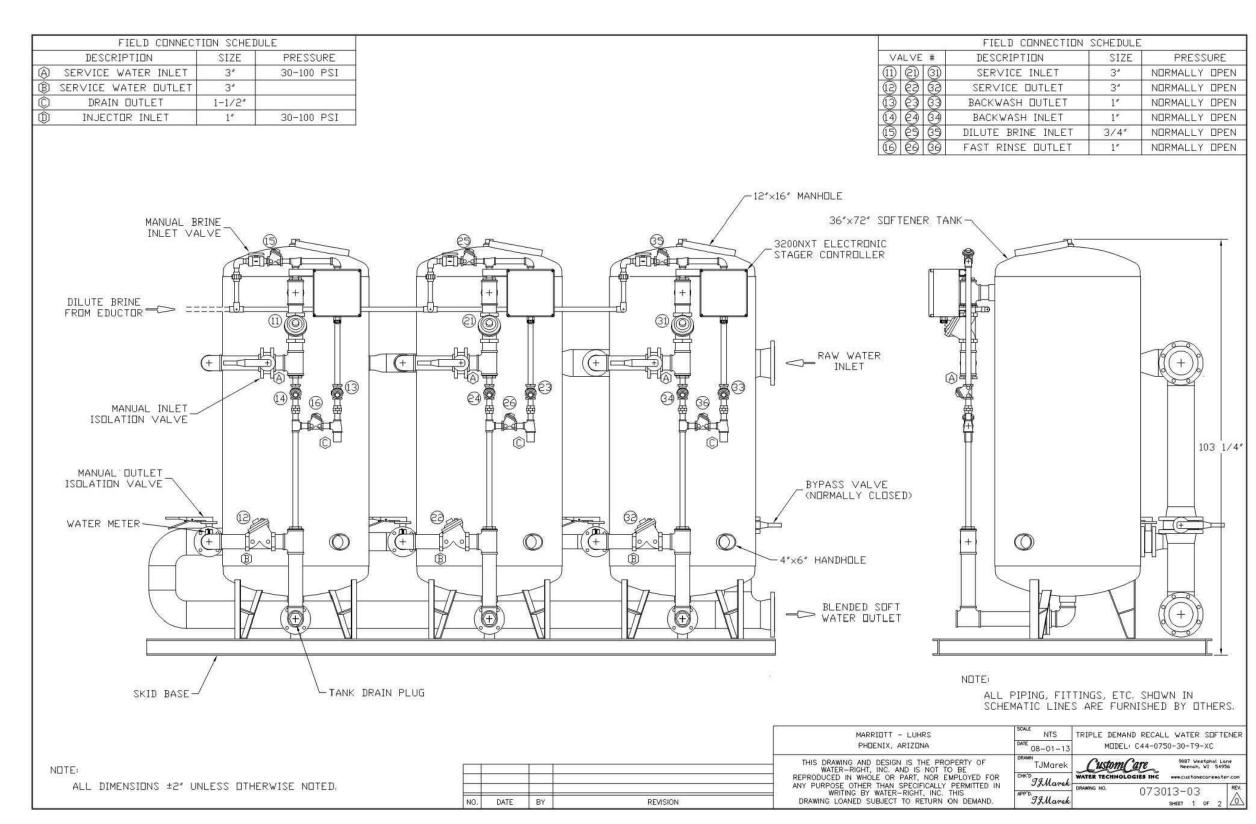


WATER SOFTENER PIPING DIAGRAM


NOT TO SCALE

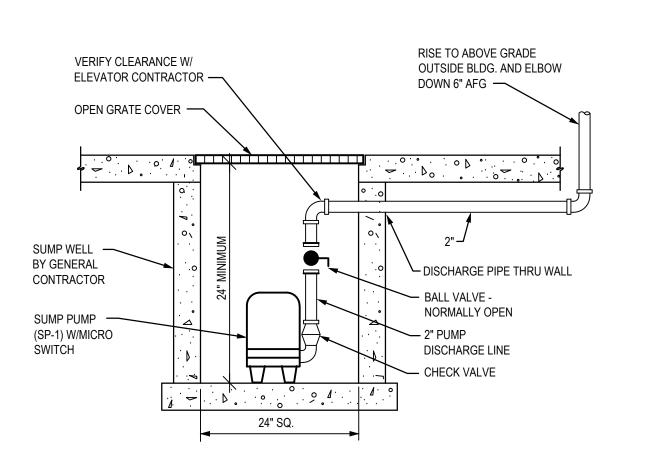


SUMP PUMP DETAIL

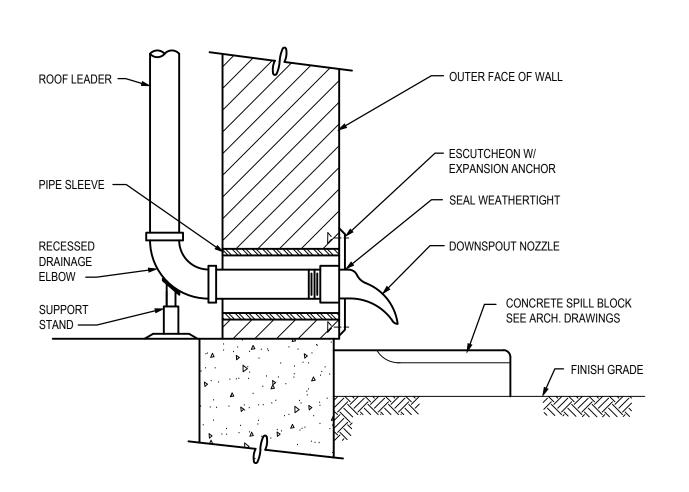

# RAINWATER PIPE THRU WALL DETAIL

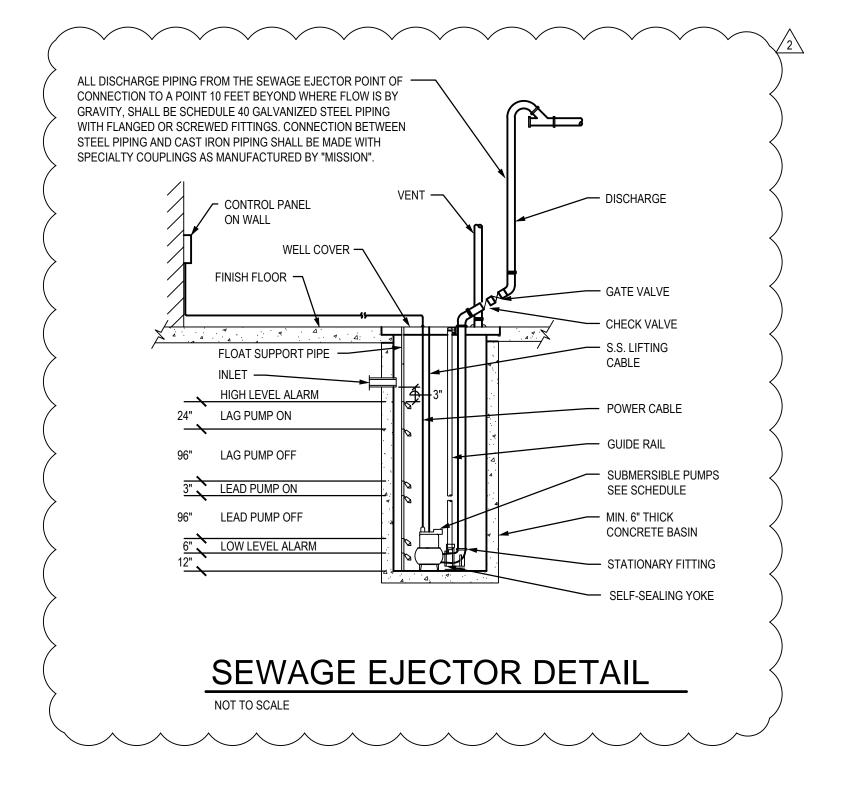

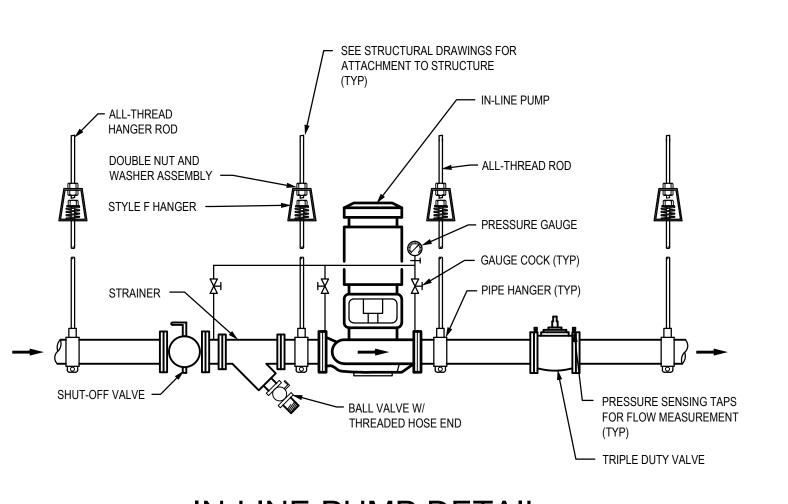

IN-LINE PUMP DETAIL



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Project No. 2013-066.000


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CONSULTANTS:



REVISIONS:

CONSTRUCTION BID SET

03/09/2015

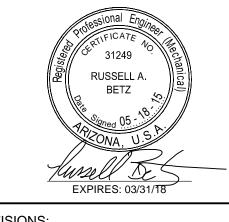A ADDENDUM A

02/02/2015

INSTRUCTION BULLETIN 1

05/11/2015

PROJECT:

RIOTT RESIDENCE OURTYARD @ LUH elopment of - LUHRS C Phoenix, Arizona

DRAWN: TS

CHECKED: RAB

DATE: 08/22/14

SHEET TITLE:
PLUMBING
DETAILS

PROJECT NO.: **12-1601** 

**P7**.1

	055 NOTEO #4 5 AND 0 BELOW	ַ דום		NIC F	IVTI	IDE COLI				
	SEE NOTES #1, 5 AND 8 BELOW	I			IXIU	JKE SCHI		UURTYARD BY MARRIC	OTT AS STANDARD FOR FL	.00RS 5 THRU 9)
PLAN MARK	ROOM DESCRIPTION	CW CW	IZE - INCHES HW	W	V	FIXTURE TYPE	SEE NOTE #5 BELOW FINISH	BASIS OF DESIGN MODEL	ALTERNATE MODEL	REMARKS
WC-1	GUESTROOM	1/2		3	2	WATER CLOSET	WHITE (4)	KOHLER K-3998-0	AM. STD. 2383.012.020	SEE NOTE #5 BELOW 1.6 GALLONS PER FLUSH
						SEAT	WHITE (4)	KOHLER K-4685-G-0	AM. STD. 5324.019.020	CLOSED FRONT
WC-2	GUESTROOM (ADA)	1/2		3	2	WATER CLOSET	WHITE (4)	KOHLER K-3999-0	AM. STD. 2386.012.020	SEE NOTE #3 BELOW 1.6 GALLONS PER FLUSH
						SEAT	WHITE (4)	KOHLER K-4685-G-0	AM. STD. 5325.999M.020	CLOSED FRONT
L-1	GUEST ROOM	1/2	1/2	2	1-1/2	LAVATORY	WHITE	KOHLER K-2979	NONE	
		-	-	-	-	FAUCET	POLISHED CHROME	KOHLER K-14402	NONE	
L-2	GUEST ROOM (ADA)	1/2	1/2	2	1-1/2	LAVATORY	WHITE	KOHLER K-2979	NONE	
		-	-	-	-	FAUCET	POLISHED CHROME	KOHLER K-14402	NONE	
BT-1	GUEST ROOM	1/2	1/2	2	1-1/2	BATHTUB	WHITE	KOHLER K-715-0 (L) OR K-716-0 (R)	AM. STD. 2390.202.020 (L) OR 2391.202.020 (R)	REFER TO NOTE #7 BELOW
		-	-	-	-	BATH / SHOWER VALVE	N/A	KOHLER K-304-KS & K-T10448-4-CP K-T395-CP & K-T15136-CP	SYMMONS CD0142-02-RHL-L/HD-TRM & 86-2X-BODY	-
		-	-	-	-	BATH / SHOWER TRIM	POLISHED CHROME	INCLUDED WITH BATH / SHOWER TRIM	AM. STD. RELIANT T064.602WDXH.002	LESS SHOWER HEAD
		-	-	-	-	BATH / SHOWER SPOUT	POLISHED CHROME	INCLUDED WITH BATH / SHOWER TRIM	INCLUDED WITH BATH / SHOWER TRIM	-
		-	-	-	-	BATHTUB DRAIN	POLISHED CHROME	McGUIRE MFG. CO. 1221LAT	GERBER 41-852	-
		-	-	-	-	SHOWER HEAD	POLISHED CHROME	KOHLER K-10284-CP	SPEAKMAN S-2005-HB	-
BT-2	GUEST ROOM (ADA)	1/2	1/2	2	1-1/2	BATHTUB	WHITE	KOHLER K-715-0 (L) OR K-716-0 (R)	AM. STD. 2390.202.020 (L) OR 2391.202.020 (R)	REFER TO NOTE #7 BELOW
		-	-	-	-	BATH / SHOWER VALVE	N/A	KOHLER K-304-KS & K-T10448-4-CP K-T395-CP & K-T15136-CP	SYMMONS CD0142-06-RHL-L/HDHSB-TRM, 86-1X-BODY & 4-460E-BODY	-
		-	-	-	-	BATH / SHOWER TRIM	POLISHED CHROME	INCLUDED WITH BATH / SHOWER TRIM	INCLUDED WITH BATH / SHOWER TRIM	LESS SHOWER HEAD
		-	-	-	-	SUPPLY ELBOW	POLISHED CHROME	INCLUDED WITH BATH / SHOWER TRIM	INCLUDED WITH BATH / SHOWER TRIM	-
		-	-	-	-	BATH / SHOWER SPOUT	POLISHED CHROME	INCLUDED WITH BATH / SHOWER TRIM	INCLUDED WITH BATH / SHOWER TRIM	-
		-	-	-	-	IN-LINE VACUUM BREAKER	POLISHED CHROME	KOHLER K-9660-CP	AM. STD. 1660.400.002	=
		-	-	-	-	BATHTUB DRAIN	POLISHED CHROME	McGUIRE MFG. CO. 1221PU	GERBER 41-802	-
		-	-	-	-	SHOWER HEADS	POLISHED CHROME	KOHLER K-286-CP, K-9514-CP, K-335-CP & K-45215-CP	SPEAKMAN VS-2950	SEE SECTION 10800 FOR SLIDE BAR
	SEE NOTES #1 & 5 BELOW		ח		NIC	FIVTUDE	CCLIEDI	II F (DECIDENCE	INN AS STANDARD FOR F	
	SEE NOTES #1 & 5 BELOW		PL	OMBI	NG	FIXTURE	20HEDU	JLE (KESIDENCE	INN AS STANDARD FOR F	,
WC-1	GUESTROOM	1/2		3	2	WATER CLOSET	WHITE (4)	TOTO CST744S	AM. STD. 2383.012.020	SEE NOTE #5 BELOW  1.6 GALLONS PER FLUSH
						SEAT	WHITE (4)	TOTO SS154	AM. STD. 5324.019.020	CLOSED FRONT
WC-2	GUESTROOM (ADA)	1/2		3	2	WATER CLOSET	WHITE (4)	TOTO CST744SL	AM. STD. 2386.012.020	SEE NOTE #3 BELOW 1.6 GALLONS PER FLUSH
						SEAT	WHITE (4)	TOTO SS154	AM. STD. 5325.999M.020	CLOSED FRONT
L-1	GUEST ROOM	1/2	1/2	2	1-1/2	LAVATORY	WHITE	KOHLER K-2979	NONE	
		-	-	-	-	FAUCET 2	BRUSHED BRONZE	KOHLER K-14402	NONE	
L-2	GUEST ROOM (ADA)	1/2	1/2	2	1-1/2	LAVATORY	WHITE	KOHLER K-2979	NONE	
		-	-	-	-	FAUCET 2	BRUSHED BRONZE	KOHLER K-14402	NONE	
BT-1	GUEST ROOM	1/2	1/2	2	1-1/2	BATHTUB	WHITE	KOHLER K-715-0 (L) OR K-716-0 (R)	AM. STD. 2390.202.020 (L) OR 2391.202.020 (R)	REFER TO NOTE #7 BELOW
		-	-	-	-	BATH / SHOWER VALVE	N/A	KOHLER K-304-KS	AM. STD. RELIANT R116SS	-
		-	-	-	-	BATH / SHOWER TRIM	POLISHED CHROME	K-T15601-4-CP	AM. STD. RELIANT T064.602WDXH.002	LESS SHOWER HEAD
		-	-	-	-	BATH / SHOWER SPOUT	POLISHED CHROME	INCLUDED WITH BATH / SHOWER TRIM	INCLUDED WITH BATH / SHOWER TRIM	-
		-	-	-	-	BATHTUB DRAIN	POLISHED CHROME	McGUIRE MFG. CO. 1221LAT	GERBER 41-852	-
		-	-	-	-	SHOWER HEAD	POLISHED CHROME	KOHLER K-10284-CP	SPEAKMAN S-2005-HB	-
BT-2	GUEST ROOM (ADA)	1/2	1/2	2	1-1/2	BATHTUB	WHITE	KOHLER K-715-0 (L) OR K-716-0 (R)	AM. STD. 2390.202.020 (L) OR 2391.202.020 (R)	REFER TO NOTE #7 BELOW
		-	-	-	-	BATH / SHOWER VALVE	N/A	KOHLER K-304-KS	AM. STD. RELIANT R116SS	-
		-	-	-	-	BATH / SHOWER TRIM	POLISHED CHROME	KOHLER K-T15621-4-CP	AM. STD. RELIANT T064.602WDXH.002	LESS SHOWER HEAD
		-	-	-	-	SUPPLY ELBOW	POLISHED CHROME	KOHLER K-9513-CP	INCLUDED WITH BATH / SHOWER TRIM	-
		-	-	-	-	BATH / SHOWER SPOUT	POLISHED CHROME	KOHLER K-15136CP	INCLUDED WITH BATH / SHOWER TRIM	-
		-	-	-	-	IN-LINE VACUUM BREAKER	POLISHED CHROME	KOHLER K-9660-CP	AM. STD. 1660.400.002	-
		-	-	-	-	BATHTUB DRAIN	POLISHED CHROME	McGUIRE MFG. CO. 1221PU	GERBER 41-802	-
_		-	-	-	-	SHOWER HEAD	POLISHED CHROME	KOHLER K-10284-CP	SPEAKMAN VS-1001-ADA	SEE SECTION 10800 FOR SLIDE BAR
KS-1	KITCHENETTE SINK	1/2	1/2	2	1-1/2	SINK	STAINLESS	STERLING UCL2522	ELKAY ELU2115	PROVIDED WITH GD
						FAUCET	POLISHED CHROME	KOHLER K-15171-F-CP	AM. STD. 4205.000.002	
_						STRAINER	POLISHED CHROME	KOHLER K-8801-CP	AM. STD. 4331.013.002	
KS-2	KITCHENETTE SINK (ADA)	1/2	1/2	2	1-1/2	SINK	STAINLESS	STERLING UCL2522	ELKAY ELU2115	PROVIDED WITH GD
_						FAUCET	POLISHED CHROME	KOHLER K-15171-F-CP	AM. STD. 4205.000.002	
_						STRAINER	POLISHED CHROME	KOHLER K-8801-CP	AM. STD. 4331.013.002	
GD	BREAKROOM / GUEST RM.	-	-	-	-	GARBAGE DISPOSER	N/A	BADGER $\frac{1}{3}$ HP, 1900 RPM		
				. 1						

PLAN	ROOM	SERVICE S			W	EIVTUDE TYPE	SEE NOTE #5 BELOW	DACIO OF DEGICAL MODEL	ALTERNATE MODEL	DEMADIZO
MARK	DESCRIPTION	CW	HW	W	V	FIXTURE TYPE WATER CLOSET, WALL HUNG,	FINISH	BASIS OF DESIGN MODEL		REMARKS
WC-3	PUBLIC RESTROOM	1		4	2	RIM AT 15" AFF	WHITE	KOHLER K4329-0	AM. STD. 2257.103	
						SEAT	WHITE	KOHLER K-4731-C-0	AM. STD. 5901.100.020	OPEN FRONT, LESS COVER
						FLUSH VALVE	CHROME	KOHLER K-13516-CP	DELTA 81T201	1.6 GALLONS PER FLUSH
WC-4	PUBLIC RESTROOM (ADA)	1		4	2	WATER CLOSET, WALL HUNG, RIM AT 18" AFF	WHITE	KOHLER K-4329-0	AM. STD. 32257.103	
						SEAT	WHITE (4)	KOHLER K4731-C-0	AM. STD. 5901.100.020	OPEN FRONT, LESS COVER
						FLUSH VALVE	CHROME	KOHLER K-13516-CP	DELTA 81T201	1.6 GALLONS PER FLUSH
UR	PUBLIC RESTROOM (ADA)	3/4		2	1-1/2	URINAL		NOMIED N 4000 T 0	AM. STD. 6590.001.020	SEE NOTE #3 BELOW
	r oblig near to an (t.a.r.)	0/1			1-1/2		WHITE	KOHLER K- 4989-T-0	AW. STD. 0090.001.020	
						FLUSH VALVE	CHROWE	KOHLER K-13521-CP	DELTA 81T231	
L-3	PER DRWG	1/2	1/2	2	1-1/2	LAVATORY	WHITE	KOHLER K-2210-0	AM. STD. 0496.221.020	
		-	-	-	-	FAUCET		KOHLER K-7514	NONE	
L-4	PUBLIC RESTROOM (ADA)	1/2	1/2	2	1-1/2	LAVATORY		SEE NOTE #6 BELOW	NONE	
		-	-	-	-	FAUCET	POLISHED CHROME	KOHLER K-7514	NONE	
SK-1	BREAKROOM	1/2	1/2	2	1-1/2	SINK	STAINLESS	KOHLER / STERLING B-155-2	ELKAY BCR153	
						FAUCET	CHROME	KOHLER K-1576-FL-CP	MOEN 7430	
						STRAINER	CHROME	KOHLER K-8801-CP		
						GARBAGE DISPOSER			ELKAY	
GD	BREAKROOM / GUEST RM.	-	-	-	-	GARBAGE DISPOSER  ELECTRIC WATER COOLER	N/A	BADGER <sup>1</sup> / <sub>3</sub> HP, 1900 RPM		
EWC	PER DRWG	1/2		2	1-1/2	(DUAL BI-LEVEL INSTALLED)	STAINLESS	HAWS H109.8	ELKAY ERFPM8K	INSTALL TO MEET ADA STANDARD
MS	PER DWGS.	3/4	3/4	3	1-1/2	MOP SINK	WHITE	MUSTEE 62M	FIAT MSBBID2424-100	
						FAUCET	CHROME	AM. STD. 8344.112.002	FIAT 830-AA-000	
						HOSE AND HOSE HOLDER	STAINLESS	MUSTEE 65.700	FIAT 832-AA-000	
						WALL GUARD	STAINLESS	MUSTEE 67.2424	FIAT MSG2424-000	
						MOP HANGER	STAINLESS	MUSTEE 63.600	FIAT 889-CC-000	
LS-1	MAIN LAUNDRY ROOM	1/2	1/2	2	1-1/2	LAUNDRY SINK	WHITE	KOHLER K - 12793-0	FIAT FLTD II	
						BRACKET	N/A	KOHLER K-1814-P	NONE	
						GOOSENECK SPOUT	CHROME	KOHLER K-13774-CP	FIAT A-1	
						KNEE CONTROL	CHROME	KOHLER K-13715-C-CP	NONE	
						STRAINER	CHROME	KOHLER K-9118-CP	FIAT, AM. STD. 4311.023.002	
SH	POOL AREA	1/2	1/2	2	1-1/2	SHOWER	POLISHED CHROME	SYMMONS CD0100-3501-CYL-L/HD-X & 86-1X-BODY & KOHLER K-10284-CP	DELTA T114261-LHD & R10000-UNWS & SPEAKMAN S-2005-HB-HB	
WB	GUEST LAUNDRY	3/4	3/4	2	1-1/2	WASHER BOX	WHITE	SYMMONS W-602	OI LAMWAN 3-2003-HD-HD	
			G/ 1		1-1/2			JAY R. SMITH 5509QT	JOSAM, WADE, ZURN	EXTERIIOR LOCATIONS
НВ	PER DRWGS.	3/4	-	-	-	WALL HYDRANT	N/A			
HB	PER DRWGS.	3/4	-	-	-	WALL HYDRANT	N/A	JAY R. SMITH 5609QT	JOSAM, WADE, ZURN	INTERIOR LOCATIONS
H & C HB	TRASH / RECYCLE	3/4	-	-	-	WALL HYDRANT	N/A	JAY R. SMITH 5560QT-H	JOSAM, WADE, ZURN	
AD-1	PER DWGS			SEE NOTE#	2 BELOW	AREA DRAIN	NICKLE BRONZE	JAY R. SMITH 2110	JOSAM, WADE, ZURN	
EEW	PER DRWGS.	1/2	1/2	2	1-1/2	EMERGENCY EYEWASH	GREEN	HAWS 7260BT-7270BT	SPEAKMAN SE-580-PT	9
LT-1	MAIN LAUNDRY ROOM	-	-	4"	2	LINT TROUGH / INTERCEPTOR	STAINLESS STEEL	JAY R SMITH SQ-9-3615 SERIES	WADE 5600 SERIES, ZURN Z-1185 SERIES	CUSTOM MADE FABRICATED STEE PRIMARY AND SECONDARY SCREE
FD-1	RESTROOMS & BACK	-	-	SEE NOTE	#2 BELOW	FLOOR DRAIN	NICKEL BRONZE	JAY R. SMITH 2005	JOSAM, WADE, ZURN	I MINIMINI AND SECONDART SCREE
FD-2	OF HOUSE POOL EQUIPMENT ROOM	_	_	SEE NOTE		FLOOR DRAIN	NICKEL BRONZE	JAY R. SMITH 2320	JOSAM, WADE, ZURN	
	& MAIN LAUNDRY ROOM							JAY R. SMITH 3140	JOSAM, WADE, ZURN	
FS	PER DRWGS.	-	-	SEE NOTE	#Z DELUW	FLOOR SINK	N/A	WAT IX OWITH STAU	OCCAMI, WALL, ZUNIN	
										WITH 2646 Y ADAPTER
FCO	PER DRWGS.	-	-	-	-	FLOOR CLEANOUT	NICKEL BRONZE	JAY R. SMITH 4020		
WCO	PER DWGS					WALL CLEANOUT	STAINLESS	JAY R. SMITH 4402	JOSAM, WADE, ZURN	
RD	PER DWGS.			SEE NOTE	E #2 BELOW	ROOF DRAIN	N/A	JAY R. SMITH 1015	JOSAM, WADE, ZURN	
OD	PER DWGS.			SEE NOTE	#2 BELOW	ROOF OVERFLOW DRAIN	N/A	JAY R. SMITH 1070	JOSAM, WADE, ZURN	
LS-2	GUEST LAUNDRY ROOM	1/2	1/2	2	1-1/2	LAUNDRY SINK	STAINLESS STEEL	JUST SLX-1815-A-GR	NONE NONE	
LU 2	SSEST ENGREPH INCOM	1/2	1/2		1-1/2			JUST JTR-50		
						FAUCET	NICKEL BRONZE		NONE	
						STRAINER	STAINLESS STEEL	JUST J-35	NONE	
US	UTILITY SINK	1/2	1/2	2	1-1/2	UTILITY SINK	WHITE	KOHLER K - 12794-0	FIAT SW-1W	
						BRACKET	N/A	KOHLER K-1814-P	NONE	
						GOOSENECK SPOUT	CHROME	KOHLER K-6130-4-CP	FIAT A-1	
						STRAINER	CHROME	KOHLER K-9118-CP	FIAT, AM. STD. 4311.023.002	
			'							

1) PROVIDE WITH RED/HOT AND BLUE/COLD WATER INDICATORS ON ALL FIXTURES.

3 FLUSH TRIGGER SHALL BE ON WIDE SIDE OF ROOM.

(4) WHITE COLOR FOR TOILET SHALL BE SAME WHITE COLOR AS TUB. VERIFY COLOR PRIOR TO ORDERING.

5 PLUMBING CONTRACTOR SHALL DIRECT FIXTURE SUPPLIER TO PROVIDE POLISHED CHROME FINISH WHERE INDICATED. MANUFACTURER'S PART NUMBER MAY NOT MATCH THAT OPTION.

(6) THIS IS A CUSTOM FIXTURE. REFER TO ARCHITECTURAL AND INTERIORS DESIGN FOR ADDITIONAL INFORMATION AND CONSTRUCTION DETAILS.

7) REFER TO SECTION 06 61 13 AND TUB AND SHOWER SURROUND PRODUCT MANUAL FOR TUB SURROUNDS.

PROVIDE AND INSTALL ALL PLUMBING FIXTURES AND KITCHEN EQUIPMENT WITH SUPPLY INLETS, SUPPLY 1/4 TURN QUICK STOPS, SUPPLY RISERS, WASTE TRAPS AND TRAP ARMS. USE APPROVED MANUFACTURER'S AS SPECIFIED.

9 PROVIDE AND INSTALL A WALL MOUNTED THERMOSTATIC MIXING VALVE BELOW FIXTURE. USE "GUARDIAN MODEL G3600 FACTORY SET AT 85° F. DELIVERY TEMPERATURE WITH 1/2" HW & CW INLETS AND 1/2" TW OUTLET OR AN APPROVED EQUAL.

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CONSTRUCTION BID SET A ADDENDUM A INSTRUCTION BULLETIN 1 02/23/2015 INSTRUCTION BULLETIN 2 05/11/2015

LRW PROJECT NO.: **12-1601** 

SHEET TITLE:
PLUMBING FIXTURE
SCHEDULE

	EXPANSION TANK SCHEDULE													
MARK	MANUFACTURER	MODEL	ACCEPTANCE VOLUME (GAL)	DIMEN DIA	ISIONS LENGTH	OPER PRESS (PSI)	REMARKS							
ET-1	BELL & GOSSETT	PTA-452	137	30	91	-	-							
ET-2	BELL & GOSSETT	PTA-80V	34	24	40	-	-							

				D	OMES	STIC WA	TER	ВОО	STE	R PU	MP S	SCH	EDUL	.E		
				INLET PR	ESS (PSI)	DISCHARGE	FLOW	HEADER	# OF	PUMP					OPER	
MARK	SERVES	MANUFACTURER	MODEL	MIN	MAX	PRESSURE (PSI)	(GPM)	SIZE	PUMPS	TYPE	FLA	MCA	MOCP	V/PH	WEIGHT (LBS)	REMARKS
BP-1	ROOF	QUANTUMFLO	GV3-375-130-460/3-NSF	50	70	180	375	6"	3	VERTICAL	70.5	-	100	460/3	-	-
BP-2	5TH TO 9TH FLOORS	QUANTUMFLO	GV3-170-50-460/3-NSF	50	70	100	170	4"	3	VERTICAL	25.8	-	40	460/3	-	-
BP-3	10TH TO 19TH FLOORS	QUANTUMFLO	GV3-265-100-460/3-NSF	50	70	150	265	6"	3	VERTICAL	51.0	-	80	460/3	-	-

1) THE COMPLETE BOOSTER PUMP SKID SHALL ADHERE TO NSF/ANSI 61 REQUIREMENTS, THE HEADER PIPING SHALL BE 304SS AND THE VFD'S SHALL BE INSTALLED IN THE CONTROL CABINET.

		WATER	SOFT	ENER	AND	BR	INE TA	ANK S	SCHE	DUI	_E
MARK	MFGR	MODEL	GRAINS/POUN	DS CAP.	CAP. FLOW RATE		BACKWASH FLOWRATE	RESIN QUANTITY	SALT STORAGE	MAX. PSI	REMARKS
IVI/ (I XI X	IVII OIX	WOBLE	MIN.	MAX.	PEAK	CONT.	GPM	FT.3	LBS.	DROP	TALIWI (TATA)
WS-1	CUSTOM CARE	C44-600-25-TRIPLEX	400,000	600,000	190	140	30	20	1200	25	1 2 3 4 5

1) TRIPLE ALTERNATING WATER SOFTENER SYSTEM INCLUDES (3) FIBERGLASS RESIN TANKS (NON-CODE 150 PSI), (3) FLECK 2" 2900 TOP MOUNT CONTROL VALVES WITH NXT TIMERS (1) 2" REMOTE METER, (12) CUBIC FEET SOFTENING RESIN, (4) PER VESSEL, SUPPORT GRAVEL AND (1) BRINE TANK ASSEMBLY.

2 REQUIRES SINGLE POINT 120 VAC, 1-PH, 60 HZ ELECTRICAL CONNECTION.

(3) PROVIDE FACTORY SKID MOUNTED, PREPIPED AND PREWIRED SYSTEM (6" INLET/OUTLET SERVICE HEADERS) SCHEDULE 80 PVC INTERCONNECTING PIPING.

4 TRIPLE ALTERNATING FLOW CONFIGURATION.

5) MINIMUM FLOW TO AVOID CHANNELING OF SYSTEM IS 3 GPM, SUSTAINED FLOW BELOW 3 GPM WILL CHANNEL THE RESIN BED.

	WATER STORAGE TANK SCHEDULE												
MARK	MANUFACTURER	MODEL	STORAGE CAPACITY (GAL)	DIMEN DIA	SIONS HEIGHT	OPER PRESS (PSI)	OPER WEIGHT (LBS)	REMARKS					
ST-1 - 6	LOCHINVAR	RGA0752	752	52	104	150	8300						
ST-7 & 8	LOCHINVAR	RGA0650	650	52	92	150	7000						

				CIR	CUL	ATIN	IG PI	JMP	SCH	EDULE
MARK	SERVES	MANUFACTURER	MODEL	GPM	TOTAL HEAD (FT)	RPM	MOTOR HP	V/PH	OPER WEIGHT (LBS)	REMARKS
RP-1A & 1B	160°F HW	EBARA	EVMU3-5	6	180	3500	1-1/2	480/3	45	STAINLESS STEEL CONSTRUCTION - BASEMENT THRU 2ND FLOOR AND BACK UP TO ROOF, NON-COINCIDENTAL OPERATION
RP-2A & 2B	124°F HW	EBARA	EVMU3-9	10	300	3500	3	480/3	45	STAINLESS STEEL CONSTRUCTION - BASEMENT THRU 4TH FLOOR AND BACK UP TO ROOF, NON-COINCIDENTAL OPERATION
RP-3A & 3B	124°F HW	EBARA	EVMU3-8	10	260	3500	2	480/3	45	STAINLESS STEEL CONSTRUCTION - 5TH FLOOR THRU 9TH FLOOR AND BACK UP TO ROOF, NON-COINCIDENTAL OPERATION
RP-4A & 4B	124°F HW	EBARA	EVMU3-7	10	220	3500	2	480/3	45	STAINLESS STEEL CONSTRUCTION - 10TH FLOOR THRU 14TH FLOOR AND BACK UP TO ROOF, NON-COINCIDENTAL OPERATION
RP-5A & 5B	124°F HW	EBARA	EVMU3-6	10	180	3500	1-1/2	480/3	45	STAINLESS STEEL CONSTRUCTION - 15TH FLOOR THRU 19TH FLOOR AND BACK UP TO ROOF, NON-COINCIDENTAL OPERATION
RP-6A & 6B	140°F HW	PATTERSON	5741-97	100	18	-	1	480/3	91	LEAD-FREE BRONZE CONSTRUCTION, NON-COINCIDENTAL OPERATION
RP-7A & 7B	165°F HW	PATTERSON	5746-97	55	20	-	3/4	480/3	84	LEAD-FREE BRONZE CONSTRUCTION, NON-COINCIDENTAL OPERATION

CIRCULATING PUMP MUST ADHERE TO NSF/ANSI 61 REQUIREMENTS.

	THERMOSTATIC MIXING VALVE SCHEDULE													
MARK	SERVES	MANUFACTURER	MODEL	COLD INLET SIZE	HOT INLET SIZE	TW OUTLET SIZE	MAX TW GPM	MIN OPER PRESS (PSI)	TW TEMP SETPOINT (°F)	REMARKS				
MV-1	124°F HW	ARMSTRONG	DMC-80-80	4"	4"	4"	165	64	124	10 GPM MINIMUM FLOW, 5 PSI MAX ΔP				
MV-2	140°F HW	ARMSTRONG	RADA 320	3/4"	3/4"	1"	16	50	140					

			DU	PLEX S	SEW	AGE	EJE	CTOF	R SC	HED	ULE	
						TOTAL		MOTOR		ВА	SIN	
MARK	SERVES	MANUFACTURER MODEL TYPE GPM HEAD RPM HP V (EACH)		V/PH	DIA	DEPTH	REMARKS 2					
SE-1	BASEMENT	EBARA	DLFU-100LMFU63.7	SUBMERSIBLE	200	31	1,730	2 @ 5 HP	480/3	60"		ROVIDE NEMA 4X DUPLEX JUNCTION BOX, FIBERGLASS BASIN, STEEL BASIN COVER & FRAME, GASKETS, DUPLEX ALTERNATING
												CONTROLS, ALARMS, REMOTE CONTACTS, ETC. 1 2


PROVIDE REMOVABLE SYSTEM WITH DUPLEX SUBMERSIBLE PUMPS, DOUBLE SEAL TANDEM MOTOR, ADVANCED LEVEL CONTROLLER AND BRONZE IMPELLER. PROVIDE FIBERGLASS BASIN 60" DIA. x 282" DEEP, ODC REMOVAL SYSTEM, DUPLEX DEAD FRONT CONTROL PANEL INTRINSICALLY SAFE CONTROLS, 4" PIPE DISCHARGE, INDEPENDENT 6" VENT RUN UP THRU ROOE, MOUNTING HARDWARE FOR PERIMETER OF COVER, PUMP OPENING COVER, PUMP LIFTING CHAIN, PUMP WATER ALARM CONTROLS. EACH PUMP DISCHARGE SHALL HAVE CAST IRON BALL CHECK VALVE, UNION AND GATE VALVE.

PROVIDE QUANTUMFLO NEMA-4 DUPLEX CONTROLLER WITH COLOR TOUCH SCREEN, PLC CONTROL, ALARM HORN & LIGHT, MODBUS OUTPUTS FOR MONITORING, AND ULTRASONIC LEVEL INDICATOR, PROVIDE EXPLOSION PROOF PUMPS WITH K-SERIES SINGLE-VANE, SEMI-OPEN IMPELLER WITH BACK PUMP OUT VANES. PROVIDE PUMPS

#### SEQUENCE OF OPERATION

SEWAGE EJECTOR CONTROL SYSTEM SHALL UTILIZE A STAINLESS STEEL, SUBMERSIBLE LIQUID TRANSDUCER. UPON A RISE OF FLUID LEVEL IN THE EJECTOR PIT, THE LEAD PUMP SHALL ENGAGE. IF THE FLUID LEVEL CONTINUES TO RISE, THE LAG PUMP SHALL ENGAGE UNTIL THE LIQUID LEVEL DROPS TO NORMAL. SHOULD THE FLUID RISE, AN AUDIO/VISUAL HIGH WATER ALARM SYSTEM SHALL ACTIVATE AND REMAIN ON UNTIL THE FLUID LEVEL DROPS. CONTROLLER SHALL AUTOMATICALLY CYCLE LEAD BASED ON RUN TIME.

	SUMP PUMP SCHEDULE												
MARK	SERVES	MANUFACTURER	MODEL	TYPE	GPM	TOTAL HEAD (FT)	RPM	MOTOR HP	V/PH	REMARKS			
P-1, 2 & 3	ELEVATORS	WEIL	1451	SUBMERSIBLE	50	38	1750	1	120/1	PROVIDE ONE FOR EACH ELEVATOR IN PIT WITH GRATE. PROVIDE TETHERED LEVEL CONTROL.			
SP-4	AREA WELL	WEIL	1451	SUBMERSIBLE	50	38	1750	1	120/1	PROVIDE ONE FOR EACH ELEVATOR IN PIT WITH GRATE. PROVIDE TETHERED LEVEL			

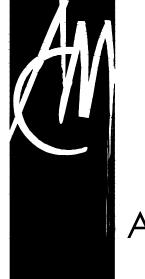

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CONSTRUCTION BID SET A ADDENDUM A 02/02/201 1\ INSTRUCTION BULLETIN 1 02/23/2015

INSTRUCTION BULLETIN 2 05/11/2015

LRW DRAWN: RAB CHECKED:

**PLUMBING SCHEDULES** 

PROJECT NO.: **12-1601**